



1132 EMPRESS AVENUE Re-issued for Re-Zoning and Parking Variance

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Re-Issued for Rezoning 24.09.26 4 Re-Issued for Rezoning 24.03.08 Re-Issued for Rezoning 23.04.28 Re-Issued for Rezoning 22.01.31

Issued for Rezoning 21.04.28 Issued for Rezoning 21.01.29 Pre Application

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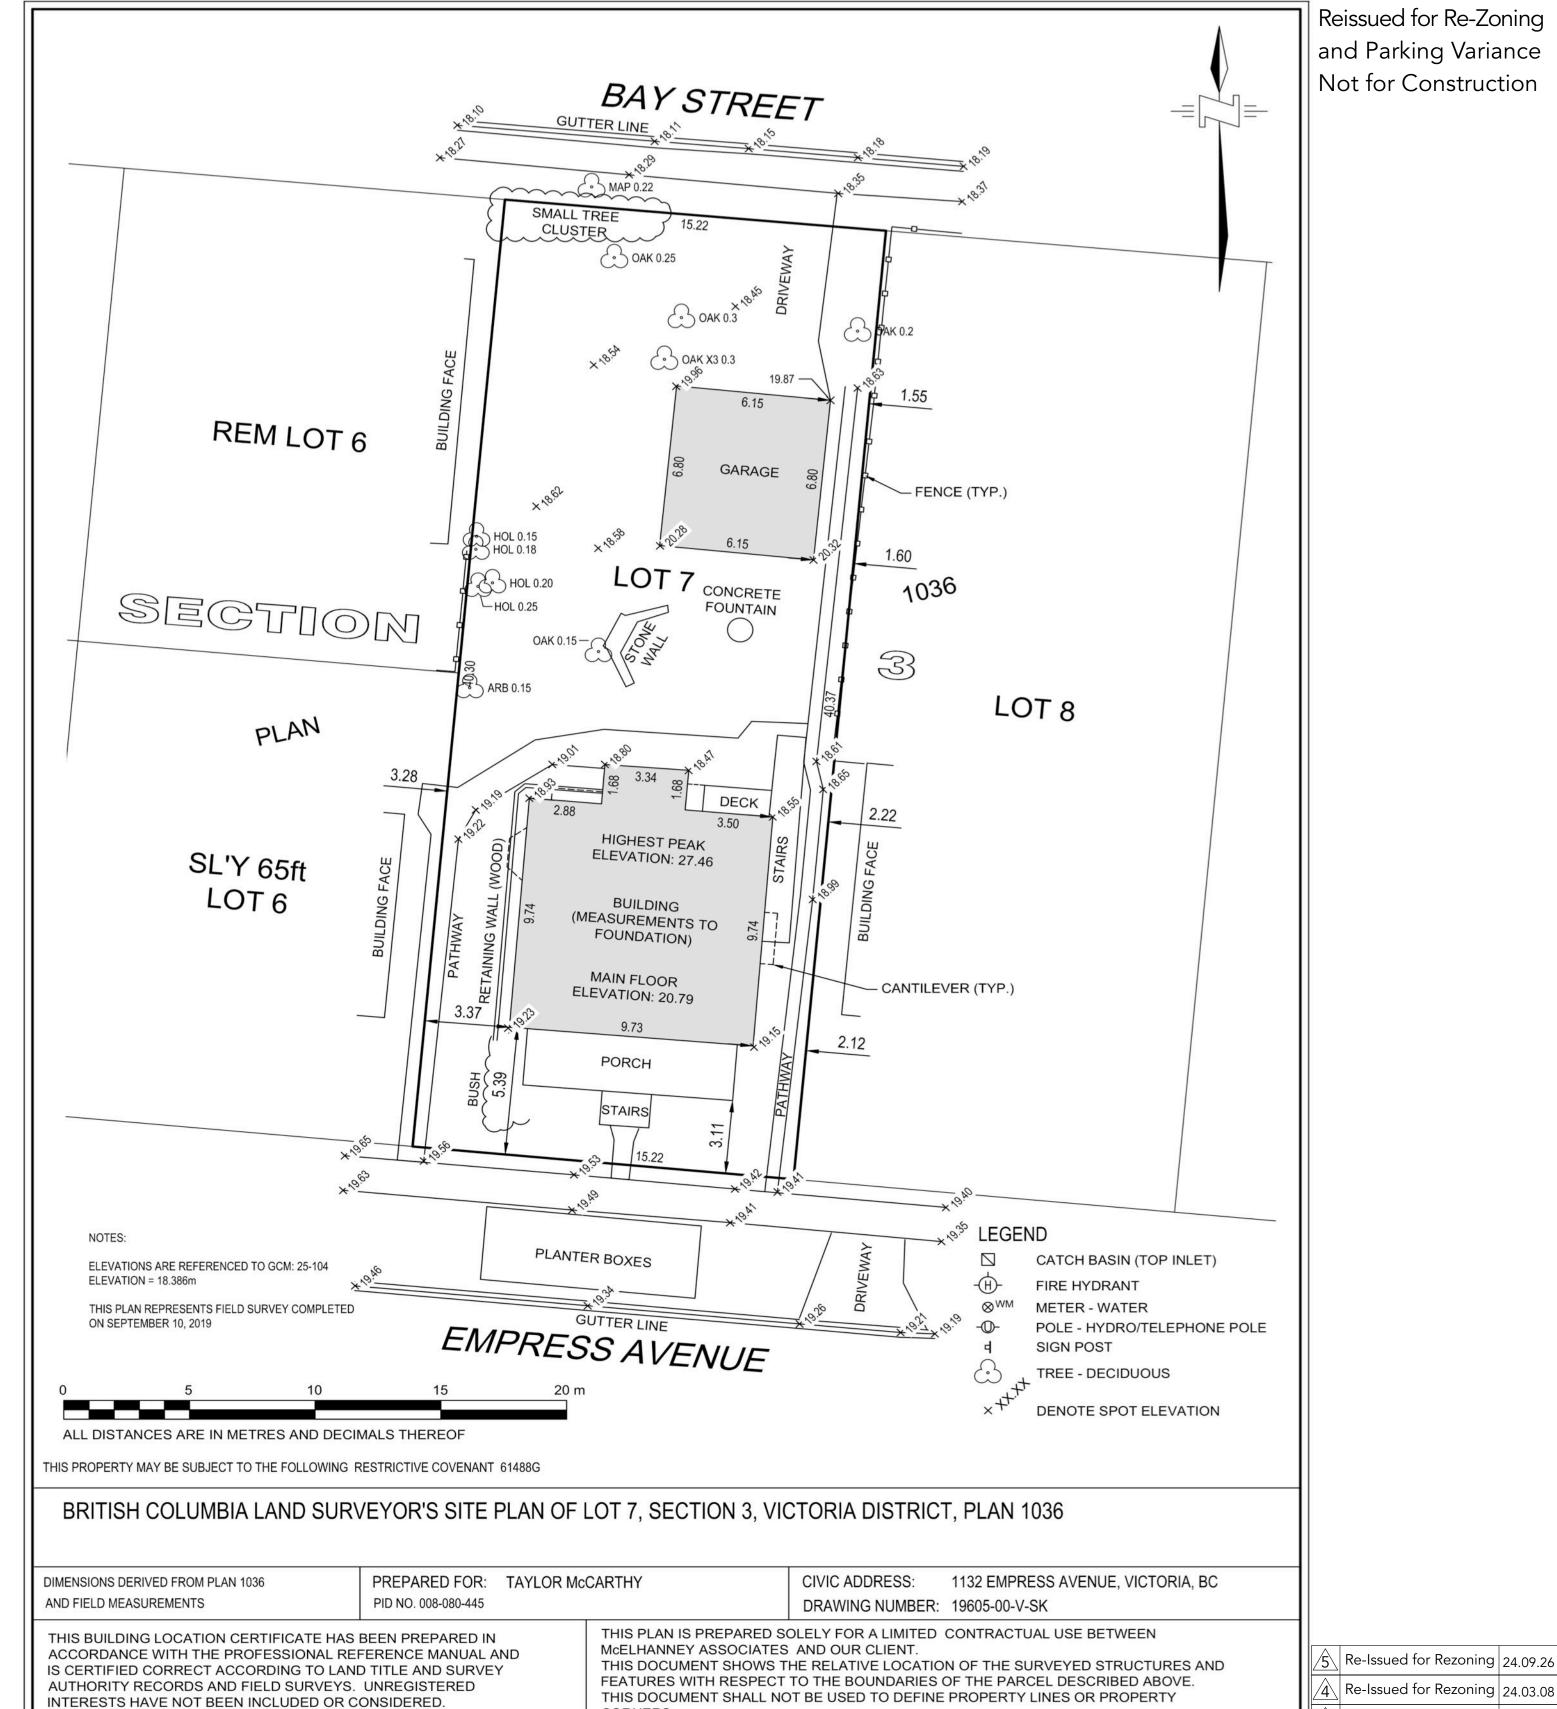
project name 1132 Empress Avenue

sheet title

Cover Sheet

24.09.26 project no. 1906 date

A000



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(01) Survey

DATED THIS 11th DAY OF SEPTEMBER, 2019

McElhanney

Bar Scale

THIS DOCUMENT IS NOT VALID UNLESS DIGITALLY SIGNED

Digitally signed by Glen Quarmby

Date: 2019.09.12 14:05:11 -07'00'

McElhanney Associates Land Surveying Ltd.

GLEN A. QUARMBY, BCLS, CLS

Suite 500 3960 Quadra Street

ACTIONS TAKEN BASED ON THIS DOCUMENT.

Victoria BC Canada V8X 4A3

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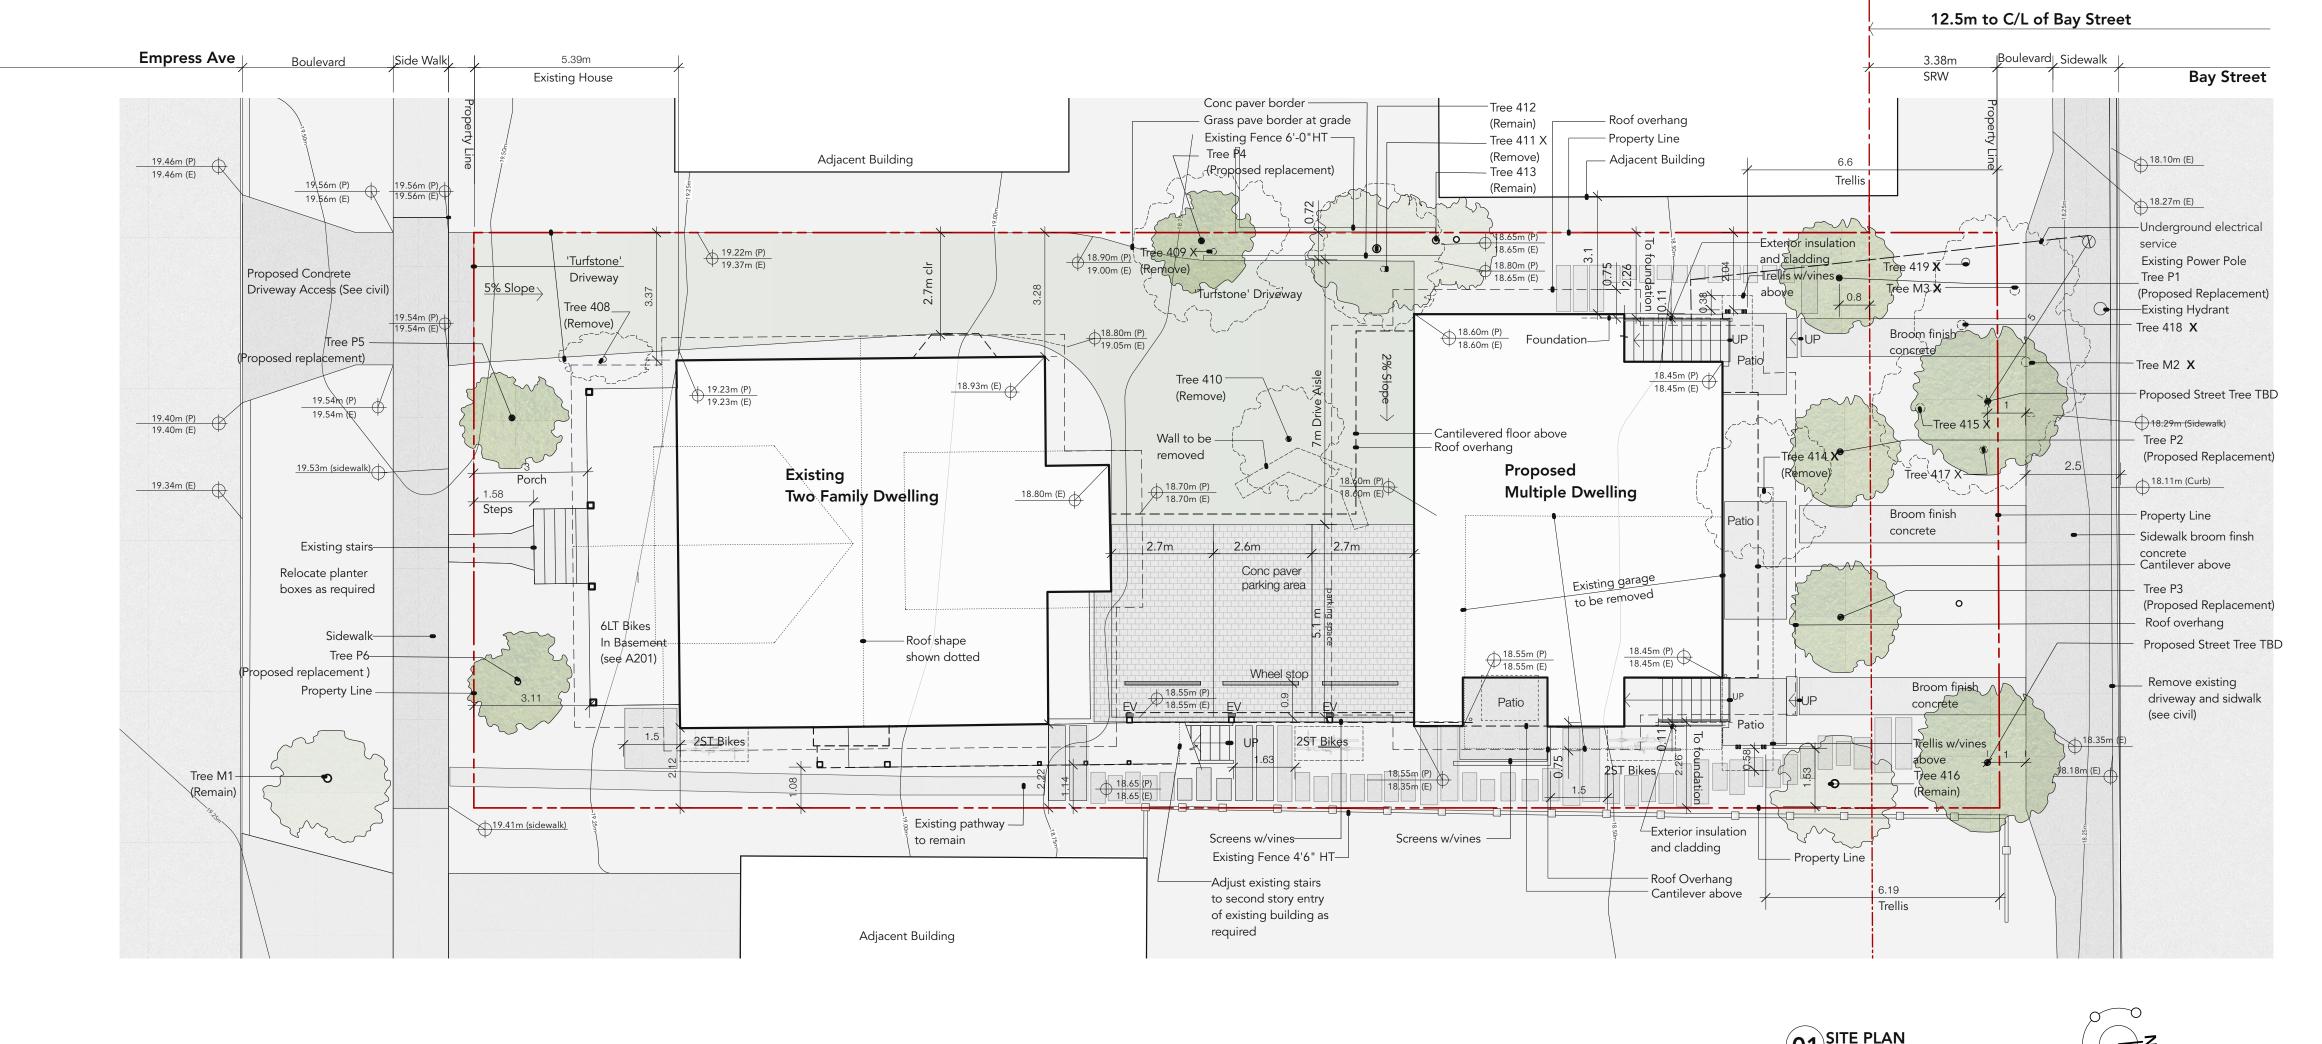
project name 1132 Empress Avenue

sheet title

Survey

project no. 1906 date 24.09.26

revison no. A001



See L100 landscape concept

(E) Existing grade
(P) Proposed grade

(05) TREE RESOURCE SPREADSHEET

Tree Preservation notes:

1) Refer to Tree Management Plan by Talbot Mackenzie & Associates
Arborists dated April 30, 2021 revised

2) Tree numbers on site plan reference see drawing 5-A100 for summary copied from TMP

Street trees to be procured by applicant species TBD by parks at BP stage

<u>19.23m</u> ○ Cantilever 19.23m May be impacted by SS 19.38m ²18.47m E <u>18.90m</u> 19.32m May be impacted by prososed 18.80m 19.44m Proposed A 18.70m 18.60m **Parking Area** Existing Proposed Codominant leaders, future conflict Conflict with proposed driveway, ິ 18.45m E with existing buildings. Building and Driveway Building Existing Proposed 18.45m P Parking Area ์ 18.45m E 135.62 m² 118.55 m² Building Building and steps Dieback, deadwood, pruning wounds Within footprint of proposed 18.47m P Moderate with poor compartmentalization. driveway. 138.50 m² 19.44m Adjacent to property fence, 18.50m E codominant, small deadwood, small 19.33m secondary stem with included bark in Within proposed driveway ——Cantilever attachment. Restricted growing footprint. May also be impacted 19.28m <u> 18.60m</u> 19.15m 7G <u>18.55m</u> *↓* conflicting with neighbour's roof. driveway, SS/SD. <u>√ 18.52m</u> 18.45m P 18.50m E 18.52m Growing adjacent to property fence, $138.50\text{m}^2 + 135.62\text{m}^2 + 118.55\text{m}^2 = 392.67\text{m}^2$ 19.05m ∕< conflicting with neighbour's roof. 18.52m 613.90m² - 392.67m² = 221.23m² $213.96\text{m}^2 \div 613.90\text{m}^2 = 36.0\%$ Point Average of Points Distance Total Point Average of Points Distance Total Adjacent to existing garage, A-B 19.33 19.28=19.31 x 3.23m= 62.36 R-S 18.50 18.45=18.48 x 7.84m= 154.45 03 OPEN SITE SPACE CALCULATION deadwood, included bark in unions, cavities between primary stem B-C 19.28 19.15=19.22 x 2.40m= 46.12 18.45 18.45=18.45 x 1.54m= 28.41 C-D 19.15 19.15=19.15 x 0.75m= 14.36 T-U 18.45 18.45=18.45 x 2.19m= 40.41 D-E 19.15 19.05=19.10 x 3.63m= 69.33 U-V 18.45 18.45=18.45 x 0.95m= 30.63 Extensive deadwood, dieback, decay footprint, poor health and E-F 19.05 19.05=19.05 x 0.96m= 18.29 V-W 18.45 18.60=18.53 x 4.11m= 14.45 derate in pruning wounds, witch's broom. structure. W-X 18.60 18.70=18.70 x 8.64m= 149.73 F-G 19.05 18.60=18.83 x 11.50m= 216.49 Slight lean northwest. West CRZ building footprint, walkway, used as parking stall historically. TBD G-H 18.60 18.60=18.60 x 1.22m= 22.69 X-Y 18.70 18.80=18.75 x 1.30m= 64.53 H-I 18.60 18.55=18.58 x 4.29m= 79.69 Y-Z 18.80 18.70=18.85 x 1.67m= 150.32 I-J 18.55 18.52=18.54 x 1.21m= 22.43 Z-ZA 18.70 18.80=18.92 x 2.68m= 25.50 May be impacted by proposed J-K 18.52 18.55=18.54 x 1.34m= 24.84 ZA-ZB 18.80 18.90=18.92 x 2.68m= 31.48 K-L 18.55 18.55=18.55 x 2.34m= 43.41 ZB-ZC 18.90 18.93=18.92 x 2.68m= 54.66 L-M 18.55 18.52=18.54 x 1.34m= 24.84 ZC-ZD18.93 19.23=19.08 x 9.74m= 185.84 May be impacted by proposed M-N 18.52 18.52=18.52 x 4.51m= 83.53 ZD-ZE 19.23 19.23=19.23 x 0.72m= 13.85 N-O 18.52 18.52=18.52 x 0.89m= 16.48 ZE-ZF 19.23 19.38=19.31 x 2.40m= 46.33 O-P 18.52 18.55=18.54 x 1.66m= 30.77 ZF-ZG 19.38 19.32=19.35 x 3.17m= 61.34 P-Q 18.55 18.50=18.53 x 2.19m= 40.57 ZG-ZH19.32 19.44=19.38 x 1.43m= 27.71 Q-R 18.50 18.50=18.50 x 1.54m= 28.49 ZH-ZI 19.44 19.44=19.44 x 1.98m= 38.49 May be impacted by proposed ZI-A 19.44 19.33=19.39 x 1.43m= 27.91 building footprint. **Existing Building** Terrace Proposed 105.79 1988.12 Building and Steps and steps Hydro clearance pruning, deflected Within footprint of proposed AVG GR 1988 ÷ 105.79 = **18.80m** 138.50 m² 37.08 m^2 and steps **Basement Calculation** 118.5 m² Main Floor Elevation (per survey) = 20.79m Cluster of plum suckers appears to Conflict with proposed boulevard Floor Depth = 0.27mBasement Ceiling = 20.52m Prepared by: Avg grade = 18.80m Talbot Mackenzie and Associates Average grade to finished ceiling = 1.72m Box 48153 RPO Uptown 1.73m > 1.2m Not a basement Victoria, BC V8Z 7H6 $138.50\text{m}^2 + 37.08\text{m}^2 + 118.50\text{m}^2 = 294.08\text{m}^2$ Ph: (250) 479-8733 ~ Fax: (250) 479-7050 314.22m² ÷ 613.9m²=**47.9%** Email: tmtreehelp@gmail.com

(04) SITE COVERAGE CALCULATION

(02) AVERAGE GRADE CALCULATION

Reissued for Re-Zoning and Parking Variance
Not for Construction

PROJECT INFORM	.,, .,, .,, .,, .,, .,, .,, .,, .,, .,,		
Zone	Existing R-2	Proposed Site Specific	Comparison RTM Traditional Residential
Use	Single Family Two Family Public Building Home Occupation Accessory Building	Multiple Dwelling As permitted in R-2	Multifamily Multiple Dwelling Single Family Two Family Attached Dwelling
Max Storeys	1 1/2 w/ basement 2 w/o basement 1 1/2 Existing bldg.	3	3
Building Height	7.6m MAX	8.9m	10.5m
Roof Deck	No	No	No
Site Area	613.9m² 555m² min.	613.9m ²	
Lot Width Lot Depth	15.22m 40.34m	15.22m 40.34m	
Site Coverage	40% max	47.9%	50%
Open Site Space	30% min	(see 4-A100) 30.0%min	30%
open site space	00/0111111	36.0% proposed (see 3-A100)	3070
Total Floor Area	238.82m ² 0.5 : 1 max	473.83m² 0.77 : 1	1.0 : 1
Floor Space Ratio	0.39 : 1 current	0.77 : 1	1.0 : 1
Existing Principal Bldg	000.00 2	200.00.3	
Total Area	238.82m ²	238.92m ²	
Upper Floor	55.97m ²	55.97m ²	
Ground Floor	94.00m ²	94.00m ²	
. –	00.05	00.05	
Lower Floor (Not considered a baser	88.85m² ment per bylaw. See calcul	88.85m² ations 2-A100)	
(Not considered a baser			
(Not considered a base) <u>Proposed Bldg</u>	ment per bylaw. See calcul	ations 2-A100)	
(Not considered a baser <u>Proposed Bldg</u> Total Area	ment per bylaw. See calcul N/A	ations 2-A100) 234.92m²	
(Not considered a baser Proposed Bldg Total Area Third Floor	ment per bylaw. See calcul N/A N/A	ations 2-A100) 234.92m ² 84.84m ²	
(Not considered a baser Proposed Bldg Total Area Third Floor Second Floor	ment per bylaw. See calcul N/A N/A N/A	ations 2-A100) 234.92m² 84.84m² 86.07m²	
(Not considered a baser Proposed Bldg Total Area Third Floor Second Floor Ground Floor	ment per bylaw. See calcul N/A N/A N/A	ations 2-A100) 234.92m² 84.84m² 86.07m²	
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(Not considered a baser Proposed Bldg Total Area Third Floor Second Floor Ground Floor Setbacks Front Yard Setback Porch and stairs	N/A N/A N/A N/A N/A N/A 7.5m or Avg of buildings abutting lot 3.5m projection 0.6 projection 1.52m	ations 2-A100) 234.92m² 84.84m² 86.07m² 64.01m² 7.5m or Avg of buildings abutting lot 3.5m projection	
Proposed Bldg Total Area Third Floor Second Floor Ground Floor Setbacks Front Yard Setback Porch and stairs Bay Window	N/A N/A N/A N/A N/A 7.5m or Avg of buildings abutting lot 3.5m projection 0.6 projection	ations 2-A100) 234.92m² 84.84m² 86.07m² 64.01m² 7.5m or Avg of buildings abutting lot 3.5m projection 0.6 projection	
Proposed Bldg Total Area Third Floor Second Floor Ground Floor Setbacks Front Yard Setback Porch and stairs Bay Window Side Yard Setback	N/A N/A N/A N/A N/A 7.5m or Avg of buildings abutting lot 3.5m projection 0.6 projection 1.52m (10%of lot width)	ations 2-A100) 234.92m² 84.84m² 86.07m² 64.01m² 7.5m or Avg of buildings abutting lot 3.5m projection 0.6 projection See dimensions	
Proposed Bldg Total Area Third Floor Second Floor Ground Floor Setbacks Front Yard Setback Porch and stairs Bay Window Side Yard Setback Side Yard Setback	N/A N/A N/A N/A N/A 7.5m or Avg of buildings abutting lot 3.5m projection 0.6 projection 1.52m (10%of lot width) 3.0m	ations 2-A100) 234.92m² 84.84m² 86.07m² 64.01m² 7.5m or Avg of buildings abutting lot 3.5m projection 0.6 projection See dimensions See dimensions	
Proposed Bldg Total Area Third Floor Second Floor Ground Floor Setbacks Front Yard Setback Porch and stairs Bay Window Side Yard Setback Side Yard Setback Combined Side Yard	N/A N/A N/A N/A N/A N/A 7.5m or Avg of buildings abutting lot 3.5m projection 0.6 projection 1.52m (10%of lot width) 3.0m 4.52m 14.12m	ations 2-A100) 234.92m² 84.84m² 86.07m² 64.01m² 7.5m or Avg of buildings abutting lot 3.5m projection 0.6 projection See dimensions See dimensions	
Proposed Bldg Total Area Third Floor Second Floor Ground Floor Setbacks Front Yard Setback Porch and stairs Bay Window Side Yard Setback Side Yard Setback Combined Side Yard Rear Yard Setback	N/A N/A N/A N/A N/A N/A 7.5m or Avg of buildings abutting lot 3.5m projection 0.6 projection 1.52m (10%of lot width) 3.0m 4.52m 14.12m (35%of lot depth)	ations 2-A100) 234.92m² 84.84m² 86.07m² 64.01m² 7.5m or Avg of buildings abutting lot 3.5m projection 0.6 projection See dimensions See dimensions See dimensions See dimensions See dimensions	
Proposed Bldg Total Area Third Floor Second Floor Ground Floor Setbacks Front Yard Setback Porch and stairs Bay Window Side Yard Setback Side Yard Setback Combined Side Yard Rear Yard Setback Eave Accessory Building	N/A N/A N/A N/A N/A N/A 7.5m or Avg of buildings abutting lot 3.5m projection 0.6 projection 1.52m (10%of lot width) 3.0m 4.52m 14.12m (35%of lot depth) 0.75m Projection 37m² max Existing garage 42m² (27m² excluded for	234.92m² 84.84m² 86.07m² 64.01m² 7.5m or Avg of buildings abutting lot 3.5m projection 0.6 projection See dimensions See dimensions See dimensions See dimensions As permitted in R-2 Existing accessory garages	
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GENERAL NOTES

1. All work shall meet BC building code 2018 and all applicable bylaws and regulations of the City of Victoria and Province of British Columbia.

2. The drawings provided are diagrammatic in nature. The contractor shall perform site measurements and report any discrepancies or omissions with site conditions to the designer and owner prior to undertaking any work.

3. Clean-up on a daily basis and at completion of the project to remove all remaining debris and construction materials and clean all exposed surfaces.

4. All waste material shall be disposed of according to all applicable municipal and provincial

regulations.

5. All dimensions are measured in meters unless otherwise noted.

6. All dimensions are measured to face of framing or concrete unless noted otherwise. Do not scale from drawings.

7. All finishes, fitments, and appliances to be installed according to manufacturer

recommendations/ warranty standards.

8. All stair, handrail, geometry, and guard geometry to BCBC 9.8. $\,$

9. Topographical lines are in .25m increments and are extrapolated from survey grades. Discrepancies with drawn topography and actual site features to be brought to the consultant's attention.

10. Discrepancies with consultant's drawings and engineer's drawings to be brought to the

attention of consultant, owner, and engineer. Changes to be approved by all parties.

11. Project to comply with step 3 of the BC energy step code for part 9 buildings.

12. Refer to Tree Preservation Plan dated April 30 2021

13. EV charging stations to be installed as per the COV "Electric Vehicle Charging Infrastructure Technical Bulletin" (2020)

14. Proposed driveway access to conform to COV Highway Access Bylaw (2015)

Proposed driveway access to conform to COV Highway Access Bylaw (2)

15. Mechanical and ventilation system to use Heat Pump and HRV

Lot 7, Section 3, Victoria District, Plan 1036, PID 008-080-445

Civic Address
1132 Empress Avenue Victoria BC

Legal description

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project name

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Pre Application

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1132 Empress Avenue
sheet title
Site Plan

Project Information

project no. 1906 date 24.09.26

revison no. sheet no. **A100**



Centre Line of Bay Street

25m Future right of way



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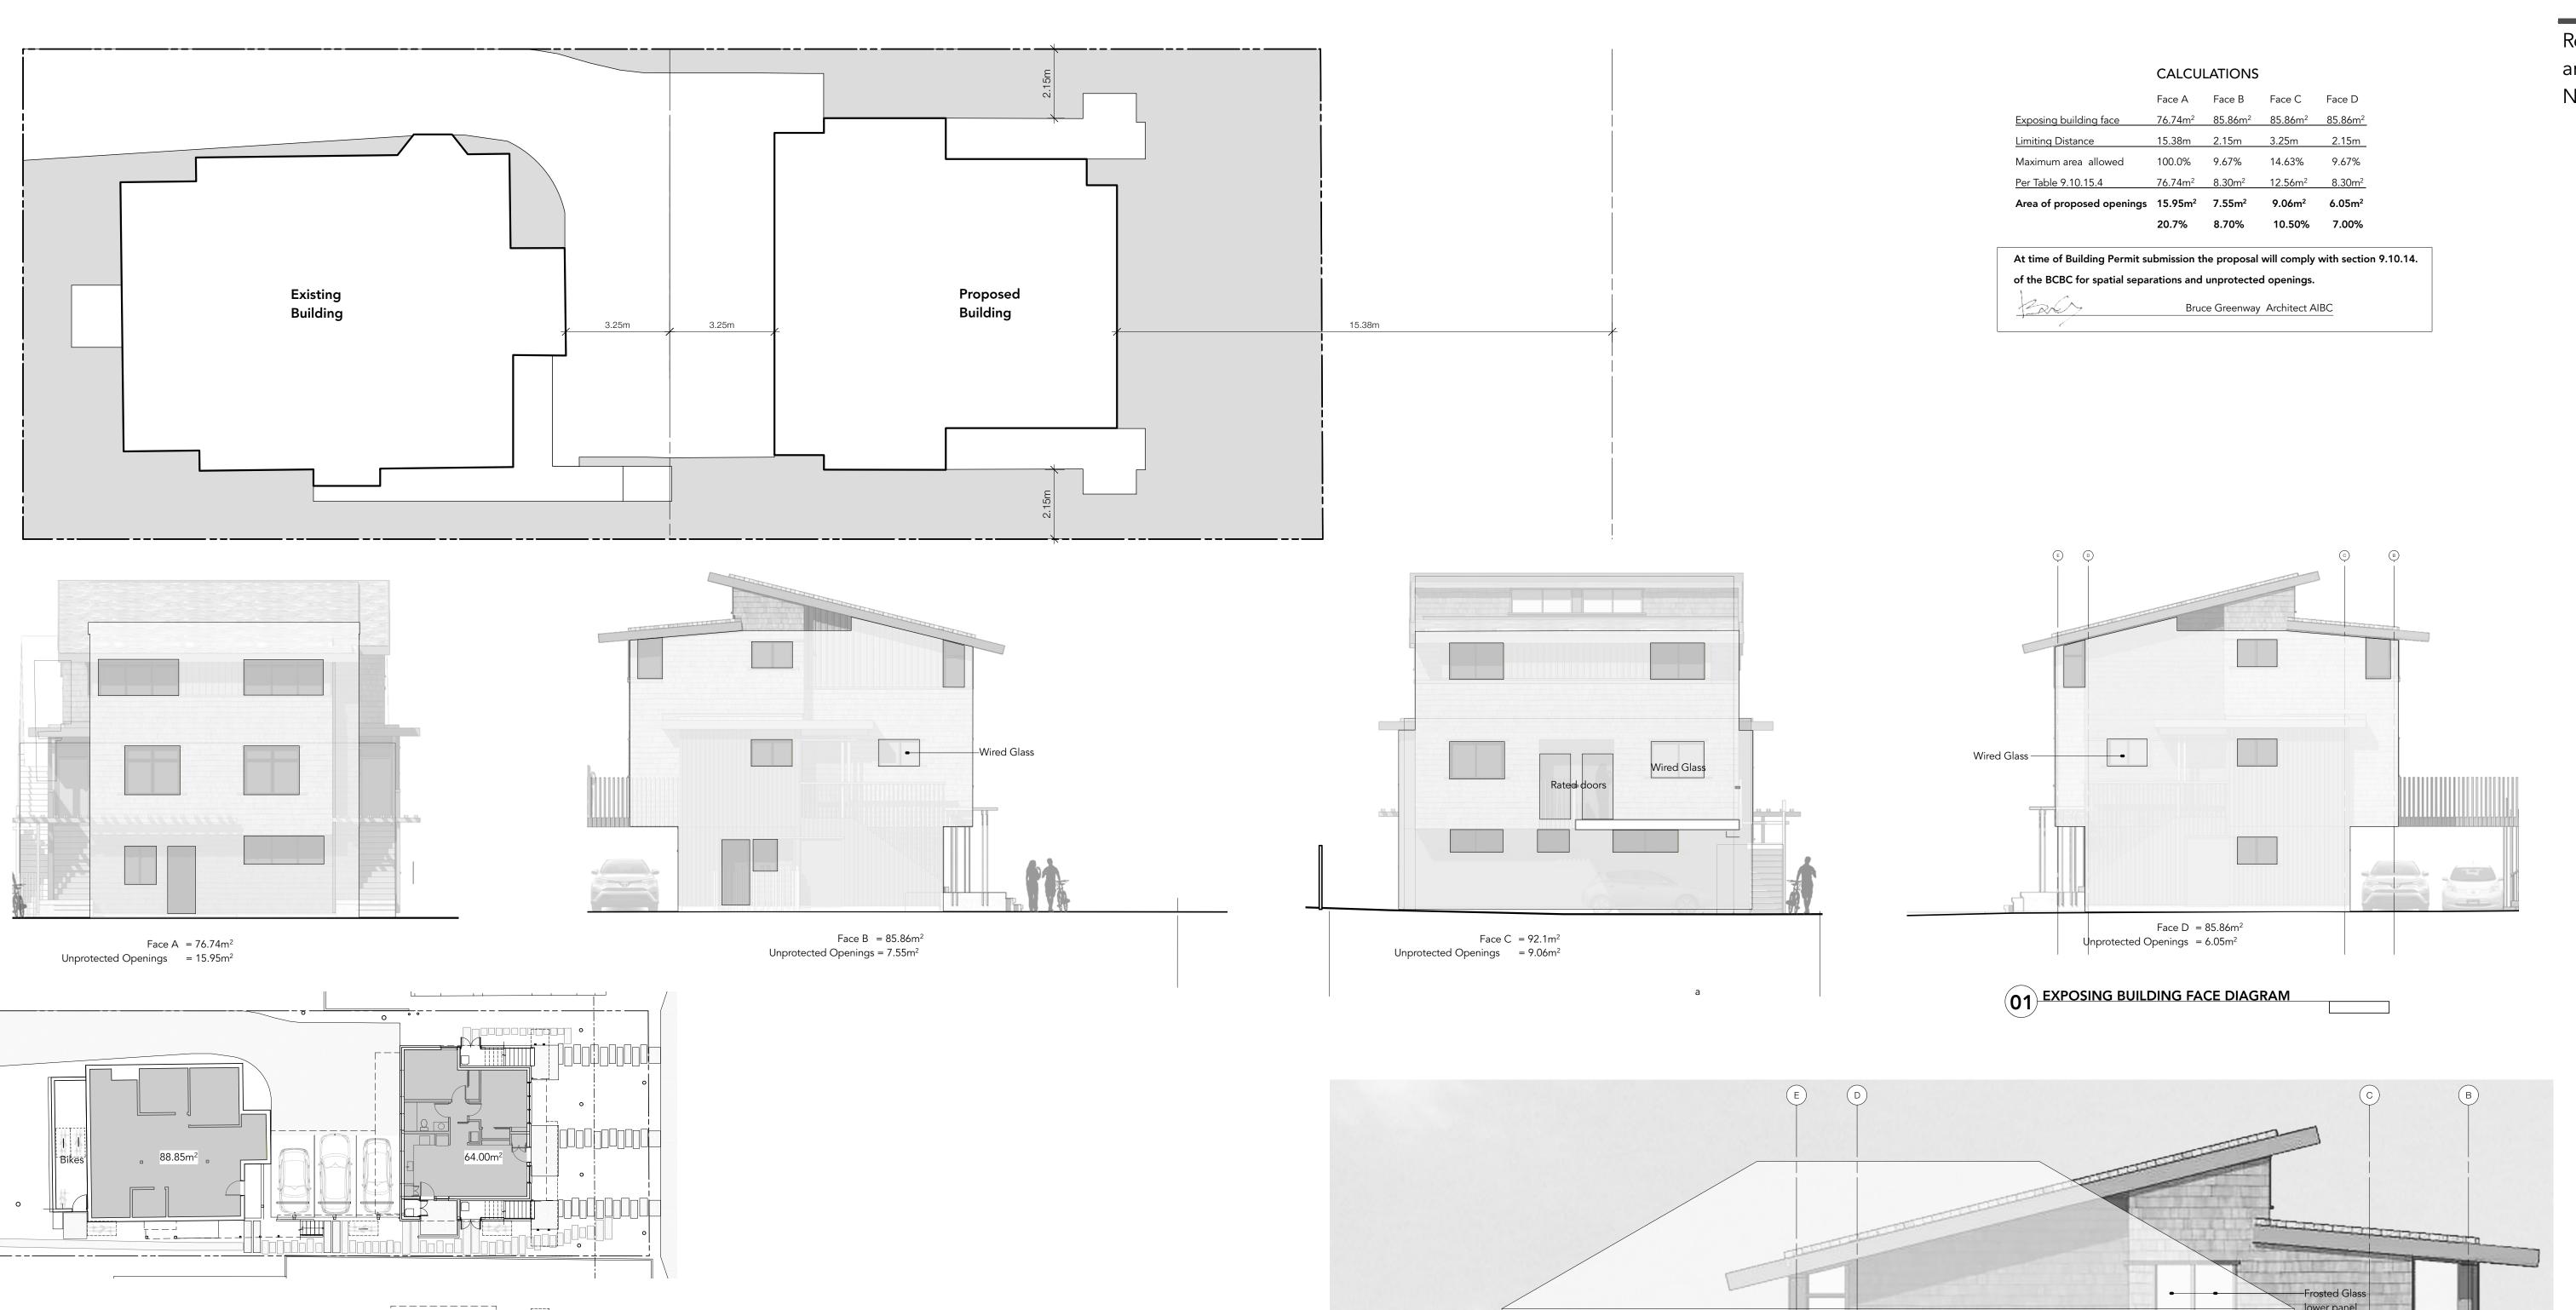
Streetscape

Streetscape

project no. 1906 date

Scale 1:200

24.09.26



94.00m²

Proposed 64.00m²

86.07m²

84.84m²

234.91m²

474.76m²

1:200

Ground Floor 88.85m²
Second Floor 94.03m²
Third Floor 56.97m²

03 Area Calculation

239.85m²

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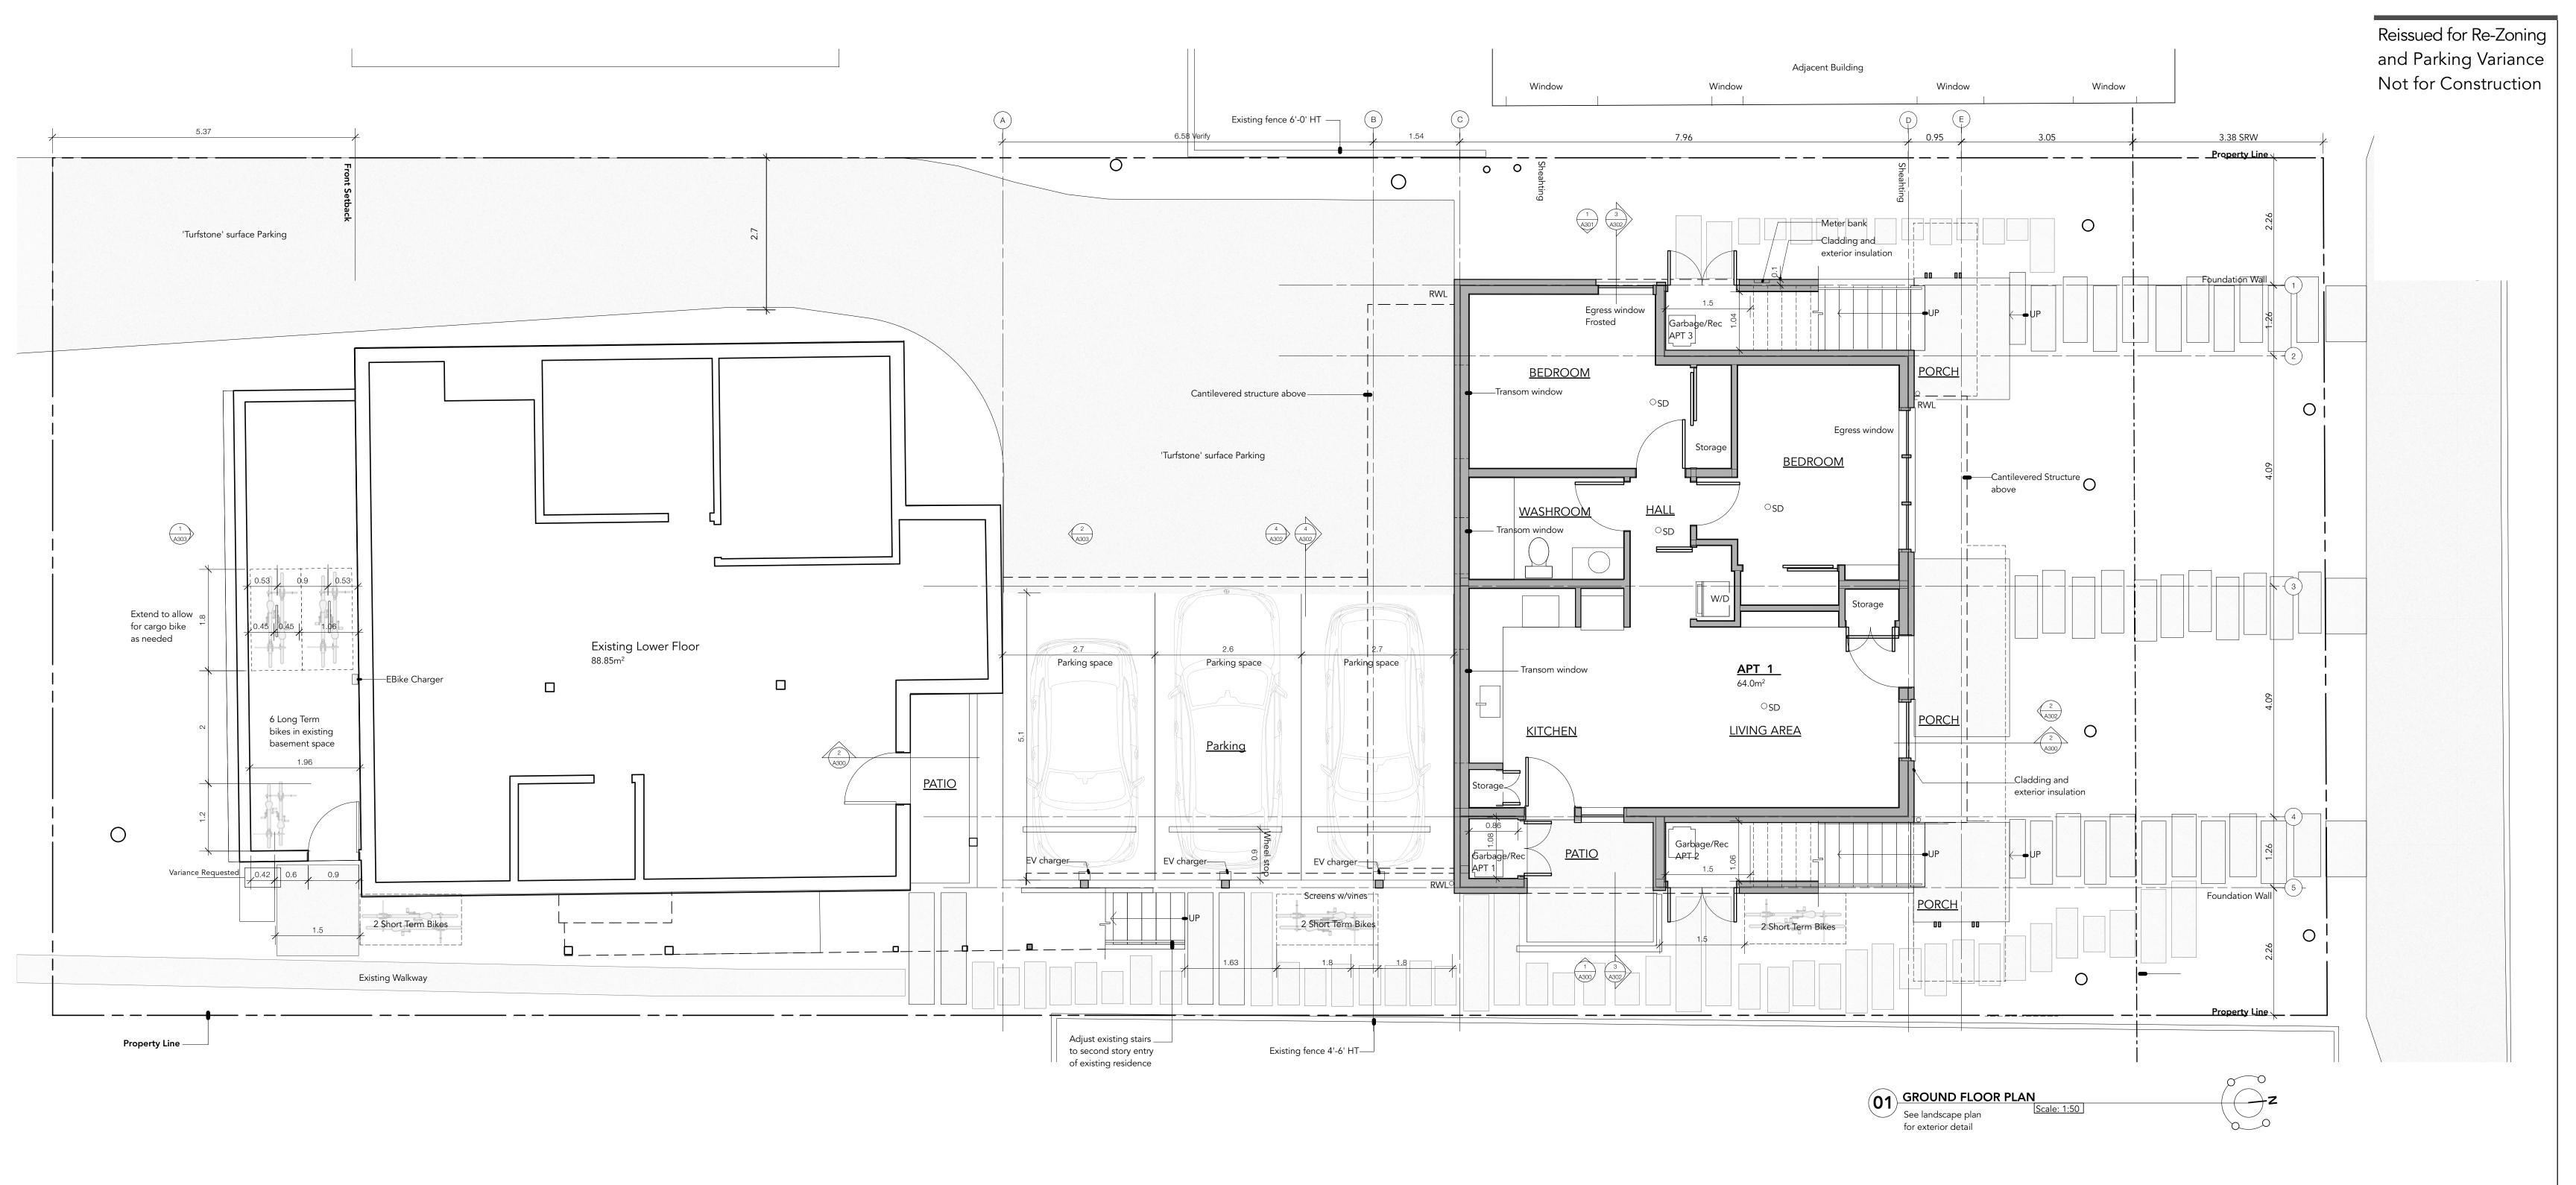
Window Alignment

Project Information

project no. 1906 date 24.09.26

A102

02 Window Alignment With Adjacent Building



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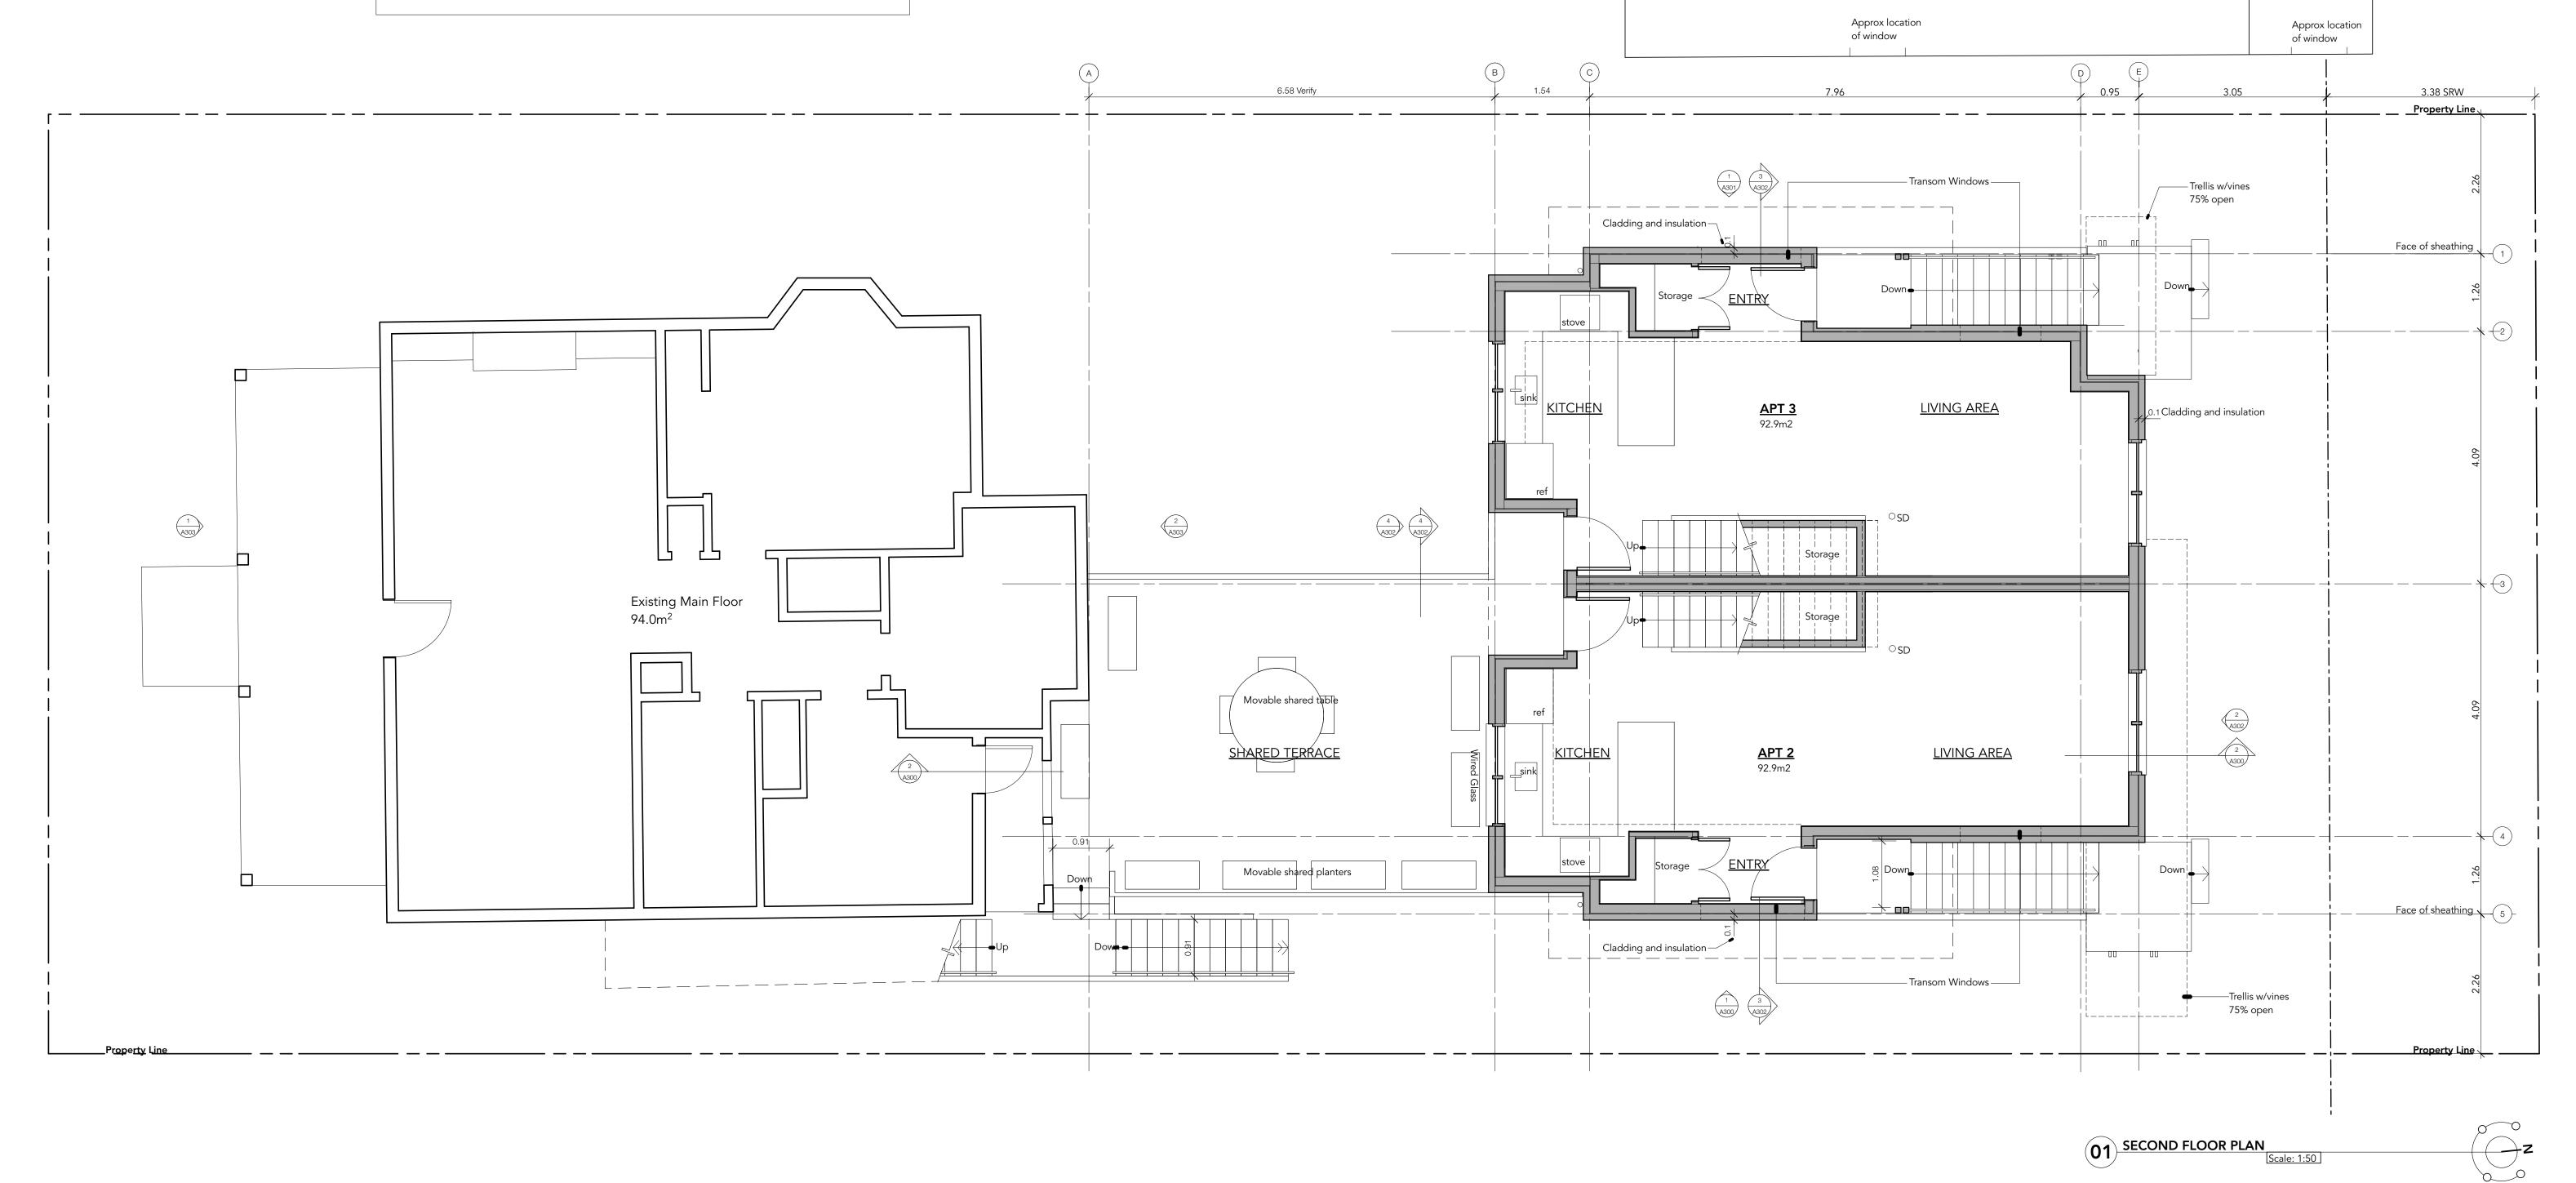
project name
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sheet title

Ground Floor Plan

project no. 1906 date 24.09.26 revison no. sheet no.

sheet no.



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project name

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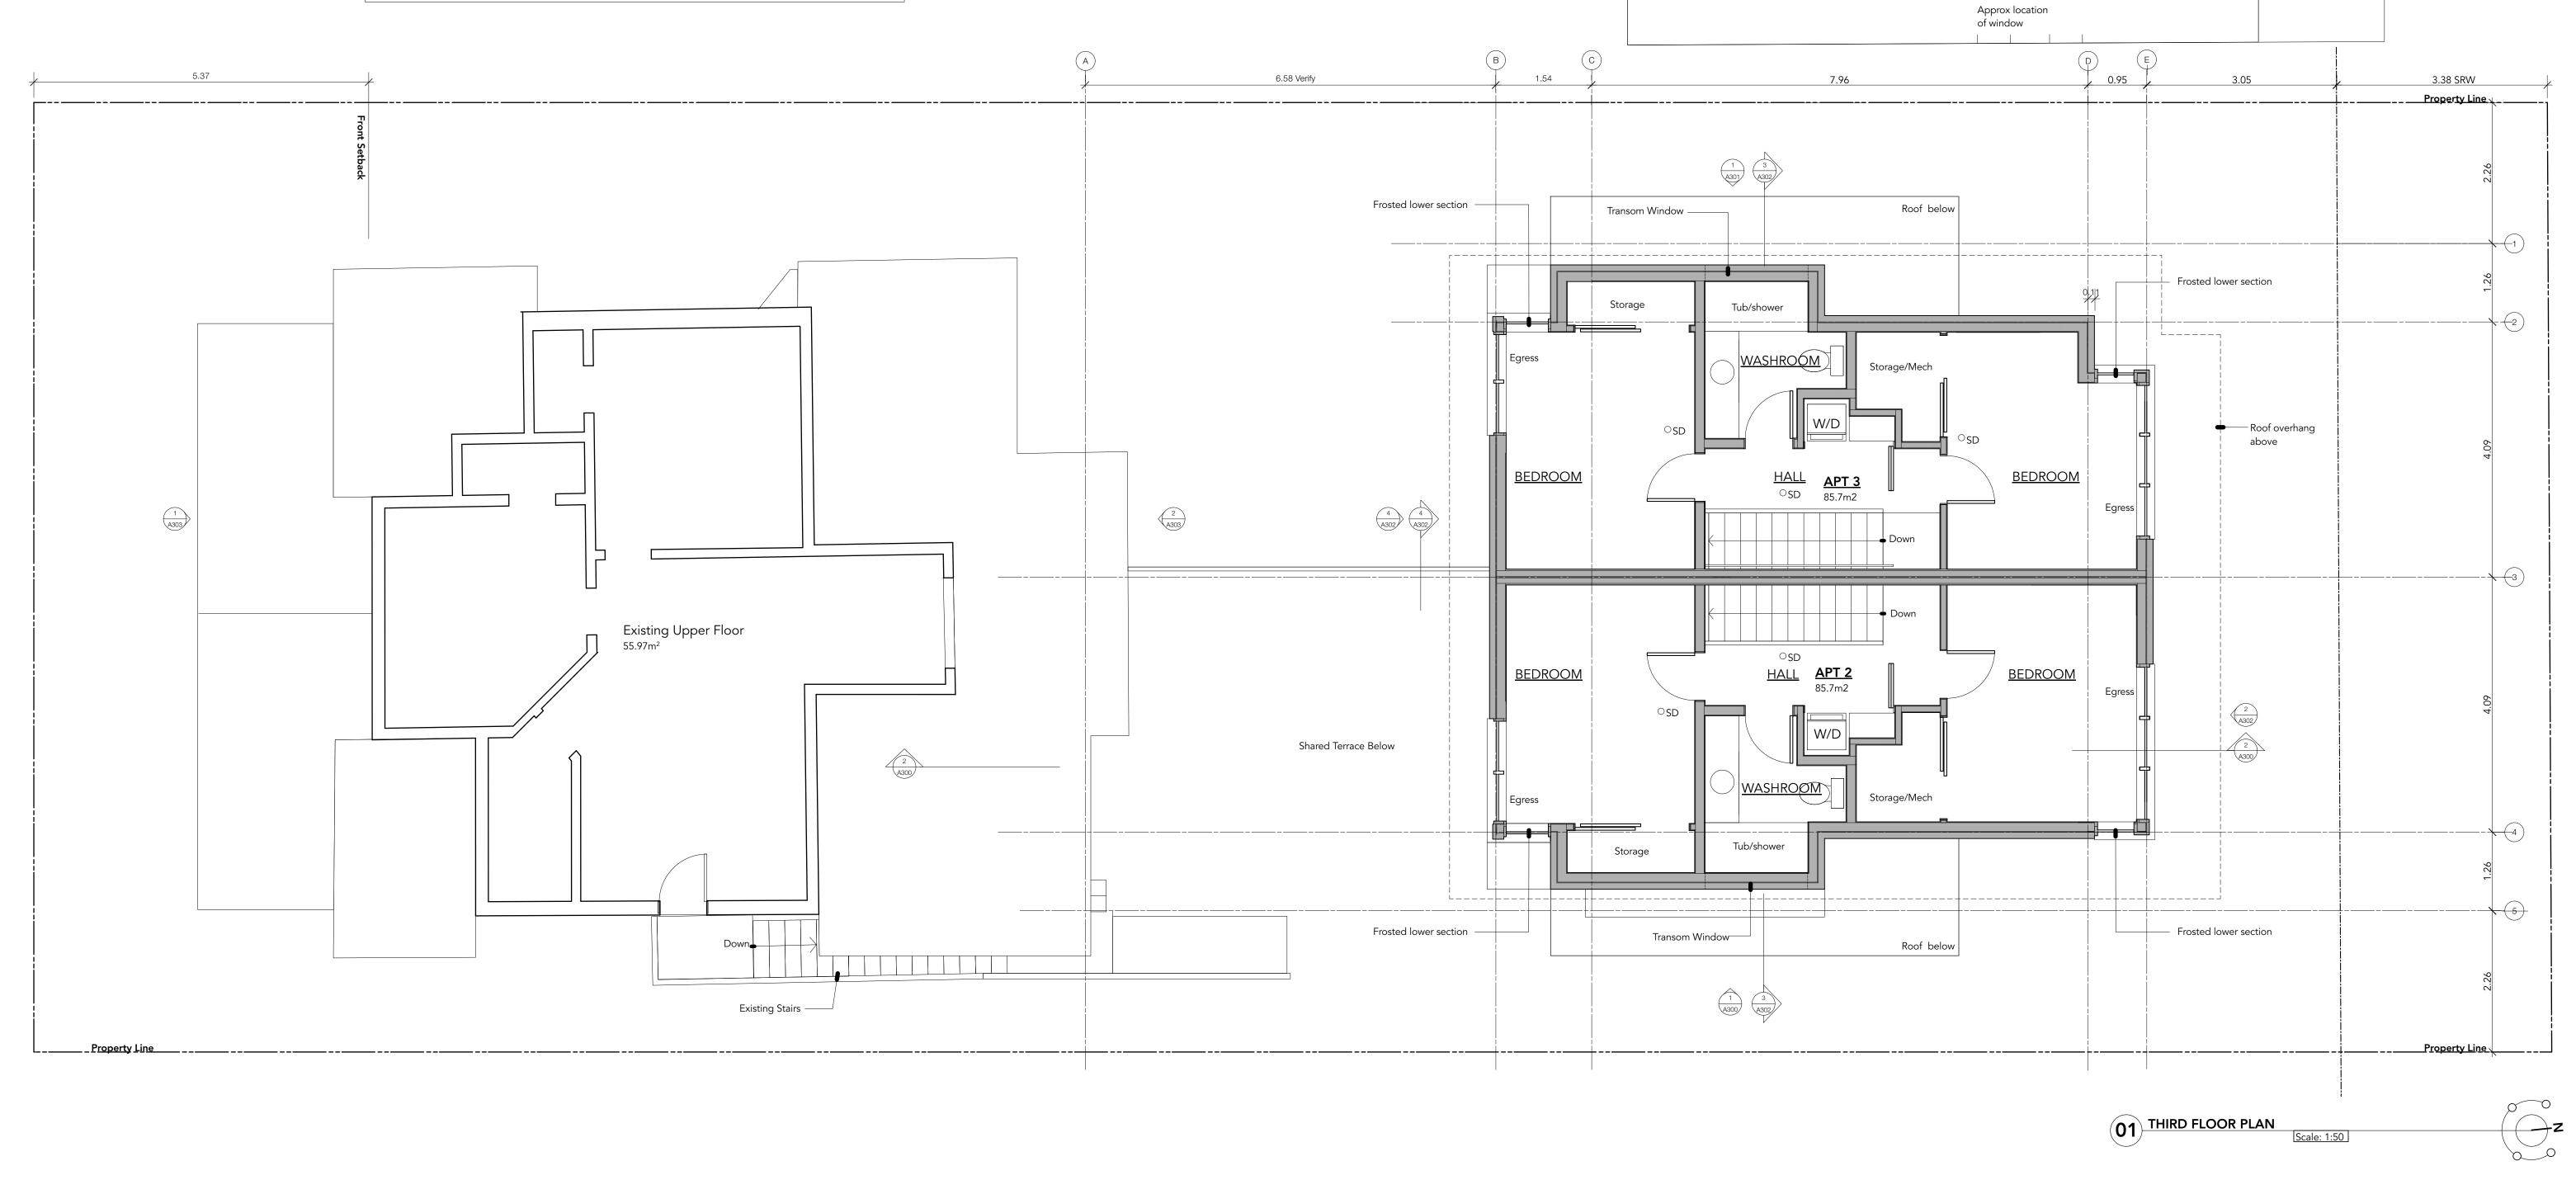
revison no.


Second Floor Plan

project no. 1906 date 24.09.26

sheet no.
A202

Reissued for Re-Zoning and Parking Variance Not for Construction



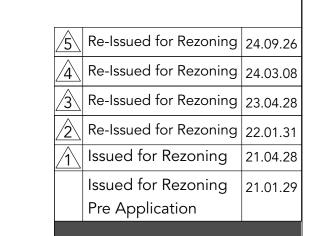



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project name
1132 Empress Avenue

sheet title


Third Floor Plan

project no. 1906 date 24.09.26

revison no. sheet no.





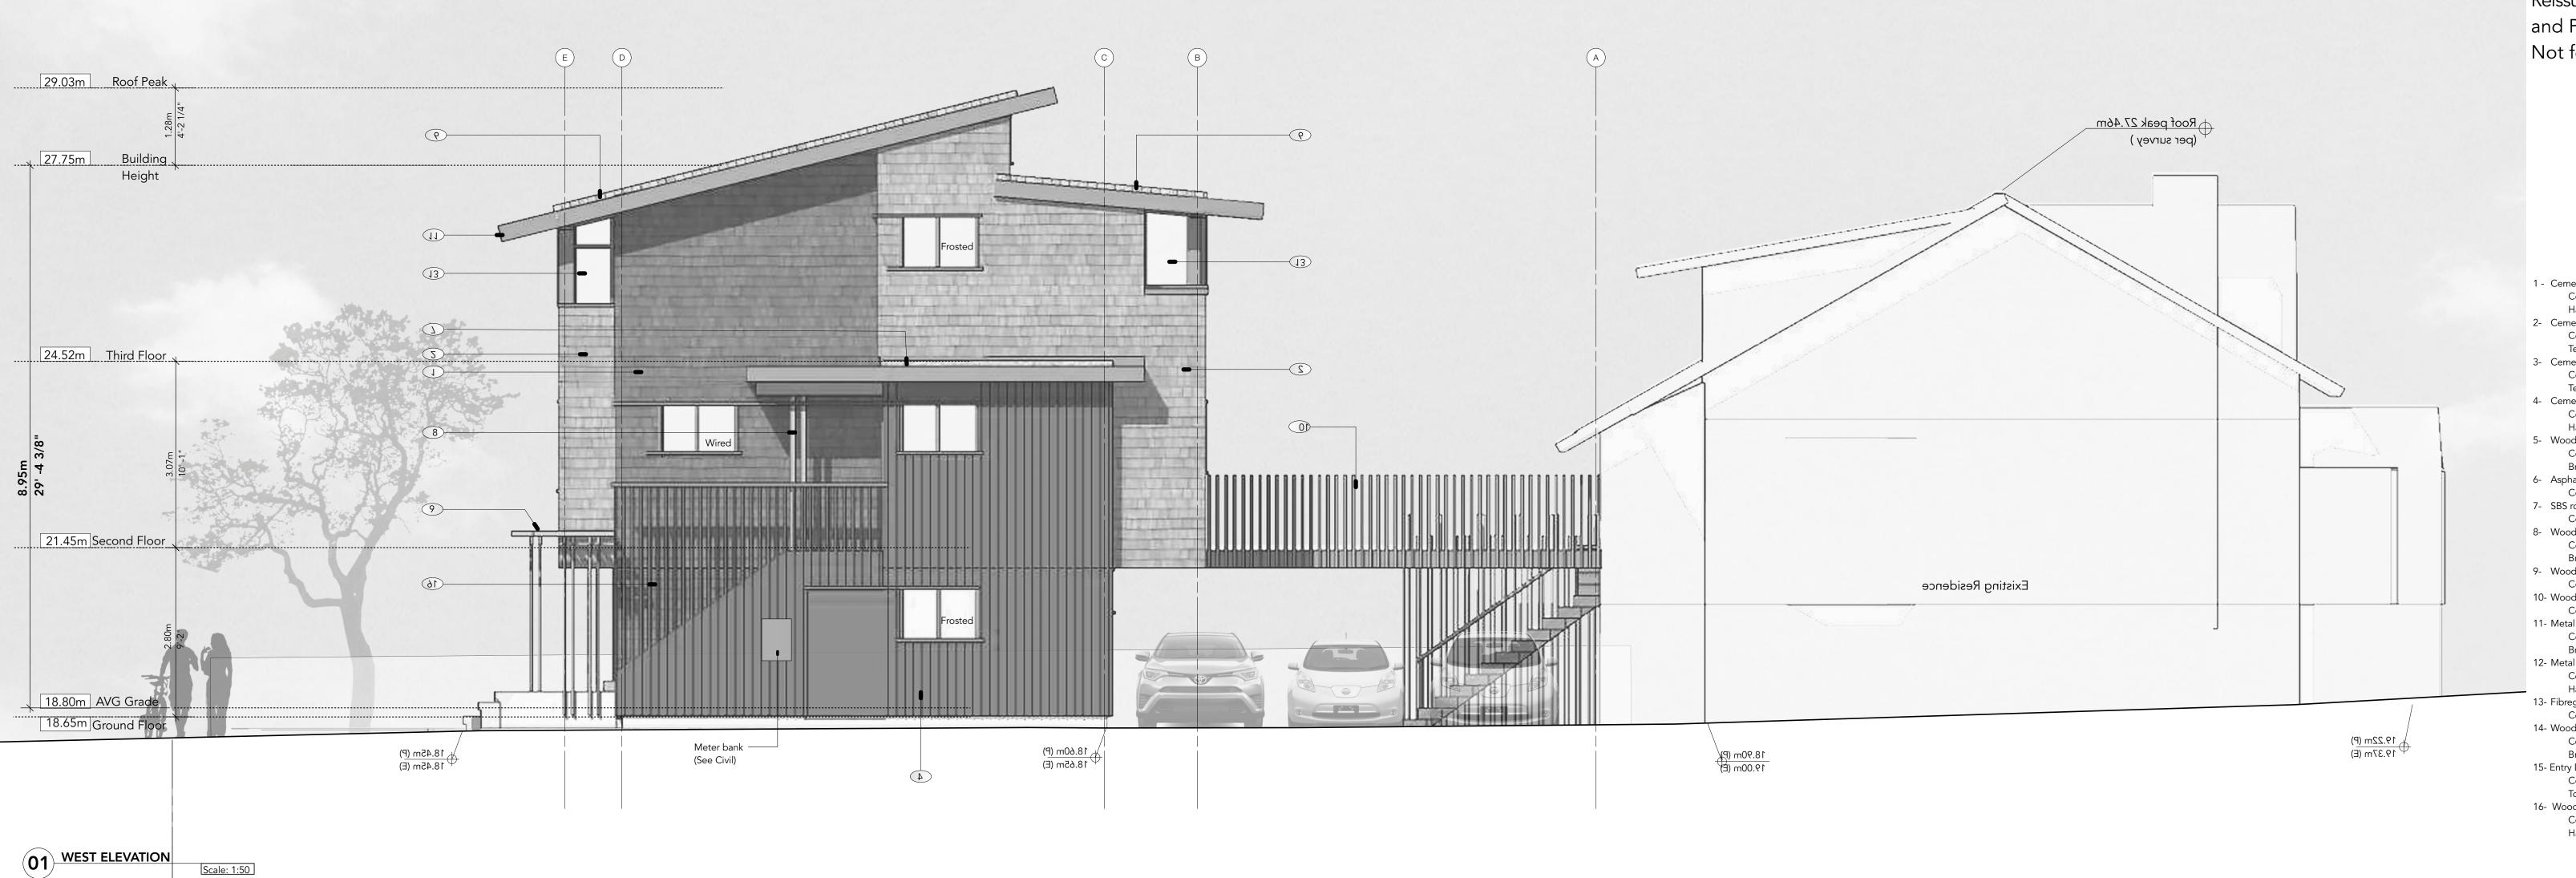

Reissued for Re-Zoning and Parking Variance Not for Construction

- 1 Cement board shingles Colour- Similar to Benjamin Moore 2- Cement board shingles
 Colour- Similar to Benjamin Moore
- Colour- Sim...
 Texas Sage

 3- Cement board and batten
 Colour- Similar to Benjamin Moore
 Toxas Sage
 'and batten
- Colour- Similar to Benjamin Moore Hale Navy
- 5- Wood Railing Colour- Similar to Benjamin Moore Brownstone
- 6- Asphault shingles Colour- Warm Grey 7- SBS roofing
- Colour to match shingles 8- Wood beams and column
- Colour- Similar to Benjamin Moore Brownstone
- 9- Wood trellis structure Colour- Pre weathered treatment 10- Wood guard/Screen
- Colour- Pre weathered treatment 11- Metal flashing Colour- Similar to Benjamin Moore
- Brownstone 12- Metal rain water leader Colour- Similar to Benjamin Moore
- Hale Navy 13- Fibreglass window Colour dark bronze
- 14- Wood trim
- Colour- Similar to Benjamin Moore Brownstone
- 15- Entry Doors Colour- Similar to Benjamin Moore
- Townsend Harbour 16- Wood Guard/Screen
- Colour- Similar to Benjamin Moore Hale Navy

Re-Issued for Rezoning 24.09.26

Re-Issued for Rezoning 24.03.08 $|\hat{3}|$ Re-Issued for Rezoning 23.04.28

 $|\hat{2}|$ Re-Issued for Rezoning 22.01.31

Issued for Rezoning 21.04.28

Issued for Rezoning 21.01.29 Pre Application

Greenway Studio Architecture ULC

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project name

1132 Empress Avenue

sheet title Elevations

Driveway Profile project no. 1906 date 24.09.26

revison no.

A301





Reissued for Re-Zoning and Parking Variance Not for Construction

- Cement board shingles Colour- Similar to Benjamin Moore Hale Navy
- 2- Cement board shingles Colour- Similar to Benjamin Moore Texas Sage
- 3- Cement board and batten
 Colour- Similar to Benjamin Moore
 Texas Sage

 4- Cement board and batten
- Colour- Similar to Benjamin Moore Hale Navy 5- Wood Railing
- Colour- Similar to Benjamin Moore
 Brownstone
 6- Asphault shingles
- Colour- Warm Grey
 7- SBS roofing
 Colour to match shingles
- 8- Wood beams and column
 Colour- Similar to Benjamin Moore
 Brownstone
- 9- Wood trellis structure
 Colour- Pre weathered treatment
 10- Wood guard/Screen
- Colour- Pre weathered treatment
 11- Metal flashing
 Colour- Similar to Benjamin Moore
- Brownstone
 12- Metal rain water leader
 Colour- Similar to Benjamin Moore
- Hale Navy

 13- Fibreglass window
- Colour dark bronze 14- Wood trim Colour- Similar to Benjamin Moore
- Brownstone 15- Entry Doors Colour- Similar to Benjamin Moore
- Townsend Harbour

 16- Wood Guard/Screen
 - Colour- Similar to Benjamin Moore Hale Navy



01 SOUTH ELEVATION PHOTO - EXISTING None





Existing House oroject no. 1906 date 24.09.26








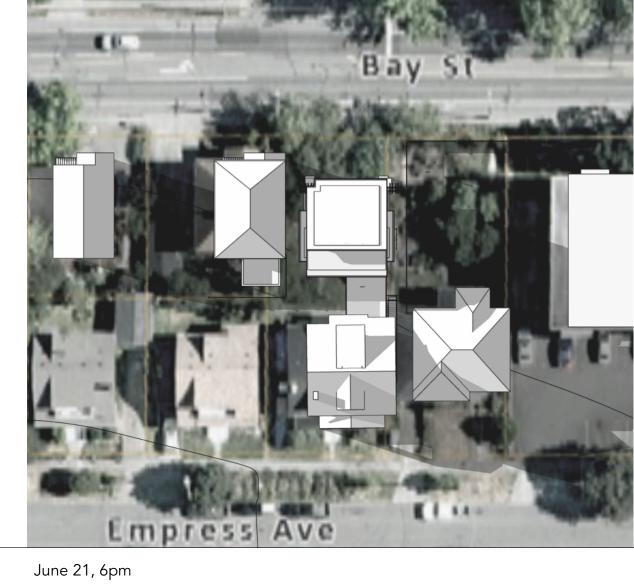

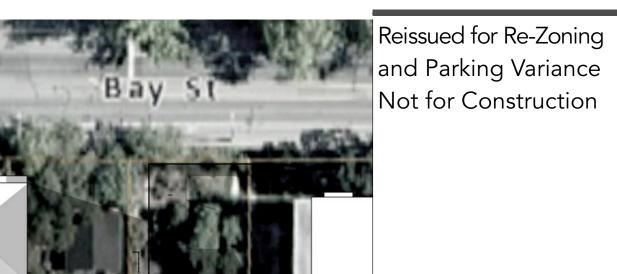


June 21, 6pm Existing Conditions (approx)

ress Ave

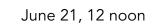



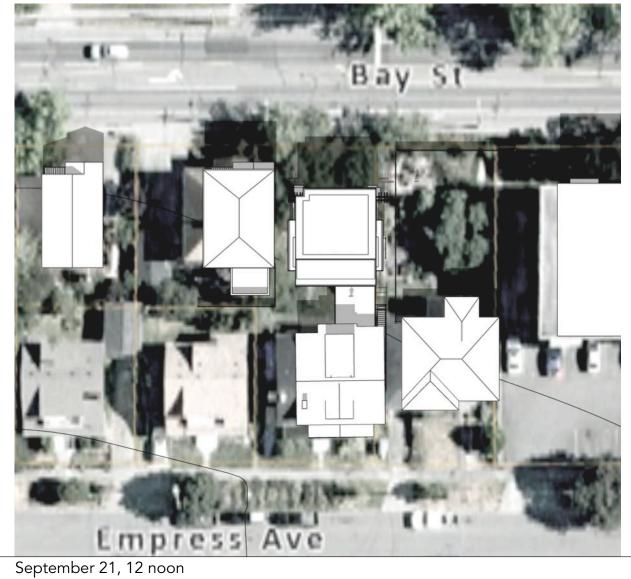



Empress Ave

December 21, 9am



December 21, 12 noon



December 21, 3pm

01 SUN STUDY

Re-Issued for Rezoning 24.09.26 |A| Re-Issued for Rezoning 24.03.08 $|\hat{\mathbf{x}}|$ Re-Issued for Rezoning $|\mathbf{z}_{3.04.28}|$ Re-Issued for Rezoning 22.01.31

/ Issued for Rezoning 21.04.28 Issued for Rezoning 21.01.29

Pre Application

Greenway Studio Architecture ULC

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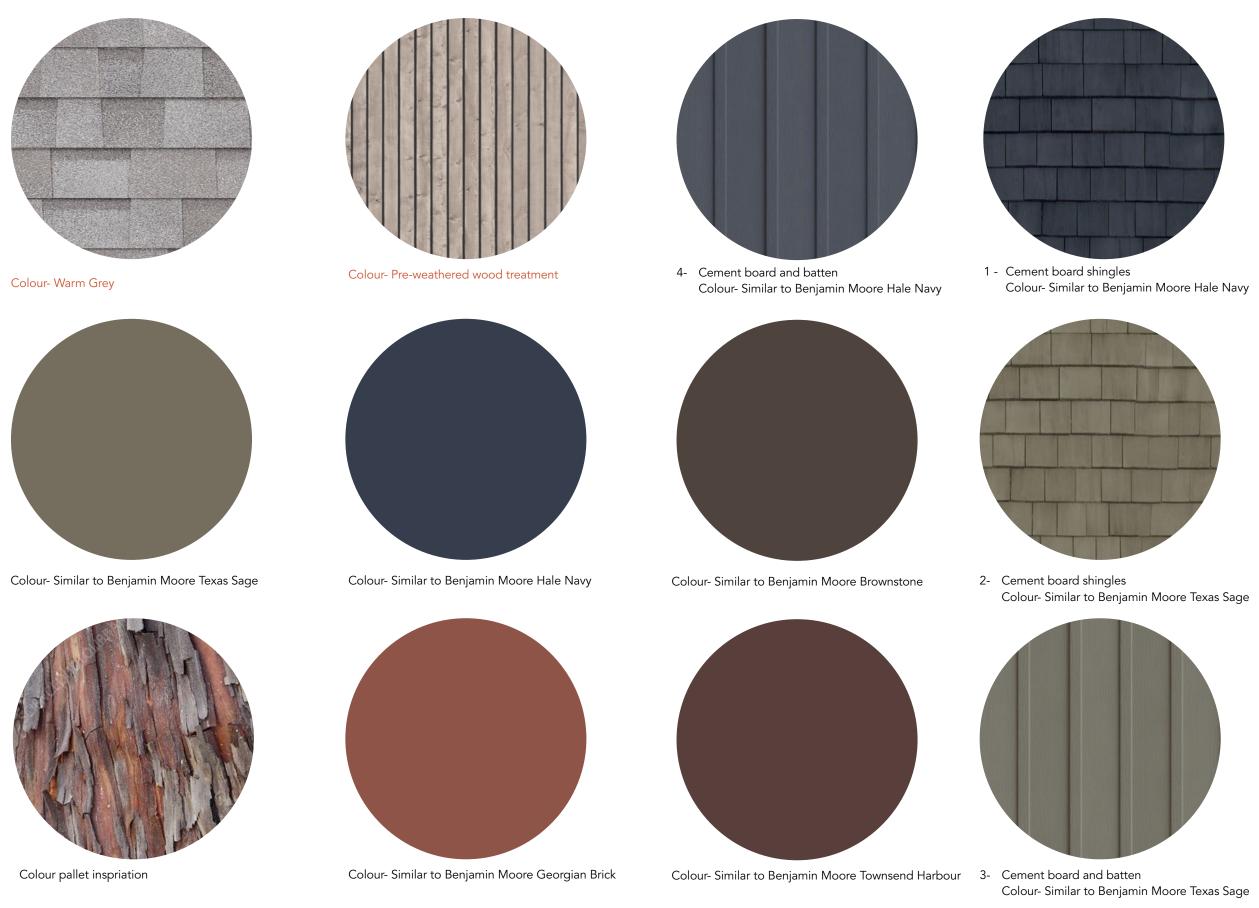
project name 1132 Empress Avenue

sheet title

Sun Study project no. 1906 date 24.09.26









01 MATERIALS

Scale: 1:50

 Cement board shingles Colour- Similar to Benjamin Moore Hale Navy 2- Cement board shingles Colour- Similar to Benjamin Moore Texas Sage 3- Cement board and batten Colour- Similar to Benjamin Moore Brownstone 4- Cement board and batten Colour- Similar to Benjamin Moore Hale Navy 5- Wood Railing Colour- Similar to Benjamin Moore Brownstone 6- Asphault shingles Colour- Warm Grey 7- SBS roofing Colour to match shingles 8- Wood beams and column Colour- Similar to Benjamin Moore Brownstone 9- Wood trellis structure Colour- Pre weathered treatment 10- Wood guard/Screen Colour- Pre weathered treatment 11- Metal flashing Colour- Similar to Benjamin Moore Brownstone 12- Metal rain water leader Colour- Similar to Benjamin Moore Hale Navy 13- Fibreglass window Colour dark bronze

14- Wood trim

15- Entry Doors

Brownstone

Colour- Similar to Benjamin Moore
Townsend Harbour

Colour and material samples must be
approved before purchase of materials)9.26

Colour- Similar to Benjamin Moore

Ke-Issued for Rezoning 24.03.08

Re-Issued for Rezoning 23.04.28

Re-Issued for Rezoning 22.01.31

Issued for Rezoning 21.04.28

Issued for Rezoning 21.01.29
Pre Application

Pre Application

Greenway Studio

Architecture ULC

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project name
1132 Empress Avenue

sheet title

Materials and

Colour Palette

project no. 1906 date 24.09.26

revison no.

sheet no.





GENERAL NOTES:

· ALL CONSTRUCTION AND MATERIALS TO BE IN ACCORDANCE WITH MMCD, PLATINUM EDITION, AND THE CITY OF VICTORIA STANDARD SPECIFICATIONS AND DRAWINGS UNLESS OTHERWISE NOTED. . WHEN A CONFLICT BETWEEN THE SPECIFICATIONS ARISES, THE MOST STRINGENT SHALL APPLY. OBTAIN A PERMIT TO CONSTRUCT WORKS ON A MUNICIPAL RIGHT OF WAY FROM THE CITY OF VICTORIA ENGINEERING DEPARTMENT TWO WORKING DAYS PRIOR TO THE START OF ANY CONSTRUCTION

• OBTAIN A DEMO PERMIT PRIOR TO REMOVAL OF ANY NON-CONFORMING STRUCTURES. • CONTACT BC HYDRO, TELUS, SHAW CABLE AND FORTISBC GAS TWO WORKING DAYS PRIOR TO THE • EXPOSE ALL EXISTING SERVICES AT CONNECTION AND CROSSING POINTS TWO WORKING DAYS PRIOR STARTING CONSTRUCTION ON ANY SUCH SERVICES. ENSURE ENGINEER HAS CONFIRMED THE HORIZONTAL AND VERTICAL LOCATION.

• BED ALL PIPE USING CLASS 'B' BEDDING. . WHERE A TRENCH IS UNDER OR WITHIN 1.0m OF THE EDGE OF A ROAD OR DRIVEWAY, USE PIT RUN GRAVEL BACKFILL FROM THE TOP OF THE PIPE BEDDING TO THE TOP OF THE ROAD, PARKING OR DRIVEWAY SUBGRADE • DO NOT START ANY BACKFILL OPERATION UNTIL THE WORKS HAVE BEEN INSPECTED BY THE

ENGINEER. • AFTER CONSTRUCTION, RESTORE WORK AREAS AND ALL EXISTING FEATURES TO THEIR ORIGINAL • MAINTAIN VEHICULAR AND PEDESTRIAN ACCESS ALONG BAY STREET, EMPIRE STREET AND EMPRESS AVENUE DURING CONSTRUCTION. • COMPACT TRENCH BACKFILL, ROAD BASE AND DRIVEWAY BASE TO 95% MODIFIED PROCTOR

· ADJUST ALL PROPOSED AND EXISTING APPURTENANCES TO MEET THE FINAL DESIGN GRADES. • ENSURE THAT ALL SERVICES TO THE EXISTING HOUSE REMAIN USABLE DURING CONSTRUCTION AND ARE CONNECTED TO ALL NEW SERVICES. ENSURE THESE SERVICES ARE INSPECTED BY THE CITY OF VICTORIA WORKS INSPECTOR. • CONSTRUCT SEWER, DRAIN, WATER AND ROADS WITHIN PRIVATE PROPERTY IN ACCORDANCE WITH THE BC PLUMBING CODE AND BC BUILDING CODE. CONSTRUCTION SHALL BE INSPECTED AND APPROVED BY THE CITY OF VICTORIA INSPECTORS.

SEWER AND DRAIN:

• SEWER AND DRAIN SERVICE CONNECTIONS TO BE 1000 PVC DR28 AT A MINIMUM GRADE OF 2.0% COMPLETE WITH INSPECTION CHAMBERS. CATCH BASIN LEADS TO BE 1500 PVC DR28 UNLESS OTHERWISE NOTED. IF COVER IS LESS THAN 750mm, USE DUCTILE IRON PIPE • SEWER AND DRAIN PIPE UP TO AND INCLUDING 150mm DIAMETER TO BE PVC DR28 AND DR35

FOR 200mm DIAMETER AND OVER. PIPE TO BE C.S.A. APPROVED PVC. . • THE CITY OF VICTORIA PUBLIC WORKS SHALL INSTALL THE SEWER CONNECTION TO THE PROPERTY LINE AT 1132-1134 EMPRESS AVENUE AT THE DEVELOPER'S EXPENSE. • THE CITY OF VICTORIA PUBLIC WORKS SHALL REPLACE THE DRAIN SERVICE CONNECTION TO 1500 PVC DR28 ALONG THE EXISTING TRENCH. MATCH EXISTING INVERTS.

• ESTABLISH THE LOW POINT OF THE EXISTING PERIMETER TILE AROUND THE EXISTING HOUSE AND CONNECT TO THE NEW DRAIN CONNECTION. • CONTRACTOR TO DYE TEST THE EXISTING HOUSE TO DETERMINE THE DRAIN OUTLET LOCATION AT THE BOULEVARD • CONNECT ALL ENCOUNTERED DRAINS TO THE PROPOSED SERVICE CONNECTION. CONTRACTOR TO RECORD THE LOCATION, ELEVATION, PIPE MATERIAL AND SIZE FOR THE AS CONSTRUCTED

• VIDEO INSPECT ALL INSTALLED SANITARY SEWER AND STORM DRAIN MAINS ON PUBLIC AND PRIVATE PROPERTY

WATER:

• INSTALL 38mm MUNICIPEX SERVICE CONNECTION COMPLETE WITH DOUBLE STRAP, STAINLESS STEEL SERVICE SADDLES TO THE PROPERTY LINE AT THE DEVELOPER'S EXPENSE. FINAL LOCATION TO BE DETERMINED IN THE FIELD BY THE ENGINEER. . THE CITY OF VICTORIA SHALL INSTALL THE PROVISIONAL WATER SERVICE CONNECTION TO THE

• WATER METER TO BE 25mmø, PROVIDED AND INSTALLED BY THE CITY OF VICTORIA AT THE DEVELOPER'S EXPENSE.

• CONSTRUCT ALL ROADWAYS IN ACCORDANCE WITH THE CITY OF VICTORIA STANDARD SPECIFICATIONS AND AS SHOWN ON THE TYPICAL SECTION AND DETAIL DRAWINGS.

• CONTRACTOR TO ENSURE EXISTING MONUMENTS ARE NOT DISTURBED DURING CONSTRUCTION. ANY MONUMENTS IN DANGER OF DISTURBANCE ARE TO BE REFERENCED BY AND, IF DISTURBED, BE REPLACED BY A B.C.L.S. AT THE CONTRACTOR'S EXPENSE.

OBTAIN A PARKS PERMIT FROM THE CITY OF VICTORIA PARKS DEPARTMENT PRIOR TO THE START • PROTECT ALL TREES EXCEPT THOSE TO BE REMOVED FROM DAMAGE DURING CONSTRUCTION. • HAND DIG WHERE ROOTS OVER 50mm ARE ENCOUNTERED. OBTAIN PERMISSION FROM THE ENGINEER, DEVELOPER AND THE CITY OF VICTORIA PRIOR TO REMOVAL OF ANY TREES ON PRIVATE OR PUBLIC PROPERTY. A COPY OF THE TREE PERMIT SHALL BE PRESENTED TO THE CITY OF VICTORIA WORKS INSPECTOR PRIOR TO THE START OF

• THE PROJECT ARBORIST TO BE RESPONSIBLE FOR SUPERVISING THE INSTALLATION OF BARRIER FENCING AT APPROPRIATE LOCATIONS. THE ARBORIST TO DETERMINE THE SENSITIVE ROOT ZONES AREAS AND BE ONSITE TO SUPERVISE TRENCHING AND ROAD CONSTRUCTION

• THE DEVELOPER SHALL PROCUR AND PLANT THE BOULEVARD TREES. CITY OF VICTORIA PARKS DEPARTMENT SHALL SELECT THE SPECIES AT BUILDING PERMIT STAGE.

HYDRO, TELEPHONE, CABLE, STREET LIGHTING AND GAS:

• CONTACT "B.C. ONE CALL" AT 1-800-474-6886 A MINIMUM OF THREE WORKING DAYS PRIOR TO

• PROPOSED DEVELOPMENT OF 1132-1134 EMPRESS AVENUE TO BE SERVICED OVERHEAD. 3 • BC HYDRO SHALL REPLACE THE EXISTING HYDRO POLE AT THE DEVELOPER'S EXPENSE. REFER TO BC HYDRO'S IFC DRAWING NO. 500-U07-09142 •BC HYDRO, TELUS, SHAW CABLE AND FORTISBC FACILITIES ARE SHOWN SCHEMATICALLY ON THIS DRAWING. REFER TO UTILITY COMPANY DRAWINGS FOR CONSTRUCTION DETAILS.

• CONSTRUCT UNDERGROUND HYDRO, TELEPHONE AND CABLEVISION AS SPECIFIED AND IN


ACCORDANCE WITH BC HYDRO, TELUS AND SHAW CABLE STANDARD SPECIFICATIONS AND •IF GAS IS REQUIRED, THE DEVELOPER IS TO CONTACT FORTISBC AT 1-888-224-2710 A MINIMUM OF 90 DAYS PRIOR TO INSTALL. FORTISBC SHALL INSTALL GAS SERVICE TO THE PROPERTY LINE.


BOULEVARD TREES

PROPOSED STREET TREES MUST COMPLY TO CITY OF VICTORIA SUPPLEMENTARY SPECIFICATIONS FOR STREET TREES AND IRRIGATION SCHEDULE C, BYLAW 12-042, SUBDIVISION BYLAW AND THE CURRENT VERSION OF THE CANADIAN LANDSCAPE STANDARD. PLANTING DETAILS CAN BE FOUND IN SCHEDULE B3-4 OR ON THE APPROVED LANDSCAPE PLAN. THE FOLLOWING TREE INSPECTIONS BY PARKS STAFF ARE REQUIRED BY SCHEDULE C. TO SCHEDULE AN INSPECTION PLEASE CONTACT ROB HUGHES, RHUGHES@VICTORIA.CA AND ALSO COPY TREEPERMITS@VICTORIA.CA 48 HOURS PRIOR TO THE REQUIRED INSPECTION


TREE PLANTING INSPECTIONS

- EXCAVATED TREE PITS, SOIL CELLS, ROOT BARRIERS TREES PRIOR TO PLANTING. (PARKS STAFF CAN INSPECT TREES PRIOR TO SHIPPING AT LOCAL NURSERIES. PHOTOS CAN BE PROVIDED FROM UP-ISLAND AND MAINLAND NURSERIES. TREE MUST MEET THE SPEC UPON DELIVERY.)
- 3. COMPLETED PLANTING TREE PLANTING, GRATE/GUARD, STAKES ETC.

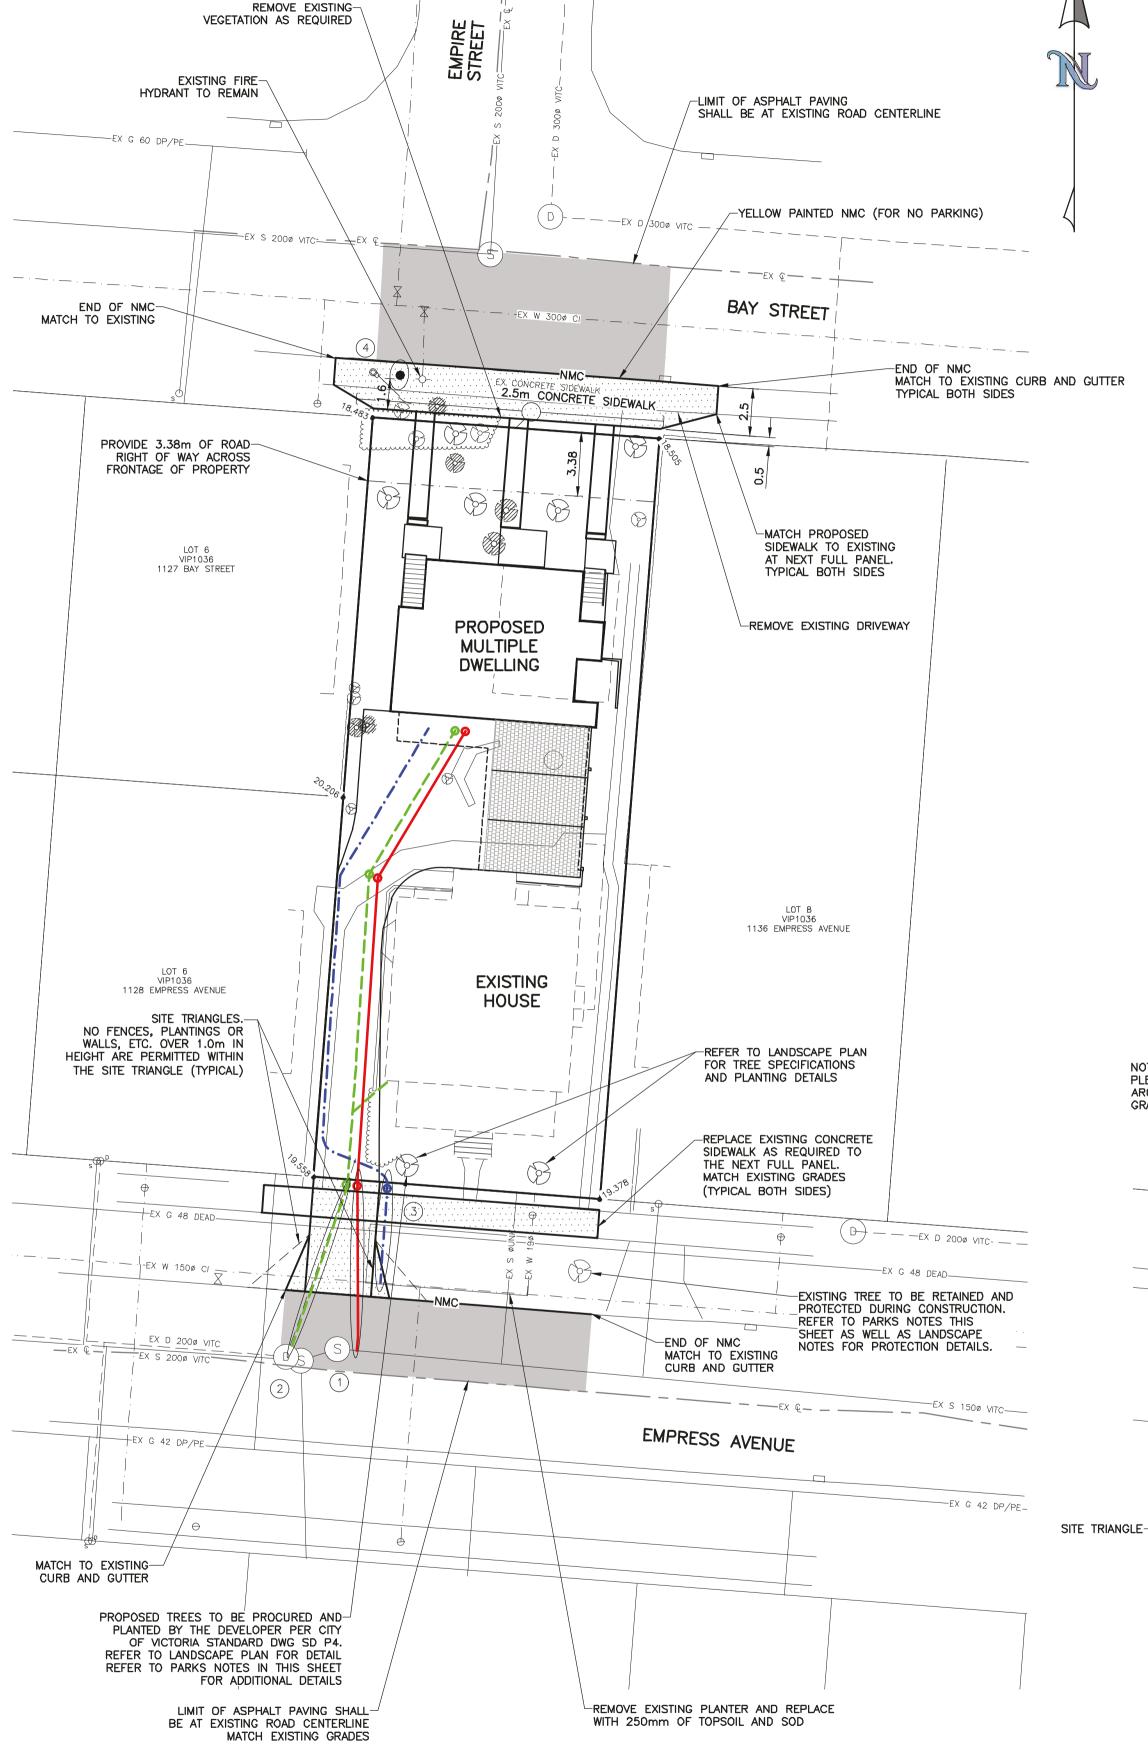


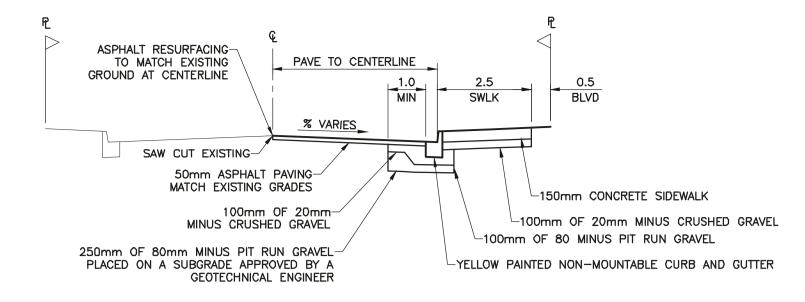


BAY STREET TYPICAL SECTION

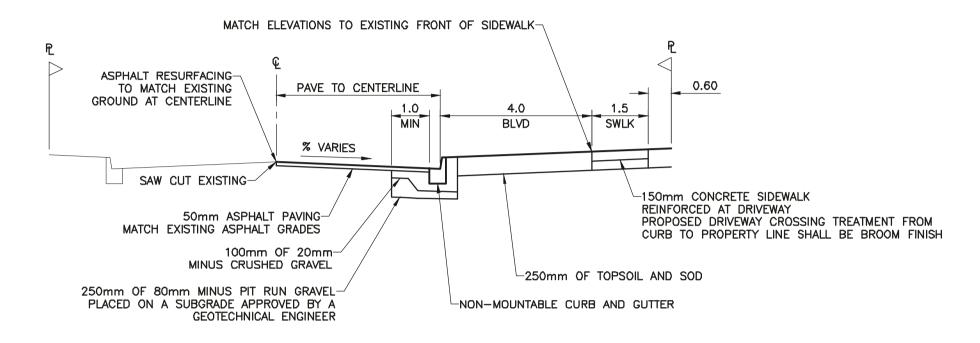

EMPRESS AVENUE TYPICAL SECTION

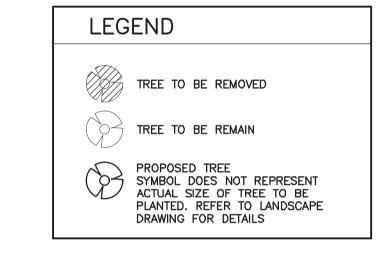

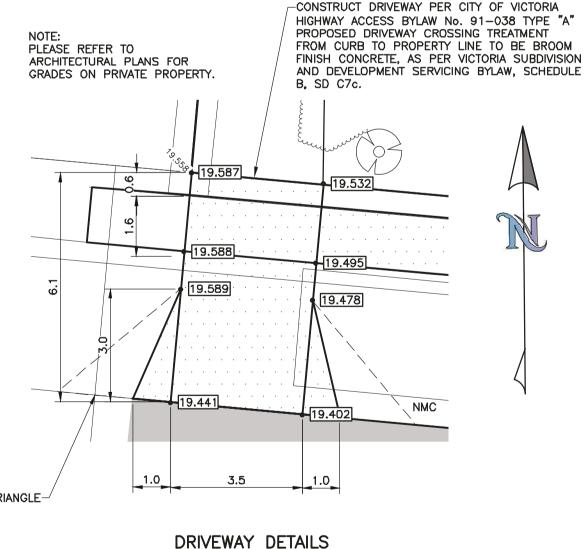

SCALE 1:100



PROPOSED DEVELOPMENT OF LOT 7, PLAN 1036, CITY OF VICTORIA. 1132-1134 EMPRESS AVENUE



THE LOCATION AND ELEVATION OF EXISTING UNDERGROUND SERVICES ON THIS DRAWING MAY NOT BE ACCURATE OR COMPLETE, THE ACTUAL HORIZONTAL AND VERTICAL LOCATIONS MUST BE CONFIRMED BY UTILITY COMPANIES AND THE CONTRACTOR PRIOR TO THE START OF ANY EXCAVATION

REQUEST LOCATE TICKETS AT

BC 1C

LEGEND - Proposed services shown in bold or colour SEWER : CULVERT

S HYDRANT WATER _____ SEWER MANHOLE DRAIN MANHOLE DRAIN _____ SEWER CLEANOUT METER GRAVEL REDUCER - / -DRAIN CLEANOUT BRICK FLUSH MONUMENT EDGE OF PAVEMENT \odot TREE LOT PIN □ / ■ LEAD PLUG ■ BUSHLINE ~~~

ROAD SIGN

UNDERGROUND — H/T/C— MOUNTABLE CURB MC HYDRO/TEL/SHAW FLAT CURB BARRIER CURB ORNAMENTAL STREETLIGHT * / * INVERT GUTTER POWER POLE

REVISIONS NON-MTBLE CURB NMC 24-09-27 ADDED UNDERGROUND BC HYDRO SERVICE 24-05-30 REVISED PER CITY OF VICTORIA COMMENTS REVISED PER CITY OF VICTORIA COMMENTS 24-02-03 DESCRIPTION DATE

SEAL

Pacific Vista Consulting Ltd. 3111 Woodpark Drive, Victoria, BC V9C 1P2 Telephone: 250-516-4143


PROJECT DESIGNED BY: TEL: (250)686-2267 Divil Design Services WRLCivilDesigns@gmail.con **ENGINEER** OCTOBER 2021 GCM 25-104 B.M. 18.386m ELEV. SCALE H 1:200 V N/A


1132-1134 EMPRESS AVE Taylor McCarthy

OVERALL SITE PLAN GENERAL NOTES, KEYPLAN AND OFFSITE GRADING

PVC PROJECT NUMBER 21-143 GOVERNING AUTHORITY FILE No.

of **2** DRAWING No. WRL 017 01

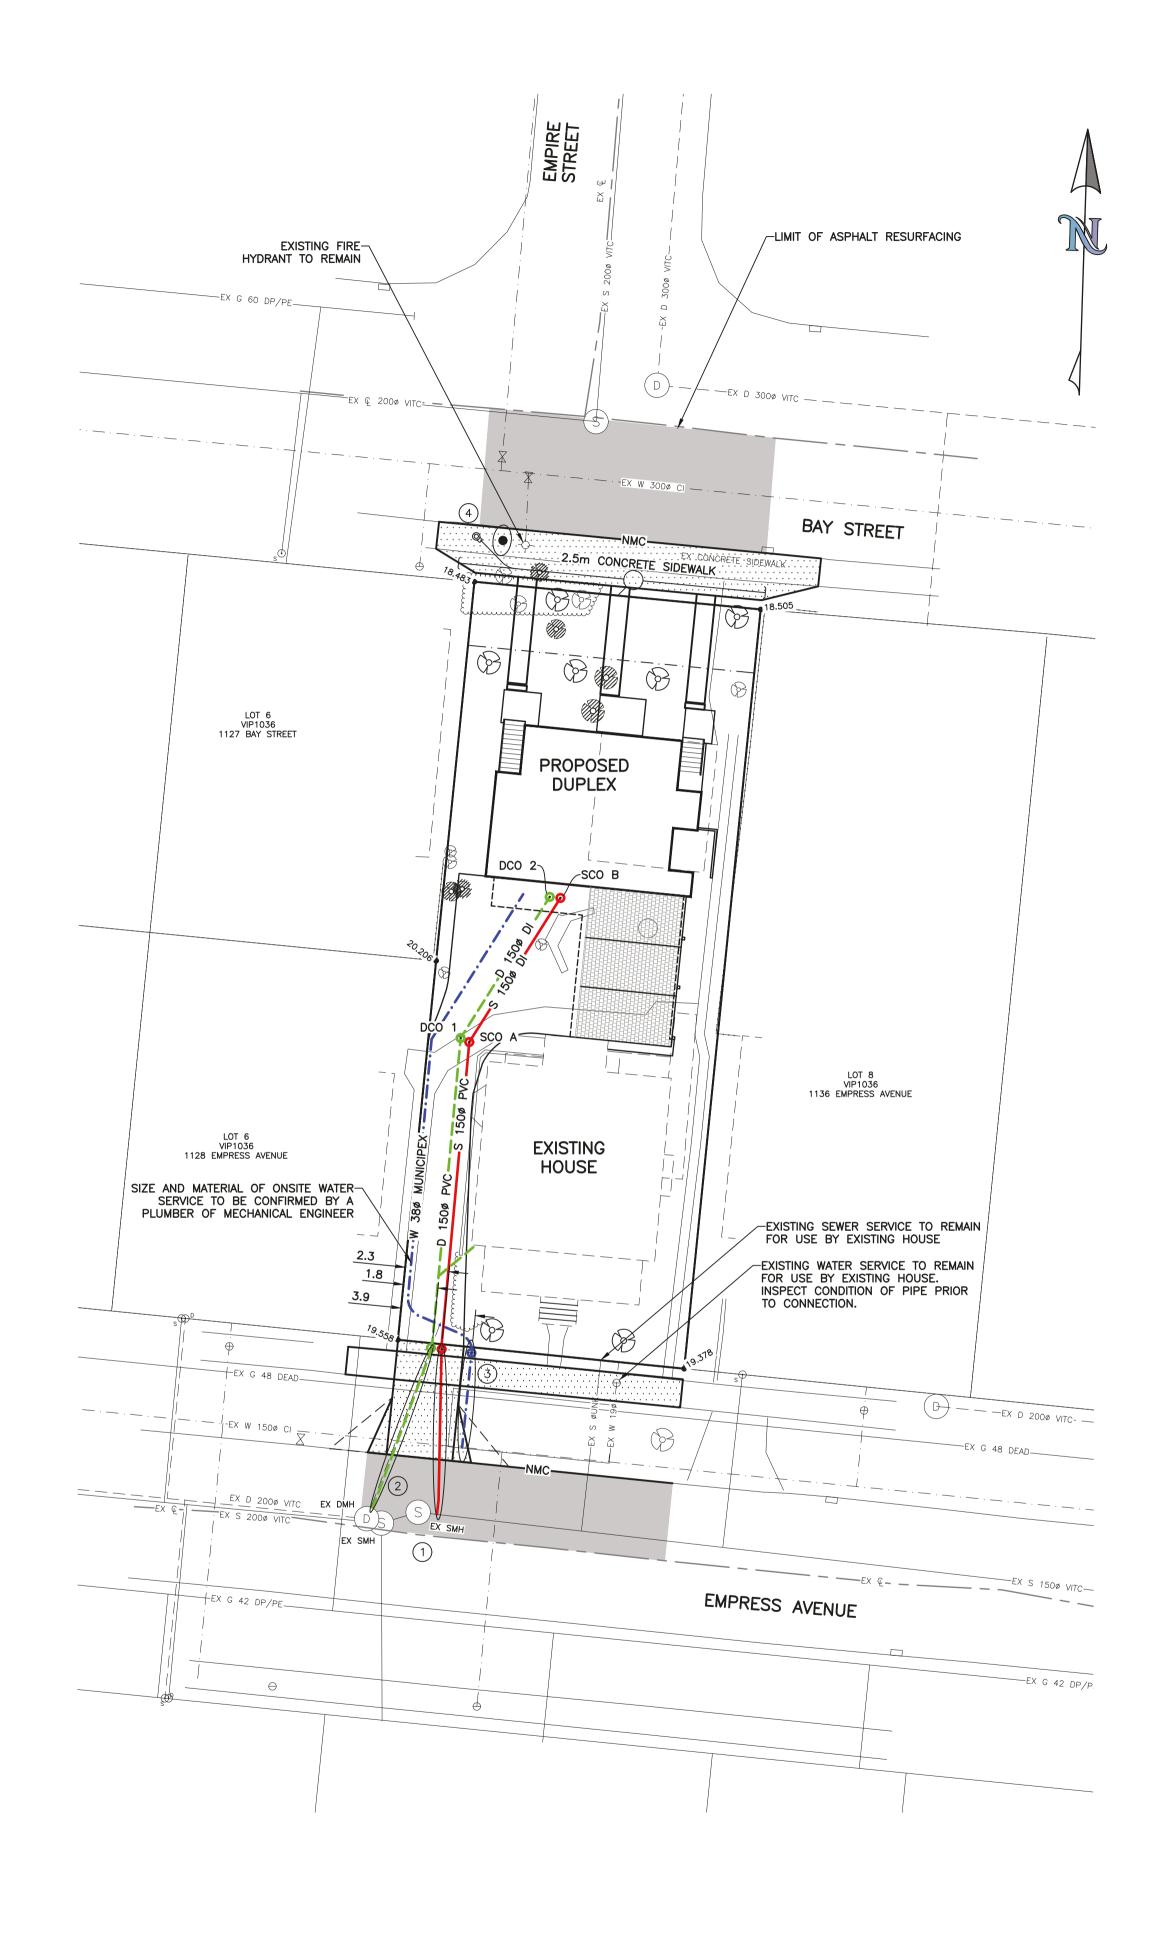

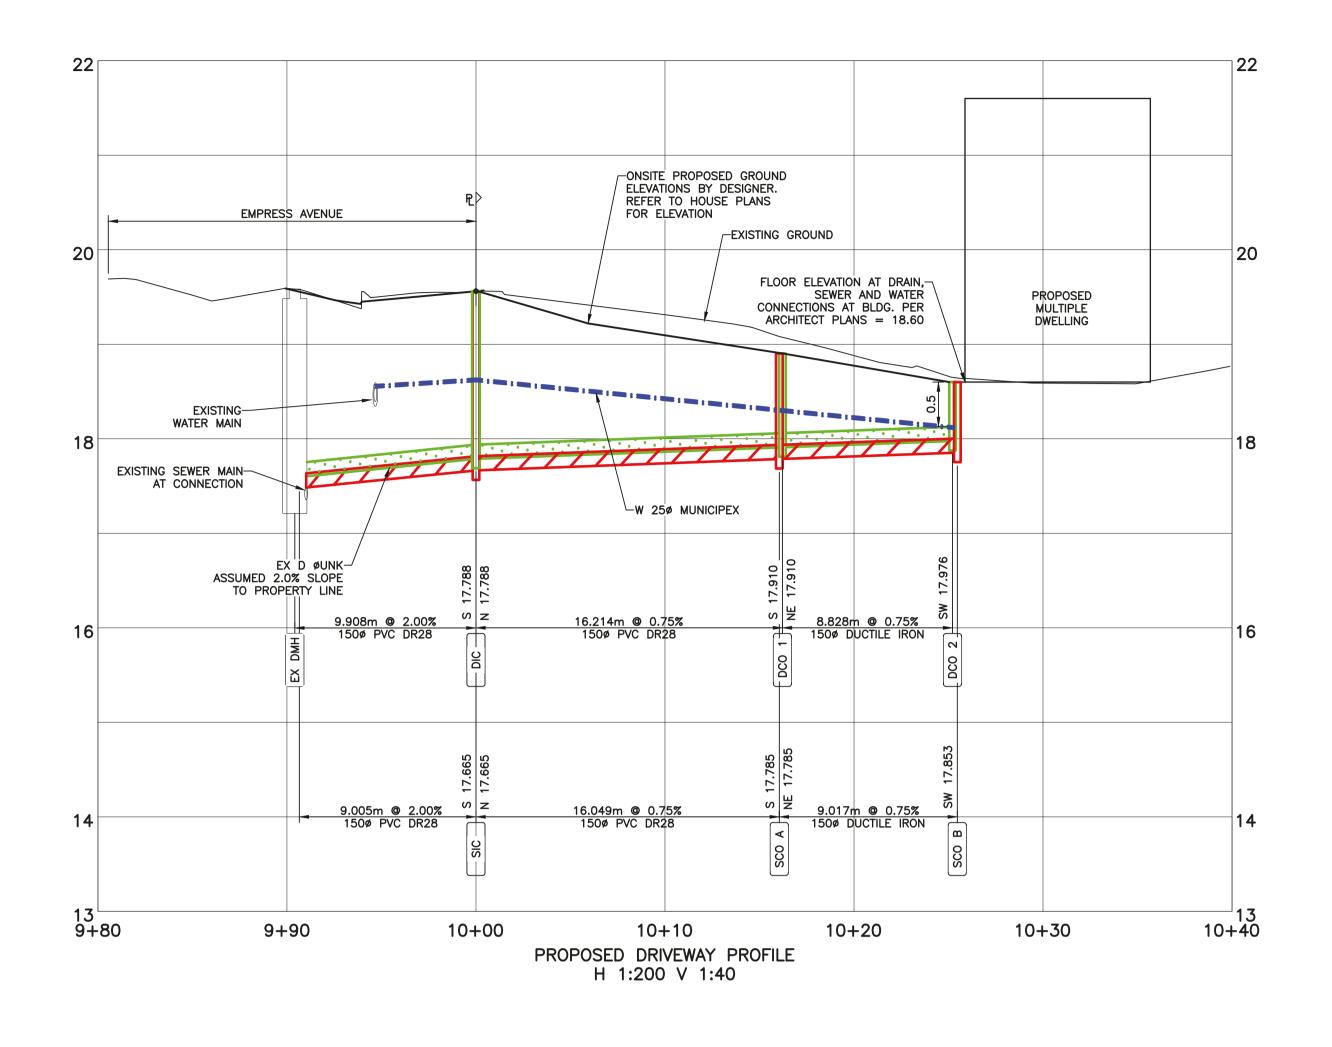

SEWER AND DRAIN NOTES

- THE CITY OF VICTORIA PUBLIC WORKS SHALL INSTALL THE SEWER CONNECTION TO THE PROPERTY LINE AT THE
- DEVELOPER'S EXPENSE.

 THE CITY OF VICTORIA PUBLIC WORKS SHALL REPLACE
 THE DRAIN SERVICE CONNECTION TO 150¢ PVC DR28
 ALONG THE EXISTING TRENCH. MATCH EXISTING INVERTS.
- ALONG THE EXISTING TRENCH. MATCH EXISTING INVERTS

 WATER NOTES
- THE CITY OF VICTORIA SHALL INSTALL THE PROVISIONAL 38mm WATER SERVICE CONNECTION c/w THE 25mm WATER METER TO THE PROPERTY LINE AT THE DEVELOPER'S EXPENSE.

UNDERGROUND SERVICE INFORMATION					
INFORMATION IS AT PROPERTY LINE	STORM DRAIN	SEWER			
PROPOSED DEPTH (m)	1.6200	1.7300			
PROPOSED INVERT ELEVATION (m)	17.7880	17.6650			
MAXIMUM DEPTH REQUESTED					

SEAL

24-09-27

24-05-30

24-02-03

DATE

WORKS AND SERVICES CHECK TABLE						
PLAN CHECKER	AUTHORIZED F	DATE				
PLAN CHECKER	NAME	SIGNATURE	DATE			
BC HYDRO		PENDING				
TELUS		PENDING				
FORTIS						
SHAW	Shawn O'Connor	Shawn O'Connor	Jan 28/2022			
LAND DEVELOPMENT						
TRANSPORTATION						
UNDERGROUND						
PARKS						

0 4 12m

THE LOCATION AND ELEVATION OF
EXISTING UNDERGROUND SERVICES ON
THIS DRAWING MAY NOT BE ACCURATE
OR COMPLETE. THE ACTUAL HORIZONTAL
AND VERTICAL LOCATIONS MUST BE
CONFIRMED BY UTILITY COMPANIES AND
THE CONTRACTOR PRIOR TO THE START
OF ANY EXCAVATION

REQUEST LOCATE TICKETS AT

OF CULVER

BC 1C

	LEGEND — Proposed services shown in bold or colour							REVISIONS	
L	WATER	_ : _ : _	SEWER MANHOLE S/S	HYDRANT -	ASPHALT	GAS ———	NON-MTBLE CURB NMC		
)	SEWER		DRAIN MANHOLE D/D	VALVE ⋈ / ⋈	CONCRETE	UNDERGROUND —— H/T/C— HYDRO/TEL/SHAW	MOUNTABLE CURB MC		
Γ	DRAIN		SEWER CLEANOUT /	METER ⊖ / ●	GRAVEL 3333	COBRA/DAVIT LIGHT COBRA/DAVIT LIGHT	FLAT CURB FC	3	ADDED UNDERGROUND BC HYDRO SERVICE
	DITCH/SWALE CULVERT -		DRAIN CLEANOUT	REDUCER -/	BRICK SSSS	ORNAMENTAL STREETLIGHT * / *	BARRIER CURB BC INVERT GUTTER IG	2	REVISED PER CITY OF VICTORIA COMMENTS
	HEADWALL —		MONUMENT 🔷	FLUSH DD /) TREE	EDGE OF WWW.	POWER POLE ↔/→	IIII GOTTEN 10	1	REVISED PER CITY OF VICTORIA COMMENTS
		□/ ■	LEAD PLUG	BUSHLINE ~~~	ROAD SIGN	ANCHOR →		No.	DESCRIPTION

Pacific Vista Consulting Ltd.

3111 Woodpark Drive, Victoria, BC
V9C 1P2 Telephone: 250-516-4143

ENGINI
DATE

DESIGNED E	BY:			PROJEC
WRL Civil Design	SERVICES		IL: (250)686—226 Designs@gmail.cor	
ENGINEER		JJS	5	
DATE		OCTOBER	R 2021	
В.М.		GCM 25	5-104	
ELEV.		18.386	6m	
SCALE	H 1:200) V	N/A	

1132-1134 EMPRESS AVE
Taylor McCarthy

SERVICING PLAN AND PROFILE

PVC PROJECT NUM 21-143	BER
GOVERNING AUTHORITY	FILE No.
SHEET 2 OF 2	
DRAWING No.	REV.
WRL 017 02	3