ATTACHMENT B



1132 EMPRESS AVENUE Re-issued for Re-Zoning and Parking Variance

Contents:

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A202 Second Floor Plan

A203 Third Floor Plan

A300 Sections and Elevations

A301 Elevations A302 Sections and Elevations

A303 Existing Elevations A700 Sun Study

A701 Materials L100 Landscape Concept Owner:

Taylor McCarthy taylor@fronterahomes.ca (514) 746-3392

Architect: Greenway Studio Architecture ULC

411 Hazlitt Creek Rd Victoria BC, V9E 2A3

250.388.0603

Bruce Greenway Architect AIBC bruce@greenwaystudio.ca

Surveyor:

McElhanney Associates Land Surveying Glen A Quarmby BCLS CLS

Arborist:

Talbot Mackenzie & Associates Consulting Arborists

Box 48153 RPO Uptown Victoria, BC V8Z 7H6

Ph: (250) 479-8733 Fax: (250) 479-7050 Email: tmtreehelp@gmail.com or trees@treehelp.ca

Civil Engineer:

Jared Steingard, P.Eng., LEED AP Pacific Vista Consulting Ltd. cell: (250) 516-4143

Revisions

Re-Issued for Rezoning 25.02.20 Re-Issued for Rezoning 24.09.26

Re-Issued for Rezoning 24.03.08 $\hat{3}$ Re-Issued for Rezoning 23.04.28

Re-Issued for Rezoning 22.01.31

1 Issued for Rezoning 21.04.28 Issued for Rezoning 21.01.29 Pre Application

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project name 1132 Empress Avenue


sheet title

Cover Sheet

project no. 1906 date





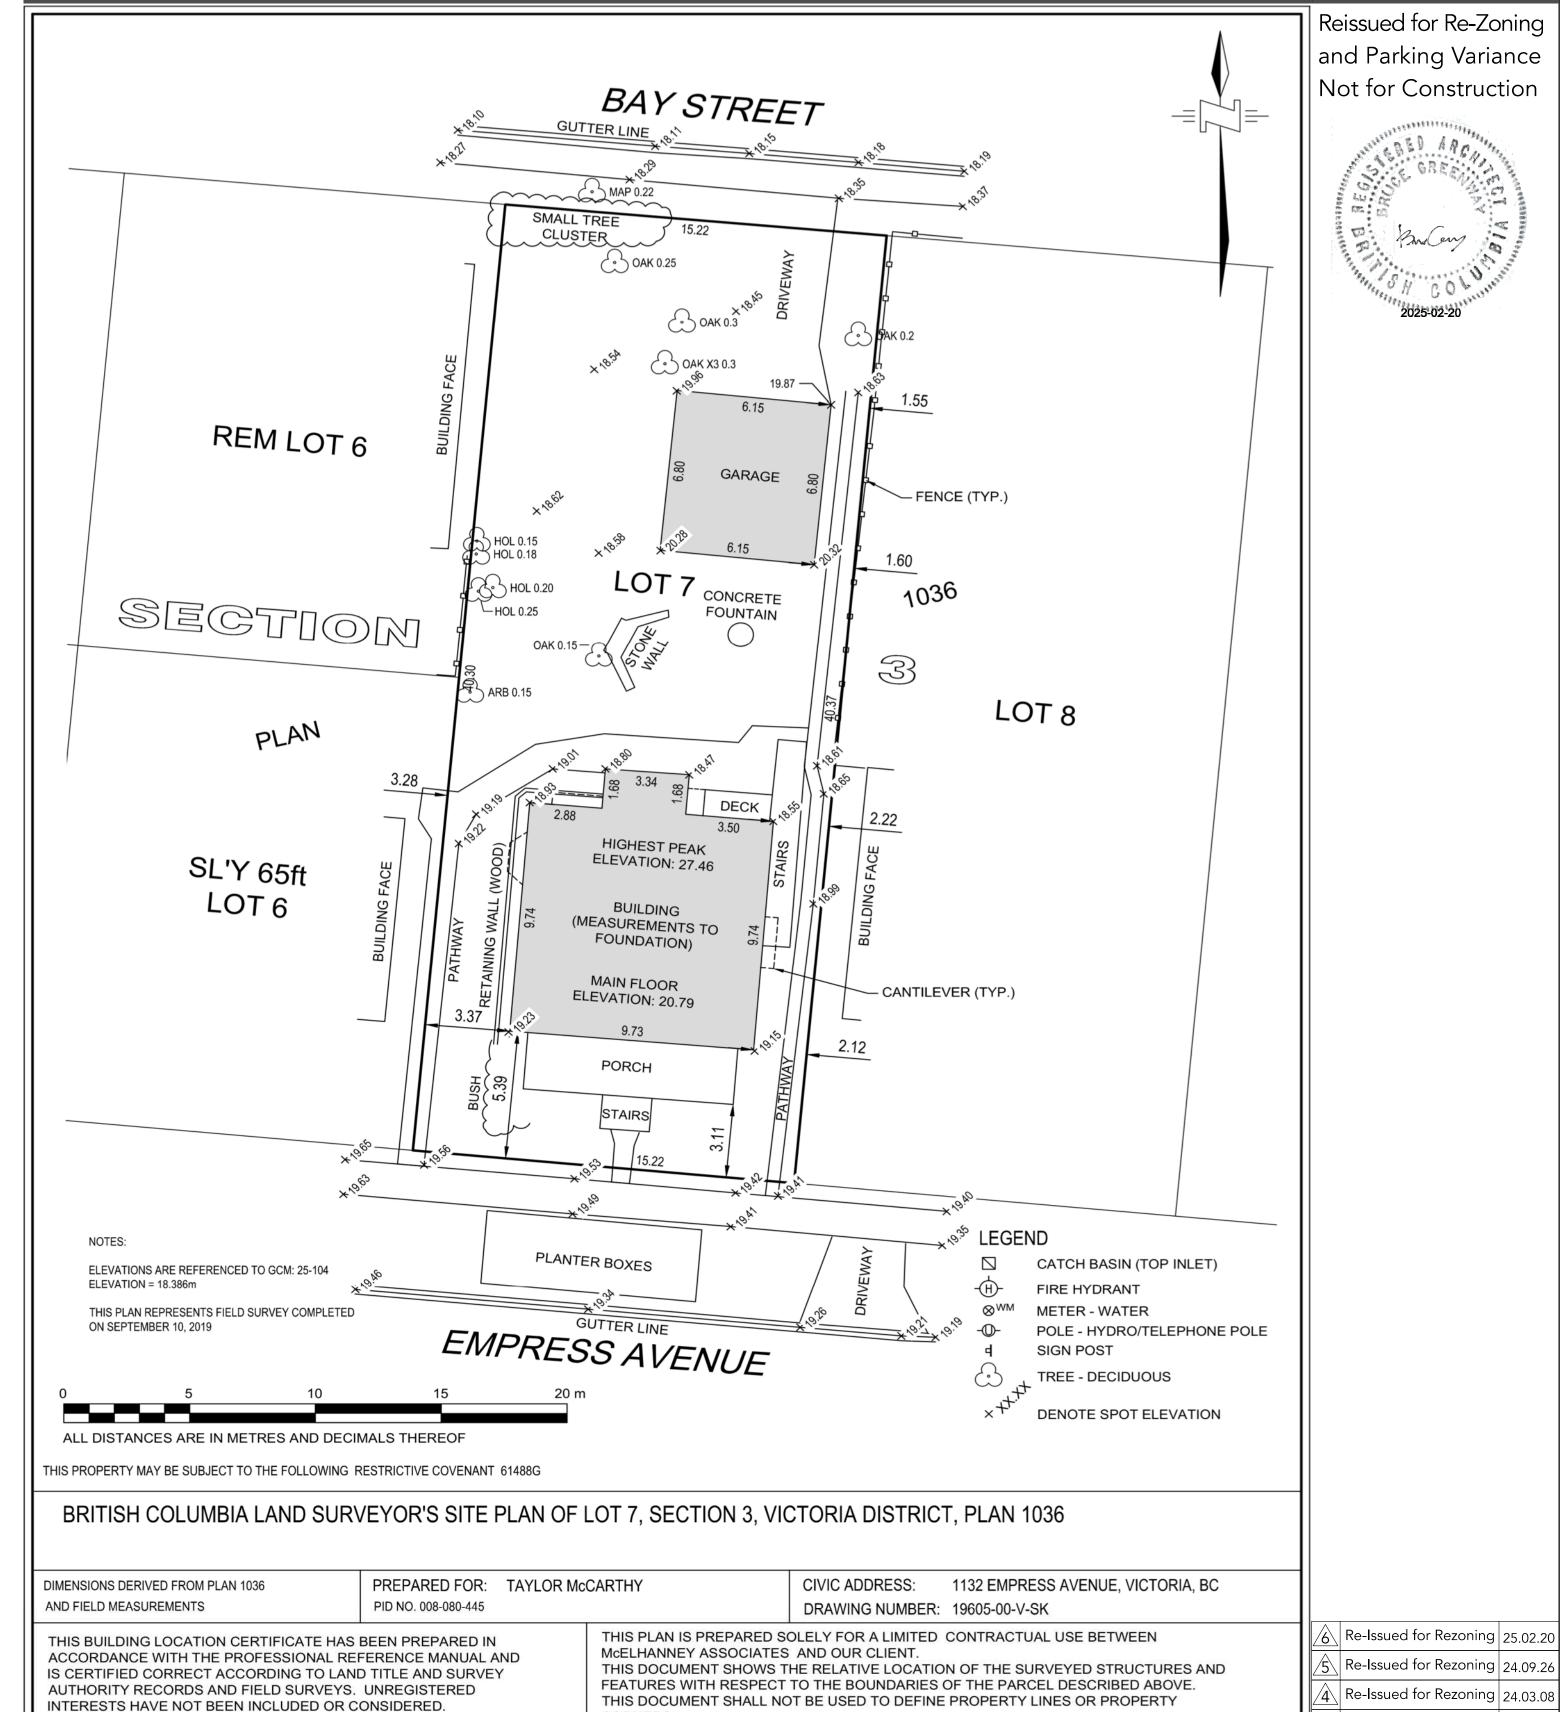

WHOLE OR IN PART PART WITHOUT THE CONSENT OF THE SIGNATORY.

ACTIONS TAKEN BASED ON THIS DOCUMENT.

Suite 500 3960 Quadra Street

DATED THIS 11th DAY OF SEPTEMBER, 2019

(01) Survey

Digitally signed by Glen Quarmby

Date: 2019.09.12 14:05:11 -07'00'

THIS DOCUMENT IS NOT VALID UNLESS DIGITALLY SIGNED

McElhanney

Bar Scale

GLEN A. QUARMBY, BCLS, CLS

McElhanney Associates Land Surveying Ltd.

Victoria BC Canada V8X 4A3

THE SIGNATORY ACCEPTS NO RESPONSIBILITY OR LIABILITY FOR ANY DAMAGES THAT

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Pre Application Greenway Studio

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 $3 \setminus |$ Re-Issued for Rezoning | 23.04.28 |

 \langle Re-Issued for Rezoning 22.01.31

| Issued for Rezoning | 21.04.28 |

Issued for Rezoning |21.01.29

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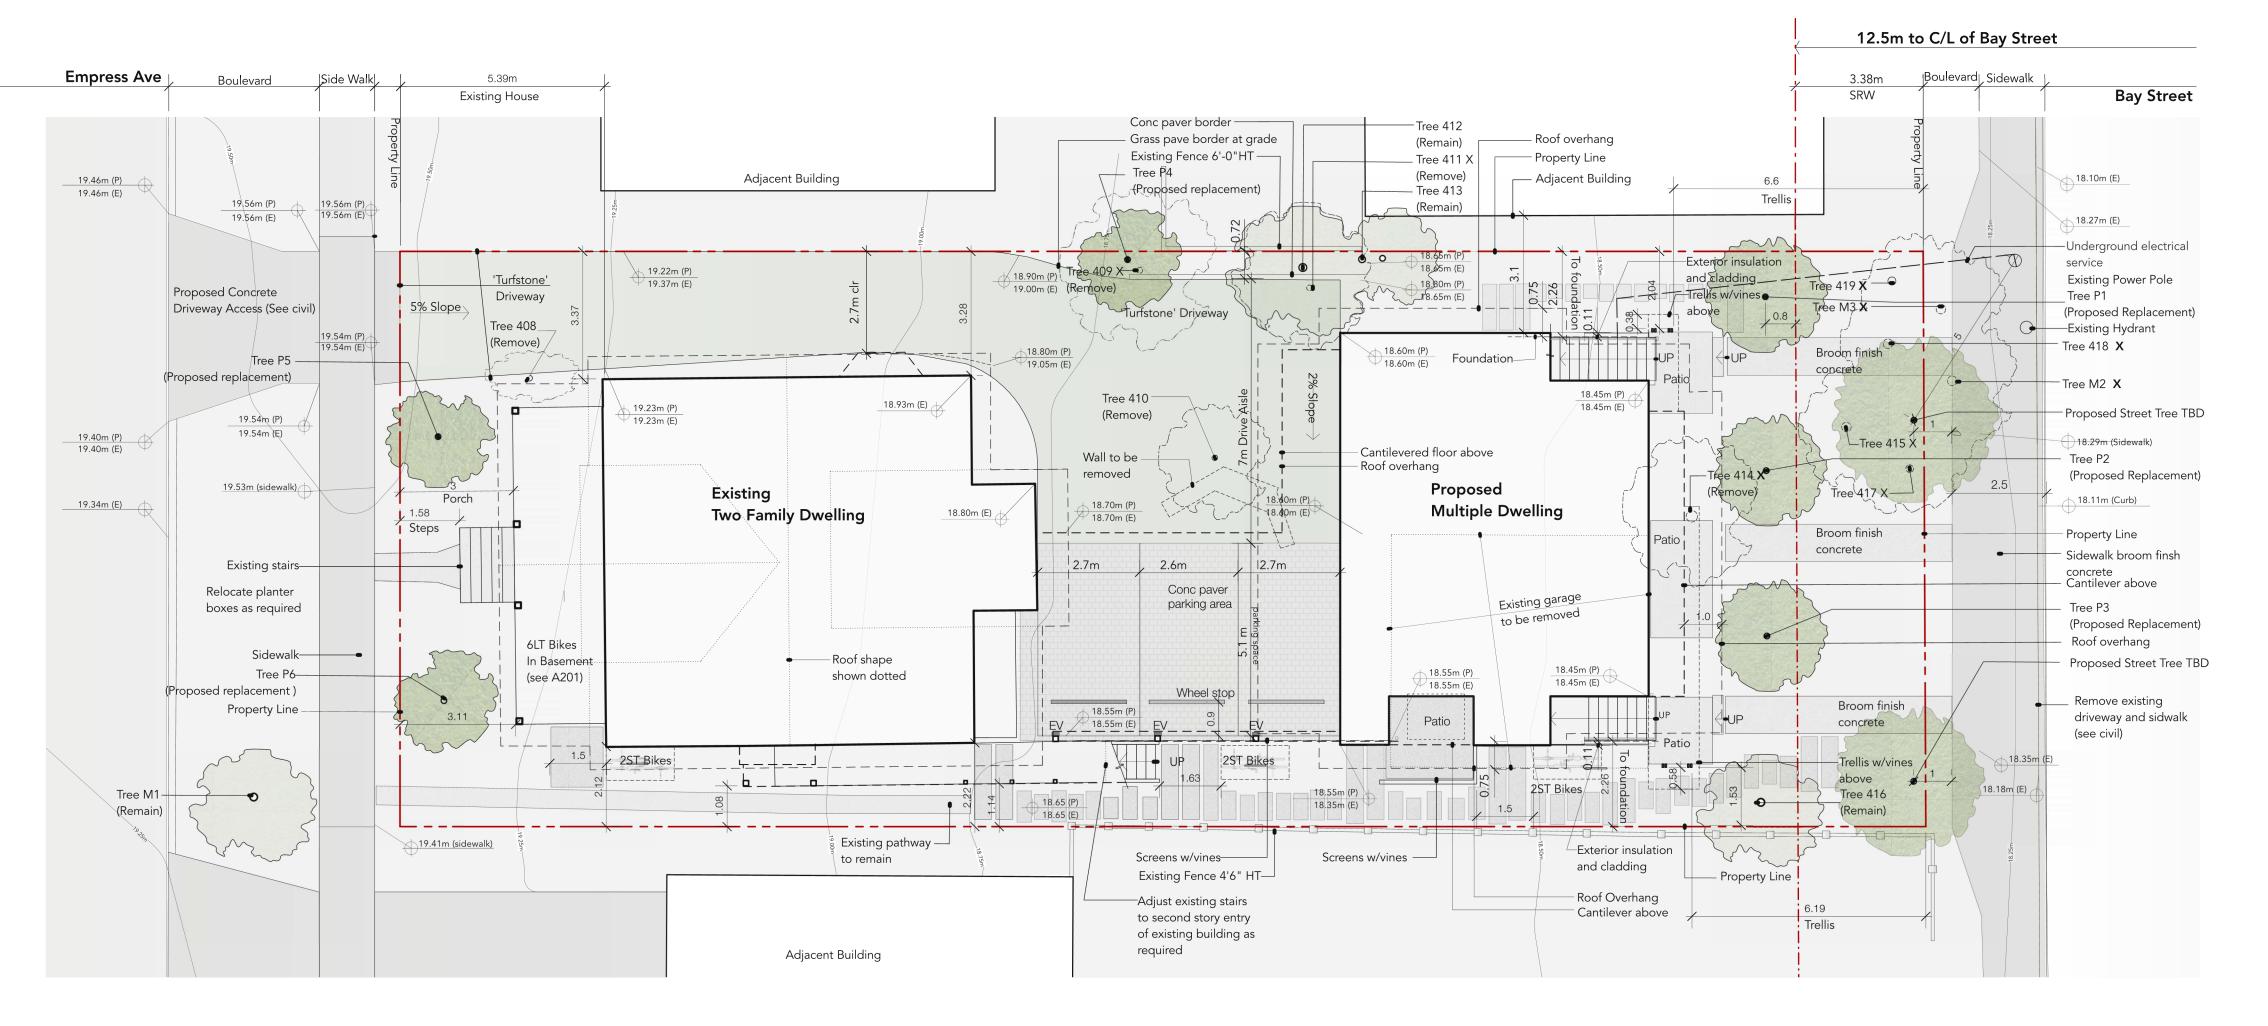
project name 1132 Empress Avenue

sheet title

Survey



project no. 1906 date 25.02.20



Street trees to be procured by applicant species TBD by parks at BP stage



(05) TREE RESOURCE SPREADSHEET

19.23m 19.23m Cantilever May be impacted by SS 19.38m 18.47m E 19.32m May be impacted by prosose <u> 18.80m</u> 19.44m Proposed 18.60m 18.47m P <u>18.70m</u> Parking Area Existing Proposed 18.45m E Z 🗸 _ _ _ _ _ _ J with existing buildings. and Driveway Building Building Existing Proposed 18.45m P Parking Area 18.45m E 135.62 m² 118.55 m² Building Building and steps Dieback, deadwood, pruning wounds Within footprint of proposed 18.47m P Moderate with poor compartmentalization. driveway. 19.44m 138.50 m² Adjacent to property fence, 18.50m E codominant, small deadwood, small 19.33m secondary stem with included bark in Within proposed driveway ——Cantilever attachment. Restricted growing footprint. May also be impacted 19.28m 18.60m 19.15m <u> 18.55m</u> O [†]G 18.55m *△* Growing adjacent to property fence, May be impacted by proposed conflicting with neighbour's roof. driveway, SS/SD. 18.52m <u>18.52m</u> ∕ \<u>√18.55m</u> Growing adjacent to property fence, $138.50\text{m}^2 + 135.62\text{m}^2 + 118.55\text{m}^2 = 392.67\text{m}^2$ 19.05m 18.52m 613.90m² - 392.67m² = 221.23m² Codominant trunk with included bark May be impacted by proposed Point Average of Points Distance Total $213.96\text{m}^2 \div 613.90\text{m}^2 = 36.0\%$ Point Average of Points Distance Total Adjacent to existing garage, A-B 19.33 19.28=19.31 x 3.23m= 62.36 (03) OPEN SITE SPACE CALCULATION R-S 18.50 18.45=18.48 x 7.84m= 154.45 cavities between primary stem Within proposed building B-C 19.28 19.15=19.22 x 2.40m= 46.12 18.45 18.45=18.45 x 1.54m= 28.41 C-D 19.15 19.15=19.15 x 0.75m= 14.36 T-U 18.45 18.45=18.45 x 2.19m= 40.41 D-E 19.15 19.05=19.10 x 3.63m= 69.33 U-V 18.45 18.45=18.45 x 0.95m= 30.63 Extensive deadwood, dieback, decay footprint, poor health and E-F 19.05 19.05=19.05 x 0.96m= 18.29 V-W 18.45 18.60=18.53 x 4.11m= 14.45 in pruning wounds, witch's broom. structure F-G 19.05 18.60=18.83 x 11.50m= 216.49 W-X 18.60 18.70=18.70 x 8.64m= 149.73 G-H 18.60 18.60=18.60 x 1.22m= 22.69 X-Y 18.70 18.80=18.75 x 1.30m= 64.53 Slight lean northwest. West CRZ used as parking stall historically.

Slight lean northwest. West CRZ building footprint, walkway, potential canopy conflict.

TBD H-I 18.60 18.55=18.58 x 4.29m= 79.69 Y-Z 18.80 18.70=18.85 x 1.67m= 150.32 I-J 18.55 18.52=18.54 x 1.21m= 22.43 Z-ZA 18.70 18.80=18.92 x 2.68m= 25.50 _---J-K 18.52 18.55=18.54 x 1.34m= 24.84 May be impacted by proposed ZA-ZB 18.80 18.90=18.92 x 2.68m= 31.48 K-L 18.55 18.55=18.55 x 2.34m= 43.41 ZB-ZC 18.90 18.93=18.92 x 2.68m= 54.66 L-M 18.55 18.52=18.54 x 1.34m= 24.84 ZC-ZD18.93 19.23=19.08 x 9.74m= 185.84 May be impacted by proposed M-N 18.52 18.52=18.52 x 4.51m= 83.53 ZD-ZE 19.23 19.23=19.23 x 0.72m= 13.85 N-O 18.52 18.52=18.52 x 0.89m= 16.48 ZE-ZF 19.23 19.38=19.31 x 2.40m= 46.33 O-P 18.52 18.55=18.54 x 1.66m= 30.77 ZF-ZG 19.38 19.32=19.35 x 3.17m= 61.34 P-Q 18.55 18.50=18.53 x 2.19m= 40.57 ZG-ZH19.32 19.44=19.38 x 1.43m= 27.71 Q-R 18.50 18.50=18.50 x 1.54m= 28.49 ZH-ZI 19.44 19.44=19.44 x 1.98m= 38.49 May be impacted by proposed ZI-A 19.44 19.33=19.39 x 1.43m= 27.91 Terrace **Existing Building** Proposed 105.79 1988.12 Building and Steps and steps Hydro clearance pruning, deflected Within footprint of proposed AVG GR 1988 ÷ 105.79 = **18.80m** 138.50 m² 37.08 m^2 and steps **Basement Calculation** 118.5 m^2 Main Floor Elevation (per survey) = 20.79m Cluster of plum suckers appears to Conflict with proposed boulevard Floor Depth = 0.27m Basement Ceiling = 20.52m Prepared by: Avg grade = 18.80m Talbot Mackenzie and Associates Average grade to finished ceiling = 1.72m _---Box 48153 RPO Uptown 1.73m > 1.2m Not a basement Victoria, BC V8Z 7H6 $138.50\text{m}^2 + 37.08\text{m}^2 + 118.50\text{m}^2 = 294.08\text{m}^2$ Ph: (250) 479-8733 ~ Fax: (250) 479-7050 $314.22\text{m}^2 \div 613.9\text{m}^2 = 47.9\%$ Email: tmtreehelp@gmail.com

04 SITE COVERAGE CALCULATION

(02) AVERAGE GRADE CALCULATION

copied from TMP

PROJECT INFORMATION FOR REZONING AND DEVELOPMENT VARIANCE Proposed Comparison Existing R-2 Site Specific RTM Traditional Residential Multifamily Multiple Dwelling Multiple Dwelling Single Family As permitted in R-2 Two Family Single Family Public Building Two Family Attached Dwelling Home Occupation Accessory Building 1 1/2 w/ basement 2 w/o basement 1 1/2 Existing bldg. **Building Height** 7.6m MAX 10.5m Roof Deck No No 613.9m² 613.9m² Site Area 555m² min. 15.22m 15.22m Lot Width 40.34m 40.34m Lot Depth 47.9% 40% max 50% Site Coverage (see 4-A100) Open Site Space 30% min 30.0%min 30% 36.0% proposed (see 3-A100) 473.83m² Total Floor Area 238.82m² Floor Space Ratio 0.5 : 1 max 0.77 : 1 1.0 : 1 0.39 : 1 current Existing Principal Blo 238.82m² 238.92m² Total Area 55.97m² 55.97m² Upper Floor $94.00 m^2$ 94.00m² Ground Floor Lower Floor $88.85m^{2}$ 88.85m² (Not considered a basement per bylaw. See calculations 2-A100) <u>Proposed Bldg</u> Total Area N/A 234.92m² N/A 84.84m² Third Floor N/A Second Floor 86.07m² N/A` Ground Floor 64.01m² Front Yard Setback 7.5m or 7.5m or Avg of buildings Avg of buildings abutting lot abutting lot 3.5m projection Porch and stairs 3.5m projection Bay Window 0.6 projection 0.6 projection Side Yard Setback 1.52m See dimensions (10% of lot width) See dimensions Side Yard Setback 3.0m See dimensions Combined Side Yard 4.52m Rear Yard Setback 14.12m See dimensions (35%of lot depth) 0.75m Projection 0.75m Projection 1.0m Front Projection Accessory Building Floor Area 37m² max As permitted in R-2 Existing accessory garage Existing garage 42m² (27m² excluded for to be removed 2 parking spaces) 3.5m 3.5m Car and Bicycle Parking Off street Car Parking Spaces 7 (5.9) Per schedule C (5 units x 1.3 appartments) + .01 visitor Long Term bicycle racks

GENERAL NOTES

Short Term bicycle racks

- 1. All work shall meet BC building code 2018 and all applicable bylaws and regulations of the City of Victoria and Province of British Columbia.
- 2. The drawings provided are diagrammatic in nature. The contractor shall perform site measurements and report any discrepancies or omissions with site conditions to the designer and owner prior to undertaking any work.
- 3. Clean-up on a daily basis and at completion of the project to remove all remaining debris and construction materials and clean all exposed surfaces.
- 4. All waste material shall be disposed of according to all applicable municipal and provincial regulations.
- 5. All dimensions are measured in meters unless otherwise noted.
- 6. All dimensions are measured to face of framing or concrete unless noted otherwise. Do not scale from drawings.
- 7. All finishes, fitments, and appliances to be installed according to manufacturer
- recommendations/ warranty standards.
- 8. All stair, handrail, geometry, and guard geometry to BCBC 9.8.
- 9. Topographical lines are in .25m increments and are extrapolated from survey grades. Discrepancies with drawn topography and actual site features to be brought to the consultant's attention.
- 10. Discrepancies with consultant's drawings and engineer's drawings to be brought to the
- attention of consultant, owner, and engineer. Changes to be approved by all parties.
- 11. Project to comply with step 3 of the BC energy step code for part 9 buildings.

12. Refer to Tree Preservation Plan dated April 30 2021

- 13. EV charging stations to be installed as per the COV "Electric Vehicle Charging Infrastructure Technical Bulletin" (2020)
- 14. Proposed driveway access to conform to COV Highway Access Bylaw (2015)

15. Mechanical and ventilation system to use Heat Pump and HRV

Lot 7, Section 3, Victoria District, Plan 1036, PID 008-080-445

Civic Address 1132 Empress Avenue Victoria BC

Legal description

1132 Empress Avenue sheet title Site Plan

project name

Reissued for Re-Zoning

and Parking Variance

Not for Construction

2025-02-20

Project Information 25.02.20 project no. 1906 date revison no.

A100

Re-Issued for Rezoning 25.02.20

/5\ Re-Issued for Rezoning 24.09.26

 $\stackrel{\frown}{\Delta}$ Re-Issued for Rezoning | 24.03.08 |

Re-Issued for Rezoning 23.04.28

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Issued for Rezoning | 21.04.28 |

| Issued for Rezoning | 21.01.29 |

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project name 1132 Empress Avenue

sheet title

Streetscape

project no. 1906 date 25.02.20

sheet no. **A101**




CALCULATIONS


	Face A	Face B	Face C	Face D
Exposing building face	76.74m ²	85.86m ²	85.86m ²	85.86m ²
Limiting Distance	15.38m	2.15m	3.25m	2.15m
Maximum area allowed	100.0%	9.67%	14.63%	9.67%
Per Table 9.10.15.4	76.74m ²	8.30m ²	12.56m ²	8.30m ²
Area of proposed openings	15.95m²	7.55m²	9.06m ²	6.05m ²
	20.7%	8.70%	10.50%	7.00%

At time of Building Permit submission the proposal will comply with section 9.10.14. of the BCBC for spatial separations and unprotected openings.

ERCY Bruce Greenway Architect AIBC

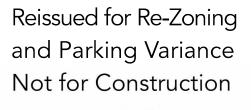



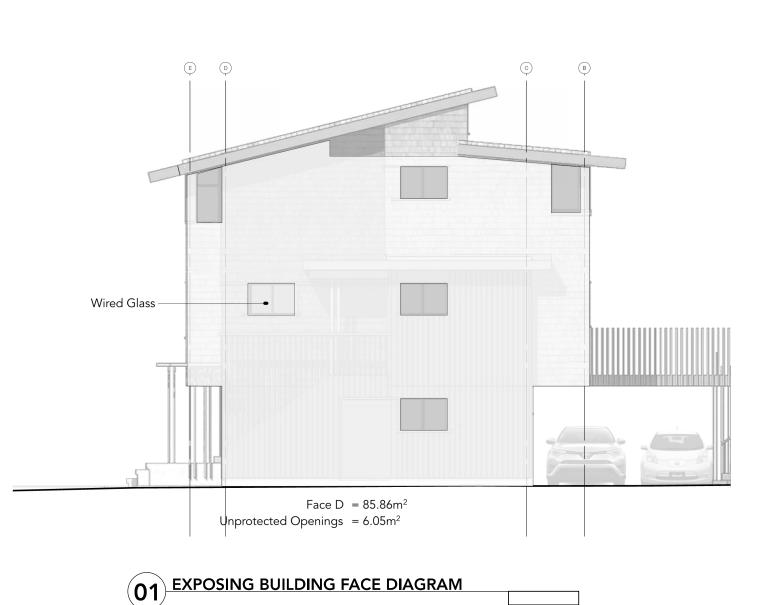



Wired Glass

Acceptance of the second			
+	6	Re-Issued for Rezoning	25.02.20
	5	Re-Issued for Rezoning	24.09.26
	4	Re-Issued for Rezoning	24.03.08
	3	Re-Issued for Rezoning	23.04.28
	2	Re-Issued for Rezoning	22.01.31
100000000	1	Issued for Rezoning	21.04.28
		Issued for Rezoning	21.01.29
		Pre Application	
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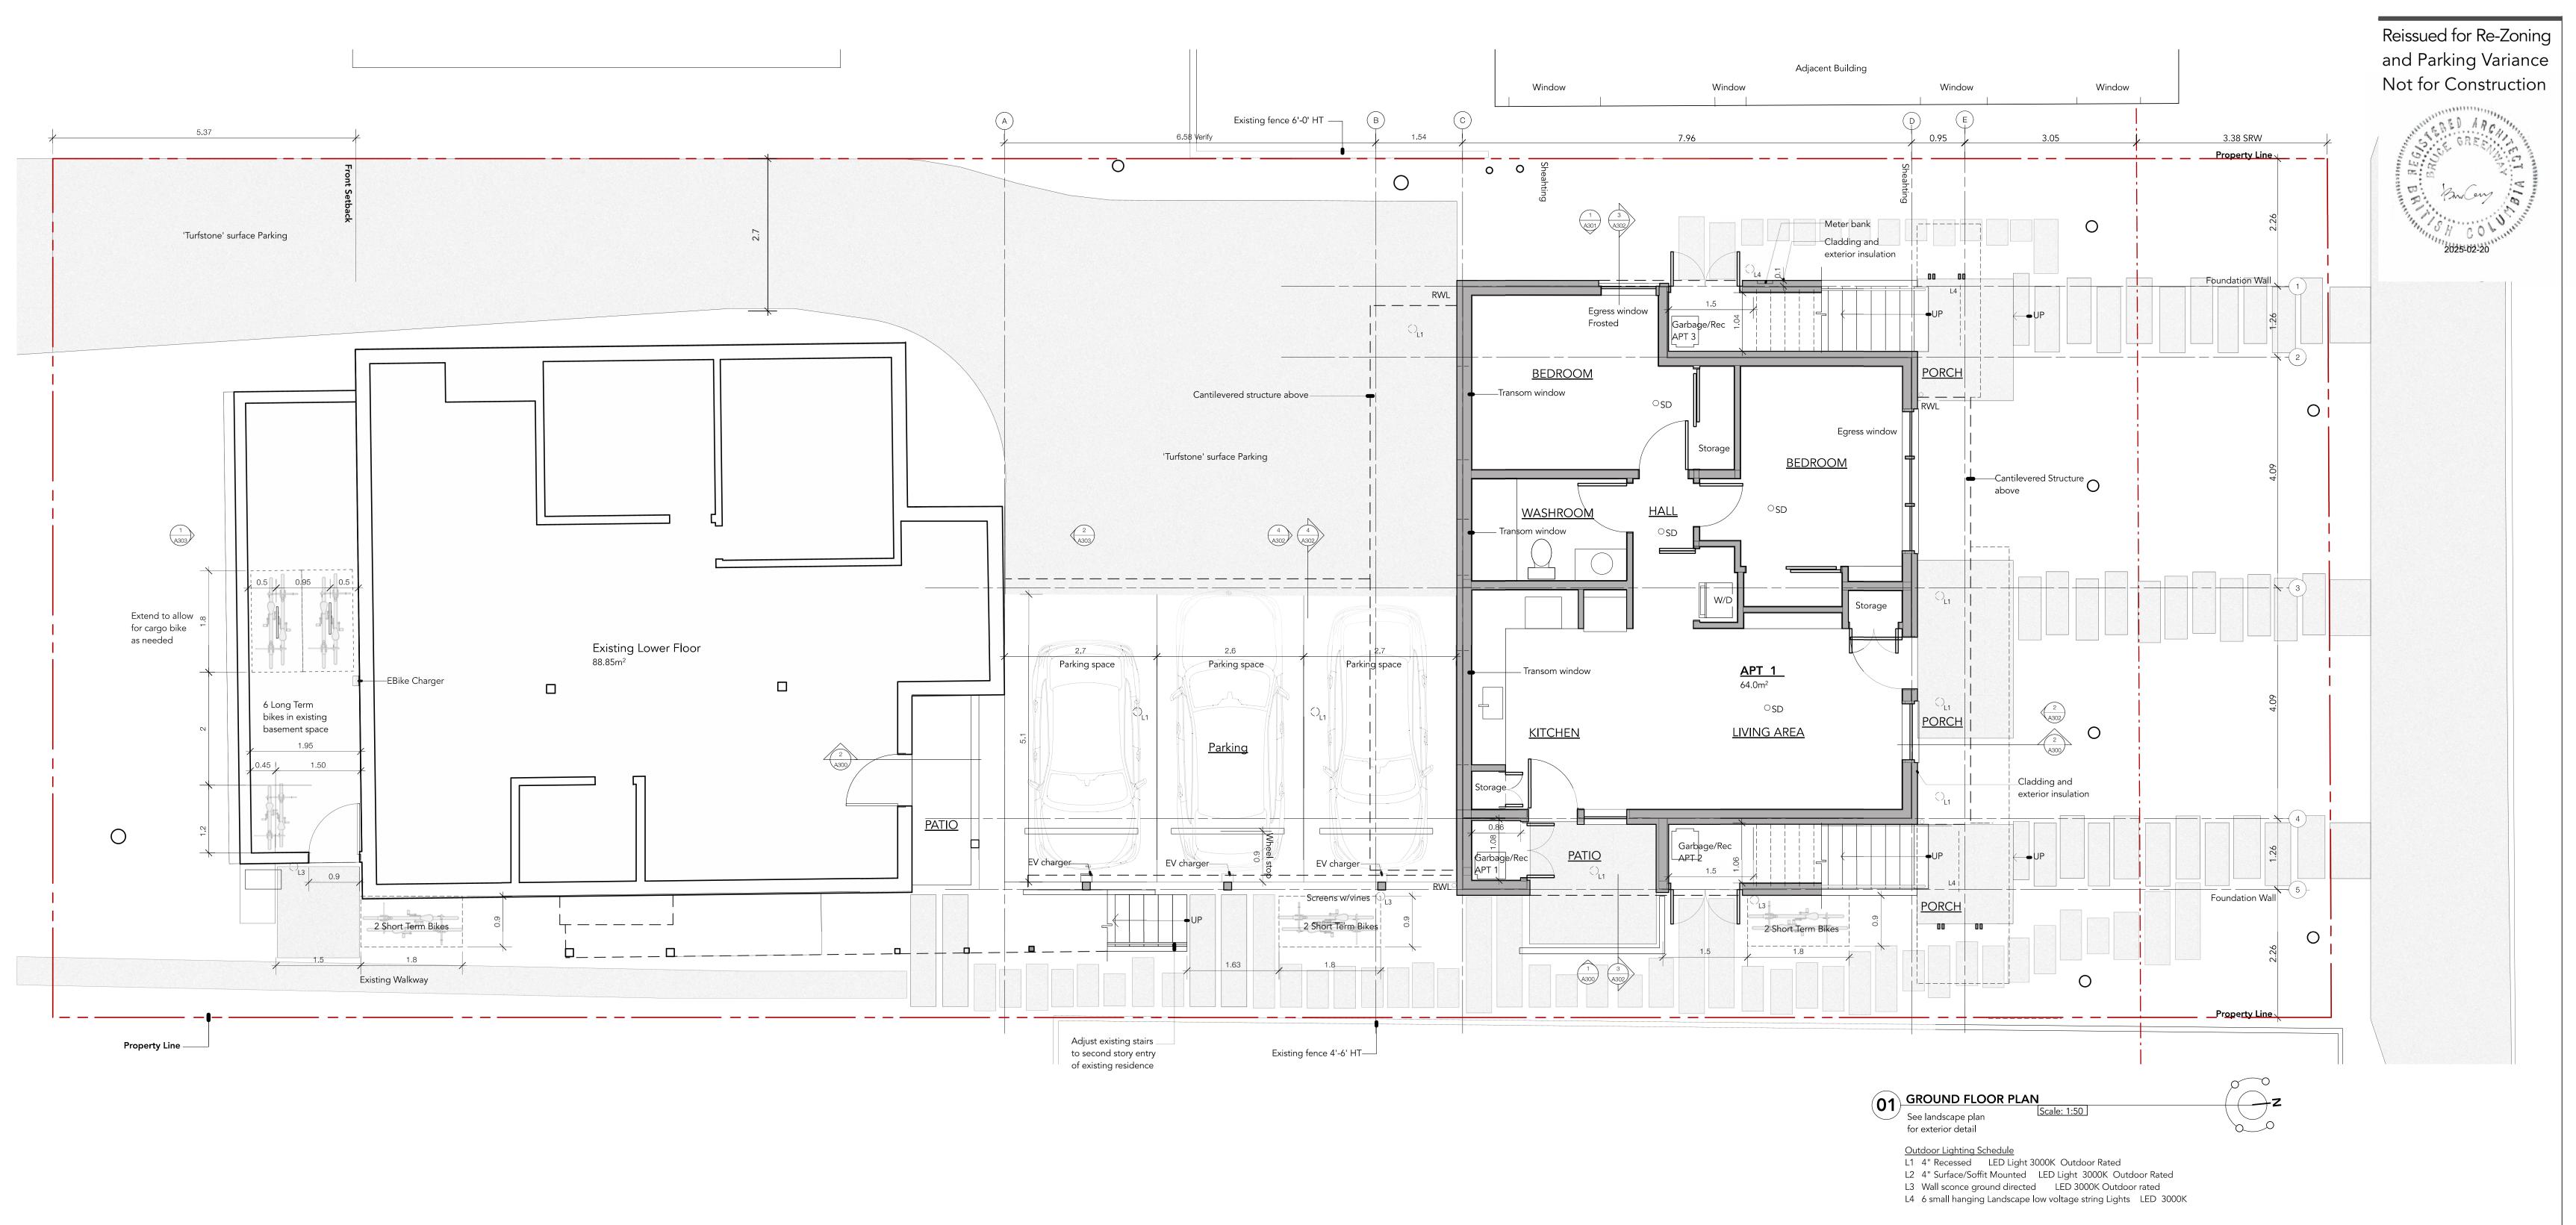
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project name 1132 Empress Avenue

Window Alignment **Project Information**

project no. 1906 date 25.02.20

A102



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Re-Issued for Rezoning 24.03.08

Re-Issued for Rezoning 23.04.28

Re-Issued for Rezoning 22.01.31

Issued for Rezoning 21.04.28

Issued for Rezoning 21.01.29

Pre Application

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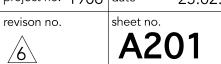
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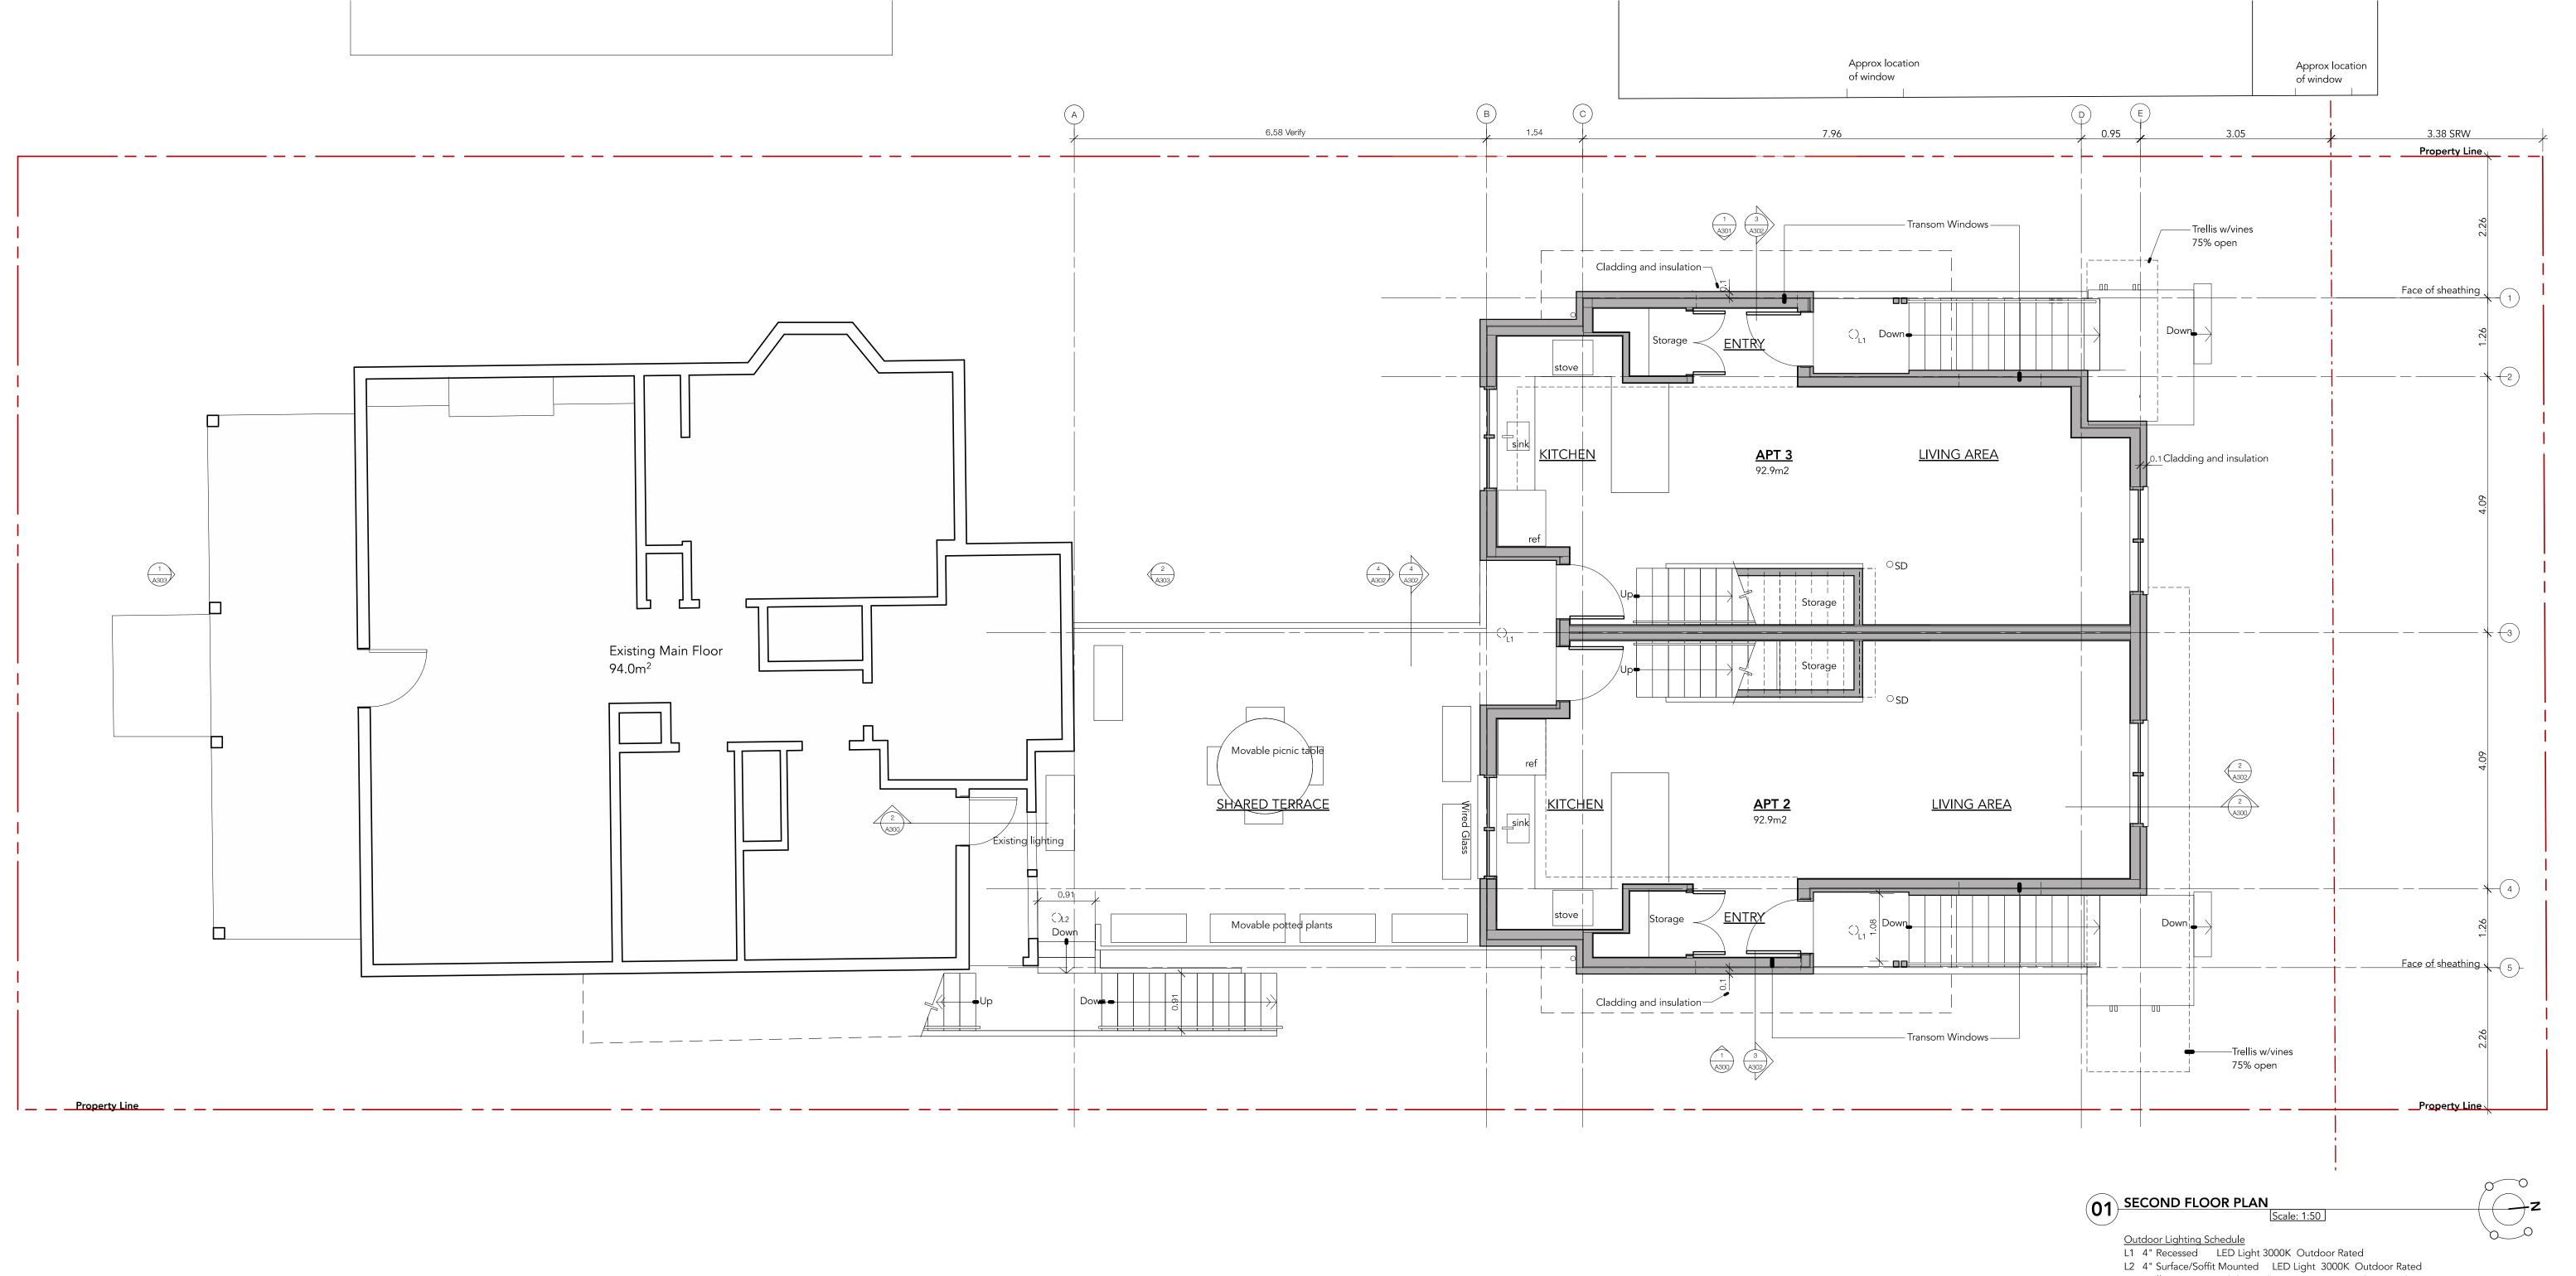
project name
1132 Empress Avenue

sheet title

Ground Floor Plan

project no. 1906 date 25.02.20







Re-Issued for Rezoning 25.02.20 Re-Issued for Rezoning 24.09.26

L3 Wall sconce ground directed LED 3000K Outdoor rated L4 6 small hanging Landscape low voltage string Lights LED 3000K

Re-Issued for Rezoning 24.03.08

 $|\hat{3}|$ Re-Issued for Rezoning |23.04.28|

2 Re-Issued for Rezoning 22.01.31

Issued for Rezoning 21.04.28

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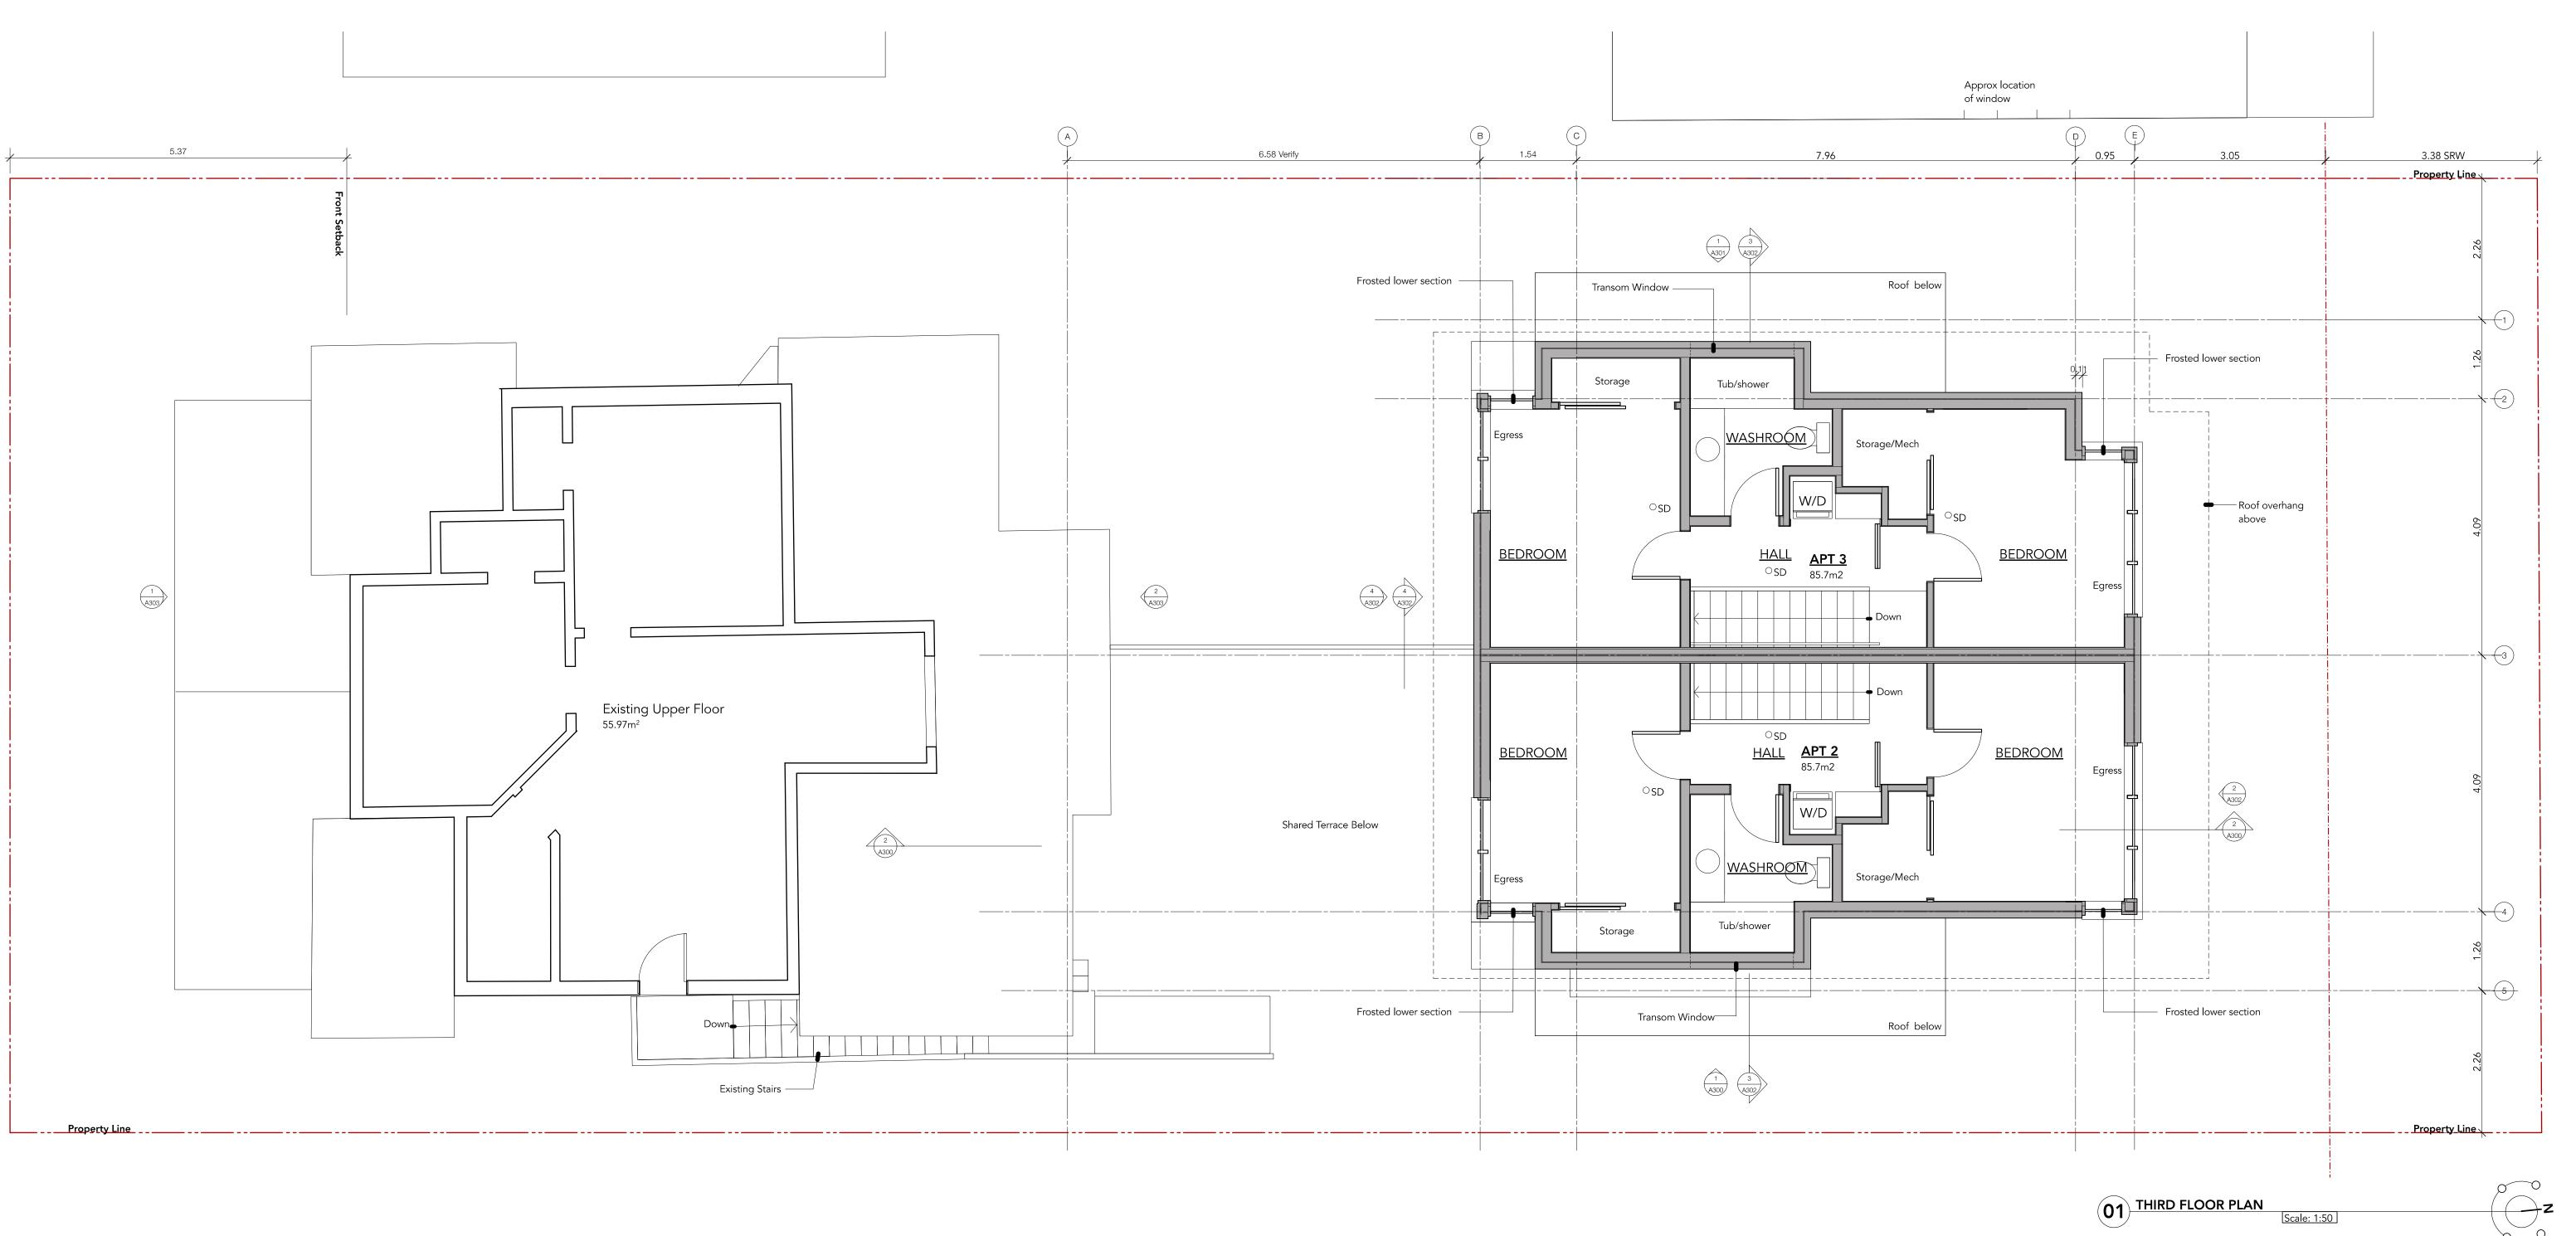
project name 1132 Empress Avenue

sheet title

Second Floor Plan

25.02.20 project no. 1906 date revison no.

A202





Re-Issued for Rezoning 25.02.20 Re-Issued for Rezoning 24.09.26 Re-Issued for Rezoning 24.03.08 $\sqrt{3}$ Re-Issued for Rezoning 23.04.28 Re-Issued for Rezoning 22.01.31 Issued for Rezoning 21.04.28 Issued for Rezoning 21.01.29 Pre Application

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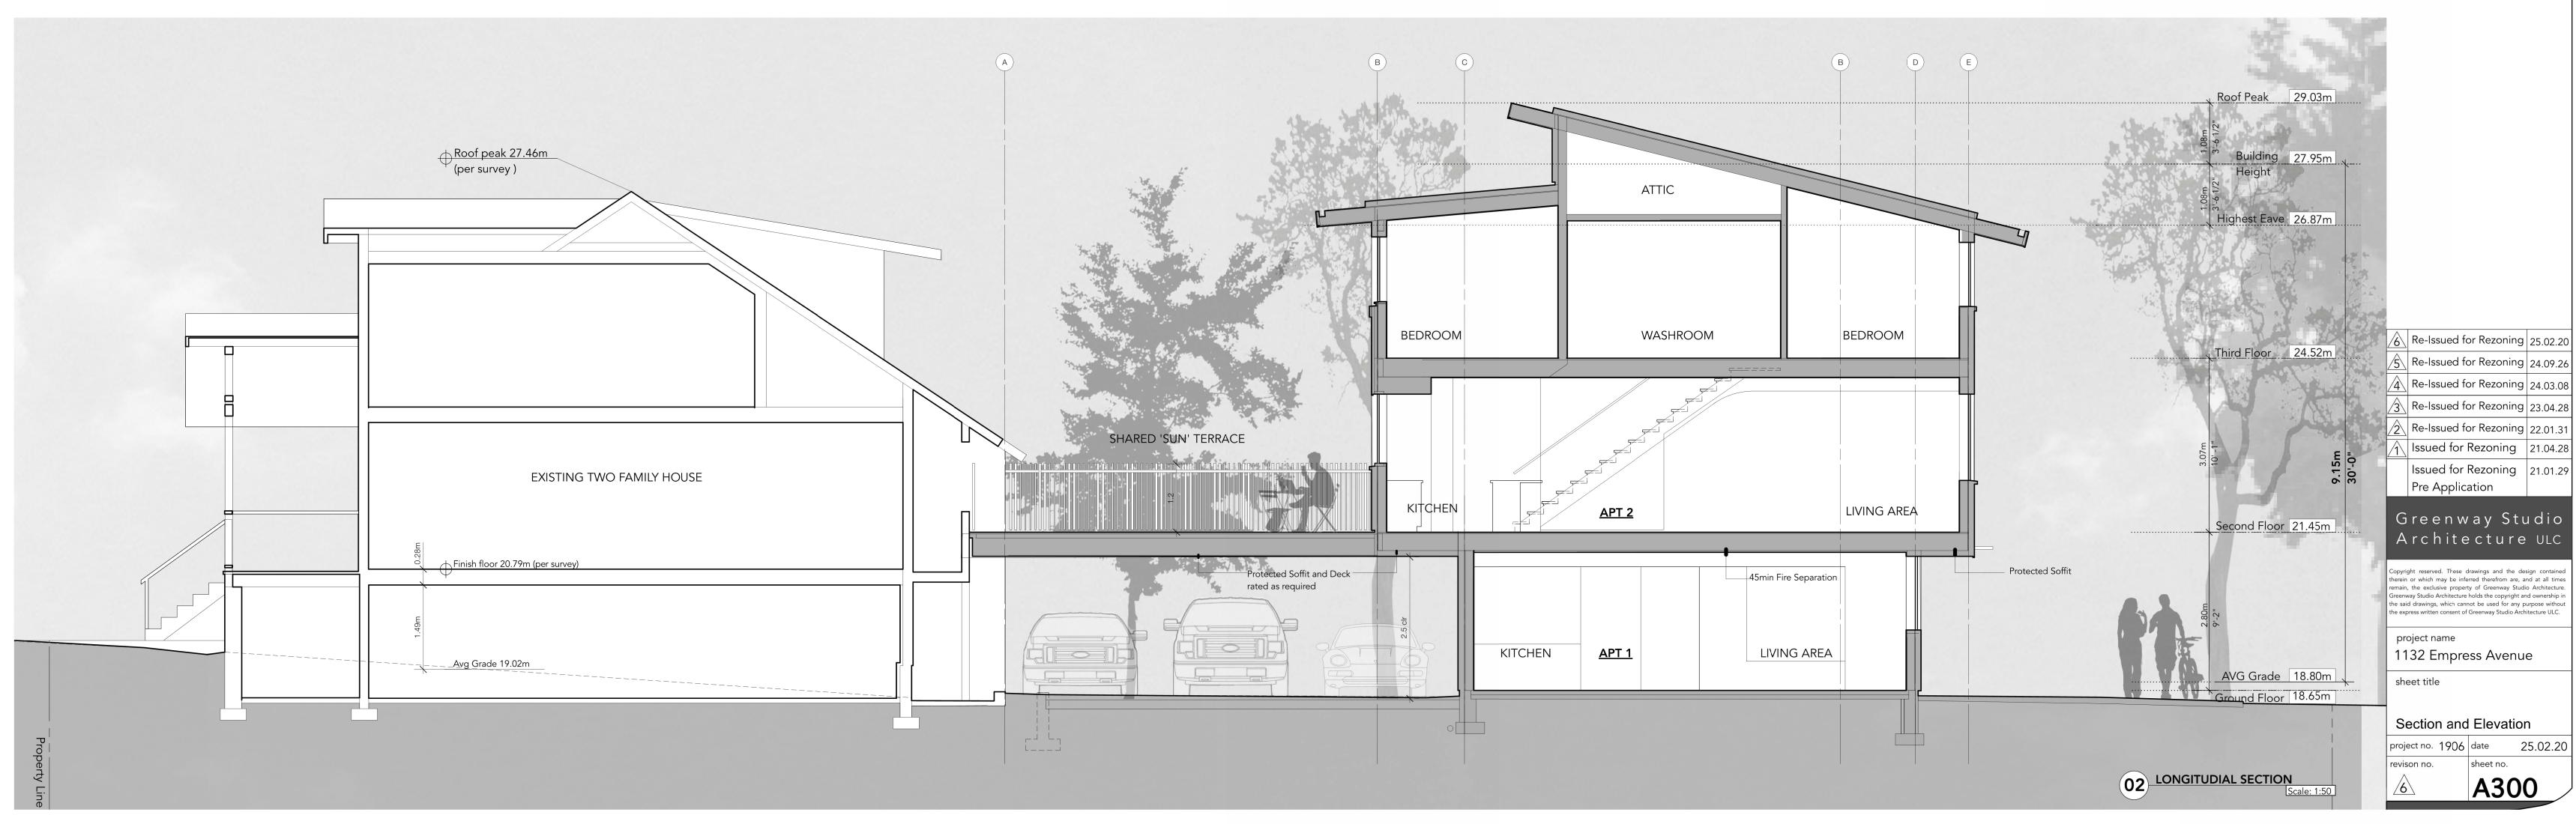
project name 1132 Empress Avenue


sheet title

Third Floor Plan

project no. 1906 date 25.02.20





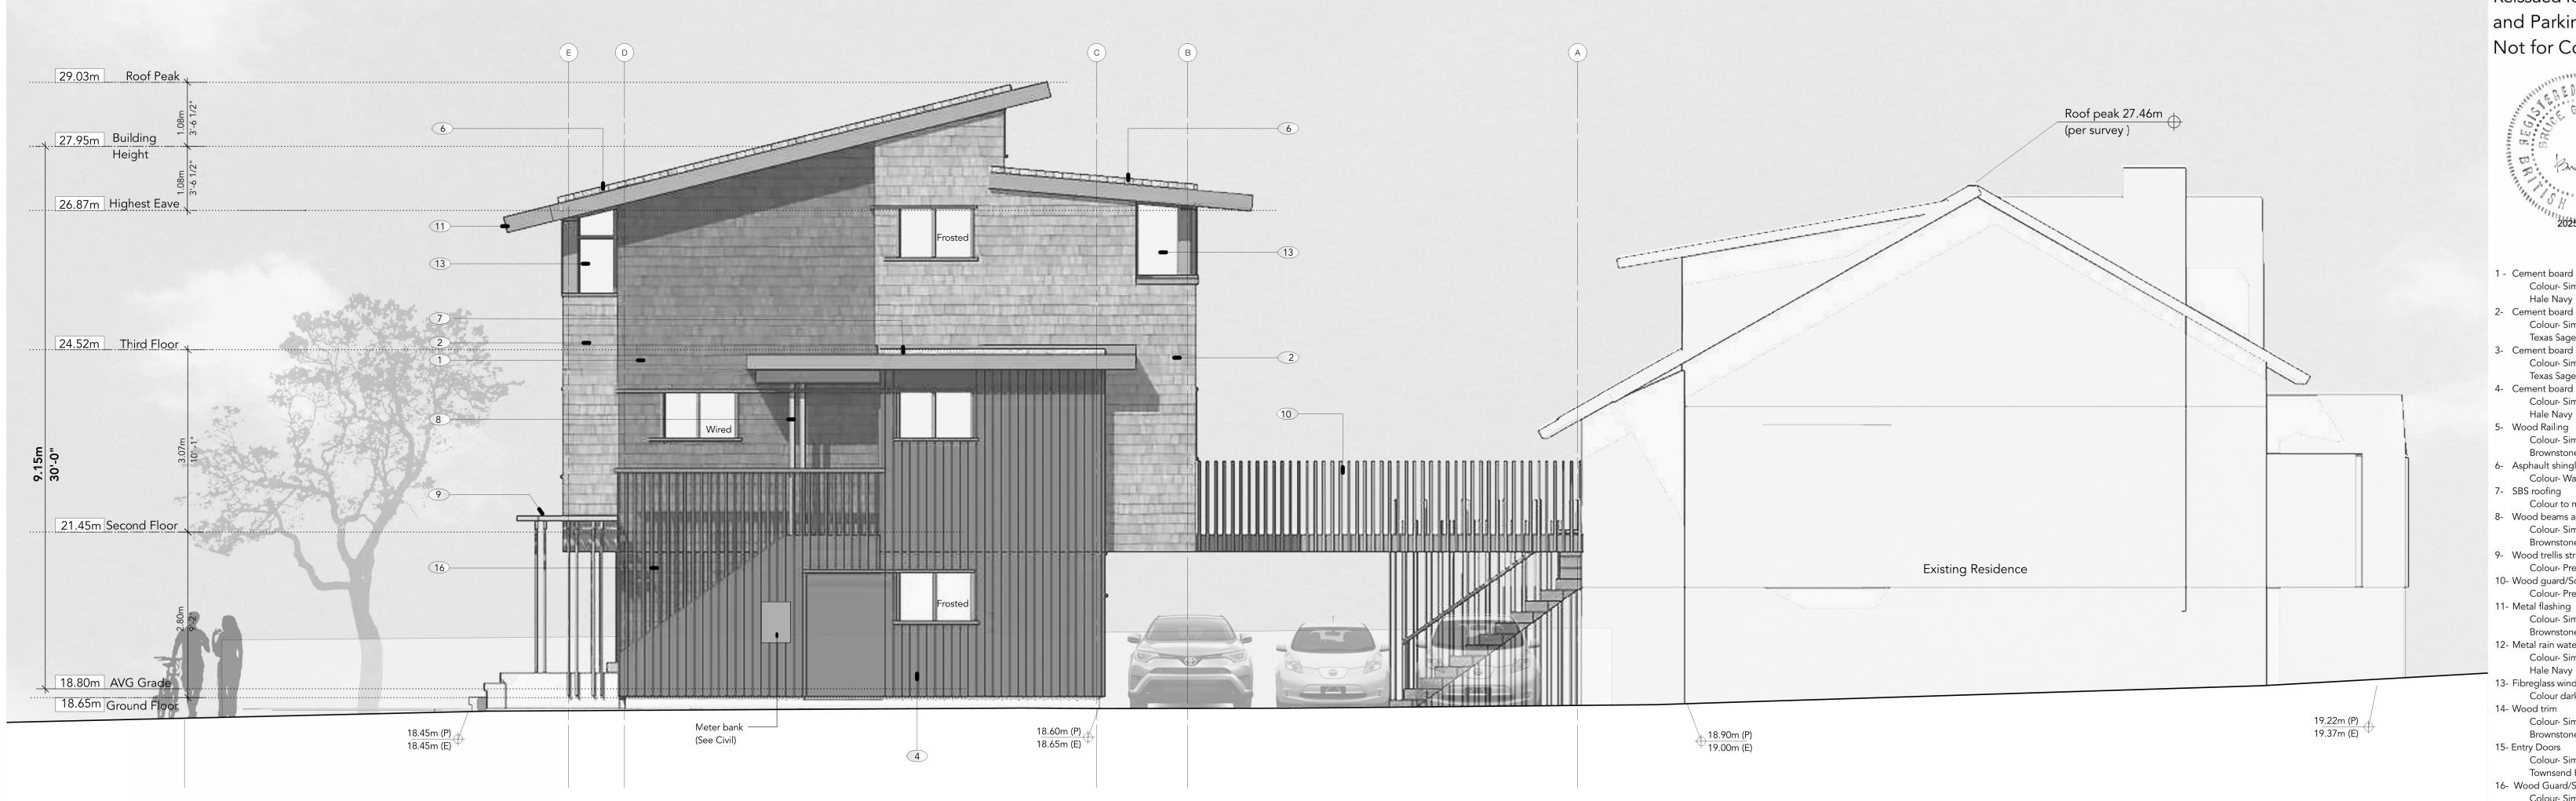

01 WEST ELEVATION

Reissued for Re-Zoning and Parking Variance Not for Construction



- 1 Cement board shingles Colour- Similar to Benjamin Moore
- Colour- Similar to Benjamin Moore
 Hale Navy

 2- Cement board shingles
 Colour- Similar to Benjamin Moore
 Texas Sage

 3- Cement board and batten
 Colour- Similar to Benjamin Moore
 Texas Sage Texas Sage
- 4- Cement board and batten Colour- Similar to Benjamin Moore Hale Navy
- Colour- Similar to Benjamin Moore Brownstone 6- Asphault shingles
- Colour- Warm Grey 7- SBS roofing
- Colour to match shingles 8- Wood beams and column
- Colour- Similar to Benjamin Moore Brownstone
- 9- Wood trellis structure Colour- Pre weathered treatment 10- Wood guard/Screen
- Colour- Pre weathered treatment 11- Metal flashing Colour- Similar to Benjamin Moore Brownstone
- 12- Metal rain water leader Colour- Similar to Benjamin Moore Hale Navy 13- Fibreglass window
- Colour dark bronze 14- Wood trim
- Colour- Similar to Benjamin Moore Brownstone
- 15- Entry Doors Colour- Similar to Benjamin Moore
- Townsend Harbour 16- Wood Guard/Screen
 - Colour- Similar to Benjamin Moore Hale Navy

Re-Issued for Rezoning 25.02.20 Re-Issued for Rezoning 24.09.26

Re-Issued for Rezoning 24.03.08 $|\sqrt{3}|$ Re-Issued for Rezoning 23.04.28

Re-Issued for Rezoning 22.01.31

Issued for Rezoning 21.04.28 Issued for Rezoning 21.01.29

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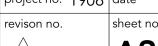
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project name

1132 Empress Avenue

sheet title Elevations


Driveway Profile project no. 1906 date 25.02.20









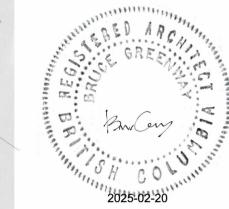

- Cement board shingles Colour- Similar to Benjamin Moore

Hale Navy
- Cement board shingles
Colour- Similar to Benjamin Moore Cement board and batten Colour- Similar to Benjamin Moore

Texas Sage Cement board and batten Colour- Similar to Benjamin Moore Hale Navy

Wood Railing Colour- Similar to Benjamin Moore Brownstone

Asphault shingles Colour- Warm Grey SBS roofing Colour to match shingles

Wood beams and column Colour- Similar to Benjamin Moore **Brownstone** Wood trellis structure

Colour- Pre weathered treatment 0- Wood guard/Screen

Colour- Pre weathered treatment 11- Metal flashing Colour- Similar to Benjamin Moore

Brownstone 12- Metal rain water leader Colour- Similar to Benjamin Moore Hale Navy

13- Fibreglass window Colour dark bronze 14- Wood trim Colour- Similar to Benjamin Moore

Brownstone 15- Entry Doors Colour- Similar to Benjamin Moore

Townsend Harbour 16- Wood Guard/Screen

Colour- Similar to Benjamin Moore Hale Navy

Re-Issued for Rezoning 25.02.20 Re-Issued for Rezoning 24.09.26 A Re-Issued for Rezoning 24.03.08 Re-Issued for Rezoning 23.04.28 $\left| \overline{2} \right|$ Re-Issued for Rezoning $\left| 22.01.31 \right|$

1 Issued for Rezoning 21.04.28 Issued for Rezoning 21.01.29 Pre Application

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project name 1132 Empress Avenue

sheet title

Section and Elevations

project no. 1906 date 25.02.20

A302







NORTH ELEVATION PHOTO- EXISTING
None

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- Re-Issued for Rezoning 25.02.20 Re-Issued for Rezoning 24.09.26 Re-Issued for Rezoning 24.03.08
- $\left| \left| \left| \right| \right|$ Re-Issued for Rezoning 23.04.28 Re-Issued for Rezoning 22.01.31
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project name

1132 Empress Avenue sheet title

Elevation Photos **Existing House**

project no. 1906 date 25.02.20











June 21, 9am June 21, 12 noon

June 21, 3pm

June 21, 6pm

June 21, 6pm Existing Conditions (approx)







Empress Ave

December 21, 9am





December 21, 3pm

01 SUN STUDY

Re-Issued for Rezoning 25.02.20 Re-Issued for Rezoning 24.09.26 Re-Issued for Rezoning 24.03.08 $\sqrt{3}$ Re-Issued for Rezoning 23.04.28 $\overline{2}$ Re-Issued for Rezoning 22.01.31 Ssued for Rezoning 21.04.28 Issued for Rezoning 21.01.29 Pre Application

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project name 1132 Empress Avenue

sheet title

Sun Study

project no. 1906 date 25.02.20







Colour- Warm Grey





4- Cement board and batten Colour- Similar to Benjamin Moore Hale Navy




 Cement board shingles Colour- Similar to Benjamin Moore Hale Navy



Reissued for Re-Zoning

and Parking Variance


Not for Construction

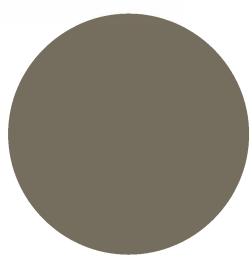

Colour- Similar to Benjamin Moore Texas Sage




Colour pallet inspriation

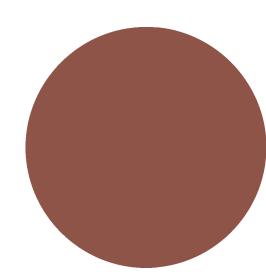


Colour- Similar to Benjamin Moore Hale Navy

Colour- Similar to Benjamin Moore Georgian Brick

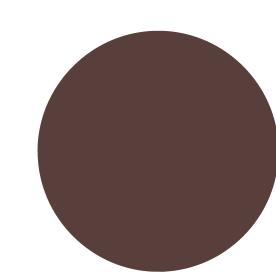



Colour- Similar to Benjamin Moore Townsend Harbour 3- Cement board and batten Colour- Similar to Benjamin Moore Texas Sage

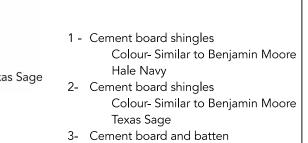

- Colour- Similar to Benjamin Moore Brownstone 4- Cement board and batten Colour- Similar to Benjamin Moore
- Hale Navy 5- Wood Railing Colour- Similar to Benjamin Moore
- Brownstone 6- Asphault shingles Colour- Warm Grey 7- SBS roofing
- 8- Wood beams and column Colour- Similar to Benjamin Moore
- Brownstone 9- Wood trellis structure Colour- Pre weathered treatment
- 10- Wood guard/Screen Colour- Pre weathered treatment 11- Metal flashing
- Colour- Similar to Benjamin Moore Brownstone 12- Metal rain water leader
- Colour- Similar to Benjamin Moore Hale Navy 13- Fibreglass window
- Colour dark bronze 14- Wood trim
- Colour- Similar to Benjamin Moore Brownstone 15- Entry Doors Colour- Similar to Benjamin Moore
- Townsend Harbour Colour and material samples must be

approved before purchase of materials

- Re-Issued for Rezoning 25.02.20 | State | Re-Issued for Rezoning | 24.09.26
- 4 Re-Issued for Rezoning 24.03.08
- Re-Issued for Rezoning 23.04.28
- Re-Issued for Rezoning 22.01.31 \uparrow Issued for Rezoning | 21.04.28 |
- Issued for Rezoning 21.01.29 Pre Application

Greenway Studio Architecture ULC

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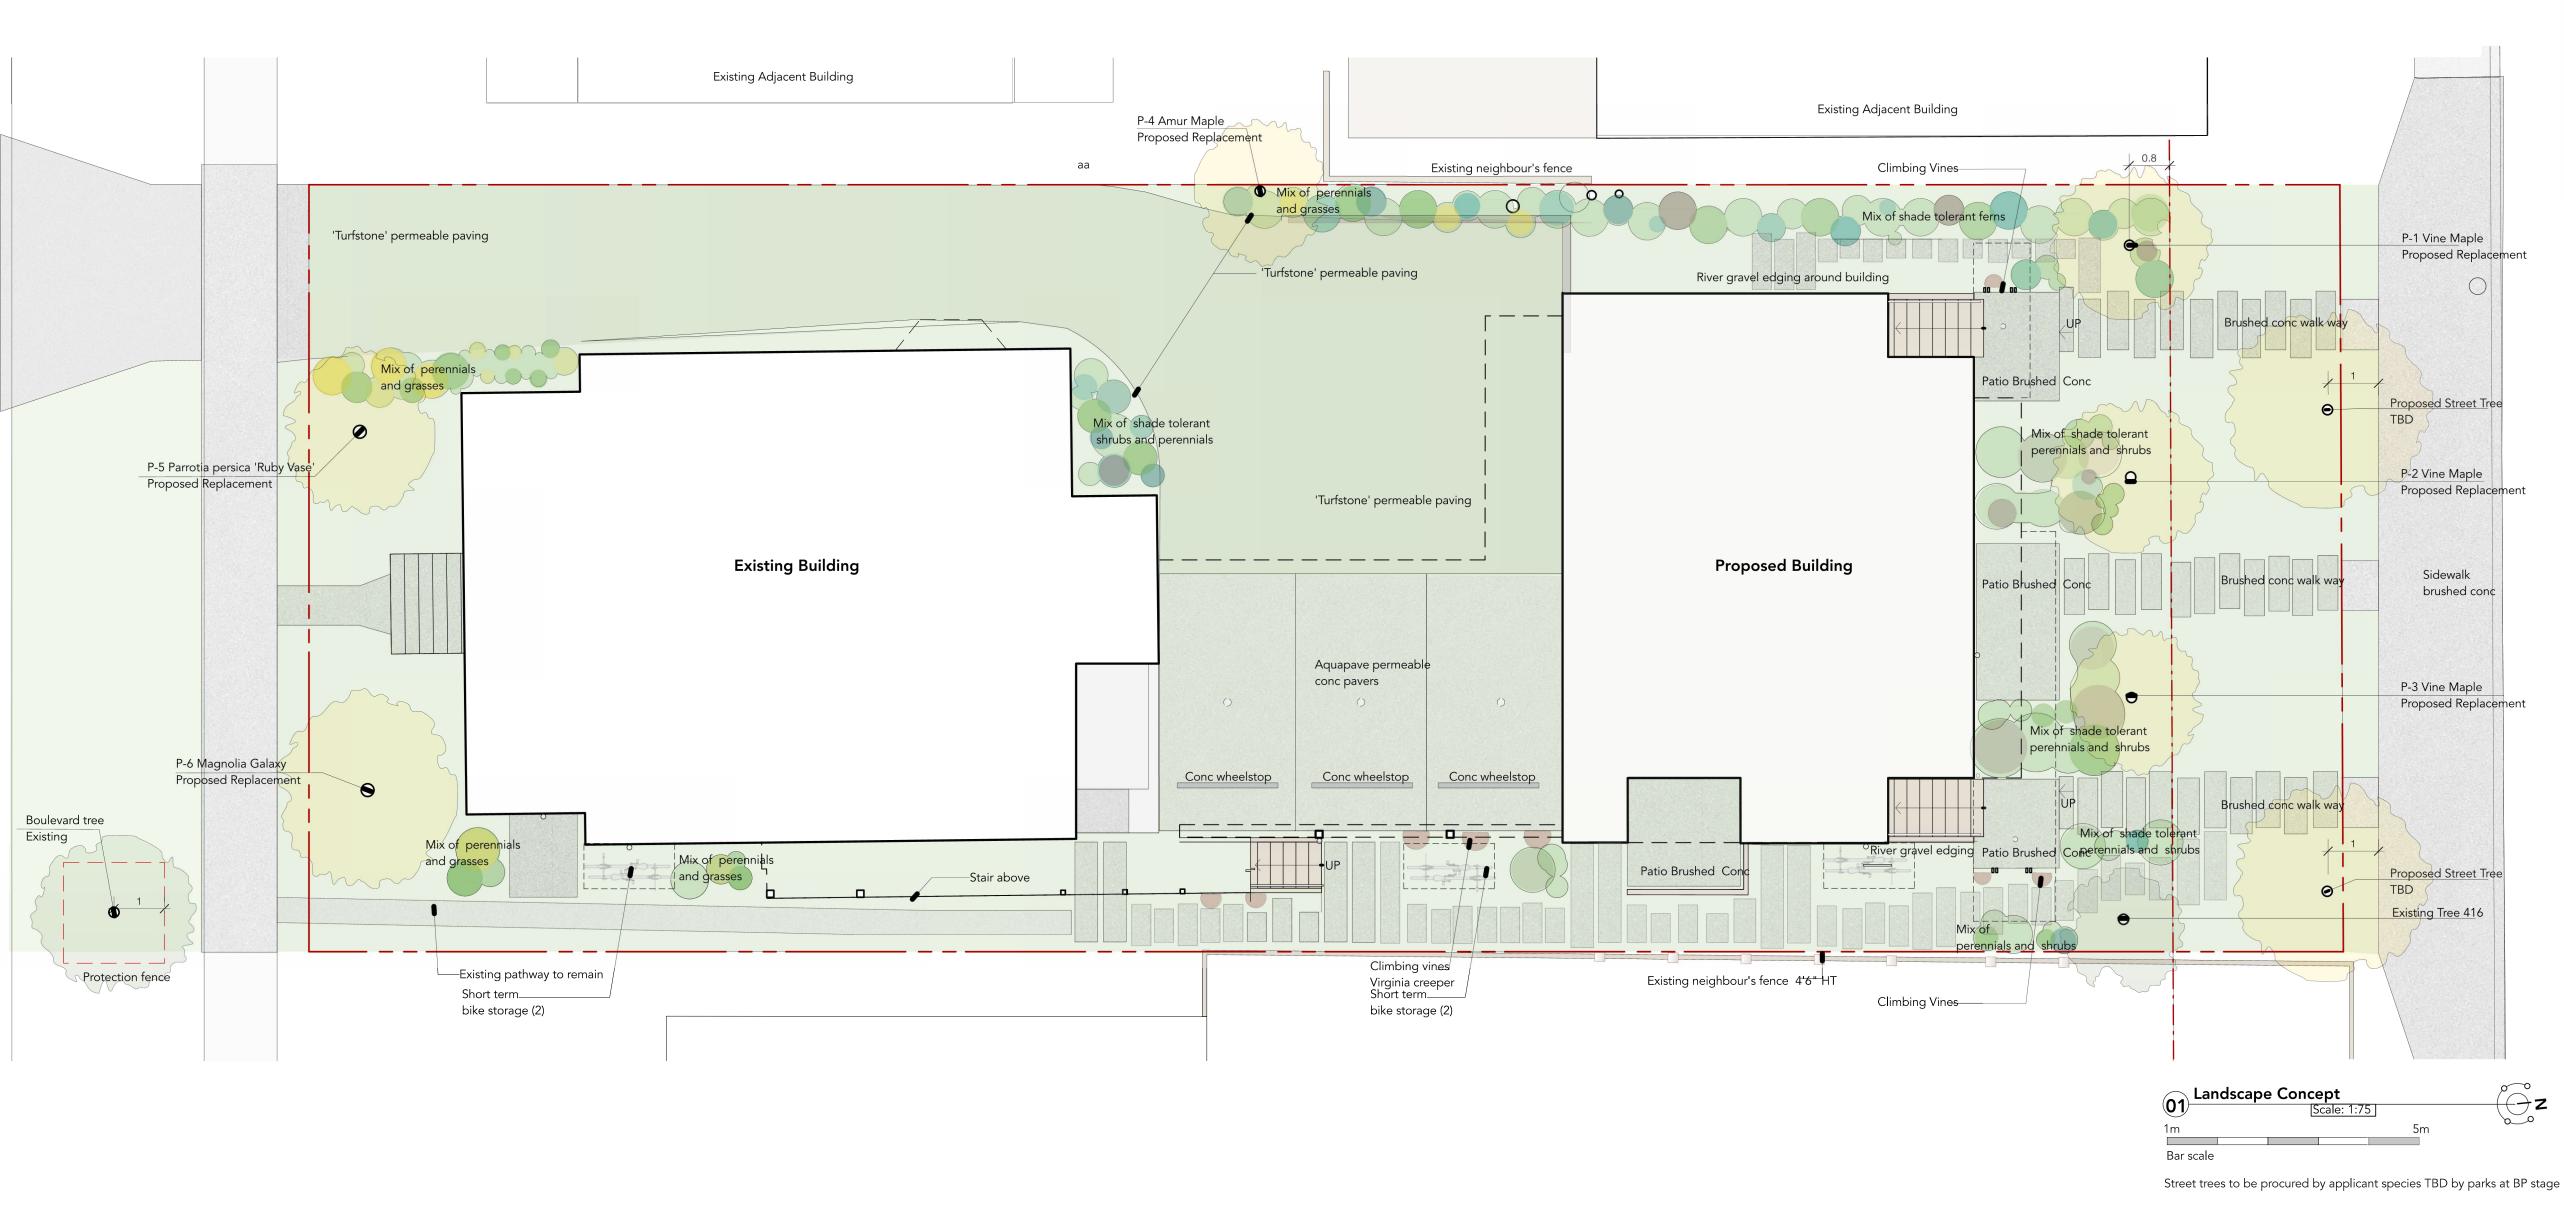
> project name 1132 Empress Avenue

sheet title Materials and


Colour Palette project no. 1906 date 25.02.20

Scale: 1:50

01 MATERIALS





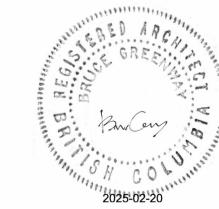

Proposed Street Trees must comply to City of Victoria Supplementary Specifications for Street Trees and Irrigation Schedule C, Bylaw 12-042, Subdivision Bylaw and the current version of the Canadian Landscape Standard. Planting details can be found in Schedule B3-4 or on the approved landscape plan. The following tree inspections by Parks Staff are required by Schedule C. To schedule an inspection please contact Rob Hughes, rhughes@victoria.ca and also copy treepermits@victoria.ca 48 hours prior to the required inspection time. Tree Planting Inspections 1. Excavated tree pits, soil cells, root

2. Trees prior to planting. (Parks staff can inspect trees prior to shipping at local nurseries. Photos can be provided from up-island and mainland nurseries. Tree must meet the spec upon delivery.)

3. Completed planting – tree planting, grate/guard, stakes etc.