

PROJECT LOCATION (NTS)

PROJECT CONTACTS

OWNER

Empresa Properties 204 - 655 Tyee Road Victoria, BC

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ELECTRICAL ENGINEER

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ARCHITECT

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LANDSCAPE ARCHITECT

Biophilia design collective 1608 Camosun St

Contact:Bianca Bodley bianca@biophiliacollective.ca

STRUCTURAL ENGINEER

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Leon Plett, P.Eng., Struct. Eng., MIStructE, LEED® AP lplett@rjc.ca

CIVIL

J.E. Anderson & Associates 4212 Glanford Avenue Victoria, BC 250.727.2214

Contact: Ross Tuck, P.Eng rtuck@jeanderson.com




PROJECT LOCATION (NTS)

SHEET LIST

ATTACHMENT A



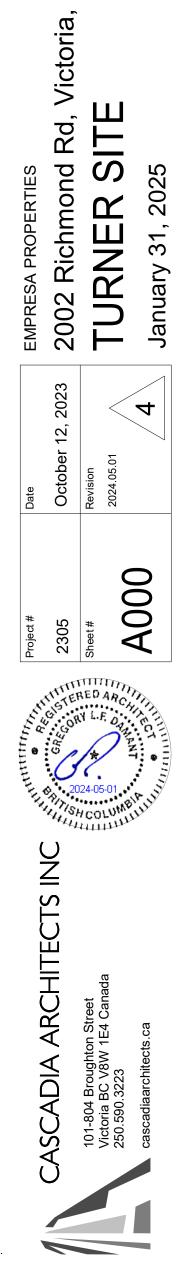

Revisions

Received Date:

February 6, 2025

TORI



1 Street Level View from South on Richmond SCALE = 1:1






2 Street Level View from North on Richmond SCALE = 1:1




4	DP Rezoning Resubmission 2	2024.05.01
3	DP Rezoning Resubmission	2024.02.09
2	DP Rezoning Submission	2023.10.12
1	Development Tracker	2023.08.04
NO.	DESCRIPTION	DATE





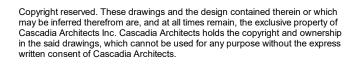

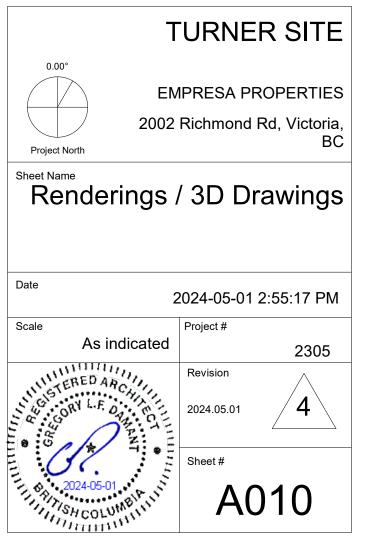




Birch-North Corner View SCALE = 1:1 1






2 Birch Street Residential Entry SCALE = 1:1

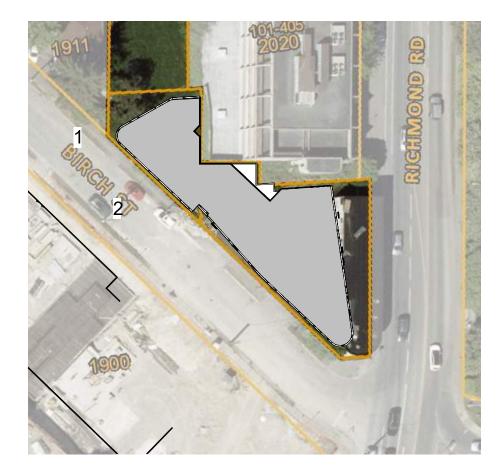


4	DP Rezoning Resubmission 2	2024.05.01
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1 Birch Street Elevation - Context SCALE = 1:200

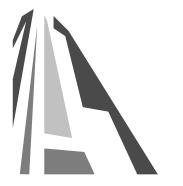

1900 Richmond Rd (Amica Jubilee House)

2002 Richmond Rd

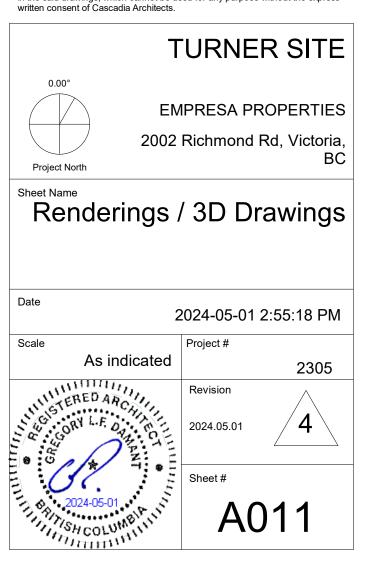2 Richmond Context Building Elevations SCALE = 1:200

2022 Richmod Rd Ryal Jubile Green

3 Context Section through birch street SCALE = 1:200 2002 Richmond Rd

2020 Richmond Rd



4 Context Section through richmond road SCALE = 1:200









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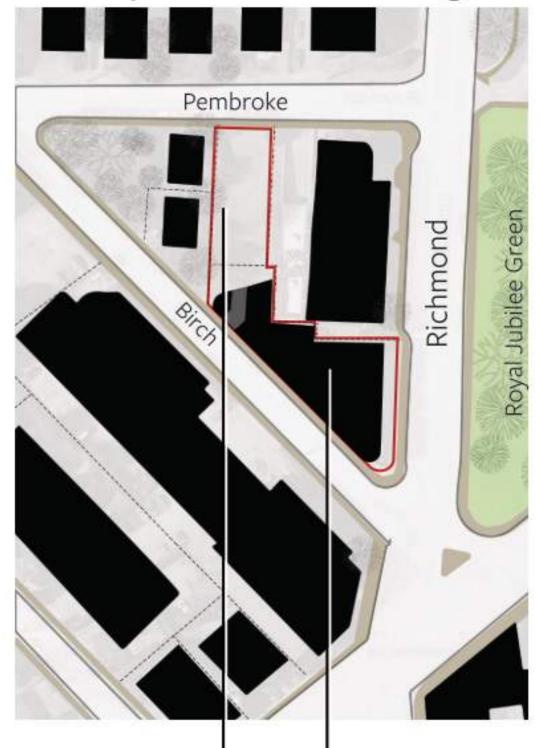






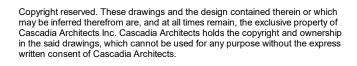


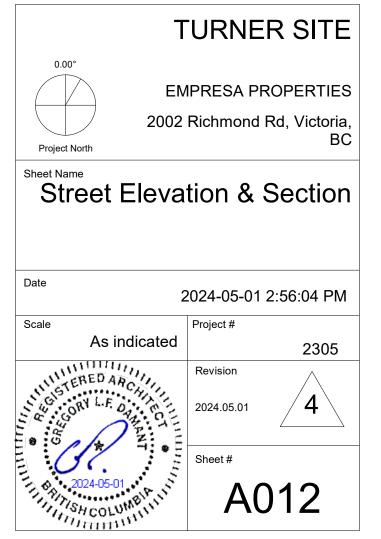Layout of the Buildings



Transitional Condition -Preserve un-buildable north lot for future development, proposed to be used as a land bank in the interim.

Urban Condition -Concentrate the 6 storey building on the village side.

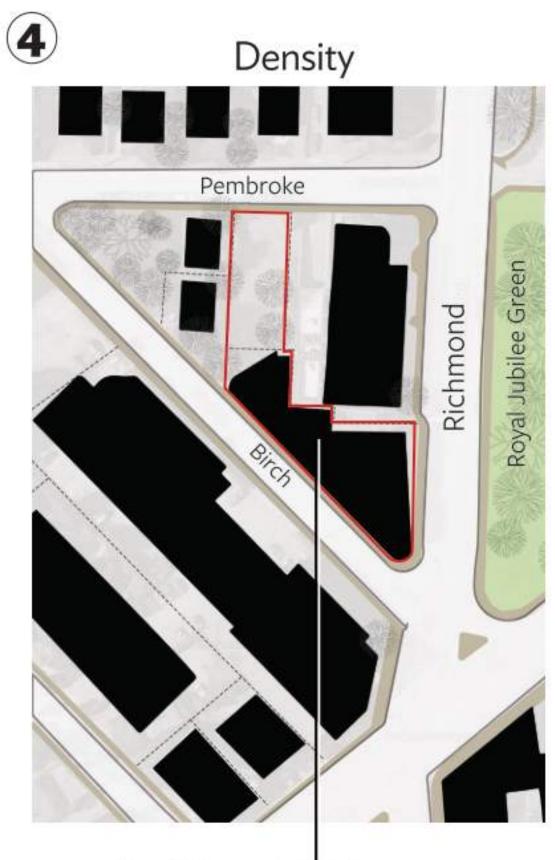




Density is a product of site geometry and OCP height vision of 6 storeys for an urban residential site.




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(5)

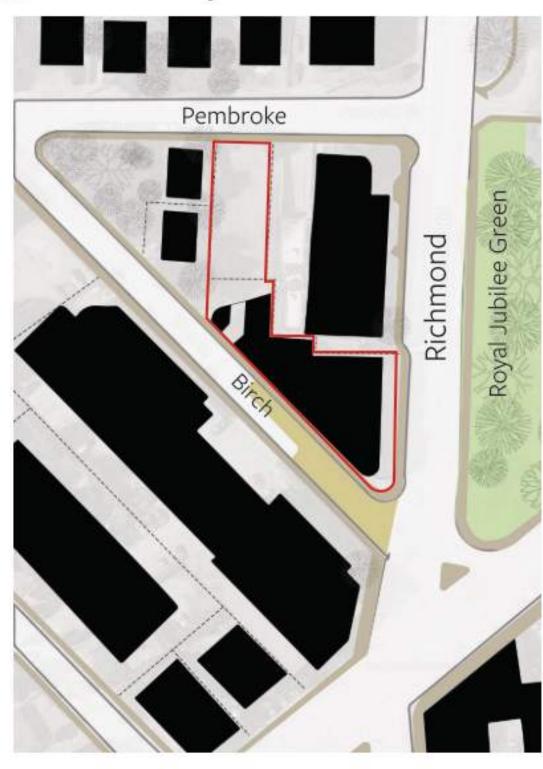

2 Future of the Neighbourhood

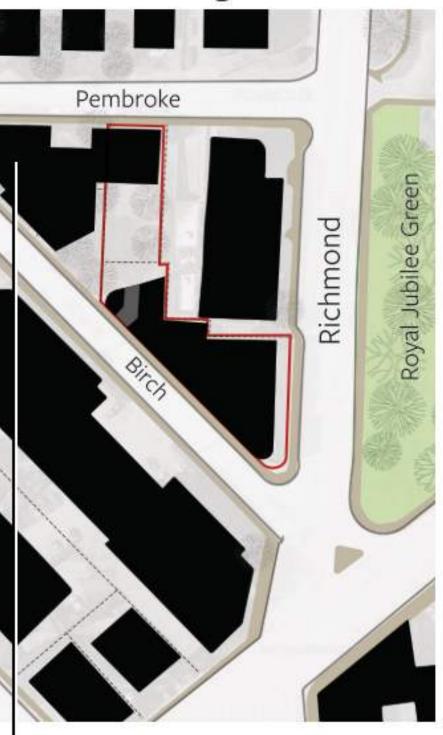


Transitional Condition - Future buildings could transition from the urban condition to the single family houses to the north across pembroke.

NOTE: West properties are under seperate ownership and the future of those sites is


Project Priorities

Forming part of Jubilee village, the introduction of a pedestrian plaza at the southern end of Birch street will provide a destination public space for the neighbourhood. The Turner family has been associated with this site for over 100 years, and the plaza is proposed to carry their name.

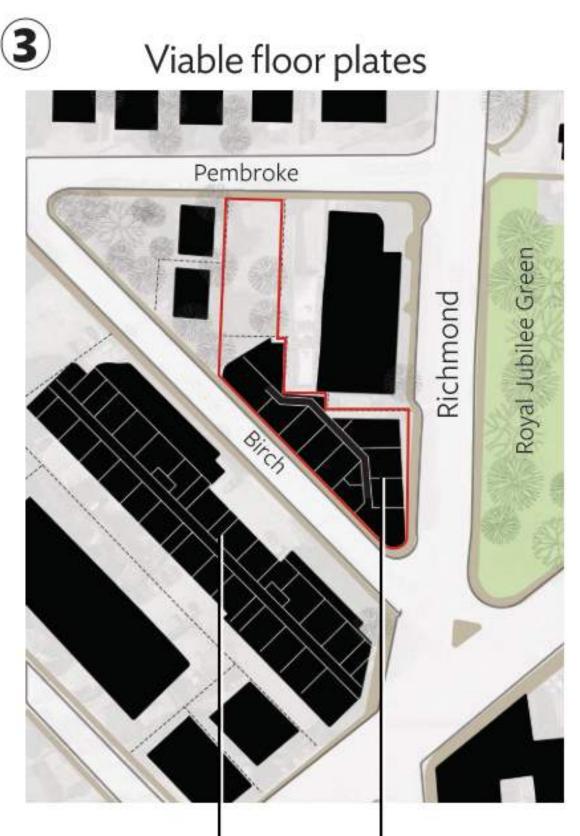

Conventional residential building layout on a typical city lot. - Setbacks are possible


Constrained layout on compressed triangular site pushes the building to the property lines.

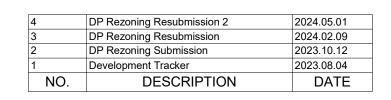






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Massing Logic Step 1 Site Constraints

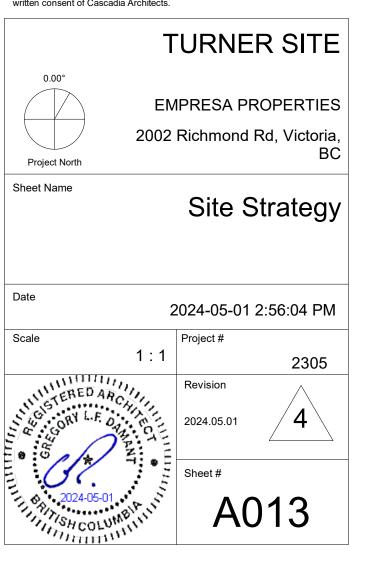- Transitional Condition Preserve un-buildable north lot for future development, proposed to be used as a land bank in the interim.
- FSR : OCP 2:1
 Proposed 2.95:1

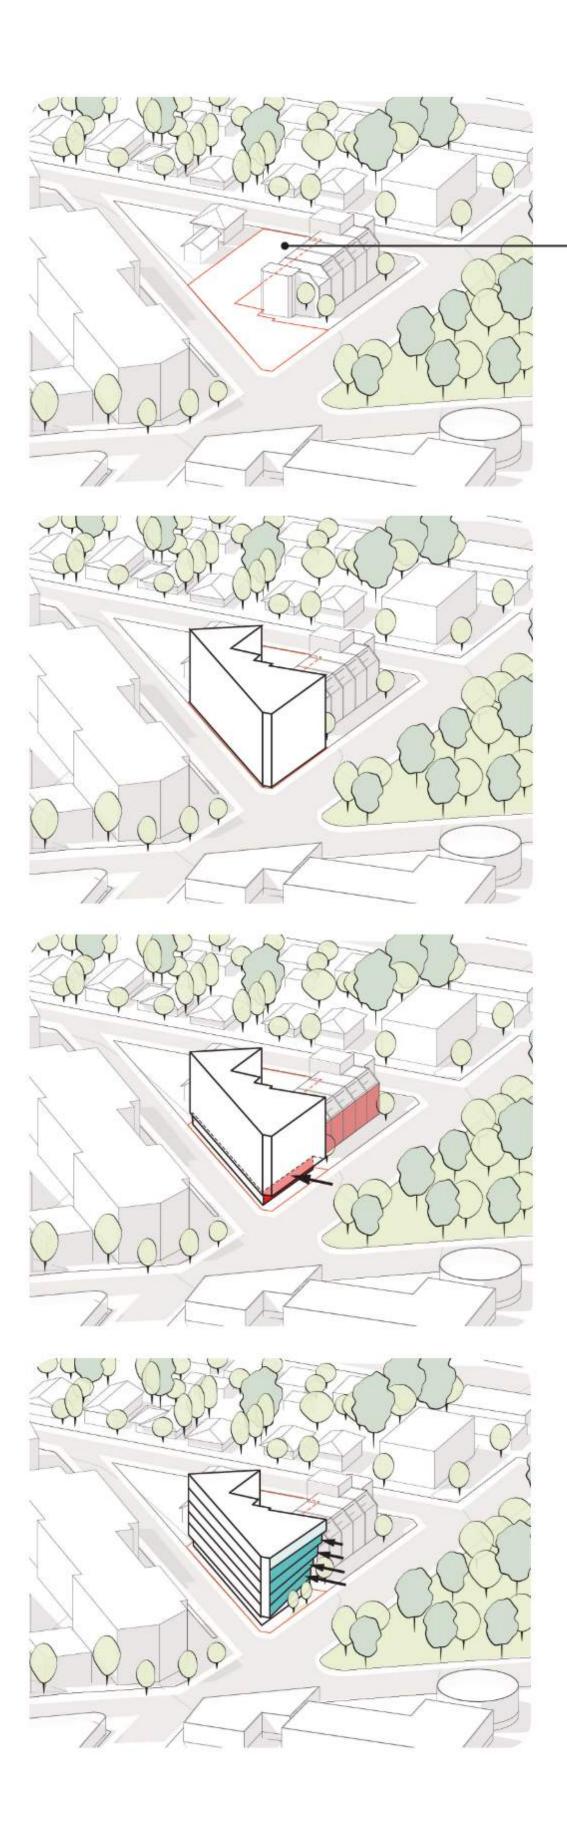Massing Logic Step 2 Massing


- Urban Condition Concentrate the 6 storey building on the village side.
- . Constrained layout on compressed triangular site pushes the building to the
- property lines.

Massing Logic Step 3 Relief

 Align ground-floor setbacks with neighbouring buildings

Massing Logic Step 4 Extension

 The architectural design features floor plates that fan from adjacent street wall to street edge.

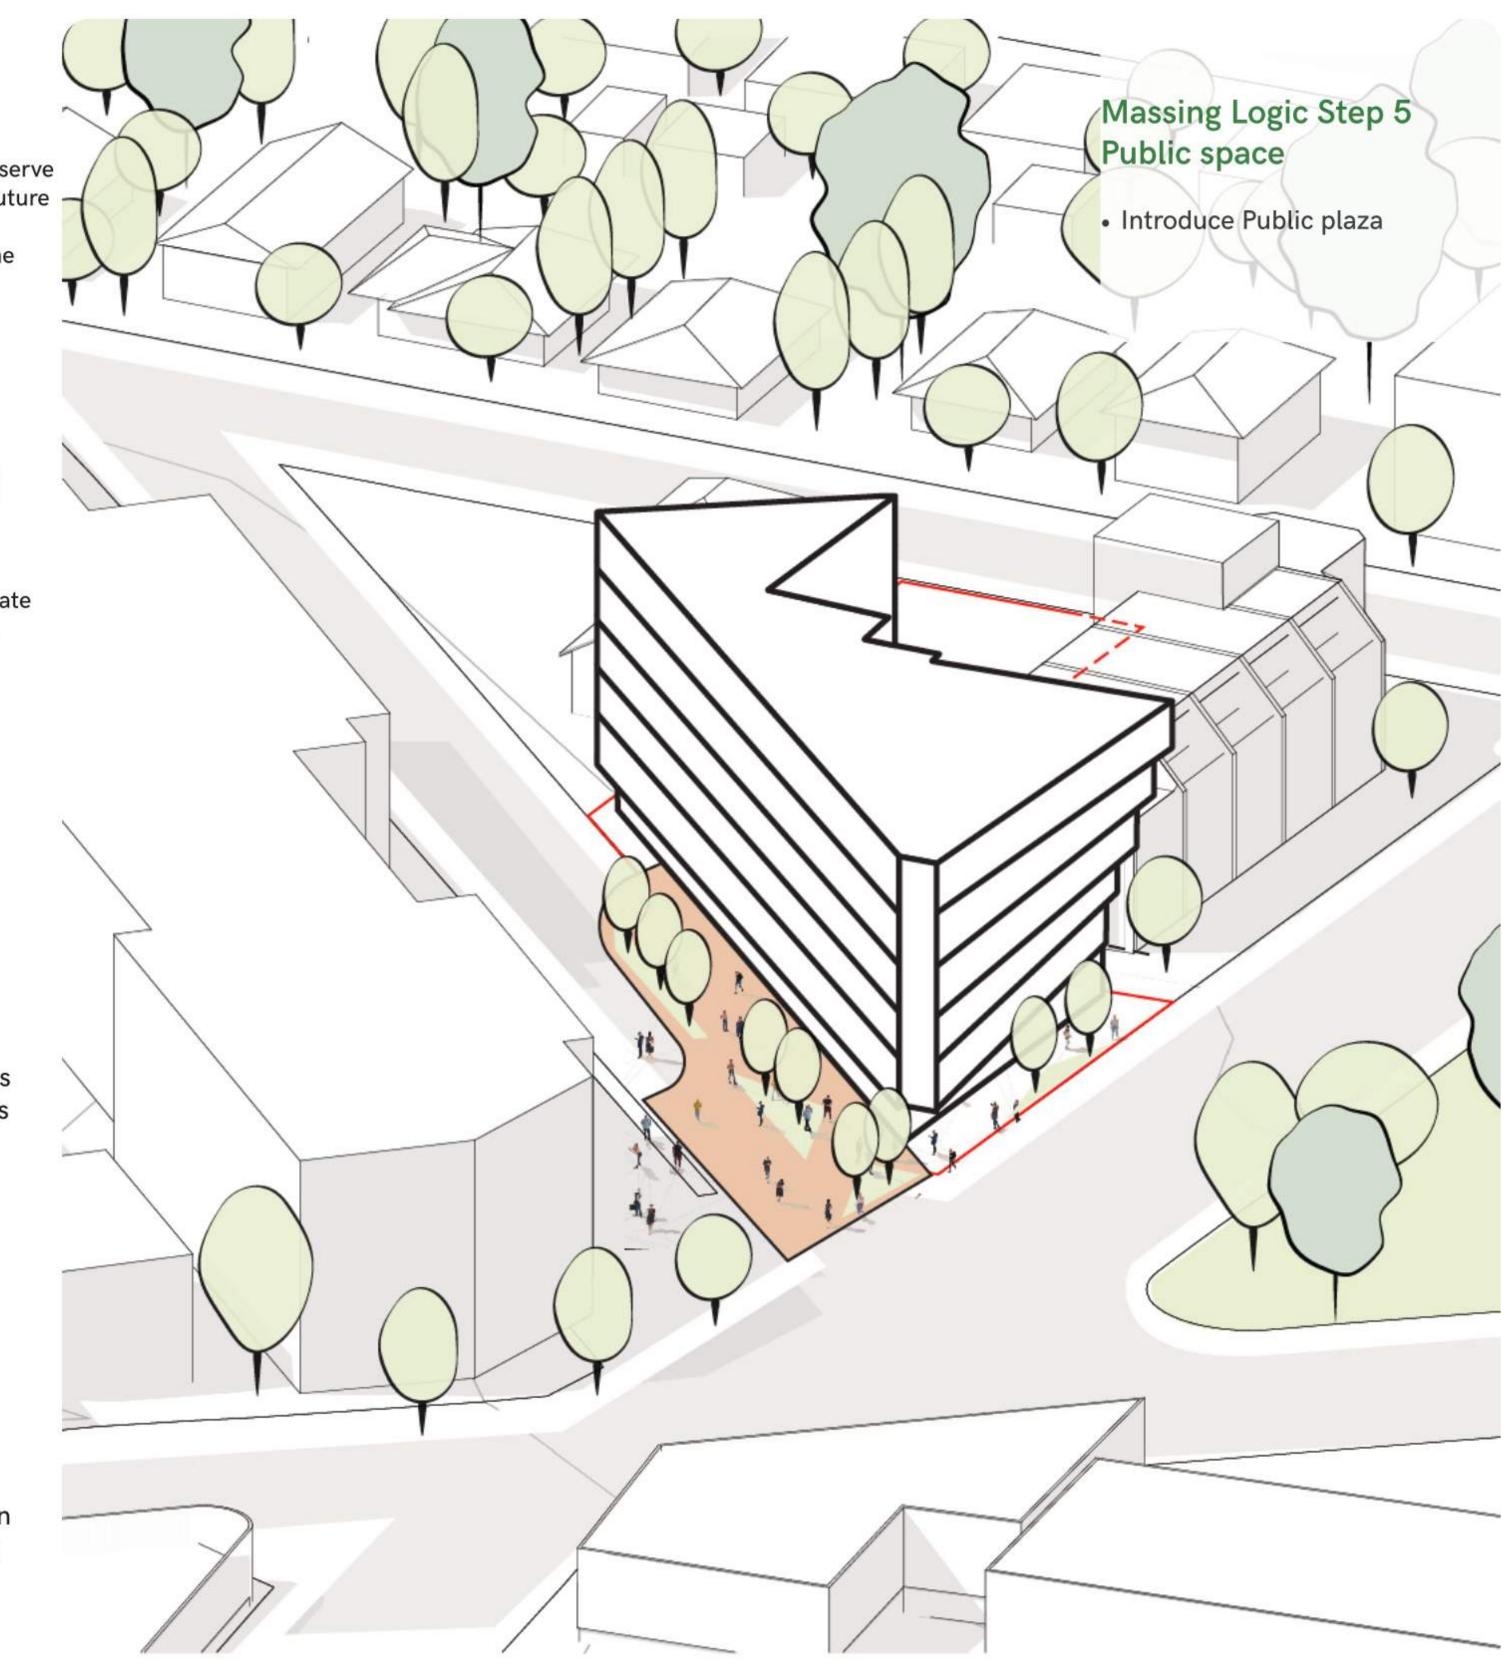

2	DP Rezoning Resubmission DP Rezoning Submission	2023.10.12
1	Development Tracker	2023.08.04
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TURNER SITE


2002 Richmond Rd, Victoria, BC

Massing Diagram


Date 2024-05-01 2:56:04 PM Scale 1 : 1 2305 Revision 2024-05-01 4 Sheet # AQ014

Sheet Name

Birch street pedestrian plaza is proposed as a joint effort between Empresa Properties and the City of Victoria. A conventional frontage improvement is shown on the left, and the public plaza is shown on the right. Refer to the cost sharing proposal in the Letter to the Mayor from Empresa properties, accompanying this application

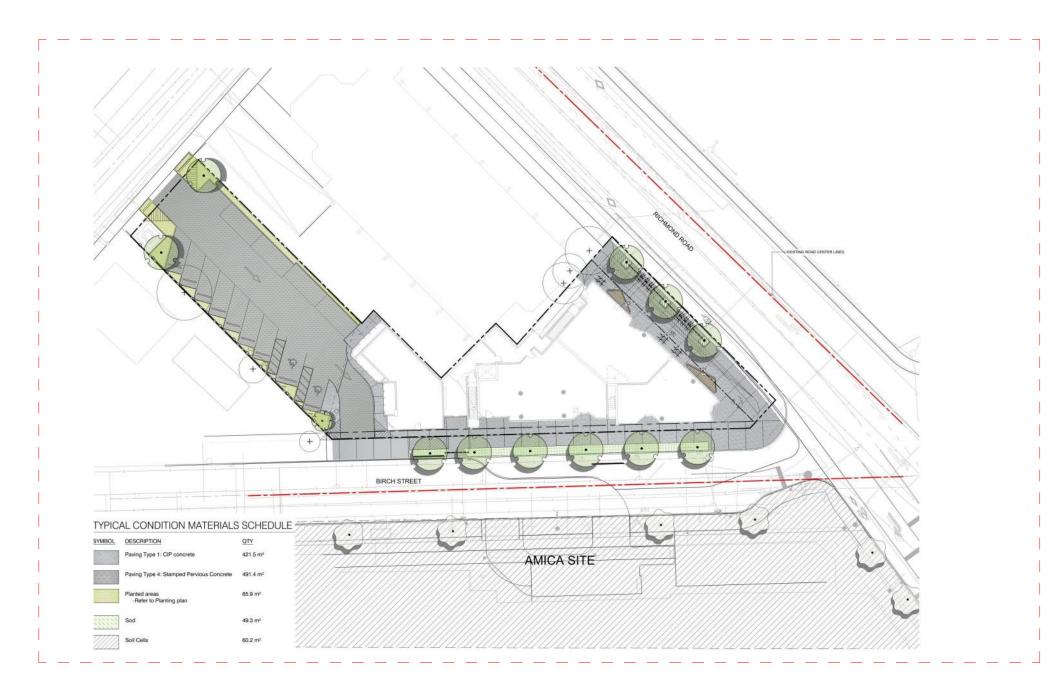


Conventional frontage improvements to centreline of R.O.W, per City of Victoria standards.

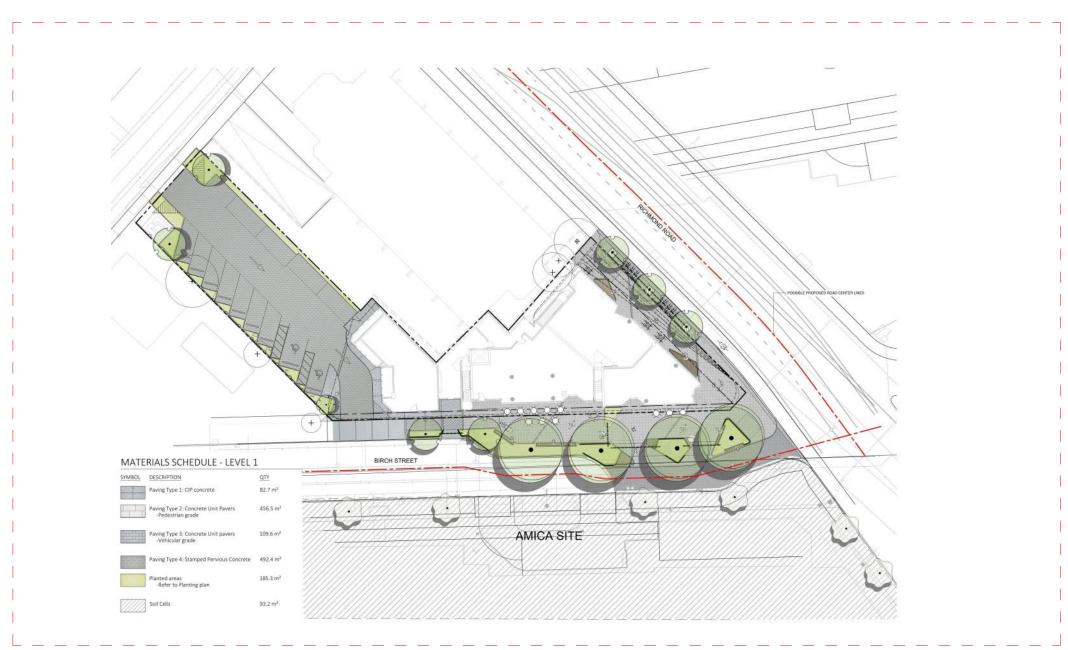

Birch street closure and conversion to public plaza. This design represents on-going collaboration between the applicant and the City of Victoria. Design is subject to change through the ongoing collaborative process.



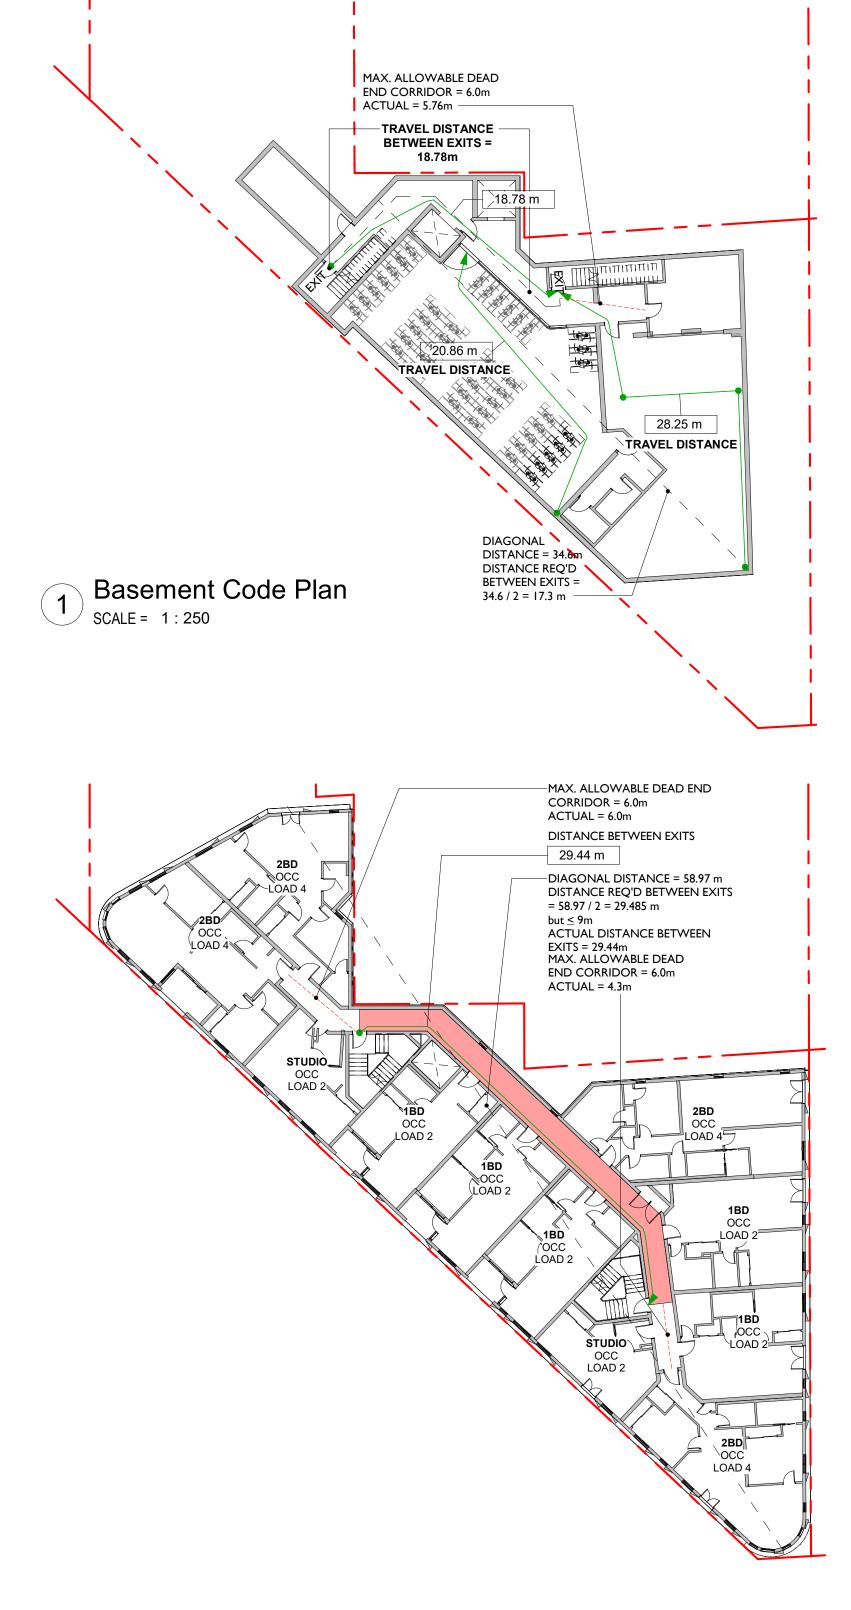

<u>Basement</u>

Req. Separation of Exits: 17.3 m but does not need to be more than 9m Max. Travel: 45 m (3.4.2.5.1.(c))

Occupancy: F, Div. 3 - Storage Occupant Load

Net Area: (102.55 + 119.27) m² (Bike + commercial storage) = 221.82 m² Storage : 46 m²/person (BCBC 3.1.17.1) $221.82 \text{ m}^2/46 = 5 \text{ people}$

Min. Exit Width <u>Ramps, Corridors, Passageways</u> 6.1mm/person x 5 = 30.5 mm or >1100 mm (Table 3.4.3.2.-A)

<u>Stairs</u> 8mm/person x 5 = 40 mm or >1100 (Table 3.4.3.2.-A)




Req. Separation of Exits: 29.5m Occupancy: GROUP C - RESIDENTIAL


Occupant Load Net Area: 829.356 m² 830/30 = 28 people (3.1.17.1.(1)(b))

Min. Exit Width Ramps, Corridors, Passageways 6.1mm/person x 28 = 170.8mm or >1100 (Table 3.4.3.2.-A)

<u>Stairs</u> 8mm/person x 28 =224mm or >1100 (Table 3.4.3.2.-A)

3 Level 6 Code Plan (Typical Residential Floor) SCALE = 1:250

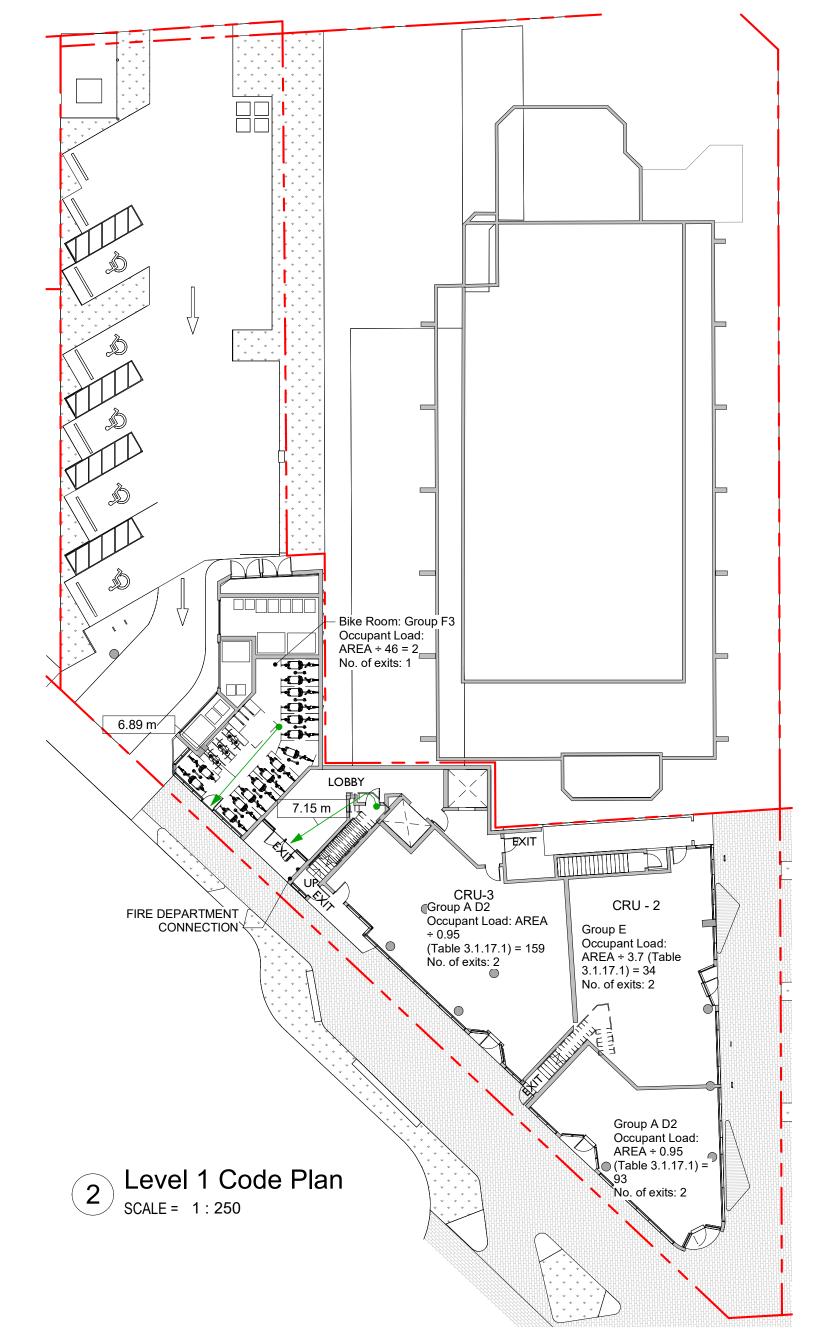

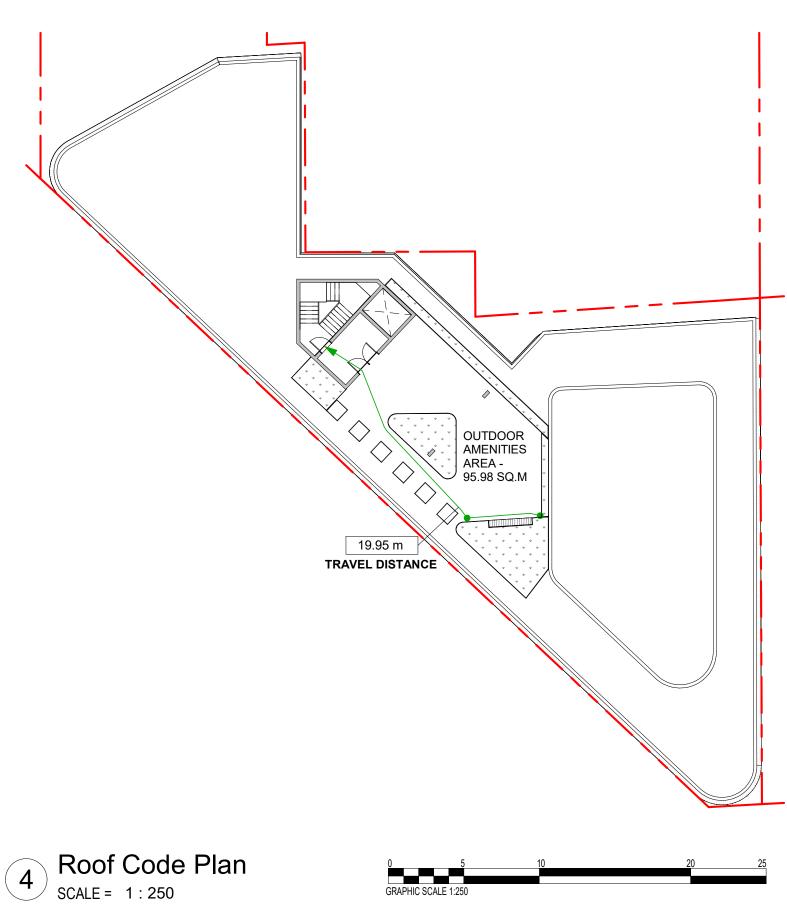

GROUND FLOOR

Max. Travel: 40m (3.4.2.5.1.(b))

Occupancy:	CRU 1 -	A2
	CRU 2 -	Е
	CRU 3 -	A2
	BIKE ROOM	1 - F3

Occupant Load

CRU 1 -Area= 87.96 m²

0.95 m²/person for Space with tables and seating (BCBC 3.1.17.1) Load= 87.96 m² ÷ 0.95 = 93 people

CRU 2 -Area= 123.98 m² 3.7 m²/person for Space with tables and seating (BCBC 3.1.17.1) Load= 123.98 m² ÷ 3.7= 34 people

CRU 3 -Area= 150.76 m²

0.95 m²/person for Space with tables and seating (BCBC 3.1.17.1) Load= $150.76 \text{ m}^2 \div 0.95 = 159 \text{ people}$

Bike room:

Area= 88.04 m² 46 m²/person for Space with tables and seating (BCBC 3.1.17.1) Load= 88.04 m² ÷ 46= 2 people

ROOF LEVEL

Travel Distance: 19.95 Max. Travel: 25m (3.3.1.5.1.(d))

Occupancy: A, Div. 2 - ROOFTOP AMENITIES

Occupant Load Net Area: 95.98 m²

space with non-fixed seats and tables: 0.95 m²/person (BCBC 3.1.17.1) 95.98/0.95 = 101.03 people (Limiting rooftop amenity acess to 60 people) Min. Exit Width


<u>Stairs</u> 8mm/person x 60 = 480mm or >1100 (Table 3.4.3.2.-A)

BUILDING CODE ANALYSIS		
PROJECT TYPE	NEW CONSTRUCTION RENOVATION ADDITION	
GOVERNING BUILDING CODE	2018 BC BUILDING CODE PART 3	REFER TO NOTES *
MAJOR OCCUPANCIES	A1 A2 A3 A4 B1 B2 C D E F1 F2 F3	3.1.2.1.
BUILDING AREA	920.81 m ² (Outside face of Exterior Walls)	Div A 1.4.1.2.
GRADE	21.74 m	Div A 1.4.1.2.
BUILDING HEIGHT (STOREYS, m)	6 STOREYS ABOVE GRADE 24.1 m 1 STOREYS BELOW GRADE	Div A 1.4.1.2.

BUILDING FIRE SAFETY & CONSTRUCTION CLASSIFICATION		
CLASSIFICATION	GROUP C, 6 STOREYS, SPRINKLERED	3.2.2.50
MAXIMUM BUILDING AREA	1500 m ²	3.2.2.50
NUMBER OF STREETS FACING	3	3.2.2.10
CONSTRUCTION TYPES PERMITTED	COMBUSTIBLE 🗸 NON - COMBUSTIBLE 🗸	3.2.2.50.
INTERCONNECTED FLOOR SPACE	YES NO	3.2.8.

EXITS FROM FLOOR AREAS		
NUMBER OF EXITS REQUIRED	2	3.4.2.1.
SEPERATION OF EXITS (MIN.)	ONE HALF MAXIMUM FLOOR AREA DIAGONAL, BUT NO MORE THAN 9 m	3.4.2.3
MAX. TRAVEL DISTANCE ALLOWED	GROUP C 45 m	3.4.2.5
MEZZANINE	YES NO 🗸	3.2.8.

FIRE RESISTANCE RATINGS		
HORIZONTAL SEPARATIONS	I hrs FLOORS NA MEZZANINE I hrs ROOF (OCCUPIED)	3.2.2.50.(2)
	2 hrs BETWEEN GROUP E AND GROUP C	
	LOADBEARING STRUCTURE IMMEDIATELY BELOW A FLOOR OR ROOF ASSEMBLY SHALL HAVE A FIRE RESISTANCE RATING NOT LESS THAN THAT REQUIRED FOR THE SUPPORTED FLOOR OR ROOF.	
BETWEEN SUITES	Ihrs RESIDENTIAL SUITES	3.3.1.1.
	2hrs GROUP E AND GROUP A2/C	3.4.4.1.
EXITS	Ihrs 2hrs UP TO LEVEL 2	3.4.4.1.

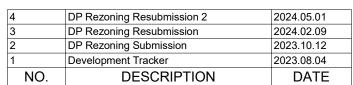



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Т	URNER SITE
0.00°	
EM	IPRESA PROPERTIES
2002	Richmond Rd, Victoria, BC
Project North	bC
heet Name	Code Data
ate 2	2025-01-31 2:51:33 PM
cale	Project #
As indicated	2305
ILLERED AAO	Revision
NORVLE OT	2024.05.01
.07.	Sheet #
2025-01-31 1, 0, 2025-01-31 1, 1, 1, 1, 1, 1, 1, 1, 1, 1, 1, 1, 1, 1	A050
2025-01-31	A050



RICHMOND RD (East) ELEVATION (1 SCALE = 1 : 250

45 min



COMBUSTIBLE / NON- Noncombustible

COMBUSTIBLE

TABLE 3.2.3.1.-D (BCBC 2018)

BUILDING COMPARTMENT LIMITING DISTANCE


0	.97 m
0	.97 m

TABLE 3.2.3.7 (BCBC 2018)

ALL COMPARTMENTS MIN. FIRE RESISTANCE RATING: 45 MIN TYPE OF CONSTRUCTION REQ'D: COMBUSTIBLE/ TYPE OF CLADDING REQ'D: NONCOMBUSTI

AR



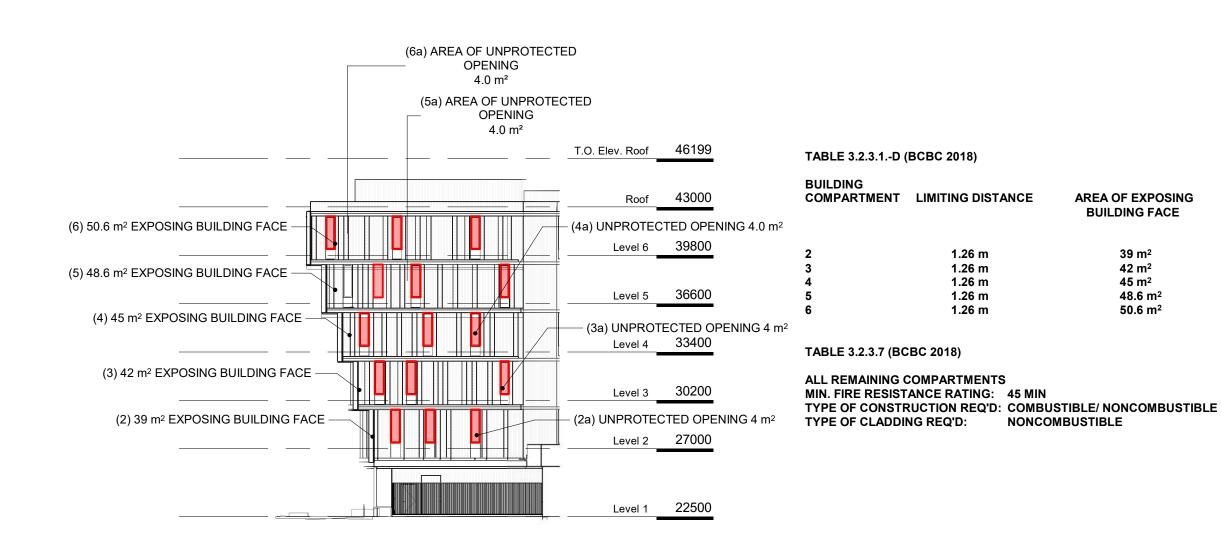


5 NORTH FACING ELEVATION FROM 2020 RICHMOND SCALE = 1:250



<u>TABLE 3.2.3.1 D</u>	LIMITING DISTANCE (m)	ALLOWABLE OPENINGS (%)	AREA OF EXPOSING BUILDING FACE (sq.m)	PROPOS OPENIN (sq.m
	7.62m	75.92%	1223	442.9
<u>TABLE 3.2.3.7</u>	REQUIRED FRR	REQUIRED TYPE OF CONSTRUCTION	REQUIRED TYPE OF CLADDING	
	45 min	COMBUSTIBLE / NON COMBUSTIBLE	- Noncombustible	
2 BIRCH ST ELEVA SCALE = 1 : 250	TION			

					 	T.O. Elev. Roof 46199	TABLE 3.2.3.1D	(BCBC 2018)					
AREA OF EXPOSING BUILDING FACE	ALLOWABLE OPENINGS (%)	PROPOSED OPENIN (SQ.M)	G PROPOSED OPENING (%)			Roof 43000	BUILDING COMPARTMENT	LIMITING DISTANCE	AREA OF EXPOSING BUILDING FACE	ALLOWABLE OPENINGS (%)		ENING PROPOSED OPENING (%)	
NO EXPO	SURE TO PROPERT	Y LINE		(6a) 0.8 m ² UNPROTECTED OPENING —		- (6) 40.2 m ² EXPOSING BUILDING FACE							
38.5 m ² 38.5 m ²	11.32% 11.32%	1.1 1.1	10.5% 10.5%			Level 6 39800	2 3	0.68 m 0.68 m	40.2 m ² 40.2 m ²	7.93% 7.93%	0.8 0.8	2% 2%	
38.5 m² 38.5 m² 38.5 m²	11.32% 11.32% 11.32%	1.1 1.1 1.1	10.5% 10.5% 10.5%	(5a) 0.8 m ² UNPROTECTED OPENING —		- (5) 40.2 m ² EXPOSING BUILDING FACE Level 5 <u>36600</u>	4 5 6	0.68 m 0.68 m 0.68 m	40.2 m ² 40.2 m ² 40.2 m ²	7.93% 7.93% 7.93%	0.8 0.8 0.8	2% 2% 2%	
				(4a) 0.8 m ² UNPROTECTED OPENING —		- (4) 40.2 m ² EXPOSING BUILDING FACE	TABLE 3.2.3.7 (B	CBC 2018)					
				(3a) 0.8 m ² UNPROTECTED OPENING —		– (3) 40.2 m² EXPOSING BUILDING FACE Level 3 30200		TANCE RATING: 45 MIN			4 DF	PRezoning Resubmission 2	2024.05.01
BLE/ NONCOMBUSTIBLE USTIBLE							TYPE OF CONST TYPE OF CLADD		STIBLE/ NONCOMBUSTIBLE MBUSTIBLE			P Rezoning Resubmission	2024.02.09
USTIBLE				(2a) 0.8 m ² UNPROTECTED OPENING —		- (2) 40.2 m ² EXPOSING BUILDING FACE						P Rezoning Submission	2023.10.12 2023.08.04
						Level 2 27000					NO.	DESCRIPTION	DATE
						Level 1 22500 Average Grade 22106							

4 EAST FACING ELEVATION FROM 2020 RICHMOND **4** SCALE = 1 : 250

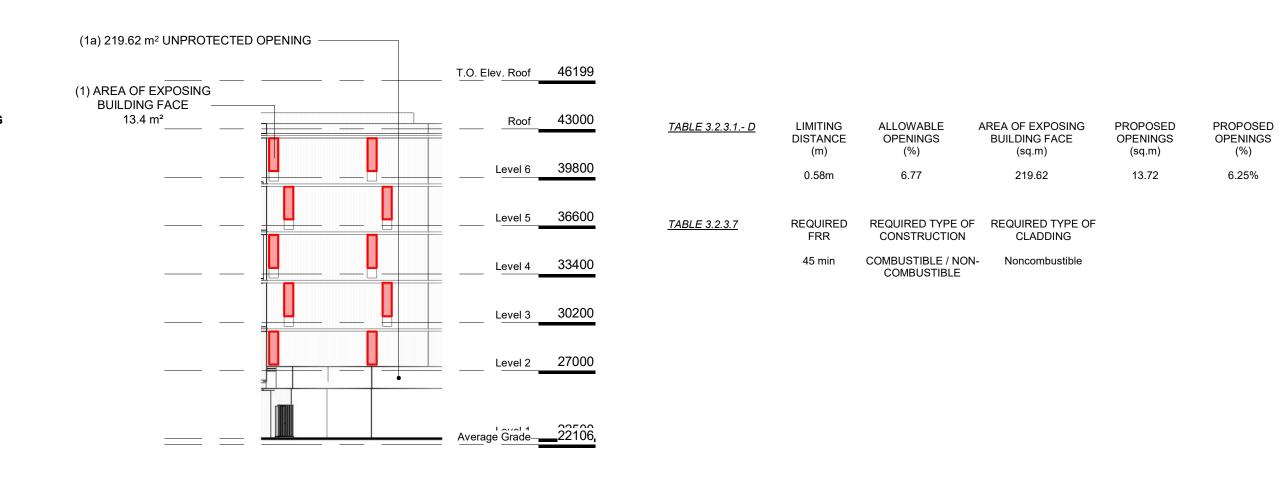

AREA OF EXPOSING ALLOWABLE PROPOSED OPENING PROPOSED OPENING BUILDING FACE OPENINGS (%) (SQ.M) (%) 39 m² 14.4% 10.3% 4 42 m² 14.4% 9.5% 4 45 m² 8.9% 14.4% 4 48.6 m² 14.4% 8.2% 4 50.6 m² 14.4% 7.9% 4

6 NORTH EAST ELEVATION SCALE = 1:250


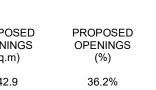


TABLE 3.2.3.1D (BCBC 2018)	

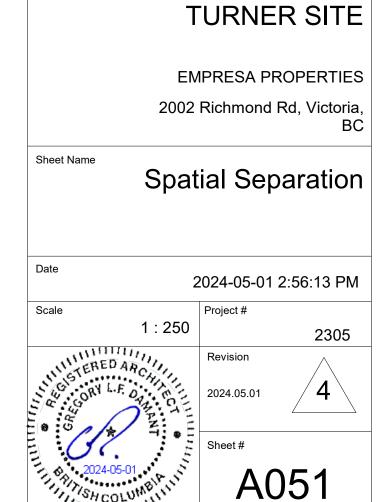

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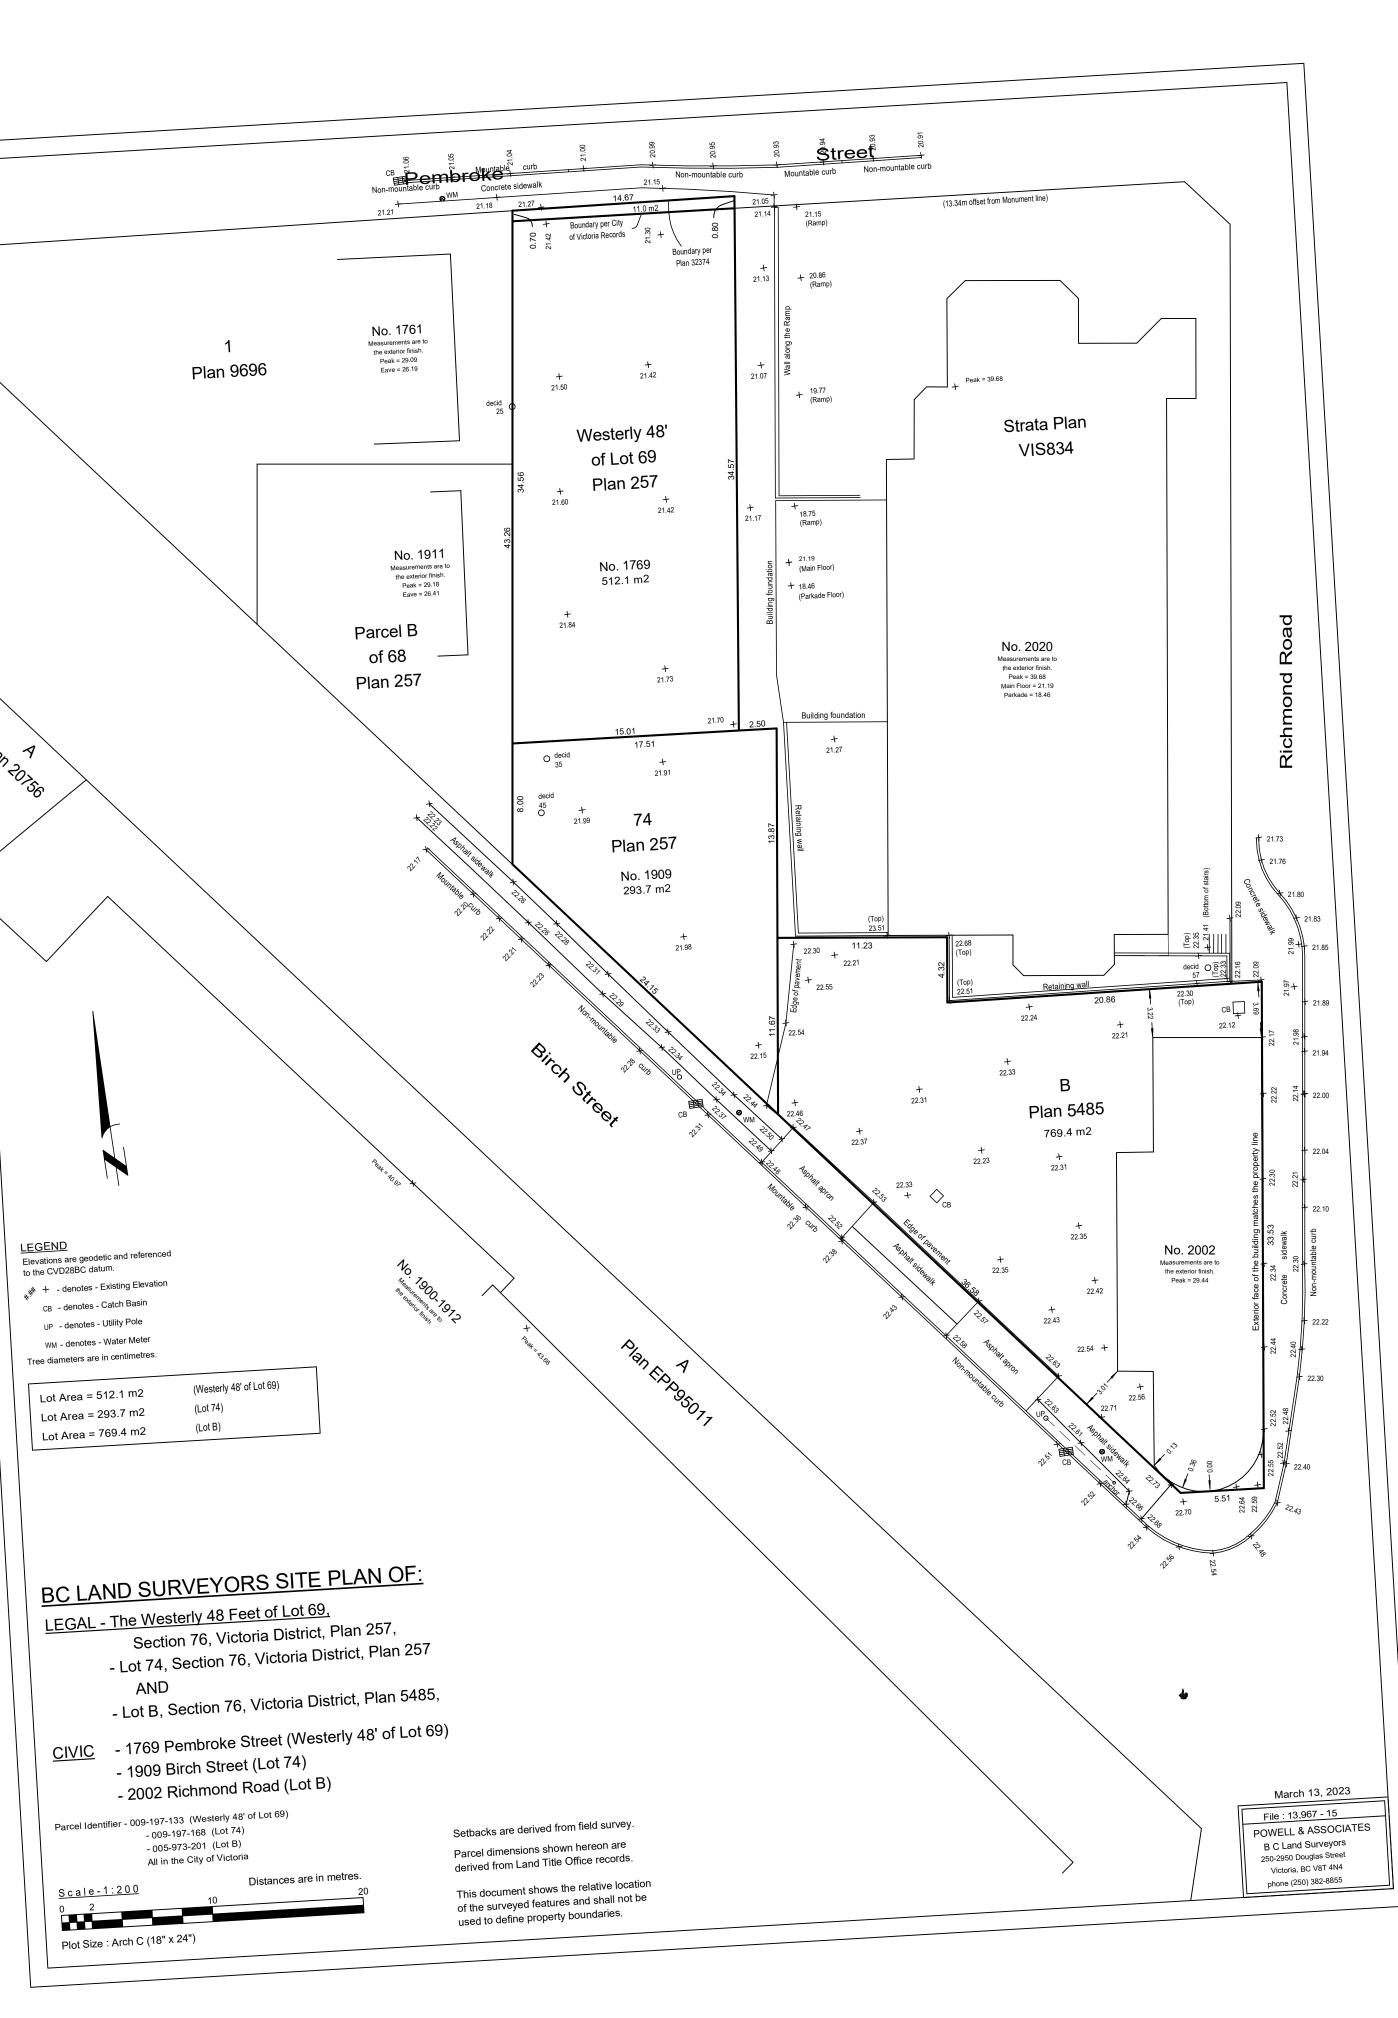
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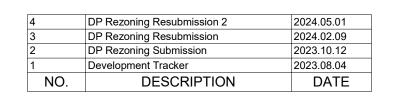


Plan Porse

LEGEND












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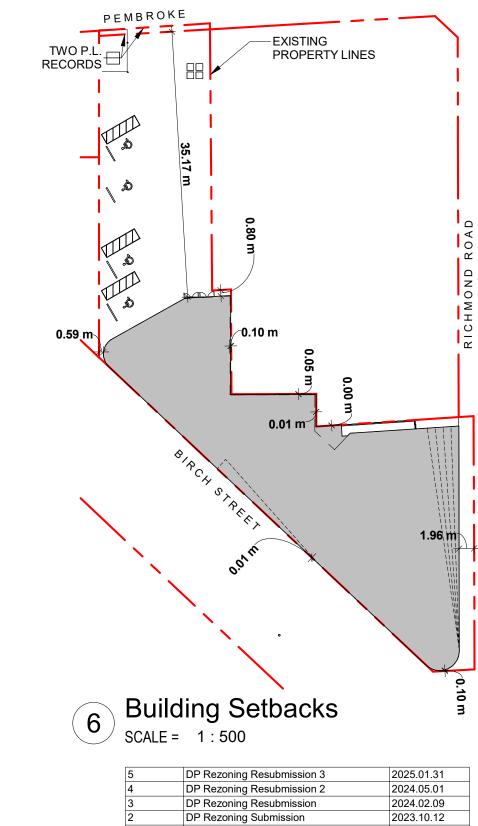


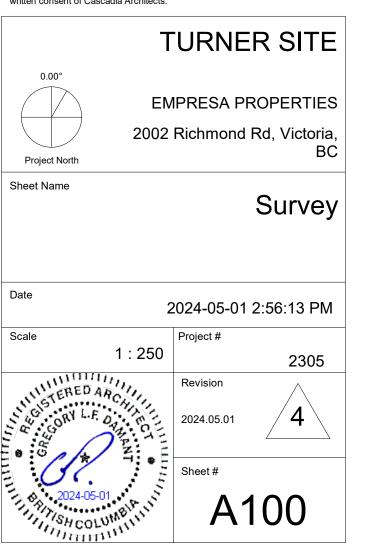


ZONING	DATA				
ZONE		TBD	- SITE SPEC	IFIC	
USE			DENTIAL (L. IMERCIAL		
EXISTING SITE	AREA		1,586.8	m ²	
PROPOSED D	EDICATION AREA		93.5	m ²	
PROPOSED SITE AREA			1,494.2	m ²	
REGULATORY	CONDITIONS				
GROSS FLOOI	R AREA		4319.3 r	m²	
COMMERCIAL	FLOOR AREA		370.1 r	m²	
TOTAL RESIDE	ENTIAL FLOOR AREA		3949.2 r	m²	
BUILDING HEI	GHT		24.0	~	
(from Natural G	rade)		24.0 r	n	
SETBACKS	RICHMOND		1.96 r	n	
	PEMBROKE	[35.17 r	n	
	BIRCH	[10.0 r	n	
WEST (SIDE)		0.6 m			
					OPEN SITE SP
FLOOR SPACE	ERATIO (FSR)	2.89 : 1 61.7 %			
SITE COVERA	GE				
PARKING - VE	HICLE				
USE	DENSITY	RATE	REQ'D	PROVIDED	
	10 UNITS (<45m ²)	0.75 / unit	7.5		
RESIDENTIAL	25 UNITS (45-70m ²)	0.90 / unit	22.5	11 SPACES	
	20 UNITS (>70m ²)	1.30 / unit	26	(3 ACCESS. + 2 VAN	
VISITOR (RES.)	55 UNITS	0.1 / unit	5.5	ACCESS.)	
COMM. *	395.3m ²	1 / 20m ²	19.7		
PARKING - BIO	YCLE	TOTAL:	81		
USE	DENSITY	RATE	REQ'D	PROVIDED	
	10 UNITS (<45m ²)	1 / unit	10		
RESIDENTIAL	45 UNITS (> 45m ²)	1.25 / unit	56	116 LONG TERM (15	
VISITOR (RES.)	55 UNITS	6 spaces	6	CARGO)	
COMM. *	395.3m ²	1 / 200m ²	2	10 SHORT TERM	
VISTOR (COMM.)		1 / 100m ²	4		
- ()	1	TOTAL:	78		
RESIDENTIA					
Total number	of Units		55		
UNIT TYPE			L	1	
Studio			10]	
1 Bed			25]	
2 Bed			20]	
Minimum uni	floor area		33.74	 m²	
		1	1	1	

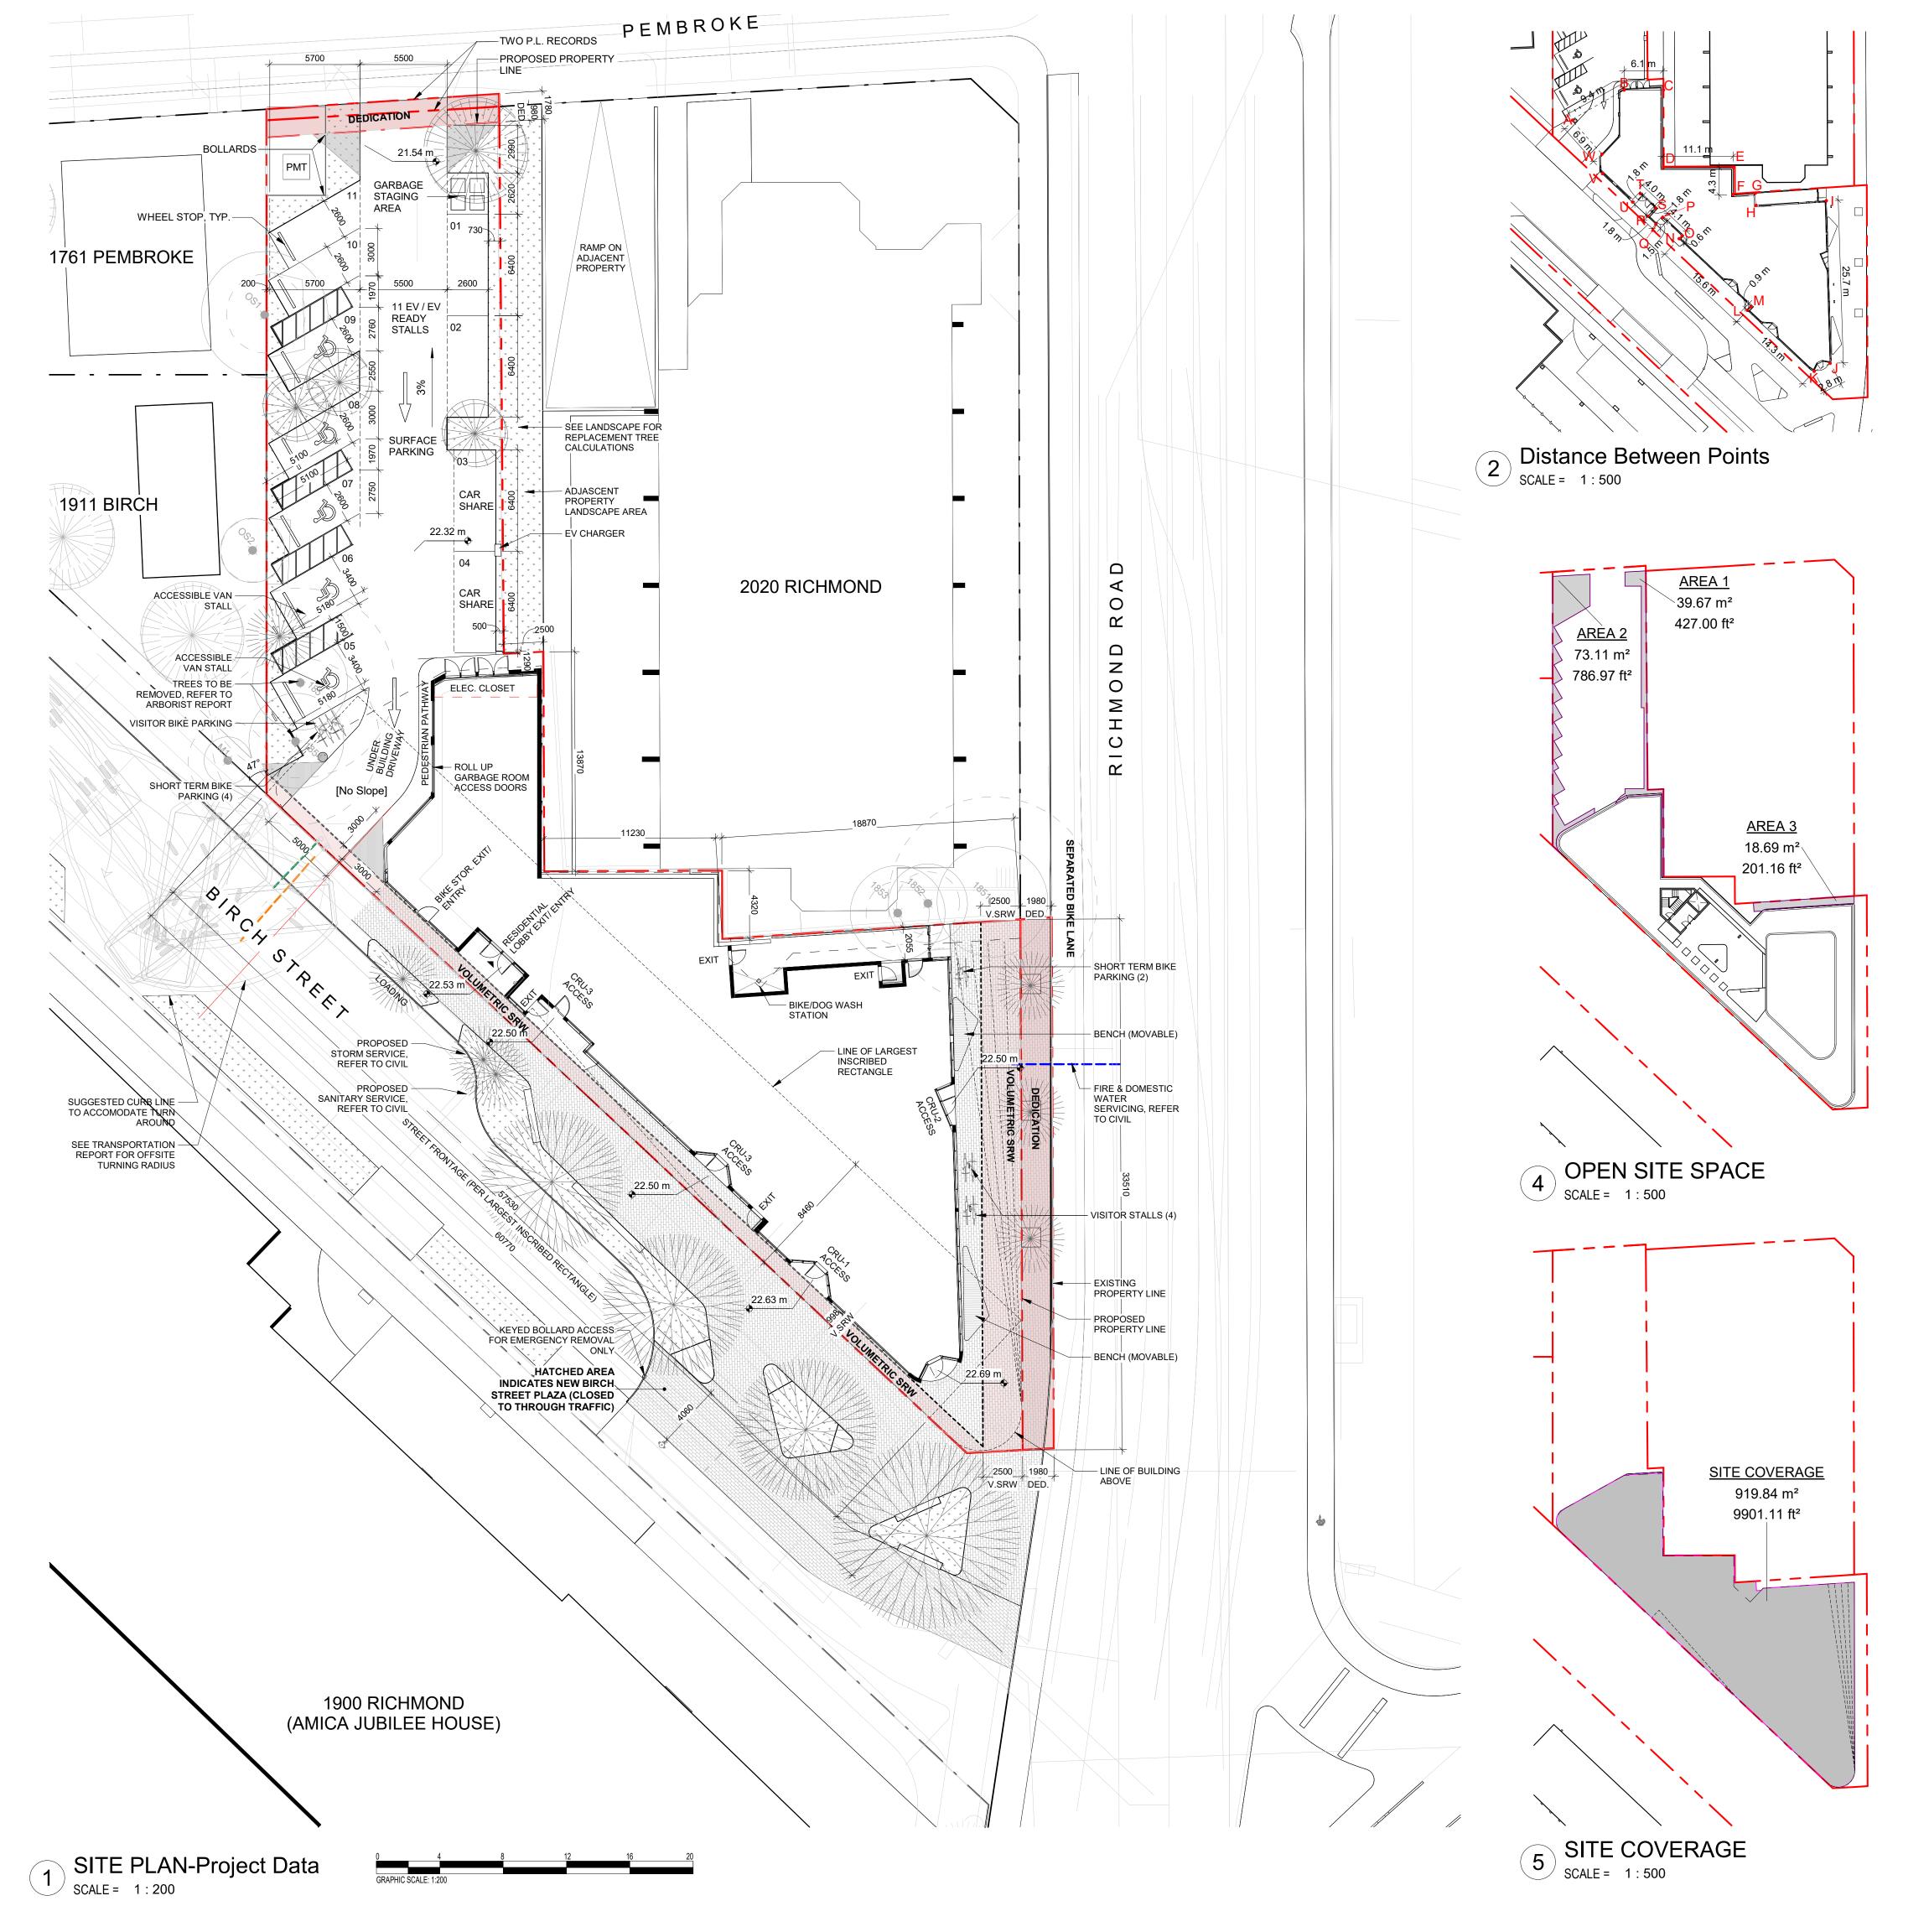* MOST RESTRICTIVE CRU USE APPLIED FOR SCHEDULE-C CALUCATIONS

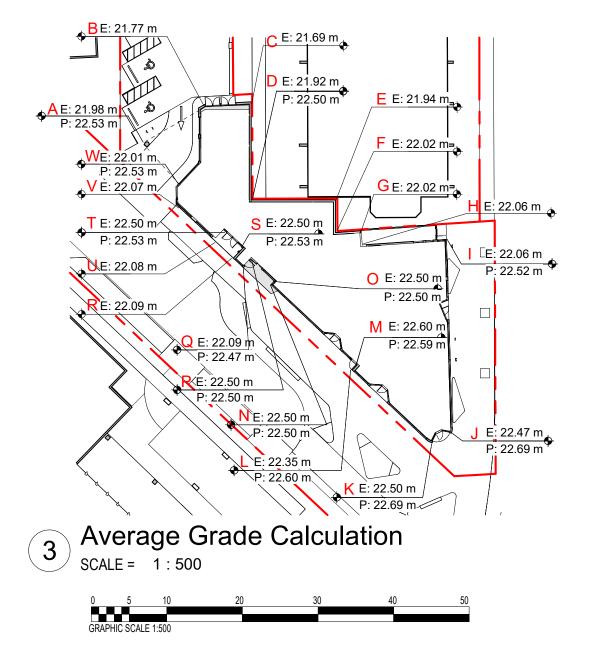Point	Existing	Proposed	Distance to	(Elev. 1 + Elev. 2)/2 *
Point	Grade (m)	Grade (m)	next point (m)	Distance
А	21.98	22.53	9.5	207.81
в	21.77	22.53	6.1	132.58
с	21.70	22.53	12.3	268.26
D	21.92	22.50	11.1	243.42
E	21.94	22.50	4.3	94.51
F	22.02	22.50	3.4	74.87
G	22.02	22.50	1.9	41.88
н	22.06	22.50	11.2	247.07
I.	22.06	22.50	25.7	572.21
J	22.47	22.69	2.8	62.96
к	22.50	22.69	14.3	320.68
L	22.35	22.60	0.9	20.22
м	22.60	22.59	15.6	351.70
N	22.50	22.50	0.6	13.50
0	22.50	22.50	4.1	92.25
Р	22.50	22.50	1.5	33.44
Q	22.09	22.47	1.8	39.76
R	22.09	22.53	1.8	40.13
s	22.50	22.53	3.3	74.25
Т	22.50	22.53	1.8	40.12
U	22.08	22.53	6.5	143.49
v	22.07	22.53	3.1	68.32
w	22.01	22.53	6.9	151.77
			Elevation	22.16



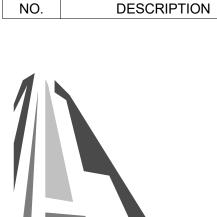

DP Rezoning Submission


Development Tracker


CASCADIA ARCHITECTS INC


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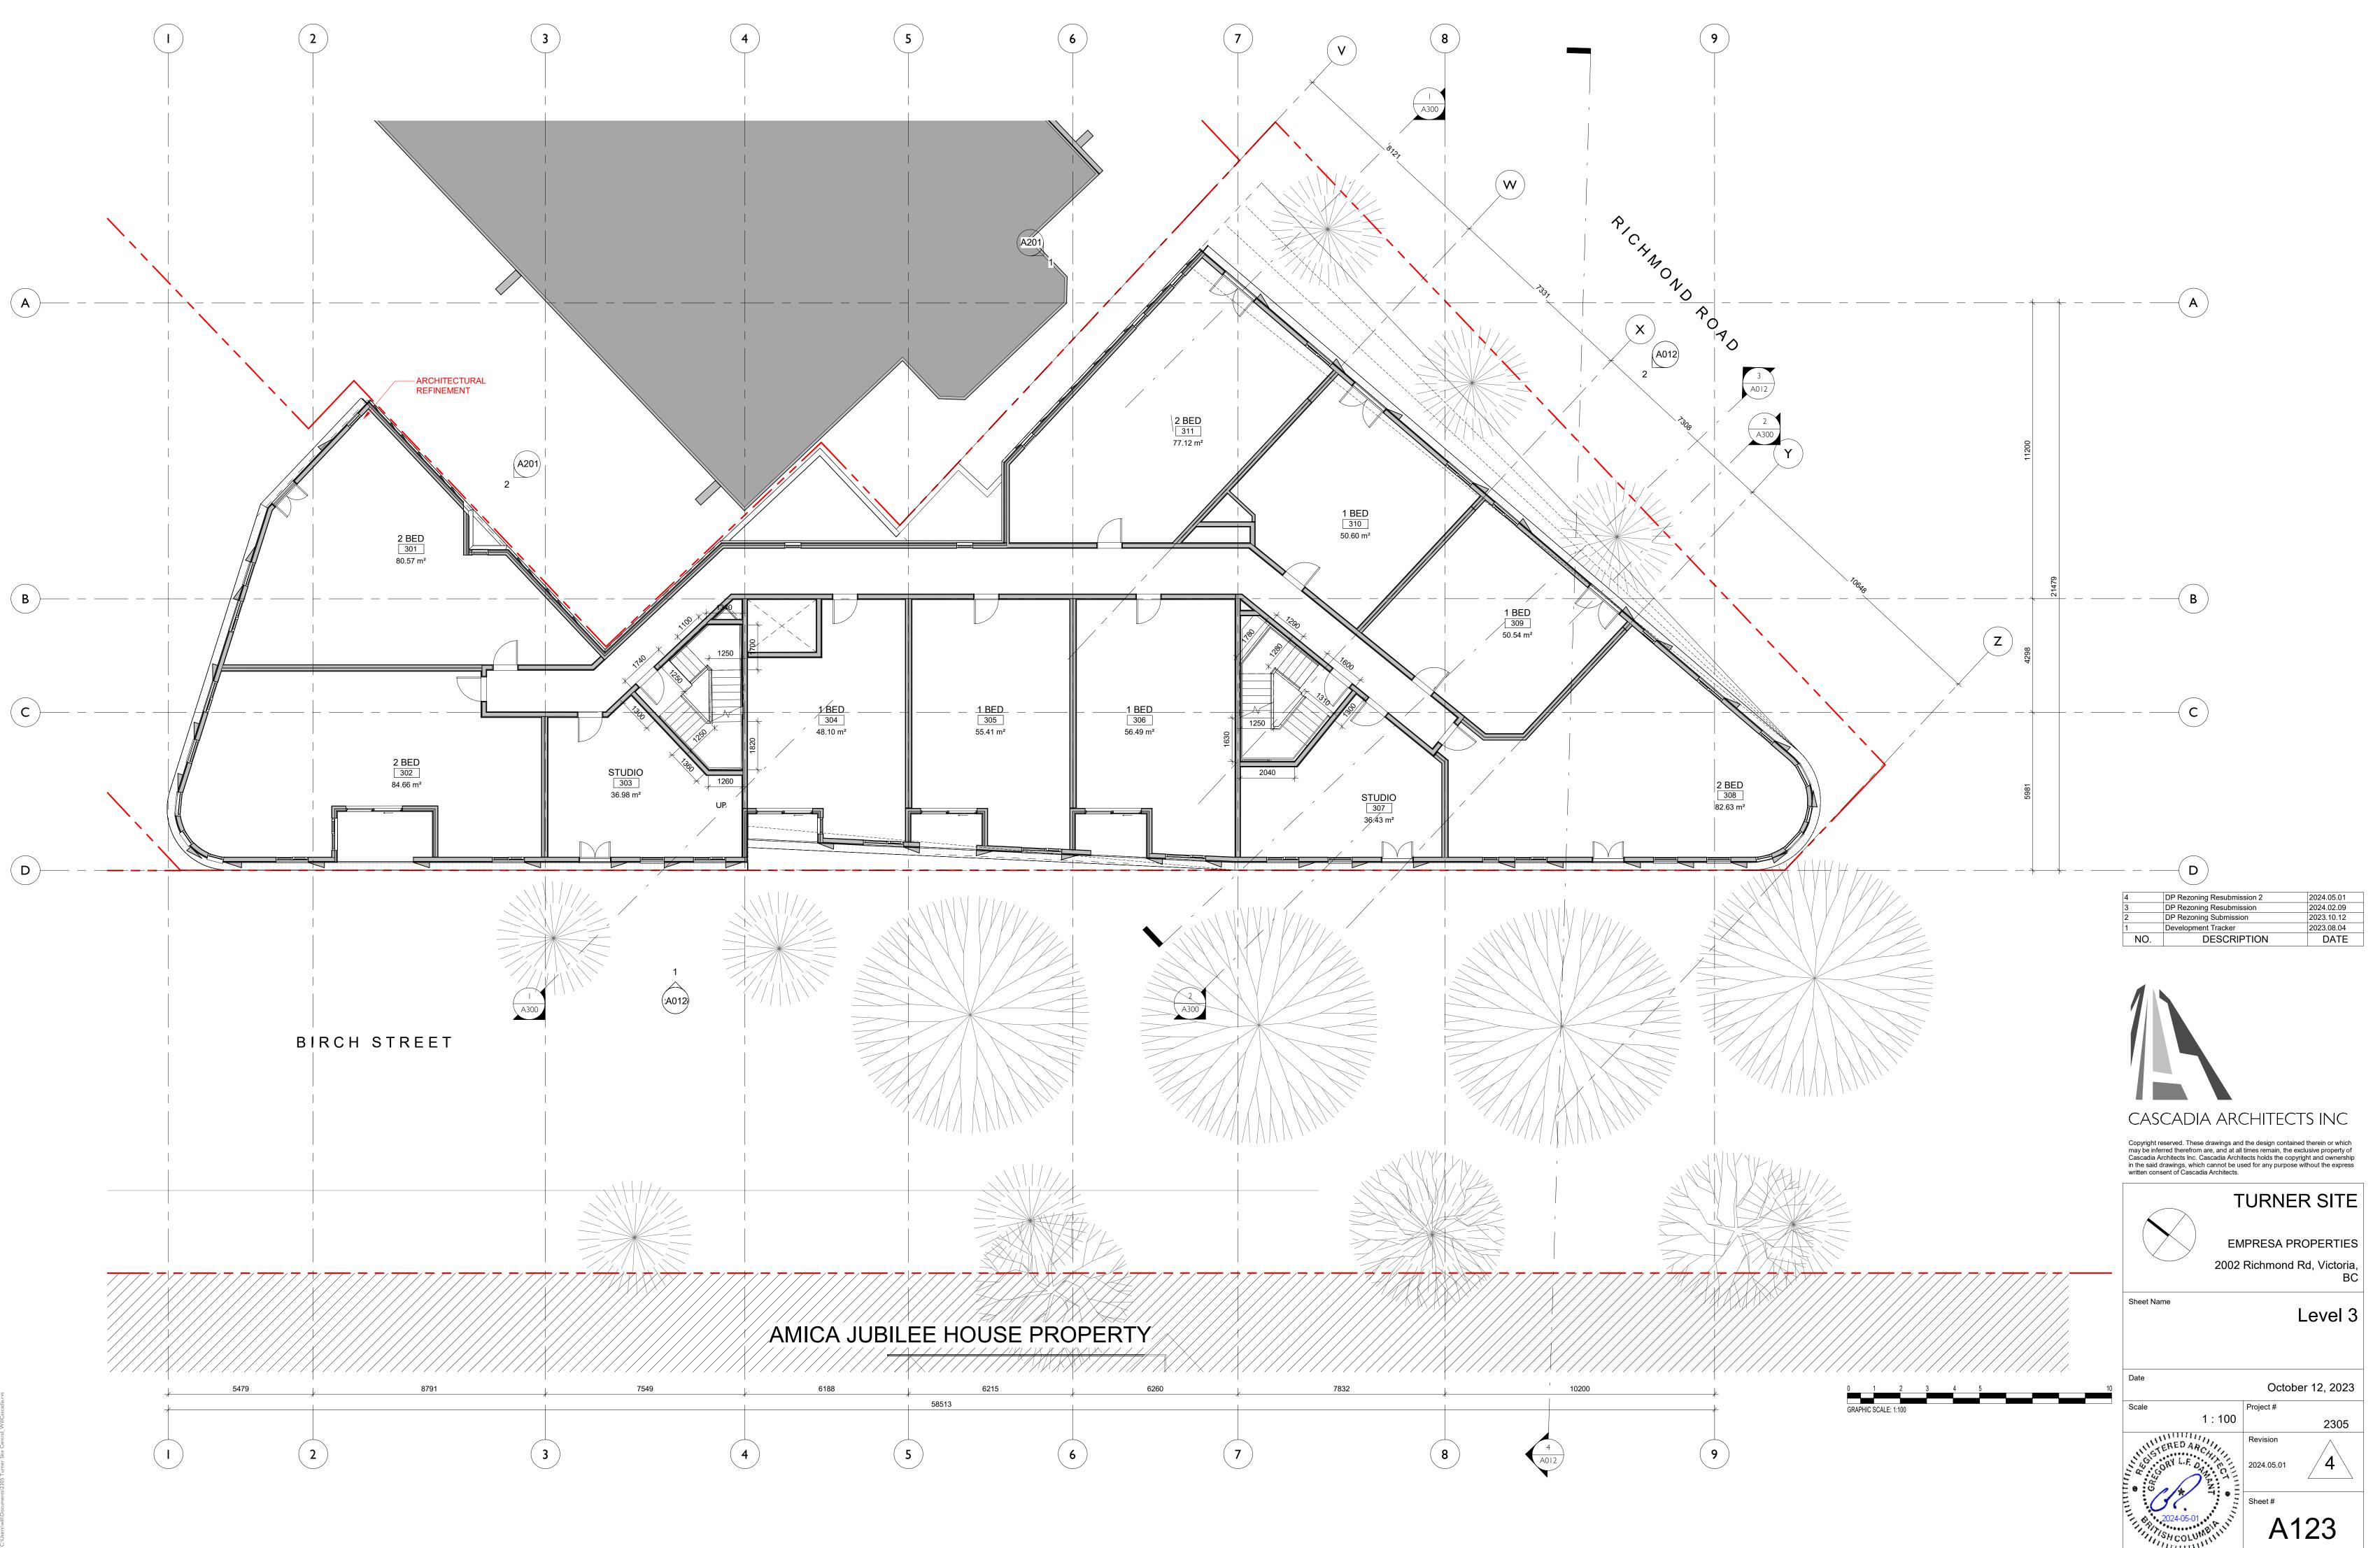
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Project North 2002	Richmond	Rd, Victoria, BC			
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Scale	Project #				
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S GORY L.F. O. T. M.	2025.01.31	5			
	Sheet #				






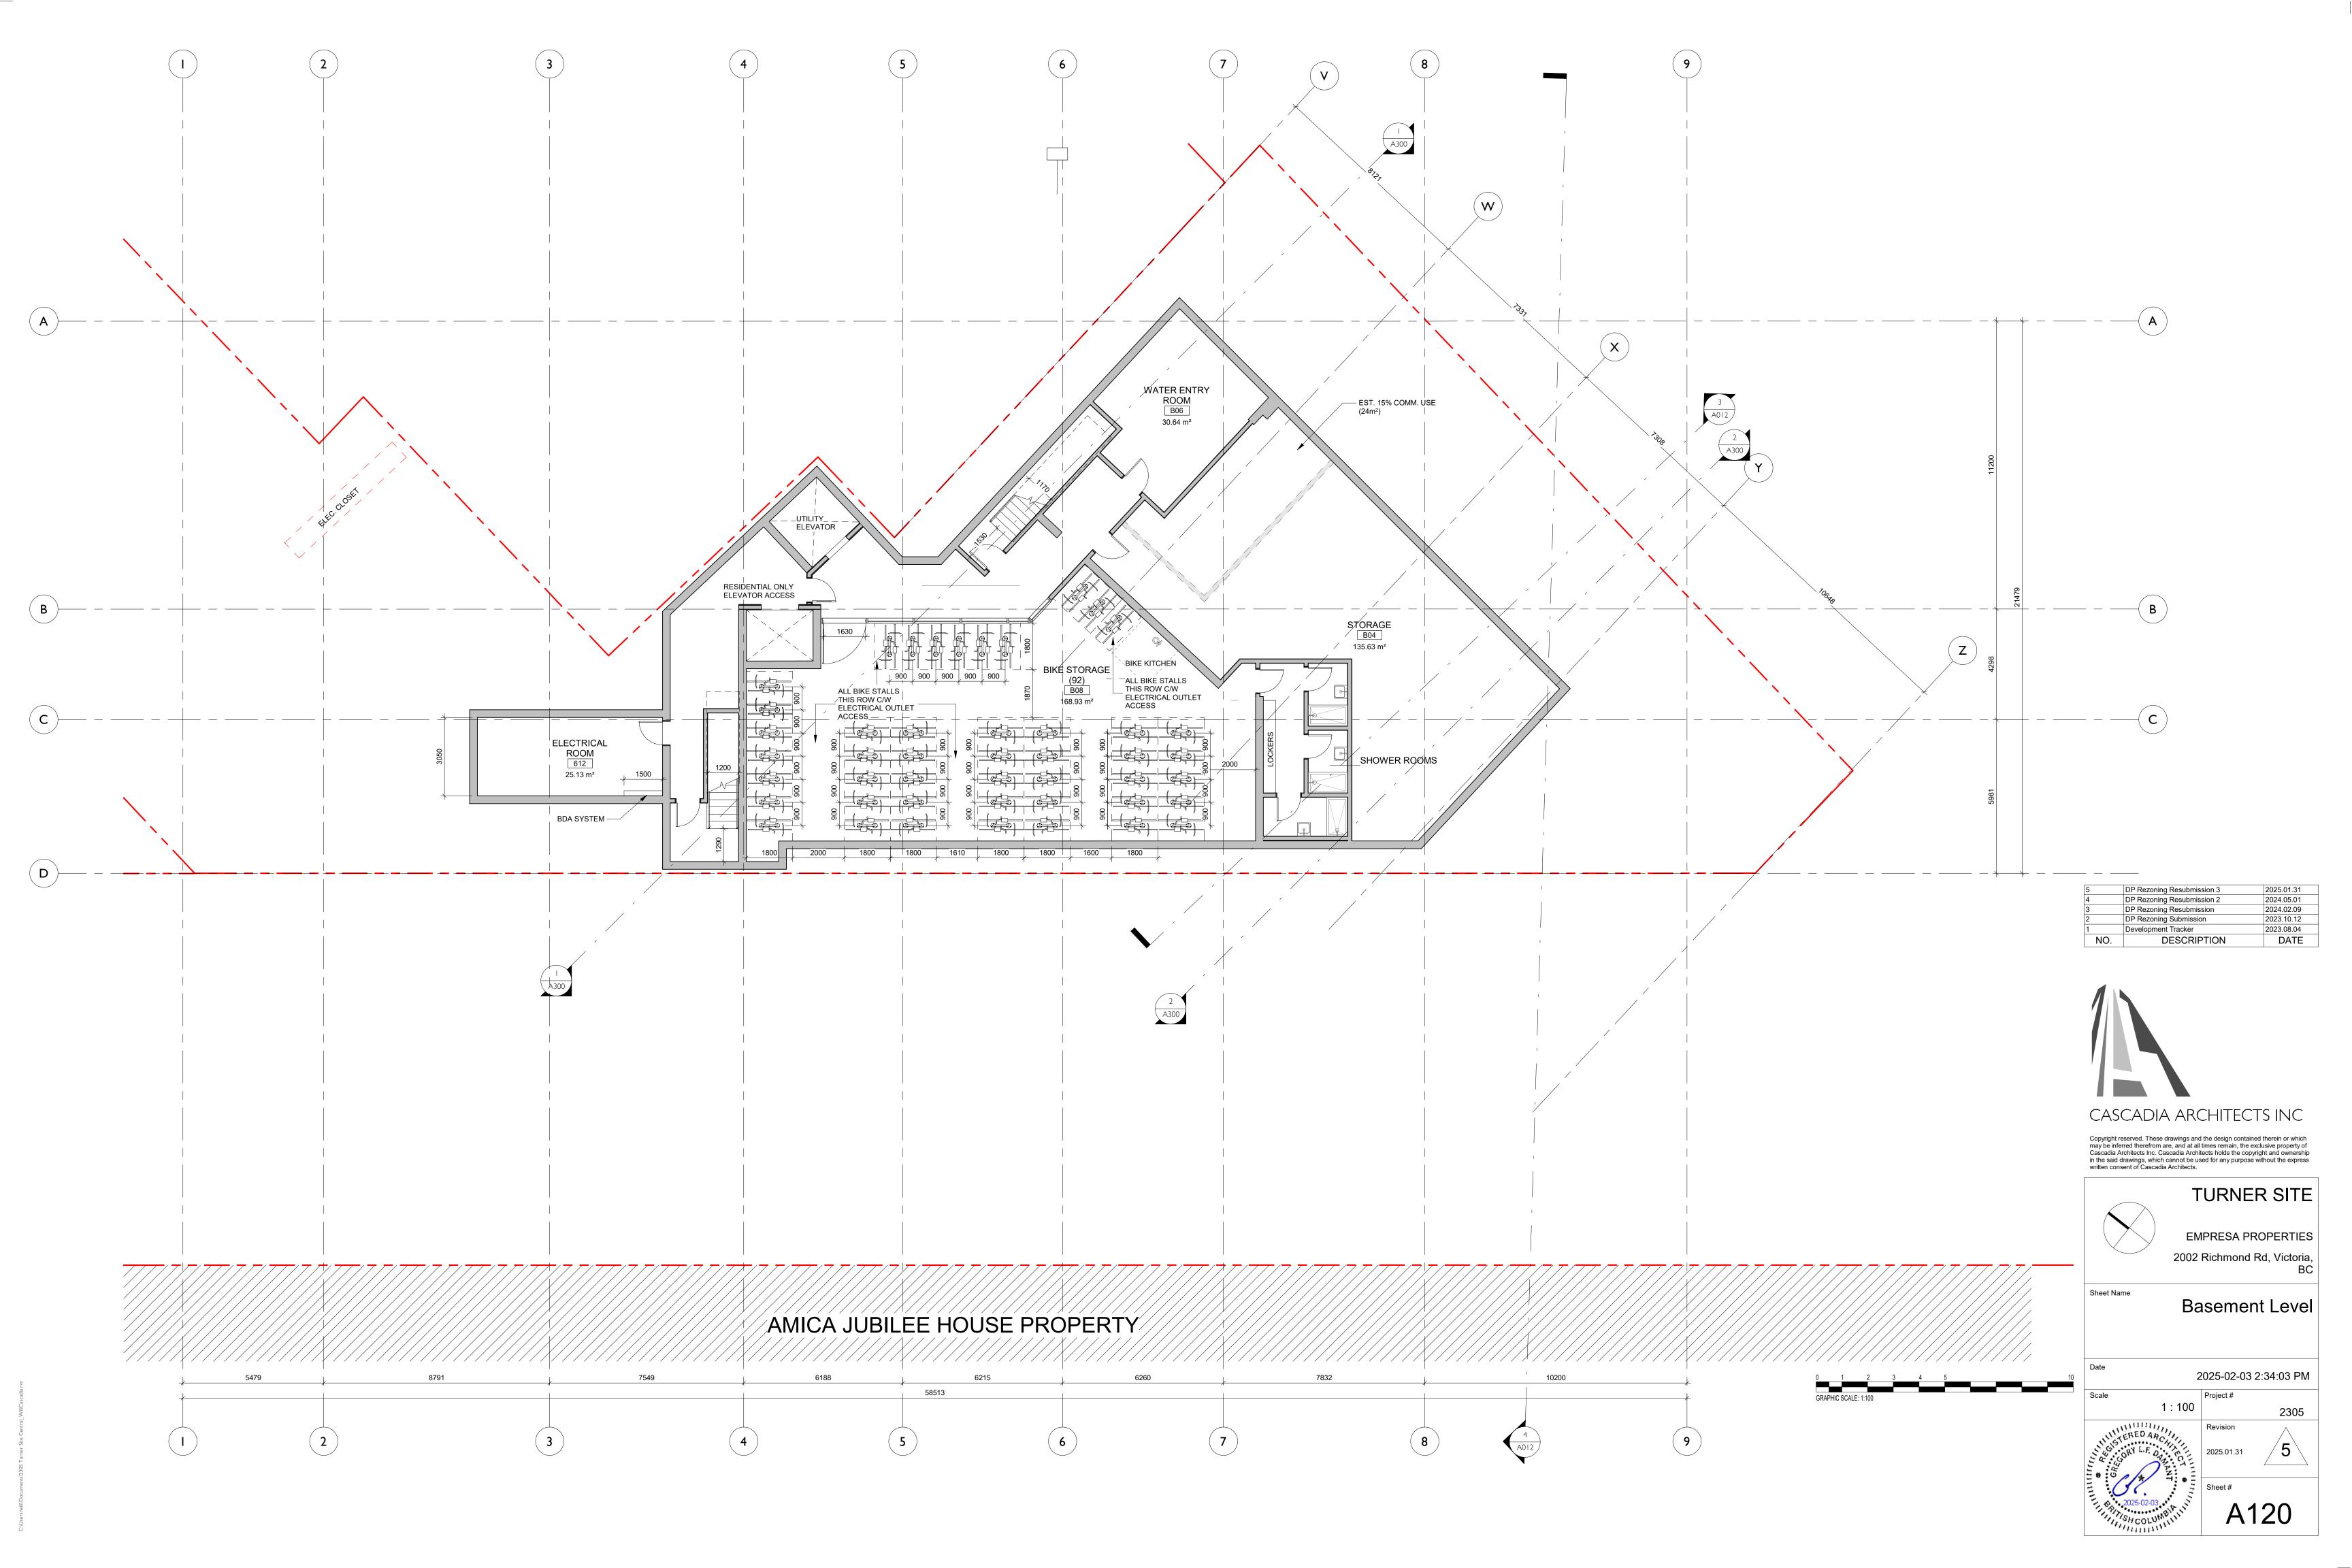

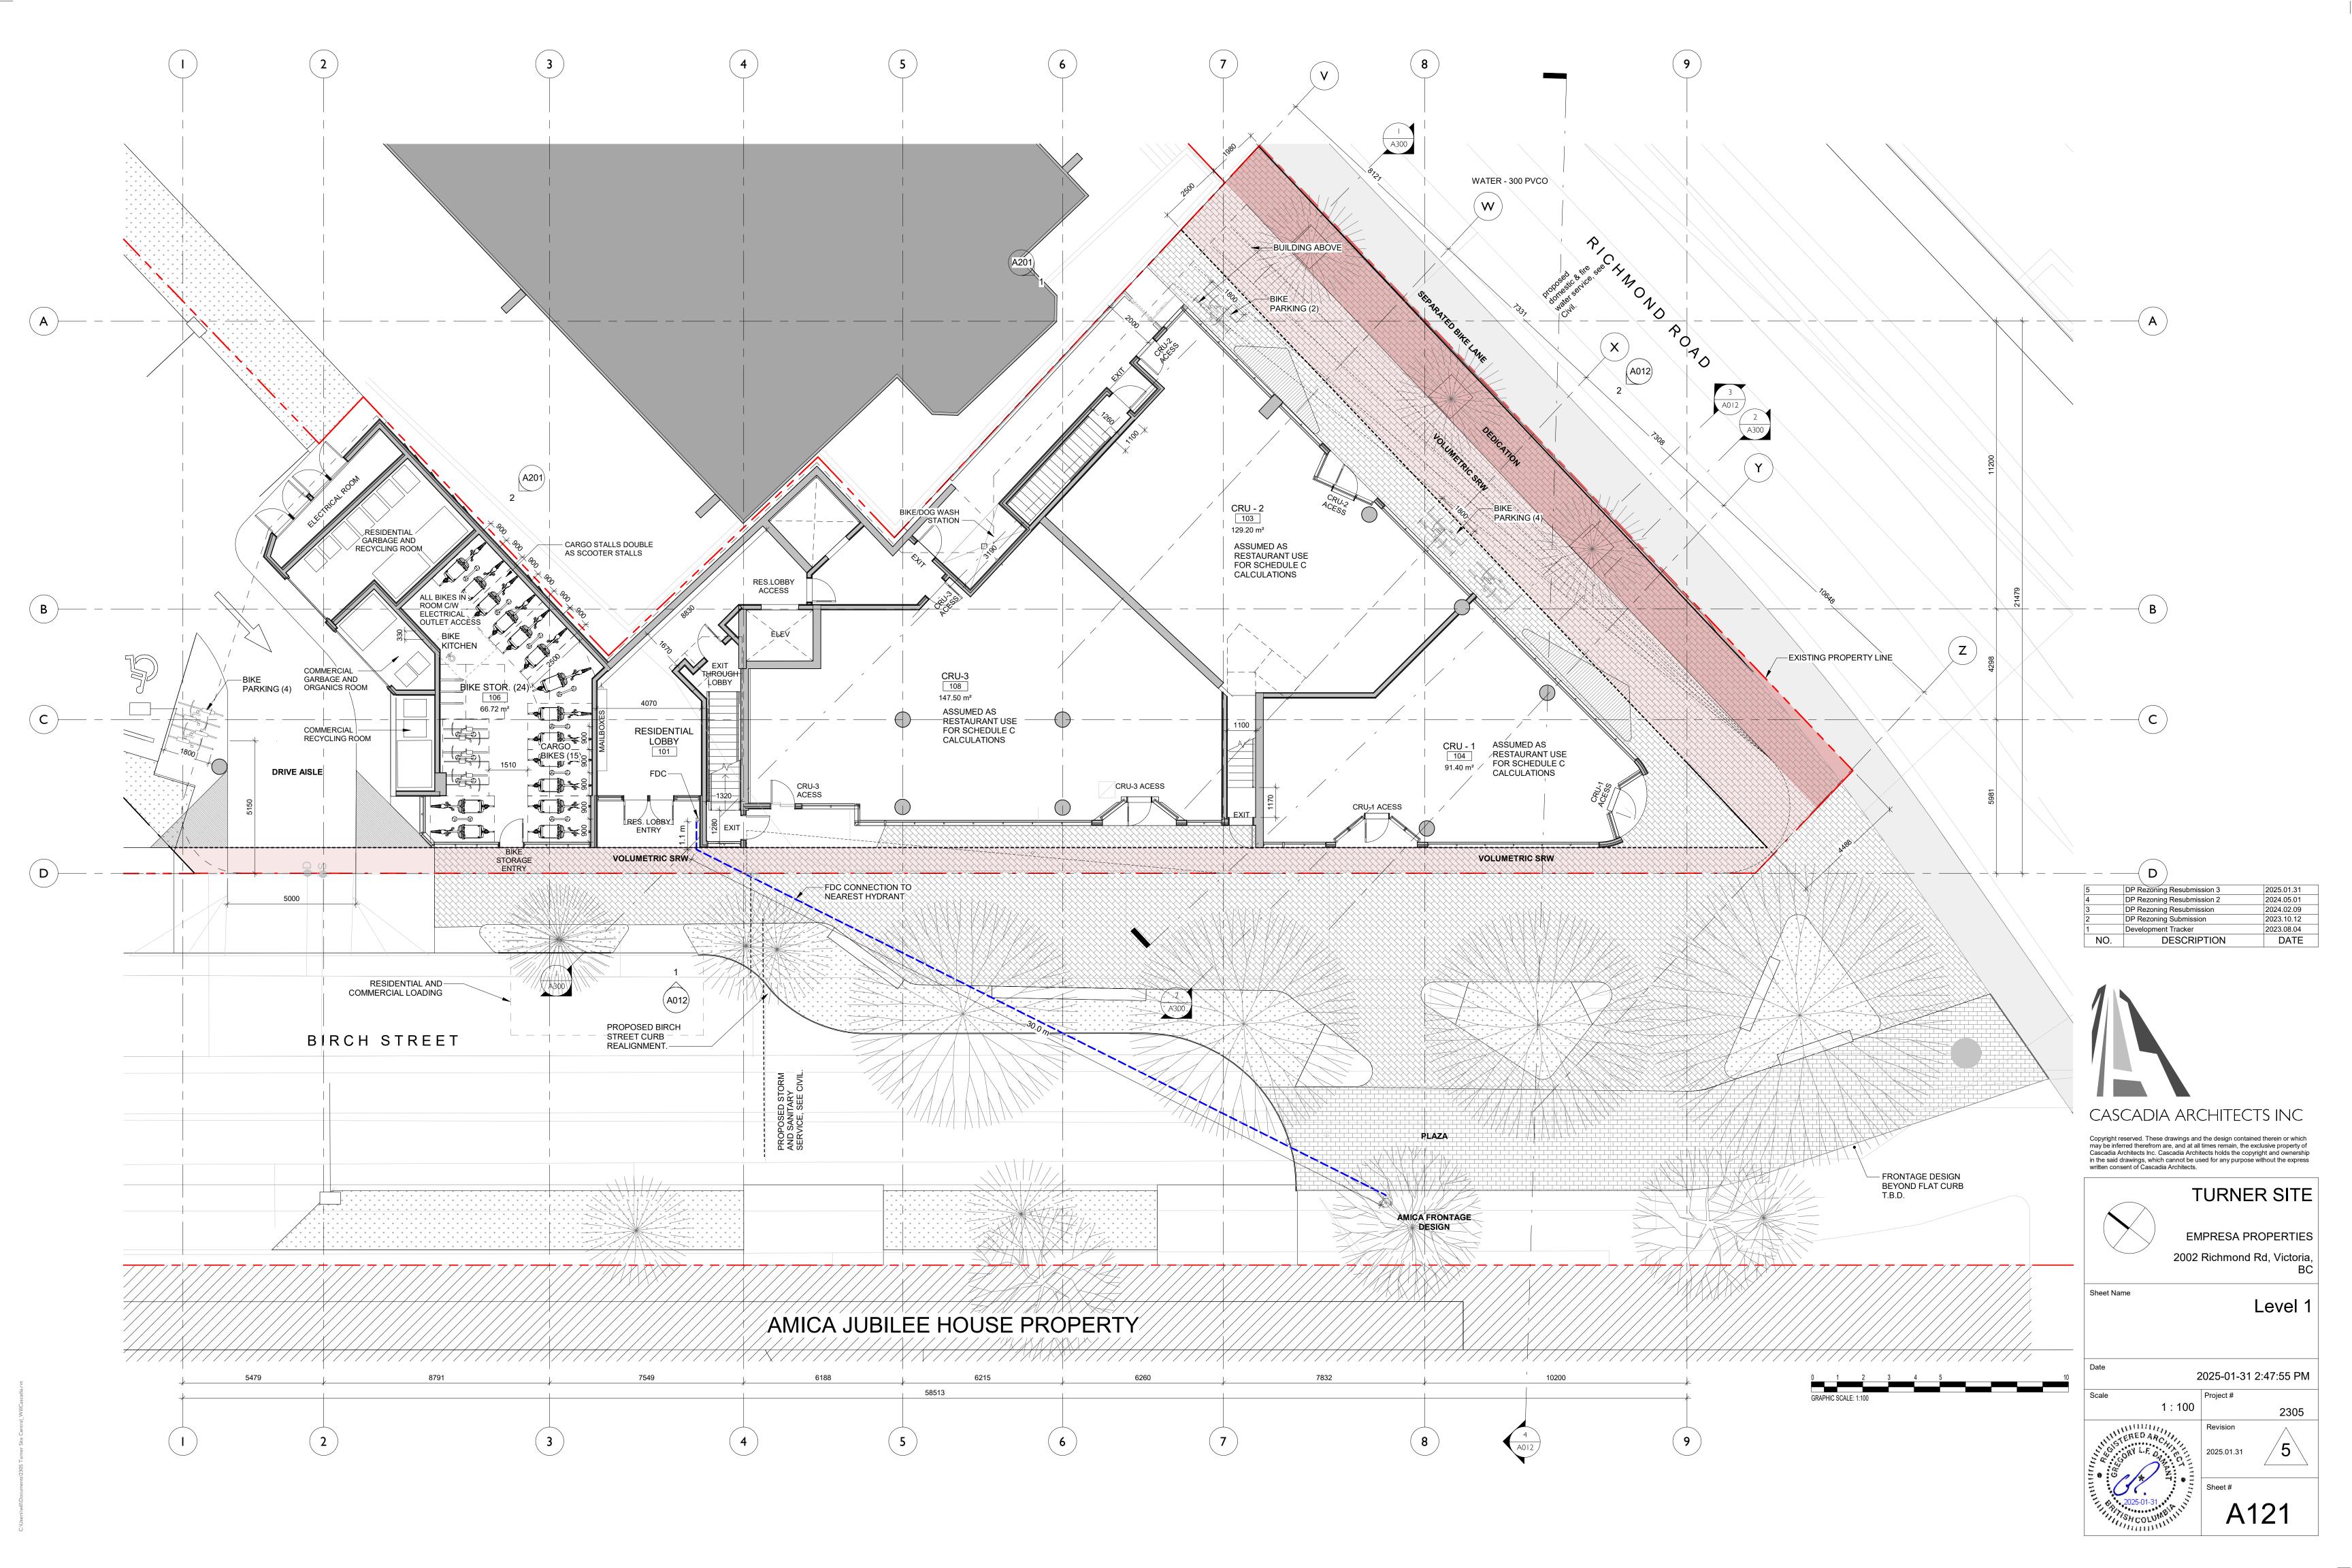


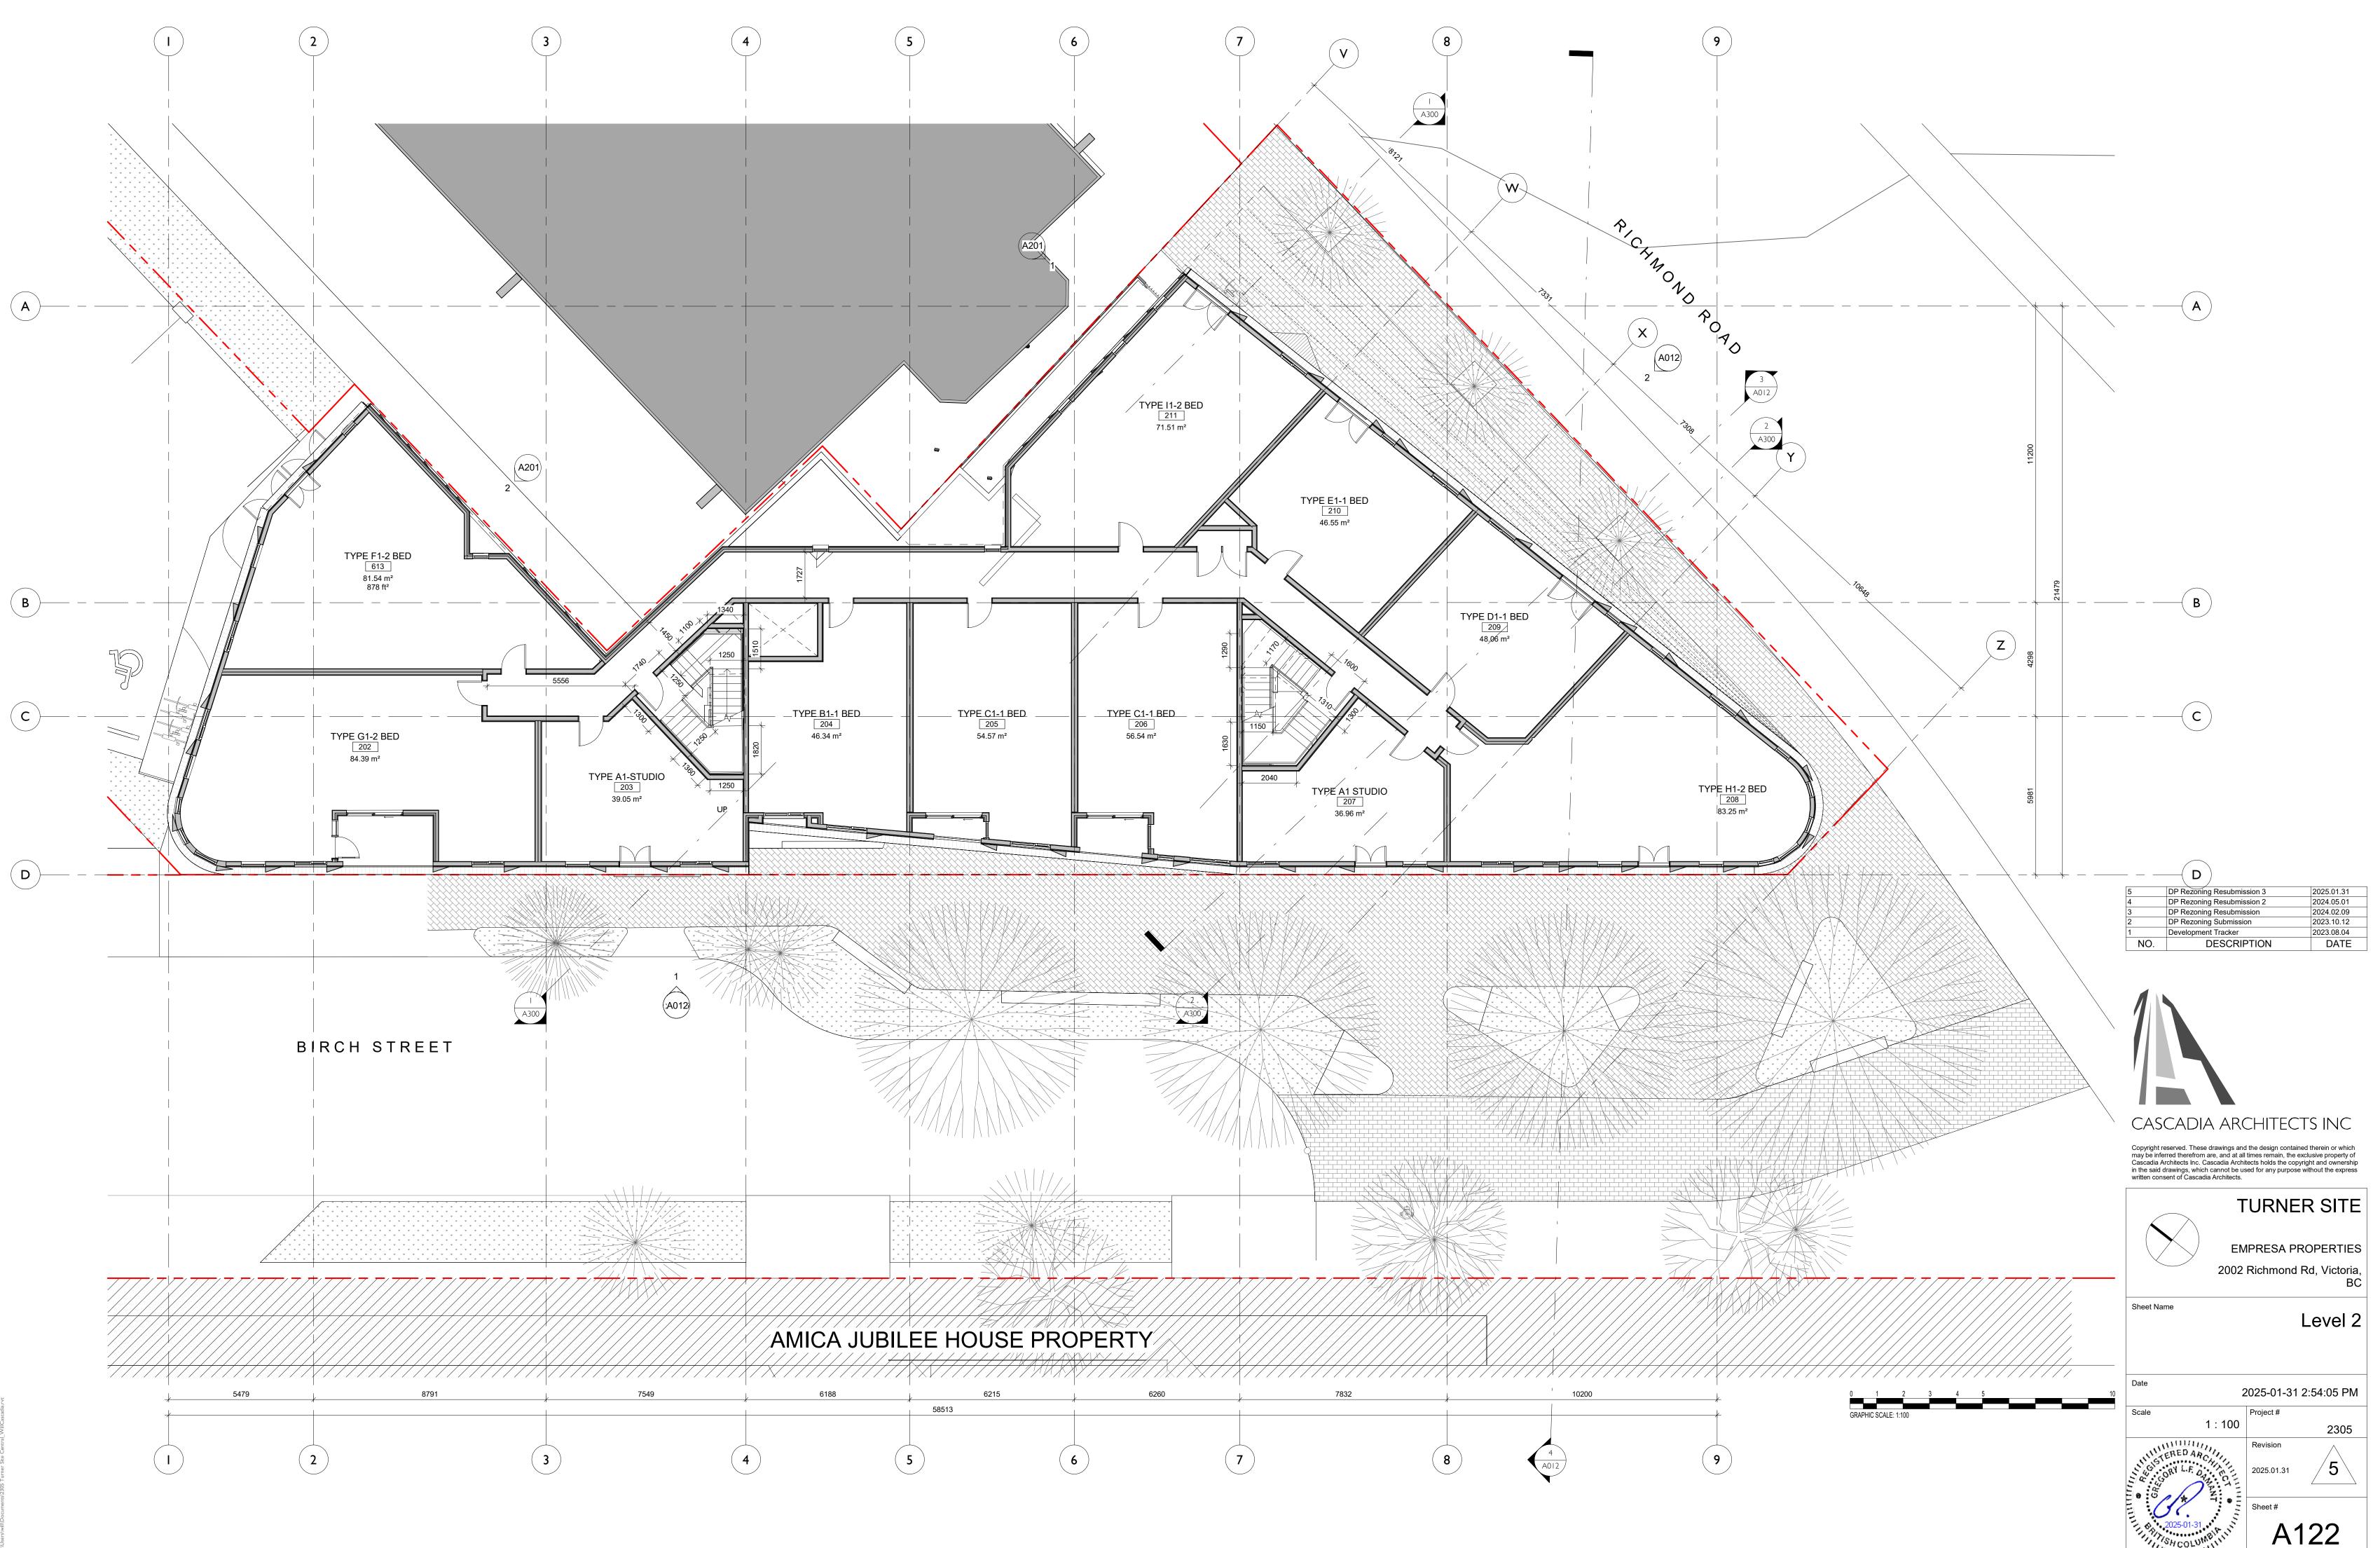
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4	DP Rezoning Resubmis		2024.05.01
3	DP Rezoning Resubmis		2024.02.09
NO.	DESCRIF	TION	DATE
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	2024-05-01	Sheet #	

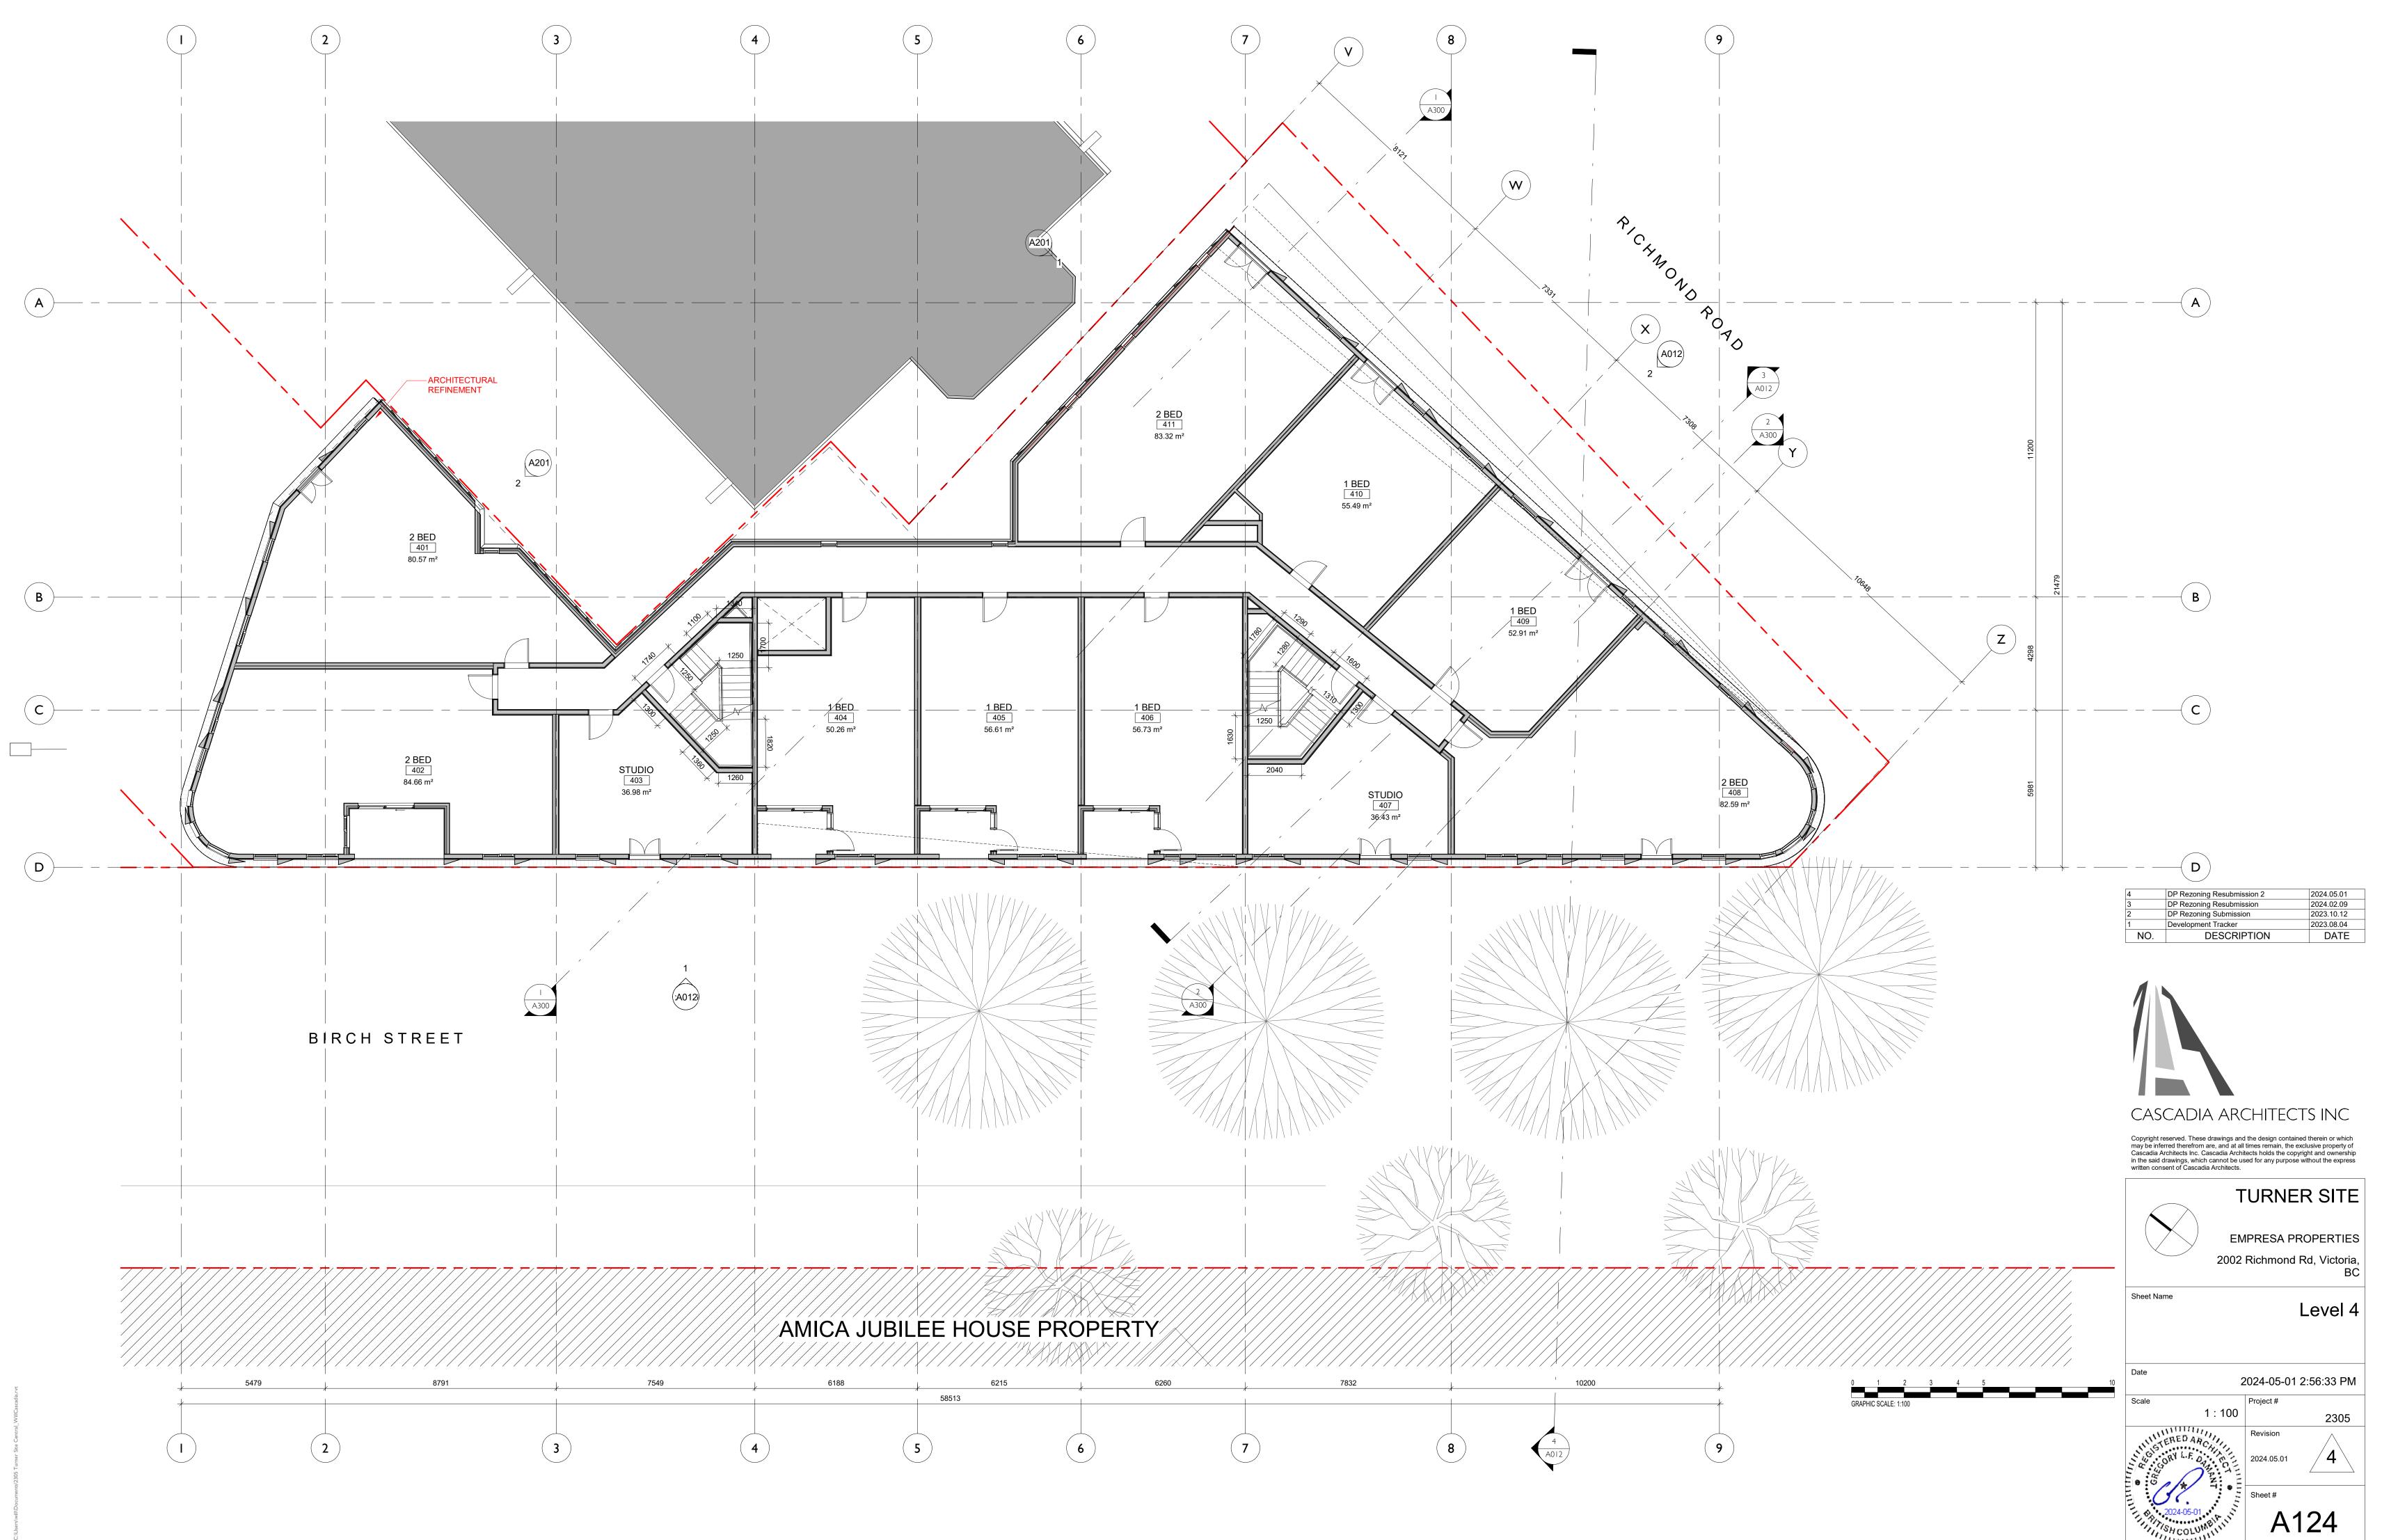




-URBAN AGRICULTURAL PLANTERS REFER LANDSCAPE

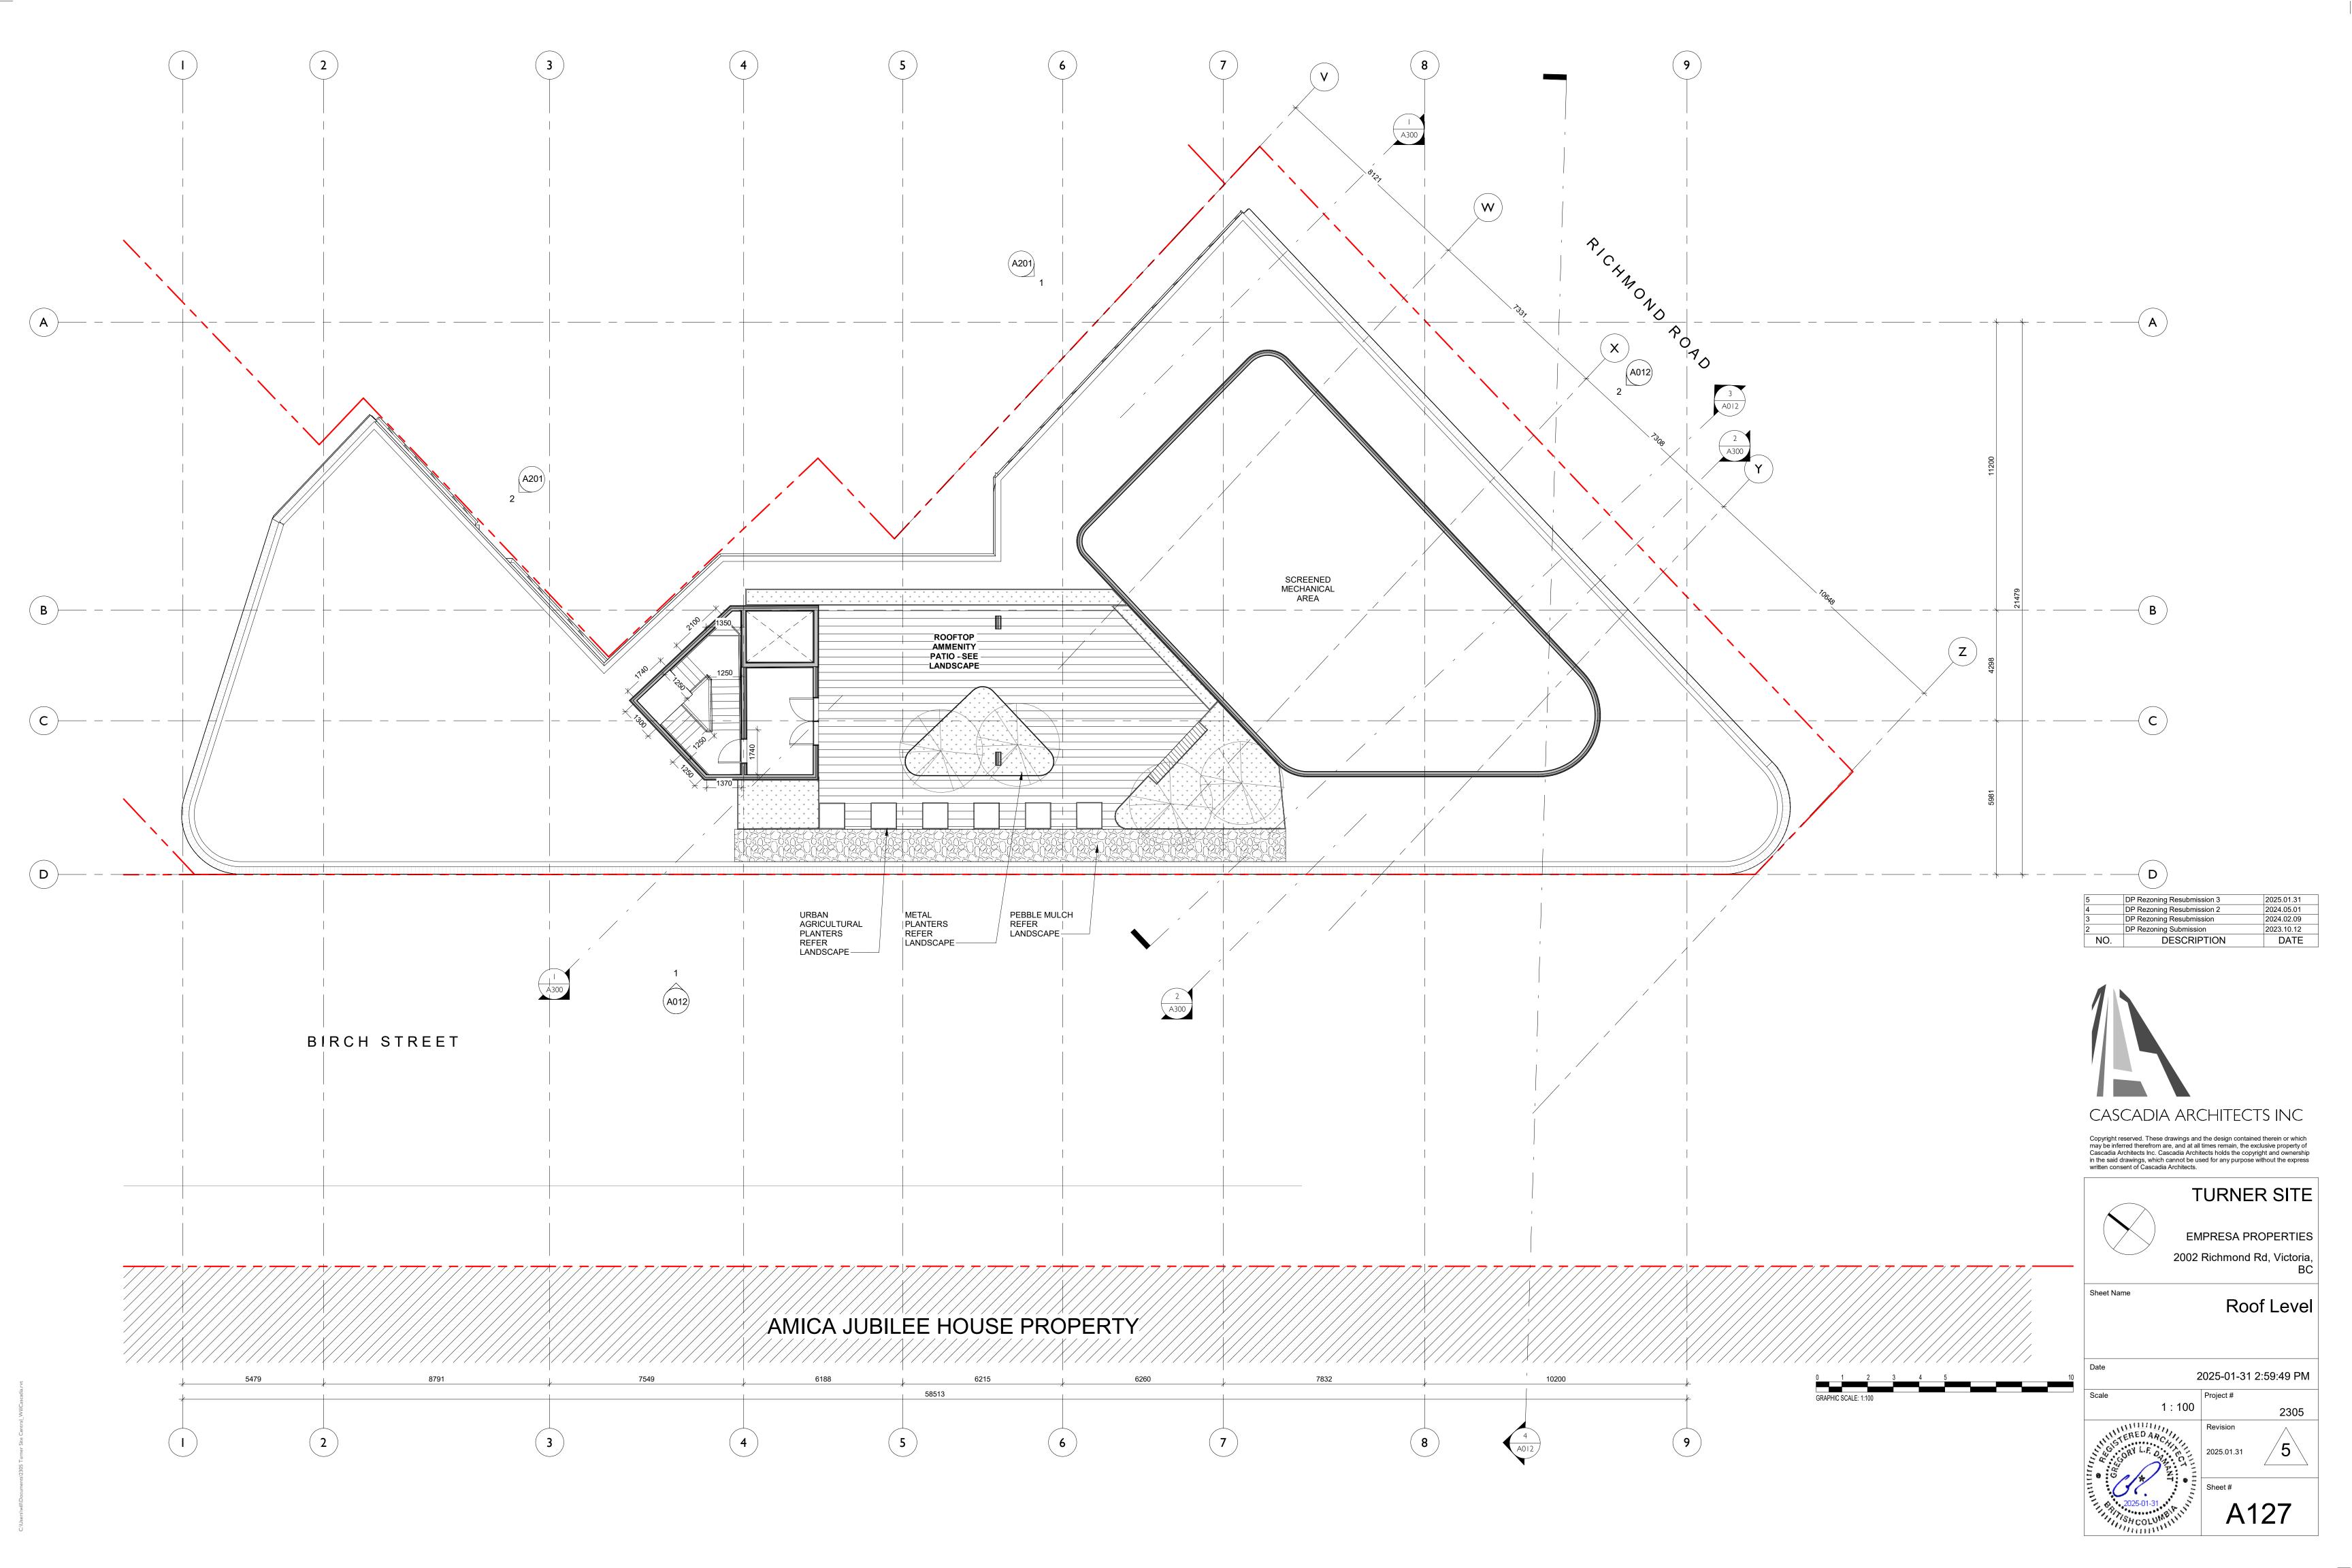Sheet # A200

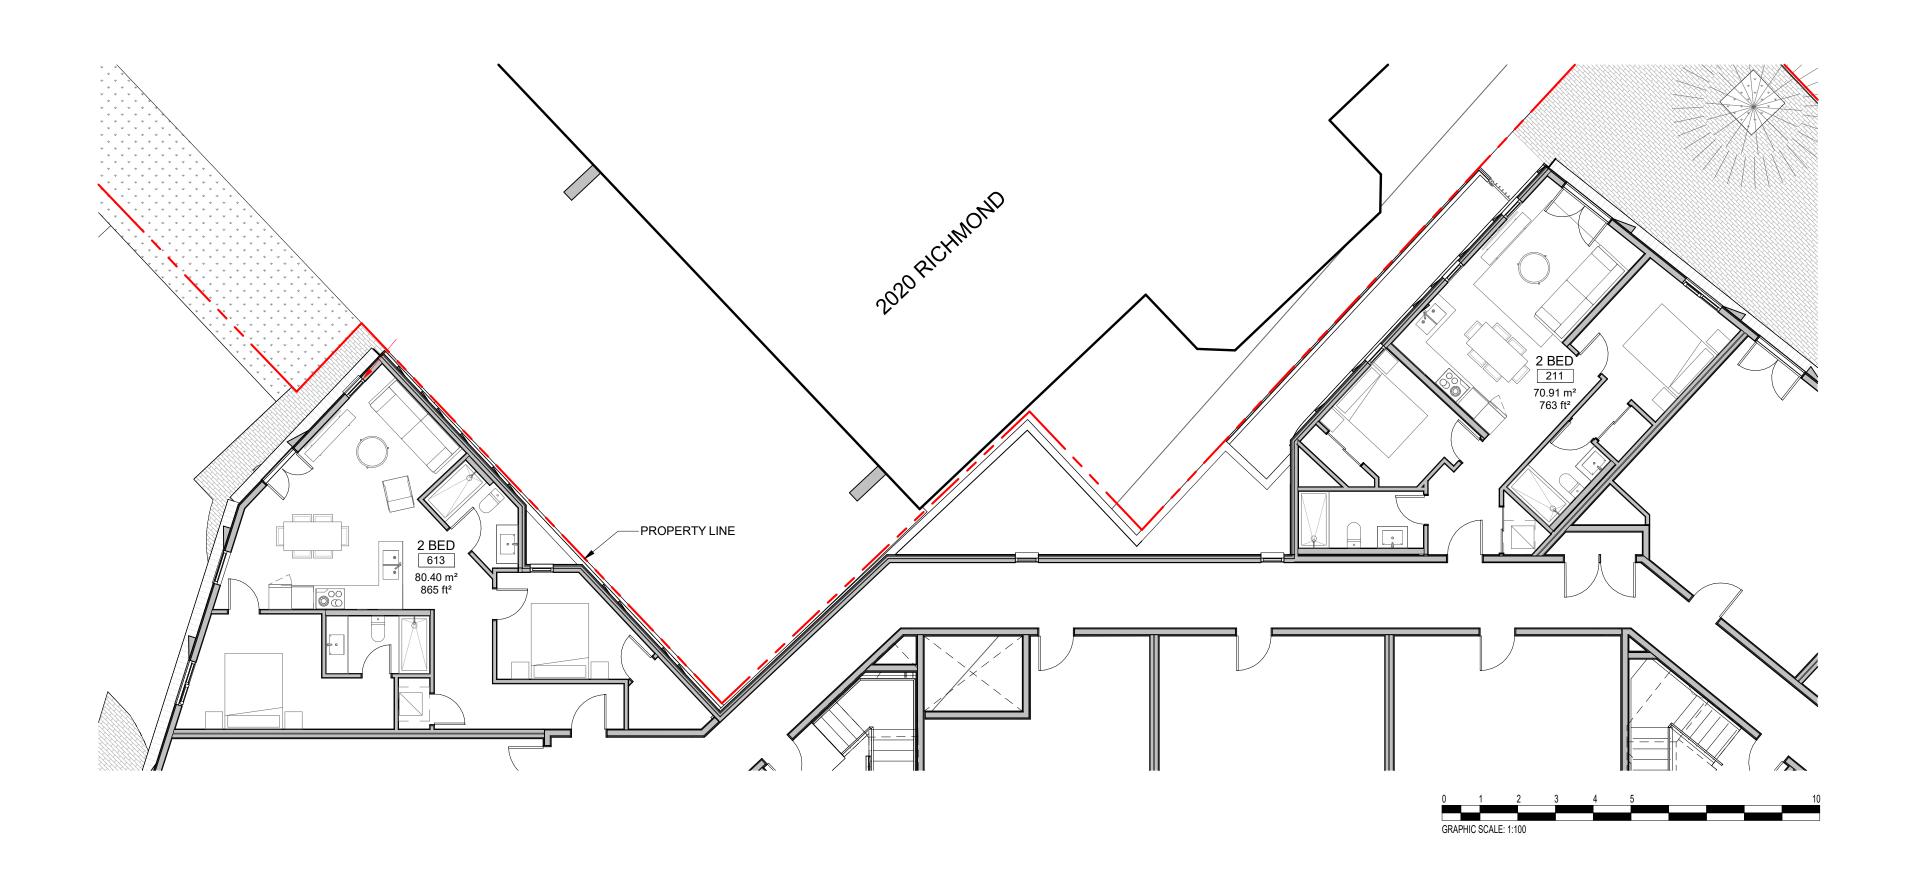

1 NORTH FACING ELEVATION FROM 2020 RICHMOND SITE SCALE = 1:100

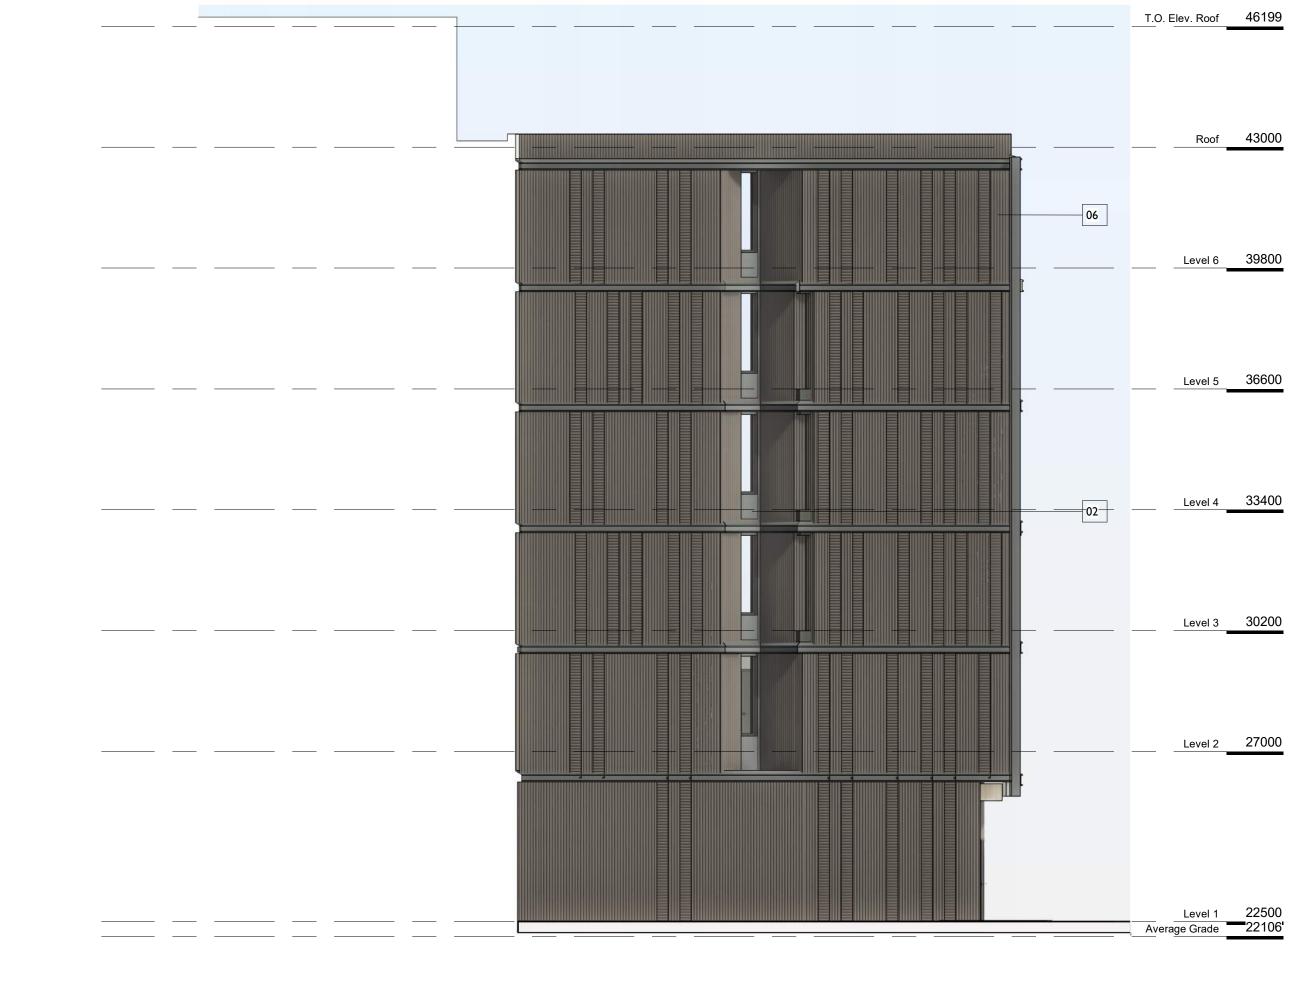



01 Metal Panel - Colour 01 02 Cementitous Panel - Dark Colour 02 03 Metal Picket - Dark Colour 02 04 Cast-in-place Arch. Concrete 05 Black tile 06 Metal Panel - Colour 02

MATERIALS LEGEND

07 Aluminum (Dark) pergola

08 Wood

09 Wood Soffit



Range of materials based on availability and cost: Illustrated are products from Pure + Freeform and Old Country Metals. Both offer custom products based on volume.

01





















2024.05.01

2024.02.09

2023.10.12

2023.08.04 DATE

CASCADIA ARCHITECTS INC



TURNER SITE

EMPRESA PROPERTIES

Elevations

2305

BC

2002 Richmond Rd, Victoria,





DP Rezoning Resubmission 2

DP Rezoning Resubmission

DP Rezoning Submission

Development Tracker

NO.

Sheet Name

Date

Scale

DESCRIPTION




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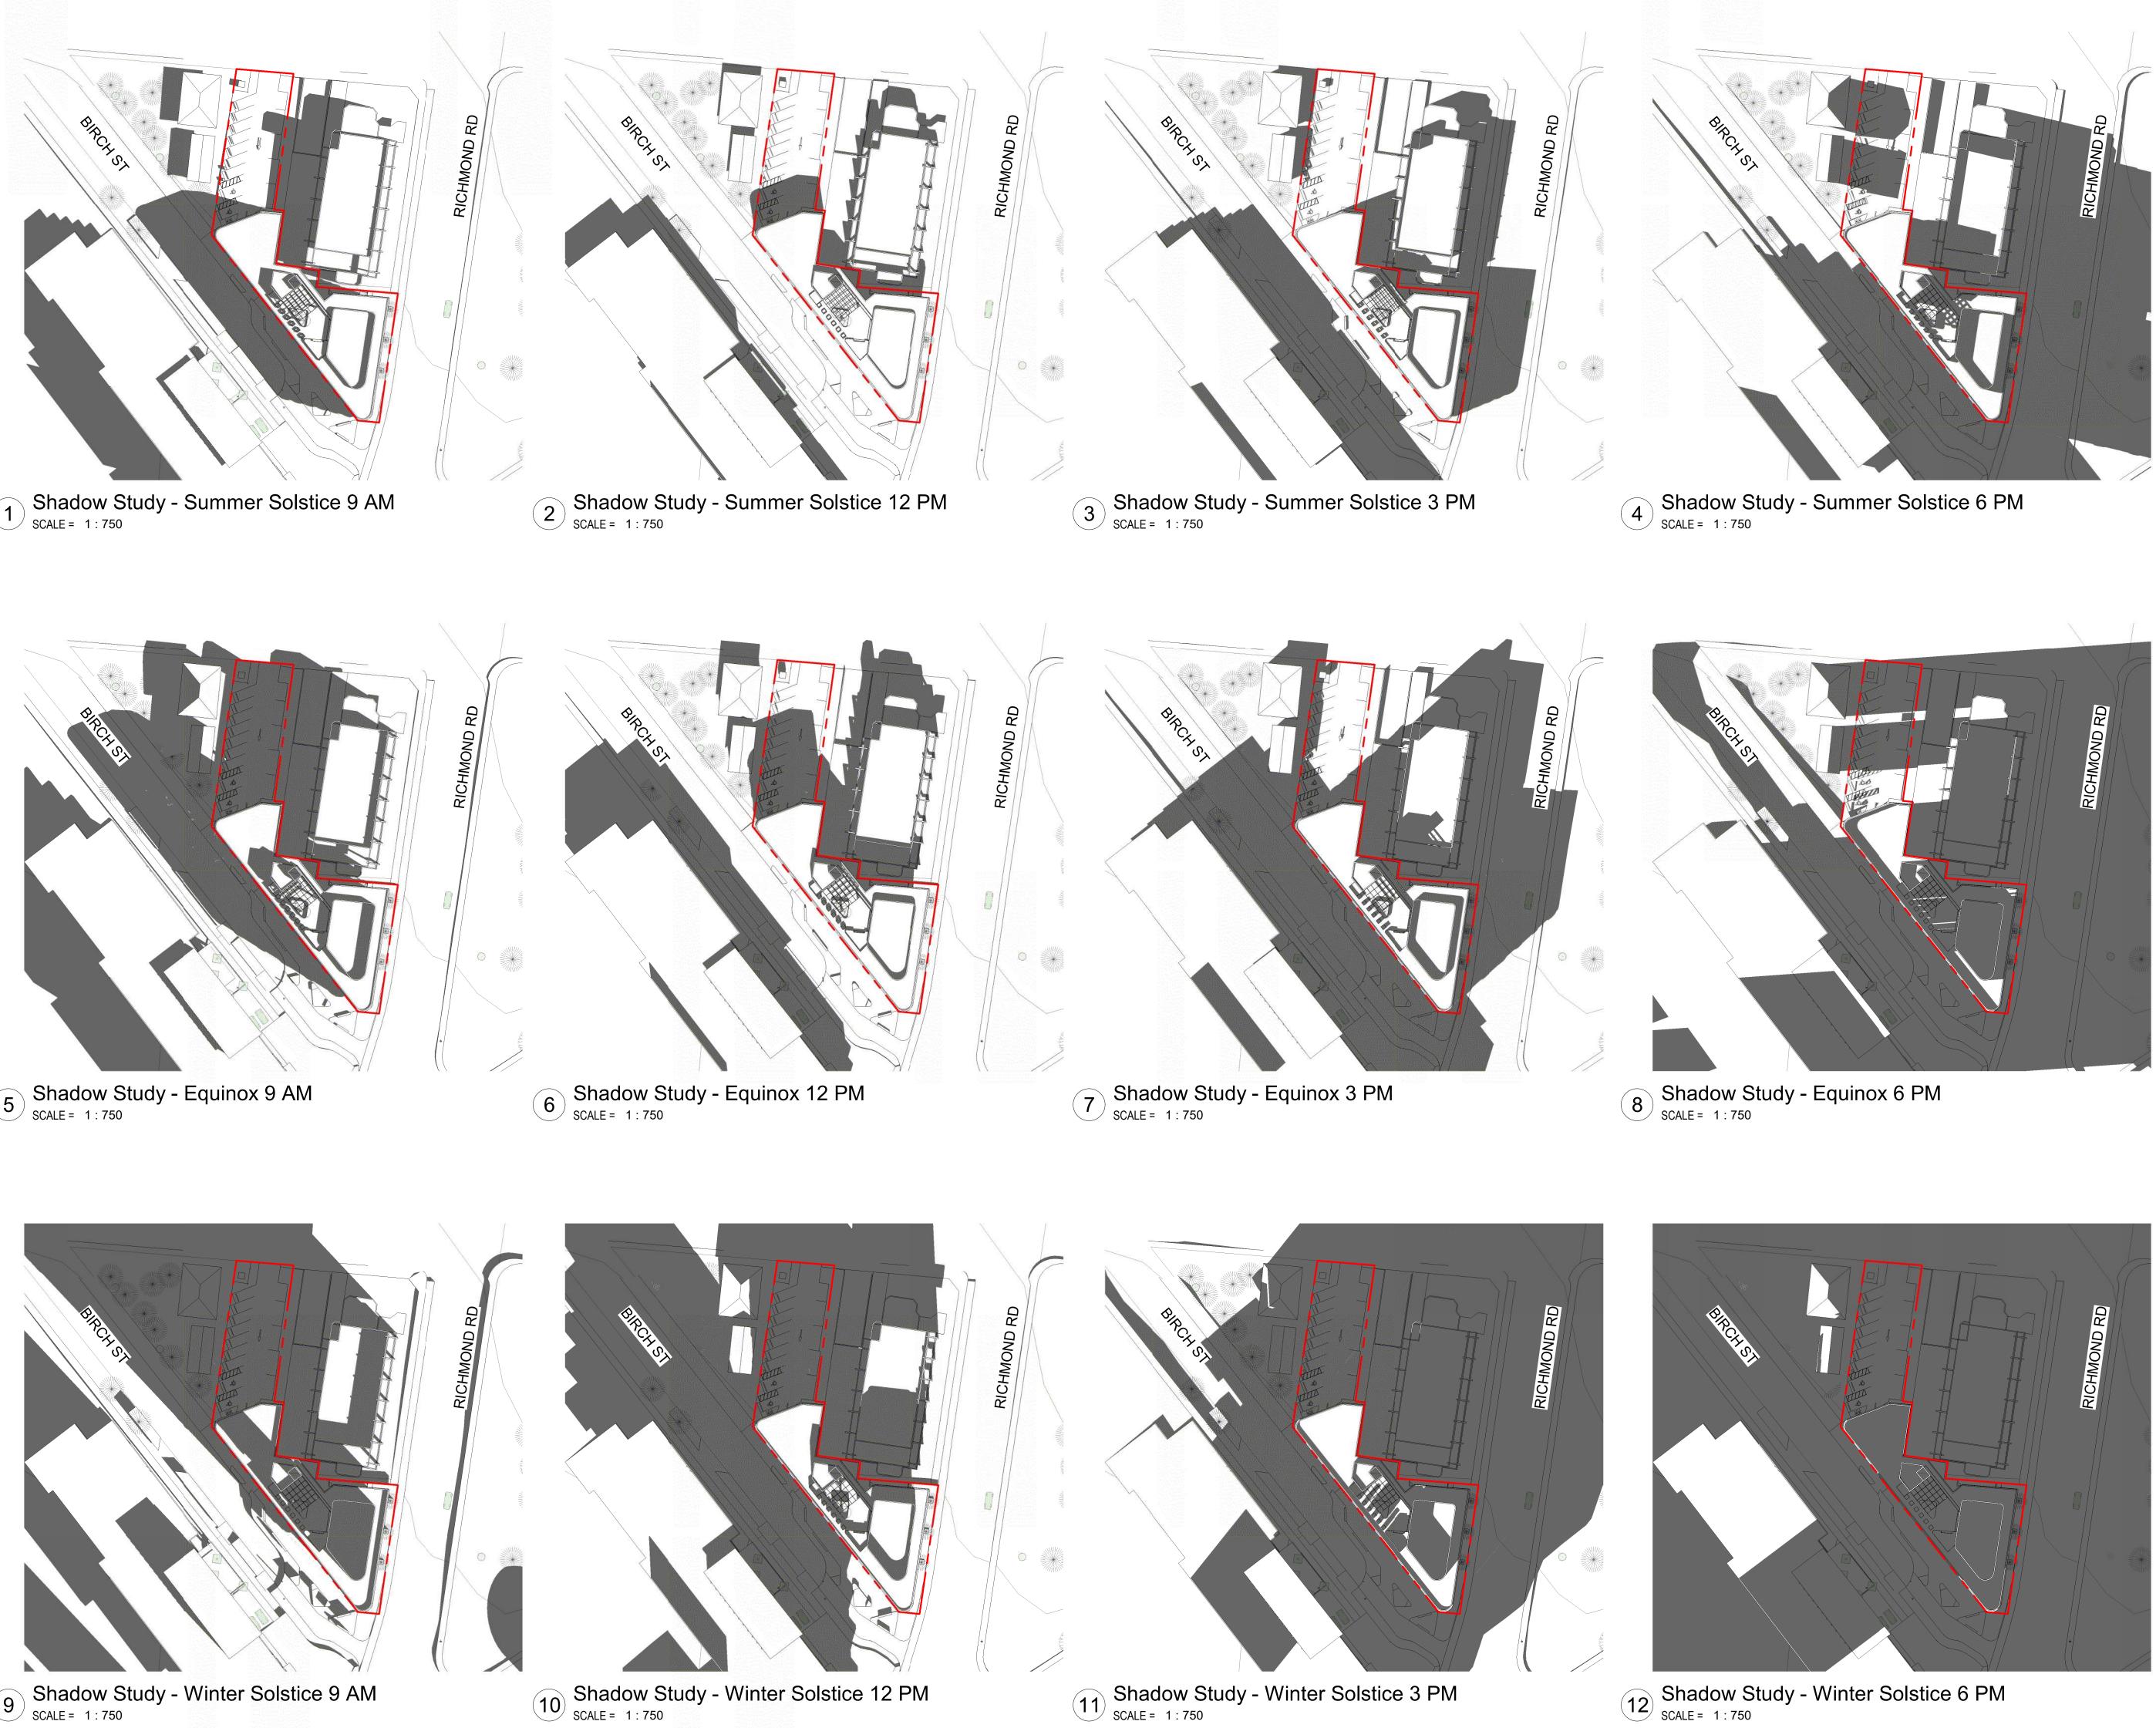
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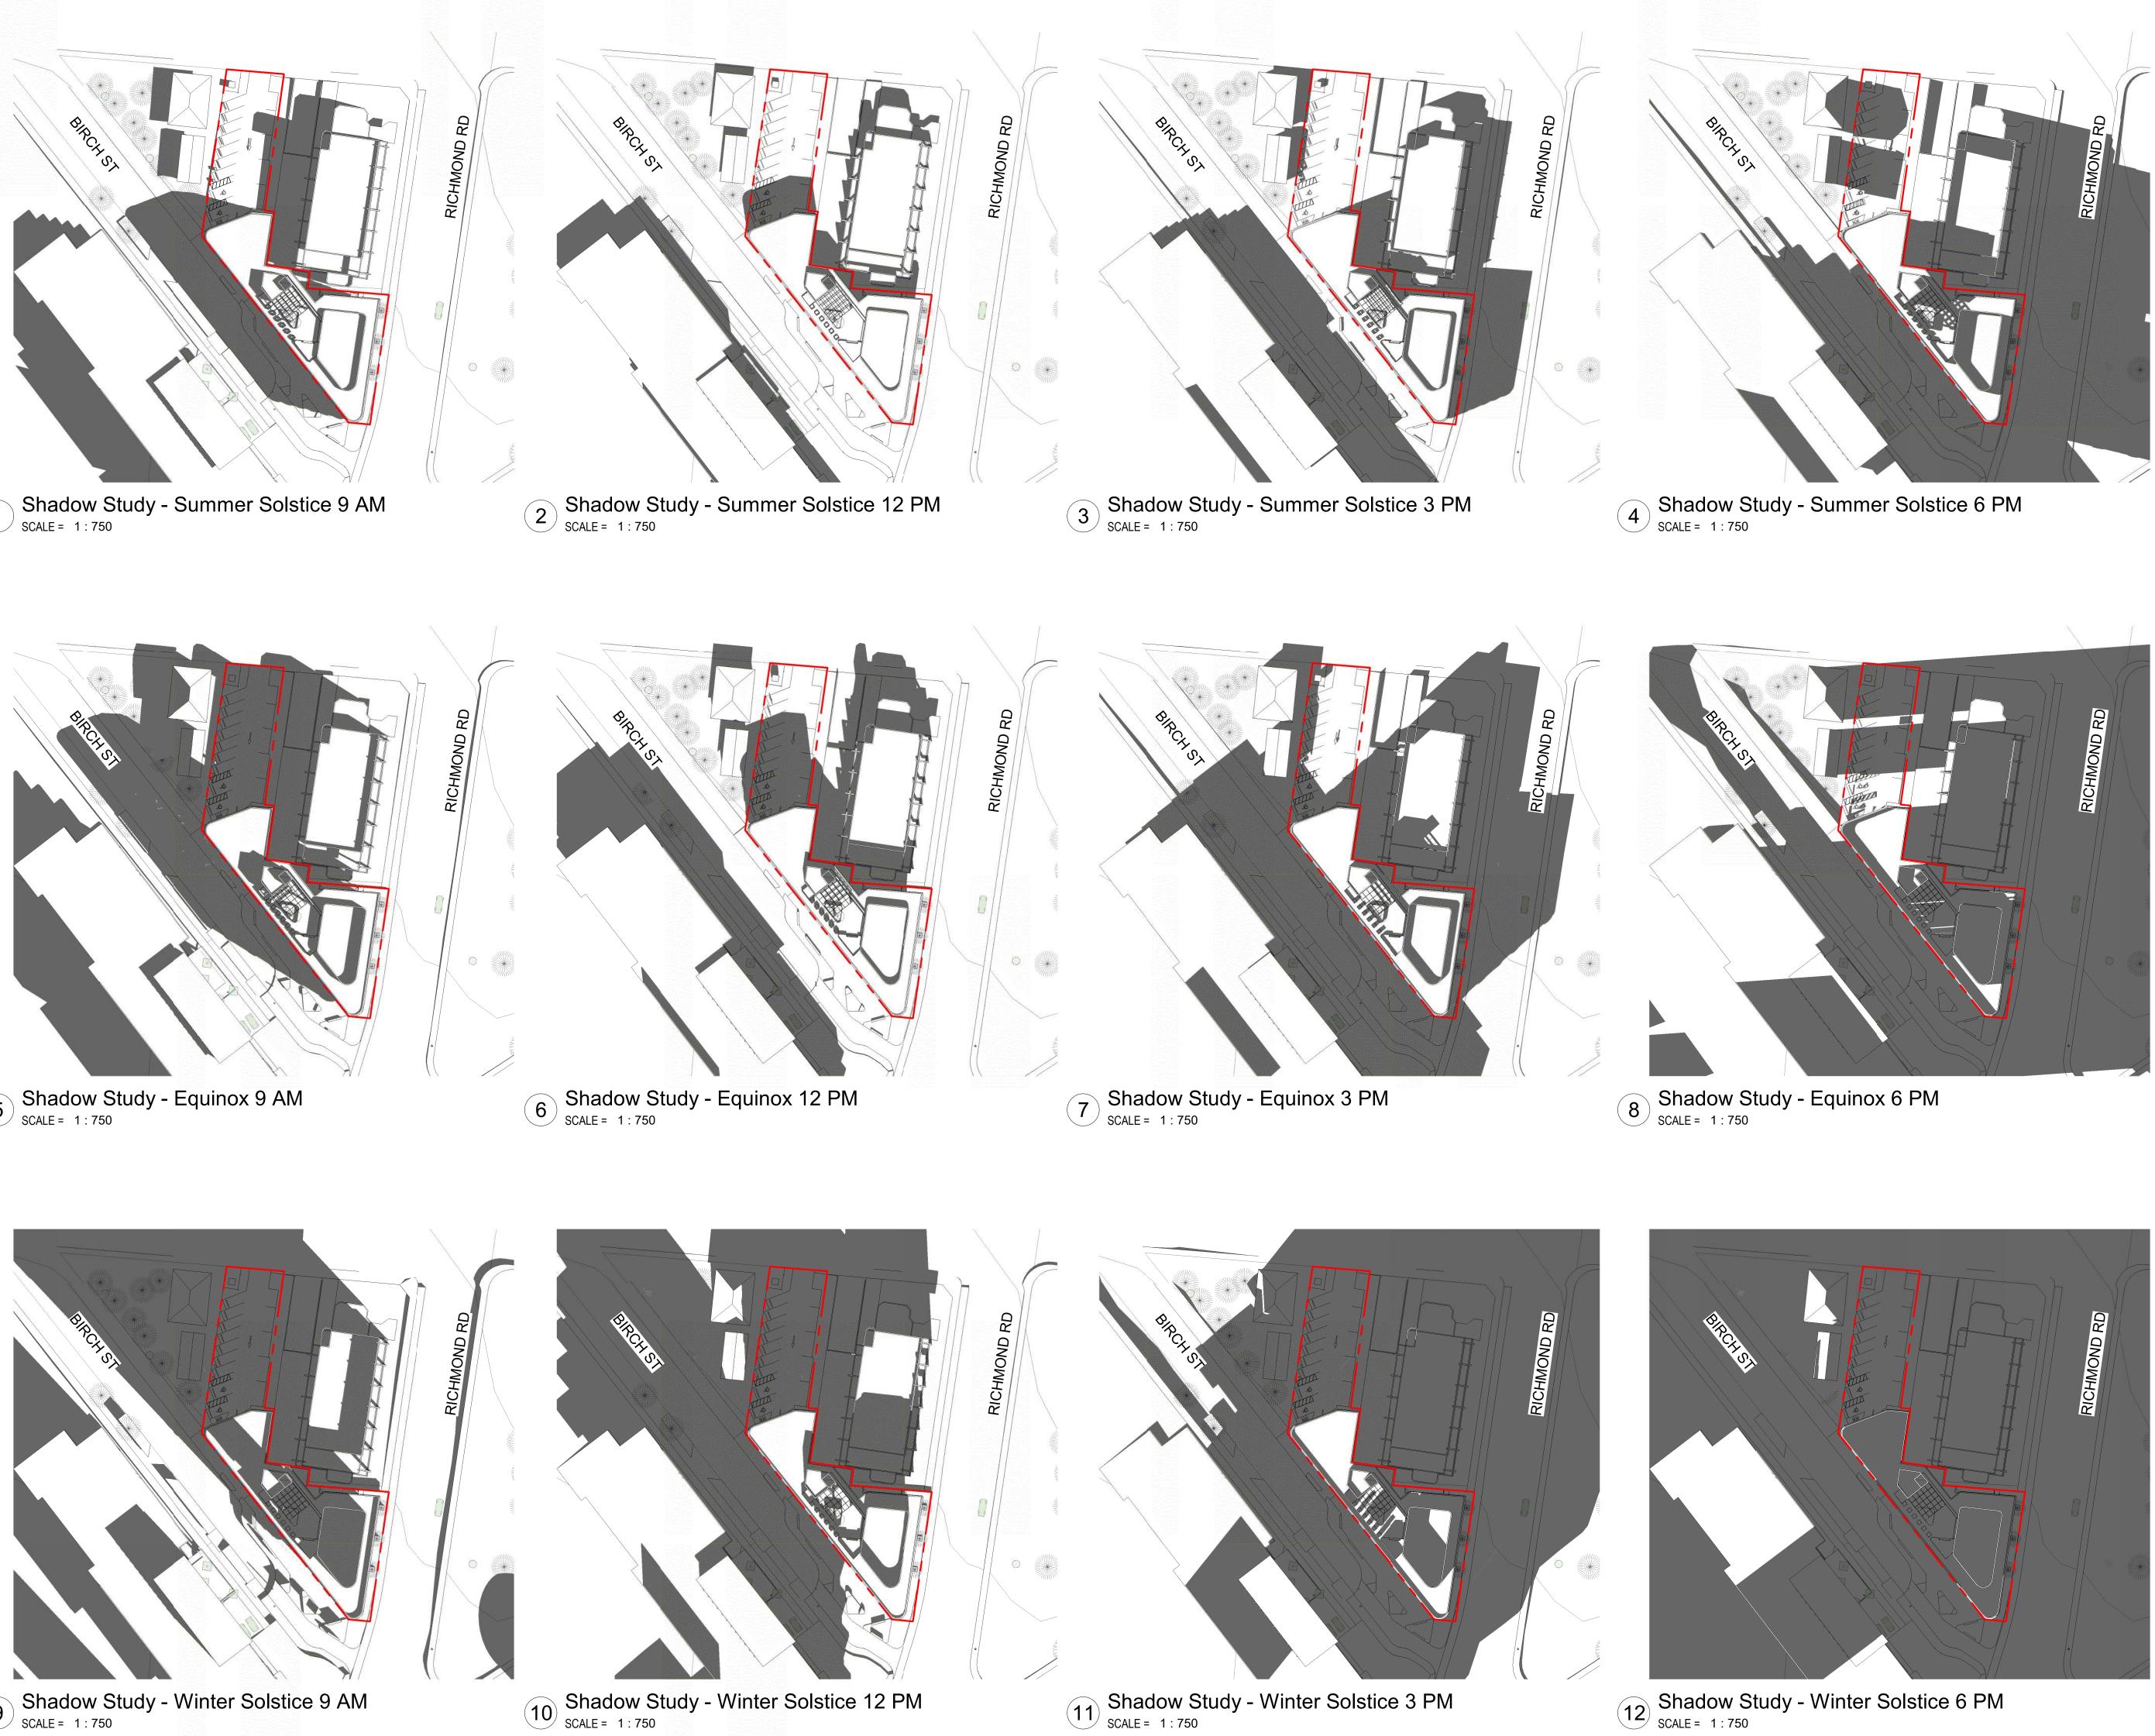
Revision

As indicated

REDAD





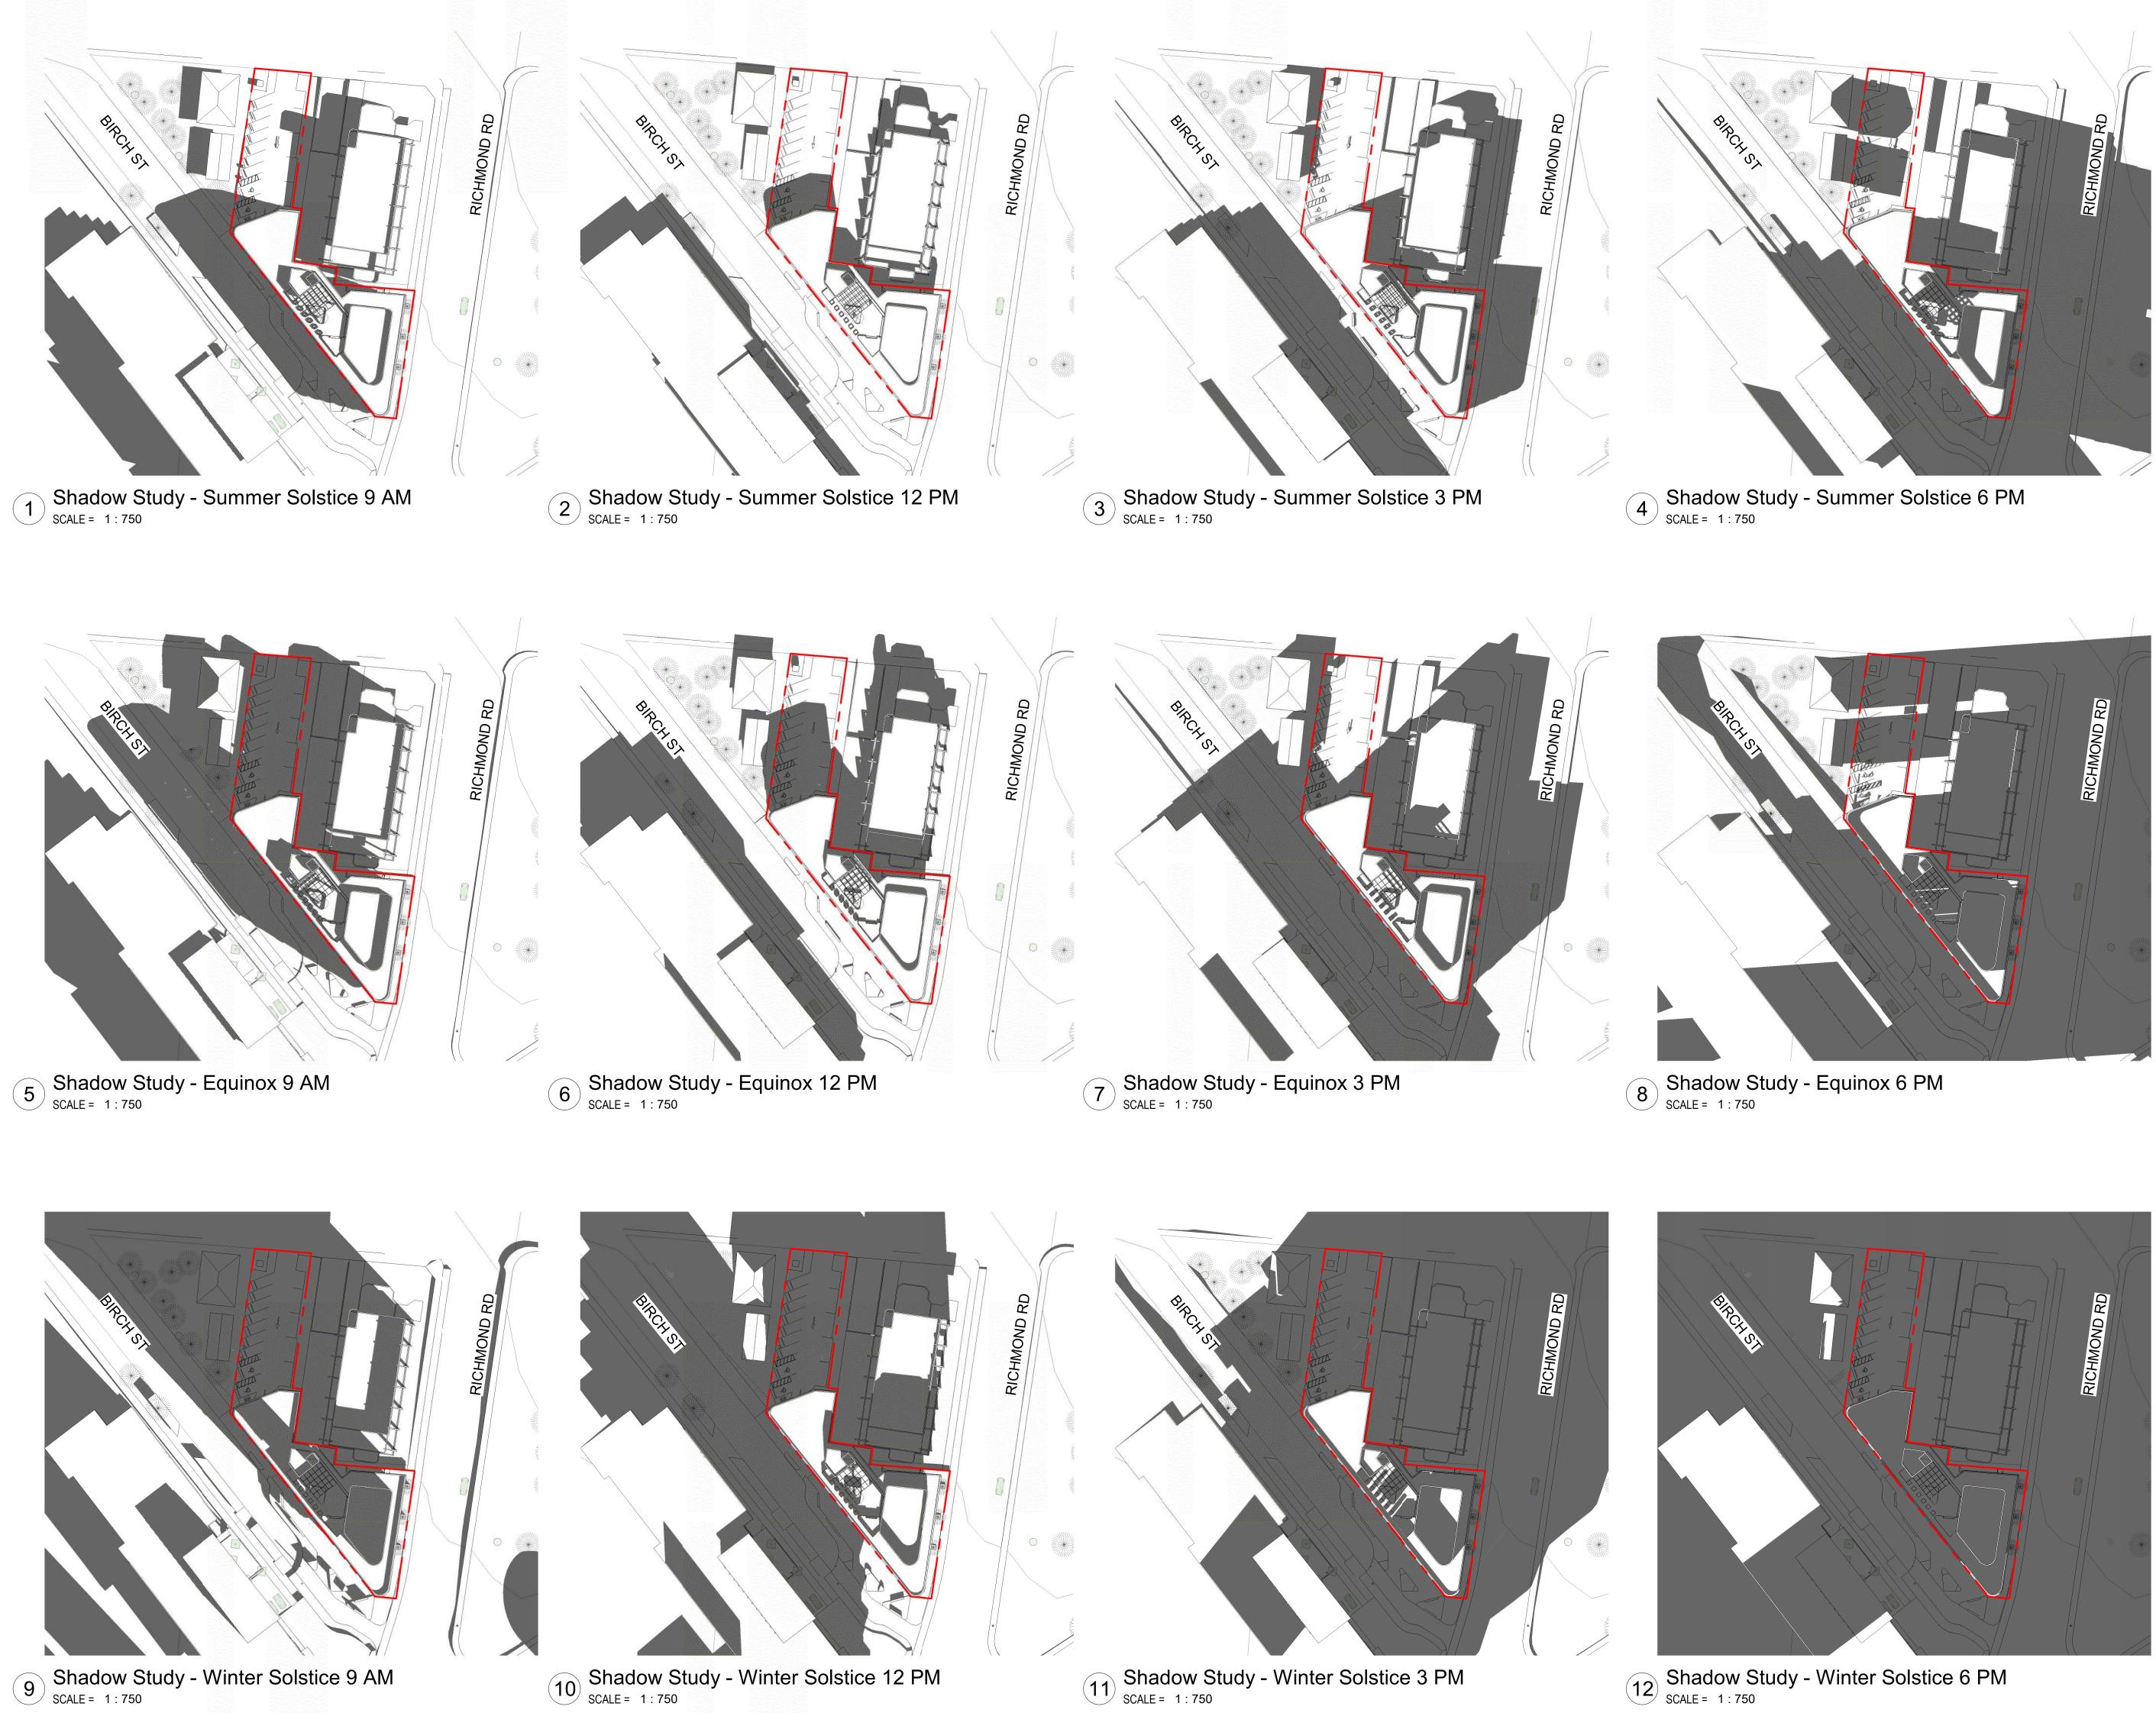



NO.	DESCRIPTION	DATE
1	Development Tracker	2023.08.04
2	DP Rezoning Submission	2023.10.12
3	DP Rezoning Resubmission	2024.02.09
4	DP Rezoning Resubmission 2	2024.05.01



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TURNER SITE

2002 RICHMOND RD. VICTORIA, BC

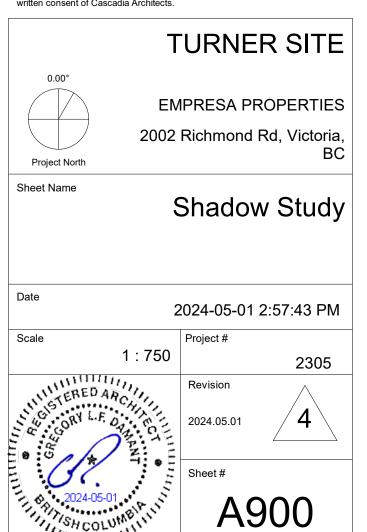SHEET LIST

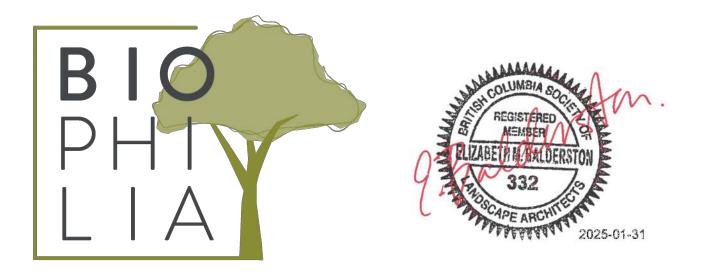L0.00 COVER PAGE

GENERAL LANDSCAPE NOTES

STANDARDS:

- 3. IN CASES OF CONFLICT BETWEEN THE BCLS AND THE MMCD STANDARDS, THE MORE STRINGENT REQUIREMENT WILL TAKE PRECEDENCE.
- SPECIFICATIONS. 5. GROWING MEDIUM AND GROWING MEDIUM TESTING TO MMCD AND BCLS SECTION 6.
- 6. IRRIGATION TO IIABC AND BCLS STANDARDS.





L0.01 TREE MANAGEMENT PLAN	L3.01 SOIL DEPTH PLAN - LEVEL 1
L0.02 TREE MANAGEMENT PLAN	L3.02 SOIL DEPTH PLAN - ROOFTOP
L1.01 MATERIALS PLAN - LEVEL 1	L3.11 SOIL CELLS PLAN - LEVEL 1
L1.02 MATERIALS PLAN - ROOFTOP	L3.21 STORMWATER MANAGEMENT PLAN - LEVEL1
L2.00 PLANTING SCHEDULE - LEVEL 1	L4.01 LIGHTING PLAN - LEVEL 1
L2.01 TREE PLANTING PLAN - LEVEL 1	L4.02 LIGHTING PLAN - ROOFTOP
L2.02 PLANTING PLAN - LEVEL 1	L5.01 SECTIONS
L2.03 TREE PLANTING PLAN - ROOFTOP	L6.01 DETAILS
L2.04 PLANTING PLAN - ROOFTOP	


1. ALL WORK ON MUNICIPAL PROPERTY TO CONFORM TO THE CITY OF VICTORIA DEVELOPMENT STANDARDS

2. ALL WORK ON THE DEVELOPMENT SITE TO CONFORM TO THE BC LANDSCAPE STANDARD (BCLS) AND THE MASTER MUNICIPAL CONSTRUCTION DOCUMENTS PLATINUM EDITION (MMCD) AND MMCD SUPPLEMENTAL DRAWINGS AND SPECIFICATIONS, UNLESS SPECIFICALLY STATED OTHERWISE IN WRITTEN SPECIFICATIONS AND ON DRAWINGS.

4. LANDSCAPE CONTRACTOR TO BE FAMILIAR WITH MUNICIPAL DEVELOPMENT STANDARDS AND BE IN POSSESSION OF THE BCLS AND MMCD MANUALS AND SUPPLEMENTAL DRAWINGS AND

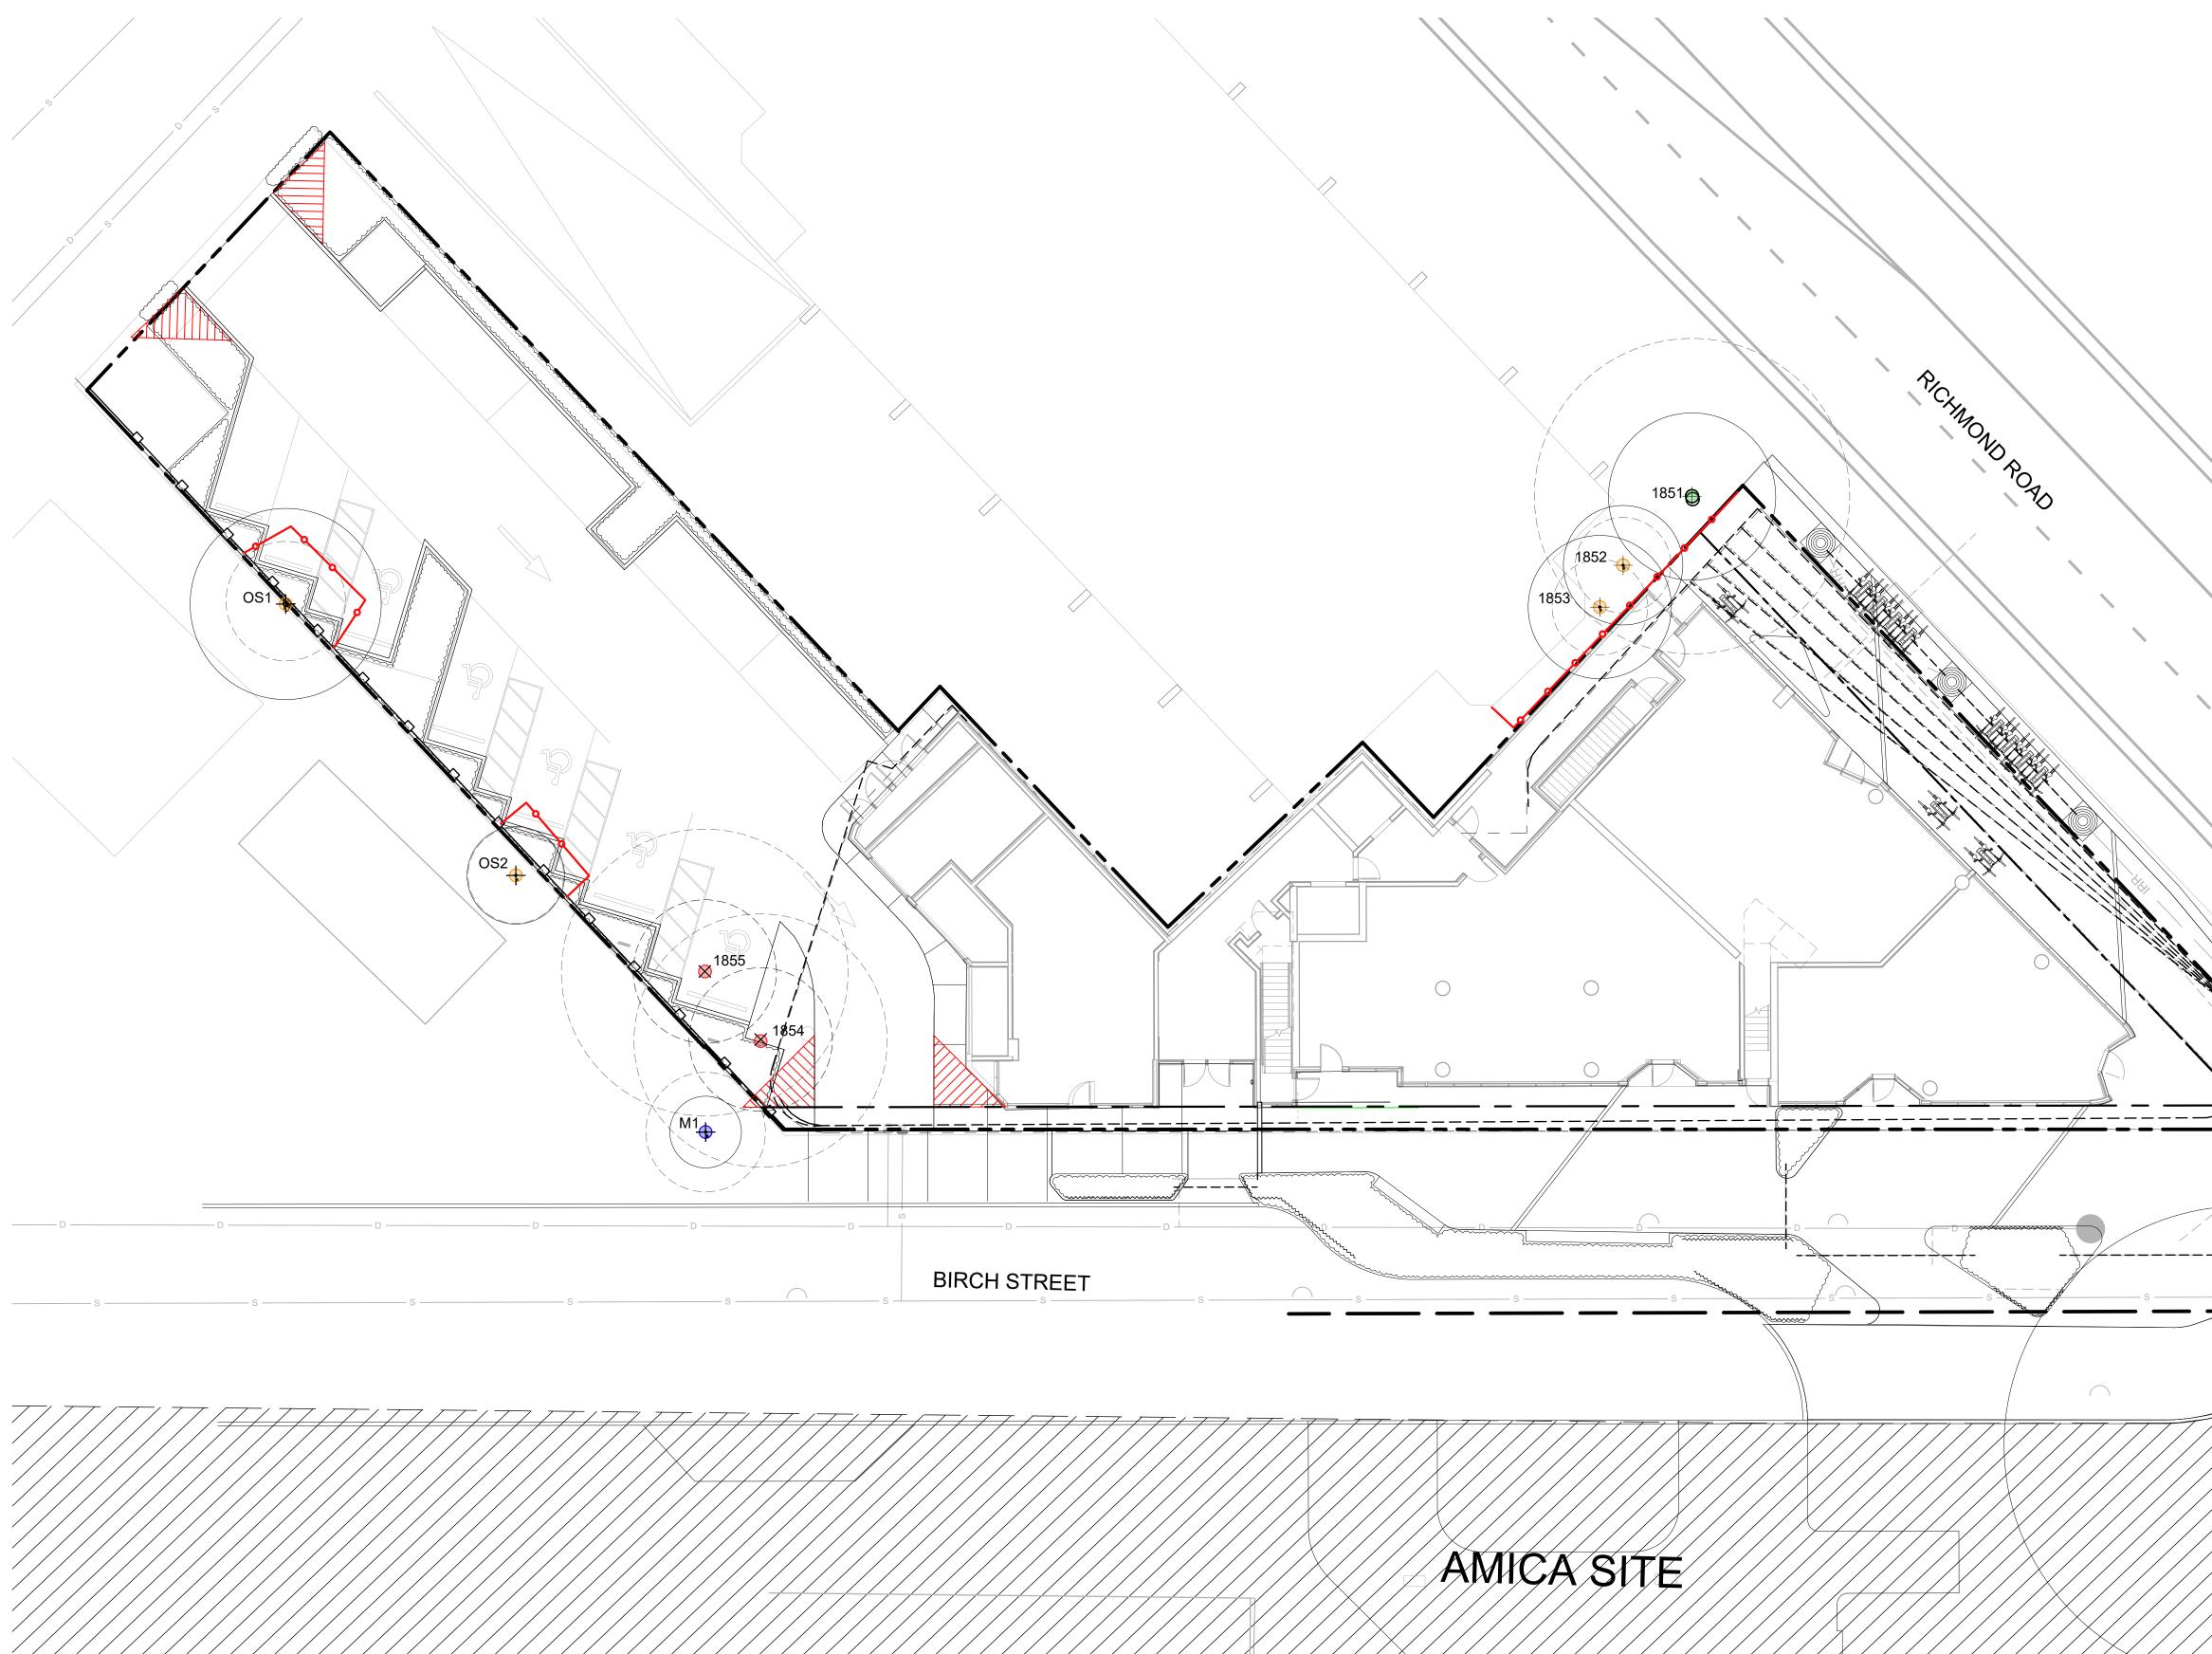


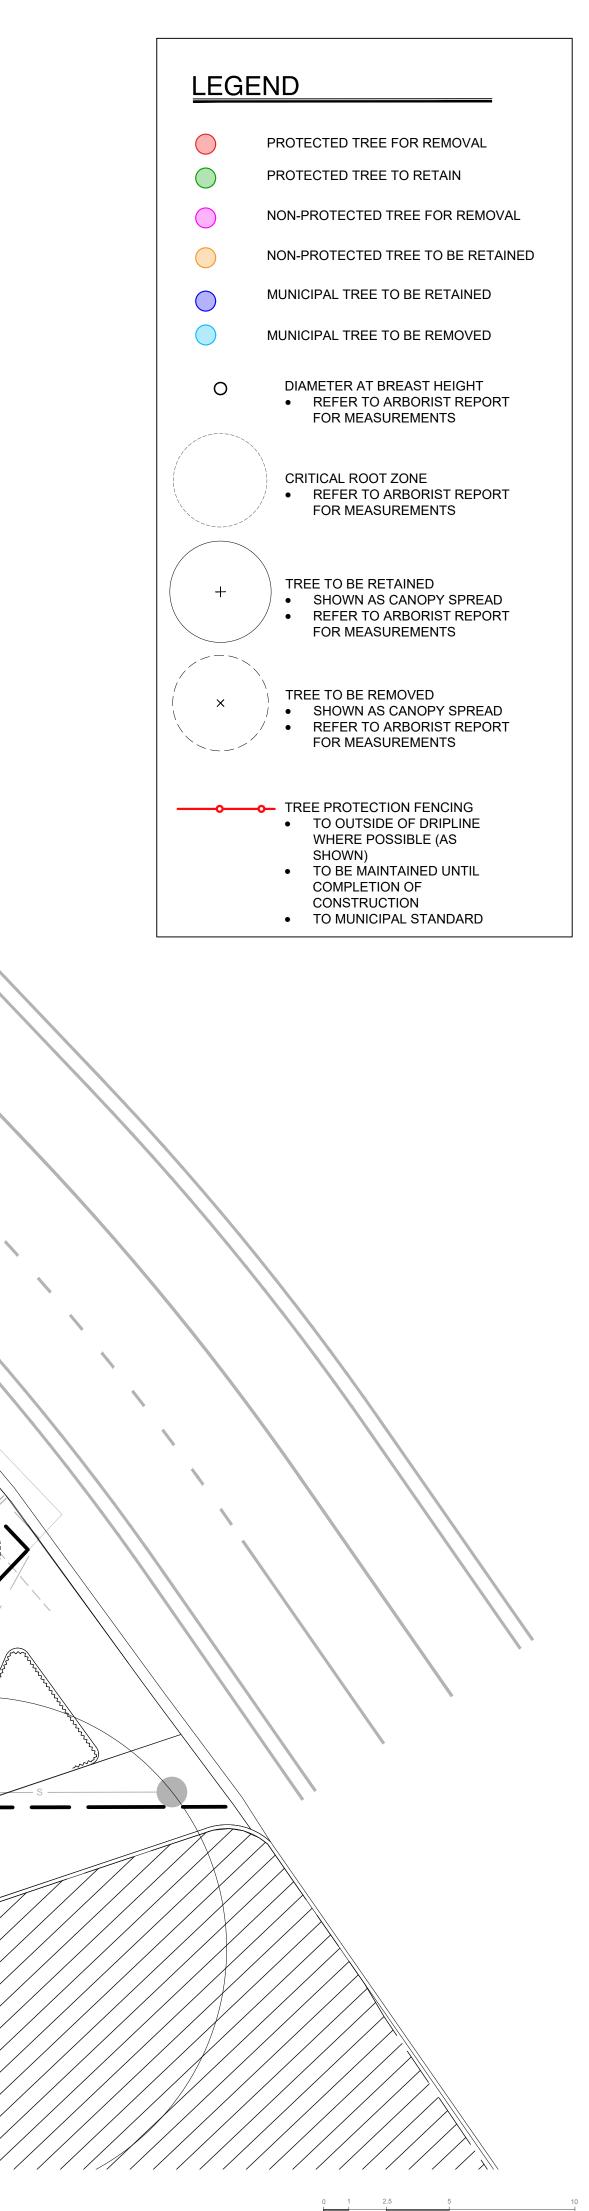

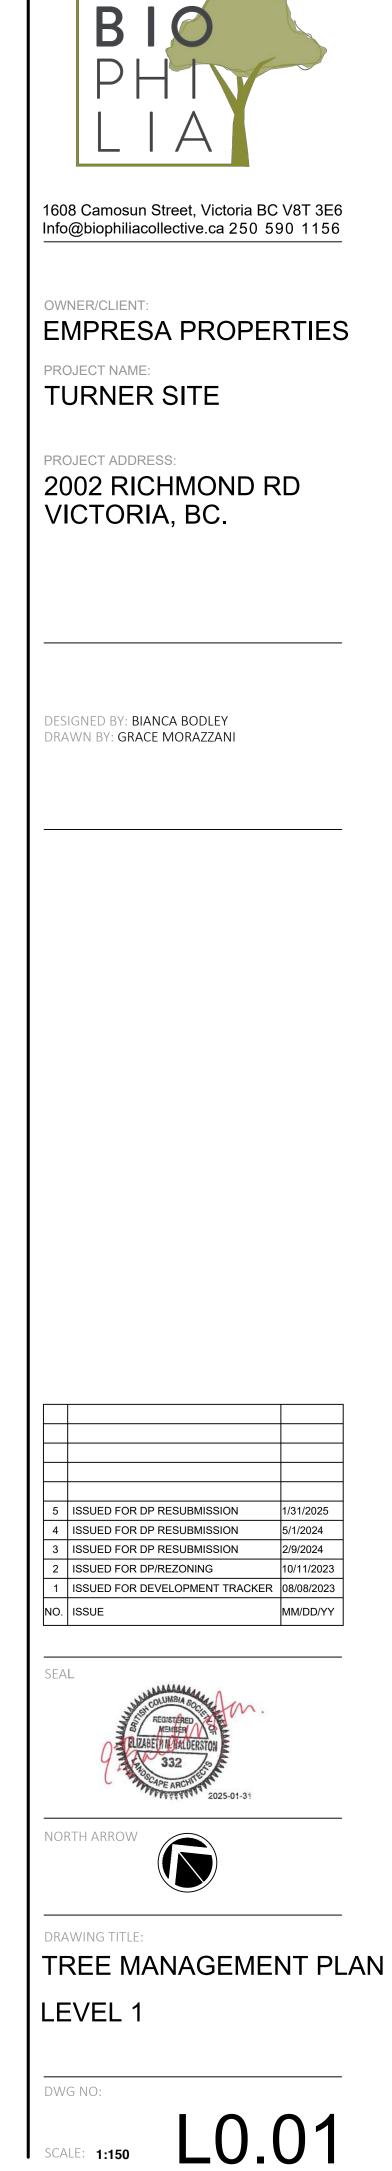

SCALE: 1:150

Table 1. Tree Inventory

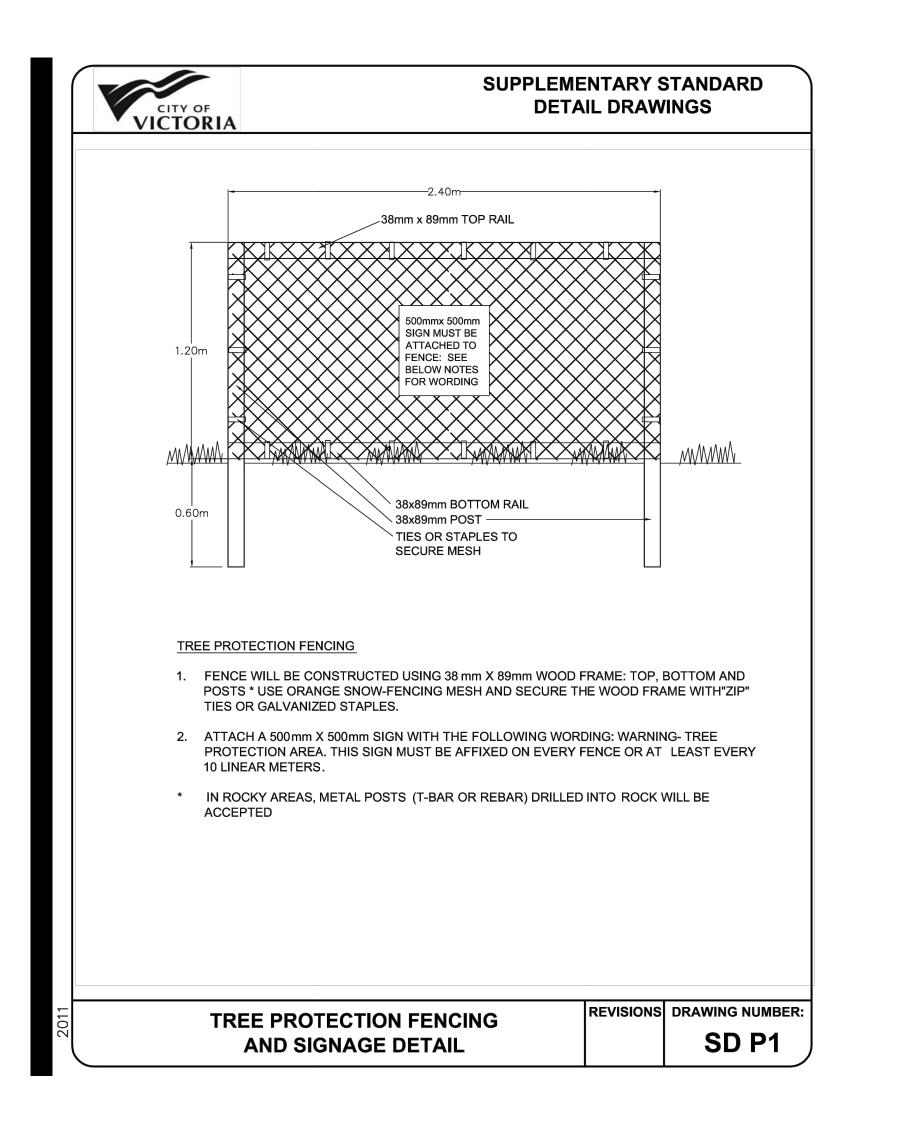

Tag #	Surve ? (Yes
1851	No
1852	Νο
1853	No
1854	Yes
1855	Yes
OS1	Yes
OS2	No
M1	Νο

Retention Location (On, Bylaw Off, Shared, protected crown Critical Name dbh Condition Relative Gener eyec radius root zone (cm) tolerance observ ? (Yes/No) City) (m) radius (m) Suitability Common Botanical Health Structural Fair-poor Moderate Suitable 55 3.5 6.6 Codom Off Norway Fair-Yes Maple inclusio good large s repeate Acer platanoides 7,4,4 2.5 2 Of No Acer palmatum Fair-Fair-poor | Moderate | Suitable | Multiple Japanese Maple 'Full | 'Full moon' good Moon' Multiple Off Acer palmatum 7,7,5 3 Fair Fair Moderate Suitable No Japanese 2 Maple 'Coral 'Coral Bark' overha Bark' Pear 44 3.5 5.3 Fair-poor | Fair-poor | Moderate | Suitable Dieback On Yes Pyrus spp. Pear 29,22 3 Fair Fair Moderate Suitable Codom On Yes 6 union, Pyrus spp. ~20 4 2.5 Fair Fair Drough Shared No Sycamore Acer Moderate Suitable Maple pseudoplatanus Golden Chain | Laburnum Off ~8,7 2 Fair Fair Moderate Suitable Co-dom No 2 Tree anagyroides remove 8,7,6 1.5 2.5 Of Golden Chain | Laburnum Decay Yes Fair-poor | Poor Moderate Suitable Tree anagyroides

ral field vations/remarks	Tree retention/location comments	Retention status
ninant structure with active ions, limited rooting area, surface roots topped tedly.	Root zone likely restricted to within planter, depending on depth of retaining wall. Will require significant pruning to accommodate new building, retention will depend on extent of pruning required.	Retain*
le stems, competing for light.	Root zone restricted to within planter. No impacts anticipated.	Retain
le stems, deadwood, angs existing balcony.	Root zone restricted to within planter. No impacts anticipated.	Retain
ck, deadwood.	Within proposed building area	Remove
ninant with included bark in small deadwood.	Within proposed parking area.	Remove
ht stress.	Shared tree, retention will depend on potential impacts from proposed parking area,	Retain*
minant 2 stems previously red.	Neighbours tree, retention will depend on potential impacts from proposed parking area.	Retain*
<i>r</i> at base, bark damage.	Municipal tree, should be possible to isolate it from construction activity.	Retain



1608 Camosun Street, Victoria BC V8T 3E6 Info@biophiliacollective.ca 250 590 1156

OWNER/CLIENT:

EMPRESA PROPERTIES

PROJECT NAME: **TURNER SITE**


PROJECT ADDRESS: 2002 RICHMOND RD VICTORIA, BC.

DESIGNED BY: BIANCA BODLEY DRAWN BY: GRACE MORAZZANI

5	ISSUED FOR DP RESUBMISSION	1/31/2025
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2	ISSUED FOR DP/REZONING	10/11/2023
1	ISSUED FOR DEVELOPMENT TRACKER	08/08/2023
NO.	ISSUE	MM/DD/YY

SEAL



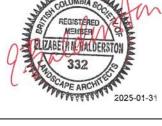



DRAWING TITLE:

TREE MANAGEMENT PLAN

LEVEL 1

DWG NO:

SCALE: 1:150 L0.02



JOHLDOLL LLVLLI			
CRIPTION	QTY	$\langle \cdot \rangle$	AMICA SITE PROPOSED TREES
g Type 1: CIP concrete	91.3 m²		
g Type 2: Concrete Unit Pavers edestrian grade	474.4 m²		PROPOSED TREES
g Type 3: Concrete Unit pavers ehicular grade	111.8 m²		
g Type 4: Stamped Pervious Concrete	455.5 m²		MOVABLE FURNITURE
ed areas efer to Planting plan ells	202.6 m²		SHORT TERM BIKE PARKING • SEE DETAILS



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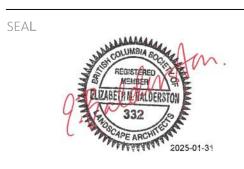
OWNER/CLIENT: EMPRESA PROPERTIES

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1	ISSUED FOR DEVELOPMENT TRACKER	08/08/2023
NO.	ISSUE	MM/DD/YY



NORTH ARROW



DRAWING TITLE: MATERIALS PLAN LEVEL 1

L1.01


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SCALE: 1:150



BBQ STAND


URBAN AGRICULTURE PLANTERS



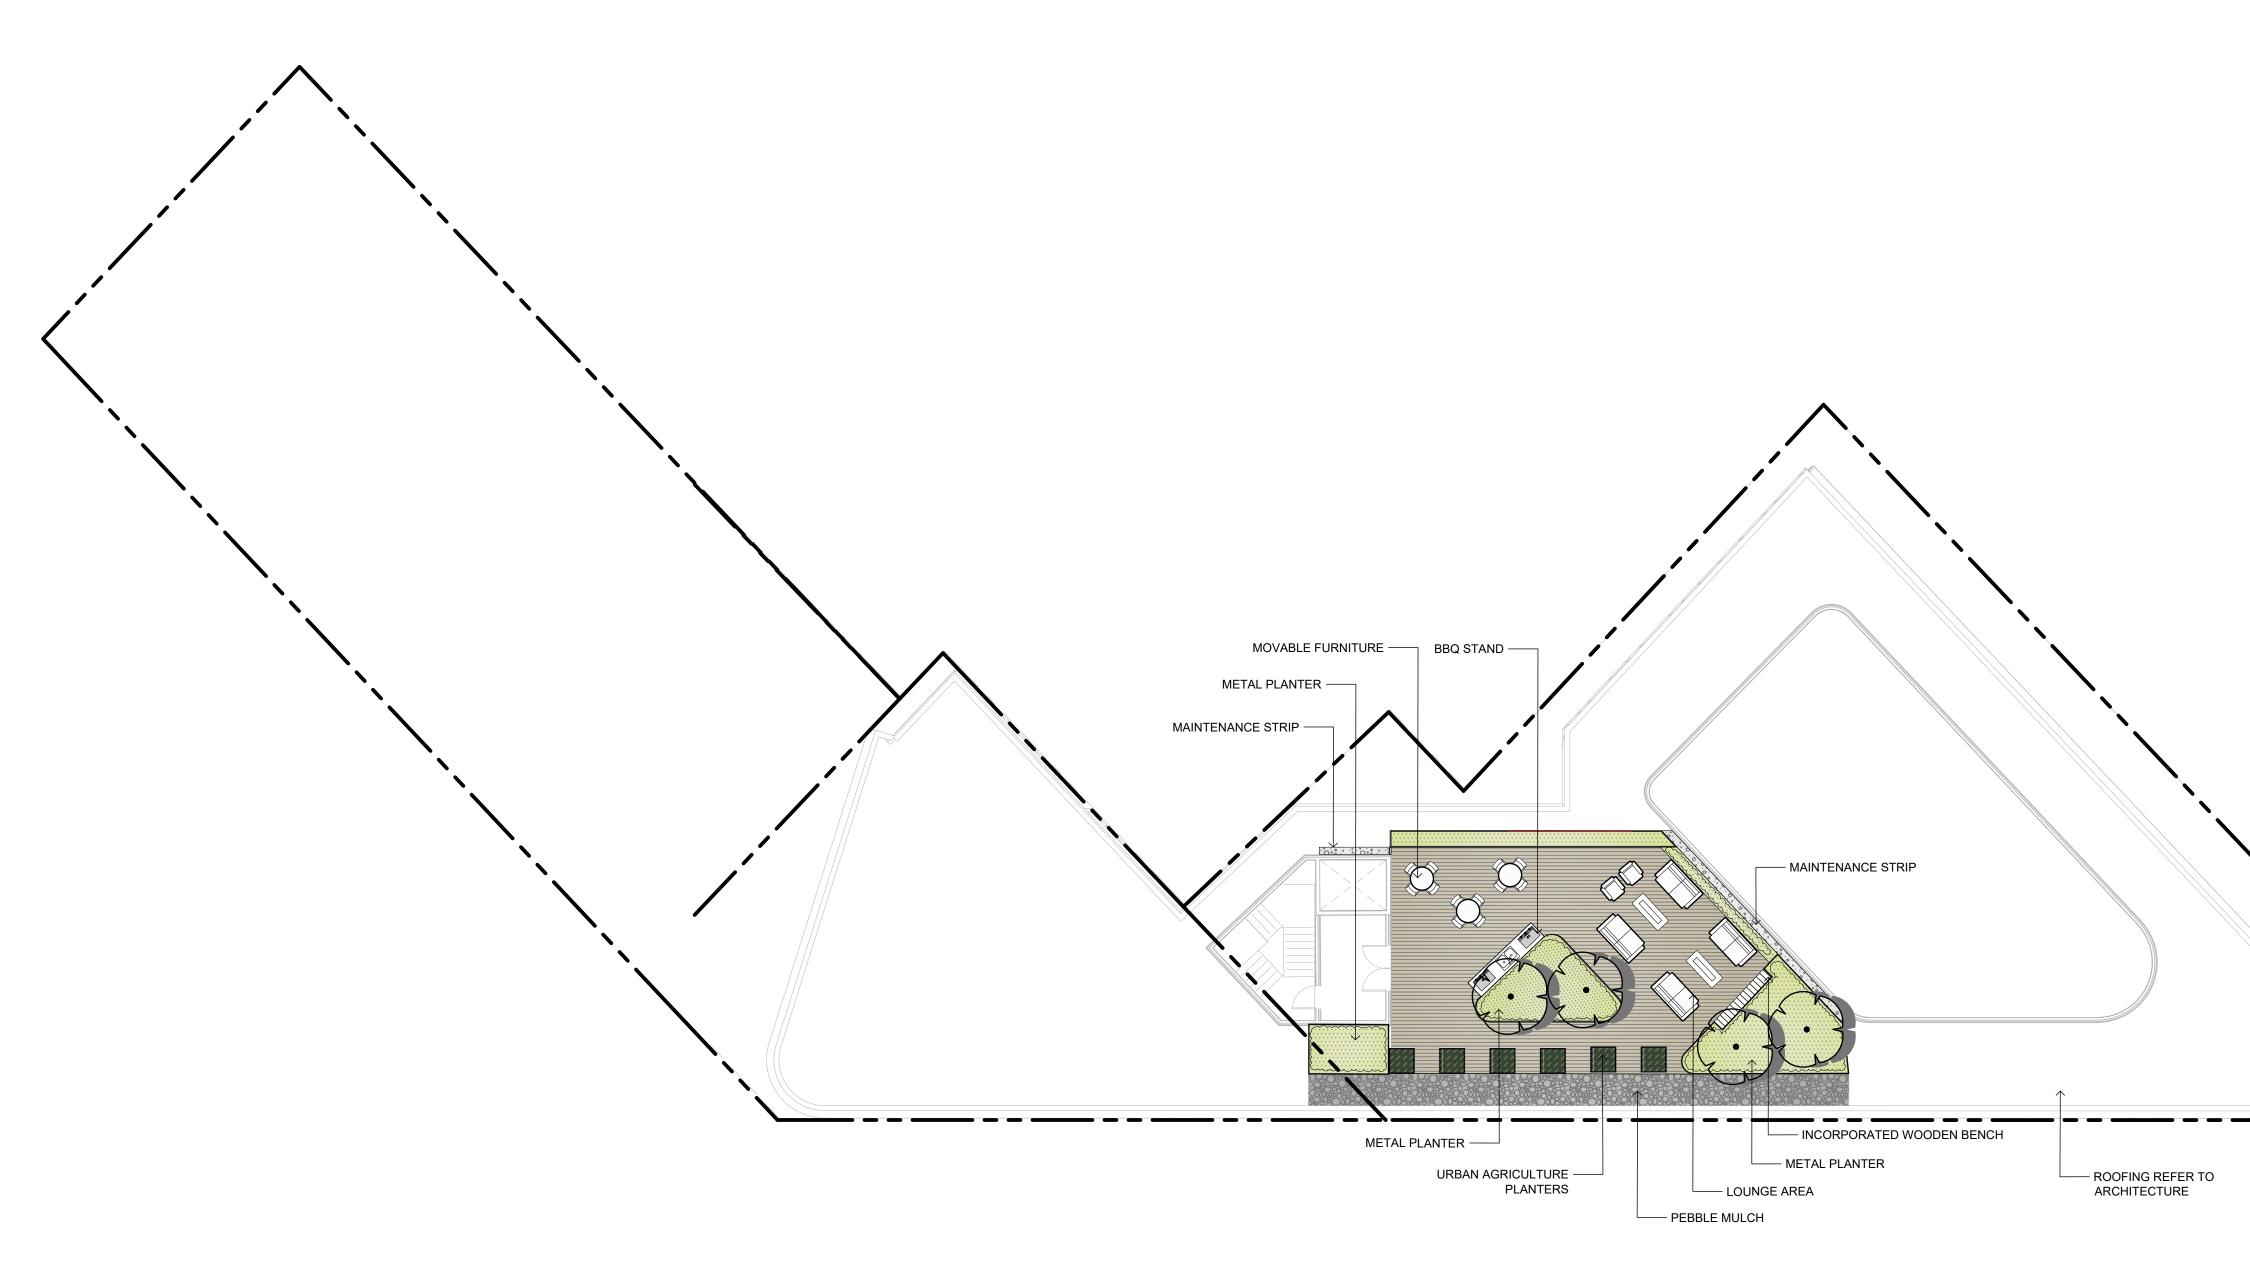


LOUNGE AREA

	QTY
Wooden Deck	94.2 m ²
	27.1 m ²
trip	3.9 m²
anting plan	47.3 m²
ıre	5.4 m²

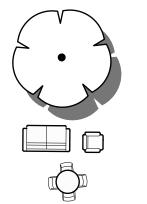

Proposed trees

Movable furniture

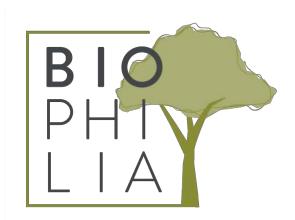

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OWNER/CLIENT: EMPRESA PROPERTIES PROJECT NAME:

TURNER SITE

PROJECT ADDRESS: 2002 RICHMOND RD VICTORIA, BC.

DESIGNED BY: **BIANCA BODLEY** DRAWN BY: **GRACE MORAZZANI**

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1	ISSUED FOR DEVELOPMENT TRACKER	08/08/2023
NO.	ISSUE	MM/DD/YY







NORTH ARROW



MATERIALS PLAN ROOFTOP









DRAWING TITLE:



L1.02

DWG NO: SCALE: 1:150



PLANT SCHEDULE LEVEL 1

SYMBOL	CODE	BOTANICAL / COMMON NAME	SIZE	SPACING	COMMENTS	QTY	REMARKS
TREES							
+	AR	Off-site medium tree	60mm Cal.	As Shown	B&B, Well Established	2	SPECIES TO BE DET
	AA	Off-site medium, vertical tree	60mm Cal.	As Shown	B&B, Well Established	3	SPECIES TO BE DET
(\cdot)	QG	Off-site large tree	60mm Cal.	As Shown	B&B, Well Established	4	SPECIES TO BE DET
	CJ	Cercidiphyllum japonicum / Katsura Tree	60mm Cal.	As Shown	B&B, Well Established	3	ON-SITE TREES
(+)	FD	Fagus sylvatica 'Dawyck Gold' / Dawyck Gold European Beech	60mm Cal.	As Shown	B&B, Well Established	2	ON-SITE TREE
SHRUBS							
$\overline{\bigcirc}$	СР	Cephalotaxus harringtonia 'Prostrata' / Prostrate Plum Yew	#2 POT	1000 mm.	Full, Well Established	1	EVERGREEN, DROU
\bigcirc	Нр	Hebe pinguifolia `Sutherlandii` / Sutherland Hebe	#2 POT	1000 mm.	Full, Well Established	24	EVERGREEN
+,	Lh	Ligustrum vulgare 'Swift' / First Editions® Straight Talk® Privet	#2 POT	800mm	Full, Well Established	46	SEMI-EVERGREEN,
(\cdot)	Рс	Prostanthera cuneata / Alpine Mint Bush	#2 POT	1200mm	Full, Well Established	1	POLINATOR SUPPO
GRASSES							
	Ck2	Calamagrostis x acutiflora 'Karl Foerster' / Karl Foerster Feather Reed Grass	#2 POT	600mm	Full, Well Established	56	POLINATOR SUPPO
······································	ML	Miscanthus sinensis 'Little Kitten' / Little Kitten Eulalia Grass	#1 POT	450mm	Full, Well Established	77	POLINATOR SUPPO
{· }	SG	Stipa gigantea / Giant Feather Grass	#2 POT	750mm	Full, Well Established	41	POLINATOR SUPPO
	LS						
(\cdot)	AG2	Allium x 'Globemaster' / Globemaster Ornamental Onion	#1 POT	600mm	Full, Well Established	18	POLINATOR SUPPO
(\cdot)	EB	Echinops bannaticus 'Blue Glow' / Blue Glow Globe Thistle	#1 POT	600mm	Full, Well Established	16	POLINATOR SUPPO
(\cdot)	Es	Erica carnea 'Springwood White' / White Spring Winter Heath	#1 POT	450mm	Full, Well Established	10	POLINATOR SUPPO
	NP	Nepeta x faassenii 'Purrsian Blue' / Purrsian Blue Catmint	#1 POT	750mm	Full, Well Established	27	POLINATOR SUPPO
Contraction of the second seco	PA	Perovskia atriplicifolia / Russian Sage	#2 POT	900mm	Full, Well Established	13	POLINATOR SUPPO
\odot	RH	Rudbeckia hirta / Black-eyed Susan	#1 POT	600mm	Full, Well Established	70	POLINATOR SUPPO
$\mathbf{\dot{\cdot}}$	SC	Salvia nemorosa 'Caradonna' / Cardonna Meadow Sage	#1 POT	600mm	Full, Well Established	26	POLINATOR SUPPO
500 - 100 -	SC2	Santolina chamaecyparissus / Lavender Cotton	#1 POT	450mm	Full, Well Established	153	POLINATOR SUPPO
$\overline{\mathbf{\cdot}}$	Тр	Thymus pseudolanuginosus / Woolly Thyme	#1 POT	300mm	Full, Well Established	149	POLINATOR SUPPO
+	VB	Verbena bonariensis / Tall Verbena	#1 POT	750mm	Full, Well Established	21	POLINATOR SUPPC
+	Vp	Veronica peduncularis 'Georgia Blue' / Georgia Blue Speedwell	#1 POT	450mm	Full, Well Established	13	POLINATOR SUPPC

A TOTAL OF 86.5% OF THE ON-SITE PLANTING PROVIDES POLLINATOR SUPPORT AS REQUIRED PER THE DESIGN GUIDELINES FOR: MULTI-UNIT RESIDENTIAL, COMMERCIAL, AND INDUSTRIAL (2019).

PLANTING PLAN NOTES

- 1. ALL PLANT MATERIAL TO BCSLA STANDARDS.
- 2. THE SEARCH ARE FOR PLANT MATERIAL IS THE PACIFIC NORTHWEST INCLUDING WASHINGTON, OREGON AND BRITISH COLUMBIA.
- 3. CONFIRM PLANTING LAYOUT WITH LANDSCAPE ARCHITECT ON SITE. 4. ALL SOIL VOLUMES TO MEET THE STANDARDS OF THE CITY OF VICTORIA. REFER TO SOIL DEPTH PLANS FOR SOIL DEPTH REQUIREMENTS.
- 5. ALL GROWING MEDIUM PROVISION AND INSTALLATION TO BE IN LINE WITH CANADIAN LANDSCAPE STANDARDS
- 6. ALL LANDSCAPE AREAS TO BE IRRIGATED BY AN UNDERGROUND AUTOMATIC IRRIGATION SYSTEM
- 7. IF REQUIRED, MUNICIPAL BOULEVARD TO BE IRRIGATED BY A SEPARATE SYSTEM FROM A SEPARATE MUNICIPAL SOURCE.

2025-01-15 18:28

E DETERMINED BY PARKS AT BP

E DETERMINED BY PARKS AT BP

E DETERMINED BY PARKS AT BP

DROUGHT TOLERANT

EEN, DROUGHT TOLERANT SUPPORT, EVERGREEN, DROUGHT TOLERANT

SUPPORT, DROUGHT TOLERANT

SUPPORT, DROUGHT TOLERANT

SUPPORT, DROUGHT TOLERANT, EVERGREEN

SUPPORT, DROUGHT TOLERANT

SUPPORT, DROUGHT TOLERANT

SUPPORT, EVERGREEN

SUPPORT, DROUGHT TOLERANT

SUPPORT, DROUGHT TOLERANT, SEMI-EVERGREEN

SUPPORT, DROUGHT TOLERANT


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SUPPORT, DROUGHT TOLERANT, EVERGREEN

SUPPORT, DROUGHT TOLERANT, EVERGREEN

SUPPORT, DROUGHT TOLERANT, EVERGREEN

SUPPORT, DROUGHT TOLERANT, SEMI-EVERGREEN

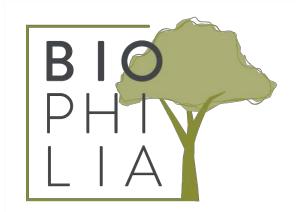

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NO.	ISSUE	MM/DD/YY

PLANTING SCHEDULE

1200

SEAL

NORTH ARROW

DRAWING TITLE:

LEVEL 1

DWG NO:


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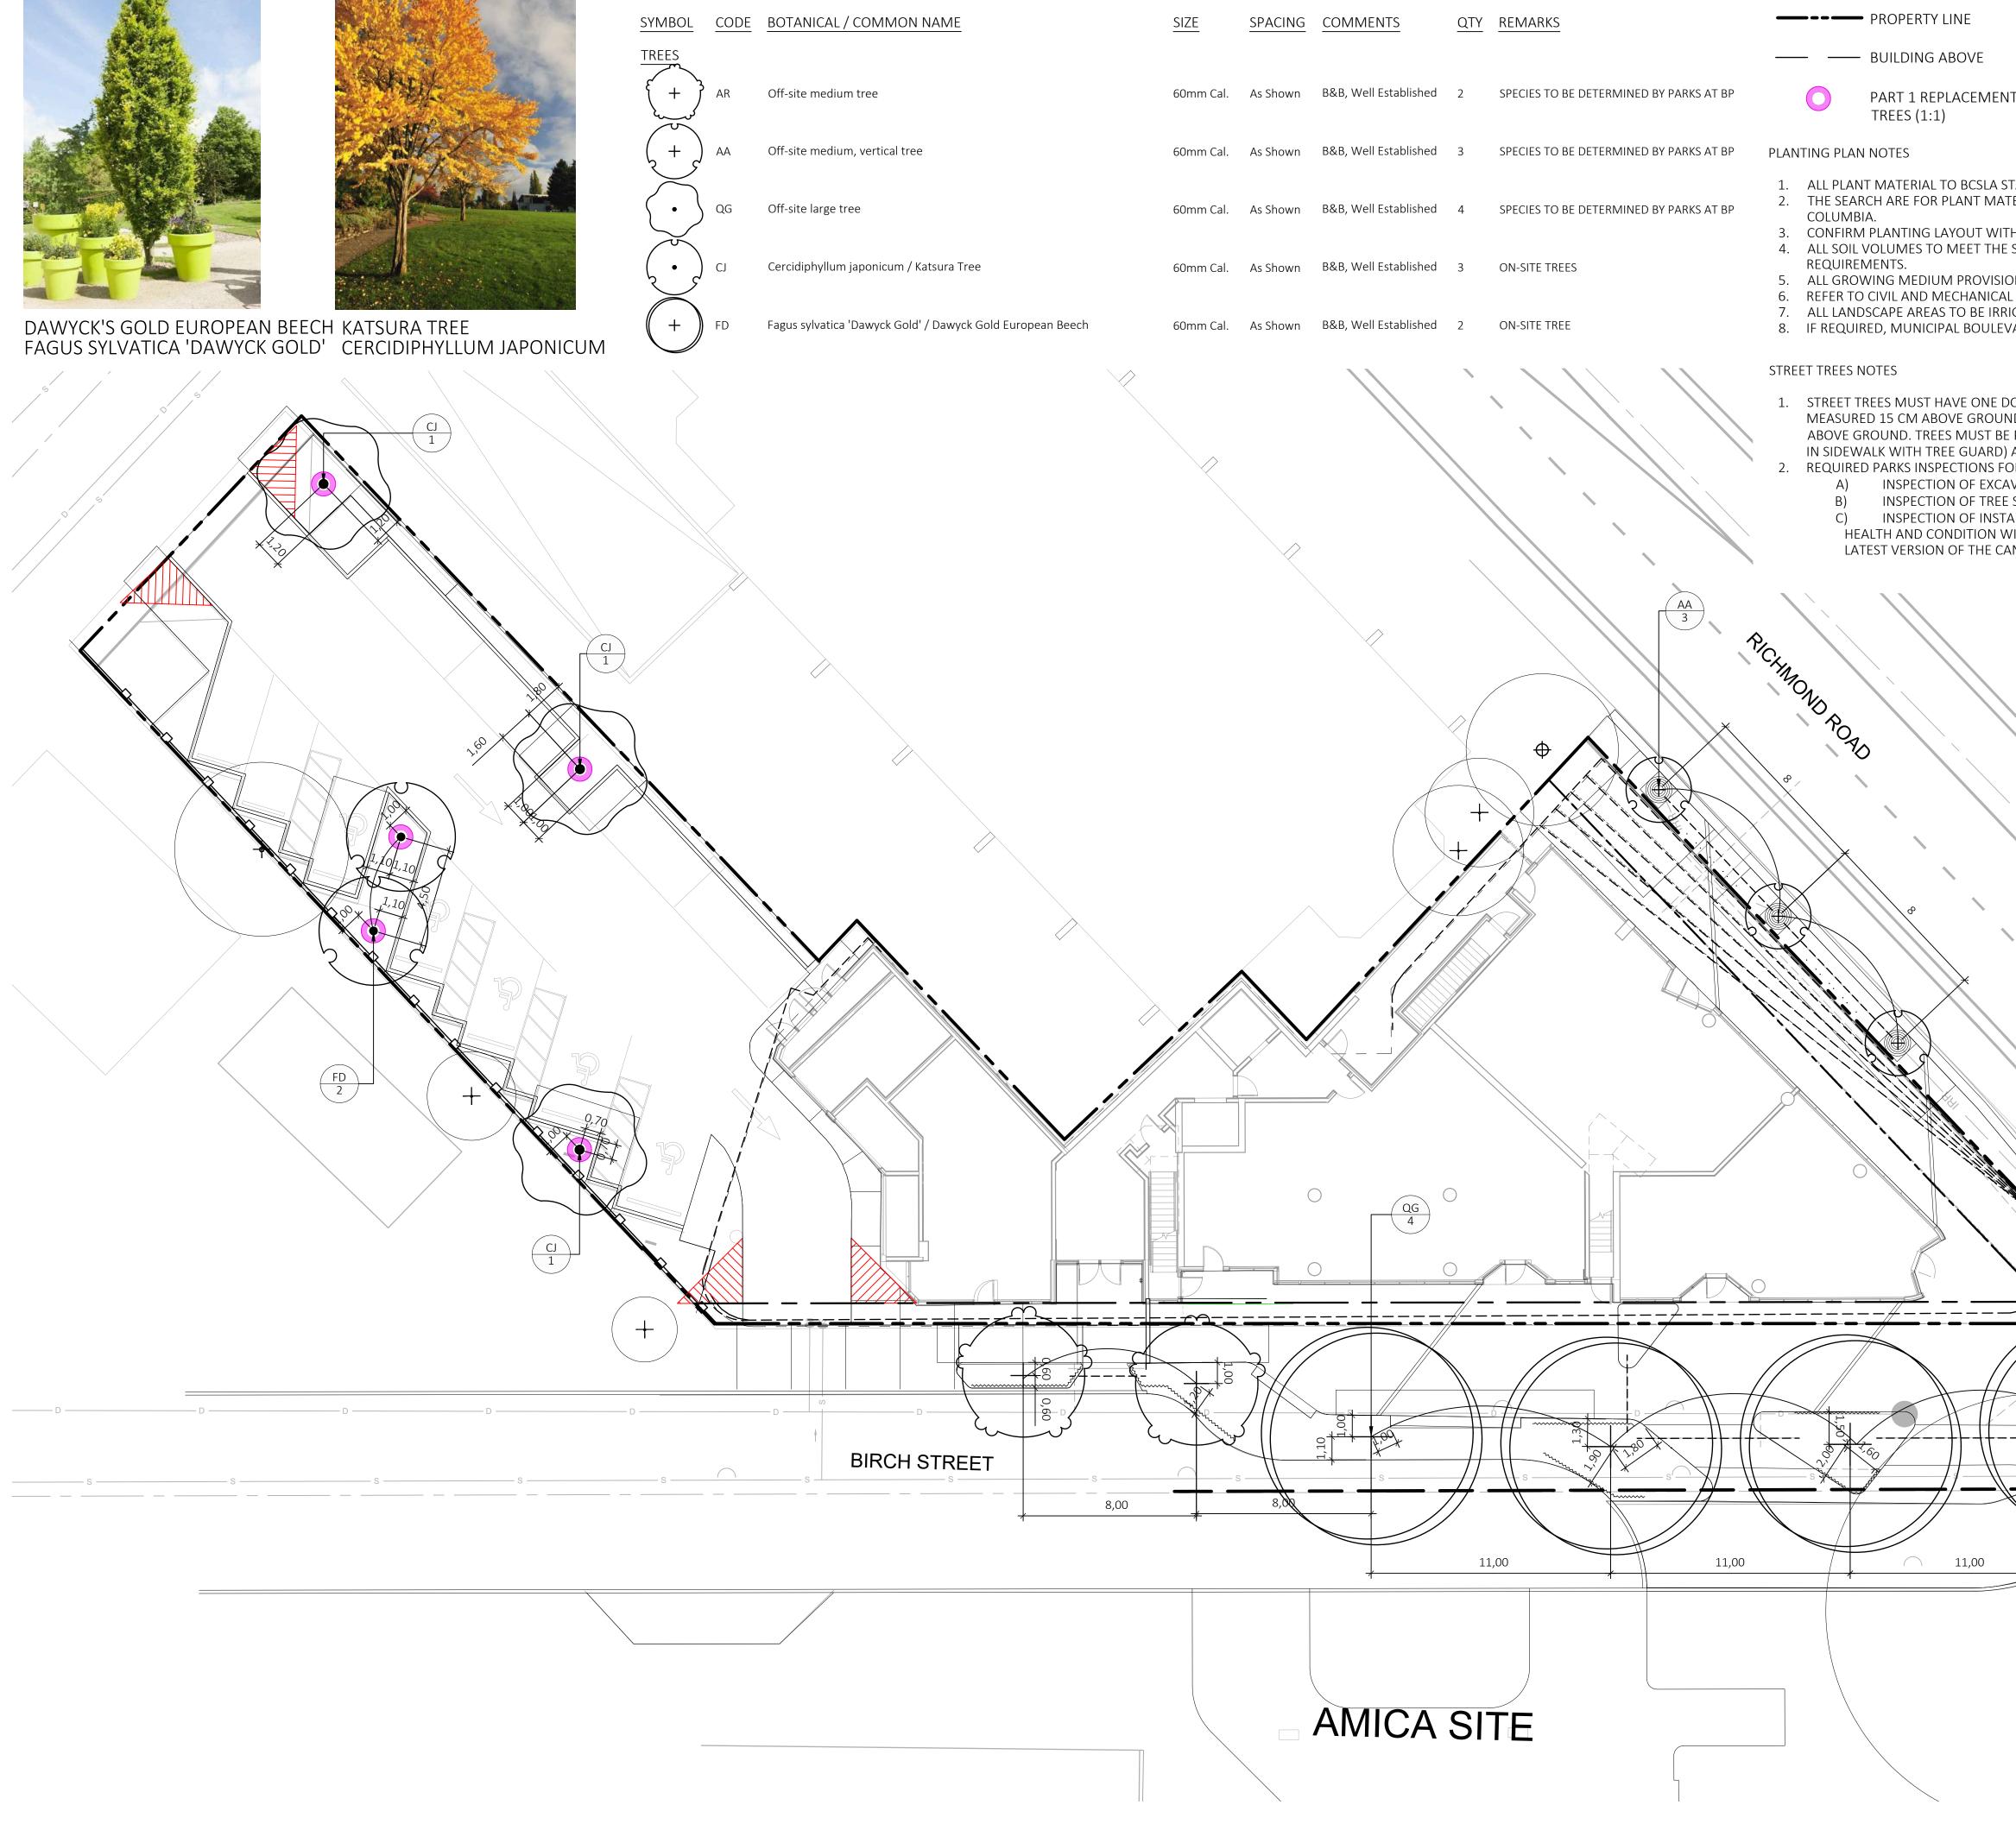
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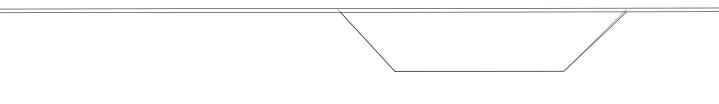




PLANT SCHEDULE LEVEL 1





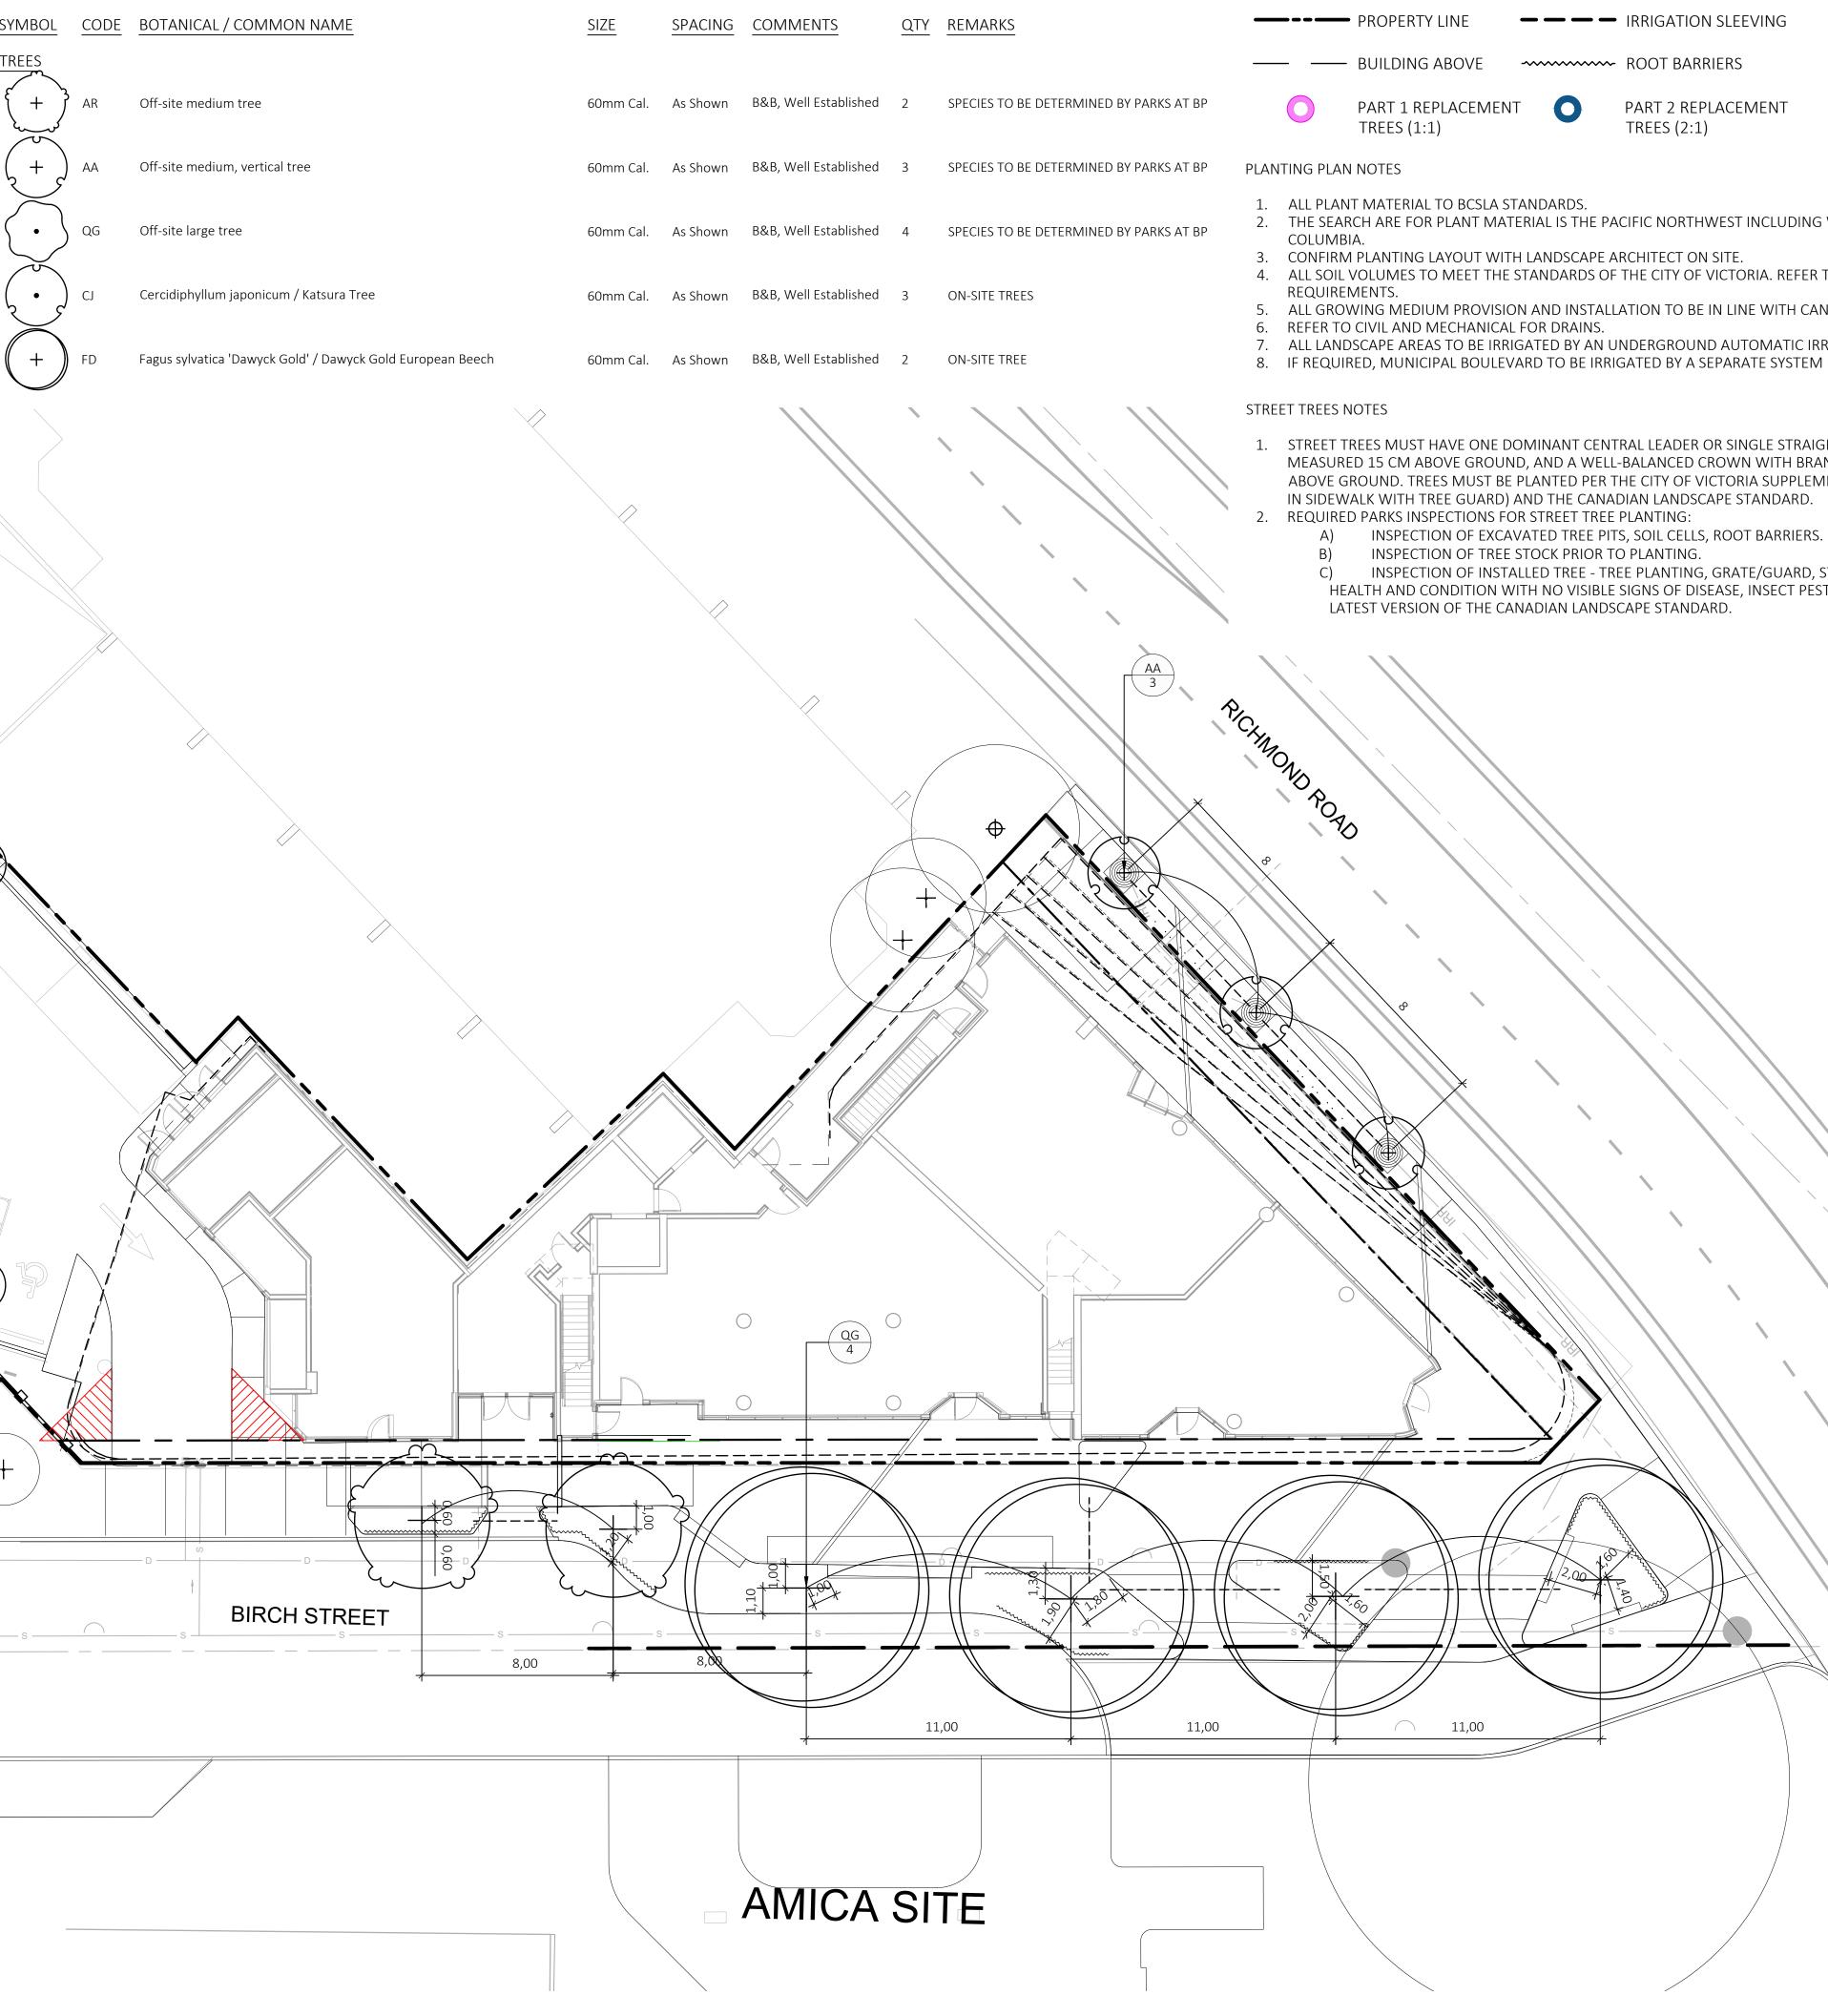

LEGEND



----- ROOT BARRIERS



PART 2 REPLACEMENT

TREES (2:1)

1 M. CLEARANCE FROM PROPERTY LINE OF A LOT, ABOVE AND UNDERGROUND UTILITY, DRIVEWAY OR OTHER PAVED SURFACE

2. THE SEARCH ARE FOR PLANT MATERIAL IS THE PACIFIC NORTHWEST INCLUDING WASHINGTON, OREGON AND BRITISH

4. ALL SOIL VOLUMES TO MEET THE STANDARDS OF THE CITY OF VICTORIA. REFER TO SOIL DEPTH PLANS FOR SOIL DEPTH

ALL GROWING MEDIUM PROVISION AND INSTALLATION TO BE IN LINE WITH CANADIAN LANDSCAPE STANDARDS

7. ALL LANDSCAPE AREAS TO BE IRRIGATED BY AN UNDERGROUND AUTOMATIC IRRIGATION SYSTEM; SEE IRRIGATION PLAN. 8. IF REQUIRED, MUNICIPAL BOULEVARD TO BE IRRIGATED BY A SEPARATE SYSTEM FROM A SEPARATE MUNICIPAL SOURCE.

1. STREET TREES MUST HAVE ONE DOMINANT CENTRAL LEADER OR SINGLE STRAIGHT TRUNK, 6-8 CM DIAMETER CALIPER MEASURED 15 CM ABOVE GROUND, AND A WELL-BALANCED CROWN WITH BRANCHING STARTING AT 1.8 M - 2.5 M ABOVE GROUND. TREES MUST BE PLANTED PER THE CITY OF VICTORIA SUPPLEMENTAL DRAWING SD-P5 (TREE PLANTING IN SIDEWALK WITH TREE GUARD) AND THE CANADIAN LANDSCAPE STANDARD.

C) INSPECTION OF INSTALLED TREE - TREE PLANTING, GRATE/GUARD, STAKES, ETC. TREES MUST BE IN GOOD HEALTH AND CONDITION WITH NO VISIBLE SIGNS OF DISEASE, INSECT PESTS, OR DAMAGE, AND COMPLY WITH THE LATEST VERSION OF THE CANADIAN LANDSCAPE STANDARD.



1608 Camosun Street, Victoria BC V8T 3E6 Info@biophiliacollective.ca 250 590 1156

OWNER/CLIENT: EMPRESA PROPERTIES


PROJECT NAME: TURNER SITE

PROJECT ADDRESS: 2002 RICHMOND RD VICTORIA, BC.

DESIGNED BY: BIANCA BODLEY DRAWN BY: GRACE MORAZZANI

5	ISSUED FOR DP RESUBMISSION	1/31/2025
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3	ISSUED FOR DP RESUBMISSION	2/9/2024
2	ISSUED FOR DP/REZONING	10/11/2023
1	ISSUED FOR DEVELOPMENT TRACKER	08/08/2023
NO.	ISSUE	MM/DD/YY



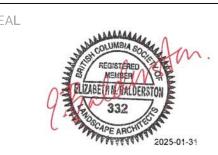

NORTH ARROW

DWG NO:

SCALE: 1:150







DRAWING TITLE:




TREE PLANTING PLAN LEVEL 1





L2.01



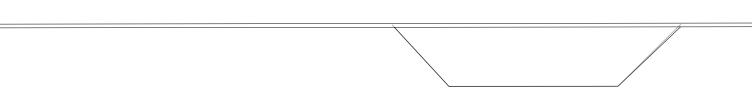

REQUIREMENTS. STREET TREES NOTES A) B) PICHMOND PORD \mathcal{A} ____ 6611+1+1+1 ML 11 EB VB 3 ______AG2_____4 (NP) PA ` RH 9 AMICA SITE





LEGEND

- ---- PROPERTY LINE
- ---- BUILDING ABOVE

PLANTING PLAN NOTES

- 1. ALL PLANT MATERIAL TO BCSLA STANDARDS.
- COLUMBIA. 3. CONFIRM PLANTING LAYOUT WITH LANDSCAPE ARCHITECT ON SITE.
- 6. REFER TO CIVIL AND MECHANICAL FOR DRAINS.

- 2. REQUIRED PARKS INSPECTIONS FOR STREET TREE PLANTING:

----- IRRIGATION SLEEVING

ROOT BARRIERS

2. THE SEARCH ARE FOR PLANT MATERIAL IS THE PACIFIC NORTHWEST INCLUDING WASHINGTON, OREGON AND BRITISH

4. ALL SOIL VOLUMES TO MEET THE STANDARDS OF THE CITY OF VICTORIA. REFER TO SOIL DEPTH PLANS FOR SOIL DEPTH

5. ALL GROWING MEDIUM PROVISION AND INSTALLATION TO BE IN LINE WITH CANADIAN LANDSCAPE STANDARDS

7. ALL LANDSCAPE AREAS TO BE IRRIGATED BY AN UNDERGROUND AUTOMATIC IRRIGATION SYSTEM; SEE IRRIGATION PLAN. 8. IF REQUIRED, MUNICIPAL BOULEVARD TO BE IRRIGATED BY A SEPARATE SYSTEM FROM A SEPARATE MUNICIPAL SOURCE.

1. STREET TREES MUST HAVE ONE DOMINANT CENTRAL LEADER OR SINGLE STRAIGHT TRUNK, 6-8 CM DIAMETER CALIPER MEASURED 15 CM ABOVE GROUND, AND A WELL-BALANCED CROWN WITH BRANCHING STARTING AT 1.8 M - 2.5 M ABOVE GROUND. TREES MUST BE PLANTED PER THE CITY OF VICTORIA SUPPLEMENTAL DRAWING SD-P5 (TREE PLANTING IN SIDEWALK WITH TREE GUARD) AND THE CANADIAN LANDSCAPE STANDARD.

INSPECTION OF EXCAVATED TREE PITS, SOIL CELLS, ROOT BARRIERS.

INSPECTION OF TREE STOCK PRIOR TO PLANTING.

C) INSPECTION OF INSTALLED TREE - TREE PLANTING, GRATE/GUARD, STAKES, ETC. TREES MUST BE IN GOOD HEALTH AND CONDITION WITH NO VISIBLE SIGNS OF DISEASE, INSECT PESTS, OR DAMAGE, AND COMPLY WITH THE LATEST VERSION OF THE CANADIAN LANDSCAPE STANDARD.



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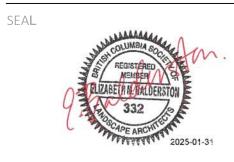
OWNER/CLIENT: EMPRESA PROPERTIES

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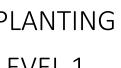
L2.02



PLANTING PLAN












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DWG NO:


SCALE: 1:150






FRAGRANT SNOWBELL STYRAX OBASSIA

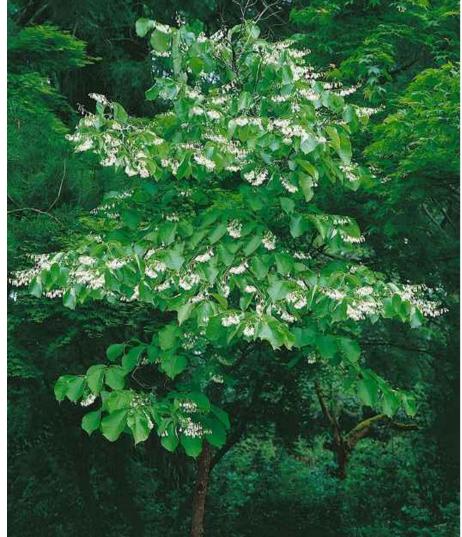
VENUS DOGWOOD CORNUS X 'KN30-8'

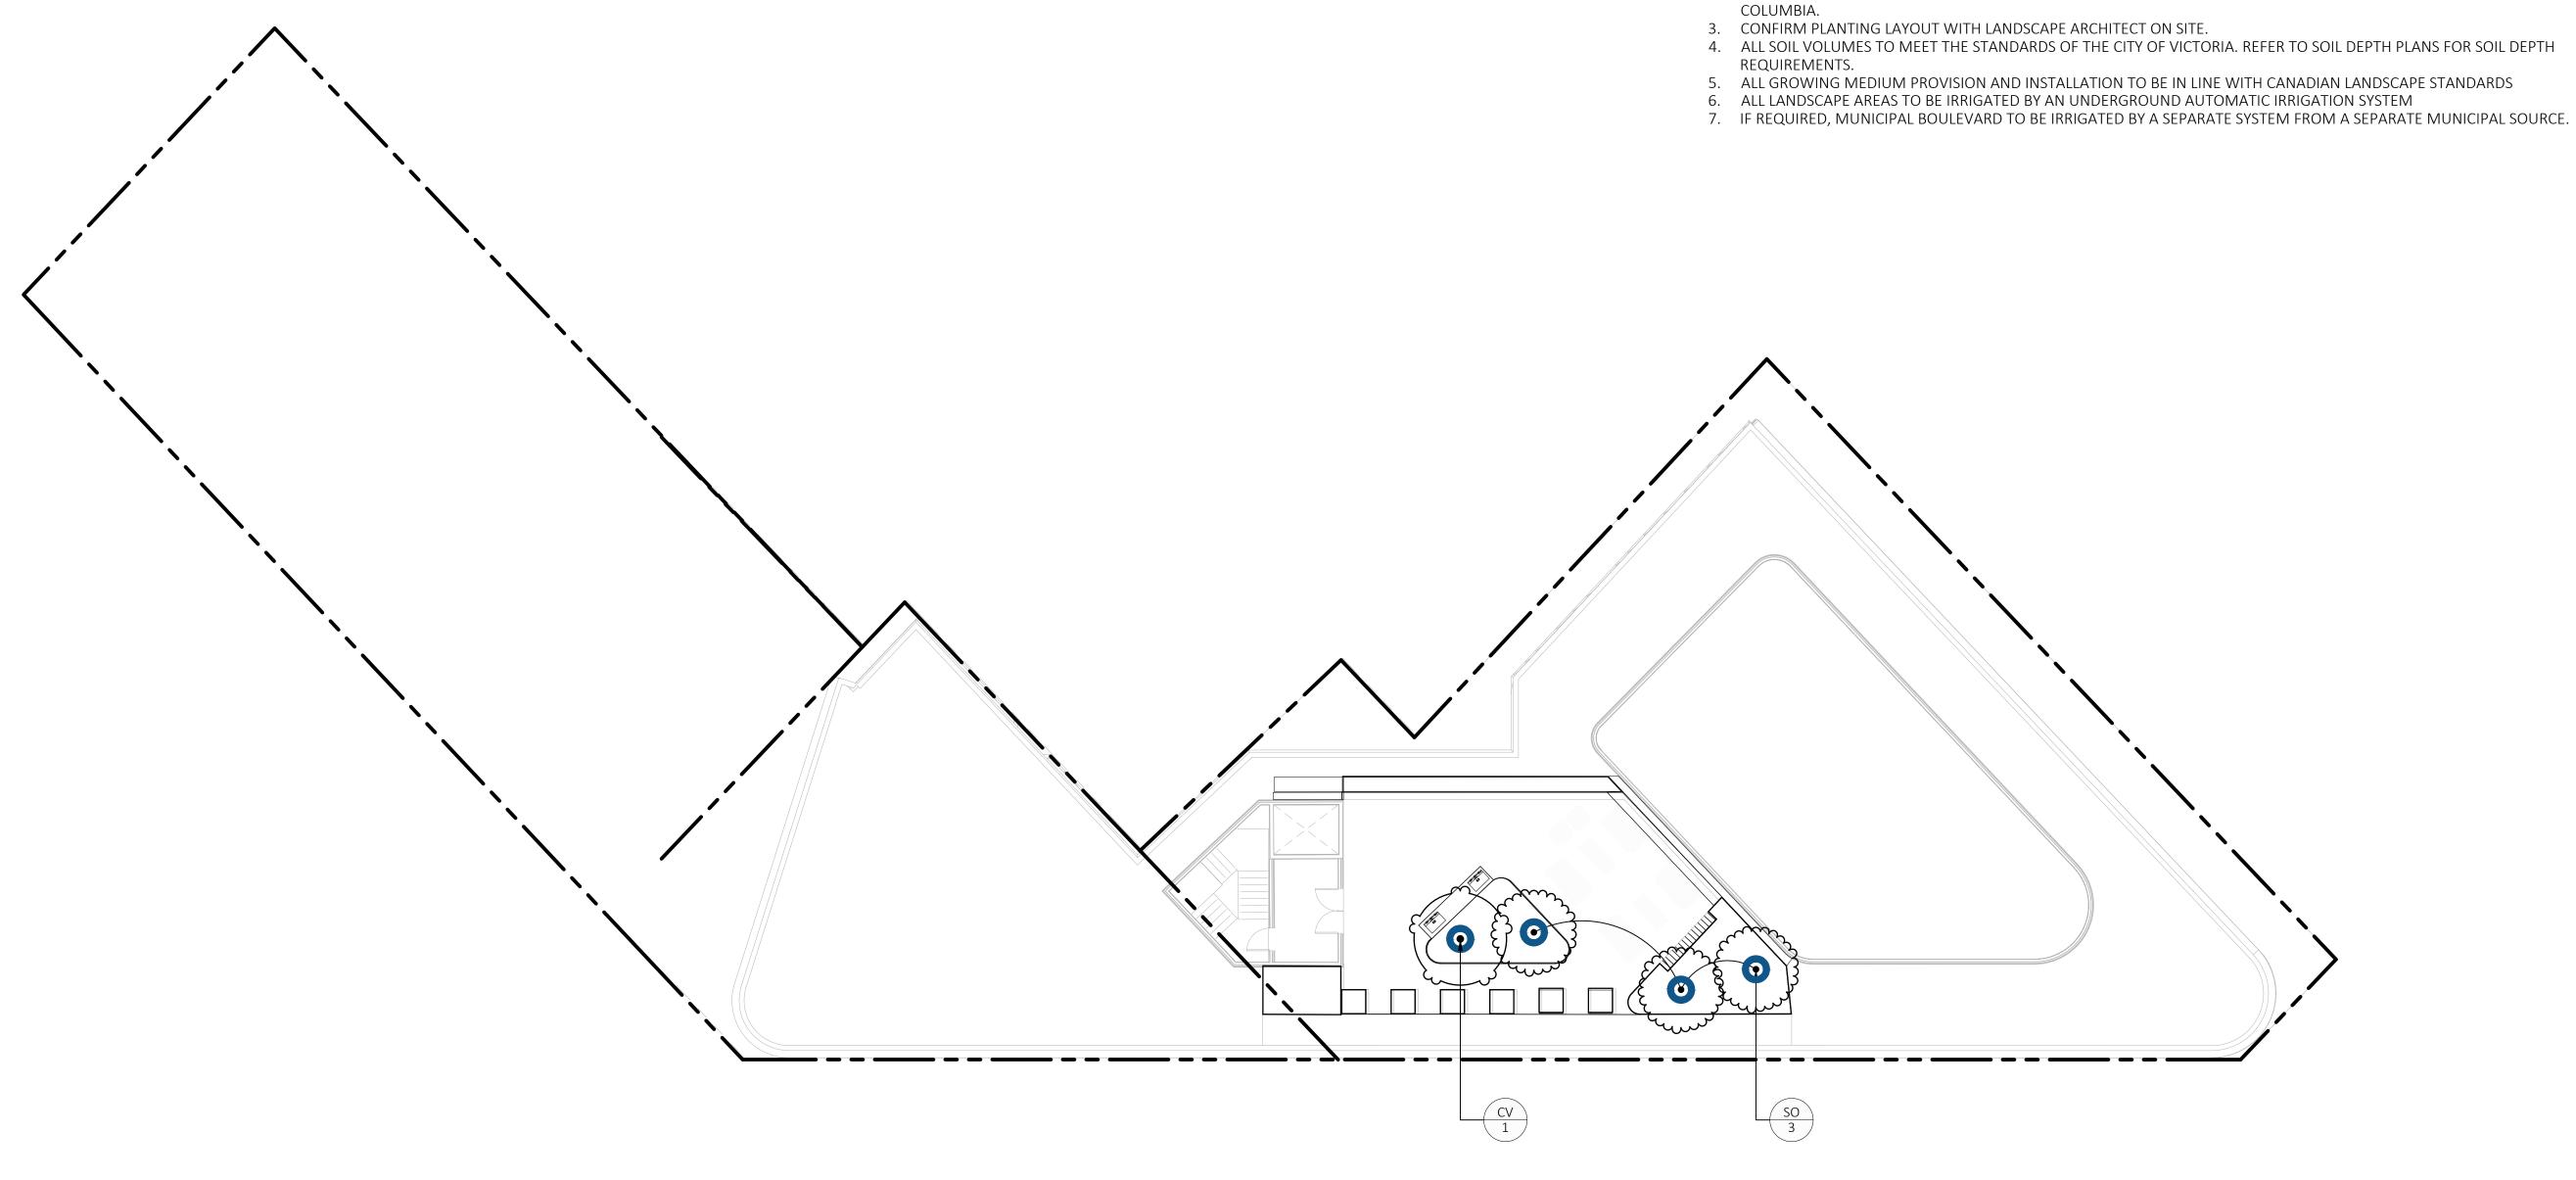

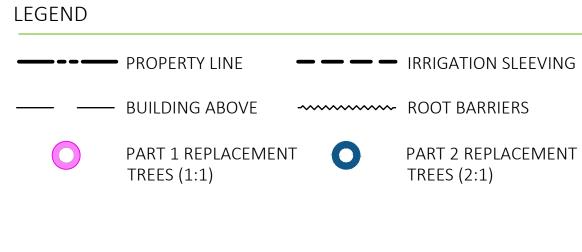

PLANT SCHEDULE ROOFTOP

 SYMBOL
 CODE
 BOTANICAL / COMMON NAME

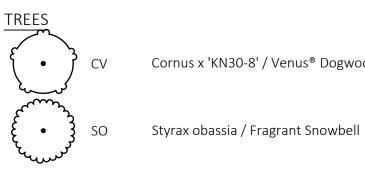

Cornus x 'KN30-8' / Venus® Dogwood

PLANTING PLAN NOTES

- 1. ALL PLANT MATERIAL TO BCSLA STANDARDS.

- 5. ALL GROWING MEDIUM PROVISION AND INSTALLATION TO BE IN LINE WITH CANADIAN LANDSCAPE STANDARDS

PART 2 REPLACEMENT

SIZE	<u>SPACING</u>	COMMENTS	<u>QTY</u>	REMARKS
60mm Cal.	As Shown	B&B, Well Established	1	ON-SITE TREES
60mm Cal.	As Shown	B&B, Well Established	3	ON-SITE TREES

2. THE SEARCH ARE FOR PLANT MATERIAL IS THE PACIFIC NORTHWEST INCLUDING WASHINGTON, OREGON AND BRITISH



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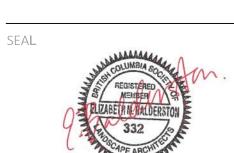
OWNER/CLIENT: EMPRESA PROPERTIES PROJECT NAME:

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DESIGNED BY: **BIANCA BODLEY** DRAWN BY: **GRACE MORAZZANI**

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NORTH ARROW



DRAWING TITLE: TREE PLANTING PLAN


ROOFTOP

SCALE: 1:150

DWG NO:





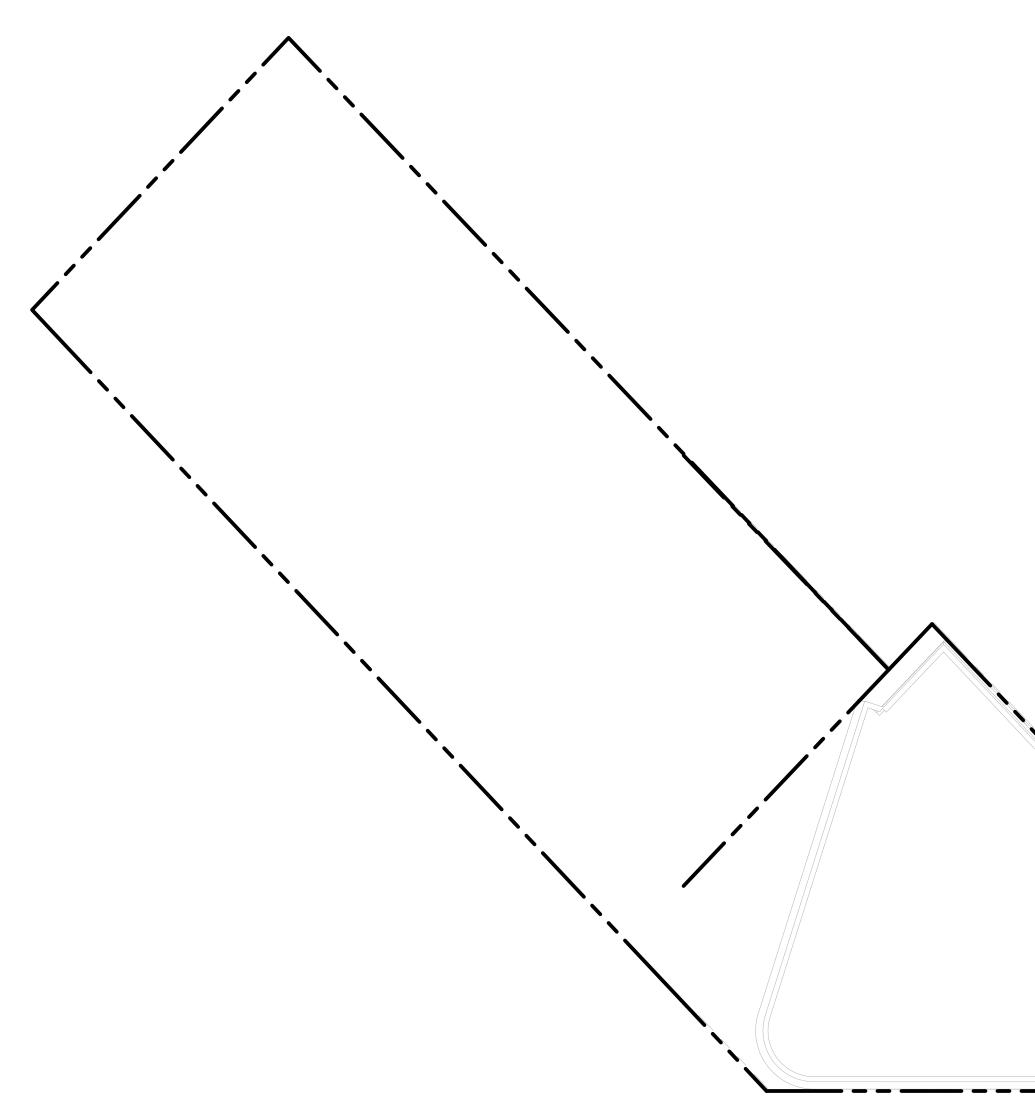



----- PROPERTY LINE

----- BUILDING ABOVE


PLANT SCHEDULE ROOFTOP

SYMBOL	CODE	BOTANICAL / COMMON NAME	SIZE	SPACING	COMMENTS	QTY	REMARKS
SHRUBS 	Hp Pc	Hebe pinguifolia `Sutherlandii` / Sutherland Hebe Prostanthera cuneata / Alpine Mint Bush	#2 POT #2 POT	1000 mm. 1200mm	Full, Well Established Full, Well Established	10 8	EVERGREEN POLINATOR SUPPORT, EVERGREEN, C
GRASSES	SG	Stipa gigantea / Giant Feather Grass	#2 POT	750mm	Full, Well Established	28	POLINATOR SUPPORT, DROUGHT TOL
	<u>-5</u> AK	Agastache x 'Kudos Mandarin' / Kudos Mandarin Anise Hyssop	#1 POT	500mm	Full, Well Established	17	POLINATOR SUPPORT, DROUGHT TOL
(+)	EG	Echinacea x 'TNECHPG' / Prima™ Ginger Coneflower	#1 POT	500mm	Full, Well Established	19	POLINATOR SUPPORT, DROUGHT TOL
£ +	NP	Nepeta x faassenii 'Purrsian Blue' / Purrsian Blue Catmint	#1 POT	750mm	Full, Well Established	8	POLINATOR SUPPORT, DROUGHT TOL
and the second s	PA	Perovskia atriplicifolia / Russian Sage	#2 POT	900mm	Full, Well Established	16	POLINATOR SUPPORT, DROUGHT TOL SEMI-EVERGREEN
$\left(\cdot \right)$	SC	Salvia nemorosa 'Caradonna' / Cardonna Meadow Sage	#1 POT	600mm	Full, Well Established	10	POLINATOR SUPPORT, DROUGHT TOL

A TOTAL OF 91.37% OF THE ON-SITE PLANTING PROVIDES POLLINATOR SUPPORT AS REQUIRED PER THE DESIGN GUIDELINES FOR: MULTI-UNIT RESIDENTIAL, COMMERCIAL, AND INDUSTRIAL (2019).

PLANTING PLAN NOTES

- 1. ALL PLANT MATERIAL TO BCSLA STANDARDS.
- 2. THE SEARCH ARE FOR PLANT MATERIAL IS THE PACIFIC NORTHWEST INCLUDING WASHINGTON, OREGON AND BRITISH COLUMBIA.
- 3. CONFIRM PLANTING LAYOUT WITH LANDSCAPE ARCHITECT ON SITE. 4. ALL SOIL VOLUMES TO MEET THE STANDARDS OF THE CITY OF VICTORIA. REFER TO SOIL DEPTH PLANS FOR SOIL DEPTH REQUIREMENTS.
- 5. ALL GROWING MEDIUM PROVISION AND INSTALLATION TO BE IN LINE WITH CANADIAN LANDSCAPE STANDARDS
- 6. ALL LANDSCAPE AREAS TO BE IRRIGATED BY AN UNDERGROUND AUTOMATIC IRRIGATION SYSTEM
- 7. IF REQUIRED, MUNICIPAL BOULEVARD TO BE IRRIGATED BY A SEPARATE SYSTEM FROM A SEPARATE MUNICIPAL SOURCE.

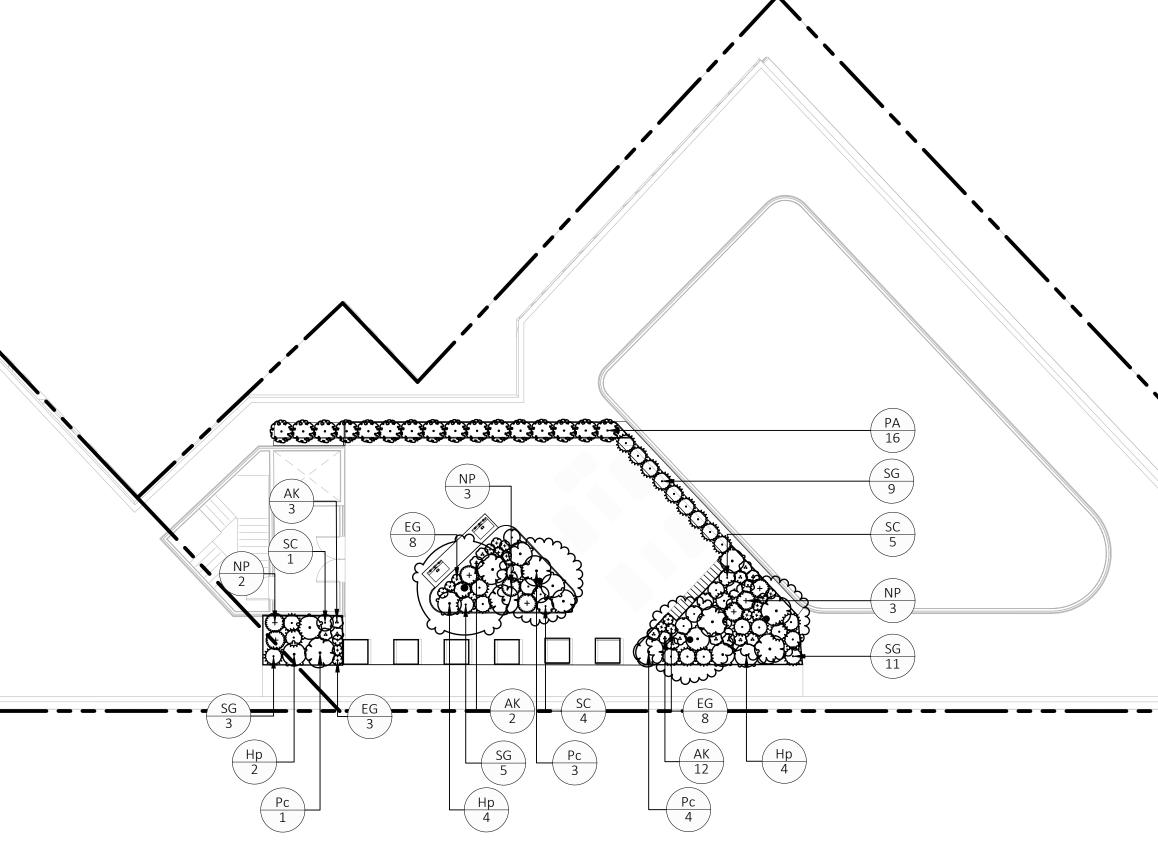



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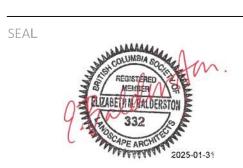
OWNER/CLIENT: EMPRESA PROPERTIES PROJECT NAME:

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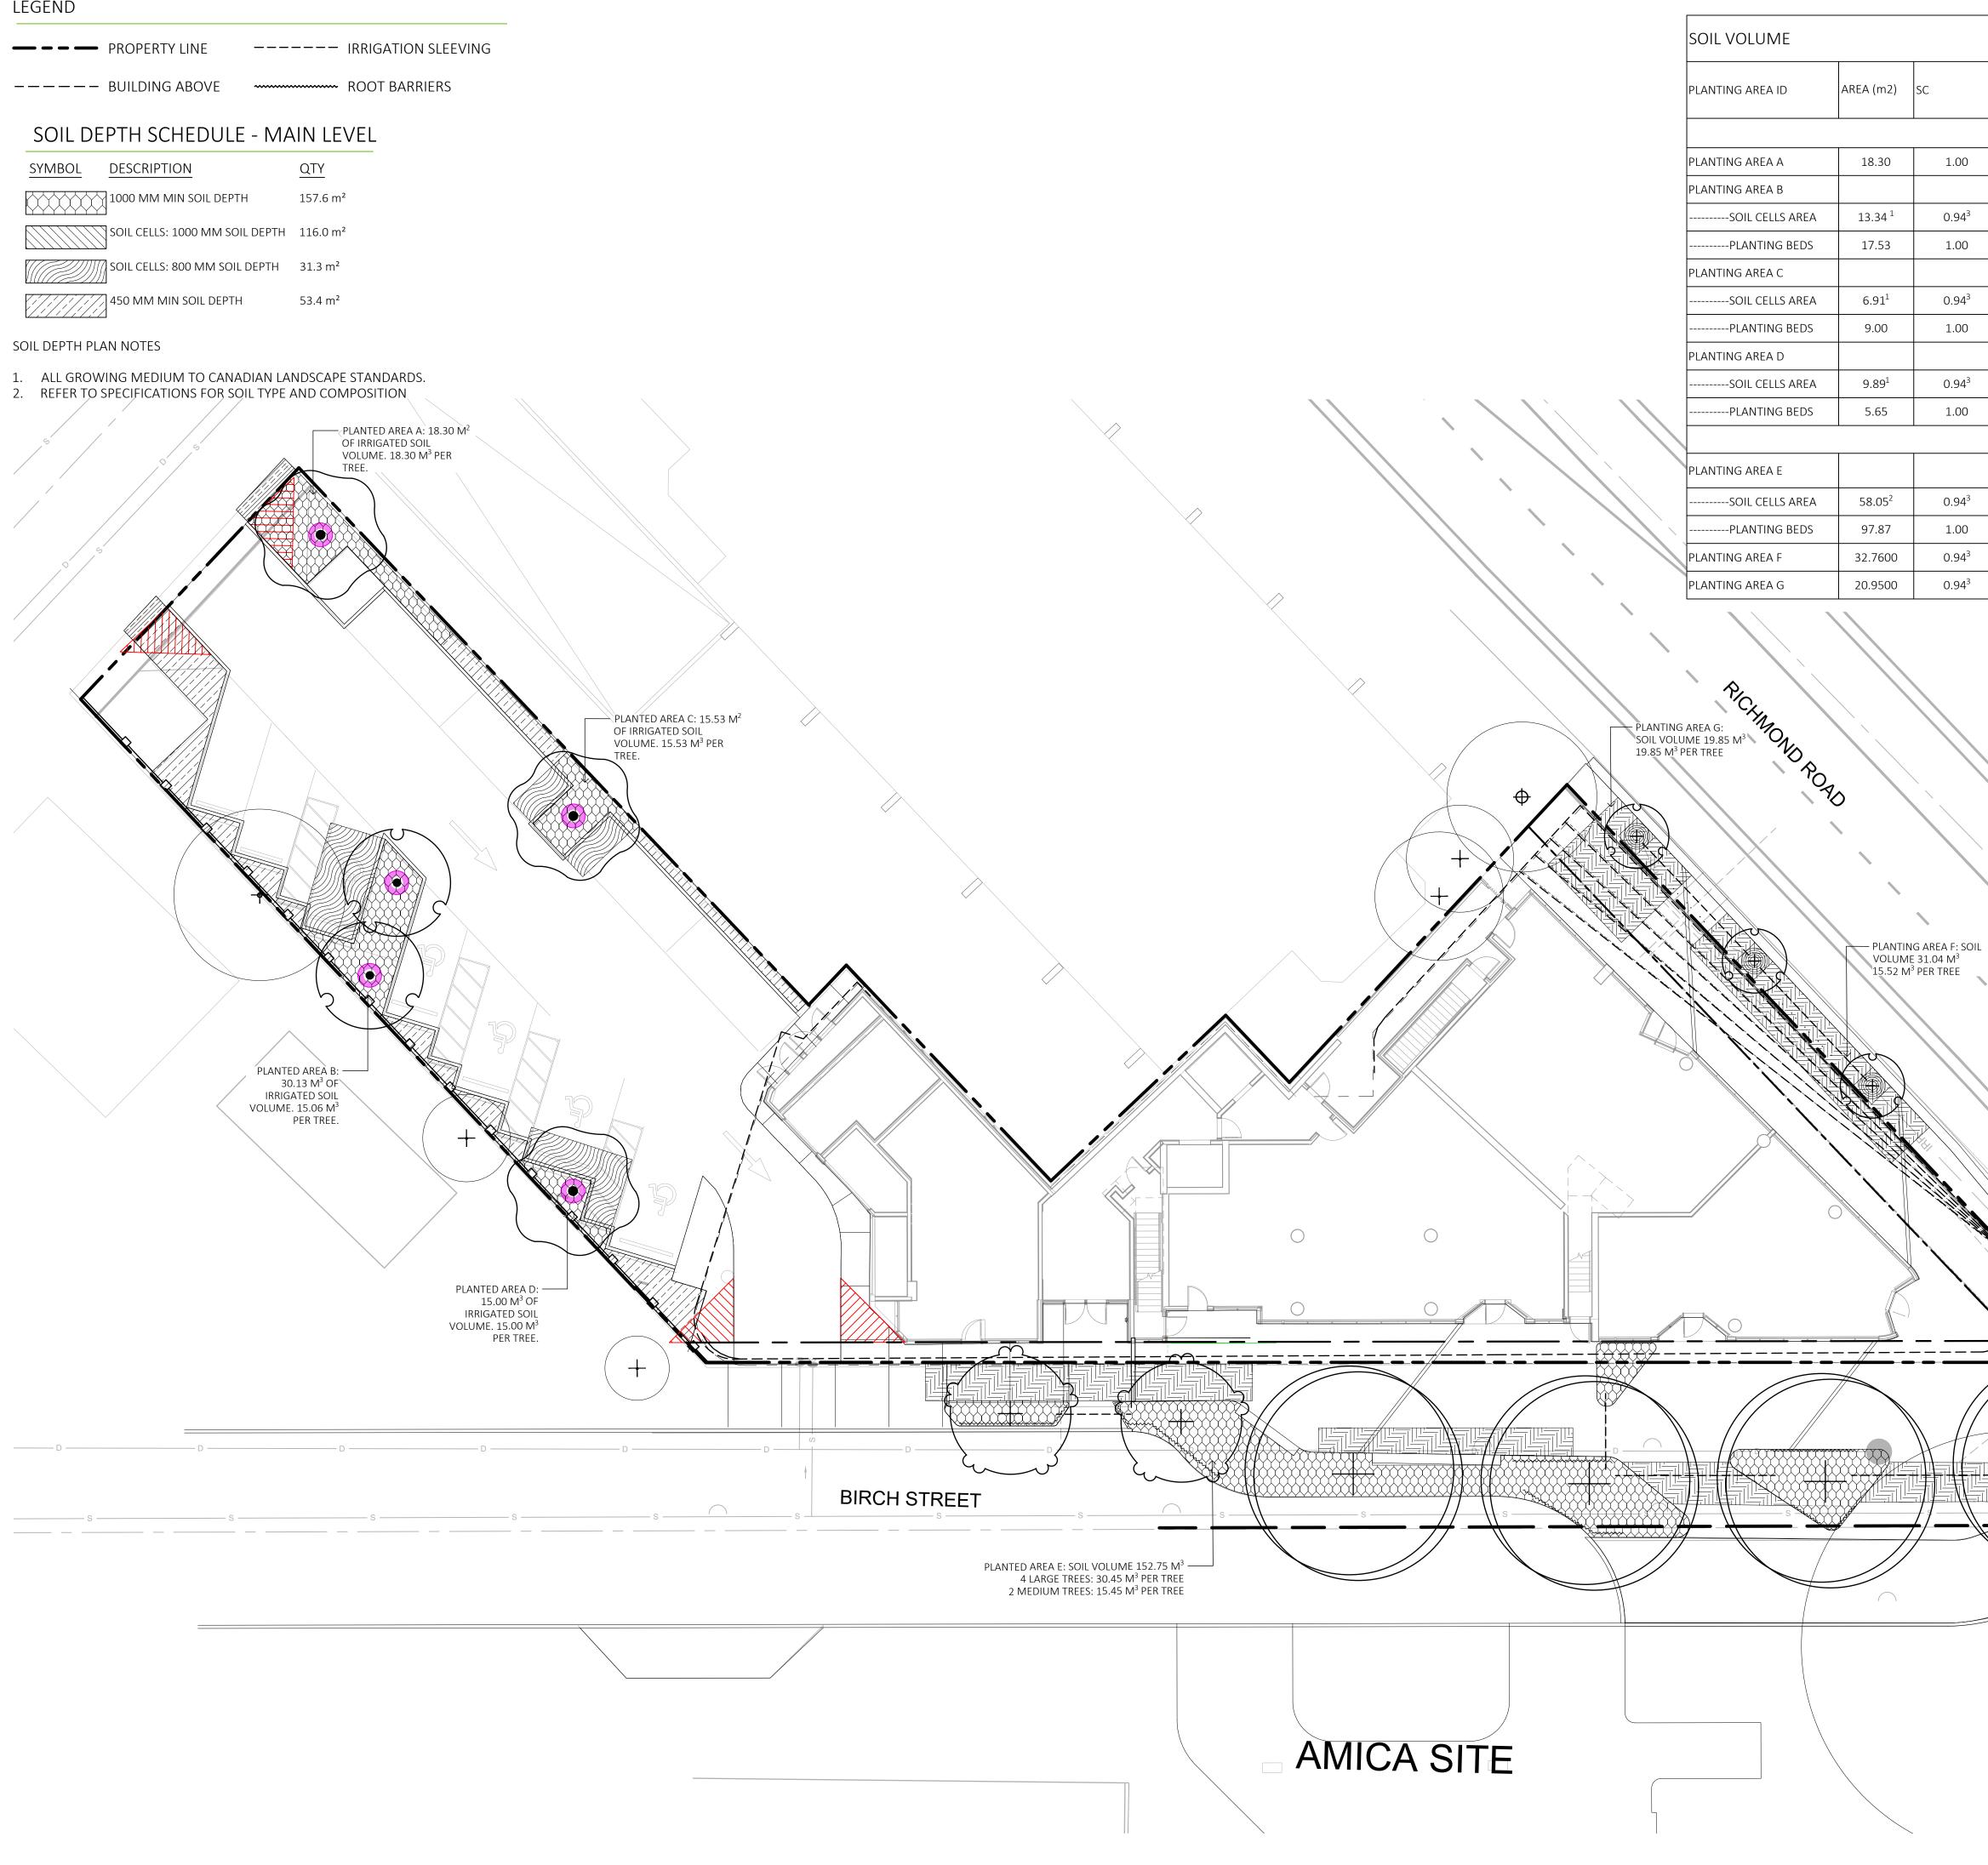


L2.04

DRAWING TITLE: PLANTING PLAN ROOFTOP

DWG NO:

SCALE: 1:150



	REPLACEM PROPOSED			SOIL VOL	ume requ	JIRED (m3)	
A.ESTIMATED SOIL VOLUME	B. # SMALL		D. # LARGE	E. SMALL	F. MEDIUM	G. LARGE	TOTAL
ON-SITE	AREA			1			
18.30		1.00			15.00		15.00
30.13		2.00			15.00		30.00
12.60							
17.53							
15.53		1.00			15.00		15.00
6.53							
9.00							
15.00		1.00			15.00		15.00
9.35							
5.65							
OFF-SITE	AREAS						
152.75		2.00	4.00		30.00	120.00	150.00
54.56							
97.87							
 31.04		2			30		30
19.85		1.00			20.00		20

1. NUMBER REFLECTS AREAS MULTIPLIED BY 0.8 TO REFLECT STRATAVAULT DEPTH. LATERAL ROOT GROWTH PRIORITIZED WHERE POSSIBLE 2. NUMBER REFLECTS THE AREA MULTIPLIED BY 0.7 (STRATAVAULT SOIL CONTENT)

3. ADJUSTMENT FACTOR MODIFIED FROM 0.92 (COV'S) TO 0.94 (STRATAVAULT) FOR ACCURACY

4. PLEASE SEE SOIL CELLS PLAN L3.11 FOR FURTHER DETAIL



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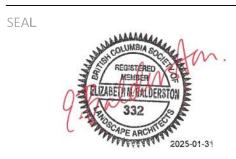
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NORTH ARROW





DWG NO:

SCALE: 1:150



PLANTING PLAN




L3.01

DRAWING TITLE:

LEVEL 1



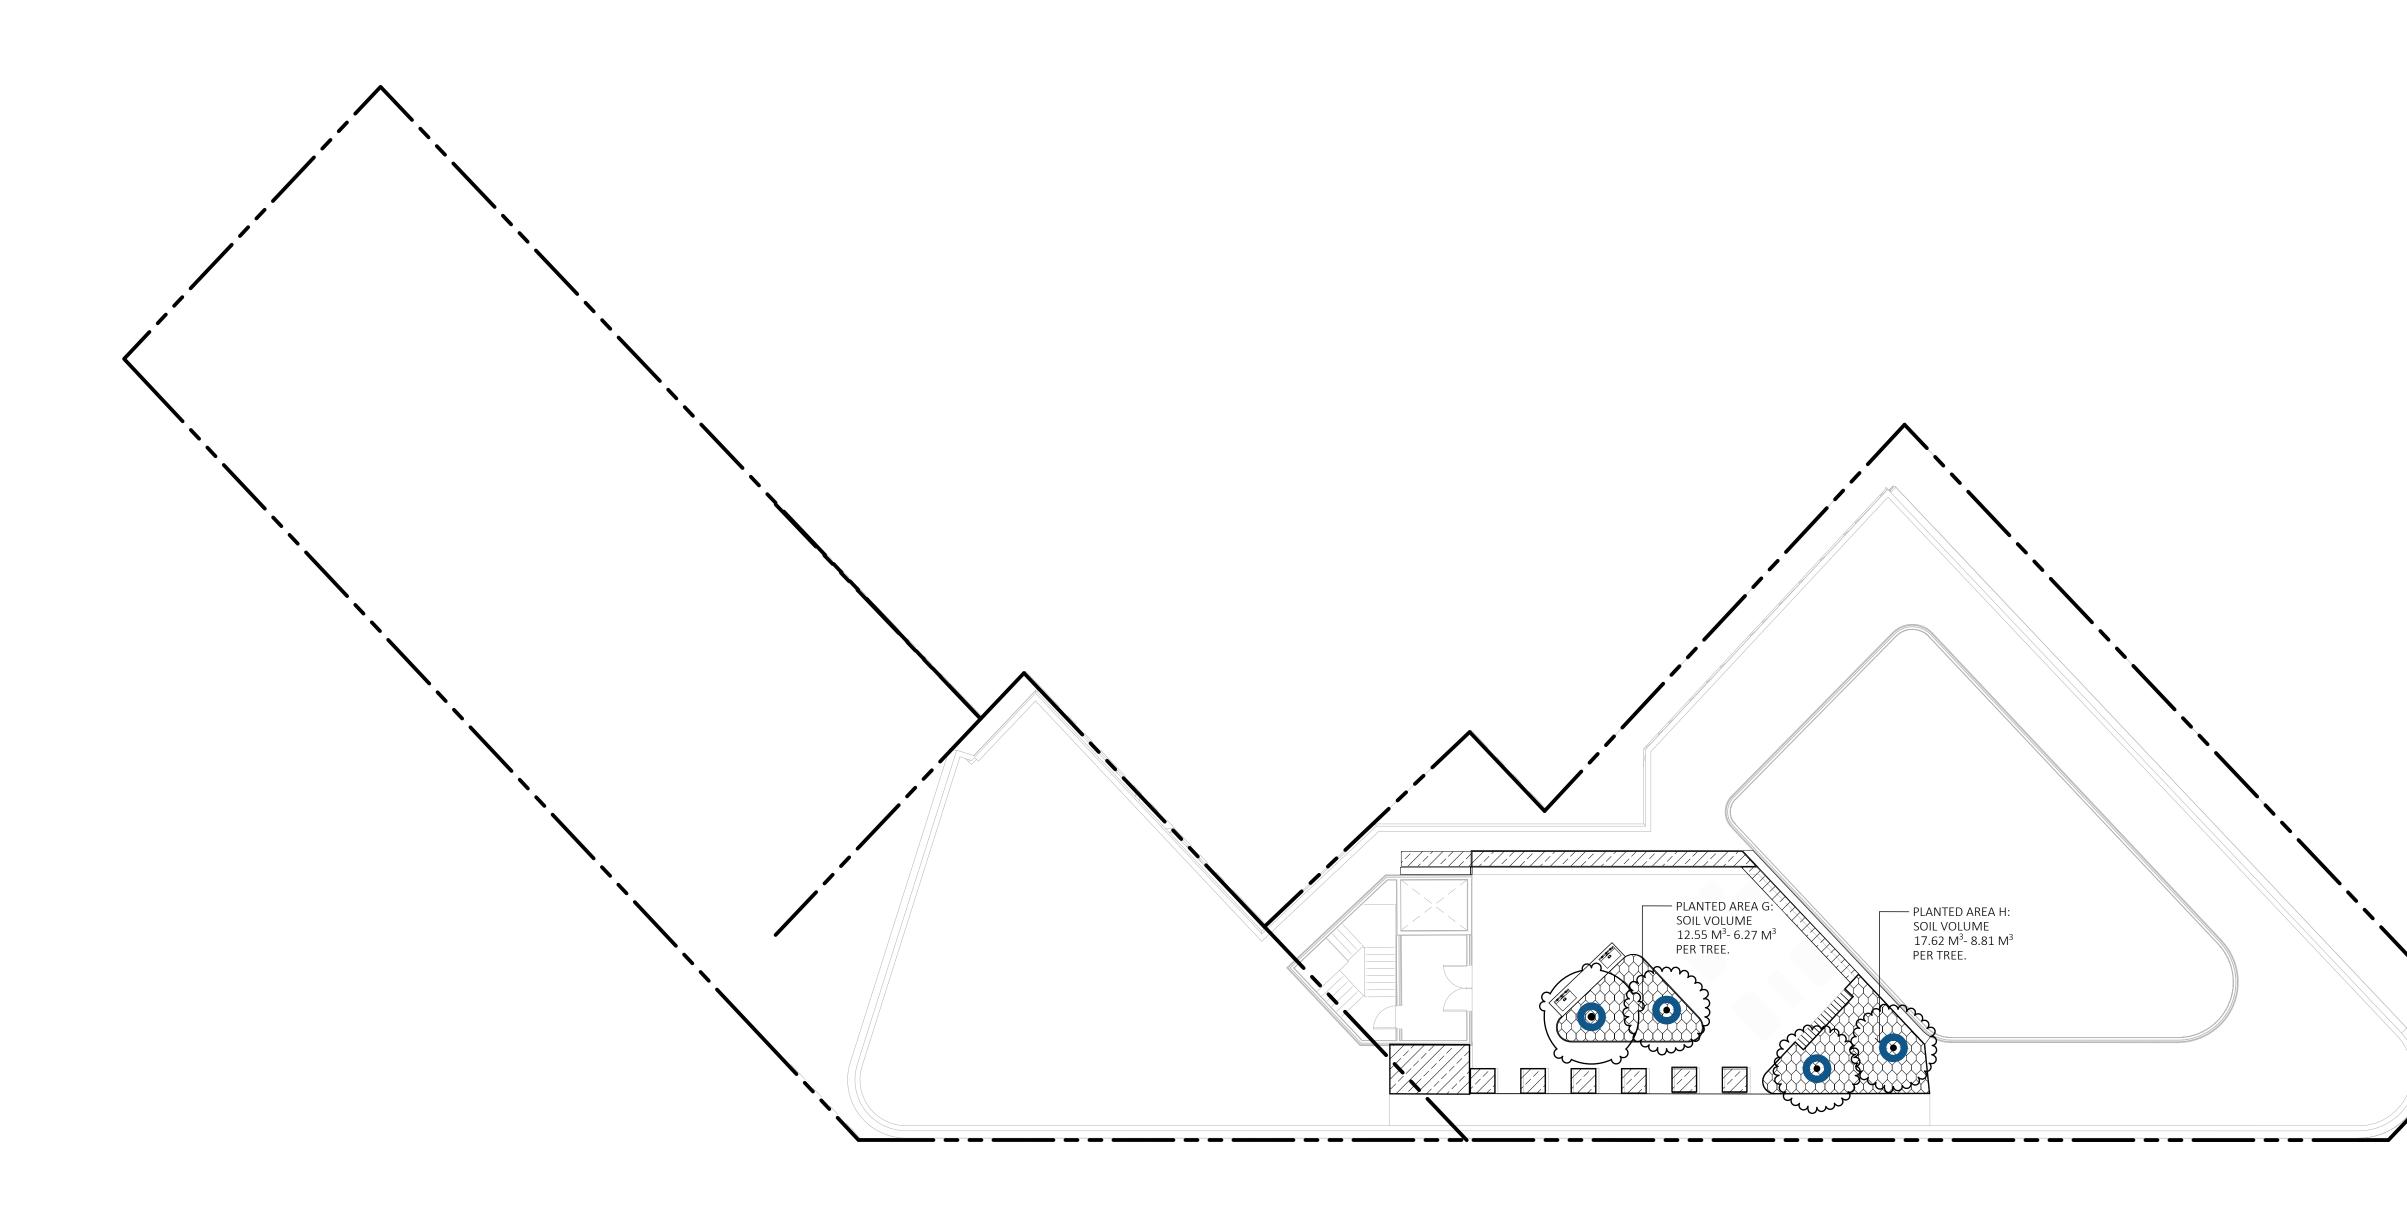

----- BUILDING ABOVE

SOIL DEPTH SCHEDULE - ROOFTOP

SYMBOL DESCRIPTION

QTY 30.2 m²

22.4 m²

SOIL VOLUME AREA (m2) SC PLANTING AREA ID PLANTING AREA G 12.55 1.00 PLANTING AREA H 17.62 1.00

1000 MM MIN SOIL DEPTH

450 MM MIN SOIL DEPTH

SOIL DEPTH PLAN NOTES

1. ALL GROWING MEDIUM TO CANADIAN LANDSCAPE STANDARDS.

2. REFER TO SPECIFICATIONS FOR SOIL TYPE AND COMPOSITION

REPLACEMENT TREES PROPOSED SOIL VOLUME REQUIRED (m3)					
A.ESTIMATED SOIL B. # C. # D. # E. F. MEDIUM G. LARGE TOTA	_				
ON-SITE AREA					
12.55 2.00 6.00 12.00					
17.62 2.00 6.00 12.00					



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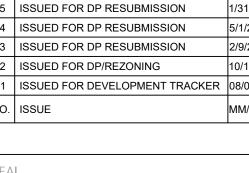
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<u>-</u>	1330ED FOR DF/REZONING
1	ISSUED FOR DEVELOPMENT TRACKER
D.	ISSUE
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DRAWING TITLE:

ROOFTOP










SOIL DEPTH PLAN

SCALE: 1:150

L3.02

DWG NO:

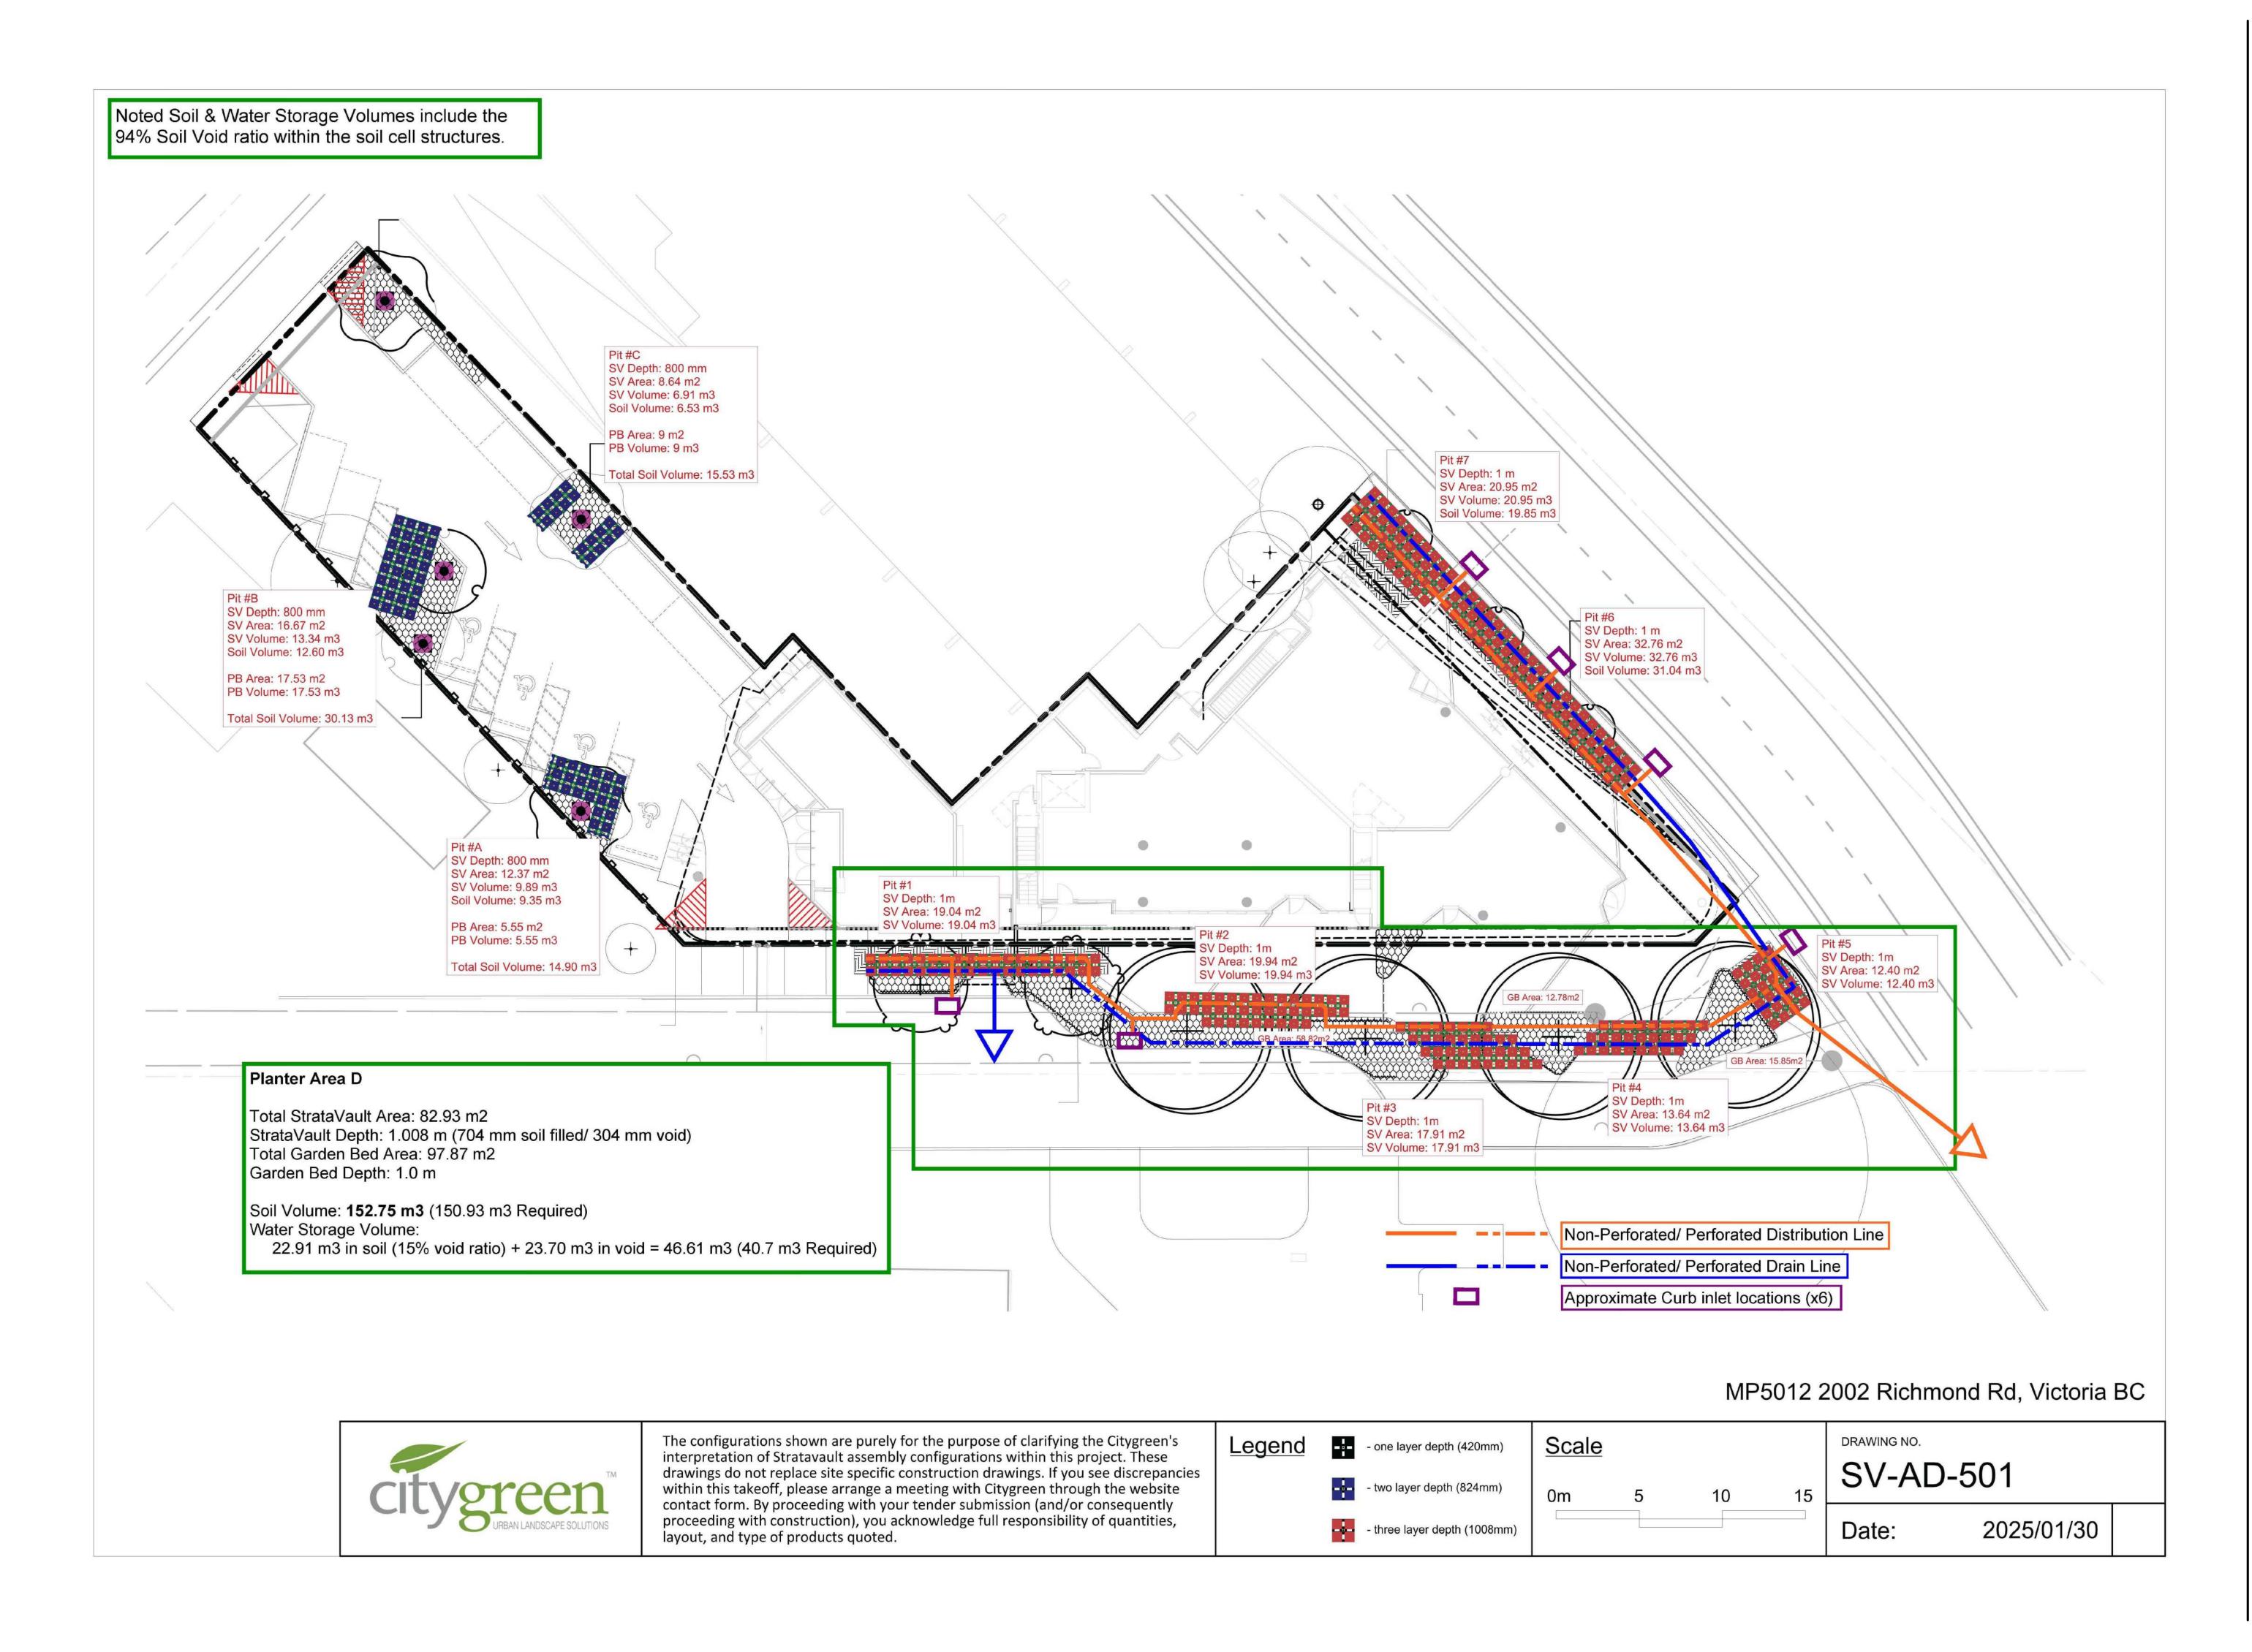



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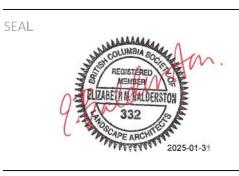
OWNER/CLIENT: EMPRESA PROPERTIES

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NORTH ARROW


DRAWING TITLE: SOIL CELLS PLAN

L3.11

LEVEL 1

DWG NO:

SCALE: NTS

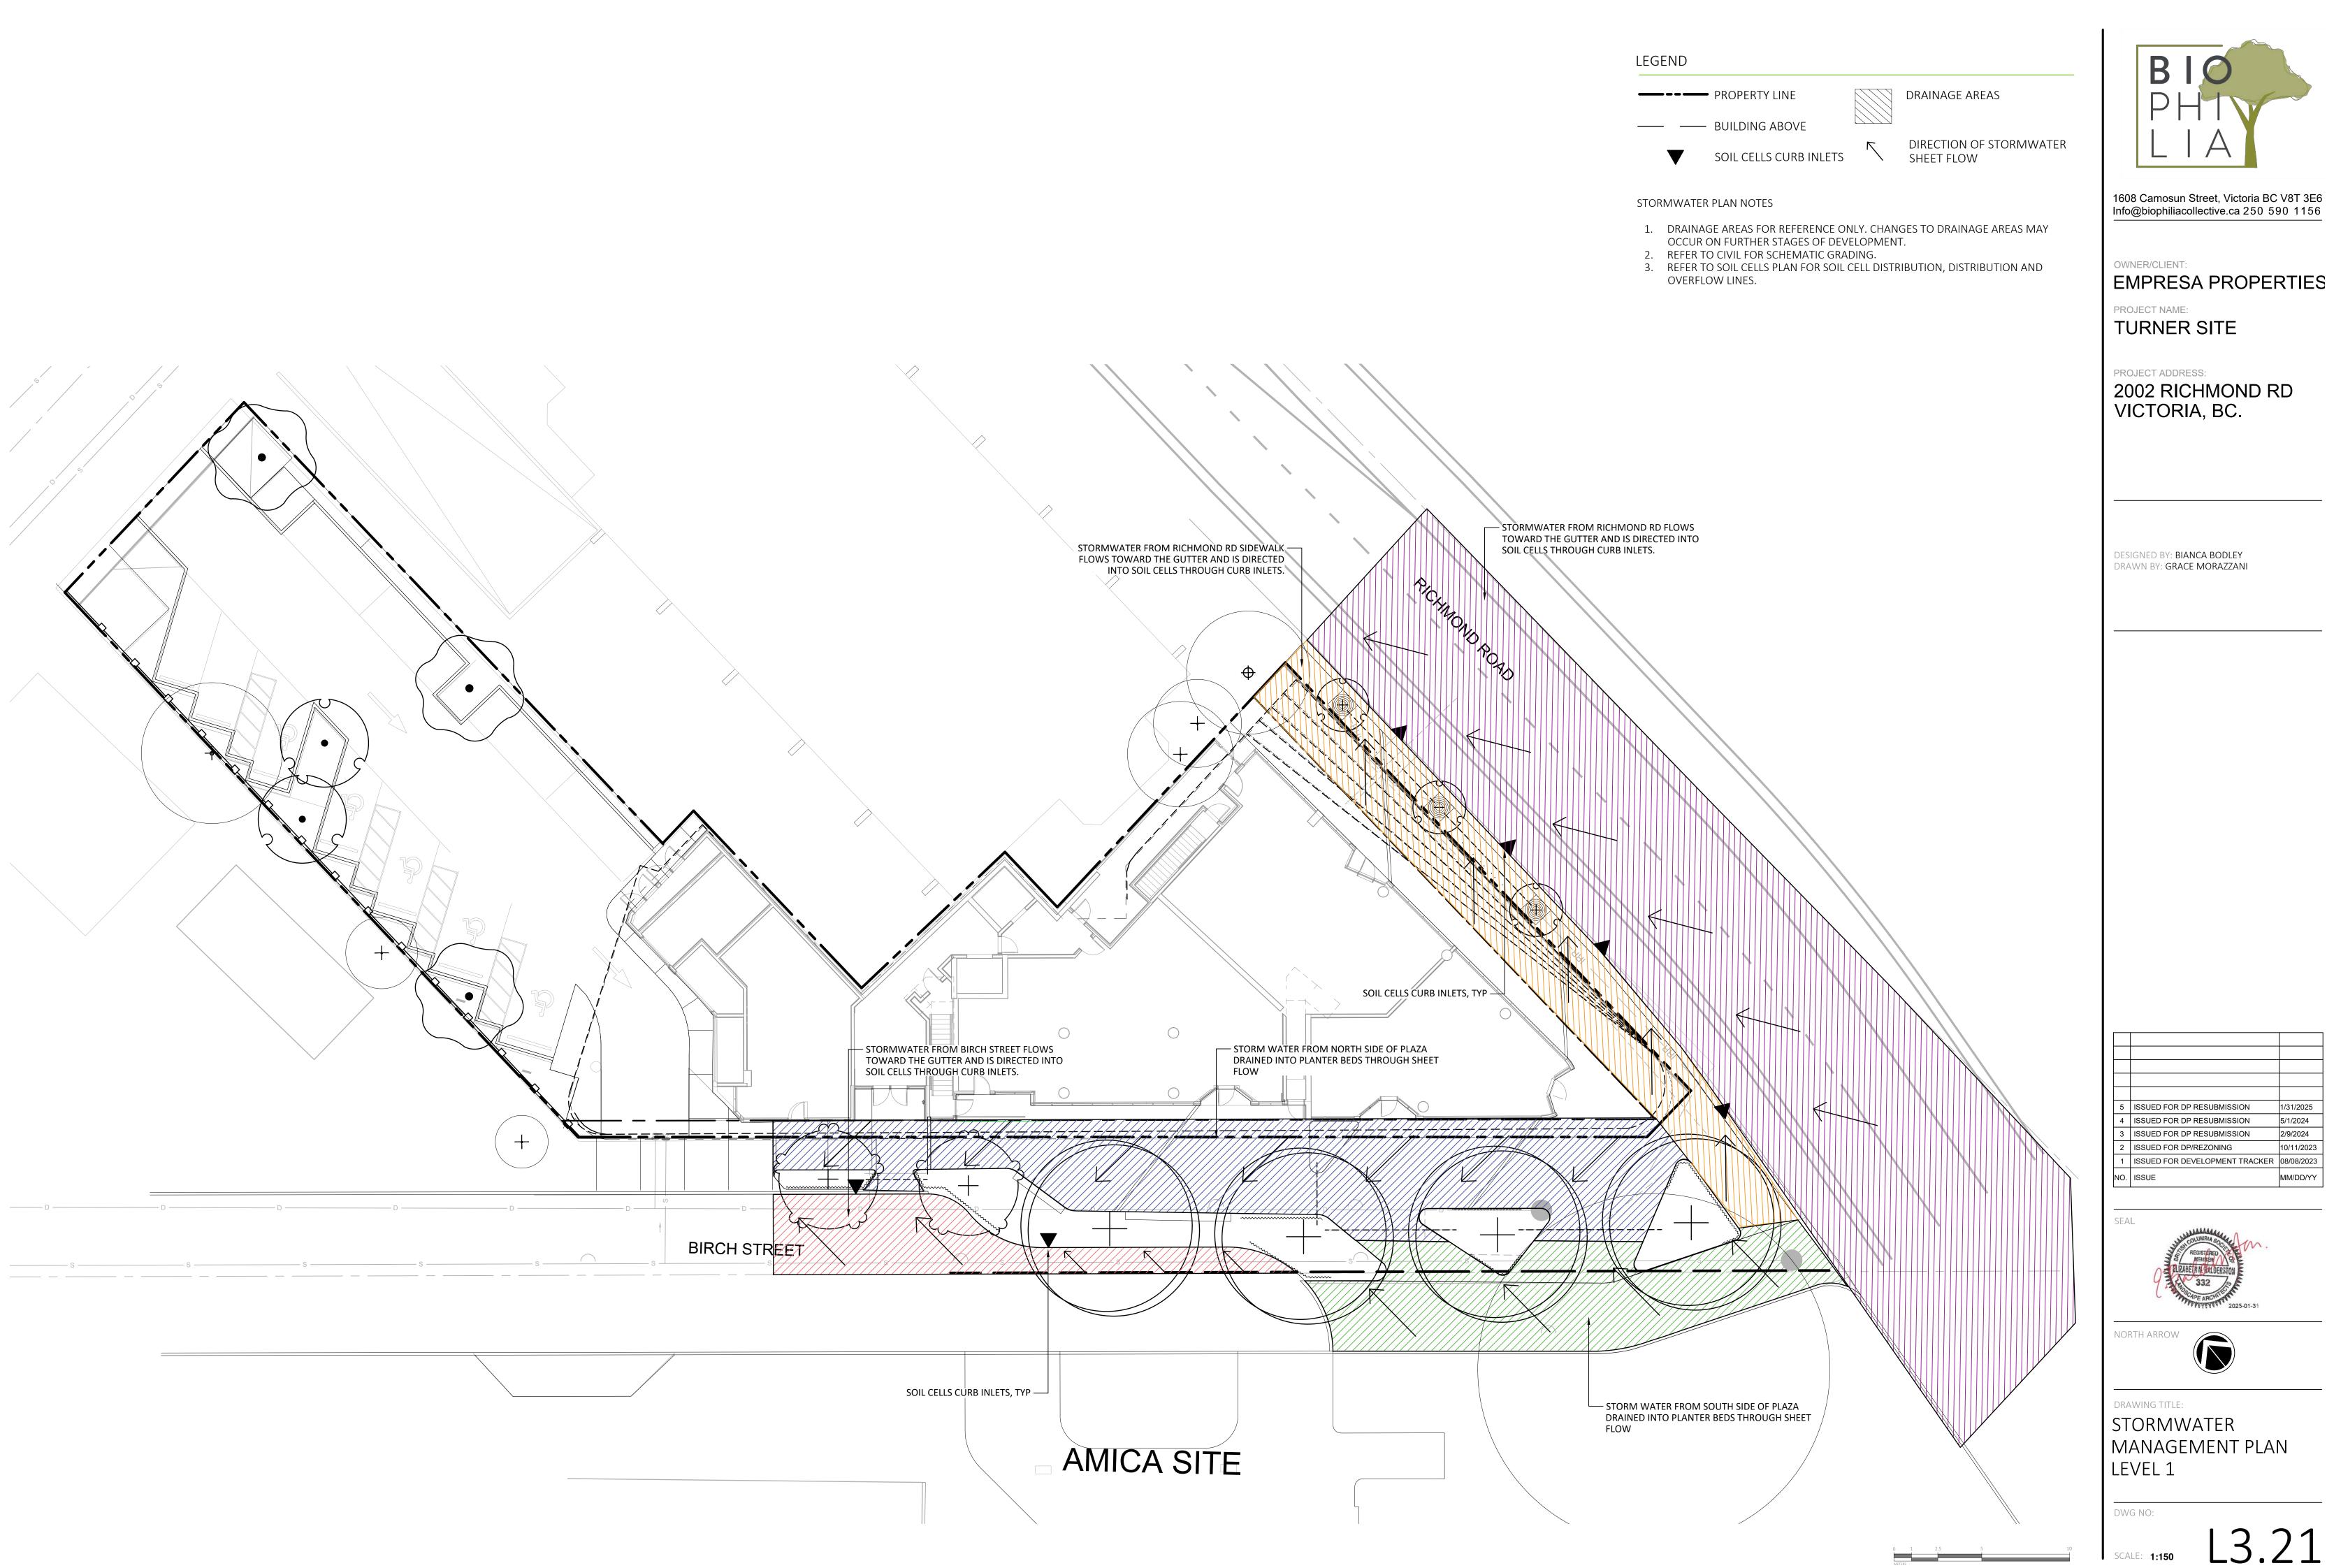

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EMPRESA PROPERTIES


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ISSUE	MM/DD/YY
	ISSUED FOR DP RESUBMISSION ISSUED FOR DP RESUBMISSION ISSUED FOR DP/REZONING ISSUED FOR DEVELOPMENT TRACKER

SCALE: 1:150







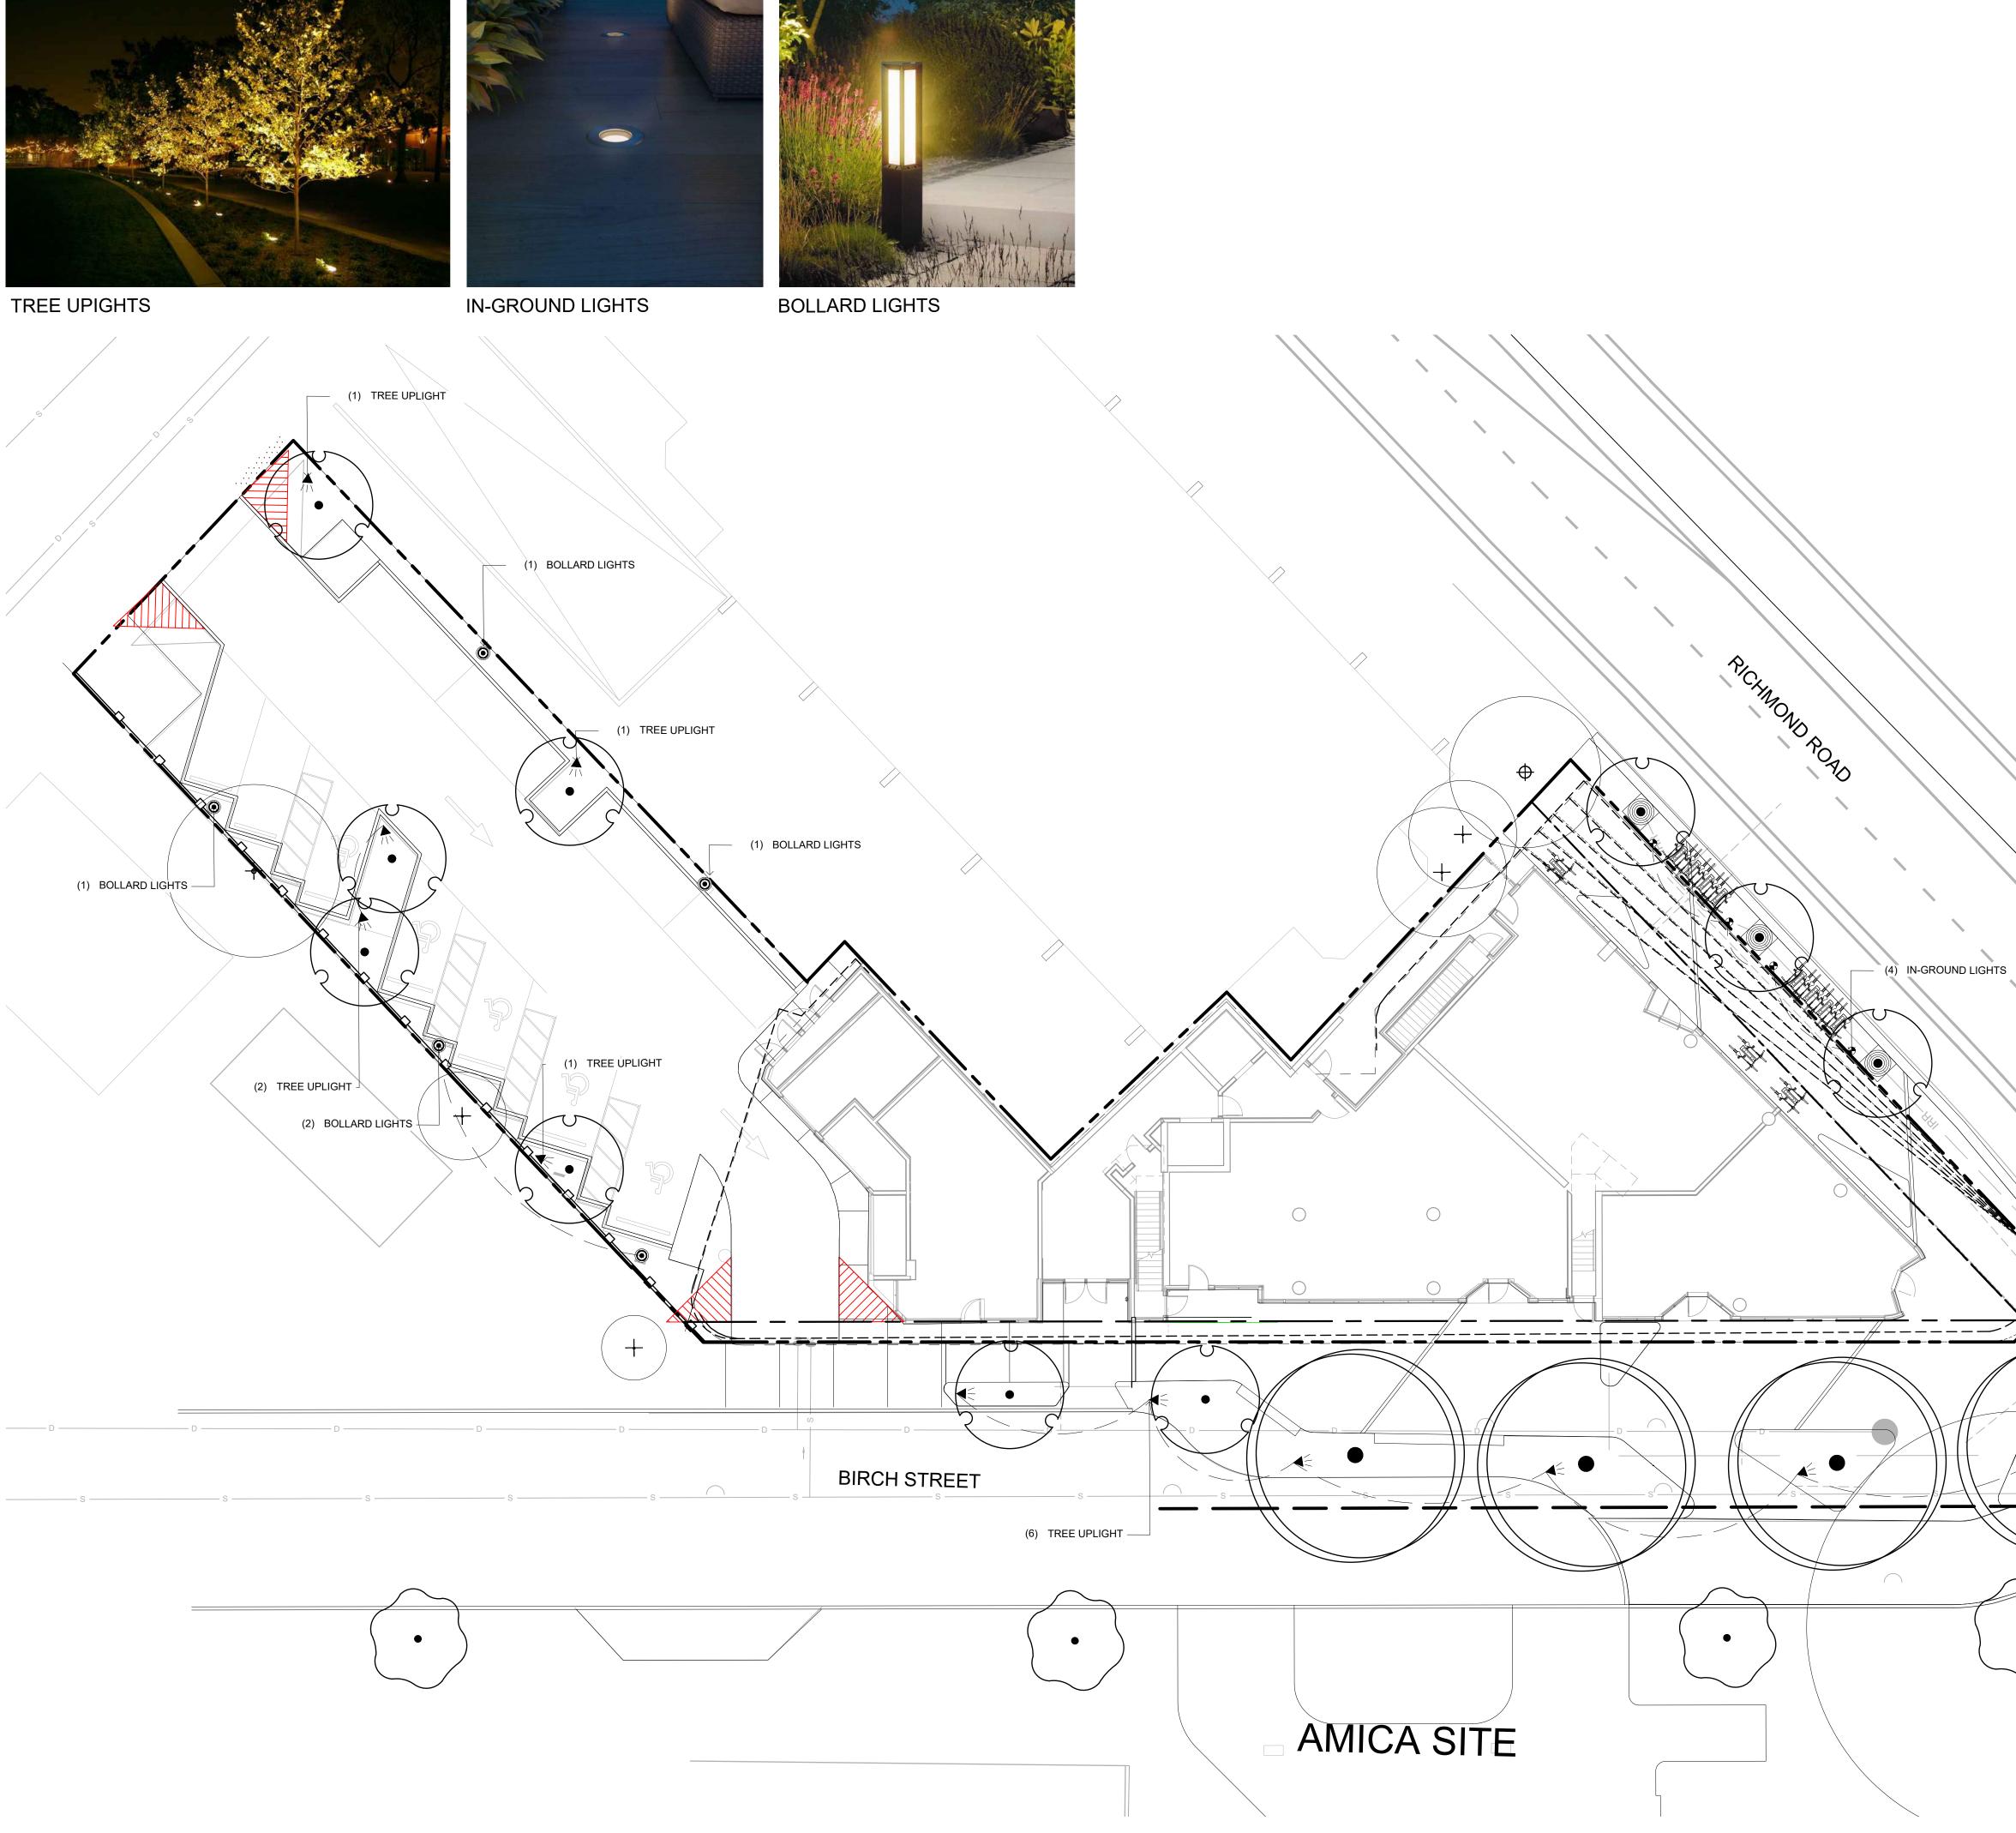





---- BUILDING ABOVE

IRR

RO(

LIGHTING SCHEDULE LEVEL 1

SYMBOL	DESCRIPTION	<u>QT</u>
◄ [_]	TREE UPLIGHTS	11
O	BOLLAR LIGHTS	5

IN-GROUND LIGHTS 4

LIGHTING PLAN NOTES

1. LIGHTING PLAN FOR ILLUSTRATIVE PURPOSES ONLY. LANDSCAPE LIGHTING FIXTURES, TYPES AND LOCATION IN PUBLIC AREAS SUBJECT TO MUNICIPAL APPROVAL



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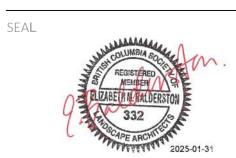
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LIGHTING PLAN












DRAWING TITLE:

DWG NO:

SCALE: 1:150



L4.01

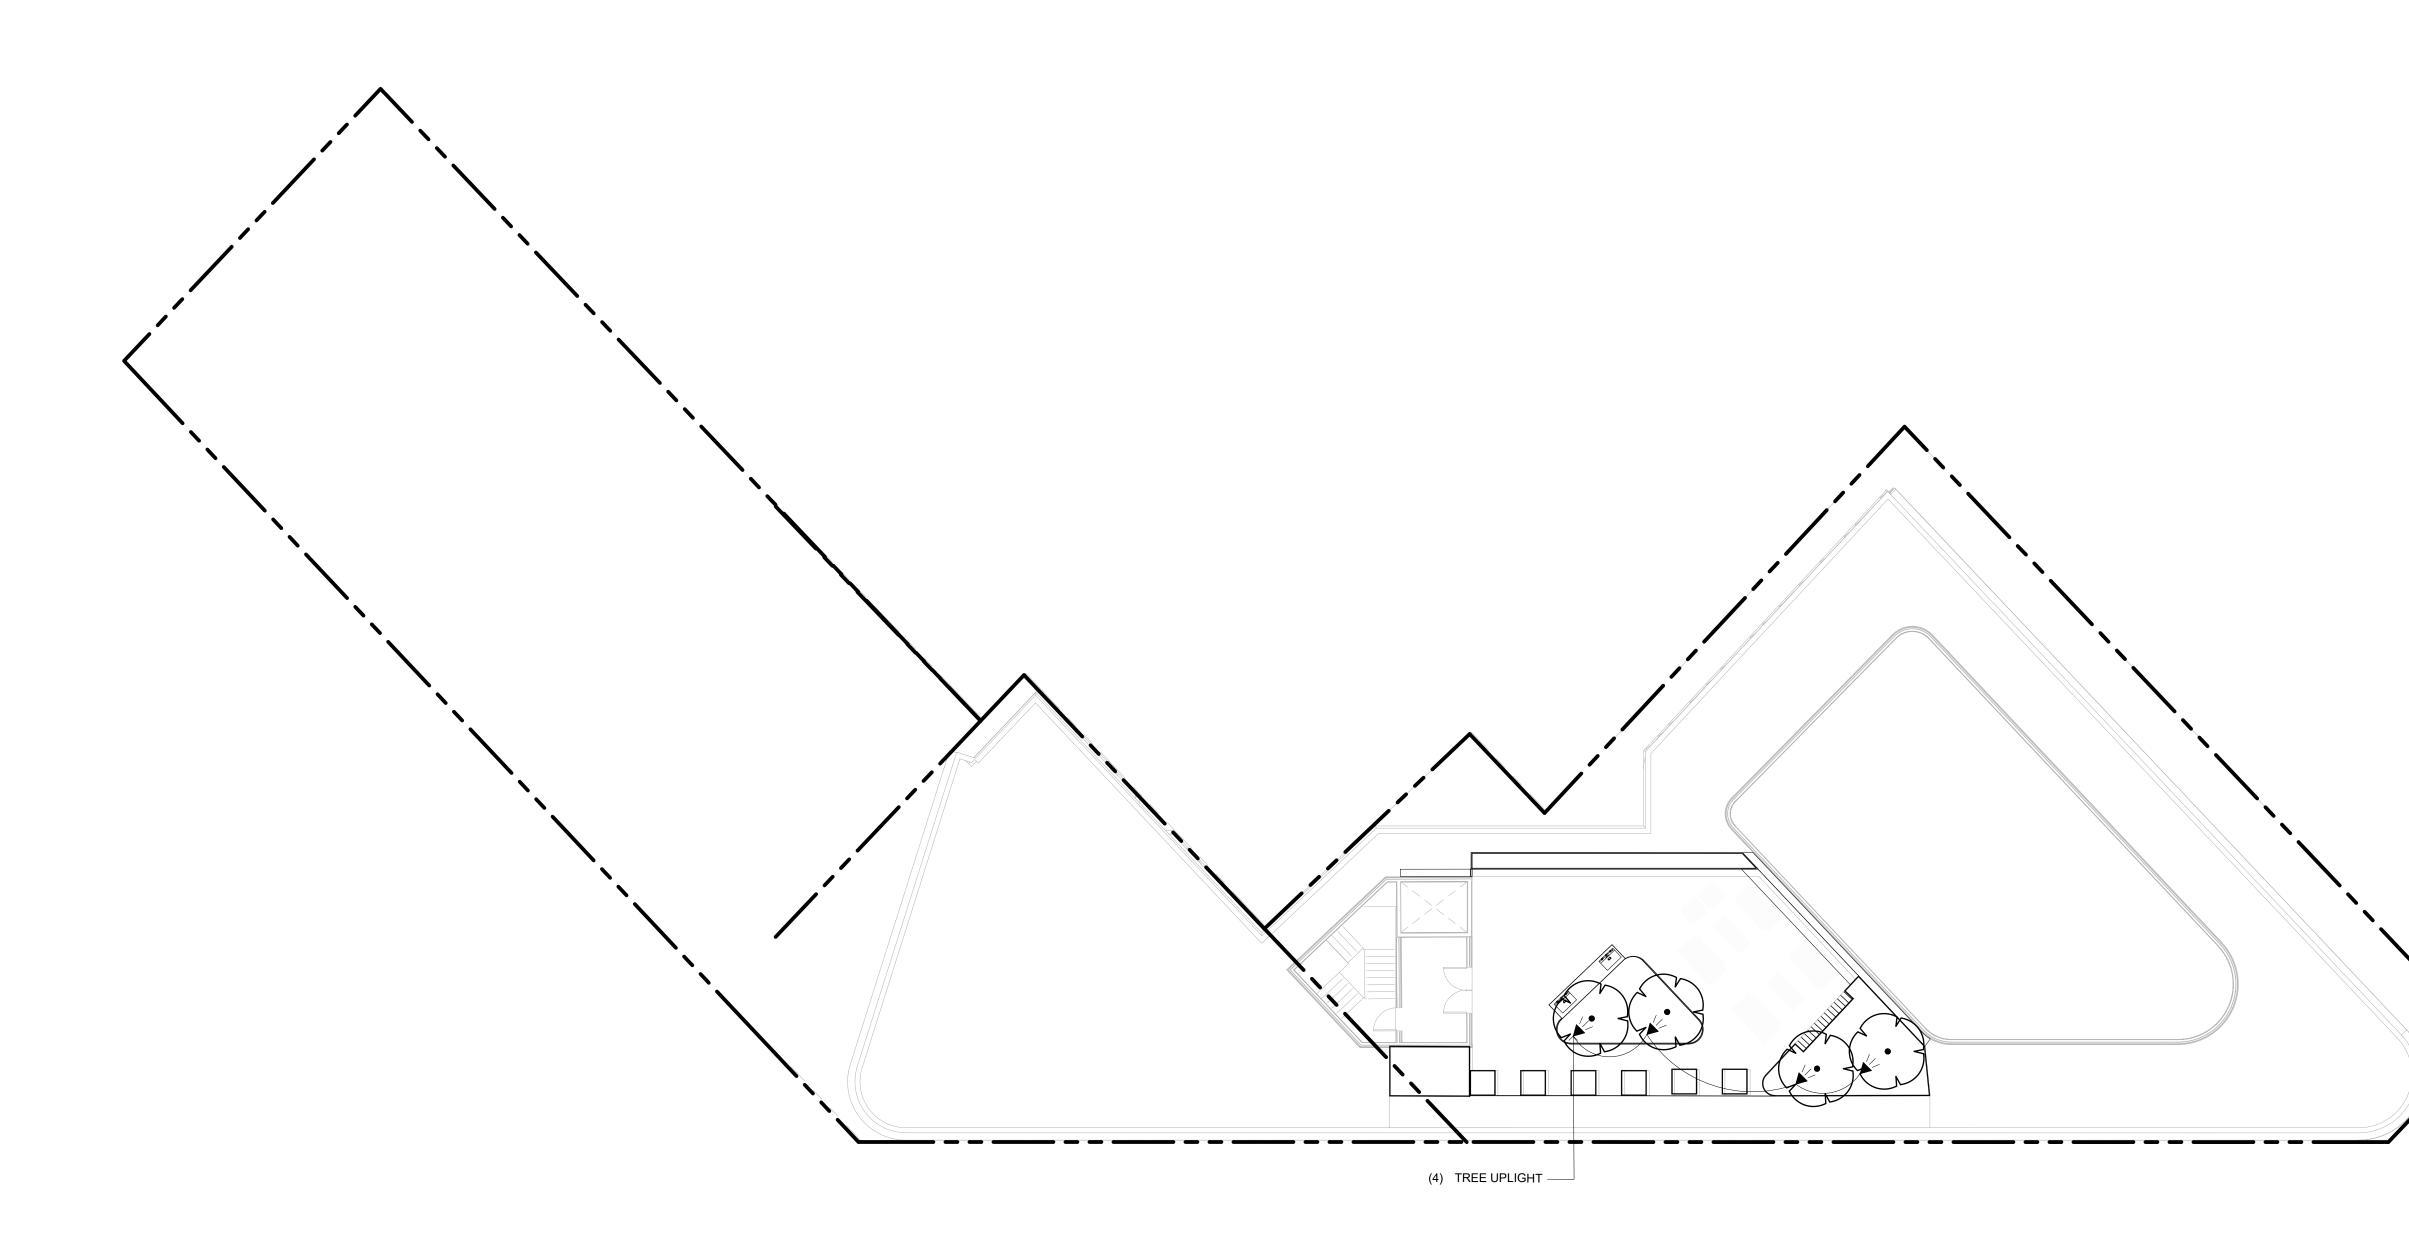

- ---- BUILDING ABOVE

LIGHTING SCHEDULE ROOFTOP2024-02-05 16:42SYMBOLMANUFACTURER/MODEL/DESCRIPTIONQTY



TREE UPLIGHTS

4



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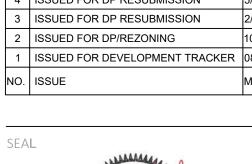
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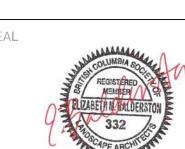
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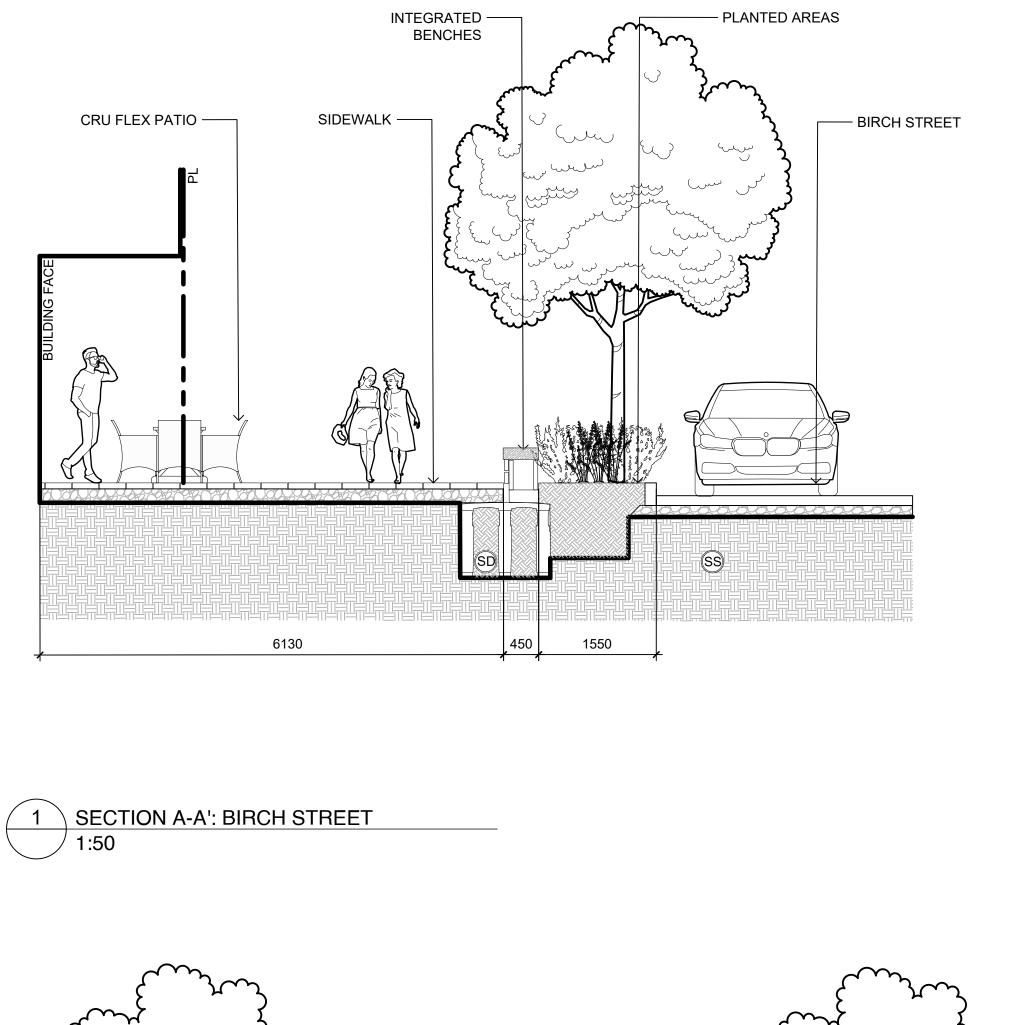



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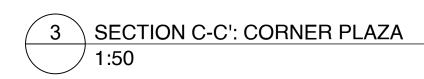
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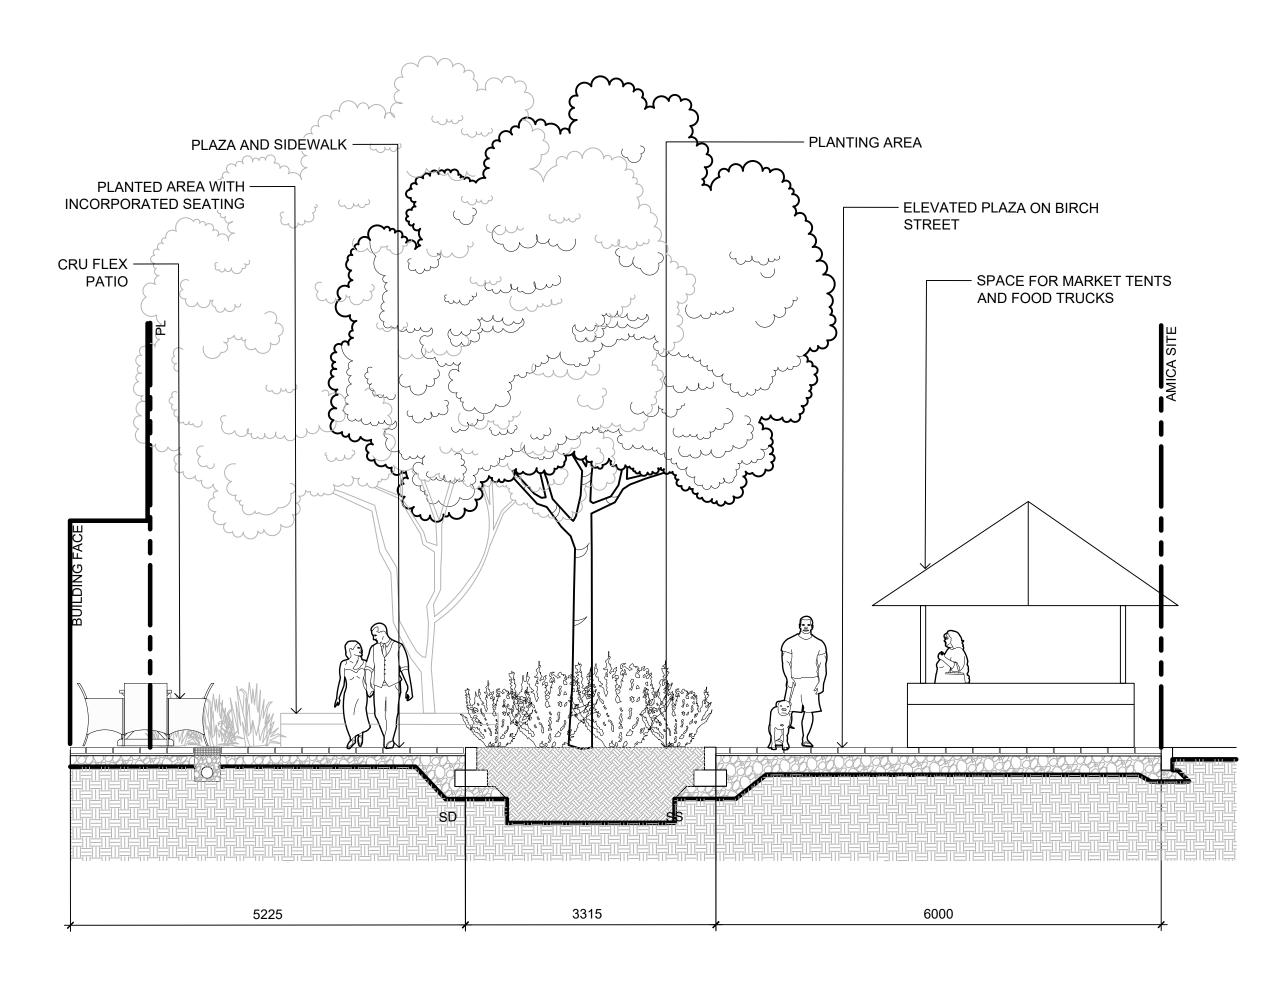













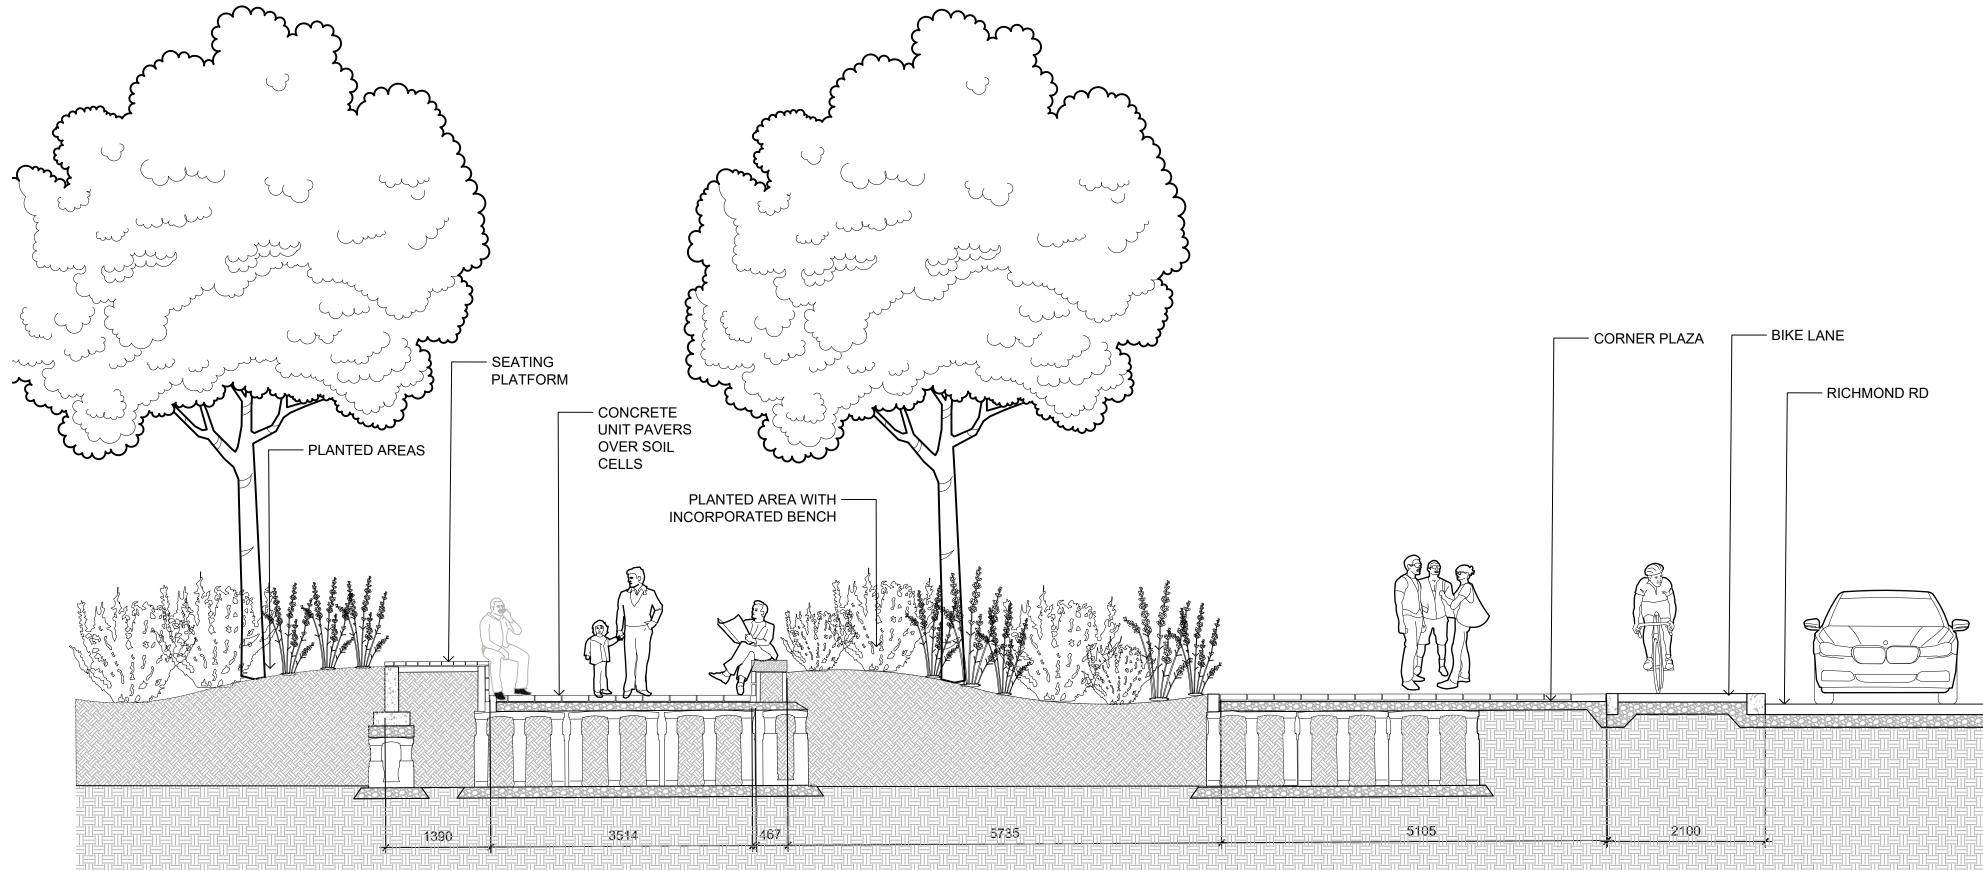

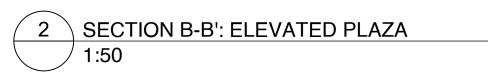

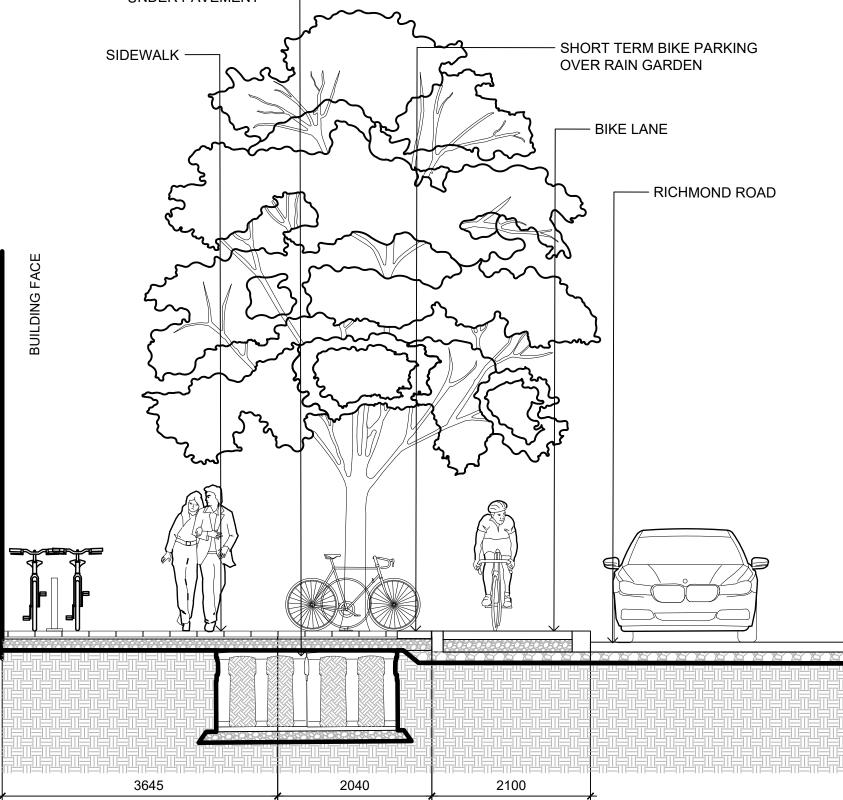



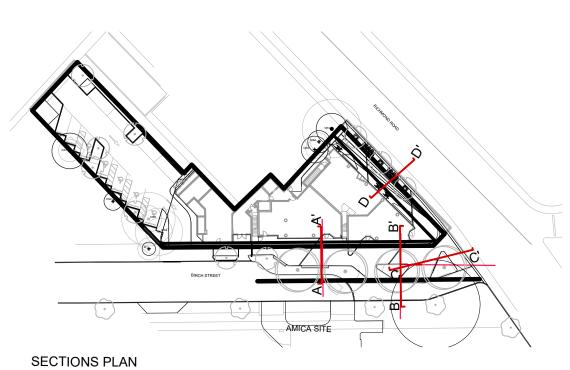

NOTE: SECTION FOR ILLUSTRATION PURPOSES ONLY. FOR CONSTRUCTION INFORMATION REFER TO PLANS AND DETAILS.



1608 Camosun Street, Victoria BC V8T 3E6 Info@biophiliacollective.ca 250 590 1156

OWNER/CLIENT: EMPRESA PROPERTIES

PROJECT NAME: TURNER SITE

PROJECT ADDRESS: 2002 RICHMOND RD VICTORIA, BC.

DESIGNED BY: BIANCA BODLEY DRAWN BY: GRACE MORAZZANI

NO. ISSUE MM/DD/YY SEAL NORTH ARROW DRAWING TITLE: SECTIONS

SCALE: 1:50 L5.01

DWG NO:

5 ISSUED FOR DP RESUBMISSION

ISSUED FOR DP RESUBMISSION

ISSUED FOR DP RESUBMISSION

1 ISSUED FOR DEVELOPMENT TRACKER 08/08/2023


ISSUED FOR DP/REZONING

1/31/2025


5/1/2024

2/9/2024

10/11/2023

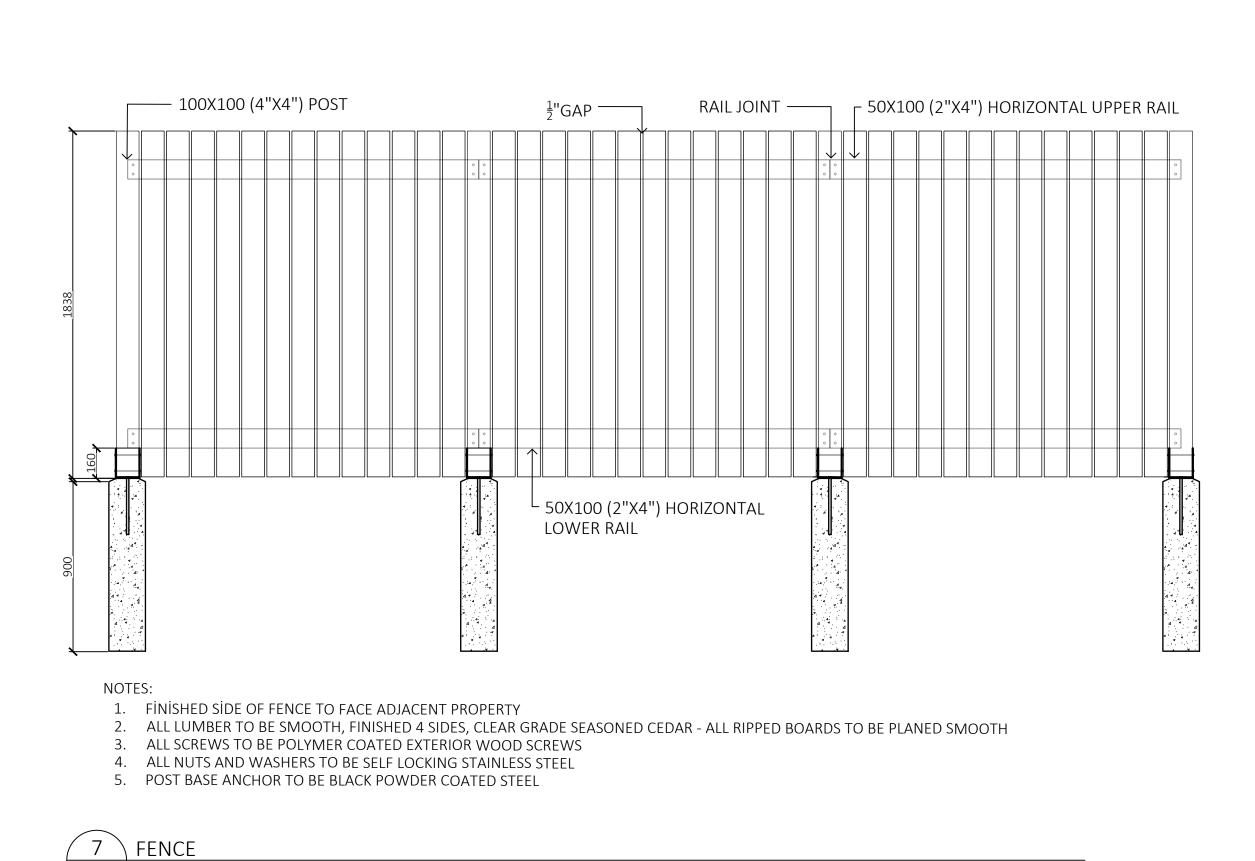

/ 1:10

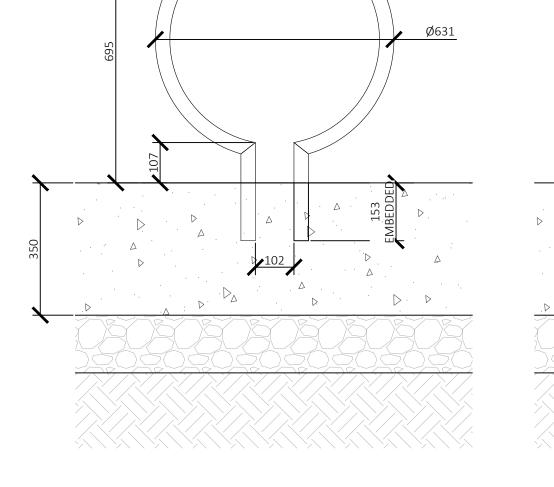

LANDSCAPE FORMS RING BIKE RACK

3

1:10

1:10

BIKE RACK. INSTALL PER MANUFACTURER'S SPECIFICATIONS

-LANDSCAPE FORMS RING



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• SUBGRADE AND GRANULAR BASE TO BE

DFOFOFC

/ 1:10

---- CONCRETE UNIT PAVER — BEDDING SAND

----- GRANULAR BASE

SUBGRADE

– JOINT WIDTH AND JOINT FILL AS PER PAVER

MANUFACTURER SPECIFICATION

• SUBGRADE AND GRANULAR BASE TO BE COMPACTED TO MIN. 95% MPD.

2 > PAVING TYPE 2: CONCRETE UNIT PAVERS


- GRANULAR BASE TO BE COMPACED IN MAX. 100mm LIFTS.
- PAVER AND PAVER INSTALLATION TO MMCD AND MANUFACTURER'S SPECIFICATION UNLESS NOTED OTHERWISE.





- CONCRETE

GRANULAR

BASE

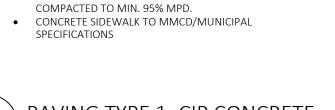

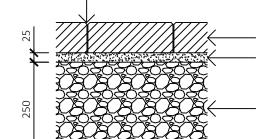

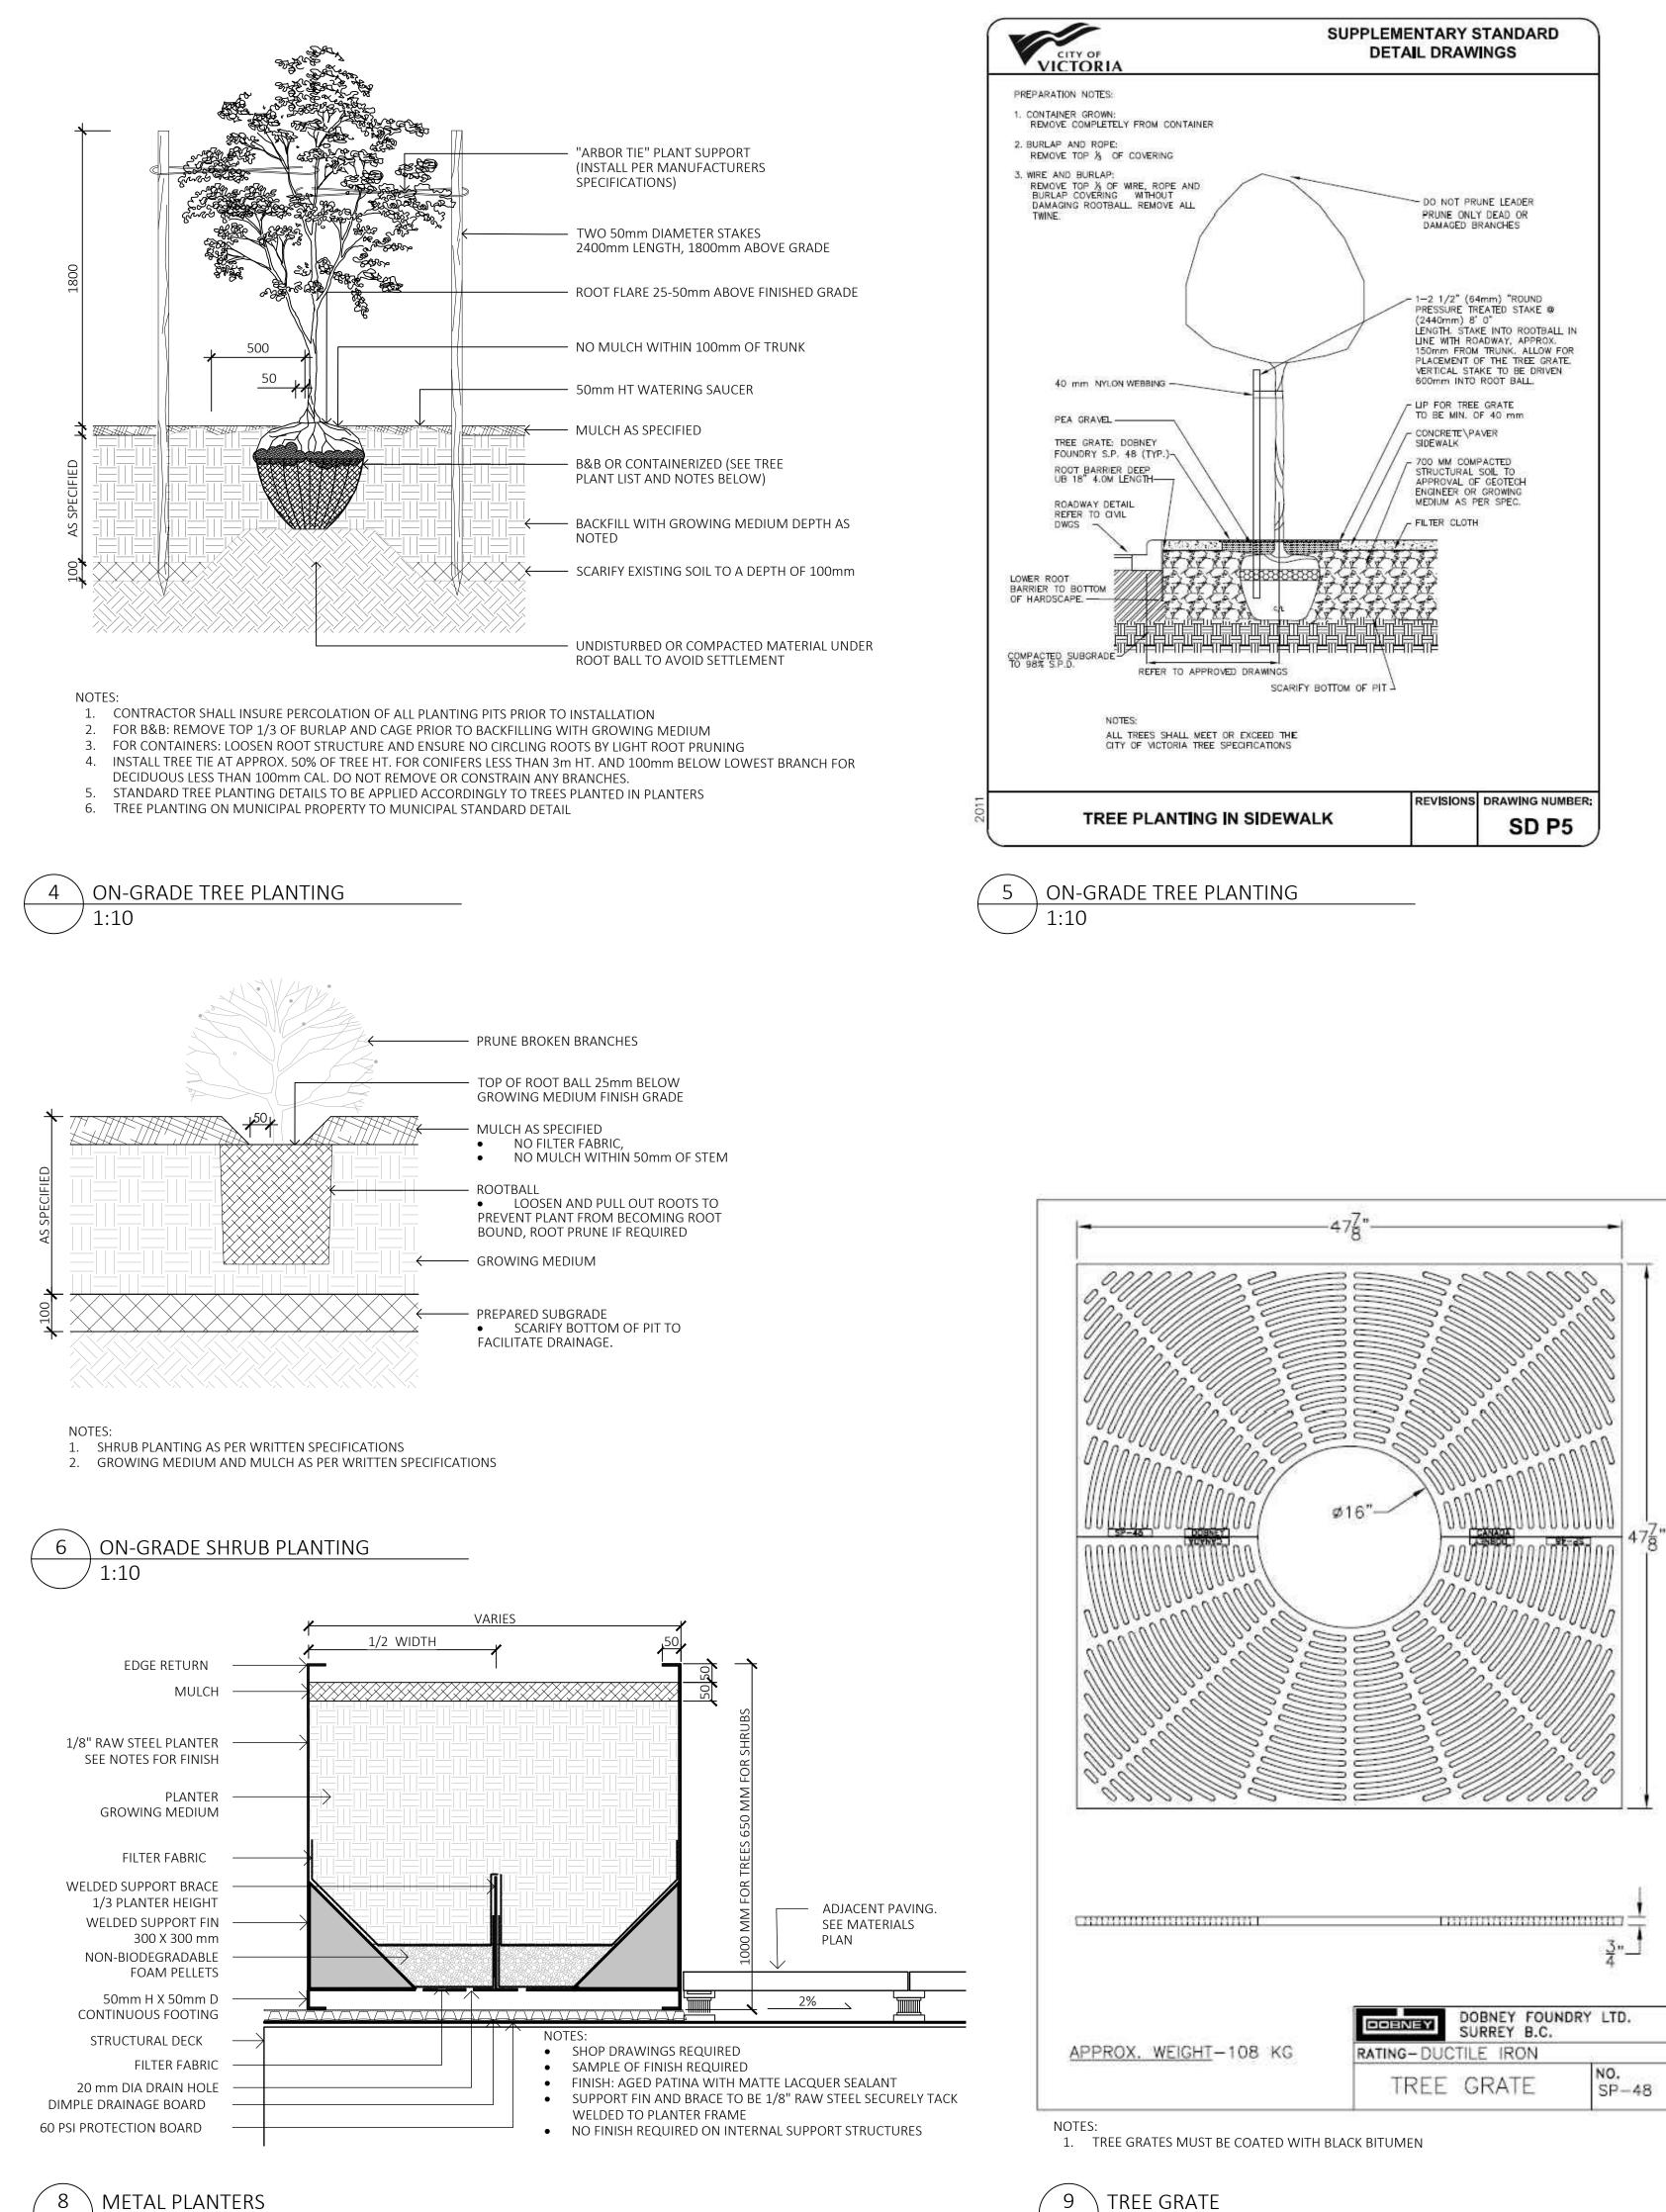


 $9 \setminus \text{TREE GRATE}$ / NTS

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DWG NO:

SCALE: AS SHOWN

6.01

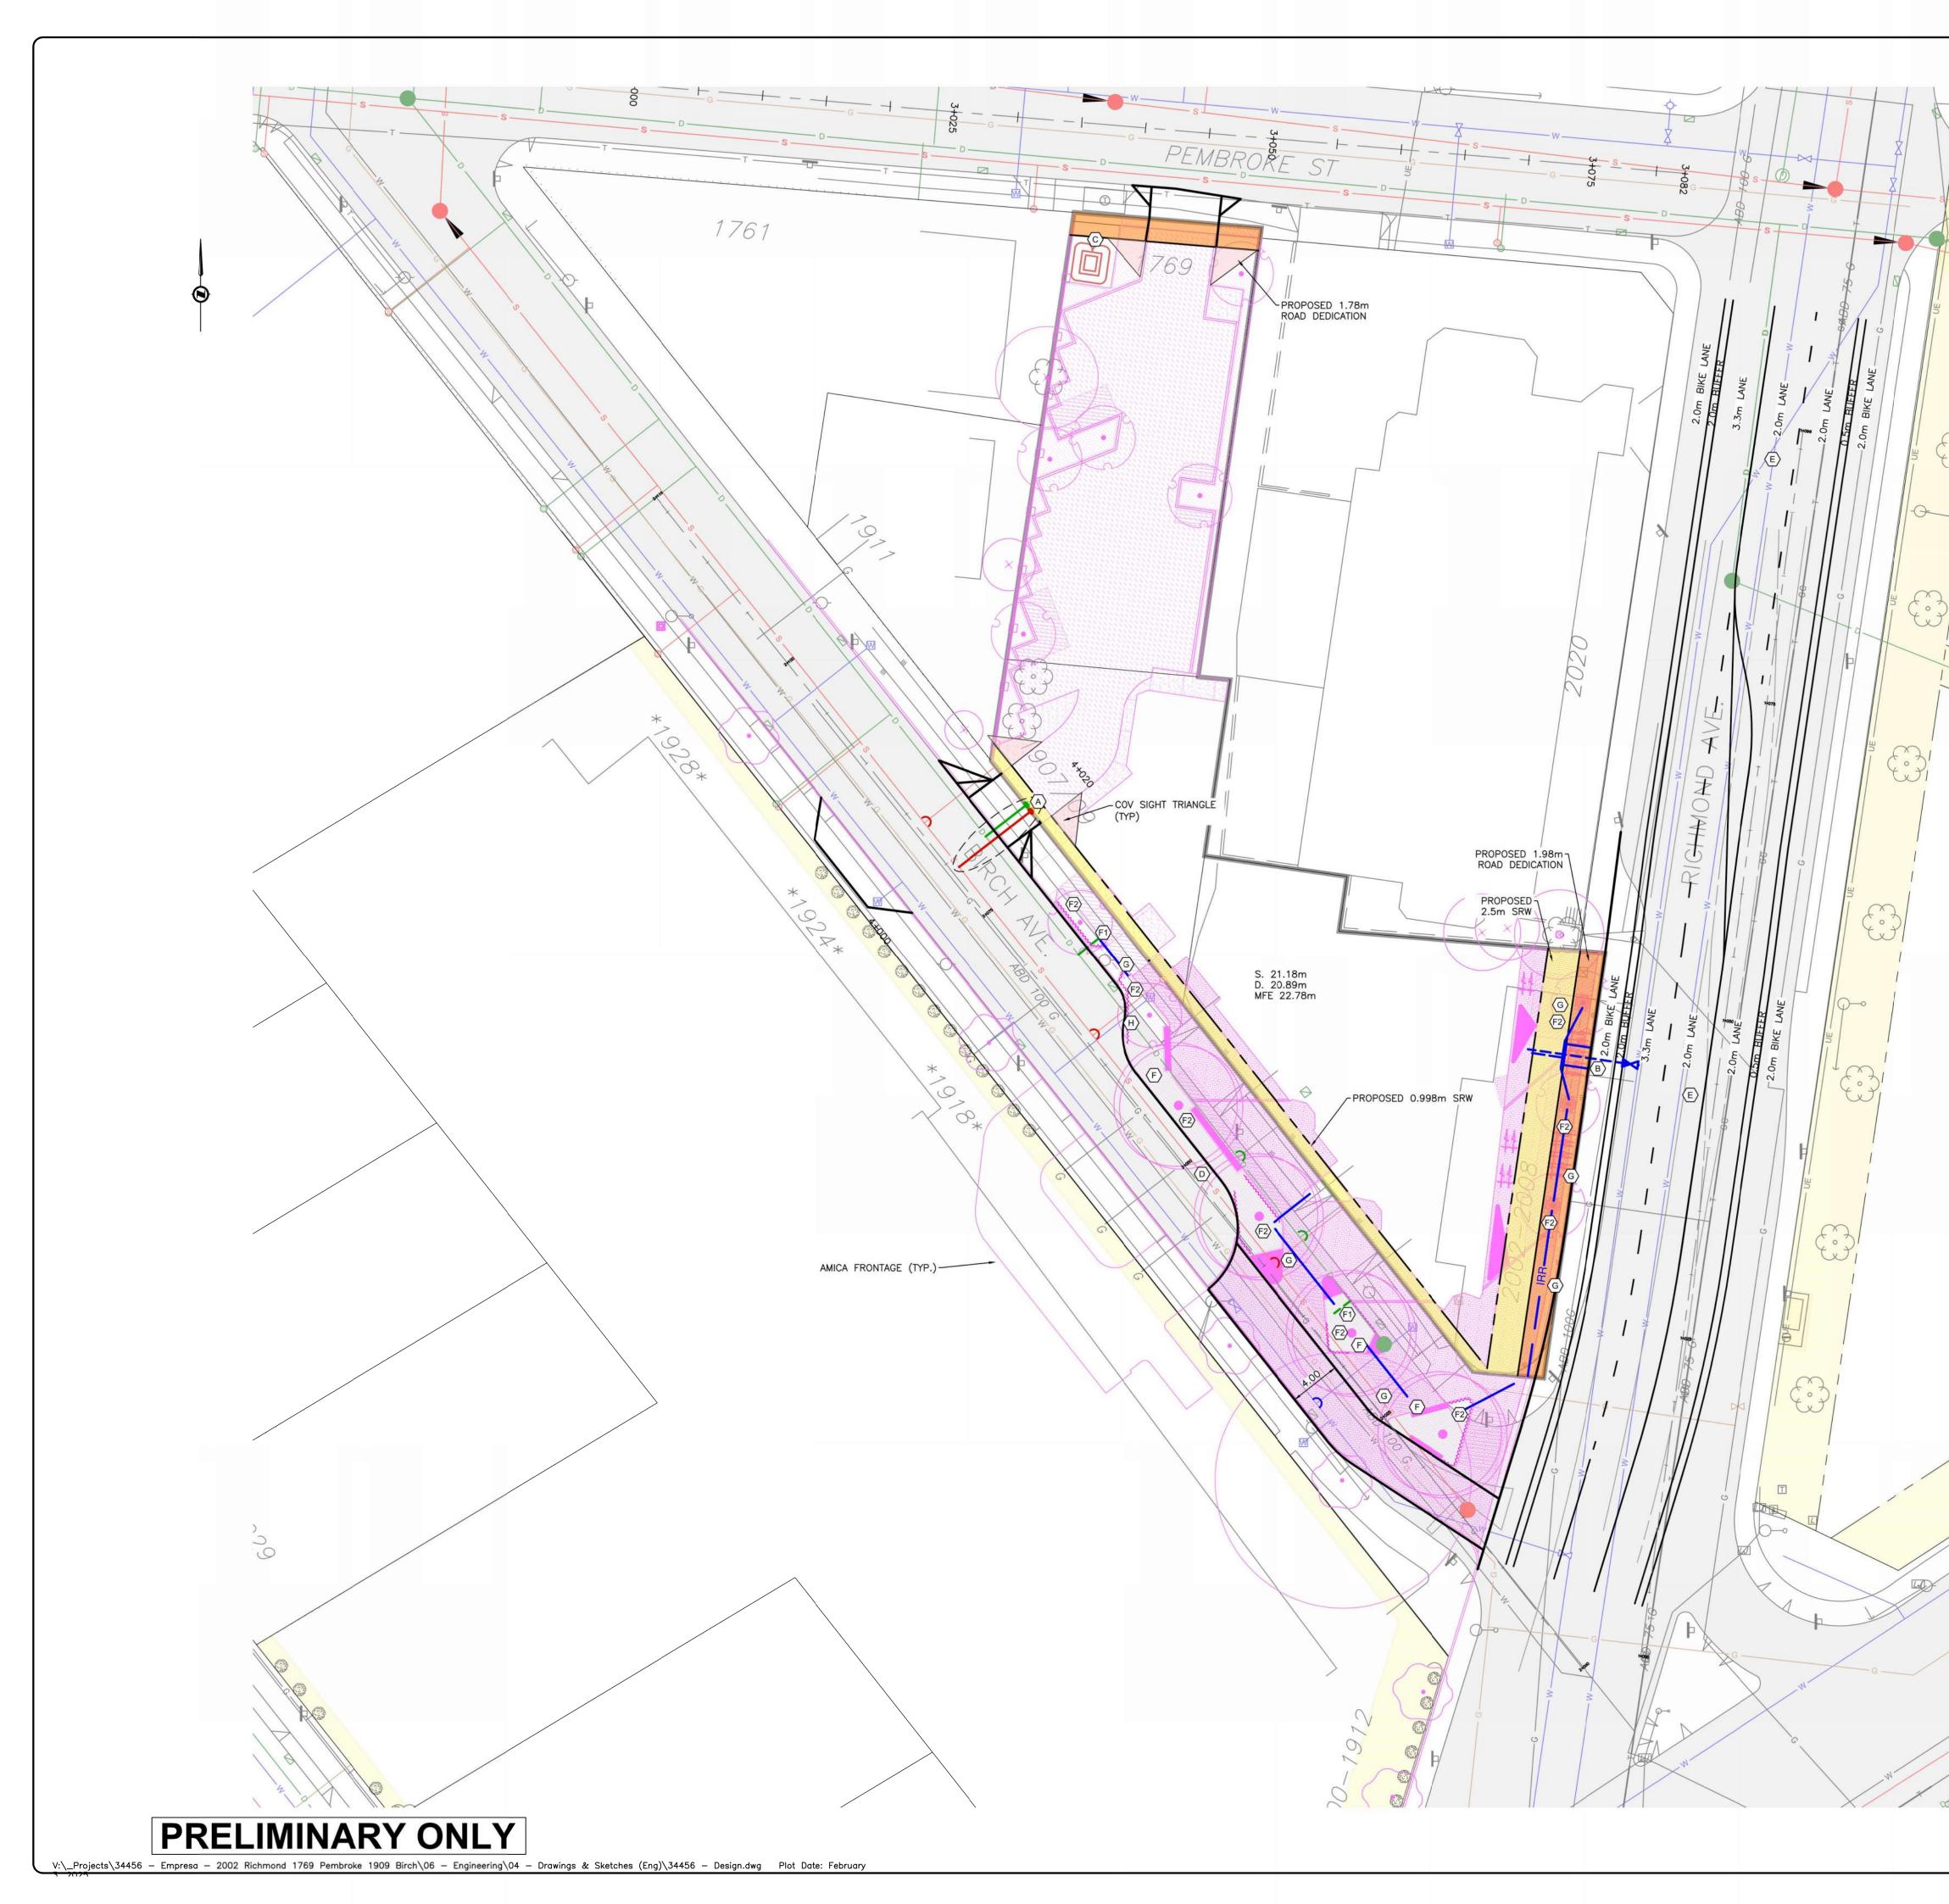

SHEET NOTES: (A) PROPOSED 150 STORM AND SANITARY SERVICES. SIZING. DETAILS TO BE CONFIRMED AT BUILDING PERMIT STAGE. B PROPOSED 100 DOMESTIC AND 150 FIRE WATER SERVICES. DETAILS TO BE CONFIRMED AT BUILDING PERMIT STAGE. C PROPOSED HYDRO SERVICING. CONCEPTUAL ONLY. PENDING HYDRO REVIEW. (D) PROPOSED BIRCH STREET CURB REALIGNMENT. SEE ARCHITECT PLANS FOR PLAZA DETAILS. E PROPOSED RICHMOND AVENUE ULTIMATE FRONTAGE. CONTRACTOR TO INSTALL NEW CURB AND BIKE LANE ACROSS FRONTAGE. REMAINING WORK TO BE DONE BY CITY OF VICTORIA. RUNOFF FROM THE PLAZA TO BE MANAGED THROUGH THE SOILS CELLS. MINIMUM VOLUME TARGET IS 32MM/24-HR RAINFALL EVENT. SOIL CELLS TO HAVE STORAGE, UNDERDRAIN AND OVERFLOW TO CITY STORM MAIN. DETAILS TO BE CONFIRMED AT BUILDING PERMIT STAGE. (F1) PROPOSED STORM SERVICE TO SOIL CELL UNDERDRAIN. UNDERDRAINS NOT SHOW FOR CLARITY. DETAILS TO BE CONFIRMED AT BUILDING PERMIT STAGE. ES SOIL CELL TO HAVE DISTRIBUTION PIPING AND UNDERDRAINS. PIPES NOT SHOWN FOR CLARITY. DETAILS TO BE CONFIRMED AT BUILDING PERMIT STAGE. PROPOSED IRRIGATION SLEEVING UNDER HARD SURFACES. ALL WORK TO BE AS PER SCHEDULE C TO THE VICTORIA SUBDIVISION AND DEVELOPMENT SERVICING BYLAW 12-042. DESIGN TO BE CONFIRMED AT BUILDING PERMIT STAGE. H EXISTING WATER SERVICE TO BE CONVERTED TO IRRIGATION SERVICE. DESIGN TO BE CONFIRMED AT BUILDING PERMIT STAGE. ()LEGEND LAMP STANDARD +LS 🔶 CLEANOUT DITCH POLE(Hydro, Tel.) 🗢 PP 🔶 CATCHBASIN METER OW \odot MANHOLE J/G WIRING ____ UE -___ SERVICE RISER VALVE \bowtie WATER REDUCER -MOUNTABLE CURB 4 SEWER NON-MOUNT. CURB + HYDRANT -0-- AIR VALVE 💿 🙆 EDGE ASPHALT -____ D ___ 2002 RICHMOND AVENUE FOR CO-ORDINATION PRELIMINARY SERVICING -ULTIMATE FRONTAGE Scale horiz. 1:250 Scale N/A Sheet 1 of Eng. Project No. 34456 Drafted by. RT/JA J E ANDERSON & R. TUCK #28072 EGBC#1001272 JE/ ASSOCIATES SURVEYORS - ENGINEERS VICTORIA NANAIMO PARKSVILLE CAMPBELL RIVER PHONE: 250-727-2214 info@jeanderson.com