

LOCATION PLAN

LOW-ENERGY DUPLEX

Address: 1008 Chamberlain
 Layer Lot 16, Section 14, Victoria District, Plan 232
 PID 003795-000
 Zoning: R2-55 - Duplex with Secondary Suite* (Chamberlain)
 Property area: 709.4 sq.m.
 Property footage: 19,444 m²

Proposed

The single-family home will be **DEMOLISHED, RECONSTRUCTED*** and expanded to primarily residential opportunity in the neighbourhood.
 An attached, two-storey, single-family addition will be constructed on the southern portion of the property.
 The existing single-storey, single-family residence with basement will be **DEMOLISHED AND REPLACED*** to include a second suite*.
 ALL SUITES will be constructed to a high energy-performance standard with the aim to achieve Passive House certification.
 *Per BCRC 2012, all suites will be constructed in accordance with the requirements for a multi-unit residential duplex.

*Demolition of the existing home is necessitated by the condition of the existing structure and structural demands of the current building code. Parts of the existing home will be salvaged and reused for non-structural purposes in the new building. Portions of the new building will resemble the existing home in proportion and layout, saving in the original intent to reuse part of the original structure.

Area

Property area: 709.37 sq.m.
 Footprint: 19,444 m²
 Basement (Suite 1, 2): 107.7 sq.m.
 Main floor (Suite 1): 107.7 sq.m.
 Lower floor (Suite 2): 79.2 sq.m.
 Upper floor (Suite 2): 74.2 sq.m.
 Total area: 262.1 sq.m. (excludes basement)
 FSR: 0.26

Setbacks

Setbacks	Required	Proposed
Front	7.37 m*	8.09 m (F/House)
Rear	3.80 m	8.70 m (T.O.W. 3.1m A.F.G.)
Side	3.80 m	6.70 m (Eaves If varies)
Star	3.80 m	3.20 m (MEETS GRADE)
North Side	1.95 m	2.58 m (BUILDING) 1.94 (HEAT PUMP)
South Side	3.80 m	3.20 m
Combined	4.95 m	5.23 m
Rear House	12.64 m*	12.70 m
Rear Deck	12.80 m	10.26 m

*0.13m allowance for exterior insulation
 *Eaves projection into required setback: (2.75 m encroachment permitted)

Front porch: 0.81 m
 Front of house (not over porch): 0.82 m
 North Side: NONE
 South Side: NONE
 Rear: 0.70 m

Height

Proposed: 7.8 m
 6.81 m to 1st parapet
 6.88 m to mid-height of gable roof
 7.58 m to roof peak

Number of storeys: Two

Parking: Two stalls in front-yard

Bicycle Parking: Three Class 1 in accessory buildings

Site Coverage: 294 sq.m. (253.4 sq.m.) (35%)

Open Site Space:

Lot: 213 sq.m. (112.7 sq.m.) (50%)
 Rear yard area: 19.44 x 10.24 = 199.30 sq.m.
 Rear storage: 31.2 sq.m. (15%)
 Rear Open: 66 sq.m. 168.1 sq.m. (85%)

Total number of units: 2 - secondary suite*

Unit types: Three bedroom: 144 sq.m.
 Two bedroom + den: 164 sq.m.
 studio: 52 sq.m.

Total floor area: 359 sq.m.
 All units ground internal

AVERAGE GRADE PER VICTORIA ZONING DEFINITION

HOUSE	EL1	EL2	LENGTH (m)	
A-B	20.02	19.95	15.18	303.37
B-C	18.88	19.88	5.51	109.74
C-C	18.88	19.28	6.06	9.95
C-D	19.28	19.47	3.46	96.84
D-D	19.47	19.47	1.09	21.22
D-E	19.47	20.34	0.78	13.01
E-F	20.34	20.39	1.03	30.57
F-G	20.39	20.11	1.52	40.80
G-H	20.11	19.44	1.46	38.88
H-J	20.14	20.06	2.38	47.44
J-K	20.06	20.33	19.43	392.39
K-L	20.33	20.28	3.51	77.61
L-M	20.28	20.19	1.11	22.42
M-M	20.19	19.27	1.26	24.86
N-P	19.27	19.27	1.52	19.86
P-Q	19.27	19.27	3.52	80.76
Q-Q	19.27	20.36	0.80	0.01
Q-R	20.36	20.36	1.41	29.46
R-S	20.36	20.37	0.54	10.84
S-A	20.37	20.02	4.58	91.81


Total perimeter: 68.67m

Average grade: EL: 19.38m

Maximum permitted height: 7.50m EL: 27.88m

ACCESSORY BUILDINGS TO CONFORM TO A MAXIMUM HEIGHT OF 2.4m AVE. AVERAGE GRADE

Elevations shown above geotied datum.

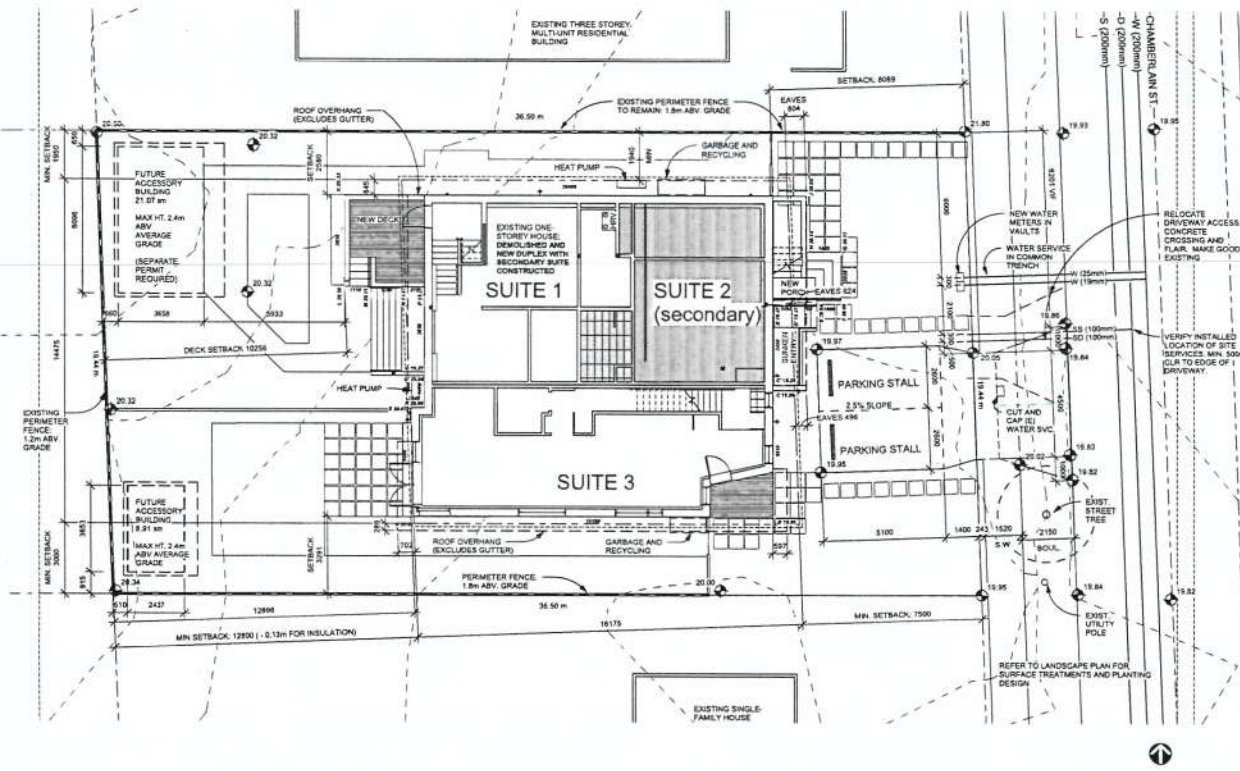

Building Code: 2012 BCRC Part 4

Major occupancy classification: C - Residential

Building Area: 252.12 m²
 Basement Area: 107.70 m²
 Total Area: 359.82 m²

Facing Slopes: (1)

Construction: Combustible

Building Height: 2 storeys + Basement

Fire suppression: Non-sprinklered

Fire alarm: Interconnected smoke detector/s within suites only

Assemblies:
 Walls between suites: 1.0 hr
 Floors between suites: 1.0 hr
 Mezzanine floors: None

Occupancy

Suite	Area	Occupant Load
Suite 1 - Existing house structure dwelling	154 m ²	4
Suite 2 - Existing house second dwelling	52 m ²	2
Suite 3 - New dwelling	144 m ²	4
Total	350 m²	10

Fire separations

Fire separation	FRR	Clause
1-2	1.0 hr	S.10.8.14
1-3	1.0 hr	S.10.8.14
2-3	1.0 hr	S.10.8.14

Spatial Separations: Per BCRC 3.16.14

Elevation	LD	FRR	Construction	Cladding	Area (sq.m)	Permitted %	Designated sq.m
North (Suite 2)	2.58 m	1.0h	Combustible	Non-Comb.	115.2 m ²	15.8%	2.2 m ²
North (Suite 1)	2.58 m	1.0h	Combustible	Non-Comb.	53.2 m ²	15%	10.8 m ²
East	8.09 m	1.0h	Combustible	Non-Comb.	75.8 m ²	100%	4.2 m ²
South	3.20 m	1.0h	Combustible	Non-Comb.	87.9 m ²	15.4%	14.5 m ²
West	9.28 m	1.0h	Combustible	Combustible	75.8 m ²	100%	-

(Areas of unprotected openings incorporated per Appendix A using linear interpolation between assigned values for limiting distance and area of opening building back.)

UNDERGROUND SERVICE INFORMATION

DEPTH (PL)	STORM	SANITARY
1.42m	1.17m	
19.62m	18.87m	

MAXIMUM DEPTH REQUESTED FOR BOTH SERVICES

INSTALL STORM DRAIN AND SANITARY SEWER IN A COMMON TRENCH

NOTE:
 Location of services in Chamberlain Street are approximate. Verify locations and depth in field.



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Do not scale these drawings.

No.	Description	Date
1	SUBDIVISION	FEB 7 2016
2	Rezoning	July 25, 2016
3	Rezoning Revision	Nov 17, 2016
4	Rezoning Revision	Mar 1, 2017
5	DP Revision	June 15, 2017
6	DP Revision	July 12, 2017
7	BP	Feb 9, 2018
8	BP Revision	Mar 2, 2018
9	BP Revision	Apr 25, 2018
10	DDP Revision	Sep 20, 2018
11	DDP Revision	Nov 1, 2018
12	DVP Application	Feb 3, 2019
13	DVP Revision	Mar 5, 2019
14	DVP Revision	Apr 17, 2019

Love-Mahoney
CHAMBERLAIN LOW ENERGY DUPLEX
 SITE PLAN, INFO & SERVICING

Project number: 2015 008
 Date: JULY 25, 2016
 Drawn by: MA
 Checked by: MA

A101
 Scale: As Indicated
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- FLOOR PLAN NOTES AND LEGEND:**
- REFER TO STRUCTURAL DRAWINGS FOR LOAD BEARING AND LATERAL SYSTEM
 - REFER TO RCP FOR ELECTRICAL VENTILATION AND FIRE SAFETY EQUIPMENT
 - WINDOWS DENOTED EGRESS SHALL BE SASH-TYPE WITH A MINIMUM CLEAR OPENING DIMENSION OF 36" HIGH AND 0.35 M²

- FLOOR PLAN LEGEND:**
- IN-FLOOR ELECTRIC RADIANT HEATER
 - RADIANT HYDRONIC ZONE
 - THERMOSTAT
 - ELECTRIC HEATER ROUGH-IN
 - HOSE BIB


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No.	Description	Date
1	SUBDIVISION	FEB 7 2016
2	Reznoring	JULY 25, 2016
3	Reznoring Revision	NOV 17 2016
4	Reznoring Revision	MAR 1 2017
5	DP Revision	JUNE 15, 2017
6	DP Revision	JULY 12 2017
7	BP	FEB 9, 2018
8	BP Revision	MAR 2, 2018
9	BP Revision	APR 25 2018
10	DDP Revision	SEP 26, 2018
11	DDP Revision	NOV 1, 2018
12	DVP Application	FEB 1, 19

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CHAMBERLAIN LOW ENERGY DUPLEX
LOWER FLOOR PLANS

Project number: 2015 008
 Date: JULY 25, 2016
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A202
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LOWER FLOOR PLANS
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FLOOR PLAN NOTES AND LEGEND:

1. REFER TO STRUCTURAL DRAWINGS FOR LOAD BEARING AND LATERAL SYSTEM
2. REFER TO RCP FOR ELECTRICAL, VENTILATION AND FIRE SAFETY EQUIPMENT
3. WINDOWS DENOTED CROSS SHALL BE SUB-TYPE WITH A MINIMUM CLEAR OPENING DIMENSION OF 36" AND 0.35 I.R.G.

FLOOR PLAN LEGEND:

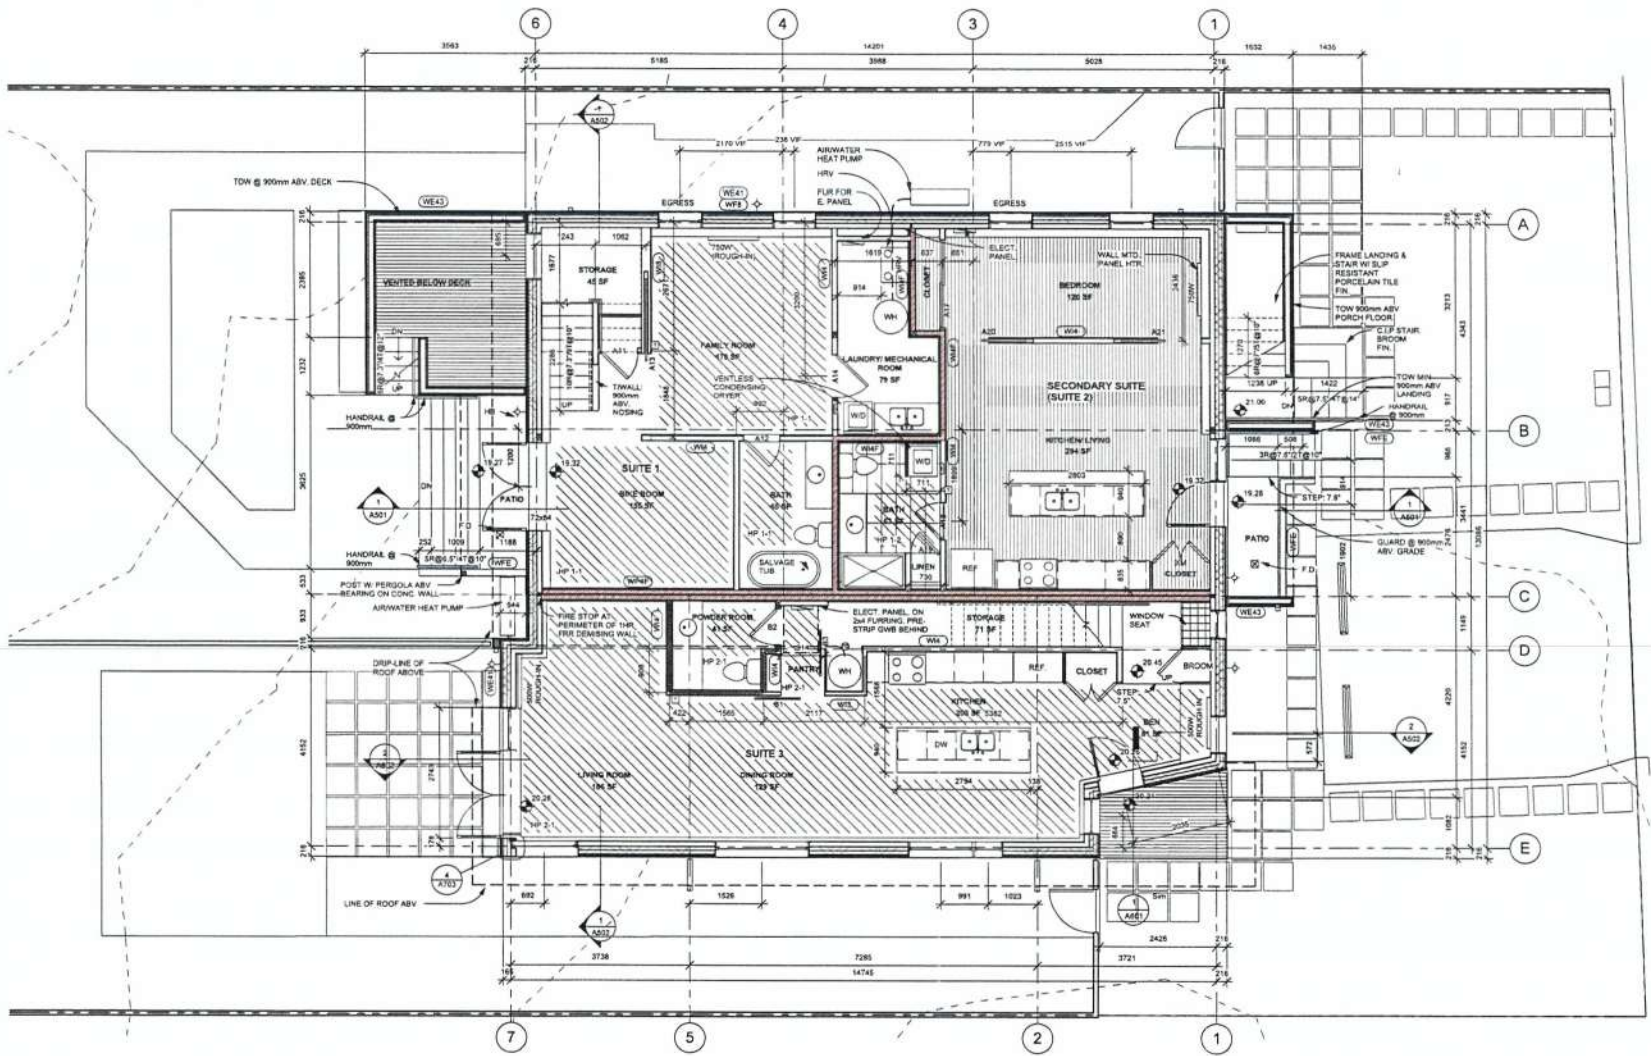- IN-FLOOR ELECTRIC RADIANT HEATER
- RADIANT HYDRONIC ZONE
- THERMOSTAT
- ELECTRIC HEATER ROUGH-IN
- HOSE BB


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No.	Description	Date
1	SUBDIVISION	FEB 7, 2016
2	Revising	MAR 25, 2016
3	Revising Revision	NOV 17, 2016
4	Revising Revision	MAR 1, 2017
5	DP Revision	JUNE 15, 2017
6	DP Revision	JULY 12, 2017
7	SP	FEB 9, 2018
8	SP Revision	MAR 2, 2018
9	SP Revision	APR 25, 2018
10	DDP Revision	SEP 20, 2018
11	DDP Revision	NOV 1, 2018
12	DDP Application	FEB 1, 19

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CHAMBERLAIN LOW ENERGY DUPLEX
UPPER FLOOR PLAN

Project number	2015 008
Date	JULY 25, 2016
Drawn by	MA
Checked by	MA
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Scale	1:50



UPPER FLOOR PLANS
1:50

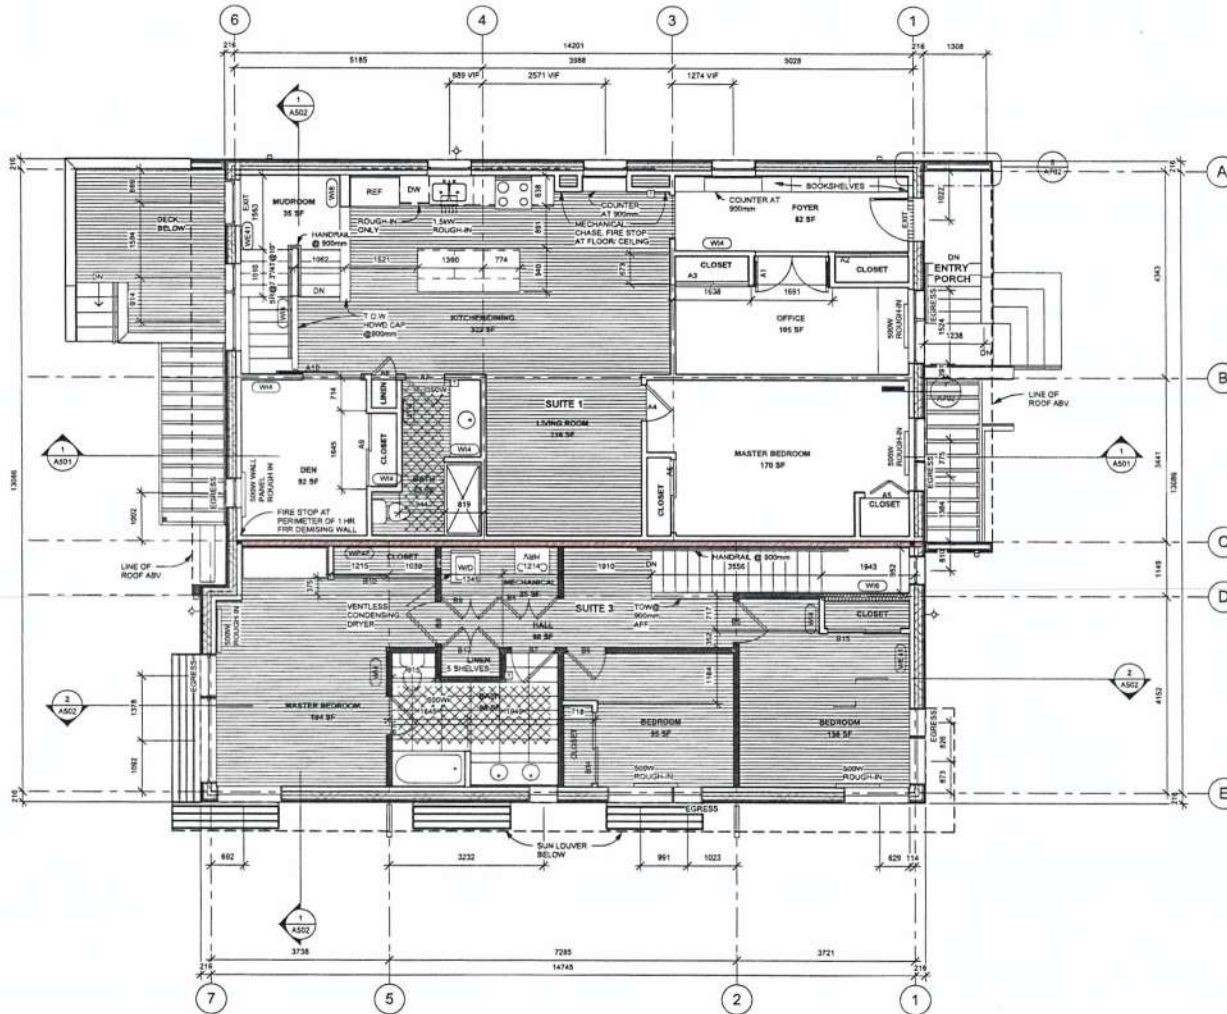
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No.	Description	Date
5	CDP Revision	July 12, 2017
7	BP	Feb 3, 2018
8	BP Revision	Mar 2, 2018
10	CDP Revision	Sep 20, 2018
11	CDP Revision	Nov 1, 2018
12	DVP Approval	Feb 1, 19

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CHAMBERLAIN LOW
ENERGY DUPLEX
ROOF PLAN

Project number	2015 008
Date	JULY 25, 2016
Drawn by	MA
Checked by	MA
A204	
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1 ROOF PLAN
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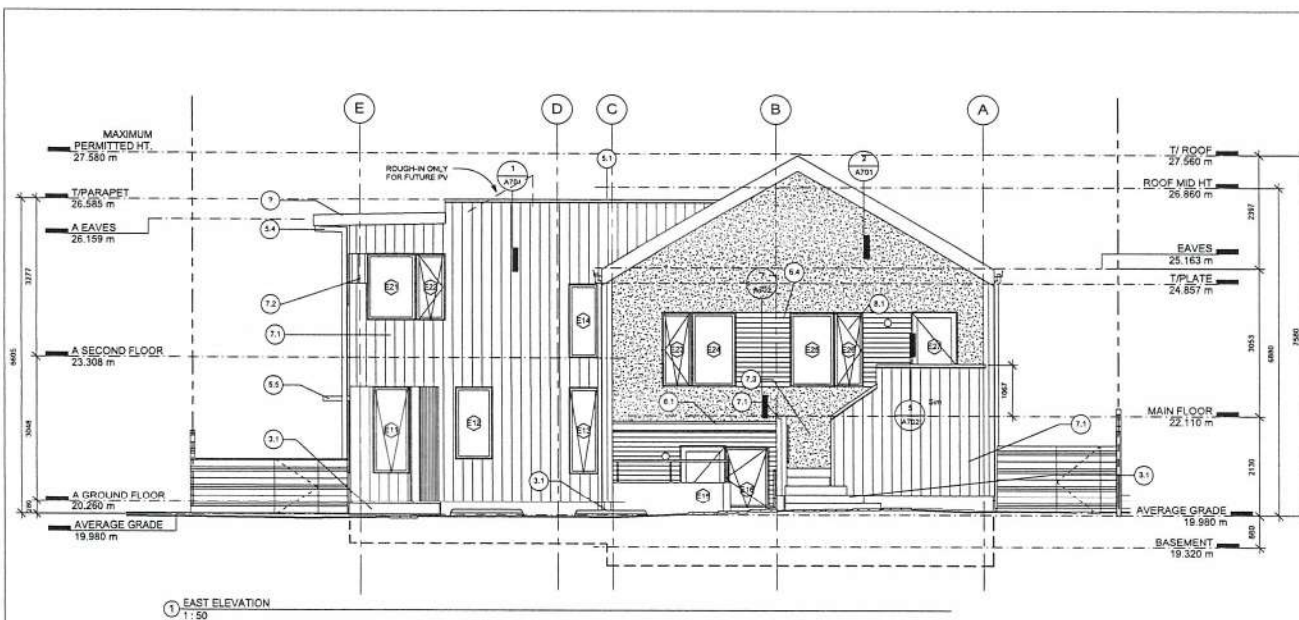
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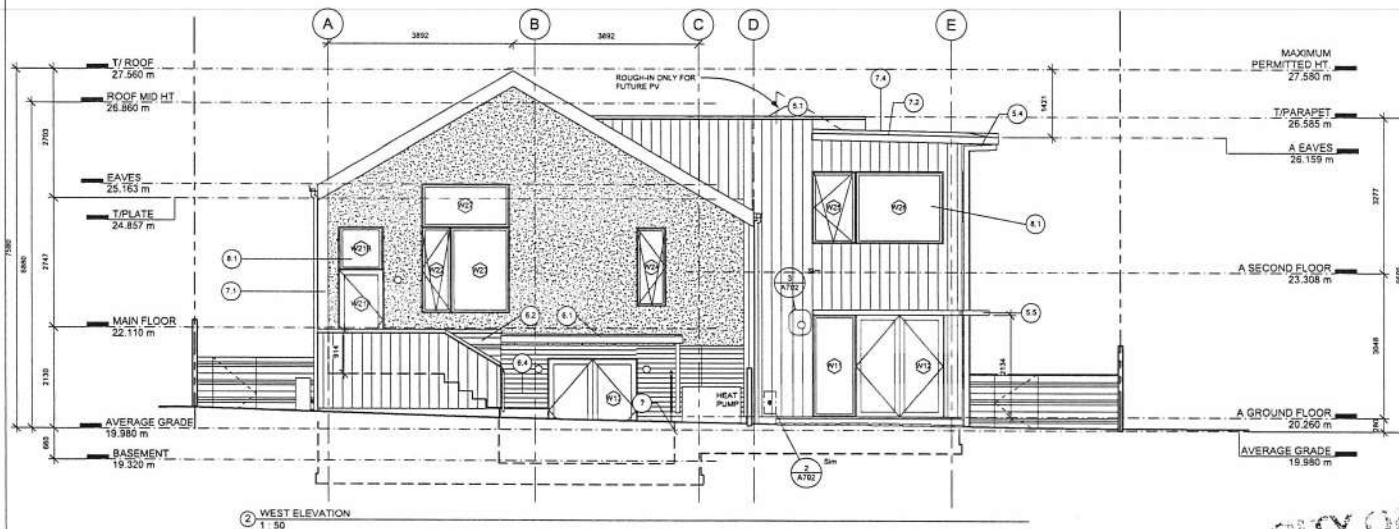
No.	Description	Date
1	SUBDIVISION	FEB 7, 2016
2	Re zoning	JUN 25, 2016
3	Re zoning Revision	Nov. 17, 2016
4	Re zoning Revision	Mar 1, 2017
5	DP Revision	JUN 15, 2017
6	DP Revision	JUN 12, 2017
7	SP	FEB 9, 2019
8	SP Revision	MAR 2, 2019
9	SP Revision	APR 26, 2019
10	DDP Revision	SEP 30, 2019
11	DDP Revision	NOV 1, 2019
12	DVP Application	FEB 1, 2020

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CHAMBERLAIN LOW ENERGY DUPLEX
ELEVATIONS

Project number	2015 008
Date	JULY 25, 2016
Drawn by	MA
Checked by	MA
Scale	1:50

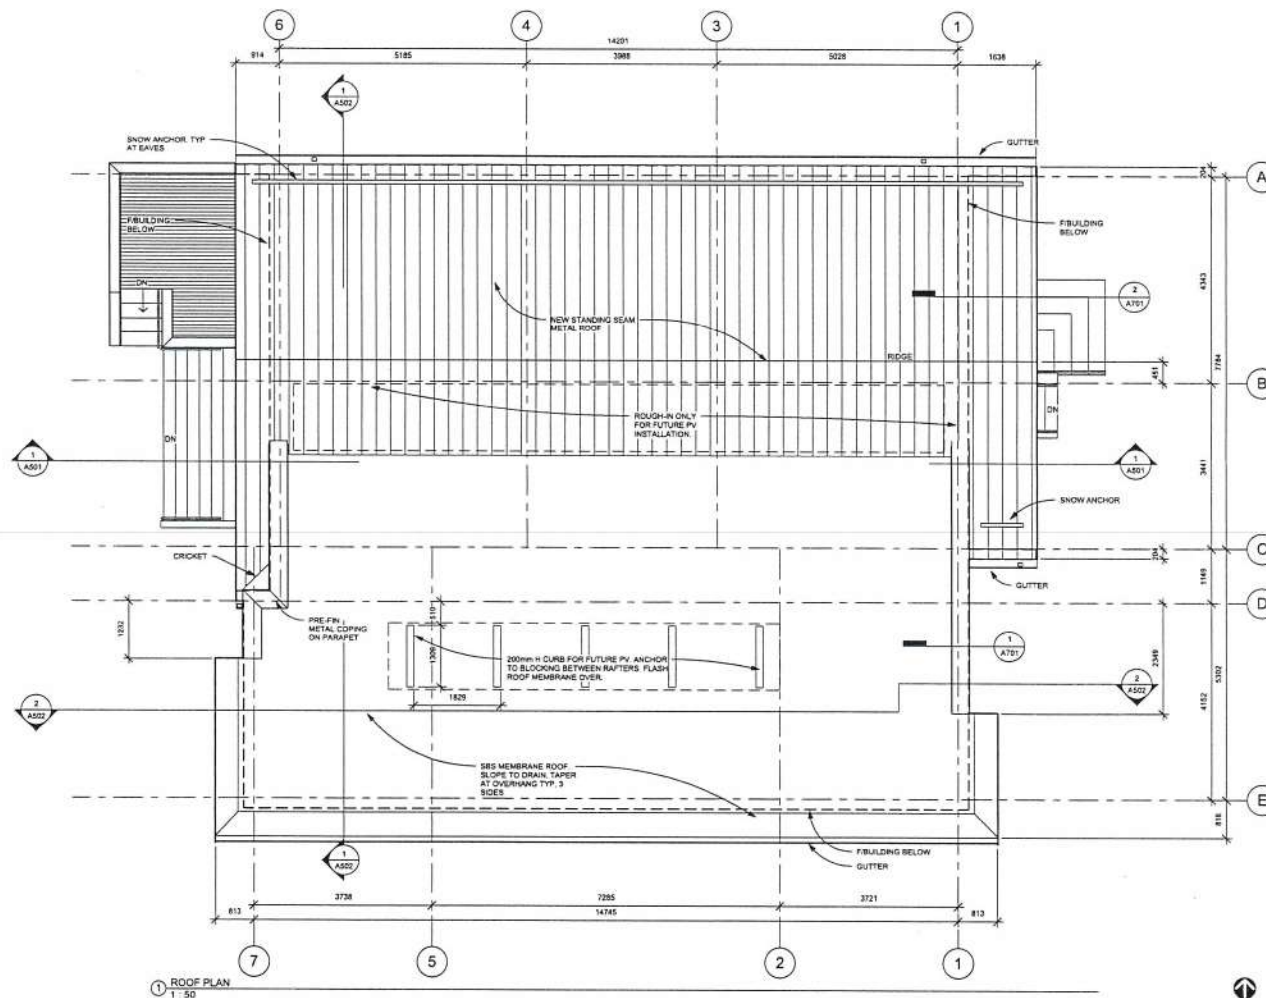

1 EAST ELEVATION
1:50



2 WEST ELEVATION
1:50

EXTERIOR FINISH SCHEDULE

- 3.1 ARCHITECTURAL CONCRETE
- 5.1 BREAK-FORMED METAL GUTTER - GALVANIZED STEEL
- 5.2 STANDING SEAM METAL ROOF - GALVALUME FINISH
- 5.3 METAL FASCIA - GALVALUME FINISH
- 5.4 PRE-FINISHED METAL RAIN-WATER LEADER, S.W. 7028
- 5.5 LOUVERED WINDOW SHADE
- 5.6 PRE-FINISHED METAL DOWNPOUT
- 6.1 STRUCTURAL TIMBER, VARIOUS DIMENSIONS
- 6.2 SCREEN AND FENCE CEDAR, CLEAR SEALANT FINISH
- 6.3 SOFFIT, 1/2" CEDAR, CLEAR SEALANT FINISH
- 6.4 CEDAR DECK, CLR. FIN.
- 7.1 INVERTED BOARD AND BATTEN CEMENT PANEL SIDING, 5/8" REVEAL, SMOOTH PAINT FINISH, S.W. 7020
- 7.2 CEMENT PANEL SIDING WITH ARCHITECTURAL REVEALS, PAINT FINISH, S.W. 7028
- 7.3 STUCCO SIDING
- 7.4 BUILT-UP ROOF MEMBRANE
- 8.1 TRIPLE-GLAZED THERMAL WINDOWS AND DOORS, ALUMINUM CLADDING, W. 7026
- 8.2 THERMAL DOOR WITH ACCENT COLOUR
- 8.3 THERMAL WINDOW WITH ACCENT COLOUR
- 8.4 THERMAL WINDOW WITH ACCENT COLOUR, (ROUGH-IN)

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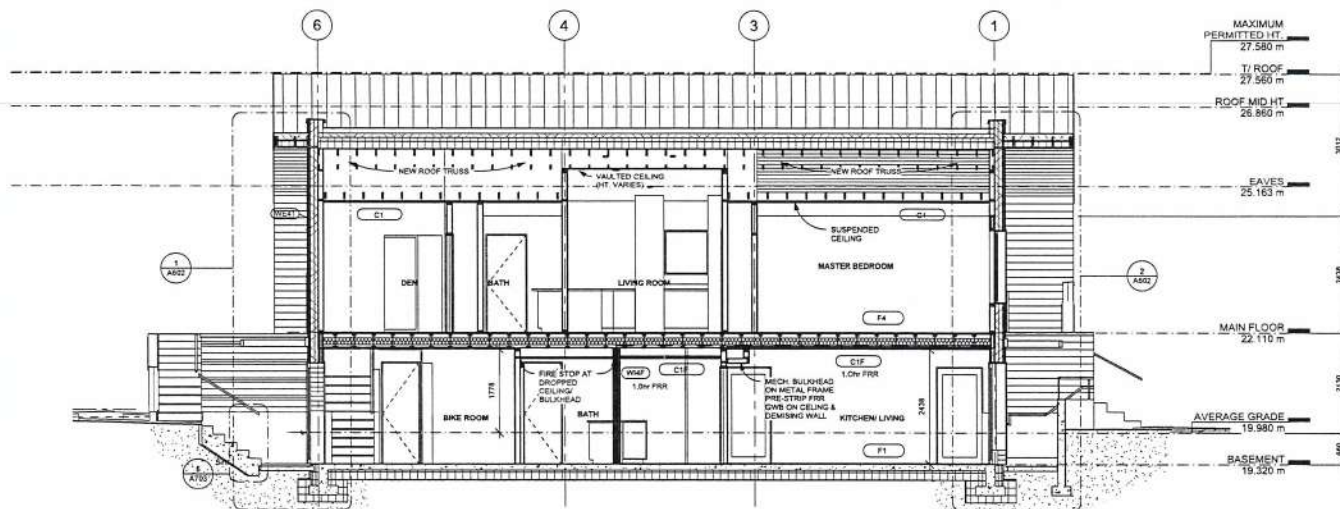
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No.	Description	Date
1	SUBDIVISION	FEB 7, 2016
2	Revising	JULY 25, 2016
3	Revising Revision	NOV 17, 2016
4	Revising Revision	MAR 7, 2017
5	D-P Revision	JUNE 15, 2017
6	D-P Revision	AUG 12, 2017
7	BP	FEB 9, 2018
8	BP Revision	MAR 2, 2018
9	DOP Revision	SEP 20, 2018
10	DOP Revision	NOV 1, 2018
11	DOP Revision	NOV 1, 2018
12	D-CP Application	FEB 1, 19

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CHAMBERLAIN LOW ENERGY DUPLEX
SECTIONS

Project number	2015 008
Date	JULY 25, 2016
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A501	
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1 NORTH LONGITUDINAL SECTION
1 : 50

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KATE STEFIUK STUDIO

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250 753-8323
kate.stefiak@gmail.com

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NO.	DATE	ISSUE
1	10/11/14	FOR REVIEW
2	11/27/18	REVISION REVISION

PLANTING NOTES:


Two existing fruit trees will be removed and replaced with:

- 2 espalier fruit trees
- 3 flowering dogwood
- 4 service berry
- 1 crabapple

Plants chosen are primarily native species, drought tolerant, hardy, and provide necessary screening from neighbours.

PLANT LIST:

Deciduous Trees	Groundcovers
Serviceberry (<i>Amelanchier canadensis</i>)	Kiwifruit (<i>Actinidia chinensis</i>)
Flowering Dogwood (<i>Cornus florida</i>)	Wild Strawberry (<i>Fragaria virginiana</i>)
Crabapple (<i>Malus domestica</i>)	Sedum
Various Fruit Trees	Creeeping Thyme
	Wild Ginger
Evergreen Shrubs	Ferns
Strawberry Bush (<i>Fragaria vesca</i>)	Japanese Painted Fern (<i>Asplenium platyneuron</i>)
Salei (<i>Salix glauca</i>)	Autumn Fern (<i>Adiantum autumnale</i>)
Dull Oregon Grape (<i>Mahonia repens</i>)	Ukioke Fern (<i>Polypodium vulgare</i>)
Evergreen Huckleberry (<i>Gaylussacia baccata</i>)	Sword Fern (<i>Polystichum acrostichum</i>)
Deciduous Shrubs	Perennials & Grasses
Saskatoon Berry (<i>Amygdaloidea</i>)	Evergold Sedge (<i>Carex obovata</i>)
Red Osier Dogwood (<i>Cornus stolonifera</i>)	Lavender (<i>Lavandula angustifolia</i>)
Heavenly Bamboo (<i>Phyllostachys puberula</i>)	Maiden Grass (<i>Stipa tenuifolia</i>)
Red Flowering Currant (<i>Ribes sanguineum</i>)	Calamint (<i>Calamintha Nepeta</i>)
Blueberry (<i>Vaccinium</i>)	Fountain grass (<i>Festuca arundinacea</i>)
	Sage (<i>Salvia nemorosa</i>)
	Snowy Stonecrop (<i>Sedum spaldingii</i>)
	Blue Moor Grass (<i>Briza media</i>)

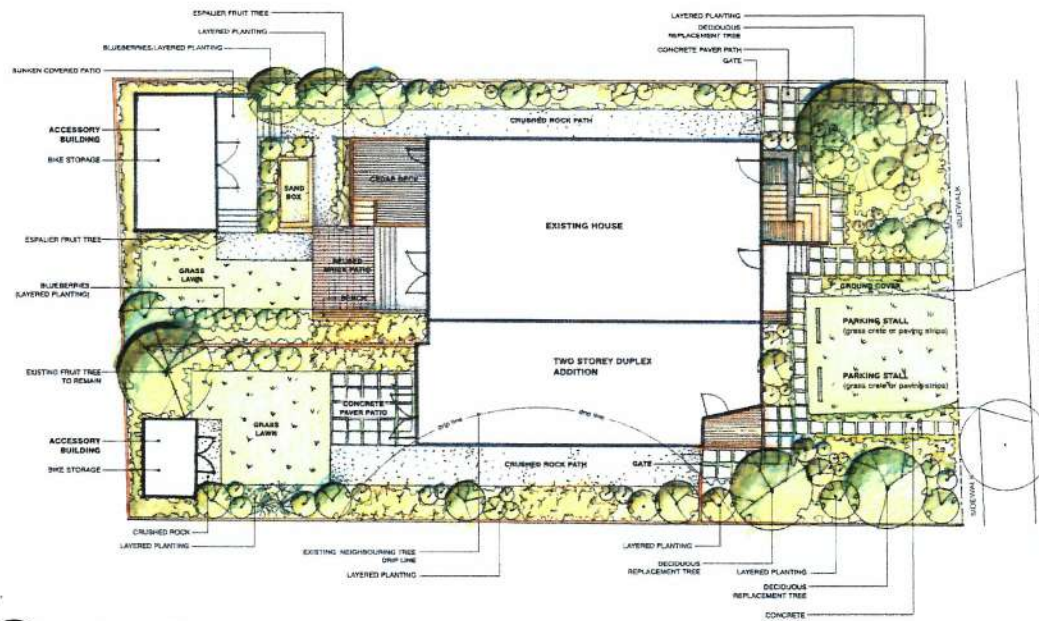

1 Landscape Plan
Scale 1:100

Plan



2 Front
Scale NTS
Elevation



3 Front Yard
Scale NTS
Perspective

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PROJECT
CHAMBERLAIN
LOW ENERGY DUPLEX
1068 CHAMBERLAIN ST
VICTORIA, BC

LANDSCAPE PLAN

PROJECT LOW ENERGY DUPLEX
DB: AS **CB:** KS
SCALE VARIES
DATE 2017-03-08

L1