


brad@cunnin.ca

Victoria, BC V8W 1S2 ph. 250-480-9693

PROJECT INFORMATION TABLE

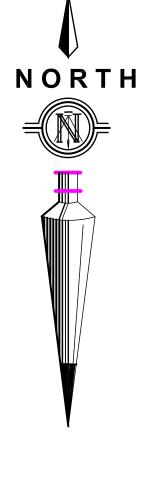

Dedicate for Road to remove

driveway

ROAD

addition

sidewalk encroachment

+ 21.96


+ 21.87

21.9B

Iree

Zoning Item	By-Law Value	Provided
Zoning	R1-S2	
Site Area	260 m²	260 m²
Floor Area		
Basement Area >1.8m ceiling AG		55.3 m² (596 sq.ft.) not inc l.
Main Floor		59.3 m ² (639 sq.ft.)
Upper Floor		76.4 m²(822 sq.ft.)
Attic > 2.10m ceiling		0
Excess Parking	>18.6 m²	0 m²
Total Floor Area	190 m²	135.7 m² (1461 sq.ft.)
Floor Space Ratio	0.6	0.46
Site Coverage %	40%	35.5 %
Open Site Space	N/A	50 %
Grade		21.96
Height of Building	7.50	7.24
Number of Storeys	2	2
Parking Stalls	1	1
Bicycle Parking	0	1
Building Setbacks		
Front Yard	6.0	6.01
Rear Yard	6.0	6.50 to house 5.30 *Variance to 5.25
Flanking Yard	2.4	N/A
Side Yard (North	1.5/2.4	1.64 *Variance to 1.60 to Hab. Room
Side Yard (South)	1.5/2.4	1.52 *Variance to 1.50 to Hab. Room

Average Grade Calc.

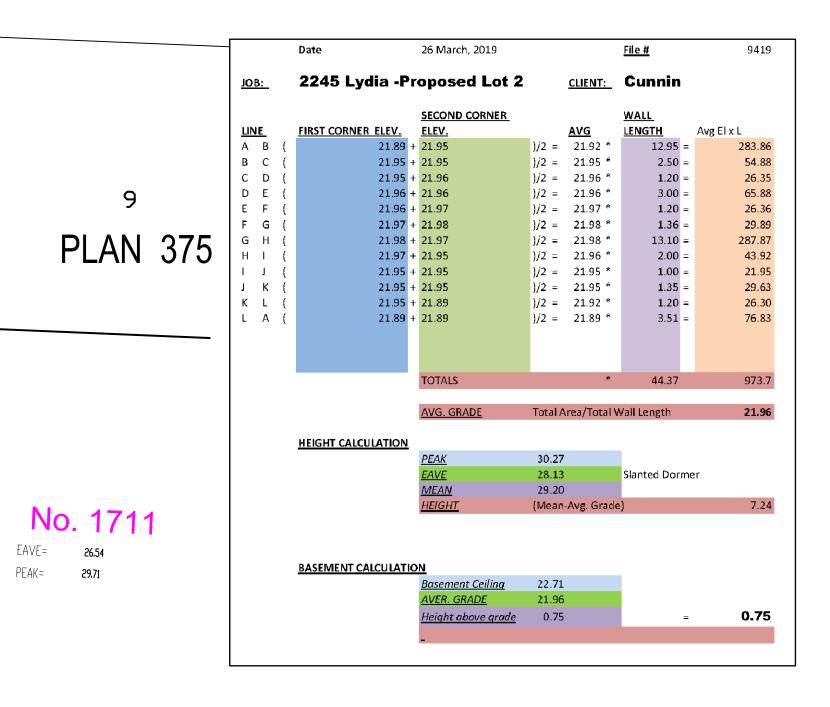


Revisions TV OF TOR **Received Date:** June 2, 2020

PROPOSED SINGLE FAMILY RESIDENCE

R1-S2


For: Brad Cunnin 2245 Lydia Street Victoria, BC


A1 of 4

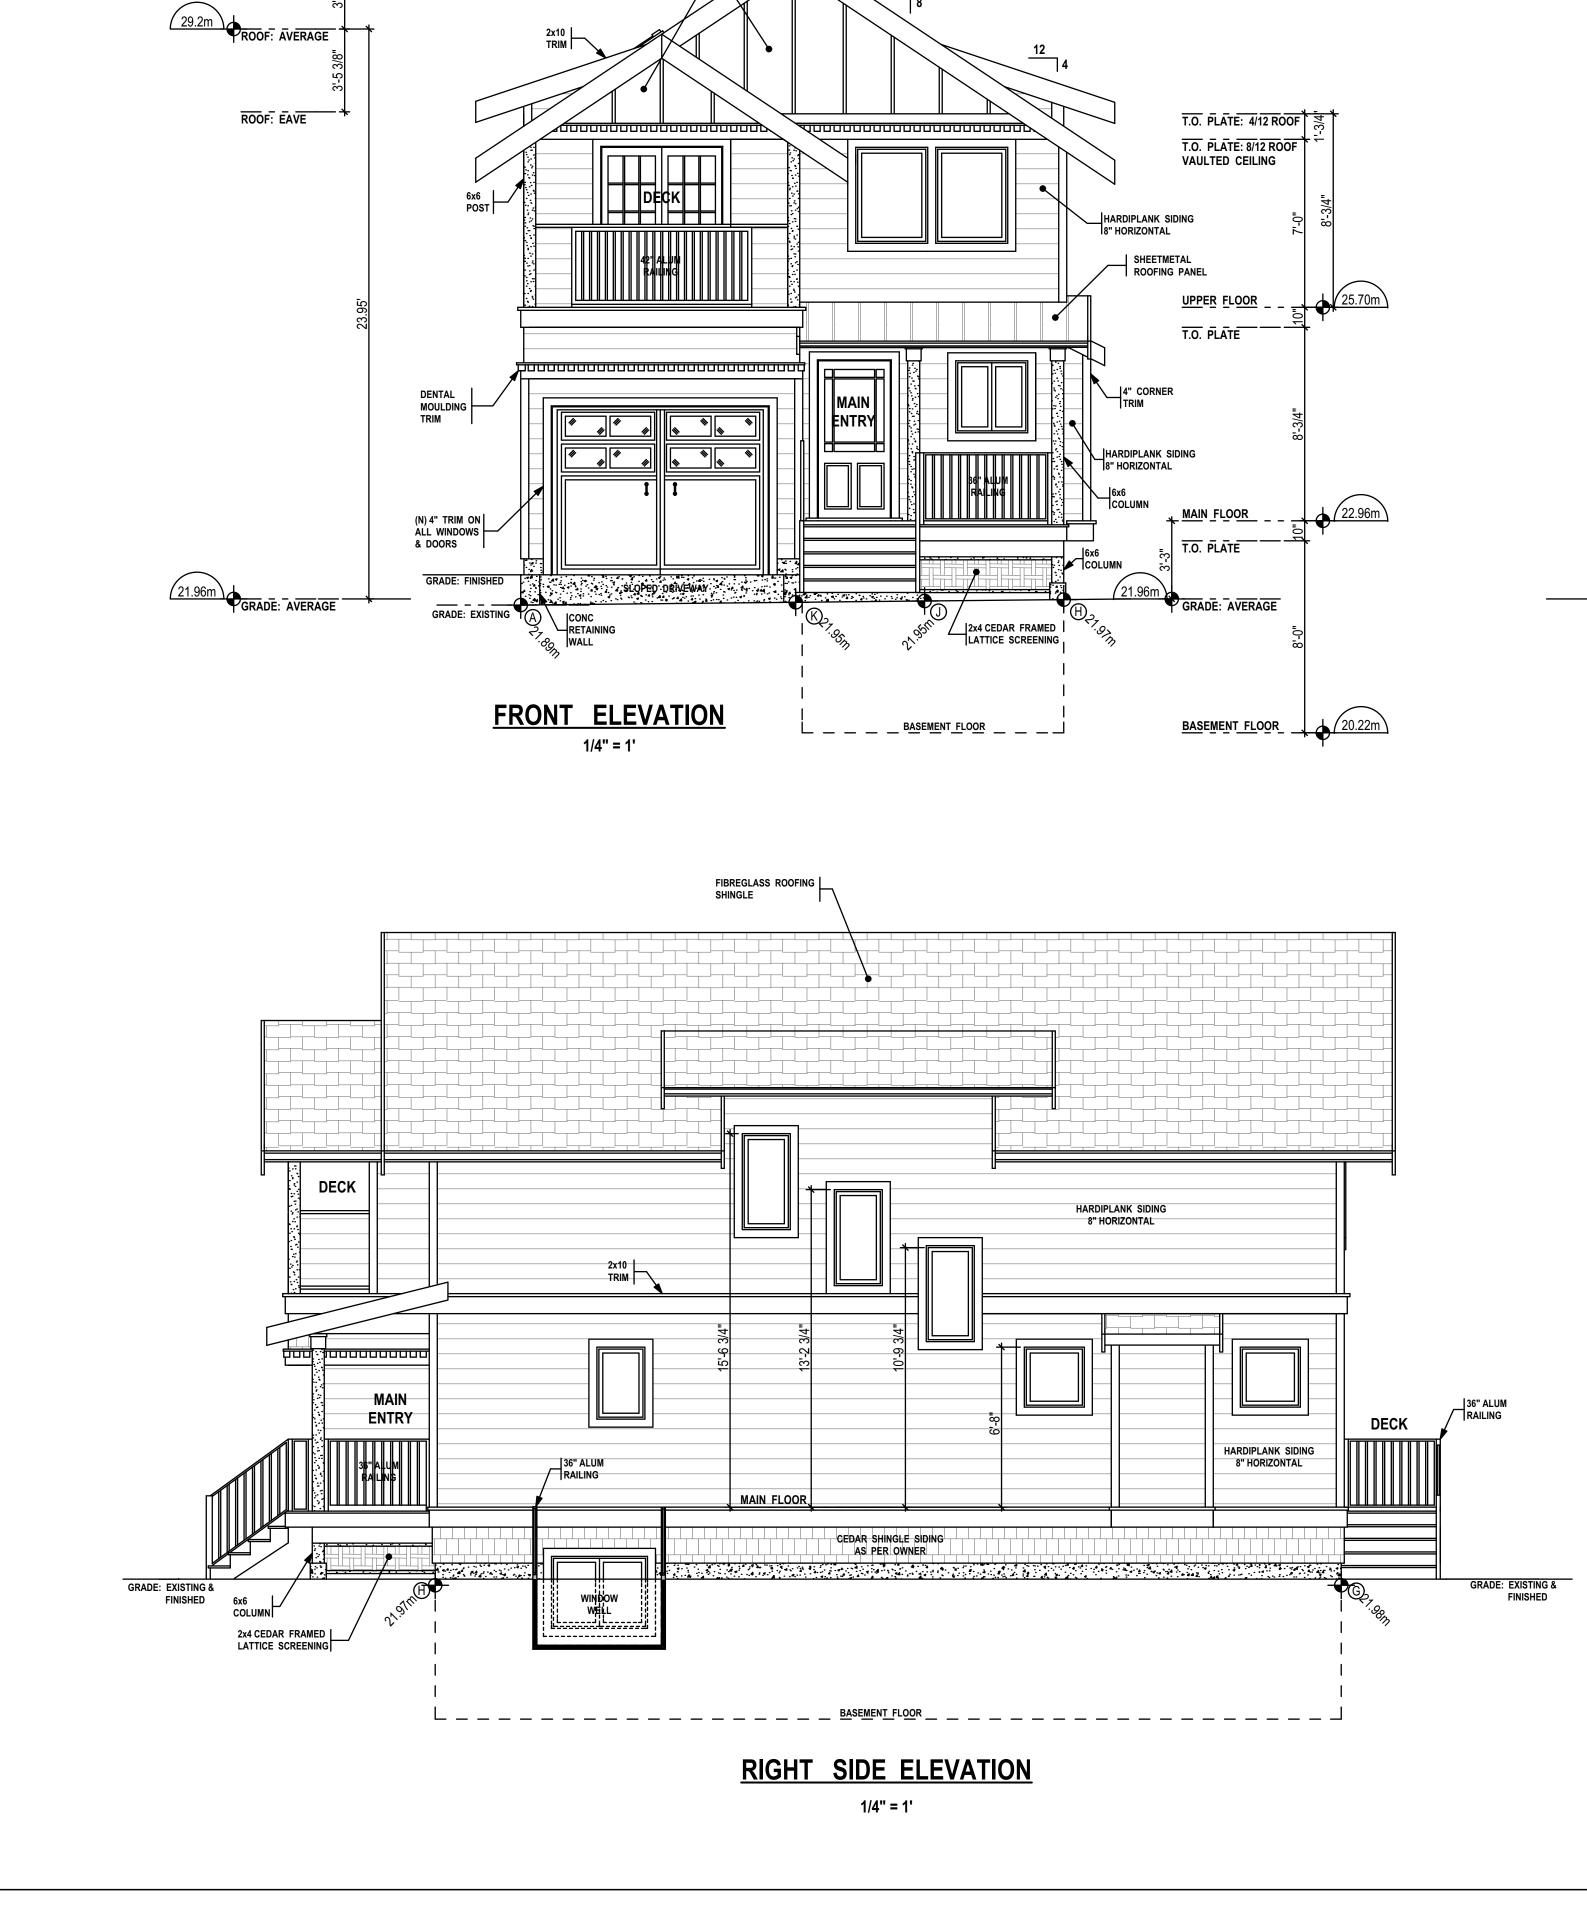


ROOF: RIDGE

HARDIPANEL VERTICAL SIDING

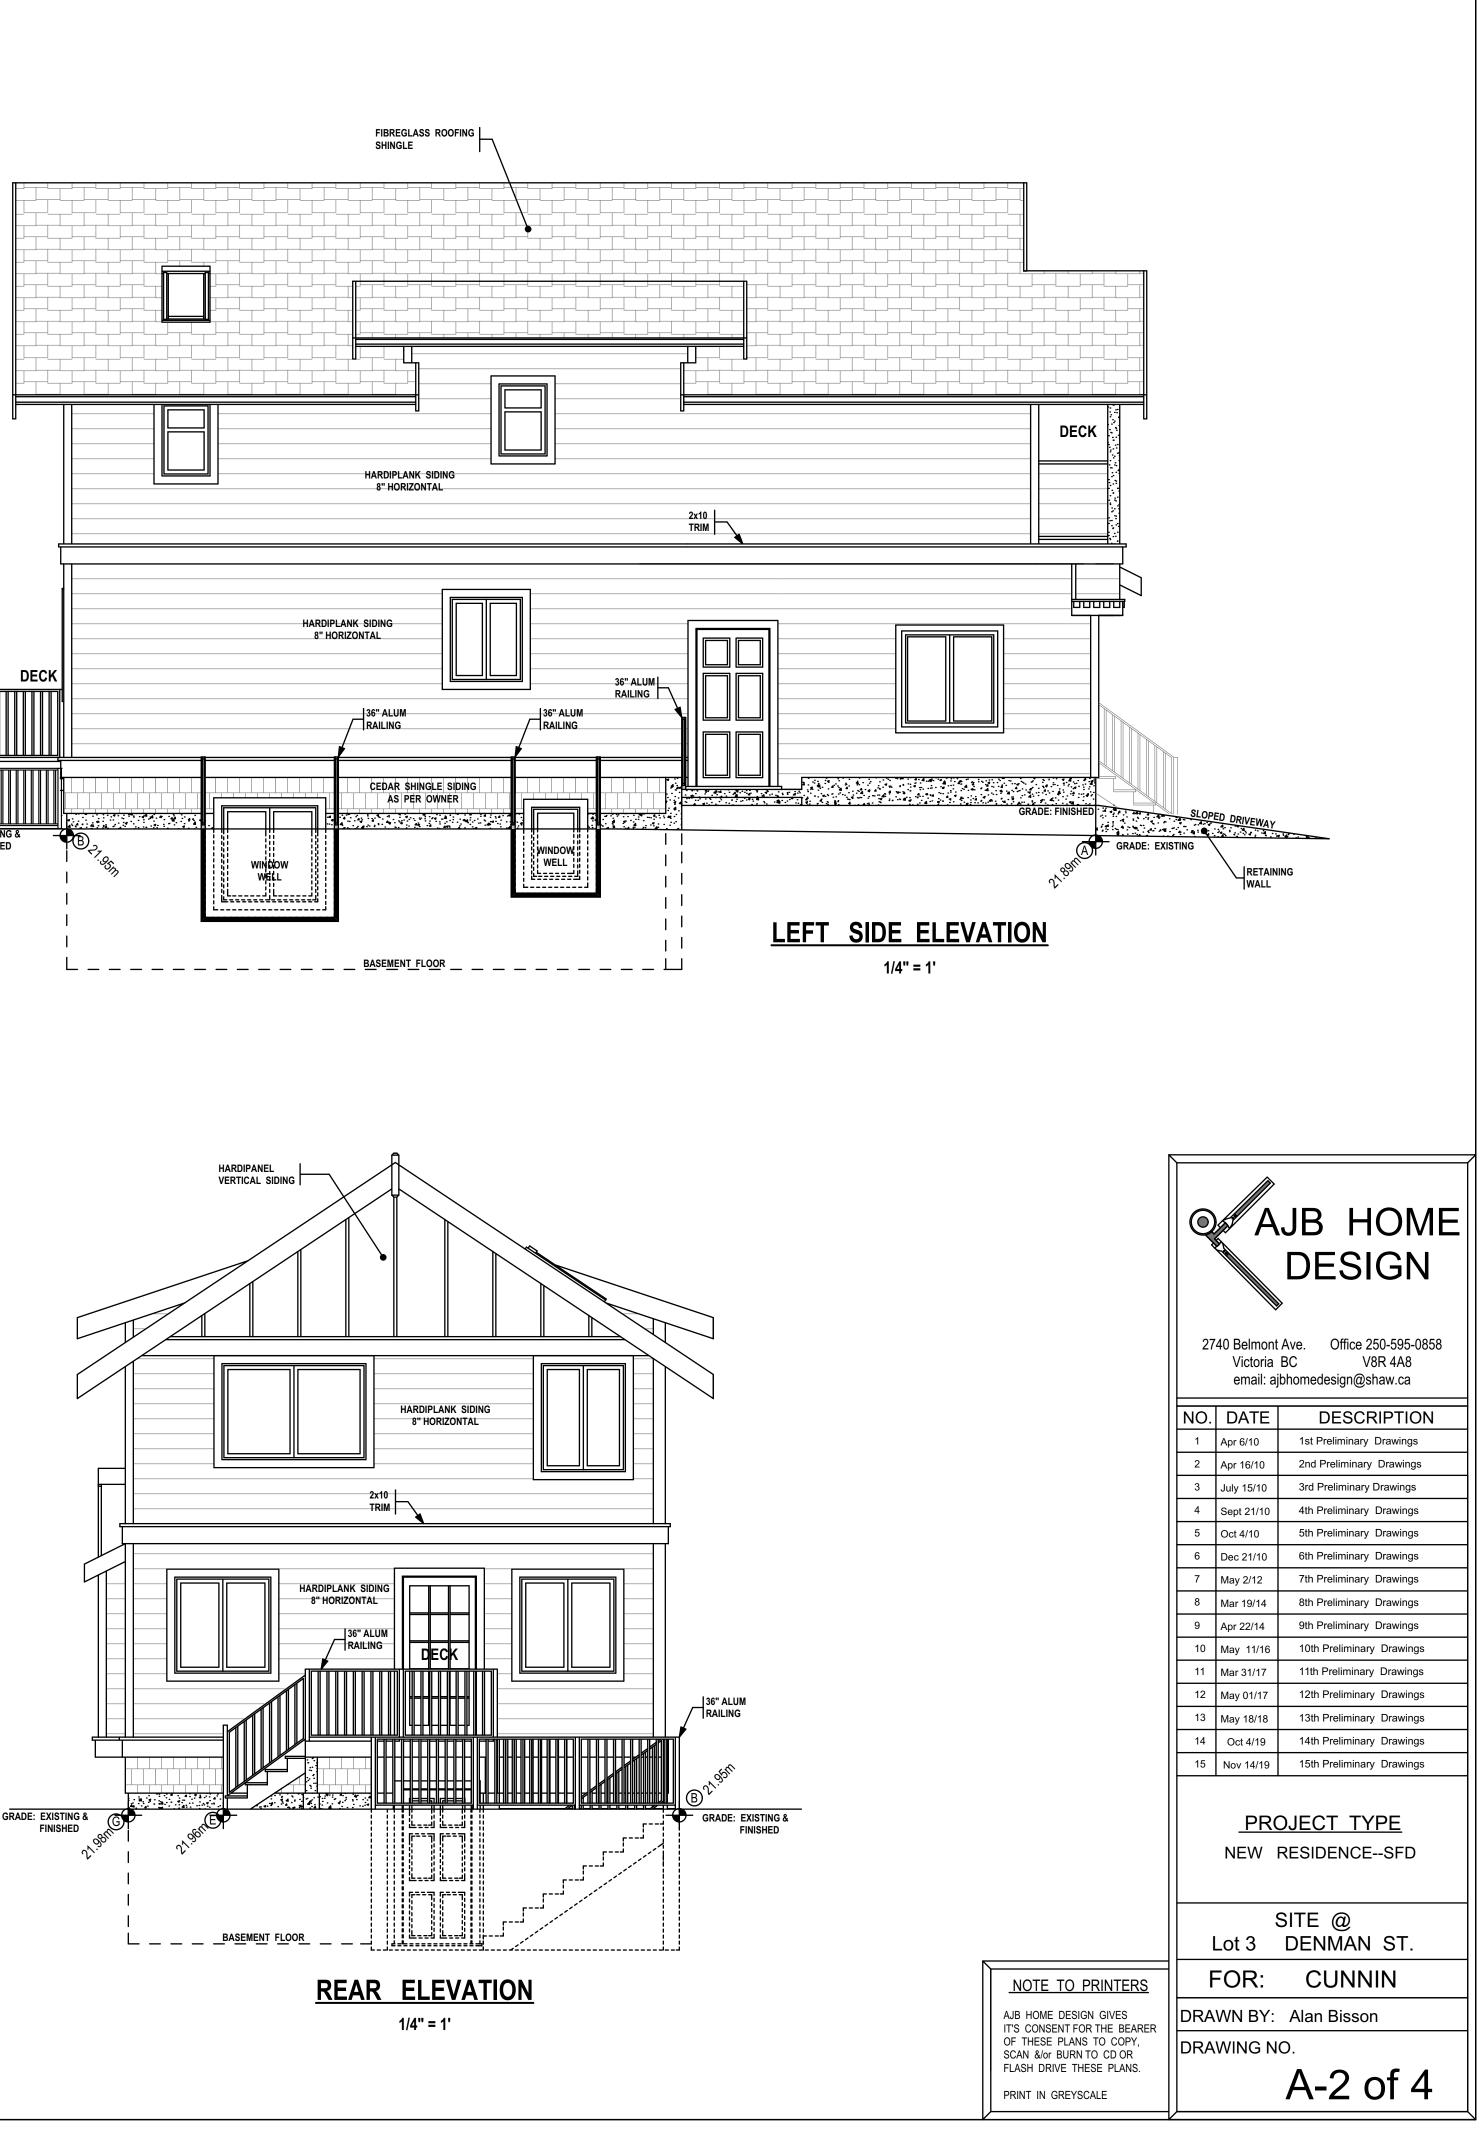


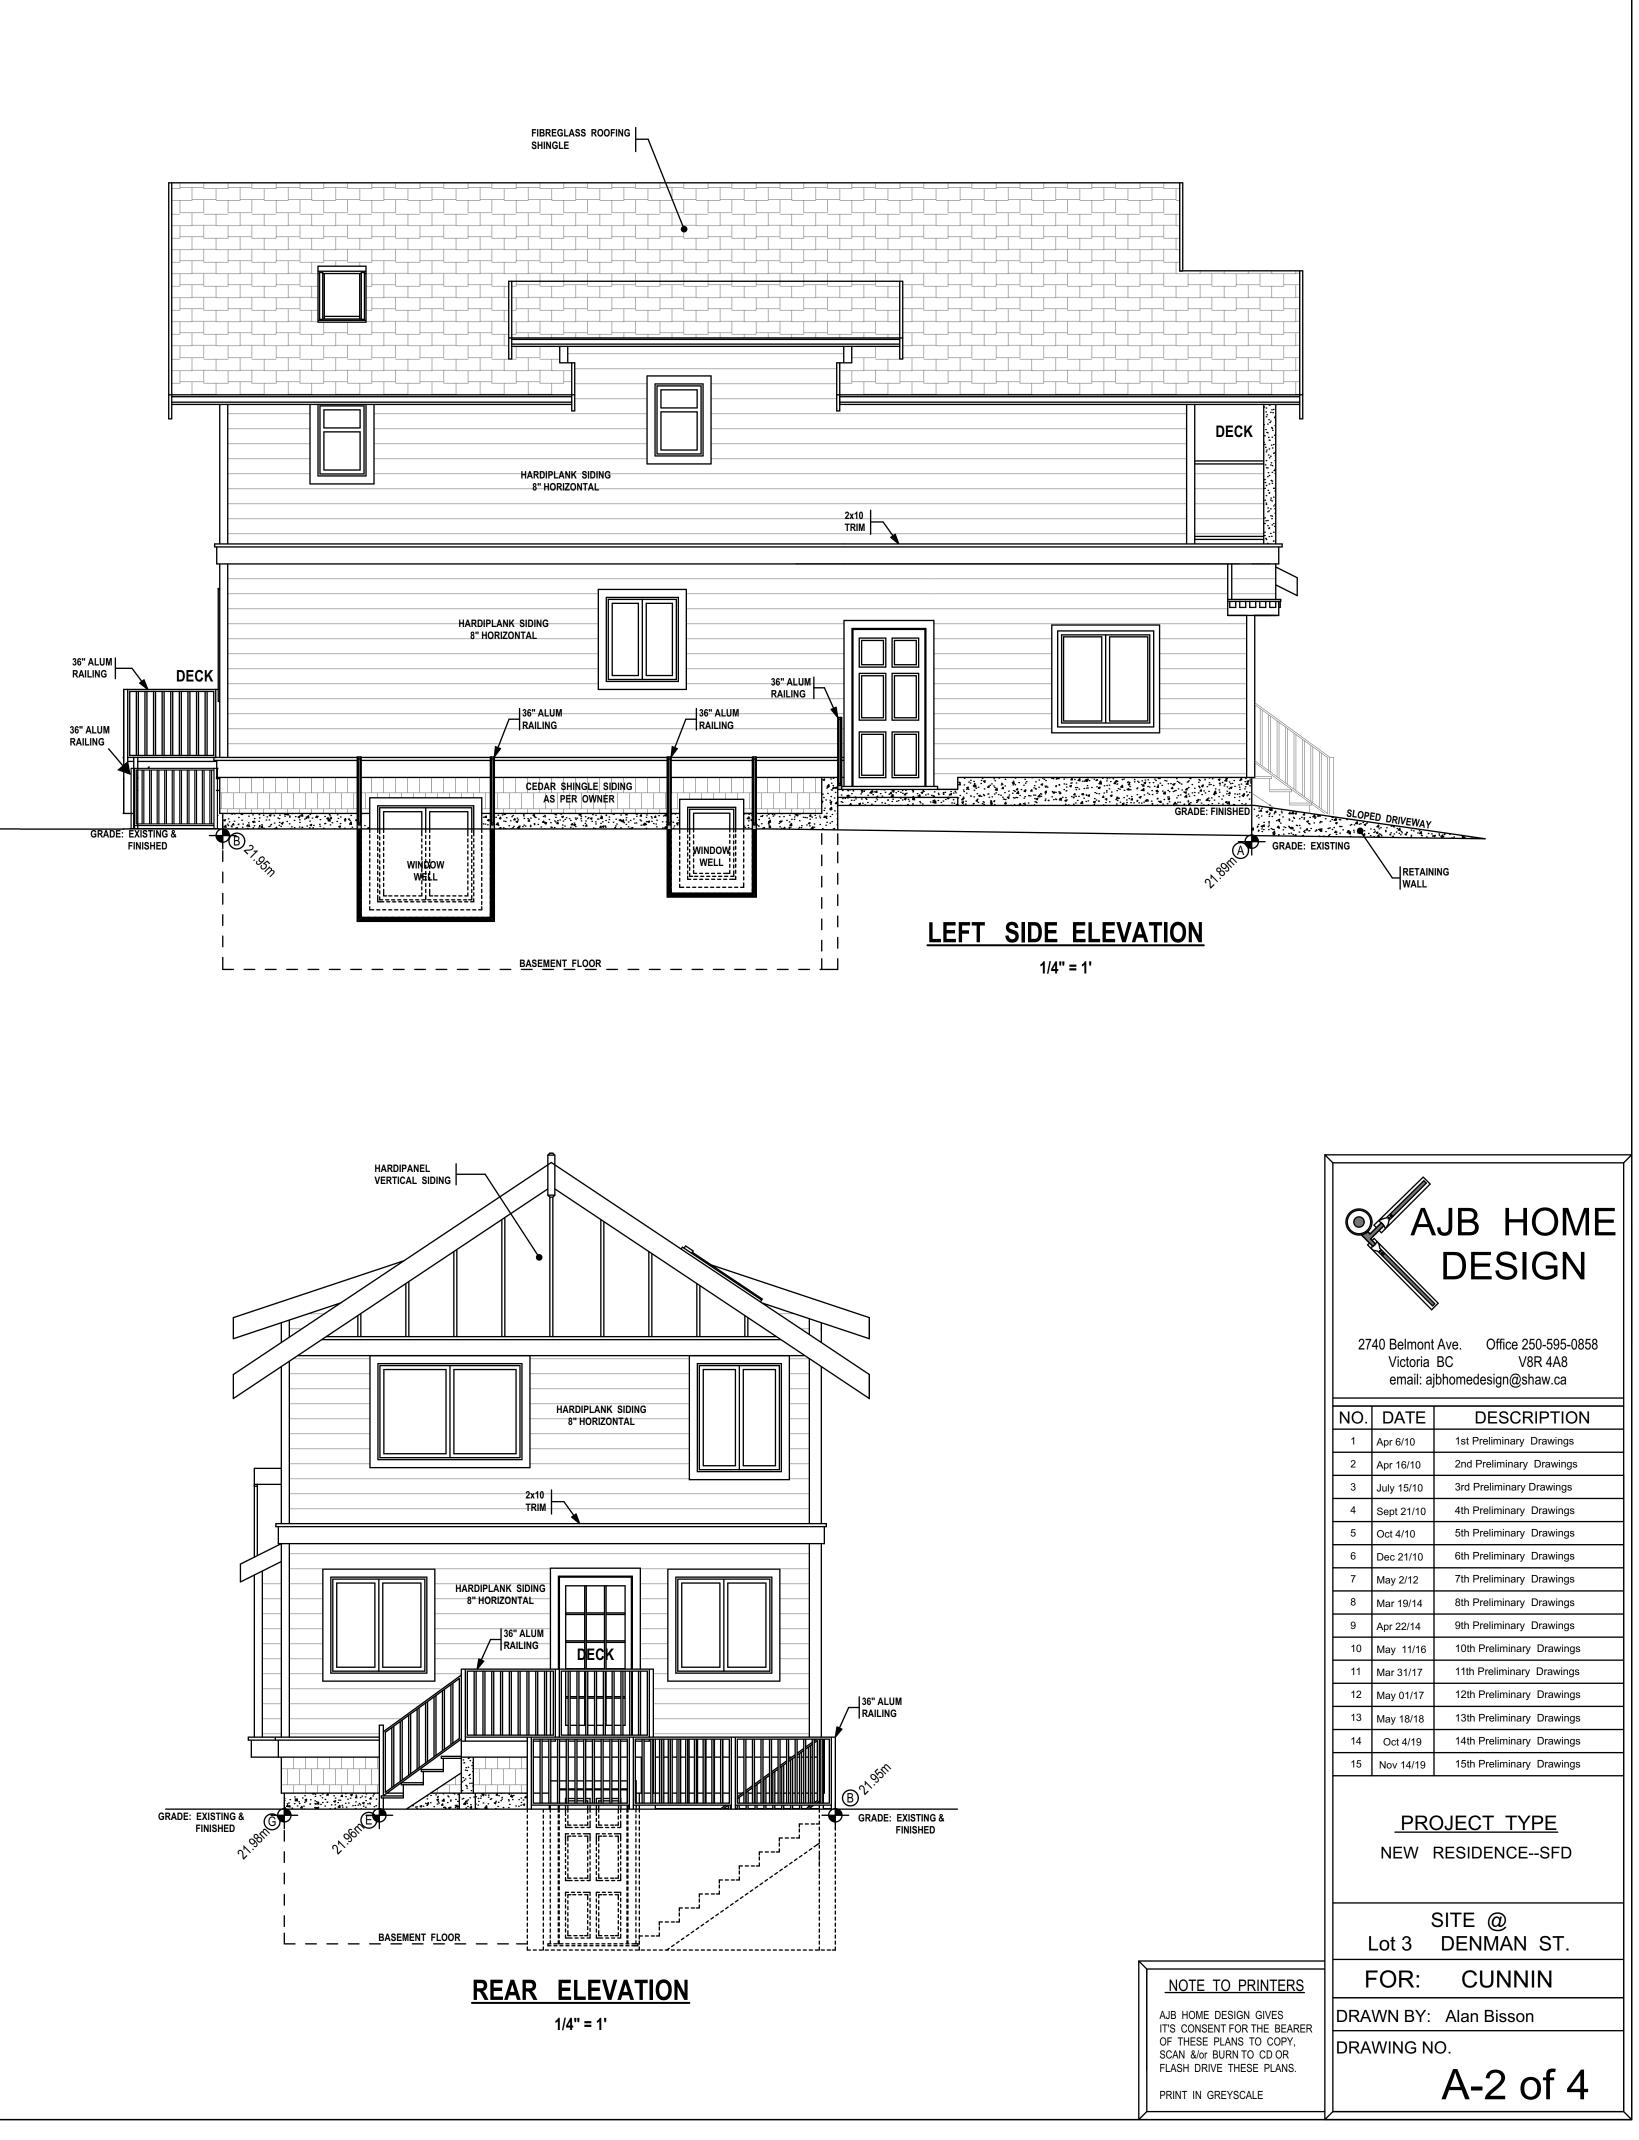


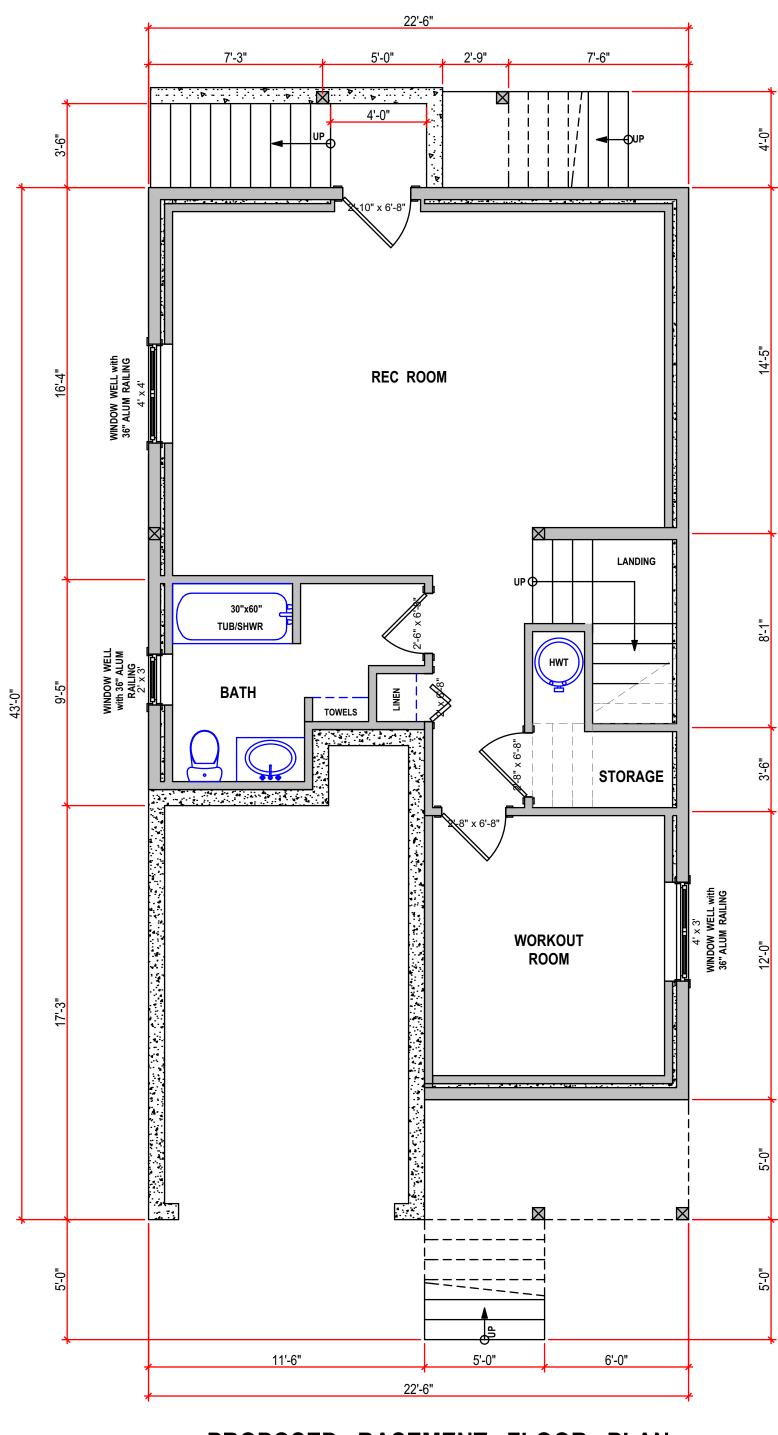


PROPOSED BASEMENT FLOOR PLAN

1/4" = 1'

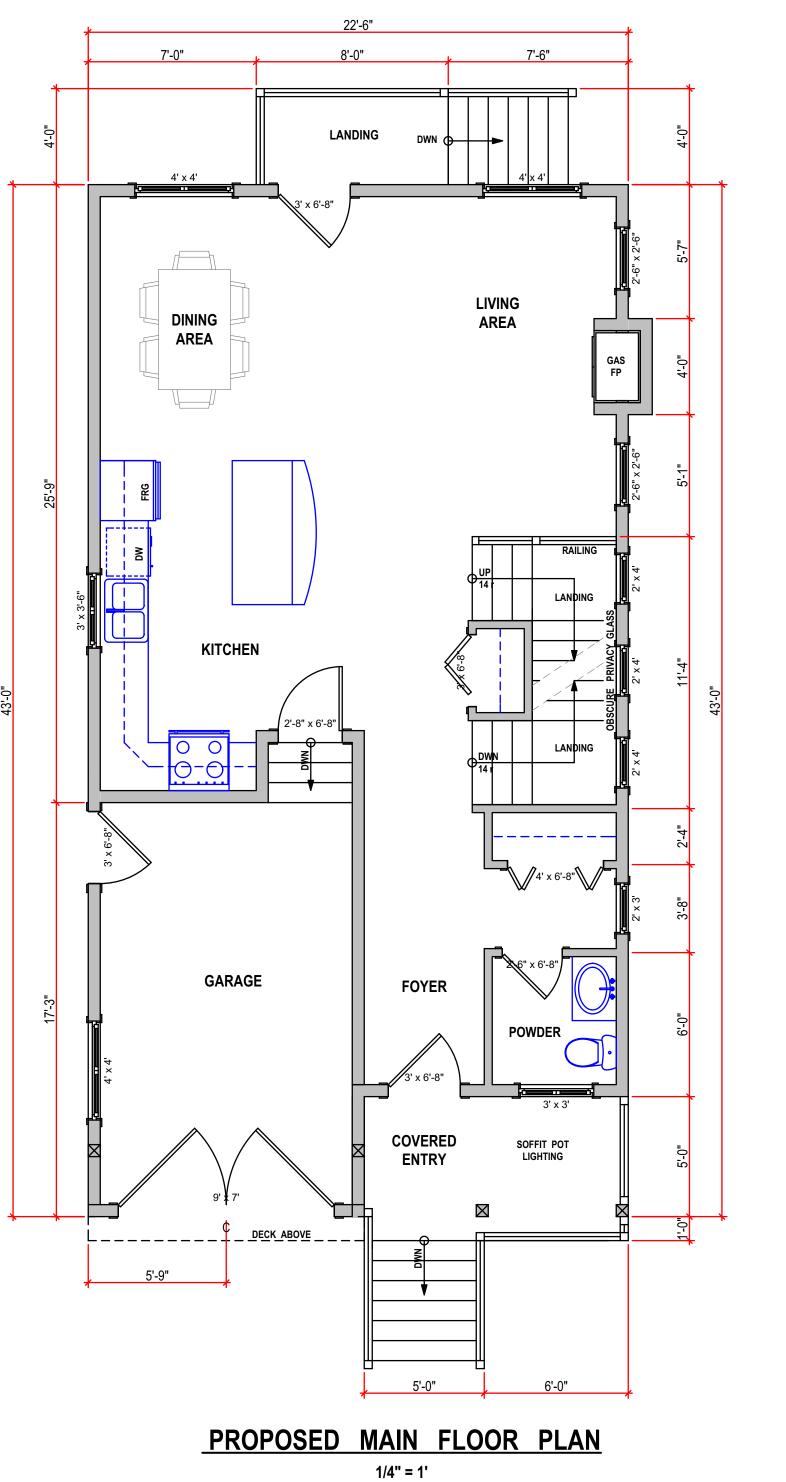


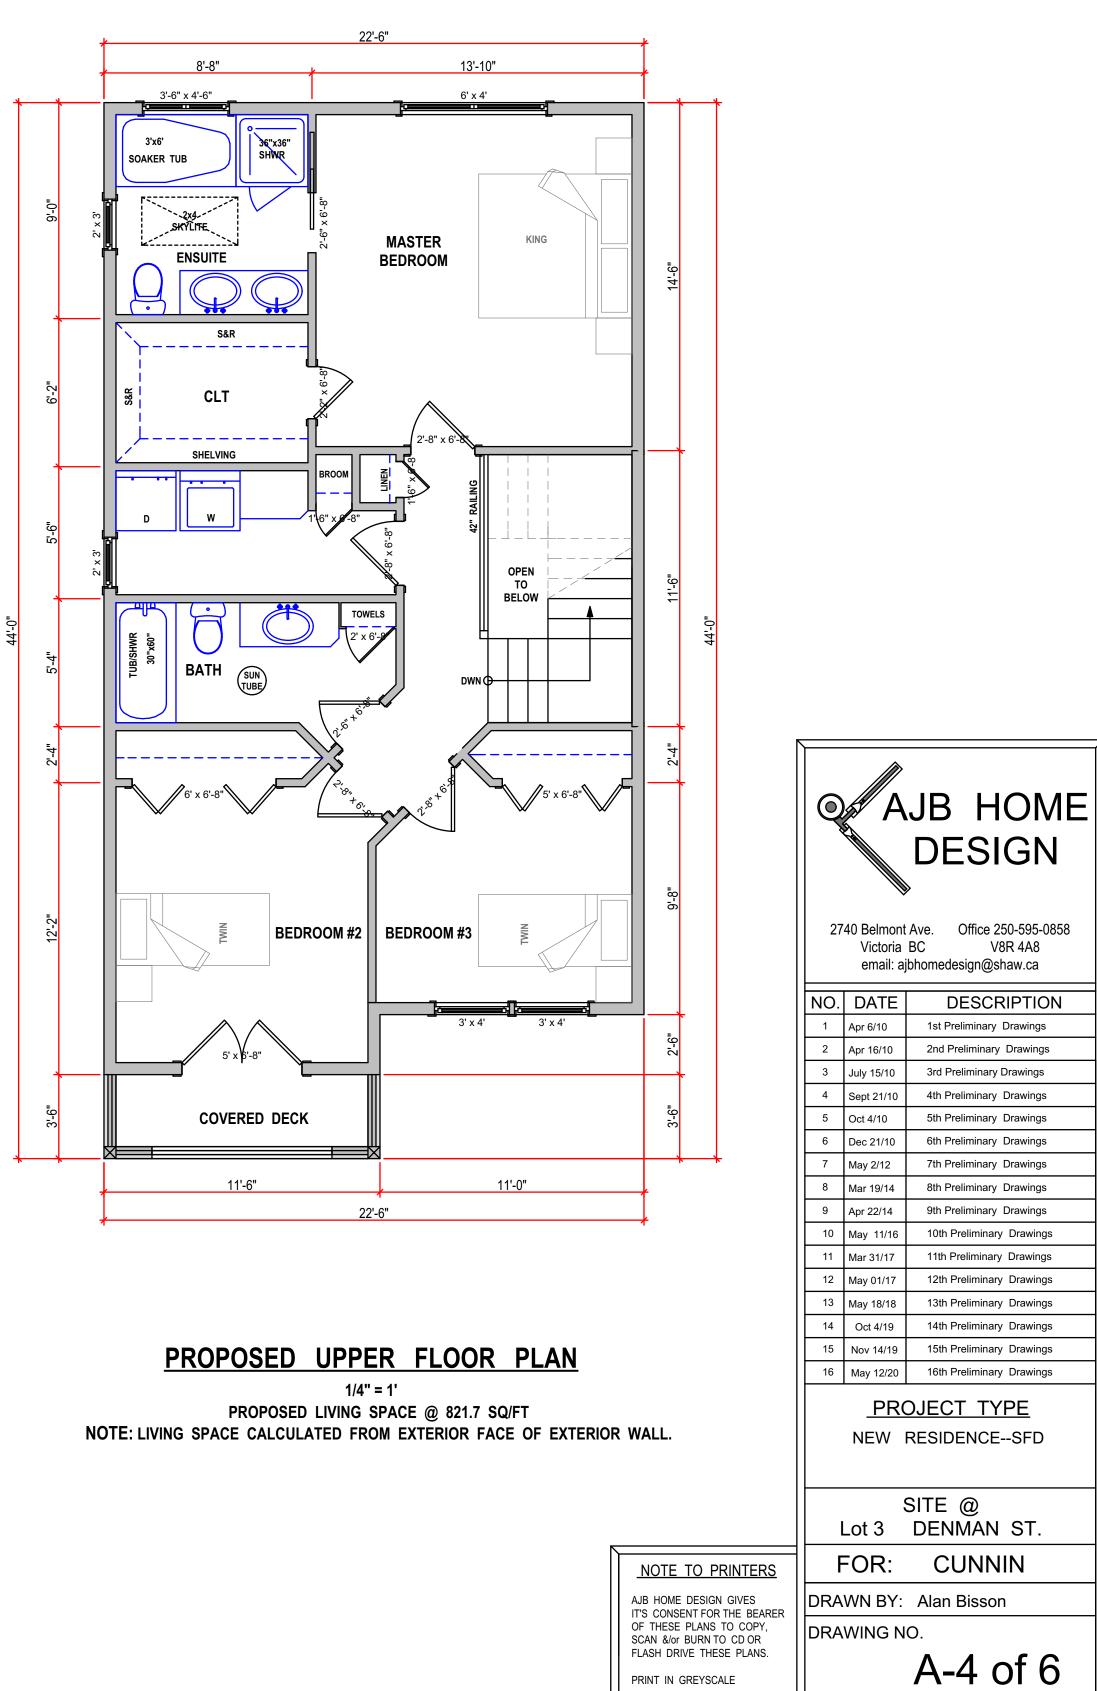

PROPOSED LIVING SPACE @ 638.7 SQ/FT NOTE: LIVING SPACE CALCULATED FROM EXTERIOR FACE OF EXTERIOR WALL

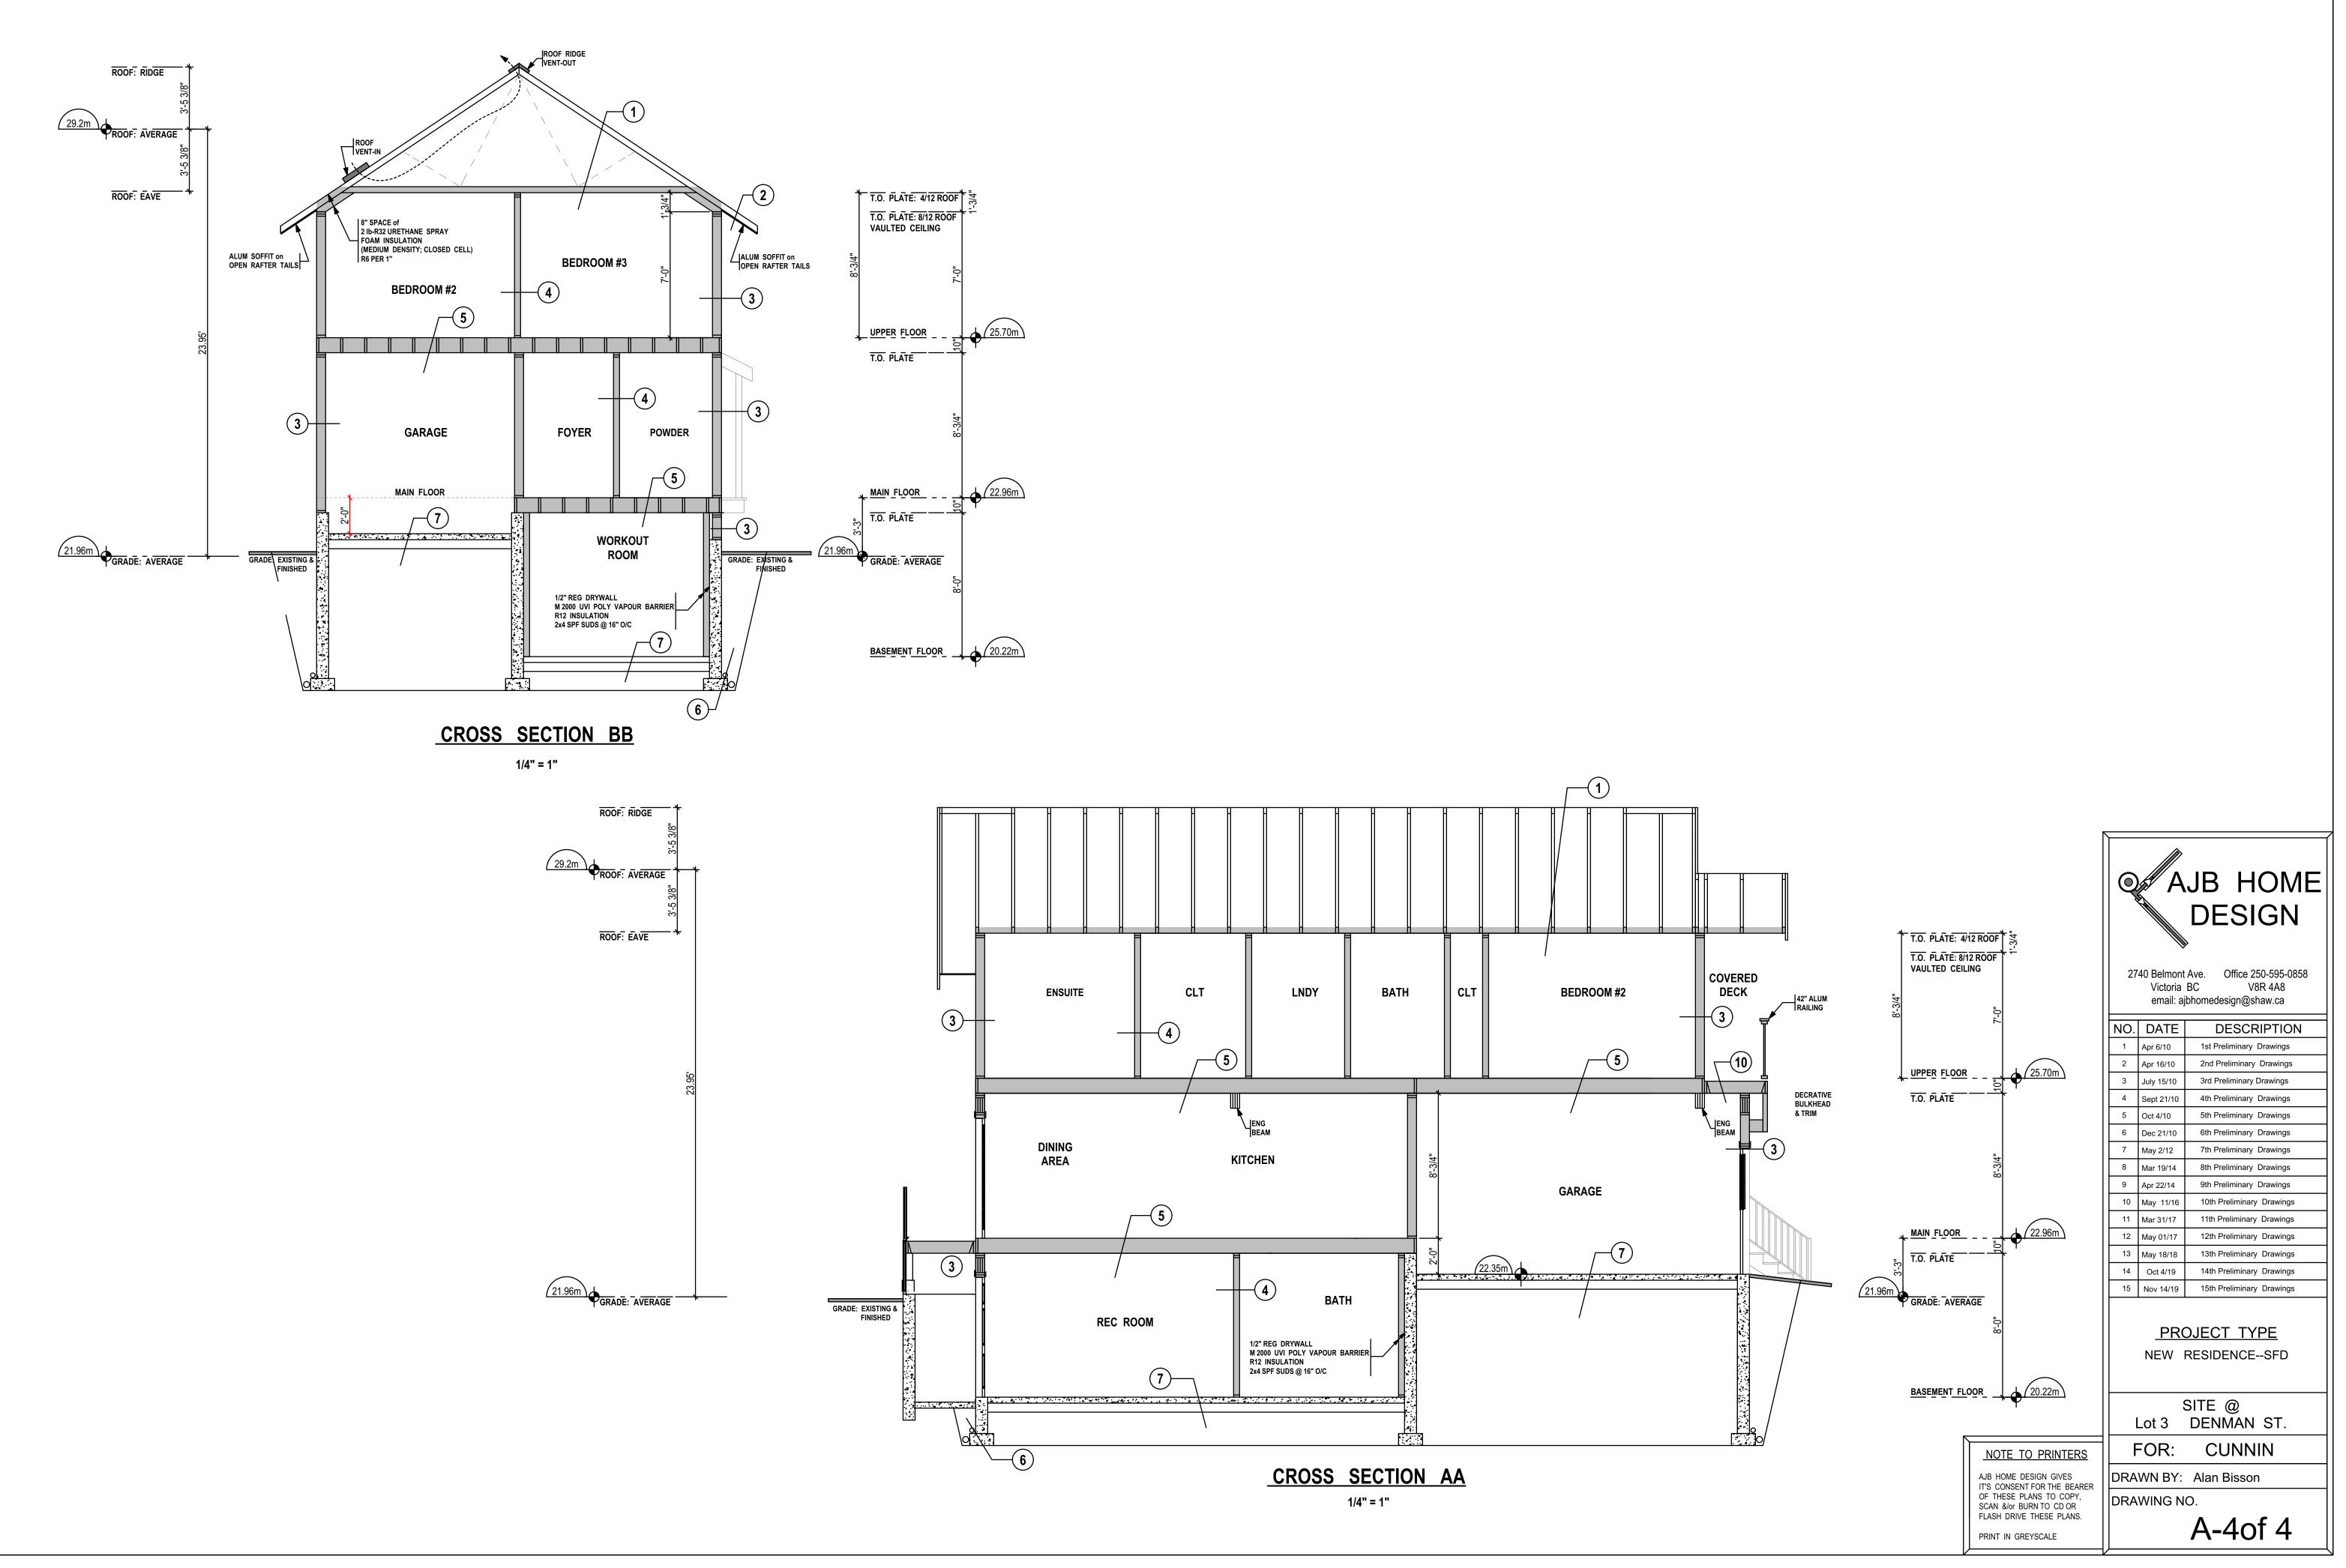

B.C. LAND SURVEYOR'S SITE PLAN TO ACCOMPANY DEVELOPMENT PERMIT APPLICATION WITH VARIANCES PROPOSED LOT 3, SECTION 57, VICTORIA DISTRICT, PLAN EPP_

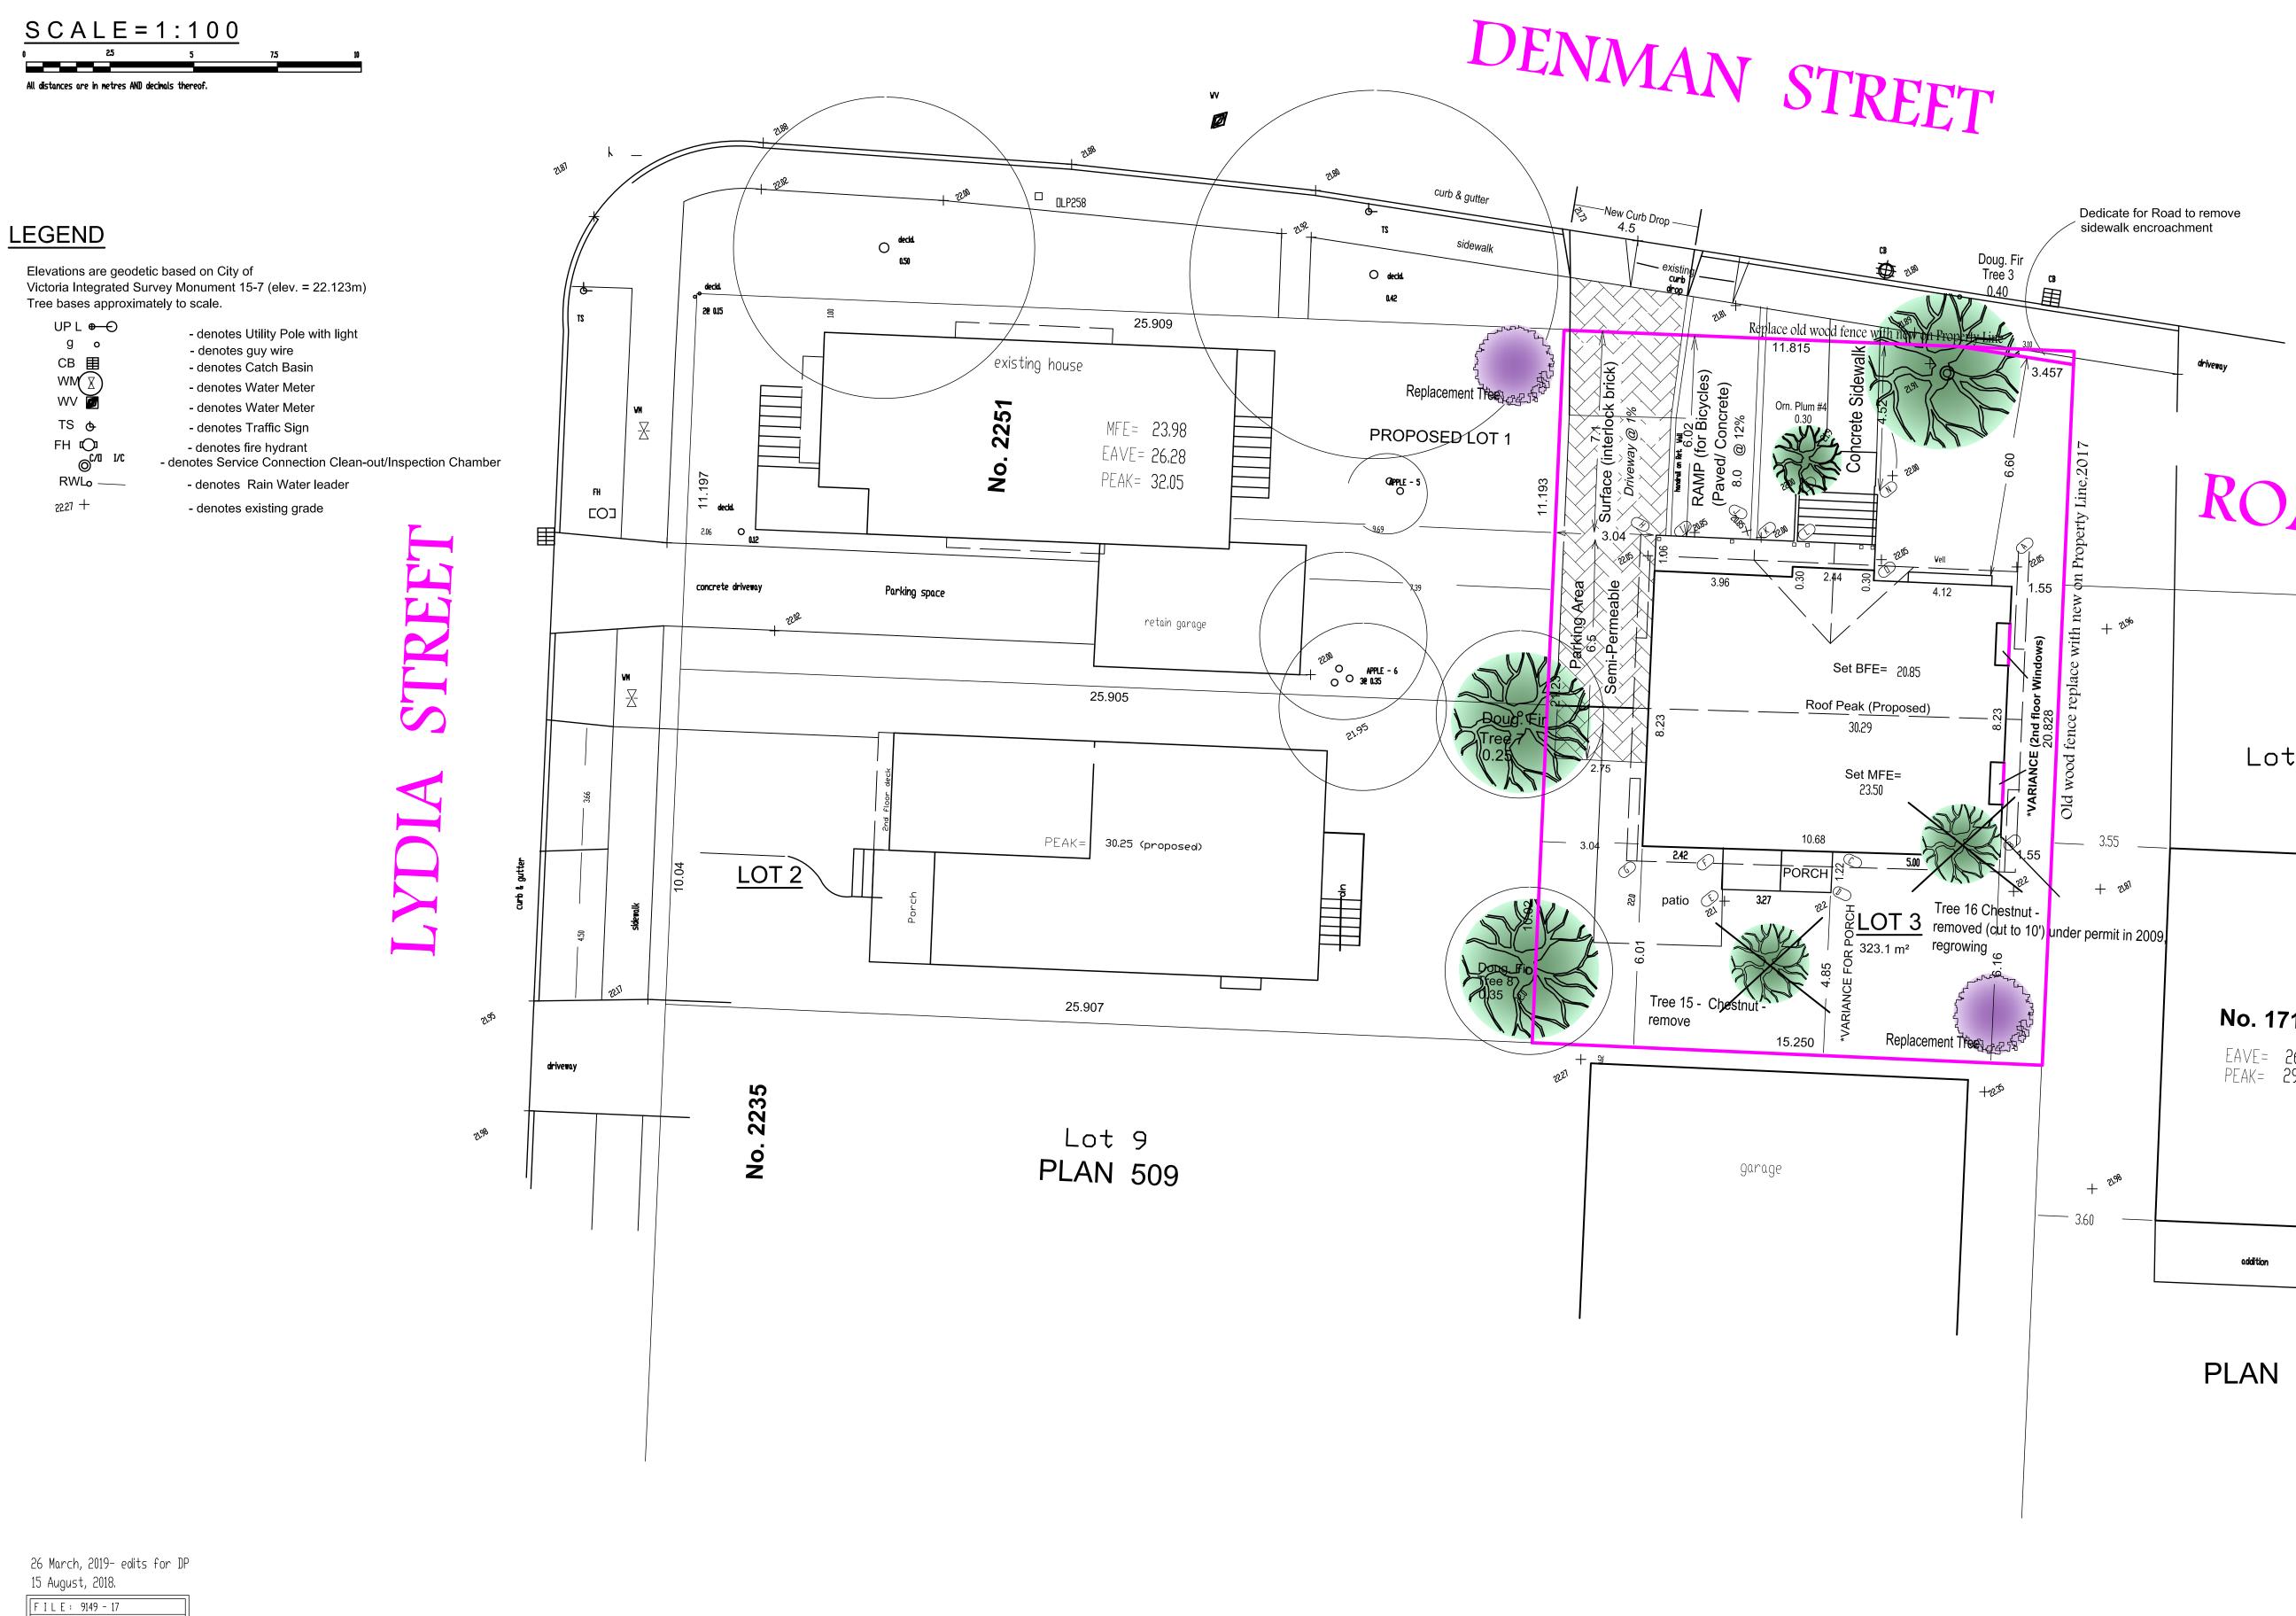


DVG/DATE: 9149SP03 / 2017-04-03 🗍 🖁 Brad Cunnin Land Services 2235 Lydia Street Victoria, BC V8W 1S2

brad@cunnin.ca

ph. 250-480-9693



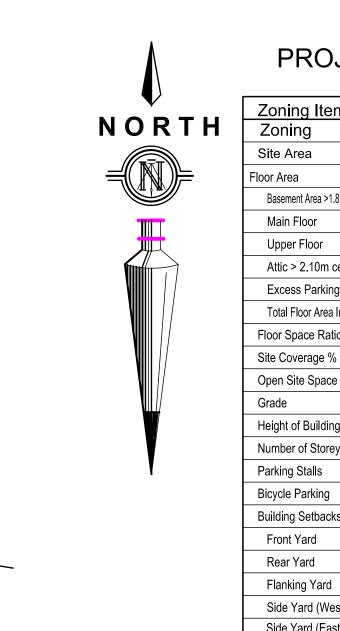

PROJECT INFORMATION TABLE					
Zoning Item	By-Law Value	Provided			
Zoning	R1-S2				
Site Area	260 m²	323 m²			
Floor Area					
Basement Area >1.8m ceiling AG		55.3 m² (596 sq.ft.) not inc l.			
Main Floor		83.7 m ² (901 sq.ft.)			
Upper Floor		78.4 m² (844 sq.ft.)			
Attic > 2.10m ceiling		0			
Excess Parking	>18.6 m²	0 m²			
Total Floor Area Incl Stairs	190 m²	162.1.0m² (1745 sq.ft.)			
Floor Space Ratio	0.6	0.51			
Site Coverage %	40%	35.5 %			
Open Site Space	N/A	50 %			
Grade		22.05			
Height of Building	7.50	7.36			
Number of Storeys	2	2			
Parking Stalls	1	1			
Bicycle Parking	0	multiple			
Building Setbacks					
Front Yard	6.0	6.01			
Rear Yard	6.0	6.01 to building 4.85 *Variance to 4.80			
Flanking Yard	2.4	N/A			
Side Yard (West)	1.5/2.4	3.04			
Side Yard (East)	1.5/2.4	1.55 *Varaince to 1.50			

+ 5%			Date	26 March, 2019			File #		9419
	ROAD	JOB:	New Denman			<u>CLIENT:</u>			
	MAD	LINE	<u>FIRST CORNER</u> ELEV.	<u>SECOND CORNER</u> ELEV.		<u>AVG</u>	<u>WALL</u> LENGTH	Avg El x L	
		A B (22.20	}/2 =	22.13 *	8.08 =		178.8
		BC (22.20)/2 =	22.2 *	5.08 =		112.8
		CD (22.20 -	22.20)/2 =	22.2 *	1.22 =		27.:
		DE (22.20 -	22.10)/2 =	22.15 *	3.27 =		72.
+ 57.06		E F (22.10 -		}/2 =	22.1 *	1.22 =		27.
		F G (22.00)/2 =	20.8 *	2.42 =		53.
		G H (22.00 -)/2 =	22.03 *	9.30 =		204.
			22.05 -)/2 =	21.45 *	0.15 =		3.
		1 K (20.85 -	- 20.85 - 22.00)/2 =)/2 =	20.85 * 21.43 *	3.81 = 0.15 =		79.
		J K (- 22.00 - 22.00)/2 =)/2 =	21.43	0.15 = 1.75 =		3. 38.
			22.00 -)/2 =	22 *	2.44 =		53.
				- 22.00)/2 =	22 *	2.44 =		56.
	Lot 9		22.00 -)/2 =	22.03 *	2.50 =		50.
			22.05 -)/2 =	22.05 *	4.12 =		90.
				TOTALS	,, -	*	45.57		.004.
				AVG. GRADE	Total	Area/Total \	Mall Length		22.0
255					Totary	Areay rotari			22.0
3.55			HEIGHT CALCULATION						
				<u>PEAK</u>	30.2				
+ 2181				<u>EAVE</u>	28.5				
				<u>MEAN</u> HEIGHT	29.4 (Mear	n-Avg. Grade	2)		7.3
ormit in 0000						_			
ermit in 2009,			BASEMENT CALCULATIO	<u>Basement Ceiling</u>	23.2	c			
				AVER. GRADE	23.2				
				<u>Height above grade</u>	1.2		_		1.20
				<u>neign: ubove grude</u>	1.2	U	-		1.21
	No. 1711			-					
	EAVE= 26.54								
	PEAK= 29.71								
. 98									
- ^{57,98}									
	addition								

PLAN 375


PROPOSED SINGLE FAMILY RESIDENCE


R1-S2

Al of 3

For: Brad Cunnin NEW DENMAN STREET House



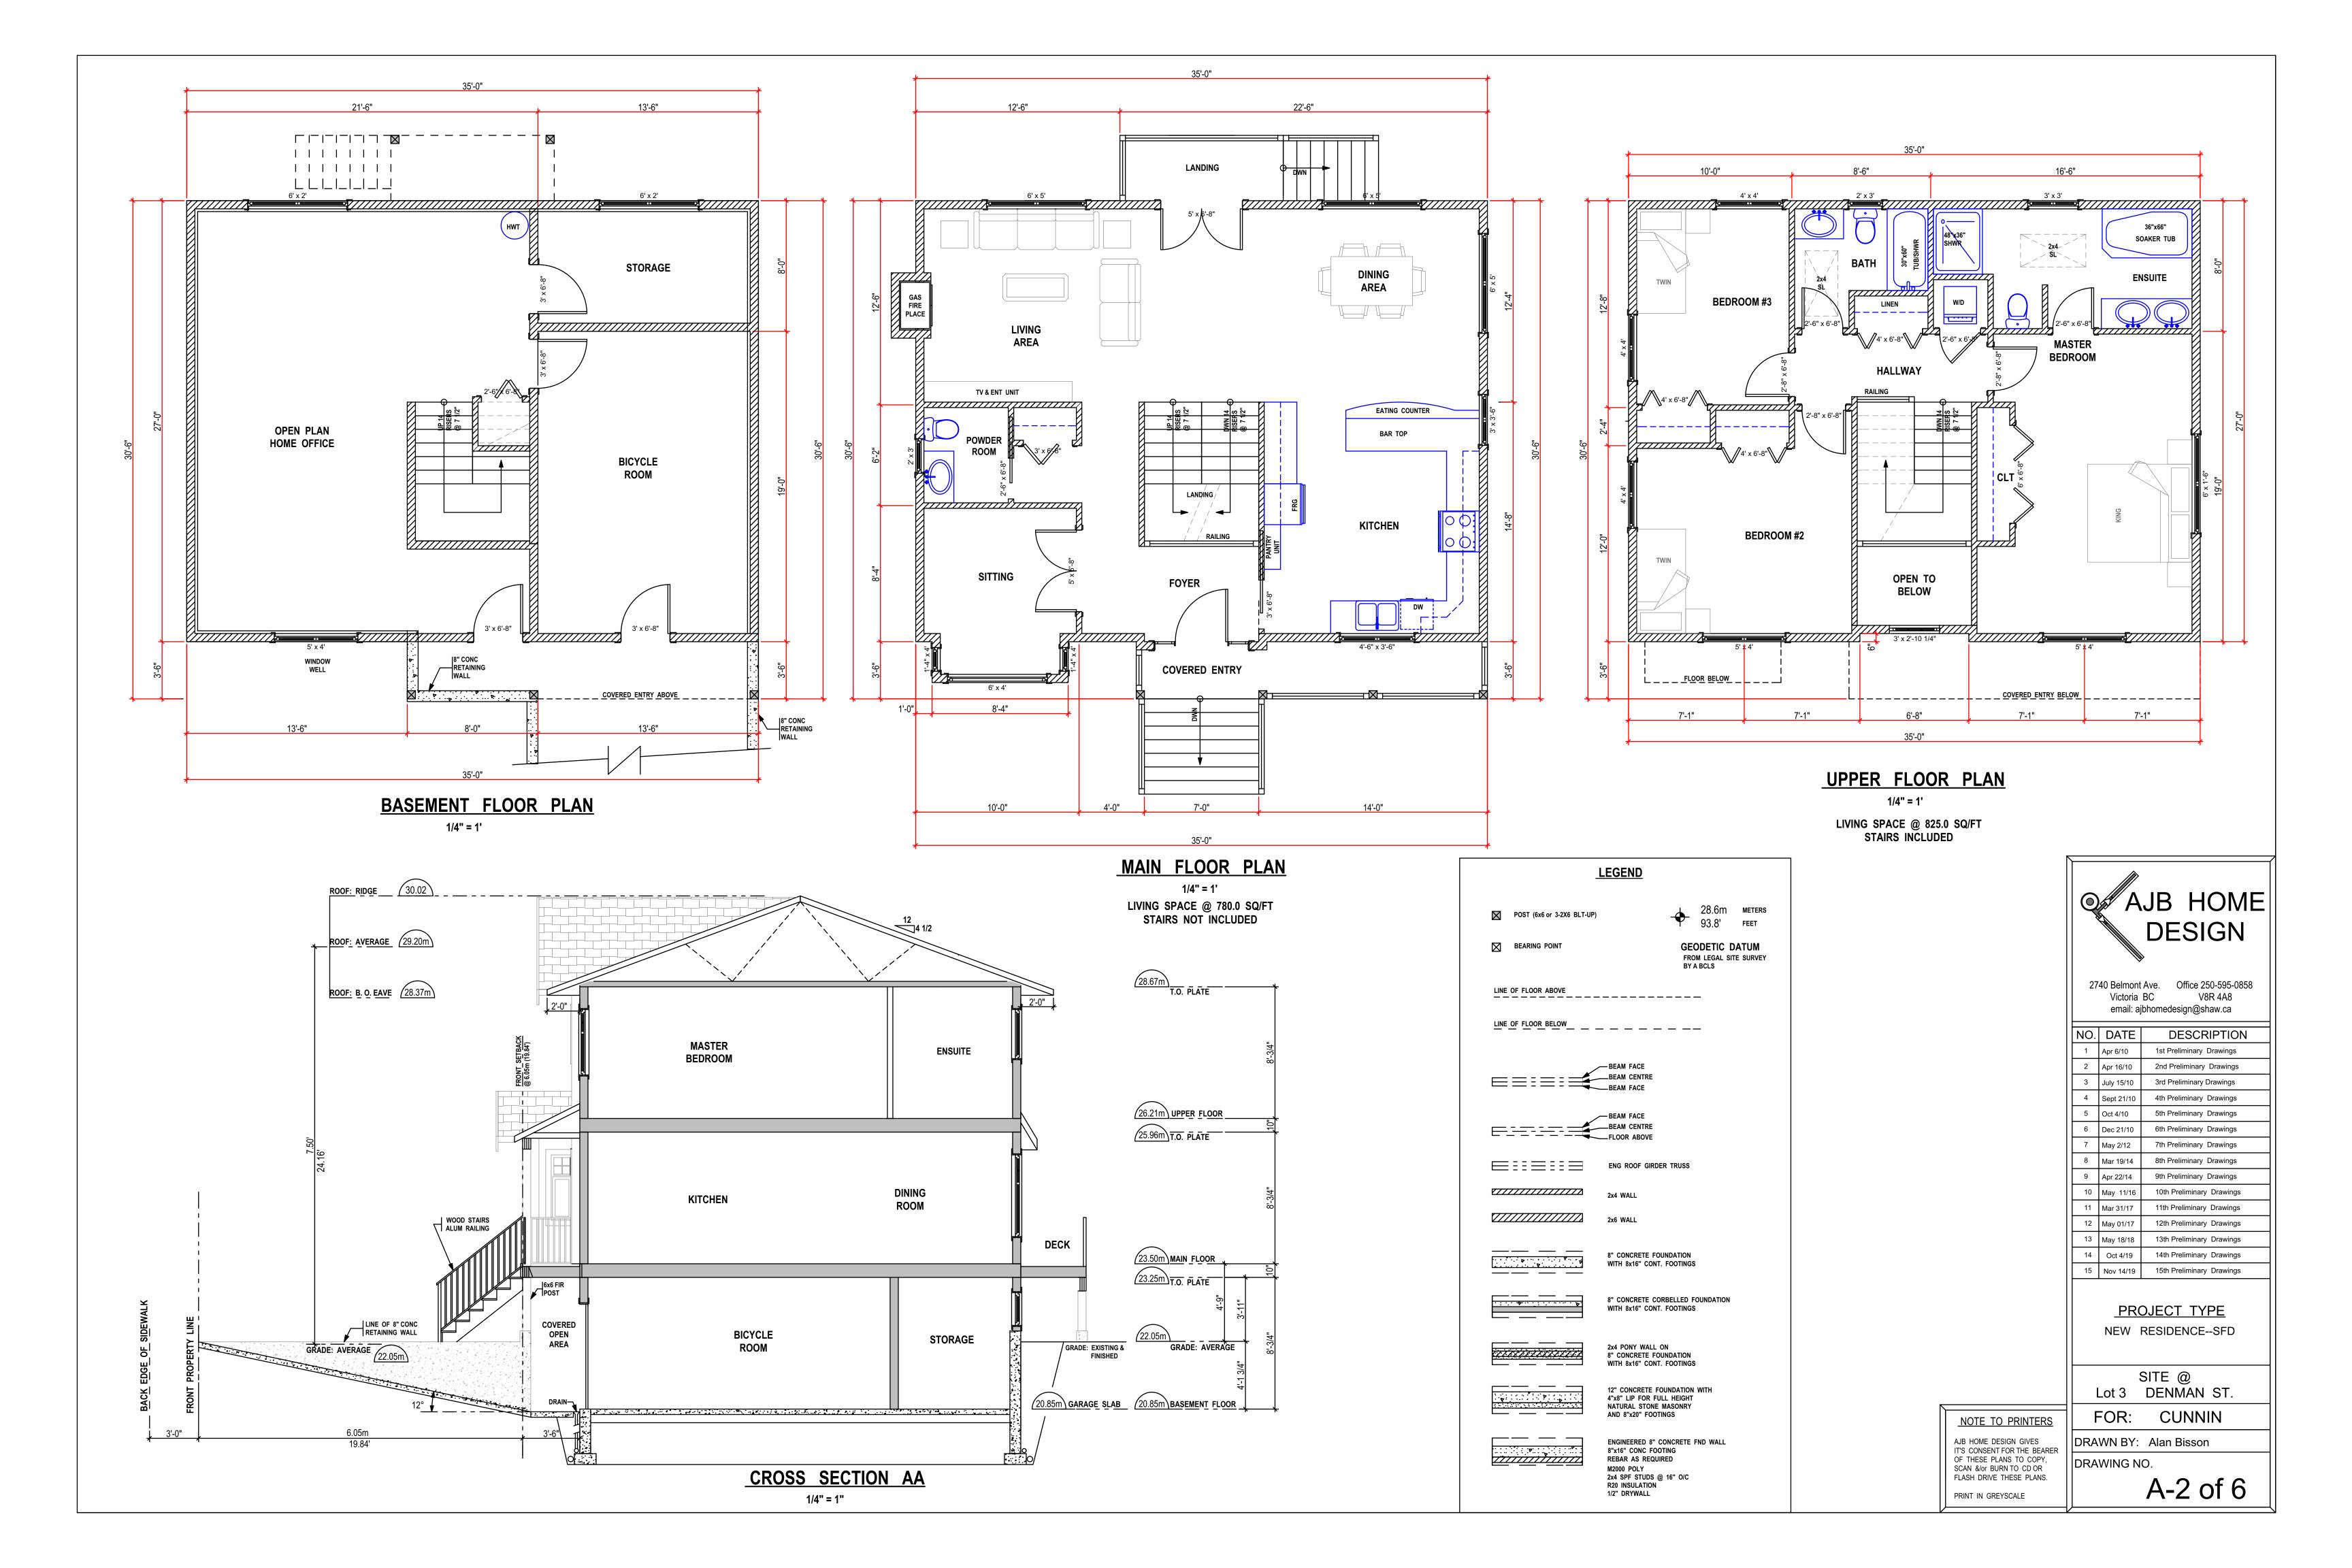

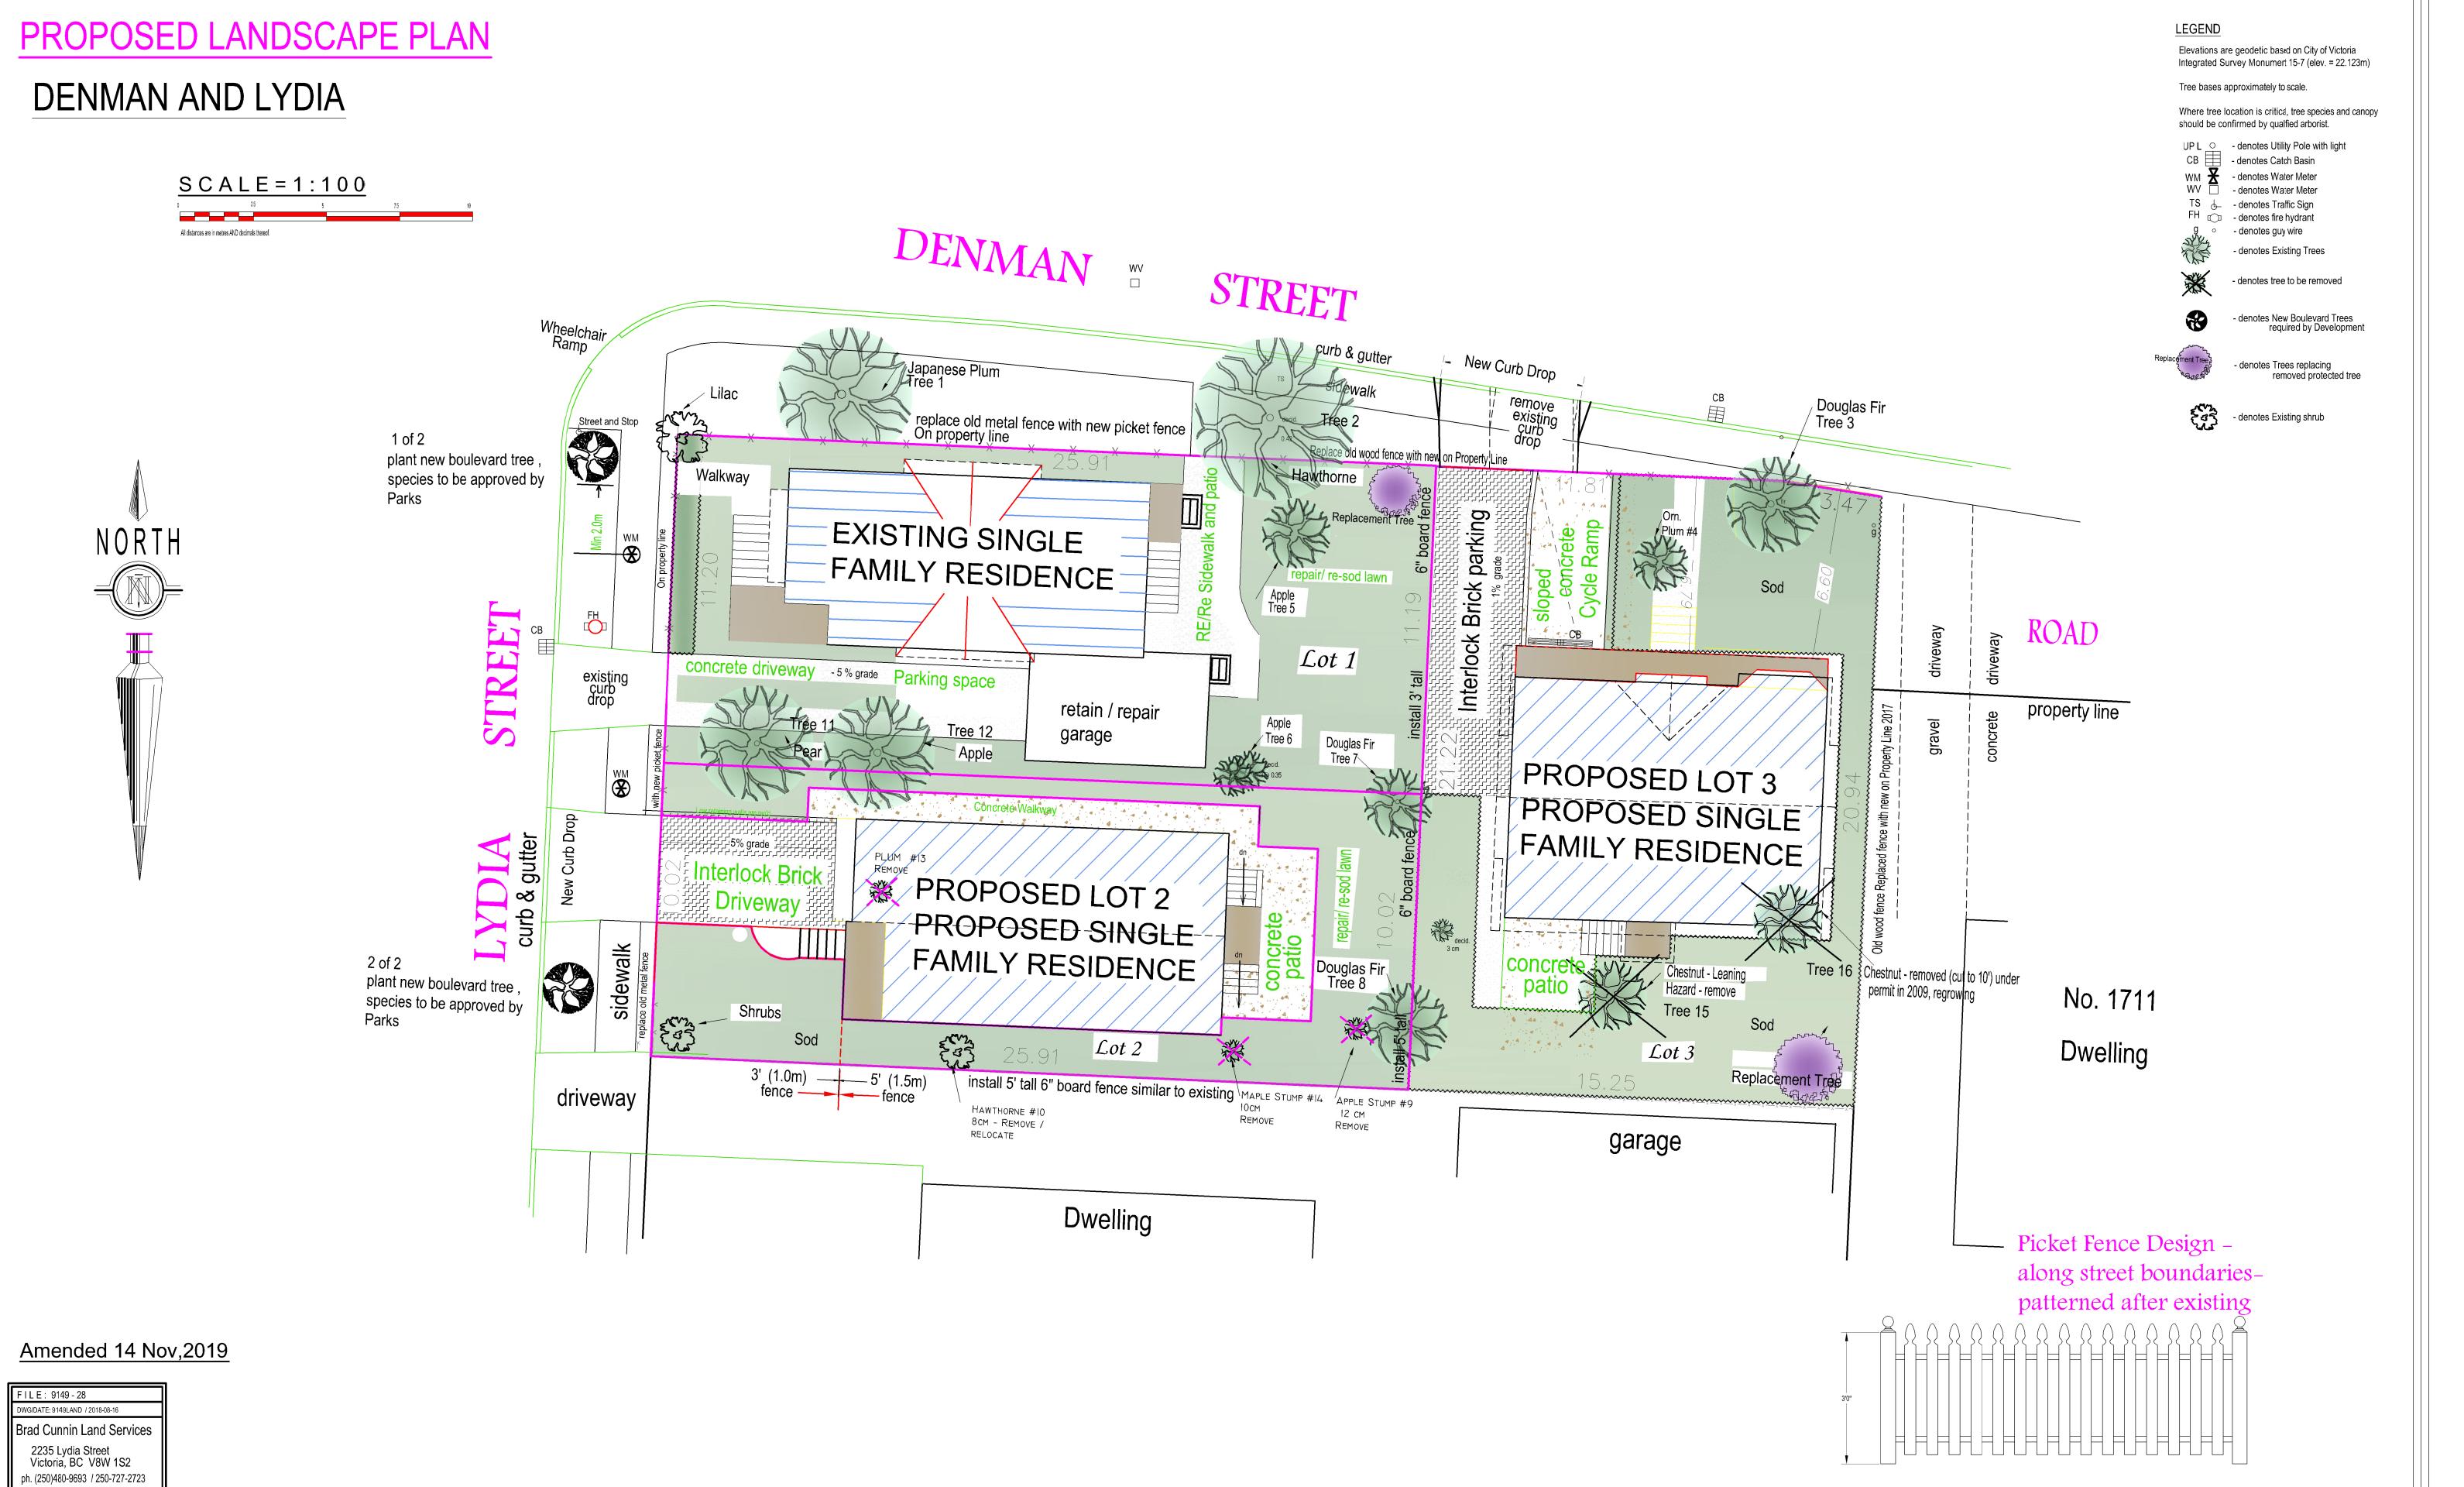

FILE: 9149-28				
DWG/DATE: 9149LAND / 2018-08-16				
Brad Cunnin Land Services				
2235 Lydia Street Victoria, BC V8W 1S2				
ph. (250)480-9693 / 250-727-2723				




1711 DENMAN STREET **EXISTING RESIDENCE**



DENMAN STREET


PROPOSED RESIDENCE (FRONT VIEW)

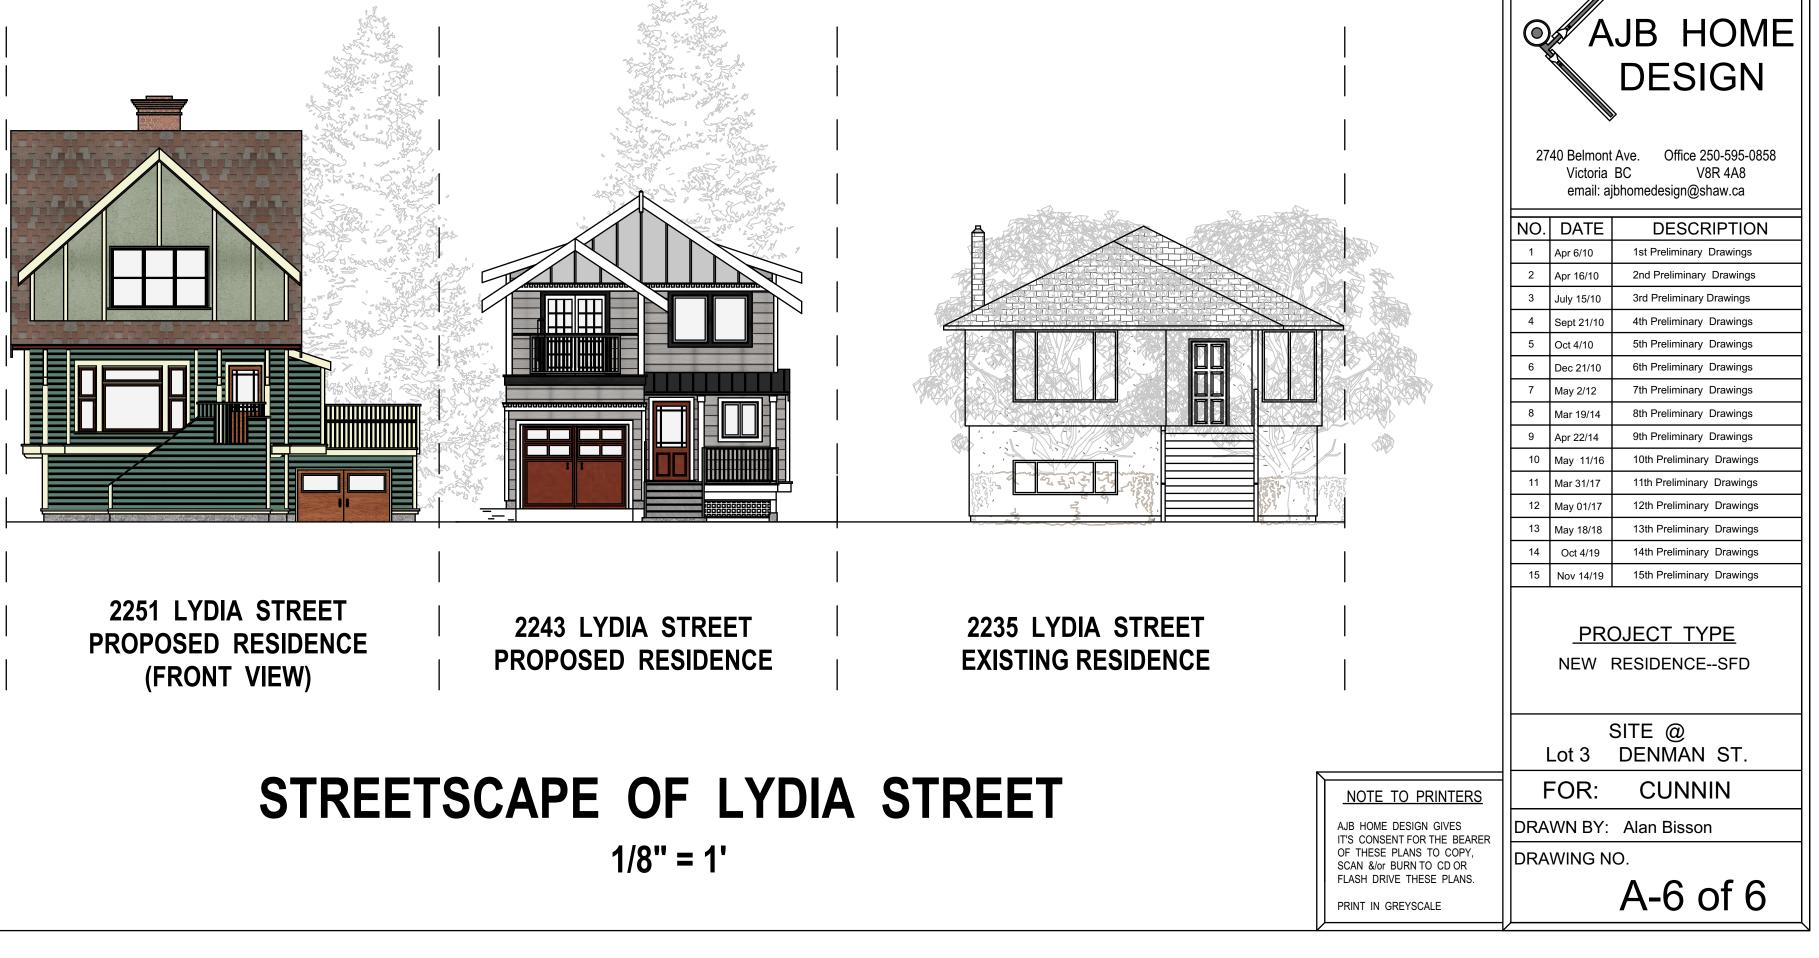

STREETSCAPE OF DENMAN STREET 1/8" = 1'

2251 LYDIA STREET PROPOSED RESIDENCE (SIDE VIEW)




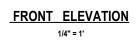


1708 DENMAN STREET PROPOSED RESIDENCE



LYDIA STREET

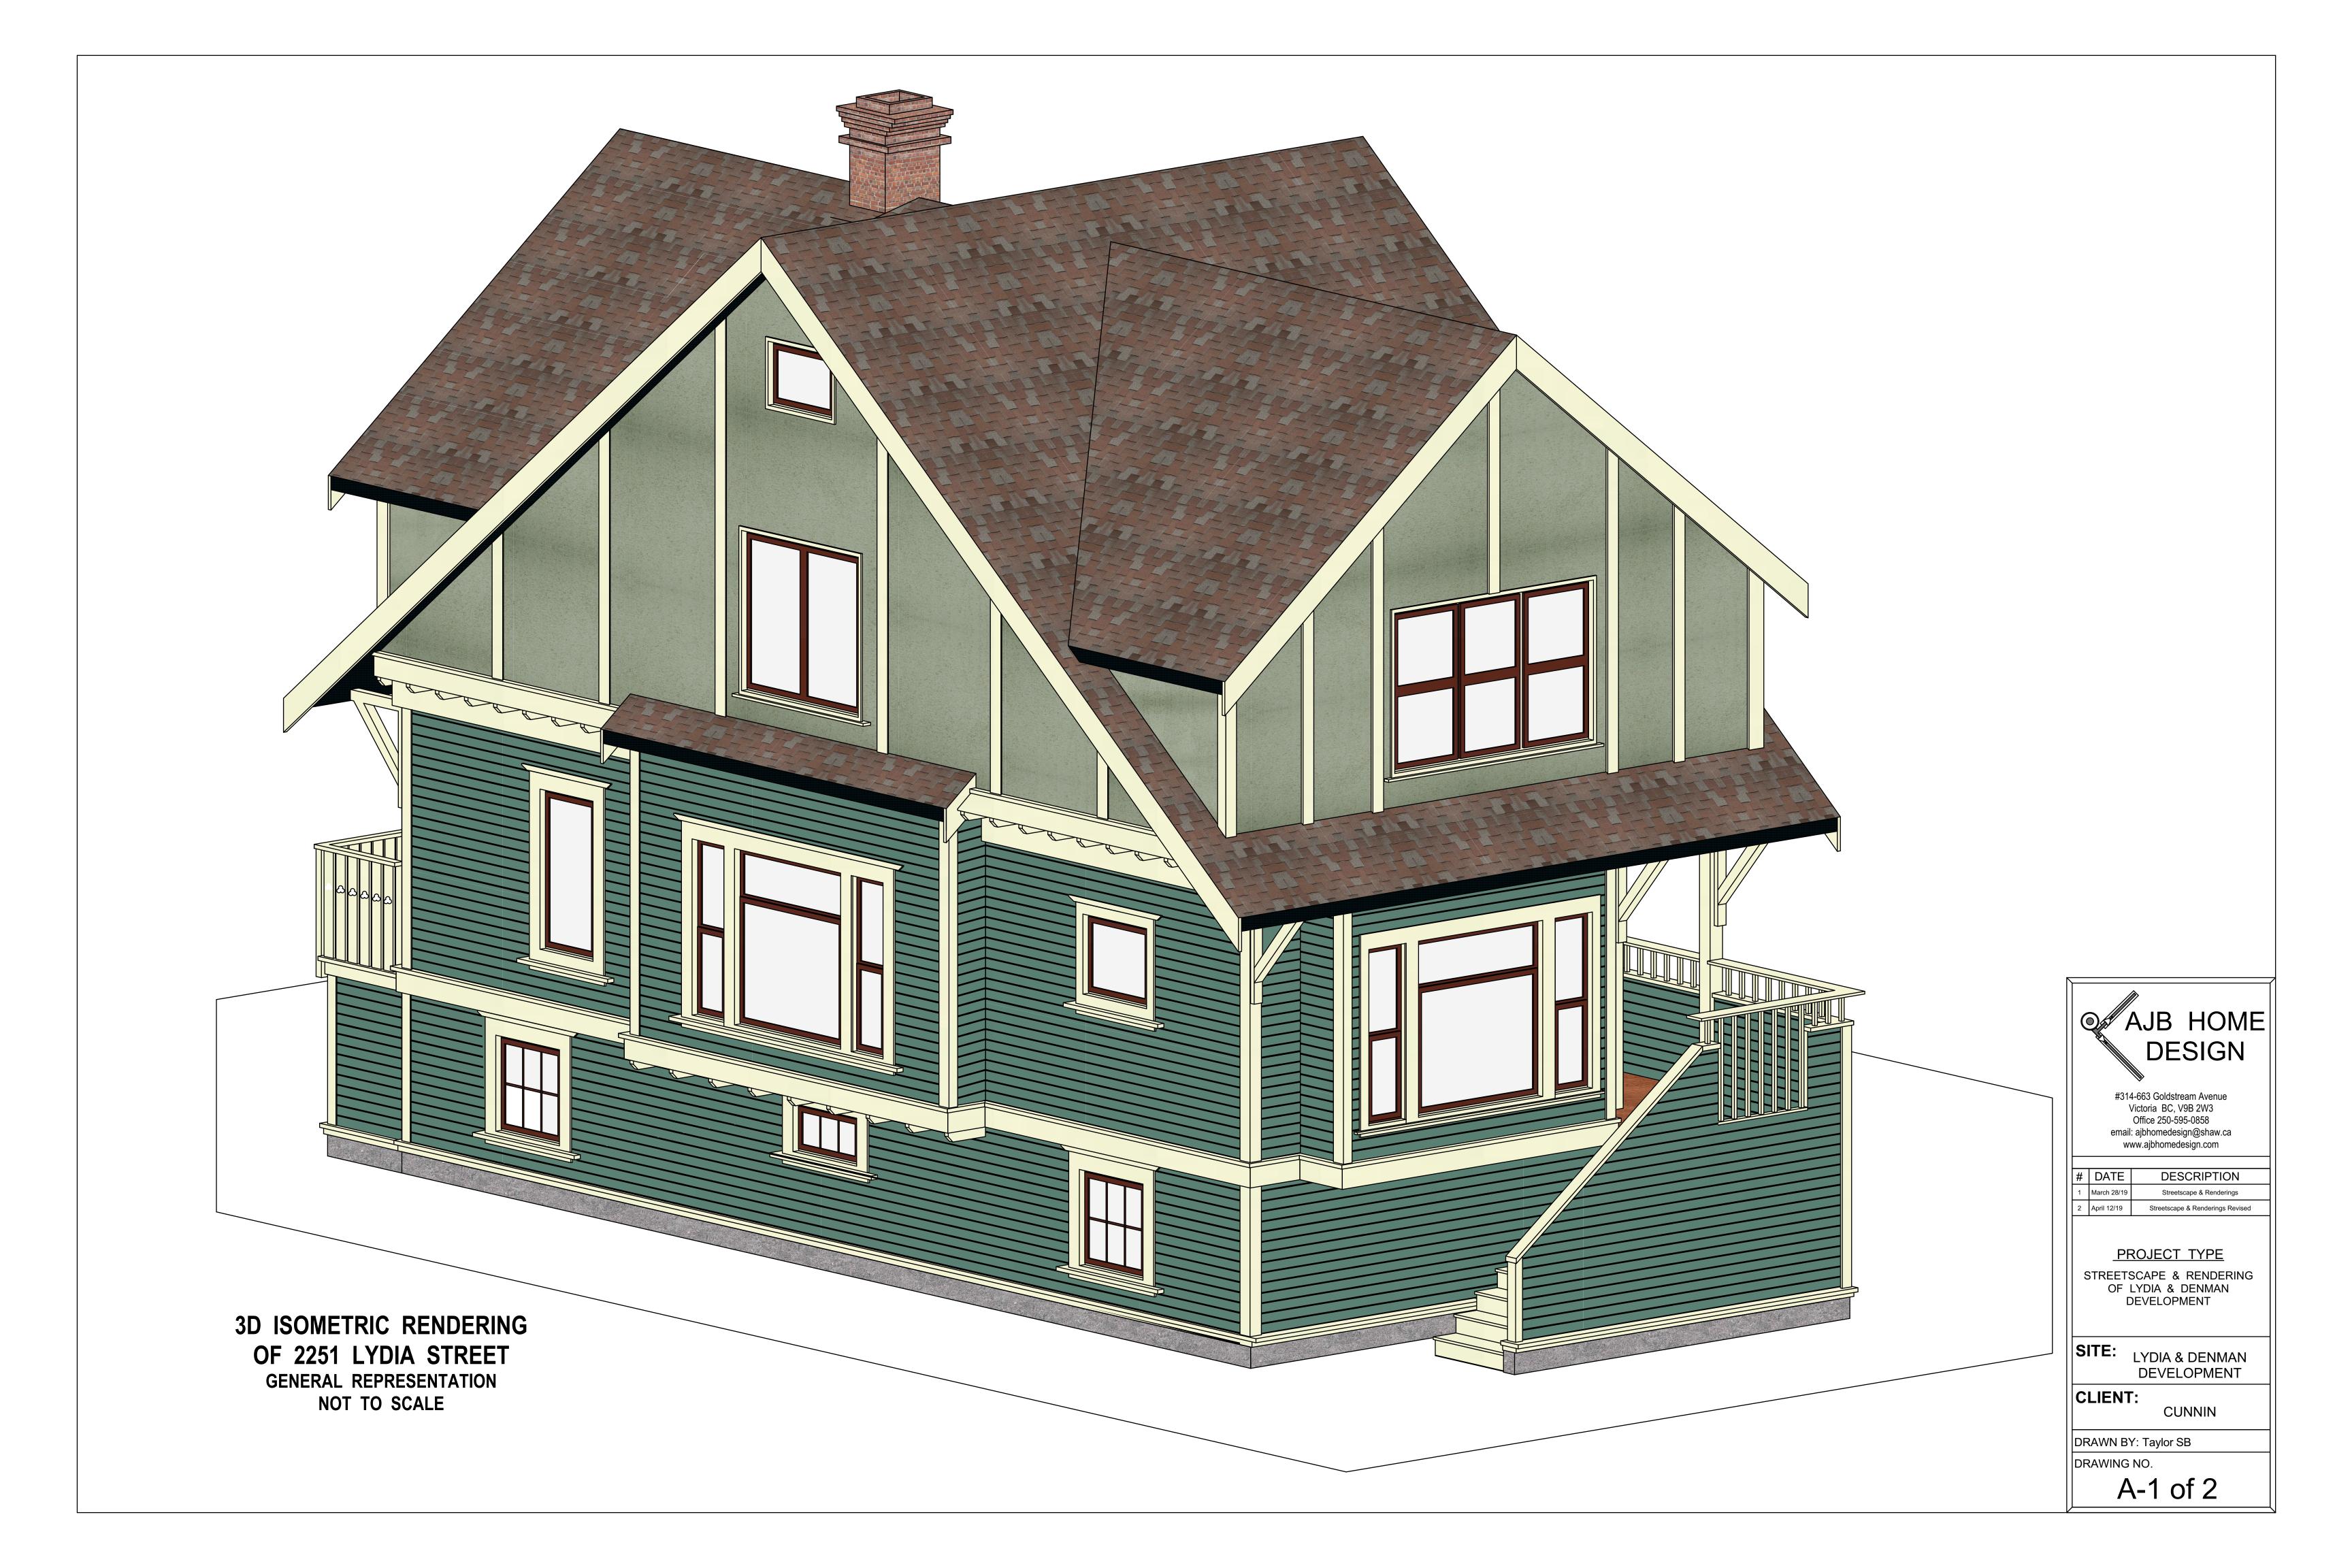

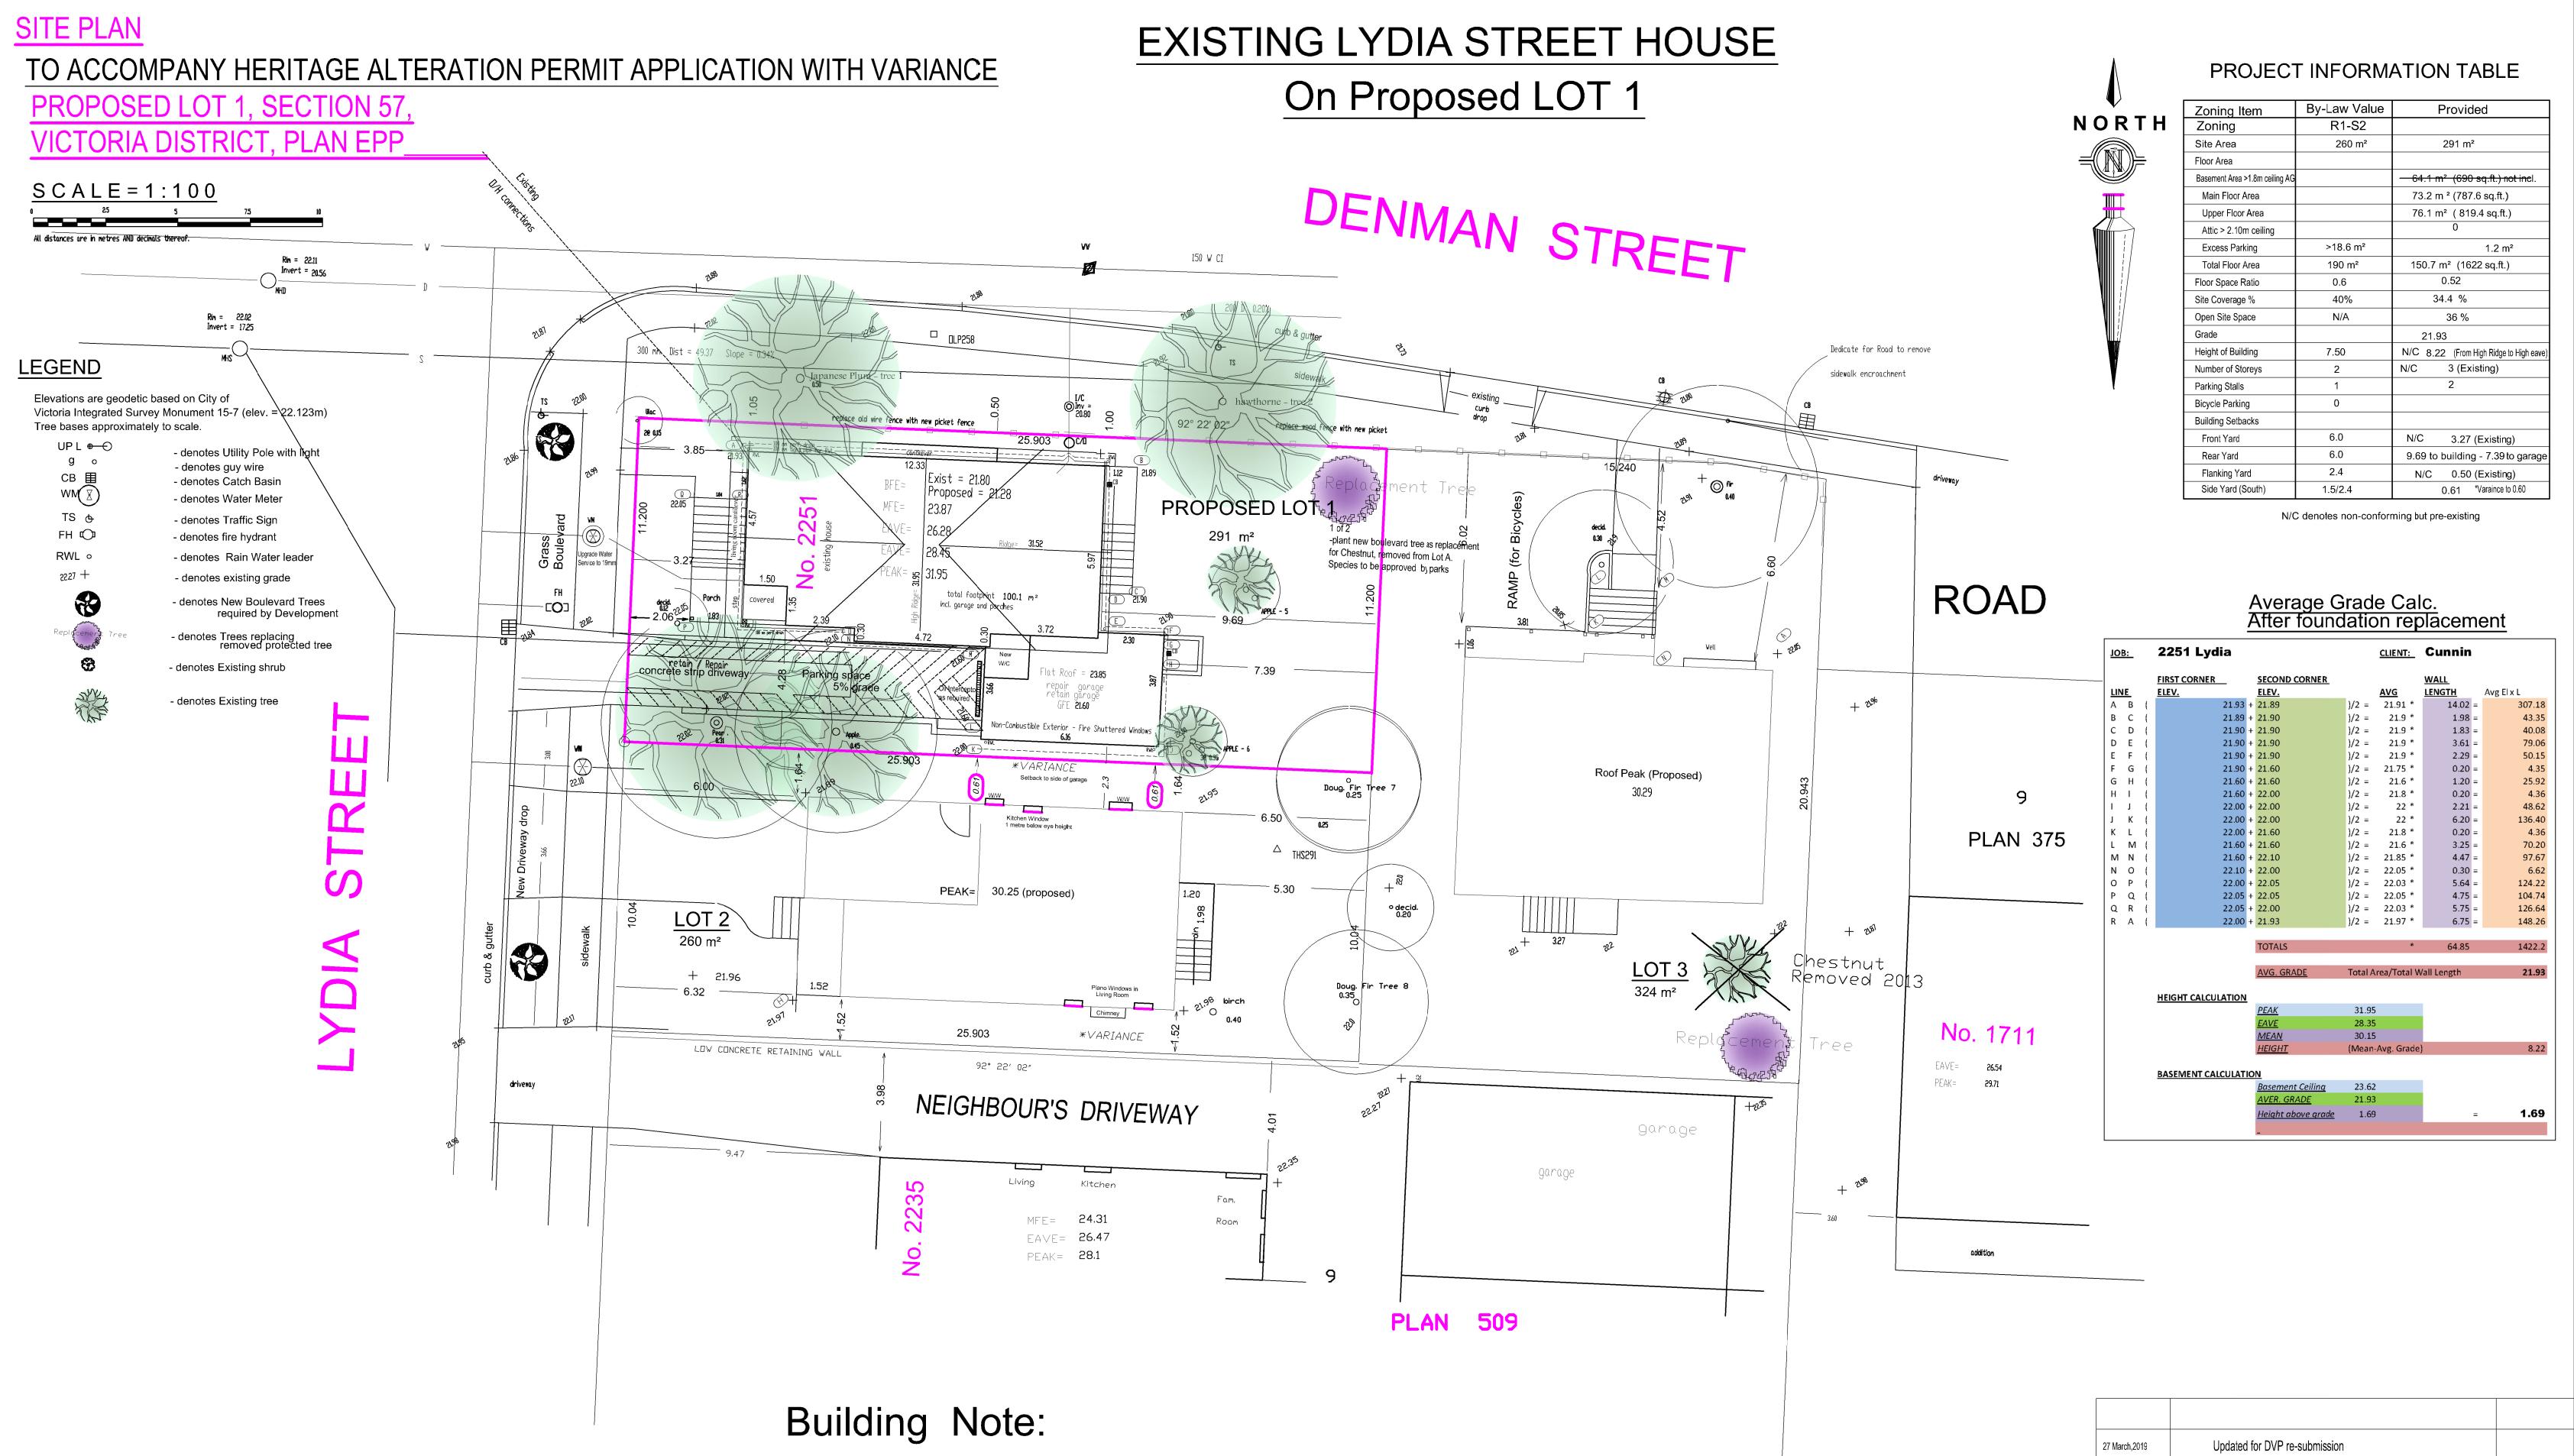

application.

5 March, 2019

FILE: 9149 - 17 DVG/DATE: 9149SP02 / 2018-08-15 🕺 Brad Cunnin Land Services 2235 Lydia Street Victoria, BC V8W 1S2 ph. 250-480-9693

<u>Notes</u>

- All connections to municipal services to be 100mm PVC

- All works to be performed to applicable by-laws and codes. No work

verified. Care to be exercised in trenching for actual locations.

to be performed from these drawings unless these drawings are approved

- Location of existing services are as per Municipal records, and must be field

- Final service connection elevations are dependent on depth of existing service

by Municipality. All works subject to municipal inspection and approval.

mains. Where critical, final service connection elevations to be verified

installed at 2% unless otherwise indicated.

before commencing any residential construction.

Existing house has had foundation reconstructed, house is now 10cm lower than before. It is in the same location. Concrete in the location of garage rebuild has been poured, but no construction or building permit has been commenced, pending the outcome of a DP

2251 Lydia Str	•
Subdivision of Am Lot 10	0
BENCHMARK: 15 - 29	
DRAWING : 9149-Lot 1	
SCALES: Hor. 1:200 Vert. nts	

Updated for BP re-submission DATE: 18 Aug, 2018. APP'D DATE REVISION DESCRIPTION reet Brad Cunnin Land Services 0, Blk 2, Sec 57, Plan 509 2235 Lydia Street Victoria, BC V8T 1Y9 ELEVATION = 24.391m(250) 480-9693 DRAWN: BWC CHECKED: B.W.C. 1 of 1 brad@cunnin.ca DATE: 18 March, 2018.



COMMUNICATIONS BETWEEN ALL PARTIES. REFER TO DRAWINGS FOR ACCURATE DETAILS.

VERSION OF THE N.B.C., THE B.C.B.C.,
MUNICIPAL BYLAWS AND ZONING REGULATIONS

- 2. SPANS FOR BEAMS, FLOOR JOISTS, ROOF RAFTER AND CEILING JOISTS ARE AS PER "THE SPAN BOOK" BY THE CANADIAN WOOD COUNCIL.
- 3. DO NOT SCALE FROM PLANS. WORK ONLY TO DIMENSIONS INDICATED.
- ALL CONSTRUCTION WORK IS TO BE DONE WITH A BUILDING PERMIT.
- 5. ALL ELECTRICAL WORK IS TO BE DONE WITH AN ELECTRICAL PERMIT, TO THE ELECTRICAL CODE AND BY A REGISTERED ELECTRICAL CONTRACTOR.
- ALL PLUMBING WORK IS TO BE DONE WITH A PLUMBING PERMIT, TO THE PLUMBING CODE AND BY A REGISTERED PLUMBING CONTRACTOR.
- 7. ALL SMOKE DETECTORS TO BE INTERCONNECTED & WIRED TO 110 VOLT.
- . FLASHING REQUIRED OVER ALL EXPOSED OPENINGS. ALL END DAMS @ 2.5mm (1") D. RAIN SCREENING IS TO BE AS PER
- THE REQUIREMENTS OF THE MUNICIPALITY AND THE BC BUILDING CODE 10. ALL MATERIALS, USED ON THIS JOB
- ARE TO MEET APPLICABLE BC BUILDING CODE STANDARDS AND HAVE APPROPRIATE DOCUMENT NUMBERS AS PER SECTIONS 5.10 & 5.11
- 11. THESE DRAWINGS SHOW SPECIFIC CONSTRUCTION METHODS AND MATERIALS USED ON THIS PROJECT. IT IS UNDERSTOOD THAT CHANGES OR SUBSTITUTIONS TO THOSE METHODS AND MATERIALS MAY OCCUR. ANY CHANGES OR SUBSTITUTIONS MUST BE APPROVED BY THE BUILDING INSPECTION DEPARTMENT OF THE APPLICABLE MUNICIPALITY. ANY REQUIRED ADDITIONAL DOCUMENTATION IS TO BE SUPPLIED BY OTHER.
- 12. THE FOLLOWING LIST CONTAINS MAIN ITEMS THAT ARE NOT PART OF THESE PLANS AND MAY BE REQUESTED BY THE MUNICIPALITY.

THEY ARE TO BE SUPPLIED BY OTHER AND ARE THE RESPONSIBILITY OF THE OWNER/BUILDER TO OBTAIN.

- LEGAL SITE SURVEY.
- THE CORRECT SITING OF THE HOUSE ON THE PROPERTY.
- ALL SITE SERVICES.
- © STRUCTURAL ENGINEER'S REPORTS. (SCHEDUAL B).
- ALL OTHER ENGINEERING. O LAYOUTS AND FOR ENGINEERING FOR
- TRUSS, BEAM AND FLOOR SYSTEMS. HEATING SYSTEM(S).
- VENTILATION CALCULATIONS & CHECK LIST.
- GEOTECHNICAL REPORTS.
- ARBORIST REPORTS.

DISCLAIMER:

- IT IS THE RESPSONABLITY OF THE CONTRACTOR and/or THE OWNER TO CHECK AND VERIFY ALL ASPECTS OF THE PLANS PRIOR TO START OF ANY CONSTRUCTION OR DEMOLITION.
- AJB HOME DESIGN IS NOT RESPONSIBLE FOR ERRORS and/or OMISSIONS
- O THESE PLANS REMAIN THE PROPERTY OF AJB HOME DESIGN AND CAN BE RECLAIMED AT ANY TIME UPON WRITTEN
- REQUEST. ALL DIMENSIONS OF EXISTING STRUCTURE ARE +-AND ARE TO BE CONFIRMED ON SITE. CHANGES TO BLUEPRINTS MAY BE REQUIRED.

NOTE TO PRINTERS


AJB HOME DESIGN GIVES ITS CONSENT FOR THE BEARER OF THESE PLANS TO COPY, SCAN &/or BURN TO CD OR A FLASH DRIVE. PRINT IN GREYSCALE.


AJB HOME DESIGN						
#314-663 Goldstream Ave. Victoria BC, V9B 2W9 Office 250-595-0858 email: ajbhomedesign@shaw.ca www.ajbhomedesign.com						
NO.	DATE	DESCRIPTION				
1	Mar. 09/18	Rough Draft Drawings				
2	Mar 28/18	Construction & Permit Drawings				
PROJECT TYPE NEW CONC FOUNDATION & RENOVATIONS TO HERATAGE SFD RESIDENCE						
SIT	SITE: 2251 LYDIA ST					
FOR:						


BC HOMES

A-1 of 6

DRAWN BY: Alan Bisson DRAWING NO.

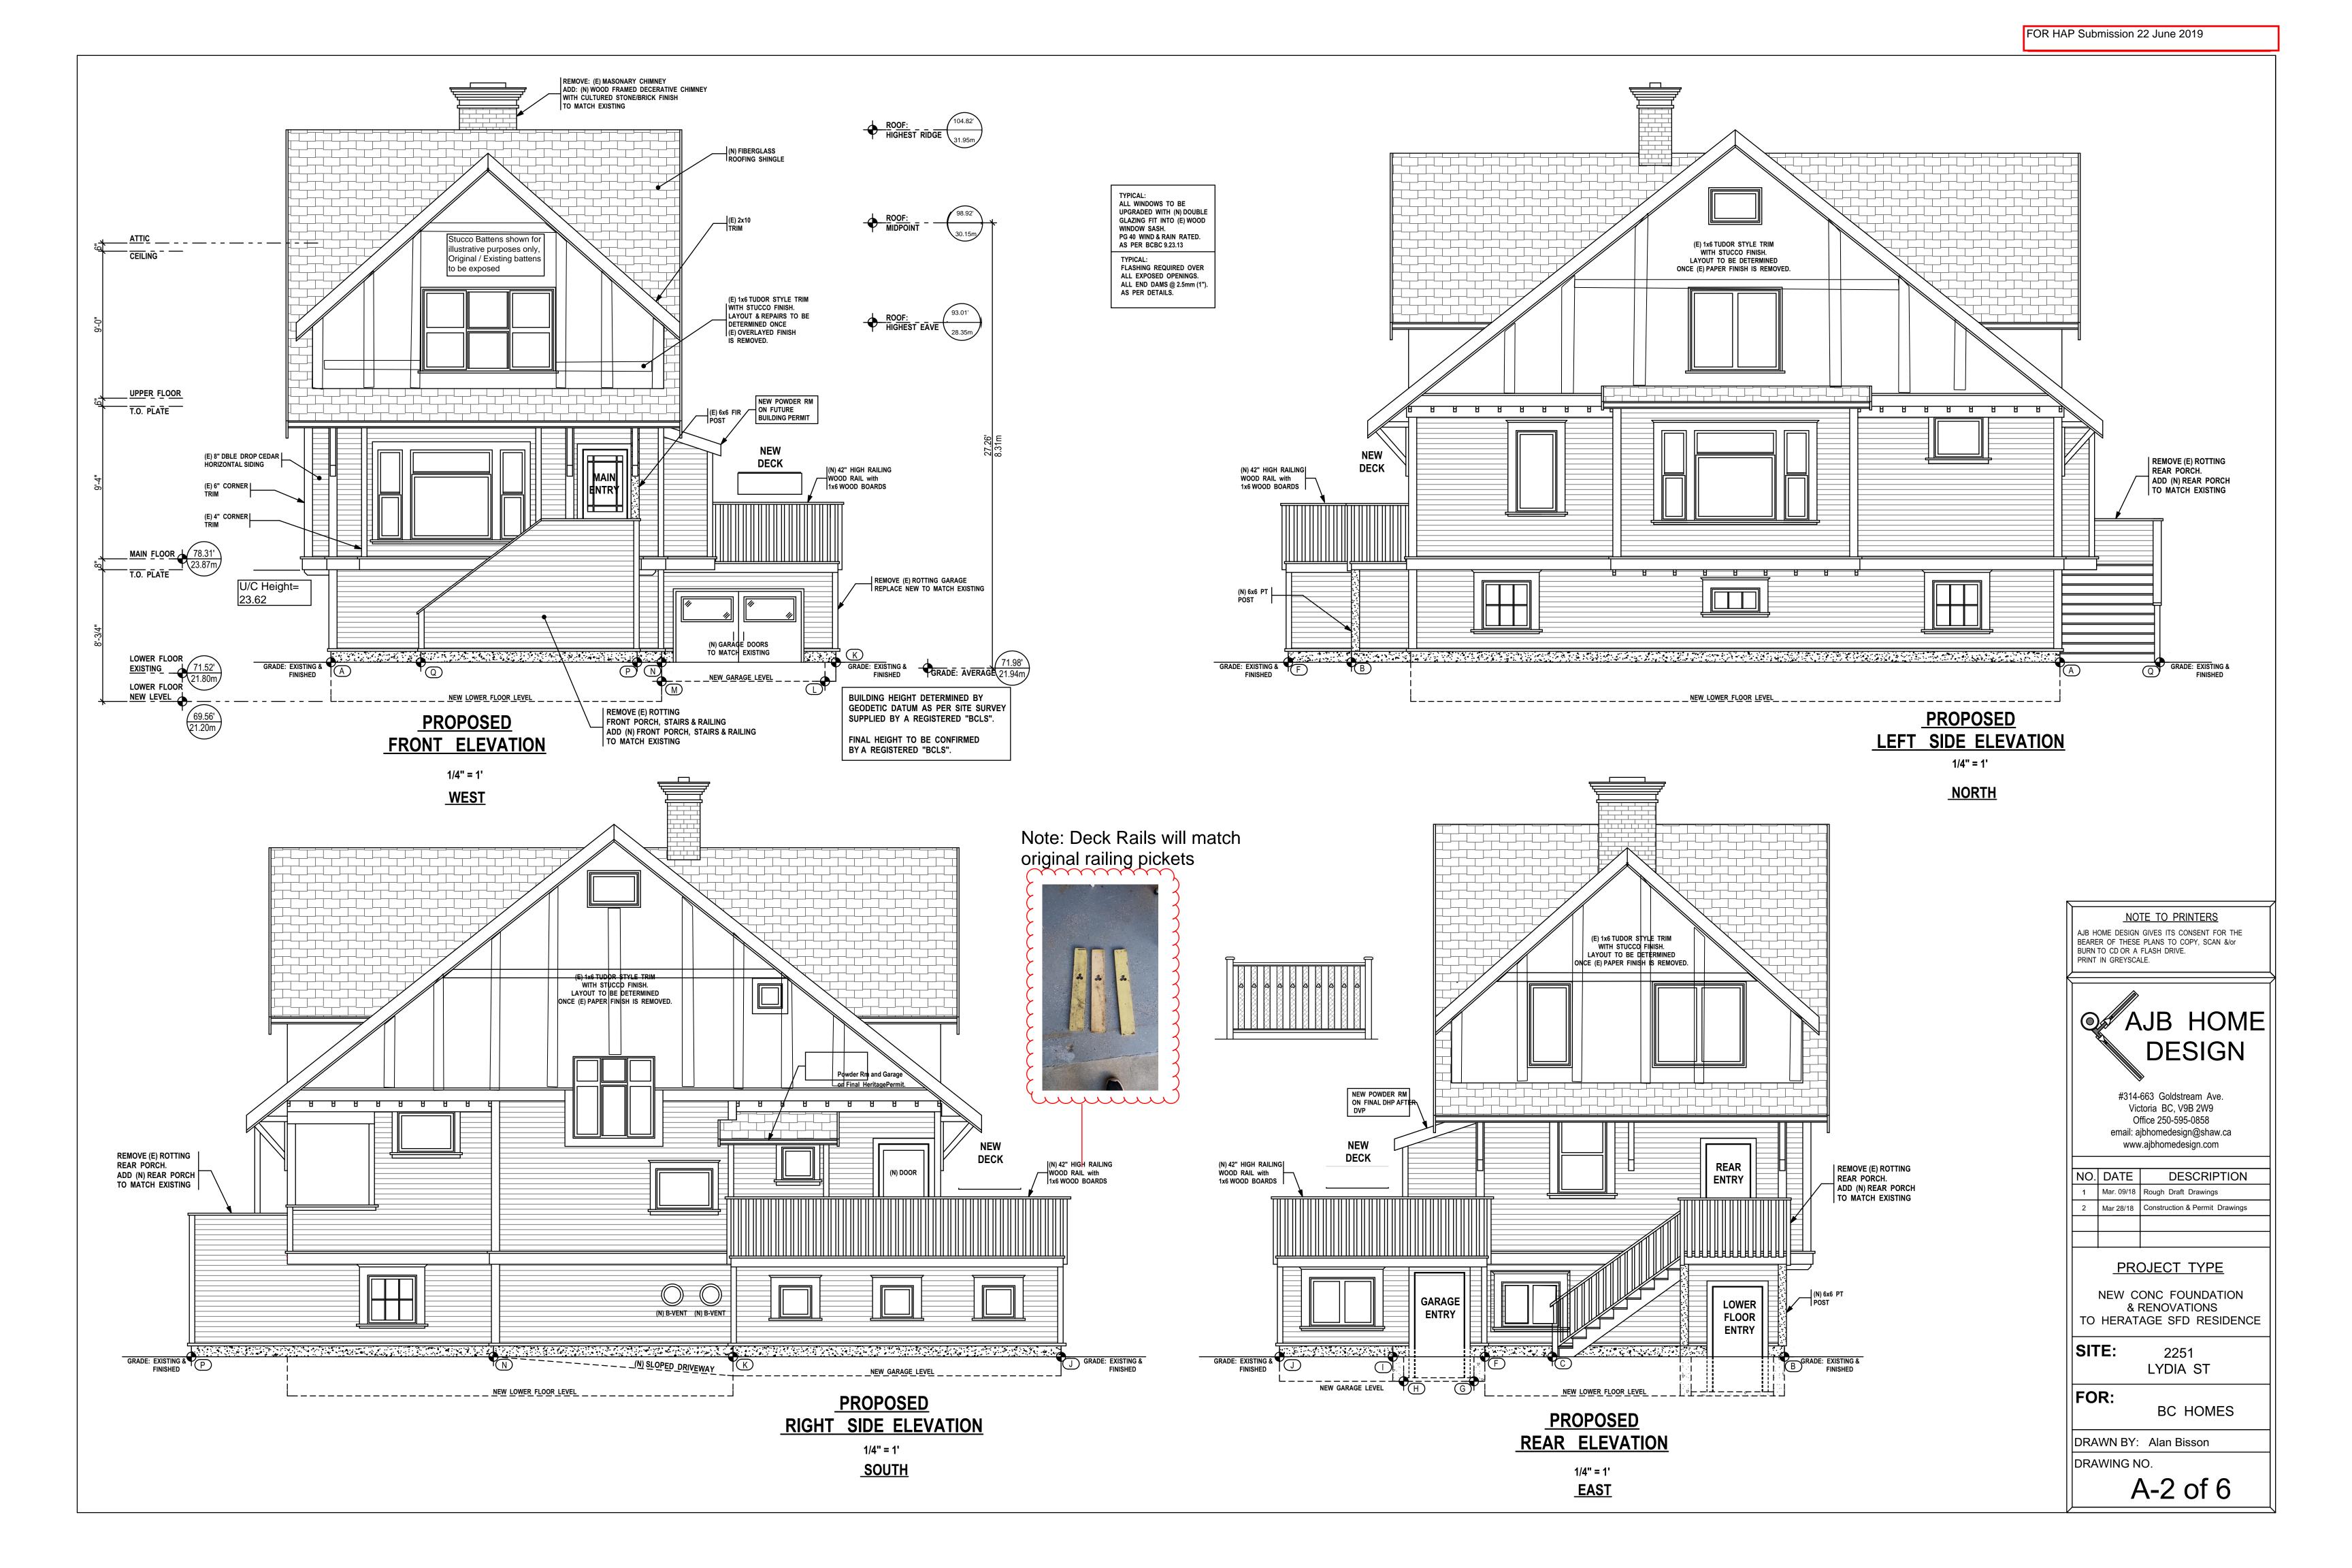


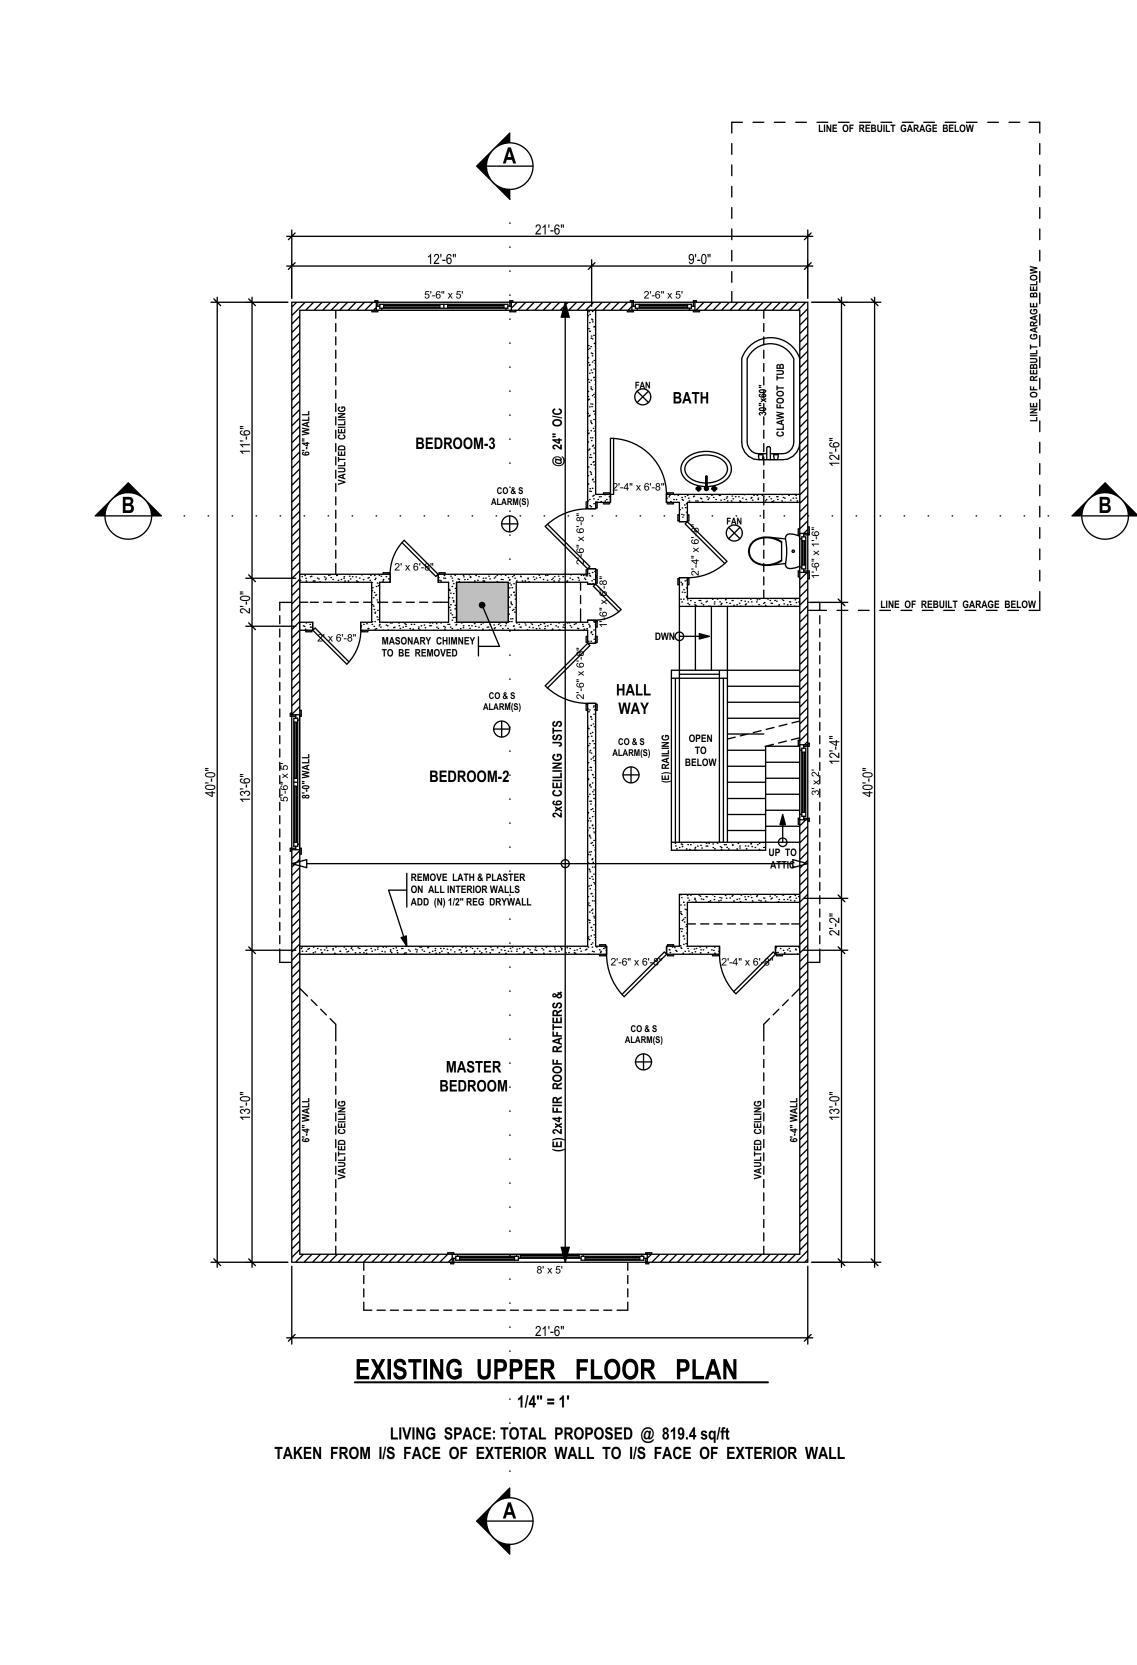


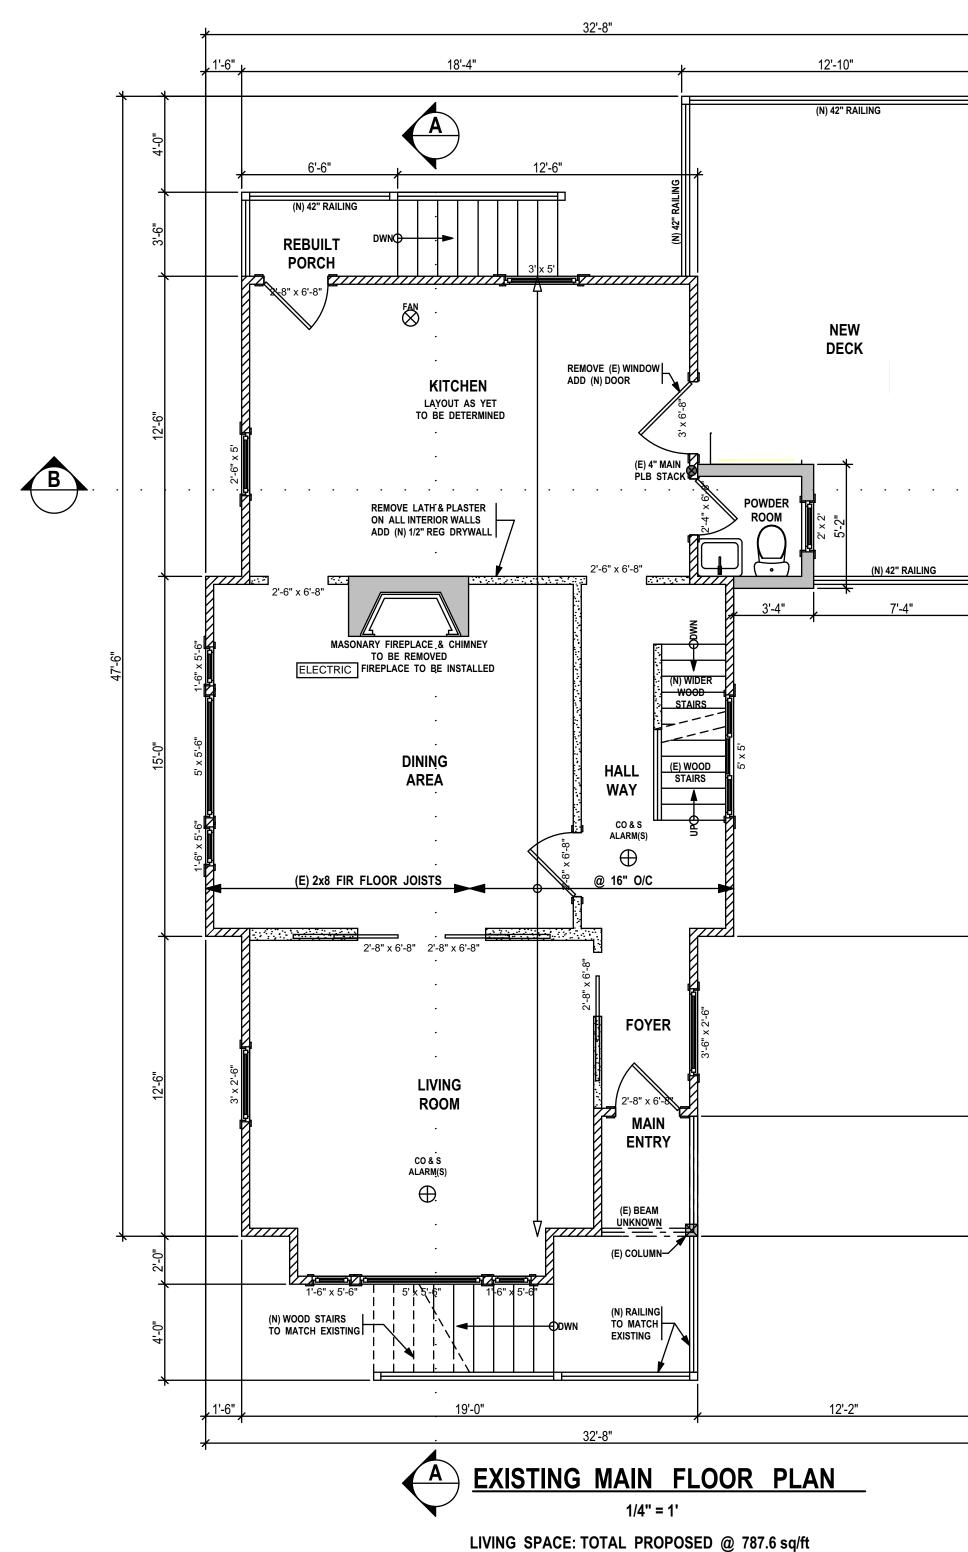


TAKEN FROM I/S FACE OF EXTERIOR WALL TO I/S FACE OF EXTERIOR WALL



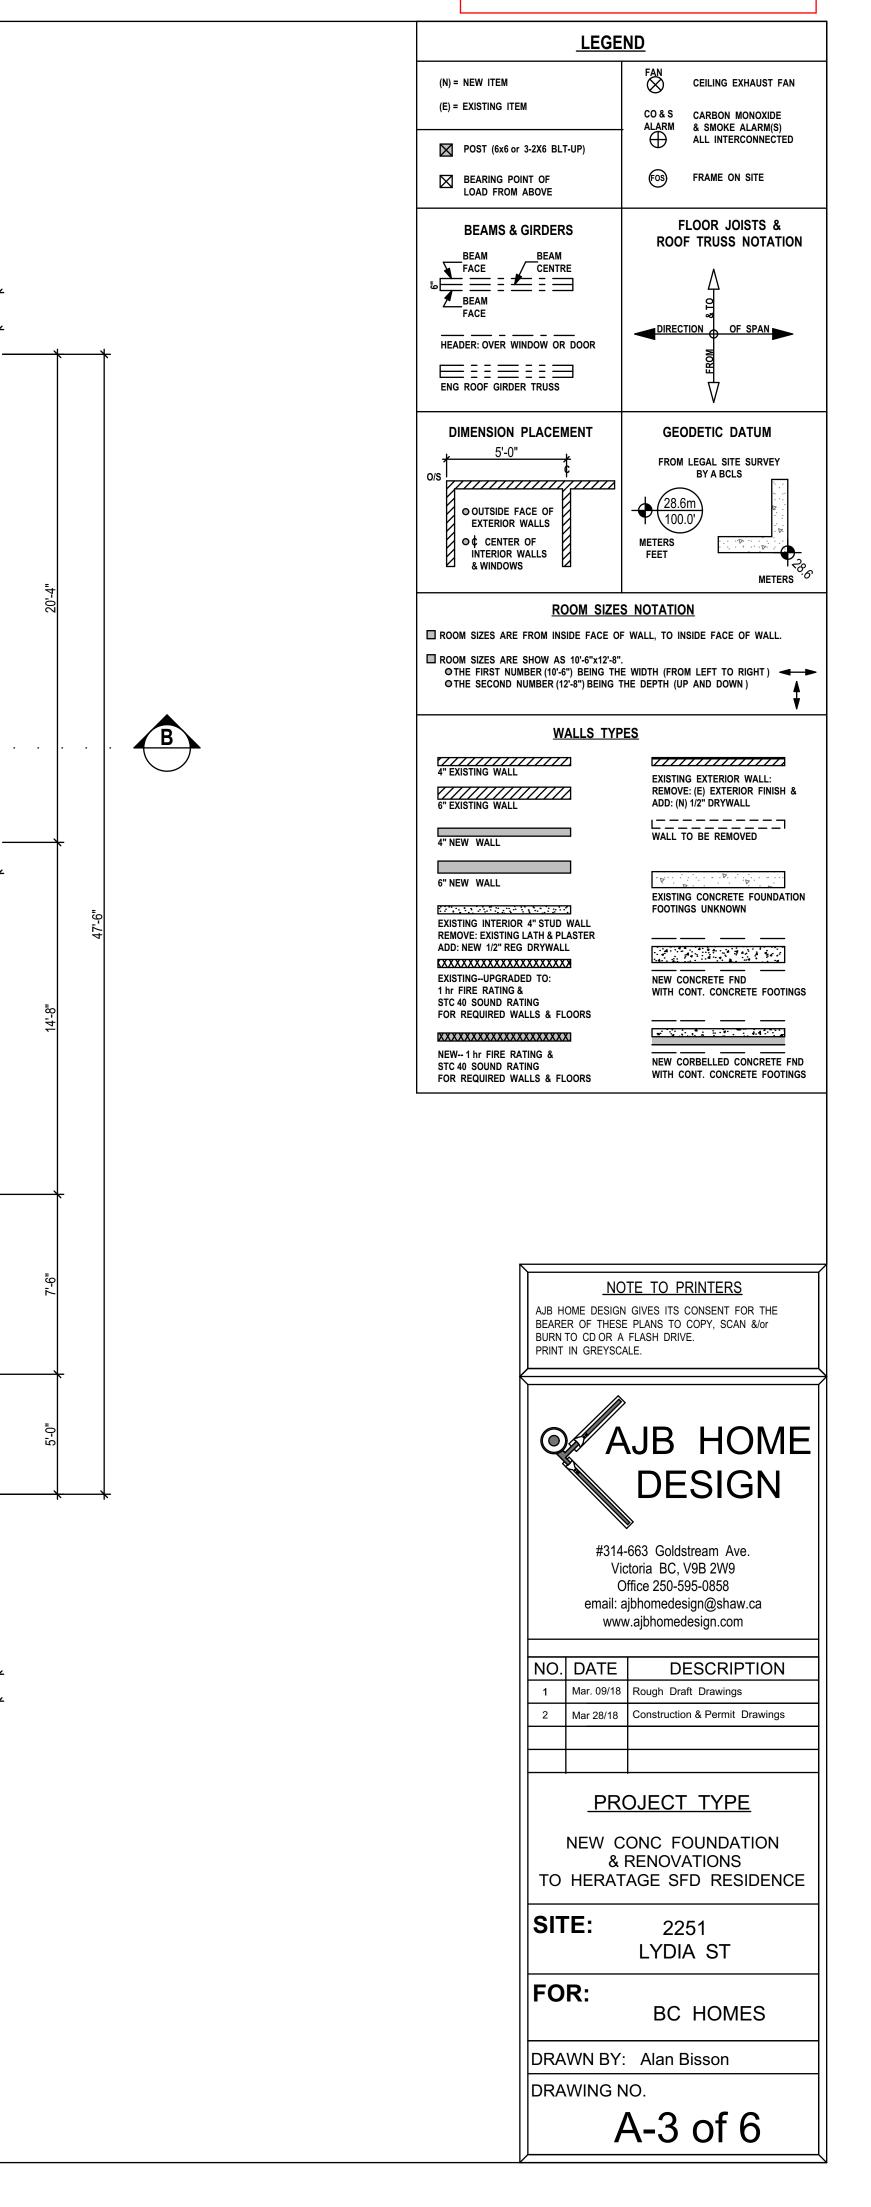


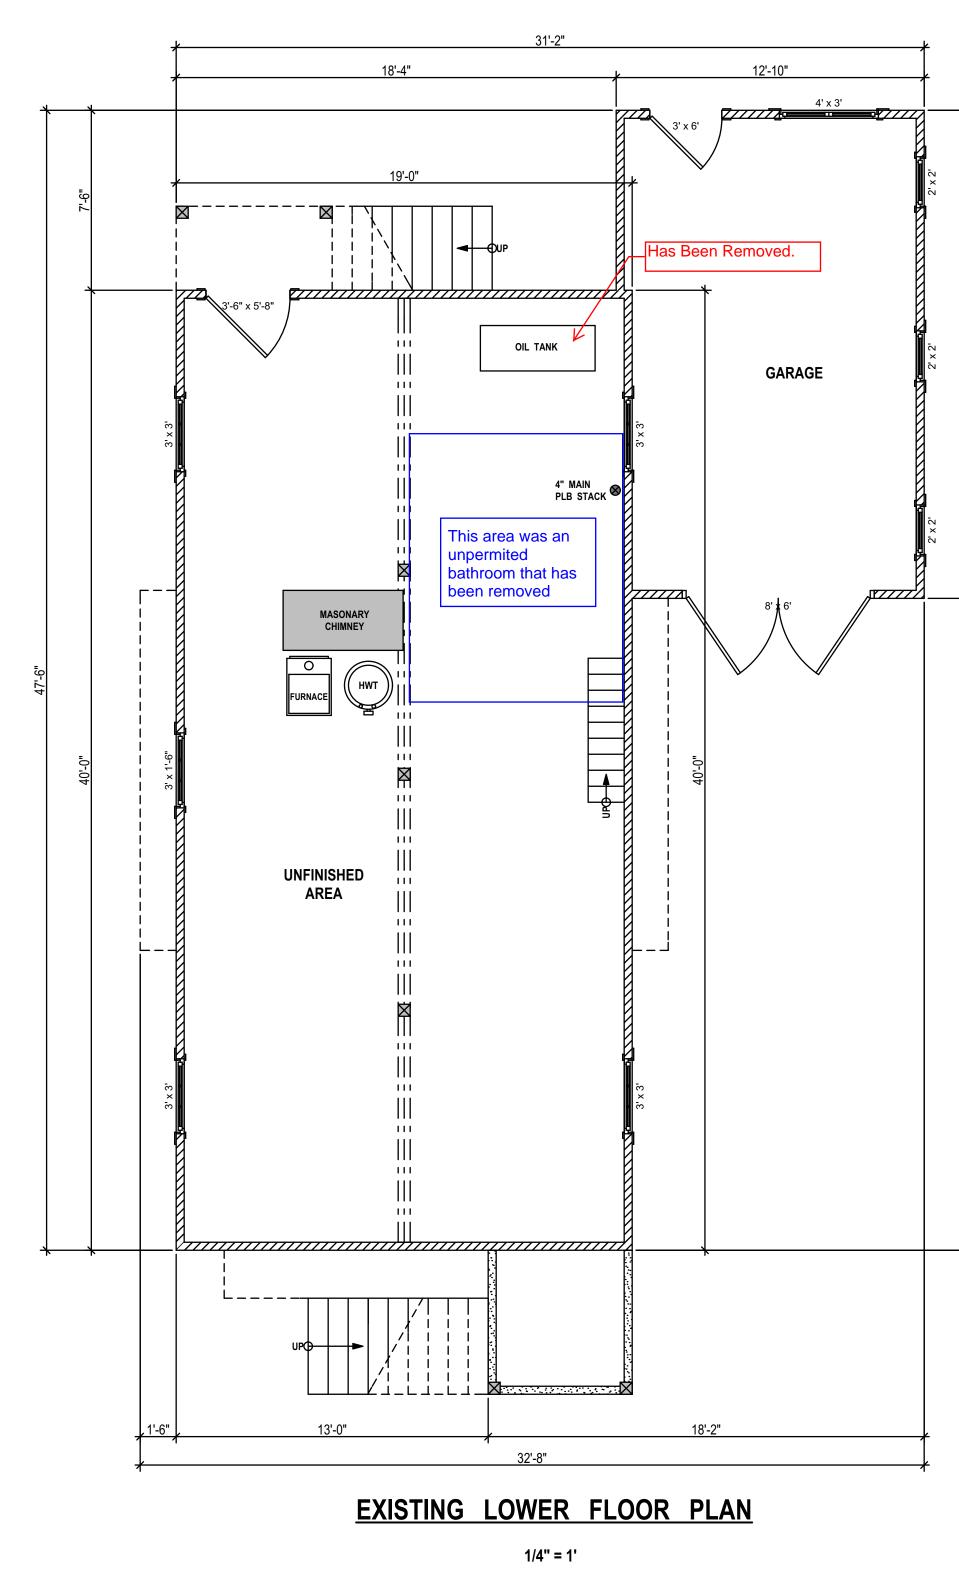


LIVING SPACE: TOTAL PROPOSED @ 721.1 sq/ft TAKEN FROM I/S FACE OF EXTERIOR WALL TO I/S FACE OF EXTERIOR WALL

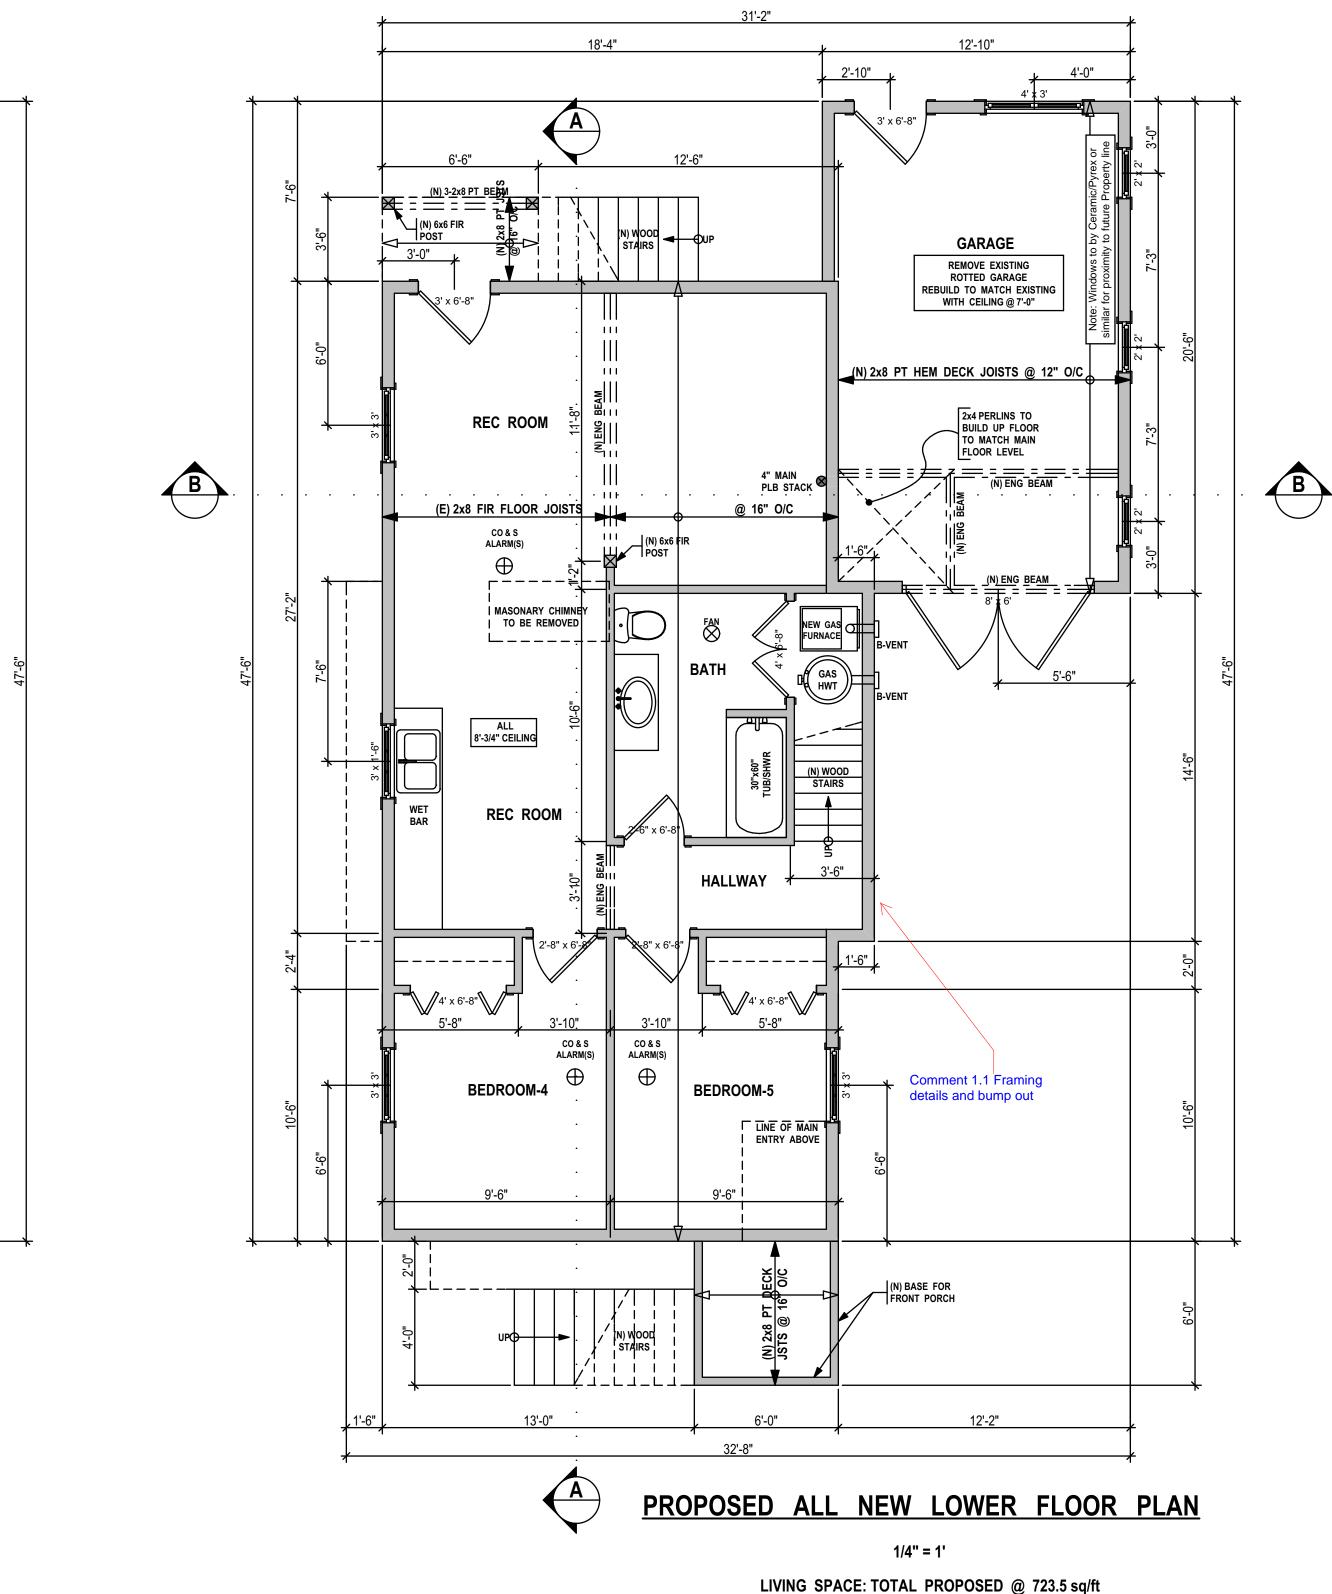

TAKEN FROM I/S FACE OF EXTERIOR WALL TO I/S FACE OF EXTERIOR WALL Comment 1.3 label all roomns

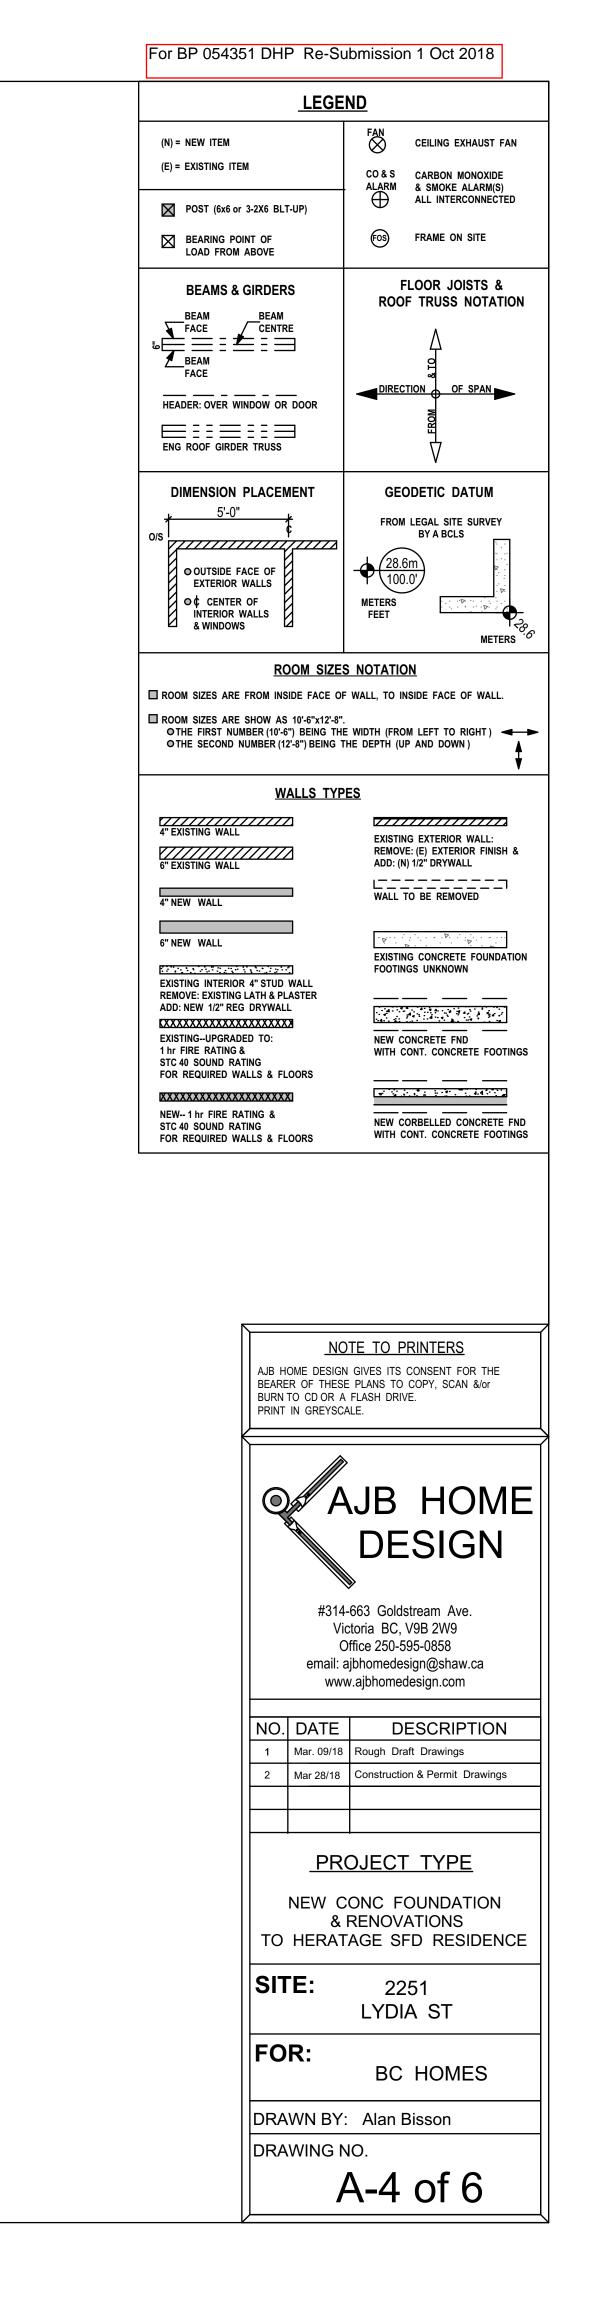

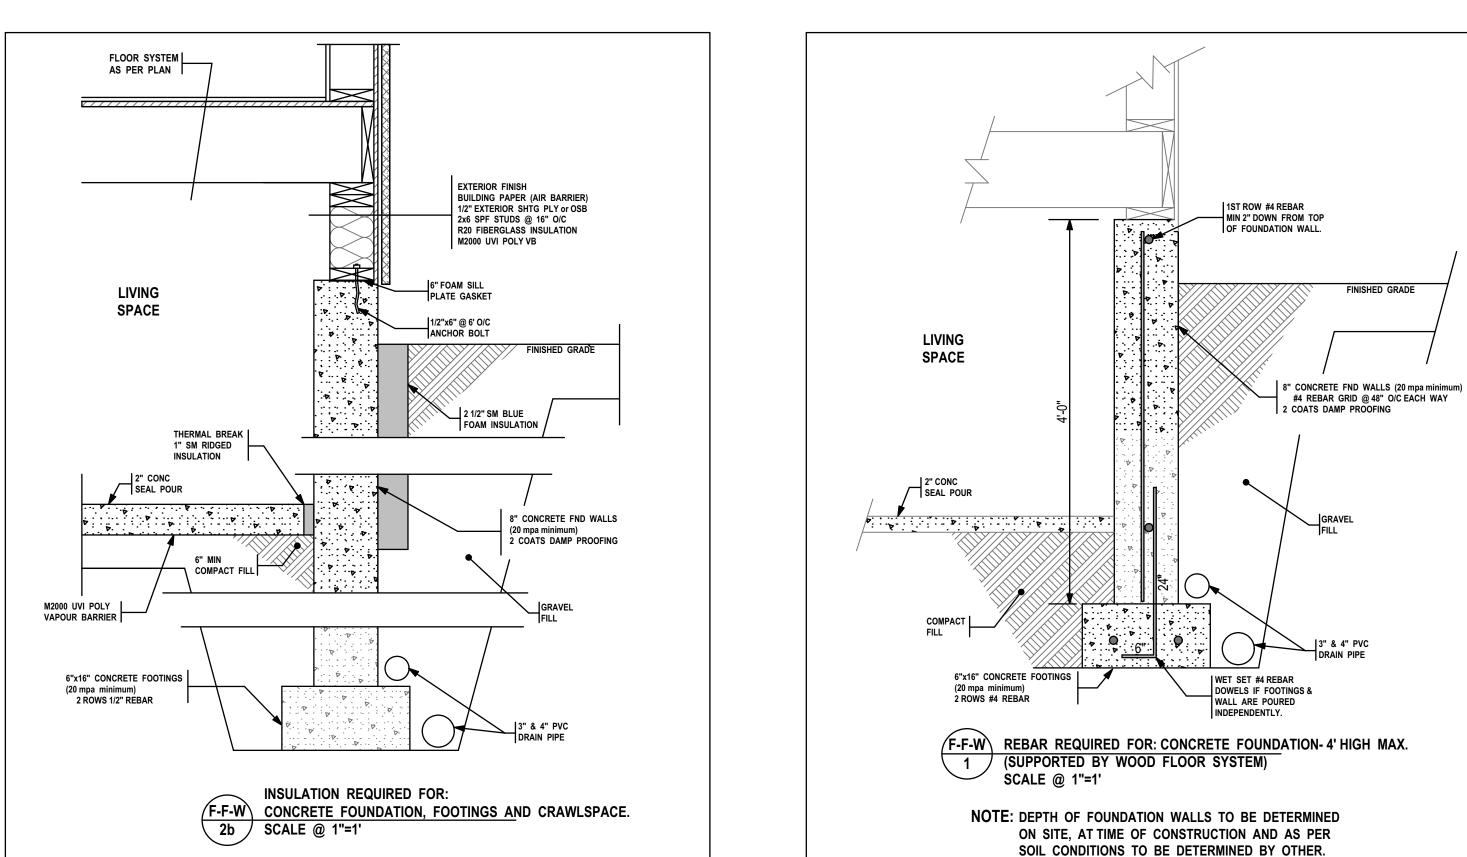

SKYLINE DETAILS GOVERN

