

Councillor Alto withdrew from the meeting at 4:44 p.m. due to a pecuniary conflict of interest as they own property near the next item.

Councillor Andrew withdrew from the meeting at 4:44 p.m. due to a pecuniary conflict of interest as they own property near the next item.

F.2 Bylaws for 3120 Washington Avenue: Rezoning Application No. 00735

Moved By Councillor Potts

Seconded By Councillor Isitt

That the following bylaw **be given first and second readings:**

1. Zoning Regulation Bylaw, Amendment Bylaw (No. 1246) No. 21-020

CARRIED UNANIMOUSLY

Moved By Councillor Dubow

Seconded By Councillor Thornton-Joe

That the following bylaw **be given first, second and third readings:**

1. Housing Agreement (3120 Washington Avenue) Bylaw (2021) No. 21-021

CARRIED UNANIMOUSLY



Council Report For the Meeting of April 8, 2021

To: Council **Date:** March 25, 2021
From: Karen Hoese, Director, Sustainable Planning and Community Development
Subject: Update Report for Rezoning Application No. 00735 for 3120 Washington Avenue

RECOMMENDATION

That Council give first and second reading of the Zoning Regulation Bylaw Amendment No. 21-020 (Amendment No. 1246) and give first, second and third readings to Housing Agreement (3120 Washington Avenue) Bylaw No. 21-021.

EXECUTIVE SUMMARY

The purpose of this report is to present Council with an update regarding the Rezoning Application for the property located at 3120 Washington Avenue. The proposal is to rezone from the R1-B Zone, Single-Family Dwelling District, to a new zone in order to increase the density and construct a strata development consisting of eight, two-storey single-family dwelling units on a lot.

On January 7, 2021, Council passed the following resolution:

That Council instruct staff to prepare the necessary Zoning Regulation Bylaw Amendment that would authorize the proposed development outlined in Rezoning Application No. 00735 for 3120 Washington Avenue, that first and second reading of the Zoning Regulation Bylaw Amendment be considered by Council and a Public Hearing date be set once the following conditions are met:

- a. Preparation of legal agreements executed by the applicant to secure the following, with form satisfactory to the City Solicitor:
 - i. a housing agreement to ensure that future Strata bylaws cannot prohibit the rental of dwelling units, to the satisfaction of the Director of Sustainable Planning and Community Development;*
 - ii. a statutory right-of-way of 1.00m on Washington Avenue for sidewalk improvements, to the satisfaction of the Director of Engineering and Public Works;*
 - iii. the design of the proposed eight single-family dwelling units and associated landscaping in accordance with the plans dated October 13, 2020, to the satisfaction of the Director of Sustainable Planning and Community Development.*
 - iv. Further consideration by the developer of options to increase the rear setback.**

COMMENTS

Rear Yard Setback

Council requested that the applicant consider options to increase the rear yard setback of single-family dwelling unit #2 (SFD 2), which is situated in the northwest corner of the site and with its front facade adjacent to a bylaw-protected Garry oak tree which is planned to be retained. The original rear yard setback of SFD 2 was 3.31m to minimize disturbances to the tree. However, in response to Council's motion, the applicant consulted with the Project Arborist and determined that SFD 2 could be shifted slightly to increase the setback from 3.31m to 4.84m and align with single family dwelling unit #1 (SFD 1). This has resulted in a small portion of the building to be located within the critical root zone of the existing Garry oak tree. To minimize the disturbance to the ground and tree roots in the area, the Certified Arborist has recommended an alternative construction method, which will result in the northeast corner of the building being constructed on a grade beam system. The applicant has also shifted the parking space for SFD 2, modified the patio and adjusted the landscape irrigation system to mitigate impacts to the tree.

Even though the applicant has revised the plans to address Council's motion and taken measures to mitigate impacts to the Garry oak tree, a situation may arise during construction where the applicant may have to shift SFD 2 slightly back to further protect the tree. To allow for this to occur and avoid a setback variance in the future, it is recommended that the rear yard setback in the new zone remain as 3.31m. However, the revised plans with the new rear yard setback of 4.84m are attached to the design covenant registered on title, which ensures that any proposed adjustments to the site layout in order to protect the tree would have to be to the satisfaction of the Director of Sustainable Planning and Community Development.

Public Hearing Conditions

With regard to the pre-conditions that Council set in relation to this application, the following legal agreements have been executed by the applicant:

- a Housing Agreement to ensure that future strata bylaws do not prohibit the rental of dwelling units
- a 1.00m statutory right-of-way (SRW) on Washington Avenue
- a Section 219 Covenant to secure the design of the proposed eight single-family dwelling units and associated landscaping, which references updated plans.

The recommendation provided for Council's consideration contains the appropriate language to advance this application to a Public Hearing.

Respectfully submitted,


Leanne Taylor
Senior Planner
Development Services Division

Karen Hoese, Director
Sustainable Planning and Community
Development Department


Report accepted and recommended by the City Manager.

List of Attachments


- Attachment A: Updated Plans date stamped March 2, 2021
- Attachment B: Updated Arborist Report dated January 21, 2021.

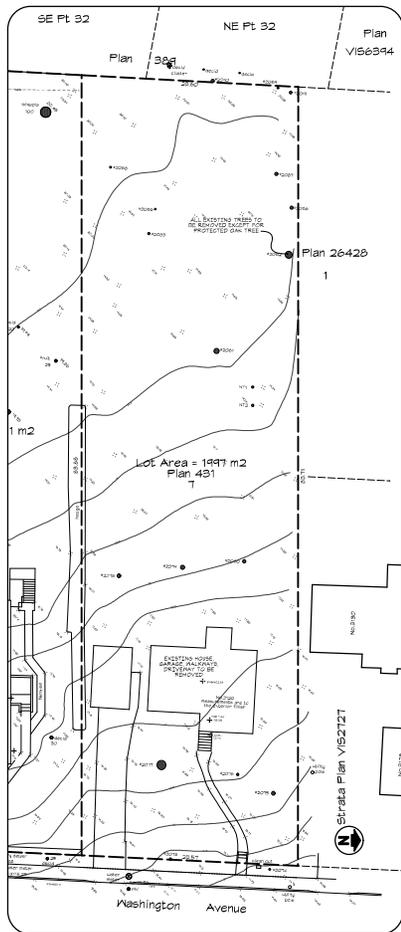

SITE PLAN - EXISTING
Scale: 1:250

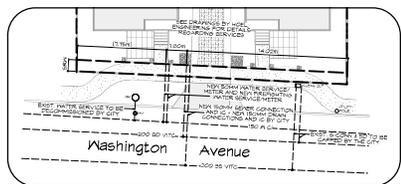

SITE PLAN - SERVICES
Scale: 1:200

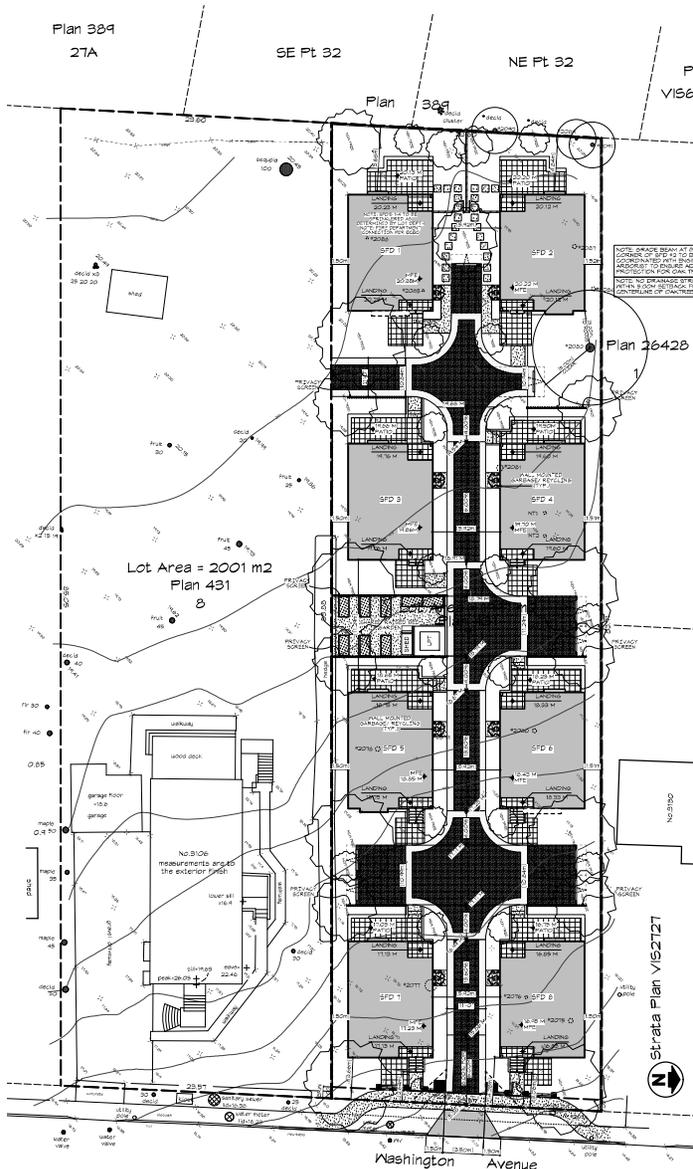

SITE PLAN - PROPOSED
Scale: 1:200

SITE DATA - 3120 WASHINGTON AVE, VICTORIA					
LEGAL DESCRIPTION - Lot 7, Section 7A, Victoria District, Plan 431					
EXISTING ZONING - R1B					
PROPOSED ZONING - SITE SPECIFIC					
	PROPOSED - SITE	PROPOSED - SFD 1	PROPOSED - SFD 2	PROPOSED - SFD 3	PROPOSED - SFD 4
LOT AREA	1997.69 M2 (21502.33 FT2)				
LOT WIDTH	23.54 M (77.23')				
LOT DEPTH (AVG.)	84.80 M (278.20')				
SETBACKS					
FRONT (F)	10.24 M (33.61') TO SPD 1	10.24 M (33.61') TO SPD 1	10.24 M (33.61') TO SPD 1	11.24 M (37.04') TO SPD 1	11.24 M (37.04') TO SPD 1
REAR (R)	9.83 M (32.24')	9.83 M (32.24')	9.83 M (32.24')	12.83 M (42.08')	12.83 M (42.08')
SIDE (S)	1.50 M (4.92')	1.50 M (4.92')	1.50 M (4.92')	1.50 M (4.92')	1.50 M (4.92')
SIDE (N)	9.42 M (31.07')	9.42 M (31.07')	9.42 M (31.07')	9.42 M (31.07')	9.42 M (31.07')
SIDE (SOUTH)	1.51 M (4.94')	1.51 M (4.94')	1.51 M (4.94')	1.51 M (4.94')	1.51 M (4.94')
AVG. SETBACK	14.96 M (49.08 FT)	14.96 M (49.08 FT)	14.96 M (49.08 FT)	14.96 M (49.08 FT)	14.96 M (49.08 FT)
BUILDING HEIGHT	6.66 M (21.85 FT)	6.66 M (21.85 FT)	6.66 M (21.85 FT)	6.66 M (21.85 FT)	6.66 M (21.85 FT)
STORIES	2 STOREYS	2 STOREYS	2 STOREYS	2 STOREYS	2 STOREYS
FLOOR AREA					
UPPER FLOOR	546.28 M2 (5860.24 FT2)	61.26 M2 (664.51 FT2)			
MAIN FLOOR	485.36 M2 (5248.64 FT2)	61.73 M2 (668.51 FT2)			
GRANSPACE INCLUDED	424.16 M2 (4569.62 FT2) EXCLUDED	53.02 M2 (570.75 FT2) EXCLUDED			
TOTAL FLOOR AREA	1045.11 M2 (11250.12 FT2)	131.02 M2 (1410.28 FT2)			
FLOOR AREA RATIO	0.523	0.666	0.666	0.666	0.666
SITE COVERAGE	30.32 % (605.66 M2)	3.80 % (75.11 M2)	3.78 % (74.78 M2)	3.74 % (74.78 M2)	3.75 % (75.01 M2)
OPEN SITE SPACE	40.26% (804.08 M2)				
PARKING	3 SPACES	1 SPACE	1 SPACE	1 SPACE	1 SPACE
LOT AREA		PROPOSED - SFD 5	PROPOSED - SFD 6	PROPOSED - SFD 7	PROPOSED - SFD 8
LOT WIDTH					
LOT DEPTH (AVG.)					
SETBACKS					
FRONT (F)		10.49 M (34.43')	10.24 M (33.61')	2.64 M (8.66')	3.06 M (10.04')
REAR (R)		11.24 M (37.04')	11.24 M (37.04')	10.49 M (34.43')	10.49 M (34.43')
SIDE (S)		1.50 M (4.92')	1.50 M (4.92')	1.50 M (4.92')	1.50 M (4.92')
SIDE (N)		9.42 M (31.07')	9.42 M (31.07')	9.42 M (31.07')	9.42 M (31.07')
SIDE (SOUTH)		1.51 M (4.94')	1.51 M (4.94')	1.51 M (4.94')	1.51 M (4.94')
AVG. SETBACK		11.76 M (38.58 FT)	11.76 M (38.58 FT)	10.49 M (34.43 FT)	10.49 M (34.43 FT)
BUILDING HEIGHT		2 STOREYS	2 STOREYS	2 STOREYS	2 STOREYS
STORIES		2 STOREYS	2 STOREYS	2 STOREYS	2 STOREYS
FLOOR AREA					
UPPER FLOOR		61.26 M2 (664.51 FT2)			
MAIN FLOOR		61.73 M2 (668.51 FT2)			
GRANSPACE INCLUDED		53.02 M2 (570.75 FT2) EXCLUDED			
TOTAL FLOOR AREA		131.02 M2 (1410.28 FT2)			
FLOOR AREA RATIO		0.666	0.666	0.666	0.666
SITE COVERAGE		3.82 % (76.41 M2)	3.86 % (77.16 M2)	3.78 % (75.68 M2)	3.75 % (75.01 M2)
OPEN SITE SPACE		1 SPACE	1 SPACE	1 SPACE	1 SPACE



LOCATION MAP
Scale: 1/8" = 1'-0"

DRAWING LIST:

DP01	SITE PLAN 4 DATA	DP08	SFD-5
DP02	AVERAGE GRADE	DP09	SFD-6
DP03	AVERAGE GRADE	DP10	SFD-7
DP04	SFD-1	DP11	SFD-8
DP05	SFD-2	DP12	STREETSCAPE
DP06	SFD-3	DP13	COLOUR BOARD
DP07	SFD-4	L1-3	LANDSCAPE

REV. NO.	DESCRIPTION	DATE
4	1. FIRE DEPARTMENT CONNECTION PER 2. SFD 10. GRANSPACE AREA REVISED IN SITE DATA TABLE	MAR 2/21

RE-ISSUED FOR DP
MAR 02, 2021





1161 NEWPORT AVE
Victoria, B.C. V8S 5E6
Phone: (250) 360-2144
Fax: (250) 360-2115

Drawn By: C.C.
Date: JUNE 24, 2020
Scale: AS NOTED
Project:
3120 WASHINGTON
AVENUE - REZONING

Title:
SITE PLAN & DATA



Revision:
Rev 1:
Rev 2:
Rev 3:
Rev 887:
Rev 888

SFD 1 - Average Grade Calculation							
SEGMENT	Start	Finish	Average	Distance	Factor	Total Factors	Average grade (total factors / perimeter)
AB	19.92	20.13	20.03	10.16	203.45	710.38	19.977
BC	20.13	20.04	20.09	7.42	149.03		
CD	20.04	19.83	19.94	10.16	202.54		
DE	19.83	19.84	19.84	0.89	17.65		
EF	19.84	19.84	19.84	0.20	3.97		
FG	19.84	19.84	19.84	1.22	24.20		
GH	19.84	19.84	19.84	0.20	3.97		
HA	19.84	19.92	19.88	5.31	105.56		
						AVERAGE GRADE	
						TOTAL	19.88

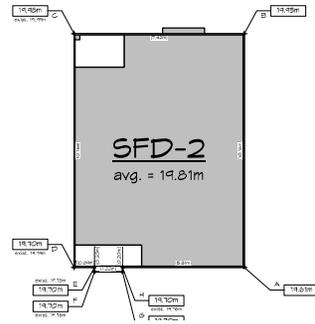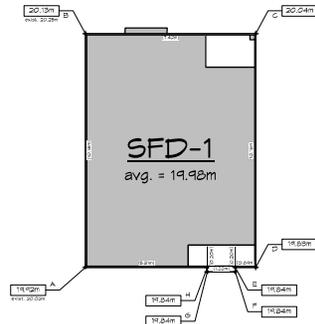

SFD 2 - Average Grade Calculation							
SEGMENT	Start	Finish	Average	Distance	Factor	Total Factors	Average grade (total factors / perimeter)
AB	19.61	19.95	19.78	10.16	200.96	704.49	19.811
BC	19.95	19.98	19.97	7.42	146.14		
CD	19.98	19.70	19.84	10.16	201.57		
DE	19.70	19.70	19.70	0.89	17.53		
EF	19.70	19.70	19.70	0.20	3.94		
FG	19.70	19.70	19.70	1.22	24.03		
GH	19.70	19.70	19.70	0.20	3.94		
HA	19.70	19.61	19.66	5.31	104.37		
						AVERAGE GRADE	
						TOTAL	19.81

SFD 3 - Average Grade Calculation							
SEGMENT	Start	Finish	Average	Distance	Factor	Total Factors	Average grade (total factors / perimeter)
AB	19.31	19.64	19.48	10.16	197.87	701.65	19.447
BC	19.64	19.64	19.64	7.42	145.73		
CD	19.64	19.20	19.42	10.16	197.31		
DE	19.20	19.23	19.22	0.89	17.10		
EF	19.23	19.20	19.22	0.46	8.84		
FG	19.20	19.26	19.23	1.22	23.46		
GH	19.26	19.29	19.28	0.46	8.87		
HA	19.29	19.31	19.30	5.31	102.48		
						AVERAGE GRADE	
						TOTAL	19.45

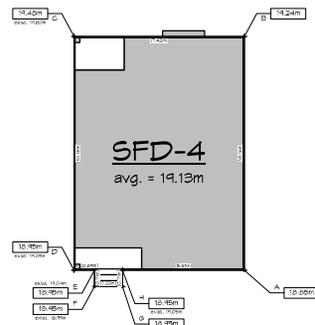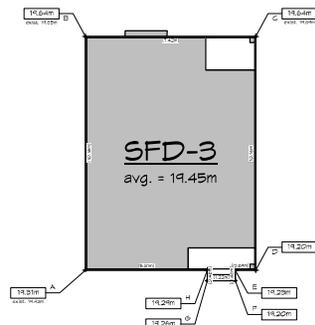

SFD 4 - Average Grade Calculation							
SEGMENT	Start	Finish	Average	Distance	Factor	Total Factors	Average grade (total factors / perimeter)
AB	18.85	19.24	19.05	10.16	193.50	699.85	19.132
BC	19.24	18.48	18.36	7.42	143.65		
CD	18.48	18.95	19.22	10.16	195.22		
DE	18.95	18.95	18.95	5.31	100.82		
EF	18.95	18.95	18.95	0.71	13.45		
FG	18.95	18.95	18.95	1.22	23.12		
GH	18.95	18.95	18.95	0.71	13.45		
HA	18.95	18.85	18.90	0.89	16.82		
						AVERAGE GRADE	
						TOTAL	19.13

RE-ISSUED FOR DP
MAR 02, 2021



1161 NEWPORT AVE
Victoria, B.C. V8S 5E6
Phone: (250) 360-2144
Fax: (250) 360-2115

Drawn By: C.C.

Date: JUNE 24, 2020

Scale: AS NOTED



Project:
3120 WASHINGTON
AVENUE - REZONING

Title:
AVERAGE GRADE

Revision: Rev 1: Rev 2: Rev 3: Rev 4: Rev 5: Rev 6: Rev 7: Rev 8: Rev 9: Rev 10: Rev 11: Rev 12: Rev 13: Rev 14: Rev 15: Rev 16: Rev 17: Rev 18: Rev 19: Rev 20: Rev 21: Rev 22: Rev 23: Rev 24: Rev 25: Rev 26: Rev 27: Rev 28: Rev 29: Rev 30: Rev 31: Rev 32: Rev 33: Rev 34: Rev 35: Rev 36: Rev 37: Rev 38: Rev 39: Rev 40: Rev 41: Rev 42: Rev 43: Rev 44: Rev 45: Rev 46: Rev 47: Rev 48: Rev 49: Rev 50: Rev 51: Rev 52: Rev 53: Rev 54: Rev 55: Rev 56: Rev 57: Rev 58: Rev 59: Rev 60: Rev 61: Rev 62: Rev 63: Rev 64: Rev 65: Rev 66: Rev 67: Rev 68: Rev 69: Rev 70: Rev 71: Rev 72: Rev 73: Rev 74: Rev 75: Rev 76: Rev 77: Rev 78: Rev 79: Rev 80: Rev 81: Rev 82: Rev 83: Rev 84: Rev 85: Rev 86: Rev 87: Rev 88: Rev 89: Rev 90: Rev 91: Rev 92: Rev 93: Rev 94: Rev 95: Rev 96: Rev 97: Rev 98: Rev 99: Rev 100:	Sheet: DF02 Proj. No. #####
---	--



REV. NO.	DESCRIPTION	DATE
4	NO CHANGES	MAR 2/21

SFD 5 - Average Grade Calculation								
SEGMENT	Start	Finish	Average	Distance	Factor	Total Factors	Average grade (total factors / perimeter)	
AB	17.63	18.63	18.13	10.16	184.20	675.28	17.960	
BC	18.63	19.42	18.53	7.42	137.46			
CD	18.42	17.37	17.90	10.16	181.81			
DE	17.37	17.34	17.36	0.89	15.45			
EF	17.34	17.28	17.31	1.22	21.12			
FG	17.28	17.31	17.30	1.22	21.10			
GH	17.31	17.39	17.35	1.22	21.17			
HA	17.39	17.63	17.51	5.31	92.98			
AVERAGE GRADE								
TOTAL						37.60	675.28	17.96

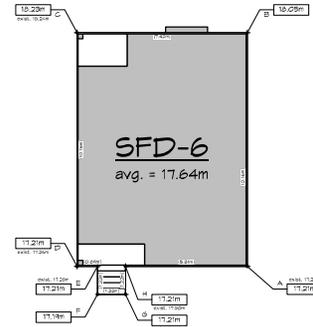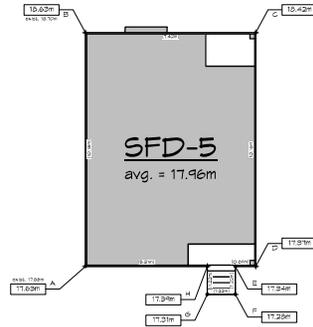

SFD 6 - Average Grade Calculation								
SEGMENT	Start	Finish	Average	Distance	Factor	Total Factors	Average grade (total factors / perimeter)	
AB	17.21	18.05	17.63	10.16	179.12	663.42	17.644	
BC	18.05	18.23	18.14	7.42	134.60			
CD	18.23	17.21	17.72	10.16	180.04			
DE	17.21	17.21	17.21	5.31	91.39			
EF	17.21	17.19	17.20	1.22	20.98			
FG	17.19	17.21	17.20	1.22	20.98			
GH	17.21	17.21	17.21	1.22	21.00			
HA	17.21	17.21	17.21	0.89	15.32			
AVERAGE GRADE								
TOTAL						37.60	663.42	17.64

SFD 7 - Average Grade Calculation								
SEGMENT	Start	Finish	Average	Distance	Factor	Total Factors	Average grade (total factors / perimeter)	
AB	16.01	16.99	16.50	10.16	167.64	617.60	16.431	
BC	16.99	16.85	16.92	7.42	125.55			
CD	16.85	16.01	16.43	10.16	166.93			
DE	16.01	16.01	16.01	0.89	14.25			
EF	16.01	15.90	15.96	1.22	19.47			
FG	15.90	15.98	15.94	1.22	19.45			
GH	15.98	16.01	16.00	1.22	19.51			
HA	16.01	16.01	16.01	5.31	85.01			
AVERAGE GRADE								
TOTAL						37.60	617.60	16.43

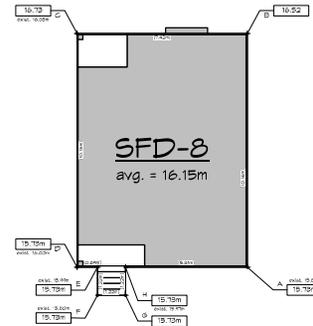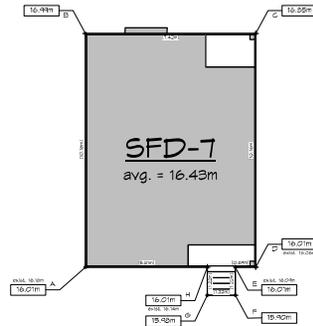

SFD 8 - Average Grade Calculation								
SEGMENT	Start	Finish	Average	Distance	Factor	Total Factors	Average grade (total factors / perimeter)	
AB	15.73	16.52	16.15	10.16	163.83	607.18	16.148	
BC	16.52	16.73	16.63	7.42	123.36			
CD	16.73	16.23	16.23	10.16	164.90			
DE	15.73	15.73	15.73	0.89	14.00			
EF	15.73	15.73	15.73	1.22	19.19			
FG	15.73	15.73	15.73	1.22	19.19			
GH	15.73	15.73	15.73	1.22	19.19			
HA	15.73	15.73	15.73	5.31	83.53			
AVERAGE GRADE								
TOTAL						37.60	607.18	16.15

RE-ISSUED FOR DP
MAR 02, 2021



1161 NEWPORT AVE
Victoria, B.C. V8S 5E6
Phone: (250) 360-2144
Fax: (250) 360-2115

Drawn By: C.C.

Date: JUNE 24, 2020

Scale: AS NOTED

Project:
3120 WASHINGTON
AVENUE - REZONING

Title:
AVERAGE GRADE

Revision:	Sheet:
Rev 1: Rev 2: Rev 3: Rev 4: Rev 5: Rev 6: Rev 7: Rev 8: Rev 9: Rev 10:	DFO3
Proj. No. 0000	

REV. NO.	DESCRIPTION	DATE
4	NO CHANGES	MAR 2/21

SFD 6

MAXIMUM GLAZING CALCULATION	
DISTANCE TO PROPERTY LINE	5.42 M (17.78')
EXPOSED BUILDING FACE AREA	44.41 M ² (532.50 SF)
GLAZING AREA	5.85 M ² (63.00 SF)
PERCENTAGE	11.82% (ALLOWED 48.54%)


MAXIMUM GLAZING CALCULATION	
DISTANCE TO PROPERTY LINE	1.50 M (4.92')
EXPOSED BUILDING FACE AREA	62.98 M ² (678.00 SF)
GLAZING AREA	1.34 M ² (15.00 SF)
PERCENTAGE	2.20% (ALLOWED 8.00%)

MAXIMUM GLAZING CALCULATION	
DISTANCE TO PROPERTY LINE	5.64 M (18.52')
EXPOSED BUILDING FACE AREA	42.11 M ² (454.00 SF)
GLAZING AREA	5.66 M ² (61.00 SF)
PERCENTAGE	13.42% (ALLOWED 51.78%)


MAXIMUM GLAZING CALCULATION	
DISTANCE TO PROPERTY LINE	2.96 M (9.71')
EXPOSED BUILDING FACE AREA	62.98 M ² (678.00 SF)
GLAZING AREA	3.34 M ² (36.00 SF)
PERCENTAGE	5.30% (ALLOWED 19.32%)




FRONT (E) ELEVATION
Scale: 1:100

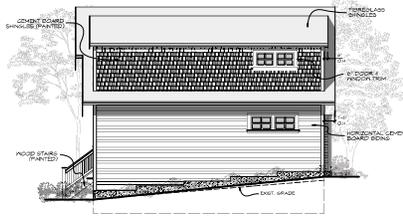


SIDE (N) ELEVATION
Scale: 1:100

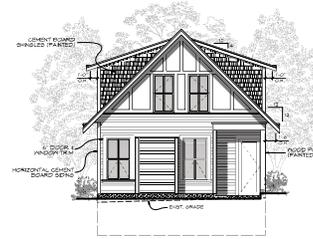


REAR (W) ELEVATION
Scale: 1:100

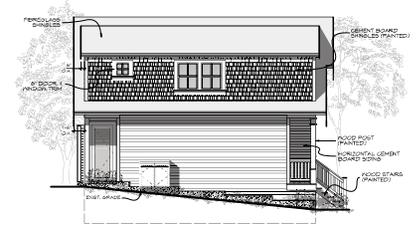


SIDE (S) ELEVATION
Scale: 1:100

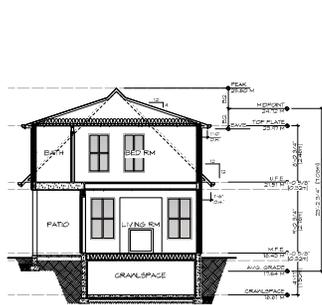


SECTION
Scale: 1:100

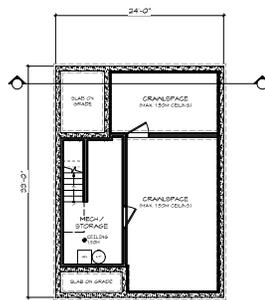


GRAWLSPACE
Scale: 1:100

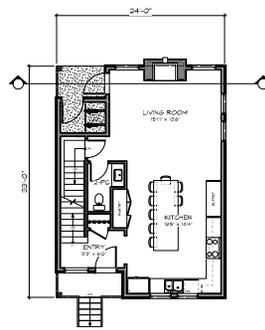

MAIN FLOOR
Scale: 1:100

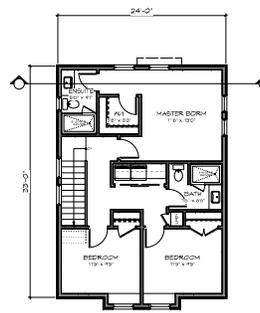

UPPER FLOOR
Scale: 1:100

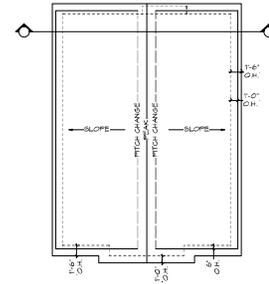

ROOF PLAN
Scale: 1:100

SFD 6

RE-ISSUED FOR DP
MAR 02, 2021

ZEBRADESIGN

1161 NEWPORT AVE
Victoria, B.C. V8S 5E6
Phone: (250) 360-2144
Fax: (250) 360-2115

Drawn By: C.C.

Date: JUNE 24, 2020

Scale: AS NOTED

Project:
3120 WASHINGTON
AVENUE - REZONING

Title:
FLOOR PLANS &
ELEVATIONS -
SFD 6

Revision: Rev 1: 2/2/20
Rev 2: 2/15/20
Rev 3: 2/15/20
Rev 4: 2/21/21
Rev 5: 2/21/21

Sheet:

DF09

Proj.No. 0000

REV. NO.	DESCRIPTION	DATE
4	10 - GLAZING CALCULATION ADDED TO ELEVATIONS	MAR 2/21



NO. 3106

NO. 3120

NO. 3128

STREETSCAPE
Scale: 1:85

RE-ISSUED FOR DP
MAR 02, 2021

ZEBRADESIGN



1161 NEWPORT AVE
Victoria, B.C. V8S 5E6
Phone: (250) 360-2144
Fax: (250) 360-2115

Drawn By: C.C.

Date: JUNE 24, 2020

Scale: AS NOTED

Project:
3120 WASHINGTON
AVENUE - REZONING

Title:
STREETSCAPE

Revision: Rev. 1: 2/1/20
Rev. 2: 2/1/20
Rev. 3: 3/1/21
Rev. 4: 3/2/21
Rev. 5: 3/2/21


Sheet:
DP12
Proj. No. 8888

REV. NO.	DESCRIPTION	DATE
4	NO CHANGES	MAR 2/21

FOR ALL RETAINED TREES, ADJACENT GRADES WILL BE RETAINED AT EXISTING ELEVATION.

RETAINED GARRY OAK TREE, REFER TO ARBORIST'S REPORT FOR ADDITIONAL INFORMATION AND PRESERVATION MEASURES.

No.3130

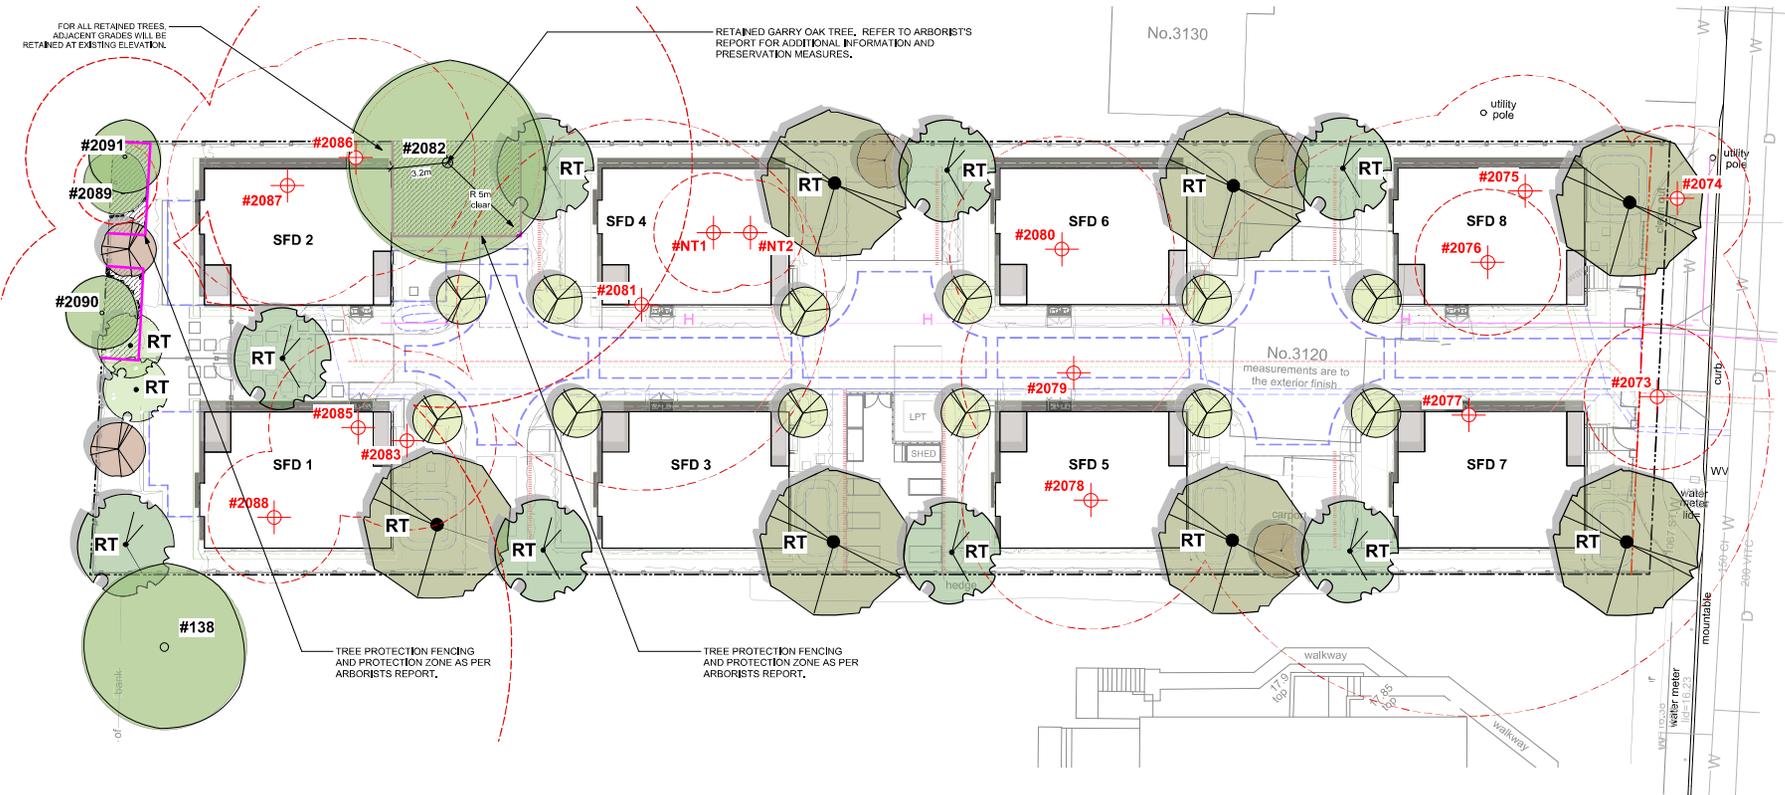

WASHINGTON AVE


NOT FOR CONSTRUCTION

TREE SUMMARY


BYLAW PROTECTED TREES REMOVED: 8
 REPLACEMENT TREES: 16
 TOTAL NEW TREES PROPOSED ONSITE: 34
 REPLACEMENT TREE RATIO = 2:1 AS PER CITY OF VICTORIA BYLAWS. REFER L3,01 PLANTING PLANS FOR ADDITIONAL INFORMATION.

TREES WILL BE OF THE APPROPRIATE SCALE, SPECIES AND LOCATION TO MEET THE CITY OF VICTORIA REQUIREMENTS. FINAL SPECIES TO BE DETERMINED IN CONSULTATION WITH CITY OF VICTORIA PARKS STAFF.

REFER TO ARBORIST'S REPORT & TREE INVENTORY FOR ADDITIONAL INFORMATION.

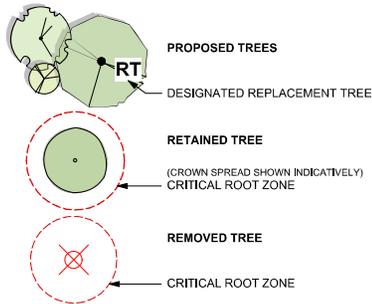

REFER TO ARBORIST'S REPORT FOR ADDITIONAL INFORMATION.

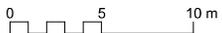

DRAWING NOTES

- DO NOT SCALE DRAWING: Verify all property lines and existing structures/vegetation to remain, prior to commencing work.
- All plan dimensions in metres and all detail dimensions in millimetres.
- Plant quantities on Plans shall take precedence over plant list quantities.
- Contractor to confirm location and elevation of all existing services and utilities prior to start of construction.
- Provide layout of all work for approval by Landscape Architect prior to proceeding with work.
- Contractor to provide irrigation system for all planters to current IABC Standards and Contract Specifications.
- Landscape installation to carry a 1 year warranty from date of acceptance.
- Plant material, installation and maintenance to conform to the current edition of the Canadian Landscape Standard.
- General Contractor and/or sub-contractors are responsible for all costs related to production and submission to consultant of all landscape as-built information including irrigation.
- Tree protection fencing, for existing trees, to be installed prior to commencement of all site work.

rev no	description	date
4	DP REV.3	25 JAN, 2021
3	DP REV.2	13 OCT, 2020
2	DP REV.1	30 JUNE 2020
1	DP	20 FEB, 2020

2272 MLLSTREAM ROAD VICTORIA BC V8M 1P1 Phone: 250.12081 250.12082


client
CUBE DEVELOPMENTS
 2272 MLLSTREAM ROAD
 VICTORIA, BC

project
 3120 WASHINGTON AVENUE
 DEVELOPMENT
 VICTORIA, BC

sheet title
**Tree Preservation
 Plan**

project no. 120403
 scale 1:125 @ 24"x36"
 drawn by MCI
 checked by SMIPGG

revision no. sheet no.
L1.02

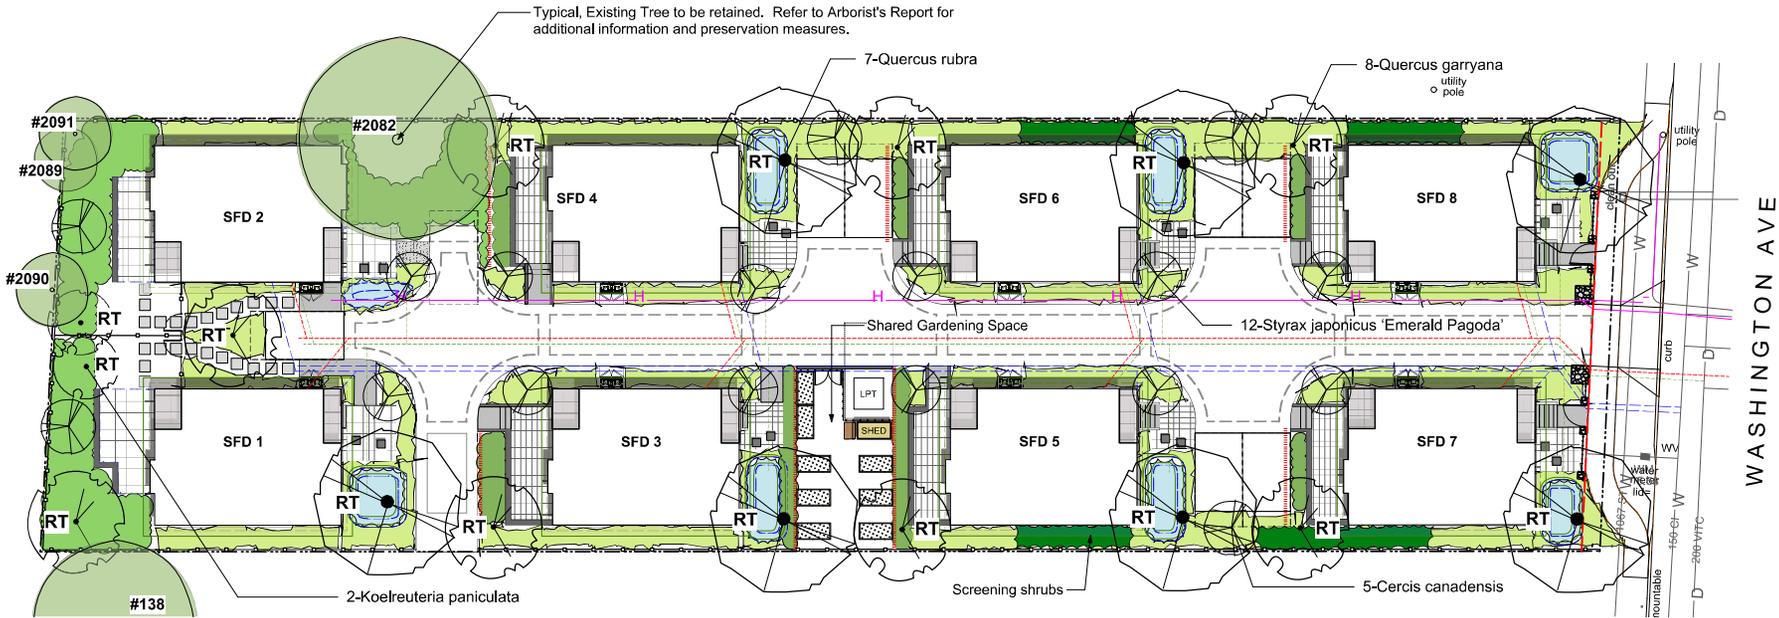

WASHINGTON AVE



NOT FOR CONSTRUCTION

rev no	description	date
4	DP REV.3	25 JAN, 2021
3	DP REV.2	13 OCT, 2020
2	DP REV.1	30 JUNE 2020
1	DP	20 FEB, 2020

LEGEND

----- Property line

PROPOSED VEGETATION

PLANT LIST	Sym	Qty	Botanical Name	Common Name	chcd, Size / Plant Spacing
TREES:					
5			<i>Cercis canadensis</i>	Eastern Redbud	5,0cm cal, b&b
2			<i>Koeleruteria paniculata</i>	Plumbed Oak/Berraintree	5,0cm cal, b&b
8			<i>Quercus garryana</i>	Garry Oak	5,0cm cal, b&b
7			<i>Quercus rubra</i>	Red Oak	6,0cm cal, b&b
12			<i>Styrax japonicus</i> 'Emerald Pagoda'	Japanese Snowbell	5,0cm cal, b&b
0					

Hedge Plantings
Hybrid Yew (*Taxus x media*)
Boxwood (*Buxus microphylla*)

Rain Garden Plantings
Total area approx. 77 sq m. Planting areas planted @ 2 x #3 pots / sq. m.

Recommended Species:
Privet honeysuckle (*Lonicera pileata*)
Carman's Grey Blue Rush (*Juncus patens* 'Carman's Grey')
Black-Eyed Susan (*Rudbeckia fulgida*)
Tall Verbena (*Verbena bonariensis*)
Crimson Flag (*Schizostylis coccinea* 'Oregon Sunset')

Naturalized Shrub Plantings
Total area approx. 90 sq m. Planting areas planted @ 1 x #5 pot OR 2 x #3 pots OR 3 x #1 pots / sq. m.

Recommended Species:
Sword fern (*Polystichum munitum*)
Oregon Grape (*Mahonia aquifolium*)
Salal (*Gaultheria shallon*)
Red Flowering Currant (*Ribes sanguineum*)
Nootka Rose (*Rosa nutkana*)
Snowberry (*Symphoricarpos albus*)
Evergreen huckleberry (*Vaccinium ovatum*)

Mixed Shrub and Perennial Plantings
Total area approx. 340 sq m. Planting areas planted @ 2 x #3 pots OR 3 x #1 pots / sq. m.

Recommended Species:
Rose Creek Abelia (*Abelia x chinensis* 'Rose Creek')
Glacier Azalea (*Azalea japonica* 'Glacier')
Beautyberry (*Callicarpa bodinieri* var. *giraldii* Profusion)
Sageleaf Rockrose (*Cistus salviniolus*)
Witchhazel (*Hamamelis mollis*)
Strawberry Tree (*Arbutus Unedo*)
Barrenwort (*Epimedium x rubrum*)
Newport Dwarf Escallonia (*Escallonia* 'Newport Dwarf')
Topiari'st's hebe (*Hebe topiana*)
Lily turf (*Liriope muscaris*)
Sword Fern (*Polystichum munitum*)
Soft Shield Fern (*Polystichum setiferum*)

RAIN WATER MANAGEMENT NOTES

Water collected from building roofs flow to the rain gardens located throughout the site or to permeable pavement in drive aisle.

The rain gardens are sized such that the bottom of the rain garden is a minimum of 5% of the impervious area. Rain gardens will be designed with underdrains and a high capacity overflow drain that will be connected to the onsite piped drainage system.

Permeable paving is used to manage onsite vehicular impervious surfaces. All paths and where possible, residential patios will be drained towards absorbent landscape areas or rain gardens.

PLANTING RATIONALE

The planting plan is designed to meet the City's Food-Bearing, Pollinator and Native Plant Landscape Design Guidelines and offers a variety of ornamental and amenity planting areas with native and appropriate non-native species that are adapted to site conditions, climate and design intent and provide pollinator habitat.

SHARED GARDENING SPACE

The site plan includes a shared gardening space that includes one raised gardening box per dwelling unit, a small shed and potting area.

GENERAL PLANTING NOTE

- Plant quantities and species may change between issuance of DP and Construction due to plant availability and design changes.

BOULEVARD NOTES


- Grass boulevard shall be in accordance with the Subdivision and Development Servicing Bylaw.
- Landscape within boulevard areas to be irrigated (unless otherwise indicated).
- Boulevard irrigation point of connection to be 10 mm service, refer to Civil drawings for location. Water meter and timer/controller, that is separate from building, to be provided at point of connection. Timer/controller for boulevard areas must be readily accessible to municipal staff.
- Design and installation of boulevard irrigation system to meet current IABC and Municipal Specifications.
- Design/build drawings for boulevard irrigation to be submitted to Landscape Architect in PDF and .dwg formats, at least two weeks prior to commencement of irrigation installation and will be reviewed by municipal staff.
- Boulevard irrigation to be inspected as per municipal specification by municipal staff. Boulevard irrigation system will be maintained and operated by municipality, after it is inspected and approved by municipal staff.

IRRIGATION AND LIGHTING NOTES

- Contractor to field fit irrigation system around existing trees, to limit disturbance to root systems.
- Sleeves shall be installed at the necessary depths, prior to pavement construction. Sleeving shall extend 300 mm from edge of paving into planting area, and shall have ends marked above grade unless otherwise shown on plan.
- Arborist to review (prior to installation) sleeving of irrigation lines in protected root zone (PRZ) of existing trees.
- Placement of electrical conduit through site to be coordinated with arborist.
- Arborist to be onsite and supervise all excavation/trenching within PRZ of retained trees.

ONSITE TREE PLANTING NOTES

- Trees are placed to avoid existing and proposed infrastructure. Trees planted within 1m of an underground service will have a root barrier installed between the root ball and the infrastructure. Final coordination of trees in relation to site servicing to be completed at the BP phase.

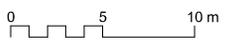


client
CUBE DEVELOPMENTS
2272 MILLSTREAM ROAD
VICTORIA, BC

project
3120 WASHINGTON AVENUE
DEVELOPMENT
VICTORIA, BC

sheet title
Planting Plan

project no. 120/03
scale 1:125 @ 24"x36"
drawn by MCI
checked by SMIPGG
revision no. sheet no.
L3.01

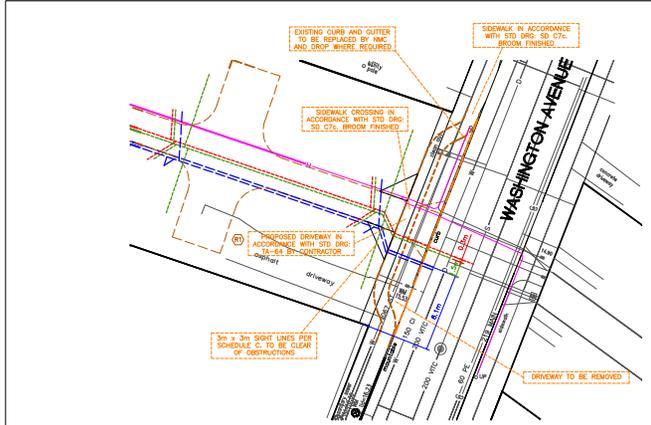

SERVICES DIMENSIONS

- SPECIFIC NOTES**
- LANDSCAPE**
- Tree Permit: Refer to Municipal Bylaws for details on tree protection, removal and permits required.
 - Tree Pruning: Trees shown bold solid line to be RETAINED, and protection fencing installed as per Arborist Report, to be reviewed by Parks.
 - Tree Removal: Trees shown dotted red line to be removed.
 - New Trees: New trees to be provided by City at applicant's expense. Location and tree specifications to be approved by City.
 - Tree Fences: All protected and new 'backyard fence' protection areas to be provided with Tree Protection Fencing as specified and approved by the Arborist and Parks.
 - New 'backyard fence' protection: Fencing to be 2.5x2.5m centered upon the proposed 'new' location.
 - Tree Other: Private, backyard and other protected trees that may or may not be shown are subject to municipal bylaw unless otherwise permitted by City Parks.
 - Arborist Coordination: The Arborist shall supervise all activities, execution or disturbance that occur within the CRZ of any tree.
 - Pre-construction meeting: A pre-construction meeting is to be conducted with City Parks, project coordinator, project sponsor, and engineers prior to any work being carried out.
 - Road Shoulder and Shoulder Restoration: All City boulevard areas to be fully restored as per the COV schedule and development servicing by law no. 12-542.
- HYDRO AND TELECOM**
- New: Coordinate with utilities for new utilities.
- Gas**
- Caution: Gas services exist in the area. Confirm cover depth OK with Fortis before construction execution. Contact BC One-Call 1-800-474-8986 for gas locate before excavation. New gas line installation to be applied for by owner if so required. Show schematically.
- ROAD**
- Driveway: Proceed CW location. Driveway Apron to be built in accordance with City of Victoria Standard Drawings TA-64 and profile, unless otherwise noted.
 - SEWER: Cap existing sewer connection by City at Applicant's expense.
 - New: Provide new 150mm sewer connection and IC by City at Applicant's expense.
 - DIAM: Provide new 150mm sewer connection on site by contractor.
 - Existing: Cap existing drain connection by City at Applicant's expense.
 - New: Provide new 150mm drain connections and IC by City at Applicant's expense.
 - Provide new 150mm drain connections on site by contractor.
- WATER**
- Existing: Existing water services to be DECOMMISSIONED.
 - New: Provide new 50mm water service/pressure and new existing water service/pressure by City at Applicant's expense.
 - Provide new 50mm water service on site by contractor.
- Other**
- Provide new 8"-Com on site by Contractor.

- GENERAL NOTES**
- DRAWING INFORMATION**
- Dimensions are metric, millimetres on Detail drawings meters on 1:500 plan and profile, unless otherwise noted. Information that is provided in our plans, sheets, or specifications is intended to indicate the general arrangement of work to be carried out. As the project progresses, the degree of detail that is provided may vary in addition or deletion.
- Existing service information within areas of construction may have been supplied by others and are approximate only. Additional services may be present but not included in these drawings.
- GENERAL REQUIREMENTS**
- Refer to local Engineer's "Statement of Conditions" for additional information as to the use of these documents and construction of the works.
- A permit to excavate or work near Fortis Gas pipelines is required. Contact 1-877-599-0996.
- Refer to City Standard Drawings and Specifications and permit, local Municipal Construction Documents, local codes, including British Columbia and other applicable laws, bylaws, rules, regulations, codes, and other applicable requirements, and other applicable requirements or provisions not covered in these drawings.
- All other construction, material and installation of service not covered, Electrical Code, or by other bylaws or specifications shall be in accordance with the Master MCO specifications/Approved detail drawings, and alterations.
- Unless otherwise specified, levels, all work within private property and easements to be installed in accordance with the BC Building Code and inspected by the Municipality of Victoria Inspector.
- COORDINATION REQUIREMENTS**
- Communication and Reporting: Contact BC One-Call prior to construction for services locate. 1-800-474-8986.
- The Contractor is to coordinate and communicate with the engineer of utilities and authorities having jurisdiction, well in advance (2-working days minimum) of the start of any excavation and commencement of work below ground.
- The Contractor shall coordinate and schedule all sub-contractors, contractors and trades required for the completion of the works.
- The Contractor shall provide the required quality control and performance testing reports to the engineer at the completion of each phase of the work.
- Permits**
- A Tree Bylaw Permit is to be obtained prior to any site activities.
- A Permit to construct works on a Municipal Road Allowance must be obtained before works commence.
- A permit to excavate or work near Fortis Gas pipelines is required. Contact 1-877-599-0996.
- Notification**
- A pre-construction meeting is required prior to the foundation pour to inspect on site and conditions.
- When giving advance notification, the contractor shall take into consideration the scheduling demand and prior commitments of all parties.
- Failure to comply with these requirements may result in delays, rejection of the work, or expensive reworking to prove compliance.
- In the event that the contractor is not providing the same construction layout, the Engineer is to be notified by email or otherwise in writing of such 5 days before any construction layout is required.
- The contractor shall notify the Engineer immediately if conditions are not favorable to the achievement of the scope of work.
- Change Requests**
- Contractor requested construction changes must be approved and approved by the Engineer prior to implementation.
- GENERAL CONSTRUCTION REQUIREMENTS**
- Public Access: Contractor shall maintain vehicular access to existing roads.
- Existing Services: Existing services must be exposed, located and elevations confirmed by the Contractor prior to works commencement.
- Service conflicts are to be reported to the Engineer immediately.
- All services to be installed to buildings and components shall be inspected by City and authorities having jurisdiction.
- Contractor shall adjust all the services components to match finished grades.
- Protection of Services: Contact BC One-Call for services locate. 1-800-474-8986.
- Contractor shall protect all services, cables, conduits and structures to be protected with traffic barriers unless subject to vehicle traffic.
- Excavation**
- Excavation shall be completed and backfilled within 24 hours of completion. Provide Class B bedding under all sewers and drainage using free draining 30mm crush gravel.
- Provision of drainage: Provide drainage through existing or new manholes, pipes, conduits or other. The top of the edge of a road or driveway.
- All trenches and road structures are to be installed with proper compaction and during the service life of the project.
- Testing Requirements**
- Construction testing is to be provided by the Contractor and approved by the Engineer. All testing shall be in accordance with the requirements of the Engineer.
- Materials**
- All materials used are to be installed and used free during construction or stored without the express written authority of the Engineering Ltd and at no time may it be used or referenced in any form for any legal instrument.



UTILITY CHECK TABLE		
UTILITY	REPRESENTATIVE SIGNATURE	DATE
BC HYDRO		
TELUS		
SHAW		
FORTIS BC		
CITY OF VICT		



KEY PLAN - NTS
Lot 7, Section 7A, Victoria District/Plan 431
3120 WASHINGTON AVENUE

FINAL DRAWING TO HAVE LIVE SIGNATURE

ISSUED IN SUPPORT OF REZONING
CHECK REGION AND RELEASE NUMBER FOR CURRENT PLAN

210202

PROFESSIONAL ENGINEER
E.S. KYLE
#146611

HOEL ENGINEERING LTD
26-40 Cassidale Avenue, Victoria, BC
Canada V8Z 1T2

REV	DATE	DESCRIPTION	SIGNATURE
01	2019	1ST ISSUE	EM
02	2019	BUILDING PP ALTERED AND TREE REMOVE ADDED	EM
03	2020	DETAILED DESIGN	EM

REVISIONS

City of Victoria

SERVICING PLAN FOR
Lot 7, Section 7A, Victoria District/Plan 431

3120 WASHINGTON AVENUE

PROJECT FILE	DATE FILE APPROVED	DRAWING NUMBER
CY2021	NA	210202

210202

CIVIL - 3120 WASHINGTON AVE - ISSUED 210202

ON SITE STORMWATER MANAGEMENT (SWM) NOTES

CONTRACTOR OBLIGATION

Pre-Construction Meeting
The contractor must arrange with the engineer to review the SWM objectives to be achieved at the foundation or building perimeter drains.

Refer to GENERAL NOTES

Surface Water Control
Sources of surface water that drain onto disturbed areas shall be intercepted and conveyed to a suitable discharge point down slope of the disturbed areas.

Sediment Retention
During construction and re-establishment of vegetation and any surface water run-off from disturbed areas of the project, all any other source of sediment or pollutants laden water, shall not be routed through the stormwater management system. A sediment pond, with its fence, or other engineer approved surface treatments shall be used.

Commissioning of SWM systems
Temporary erosion and silt control treatments shall remain in place until the entire site has been stabilized and vegetation re-established.

SWM OBJECTIVES

General
All LRS shall be provided with stormwater management systems for roof and driveway surfaces.

This plan shows representative examples of typical SWM configurations for each lot.

The Owner and Contractor shall consult with the Engineer regarding the ultimate unpermeated end use of required SWM components.

Building Foundation Perimeter Drains
The Foundation Perimeter Drains (PD) from buildings shall be directly connected to the common or municipal drain connection, as applicable, and not routed through the Roof or Driveway drain systems.

Foundation drains to be provided otherwise as required by the BC Building Code.

Building Roof Drains

The Roof Downspouts (RD) from buildings are to be separate from the foundation perimeter drains and routed through the SWM systems as prescribed herein.

On-Site Drainage
New driveway surface areas are to be permeable, clear drain grade or permeable pavers unless otherwise approved by City.

Provide driveway surface and subgrade drainage as required to meet objectives.

Emergency storm overflows must be dispersed on-site.

SWM SYSTEM DESIGN NOTES

FOUNDATION PERIMETER DRAIN
Provide drains substantially in accordance with the BC Plumbing Code unless otherwise approved by the engineer.

ROOF DRAIN
Provide roof water headers and perimeter drain drains substantially in accordance with the BC Building Code as shown on the Approved Building Form unless otherwise approved by the engineer.

Overhead 150mm roof water collection pipe to Rain Gardens as indicated.

Construction and Finishing

All building site perimeter are to be remediated with vegetation or lawn over a minimum of 150mm of free draining topsoil.

SPECIFIC NOTES

- ① DMAN
- ② Existing City existing drain connection by City at Applicants expense.
- ③ New Provide new 150mm drain connection and IC by City at Applicants expense.
- ④ Provide new 150mm drain connections on site by contractor



RAIN GARDEN BY OTHERS CONNECTION MINIMUM DRAIN CONNECTION ELEVATIONS SHOWN. REFER TO LANDSCAPE PLAN FOR DETAILS ON RAIN GARDENS.

CLEARINGS NOT SHOWN BUT ARE TO BE PROVIDED IN ACCORDANCE WITH BC BUILDING CODE.

ALL LATERALS NOT SHOWN SPECIFICALLY ARE TO BE 100mm DOWN

MIN COVER OVER DRAIN: 1m



UTILITY	REPRESENTATIVE SIGNATURE	DATE
BC HYDRO		
TELUS		
SHAW		
FORTIS BC		
CITY OF VICT		

FINAL DRAWING TO HAVE LIVE SIGNATURE

ISSUED IN SUPPORT OF REZONING CHECK REVISION AND RELEASE NUMBER FOR CURRENT PLAN

HOEL ENGINEERING LTD
28-40 Cadillac Avenue, Victoria, BC
Canada V8Z 1T2

REV	DATE	DESCRIPTION	BY	CHK
01	2023	LPT ADDED		ESL
02	2023	BUILDING FP ALTERED AND TREE REMOVAL ADDED		ESL
03	2023	DETAILED DESIGN		ESL

City of Victoria

SERVICING PLAN FOR
Lot 7, Section 7A, Victoria District, Plan 431

3120 WASHINGTON AVENUE

PROJECT FILE	CITY FILE REFERENCE	DRAWING NUMBER
CV2027	NA	C2 of 3


STAFF PRINTING BEARING OTHER REG. NO.

CIVIL - 3120 WASHINGTON AVE - ISSUED 210202

- SPECIFIC NOTES**
- SEWER
 - ① Existing
 - ② Cop existing sewer connection by City at Applicant's expense.
 - ③ New
 - ④ Provide new 150mm sewer connection and IC by City at Applicant's expense.
 - ⑤ Provide new 150mm sewer connection on site by contractor



UTILITY CHECK TABLE		
UTILITY	REPRESENTATIVE SIGNATURE	DATE
BC HYDRO		
TELUS		
SHAW		
FORTIS BC		
CITY OF VICT		

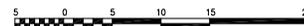

FINAL DRAWING TO HAVE LIVE SIGNATURE

ISSUED IN SUPPORT OF REZONING CHECK SPONSOR AND RELEASE NUMBER FOR CURRENT PLAN

210202

HOEL ENGINEERING LTD
28-40 Cadillac Avenue, Victoria, BC
Canada V8Z 1T2

PROFESSIONAL ENGINEER
E. S. HOEL
#44517
P.A.T.H. ENGINEER

REV	DATE	DESCRIPTION	SIGNATURE
01		ISSUE	ERK
02	2/19/18	BUILDING FP ALTERED AND TREE RADIIUS ADDED	ERK
03	2/22/18	DETAILED DESIGN	ERK

REVISIONS

City of Victoria

SERVICING PLAN FOR
Lot 7, Section 7A, Victoria District Plan 431

3120 WASHINGTON AVENUE

PROJECT FILE: CV9007 CITY FILE REFERENCE: NA DRAWING NUMBER: C3 of 3 ENTRY POINT BOUNDARY SHEET NO.

CIVIL - 3120 WASHINGTON AVE - ISSUED 210202

DUNSTER & ASSOCIATES

Environmental Consultants Ltd.

January 21, 2021

Scott Davies,
Cube Project Management Ltd.,
1605 - 728 Yates St., Victoria BC
V8W 0C8

Dear Mr. Davies.

As requested I have visited the site and reviewed the trees on site. Figure 1 is a survey plan of the trees. Table 1 provides details about each tree.

There are 11 bylaw sized trees on site. One tree (# 2074) is on City property. There is also a bylaw sized sequoia tree on the adjacent property in the south west corner. Two trees straddle the property line. One of those (# 2073) is between the site and City land. The other (# 2090) is at the west end of the site. The proposed works will require removal of all but four of the trees on site. That means removal of 16 trees, of which 8 are not protected trees, and 8 are protected trees. The four trees to be retained are one Garry Oak (# 2082), and 3 hawthorns ((#2089, #2090, #2091).

Table 1 provides details about the trees located. Specific actions for the trees to be retained are described below.

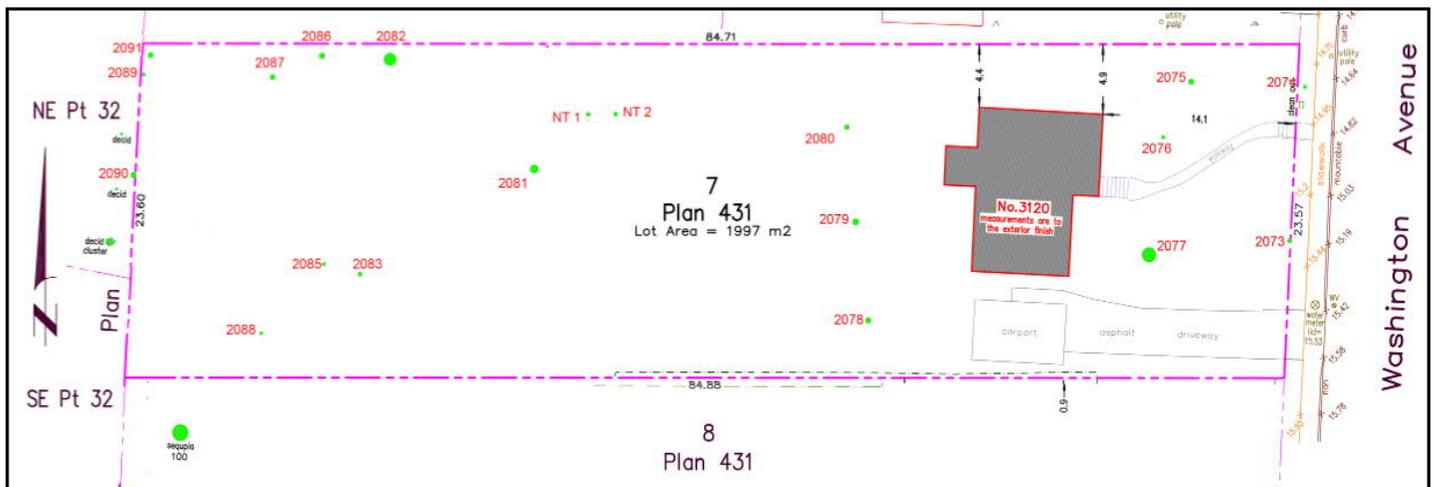


Figure 1. Location of trees on site.

DUNSTER & ASSOCIATES

Environmental Consultants Ltd.

Table 1. Details of the trees on site.

Tag #	Species	Trunk Diameter (cm)	TPZ radius (m)	Protected Tree (PT) / Unprotected (UP)	Retain Y / N	Reason for removal	Comments
2073	Purple Leaf Plum	22	3.96	UP	N	Engineering upgrades	Street Tree. Poor condition
2074	Purple Leaf Plum	22	3.96	UP	N	Engineering upgrades	Straddles property line. Fair condition
2075	Blue spruce	35	6.30	PT	N	Within footprint of new design	Good condition
2076	Pine	22	3.96	UP	N	Within footprint of new design	
2077	Douglas-fir	67/40	16.38	PT	N	Within footprint of new design	Twin stems joined at 70 cm
2078	Pine	39	7.02	PT	N	Within footprint of new design	
2079	Pine	34	6.12	PT	N	Within footprint of new design	
2080	Pine	34	6.12	PT	N	Within footprint of new design	
2081	Pear	56	10.08	PT	N	Within footprint of new design	
NT 1	Apple	18	3.24	UP	N	Within footprint of new design	Poor condition
NT 2	Apple	16	2.88	UP	N	Within footprint of new design	Poor condition
2082	Garry Oak	74	13.32	PT	Y		
2083	Apple	27	4.86	UP	N	Within footprint of new design	
2085	Apple	18	4.86	UP	N	Within footprint of new design	
2086	Western Redcedar	36	6.48	PT	N	Within footprint of new design	
2087	Pear	29 / 12	6.52	PT	N	Within footprint of new design	
2088	Apple	20	3.60	UP	N	Within footprint of new design	
2089	Hawthorn	22/14	2.26	PT	Y		Multiple stems
2090	Hawthorn	18/14/9	5.72	PT	Y		Multiple stems - straddles property line
2091	Hawthorn	30	5.40	PT	Y		
138	Sequoia	105	18.90	PT	Y		Off site - considered for development impact

The Development Proposed

Figure 2 shows the footprints of the eight units planned. I have also included the tree protection zones for the trees to be retained. The three hawthorn trees along the west boundary (#2089, #2090, #2091) are all small and are also being retained. There may be a need to prune back some parts of them to clean them up after many years of bramble growth. Since that part of the site is a rear yard there will not be a major disturbance affecting them.

DUNSTER & ASSOCIATES Environmental Consultants Ltd.



Figure 2. Proposed design with building footprints.

ACTION - install tree protection fencing

Before any other site work commences the hawthorn trees to be retained shall be fenced off at a distance of 1.0 metres from the base of trees # 2091. This fence shall extend to a distance of 1.5 metres to the south of tree # 2090. See Figure 3.

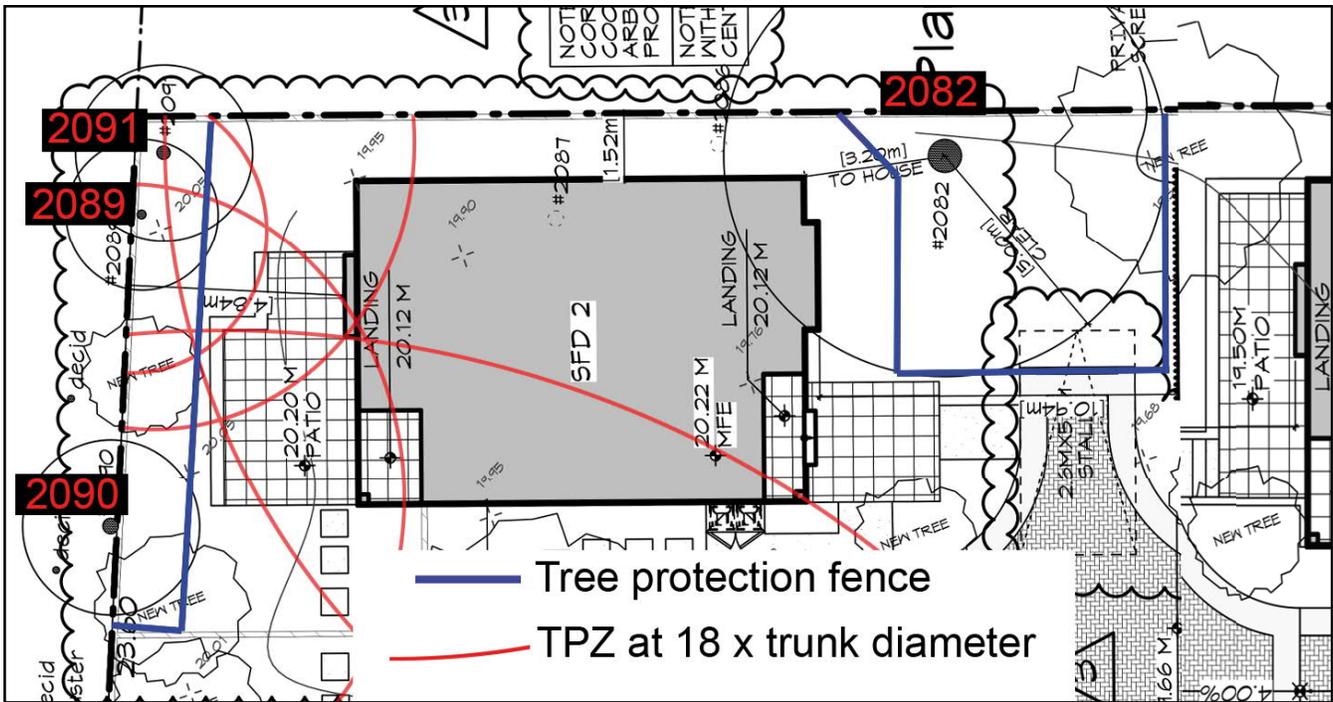


Figure 3. Fencing Plan.

DUNSTER & ASSOCIATES Environmental Consultants Ltd.

The oak tree (# 2082) shall be fenced off as shown in figure 4 below.

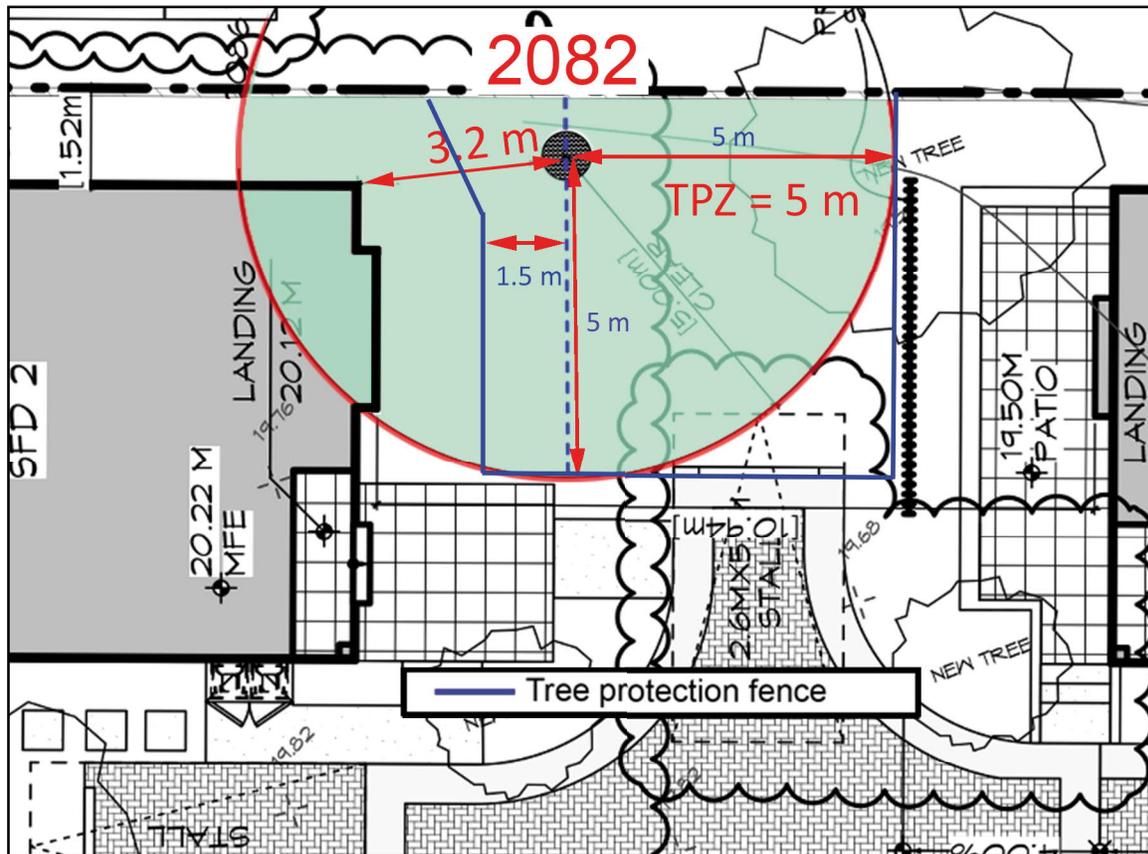


Figure 4. Fencing detail by tree # 2082.

The tree protection zone (TPZ) is set at a radial distance of 5 metres from the centre of the tree (the green area in figure 4). The fence shall extend 5 metres to the east and 5 metres to the south. Using a north - south line from the centre of the tree (dashed blue line in figure 4), set the west side of the fence 1.5 metres to the west of that centreline. Closer to the tree, angle the fence over towards the boundary.

The original design had this unit set further back to offer more protection for the tree. Council rejected that design on the basis that the rear yard would be too small, so the unit is now located in line with the other unit in the south west corner. In the new design the corner of new house is 3.2 metres from the centre of the oak tree. In order to try and ensure effective retention of the Garry oak tree I have worked with the design team to come up with a way to minimise the disturbance to the ground and roots in this area. The new design will see the north east corner of the house built on a grade beam installed on helical piles. The base of the beam is designed to be above ground, and the slab beyond it is poured on top of a gravel base so that there is no disturbance of the existing soils within the 5 metre TPZ. The parking space for the unit to the east has been modified to get it away from the TPZ, the patio for the unit in the north west corner has been modified, and the landscape irrigation will be surface drip lines or spray heads installed outside of the TPZ.

In order to make this approach work the following actions shall be implemented under the supervision of the project arborist.

DUNSTER & ASSOCIATES

Environmental Consultants Ltd.

Figure 6 shows a detail of the grade beam and slab. NOTE: within the TPZ there shall be no drainage along the two walls affected.

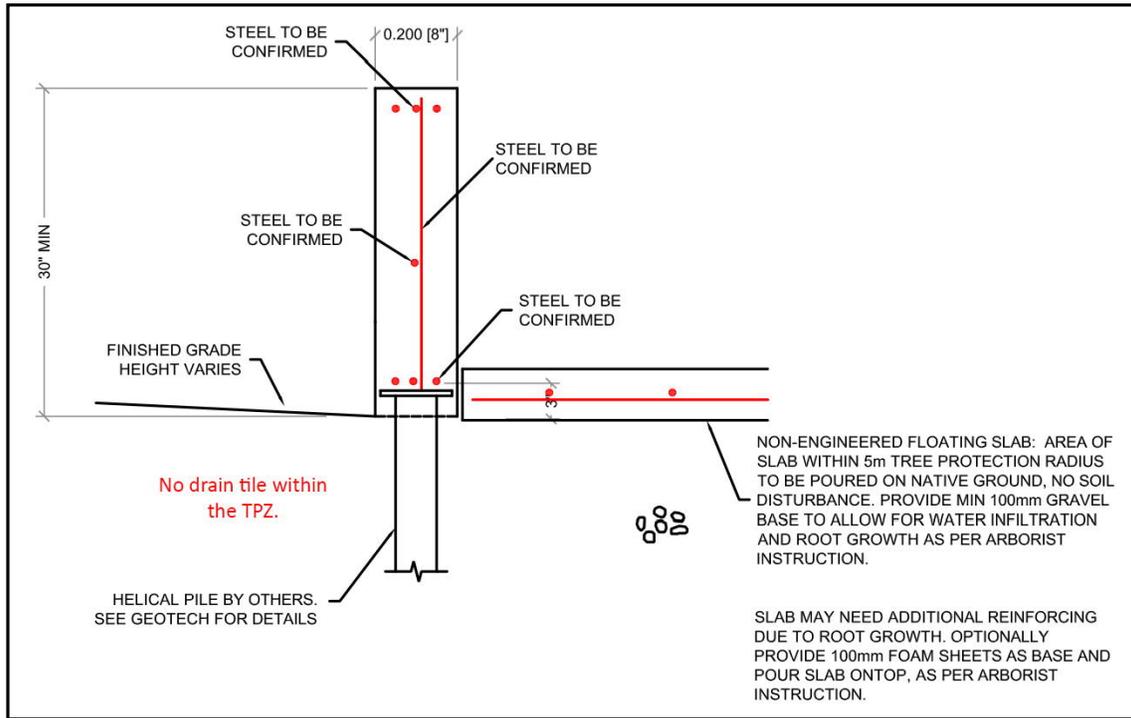


Figure 6. Detail of the grade beam and slab within the TPZ.

The plywood between the fence and the new house shall be retained in place until all construction work is completed, and the site is ready for final landscaping.

It is possible that once the new building's location is laid out on site, there may be a need for some pruning of the oak tree canopy to create a minimum distance of 2 metres between the walls or roof and the oak tree. The exact extent of pruning required will not be known until the project is underway. Preliminary investigations suggest that it will not be extensive. Any such work is to be reviewed on site by the project arborist and conducted under that person's supervision.

Finally, it is noted that there is a large sequoia tree on the property to the south. It is located about five metres from the property line. The construction of the new unit in that area will not cause damage to this tree at this distance. This report shall form part of the materials to be read and implemented by the contractor, and said contractor shall be solely responsible for ensuring that the items listed above are implemented as specified.

In summary, I have revised the plans to accommodate the new location of the unit in the northwest corner. To retain the oak tree # 2082 will require care. It will be possible if the specifications provided above are followed carefully. If there are any questions please let me know.

DUNSTER & ASSOCIATES Environmental Consultants Ltd.

Yours truly,
On Behalf of Dunster & Associates Environmental Consultants Ltd.



Dr. Julian A. Dunster, R.P.F., R.P.P., ISA Certified Arborist
ASCA Registered Consulting Arborist # 378
ISA Tree Risk Assessment Qualified
Honourary Life Member ISA + PNWISA