

UPPER HARBOUR PLACE
B.C.B.C 1998

B.C.B.C 199

Building size and Construction Requirements 3.2.2.
Building Area- 21,828 sq. ft. - 2,028 sq. m.
Five Stories (Mechanical Rooms/Elevator Rooms:
Not considered a storey for 3.2.2 as 3.2.2.1.1)

Group 'D' Office Fully sprinklered

- Fully Sprinklered

3.2.2.51 Applies-Group D up to Six Storeys

.1 a) Building Sprinklered -OK
b) Not more than 6 Storeys -OK
c) Building area Max 7,200m² permitted -OK

Construction Requirements Are:
Combustible or Non Combustible Construction
- Provided by Cast in Place Concrete Construction
- 1 HR F.R.R for Floor Assemblies
- Provided by Cast in Place Concrete Construction
- 1 HR F.R.F for Mezzanines
- Provided by Cast in Place Concrete Construction
- 1 HR Supporting Structure

- Provided by Cast in Place Concrete Construction

Storage garage: Garage separated from other occupancies by 11/2HR as 3.3.5.6 - Provided by cast in place concrete construction.

Vestibules Required as 3.3.5.4
Vestibules to conform to 3.3.5.7(3)

3.2.3 Spatial Separation

Group 'D' Sprinklered - Table 3.2.3.1.C applies

South Elevation L.D. = 30' (50% of distance between Phase I & Phase II) = 9.1m Over 9m -100% Openings Permitted

East Elevation L.D. = 22' to 46'meters
L.D. to Property line or Centre line of Park over 9m
(over 9 m 100% openings permitted)

North Elevation - L.D. to Property Line along Bay Street = 36'+ Over 9 meters - 100% openings permitted

West Elevation - L.D. to Centre Line Tyee Road
Over 9meters - 100% openings permitted

OCCUPANT LOAD

Largest floor area less core space = 1815 sq. m

1815 sq m floor area @ 9.3 sq m / person(office) = 195 occupants / floor

EXITS
2 exit stairs per floor
1100mm / 8.0 Persons x 2 stairs = 274 people
Exit separation exceeds 9m as per 3.4.2.3.

WASHROOMS
Table 3.7.4.2.B. applies
195 occupants per floor / assume 98 each sex
3 fixtures required for each sex
4 fixtures provided for each sex

NOTE:

6.88' (2.1m) MIN. CLEARANCE
UNDER ALL OBSTRUCTIONS PIPEWORK, SPRINKLERS, ETC.

UPPER HARBOUR PLACE

655 TYEE ROAD





PHASE 2
BUILDING TWO


SUB-SITE PLAN (P1)

SCALE:1/16"=1'-0" DATE : OCT 06/04 DESIGN : XX PROJECT No. 22010 DRAWN : JC


A.1.02

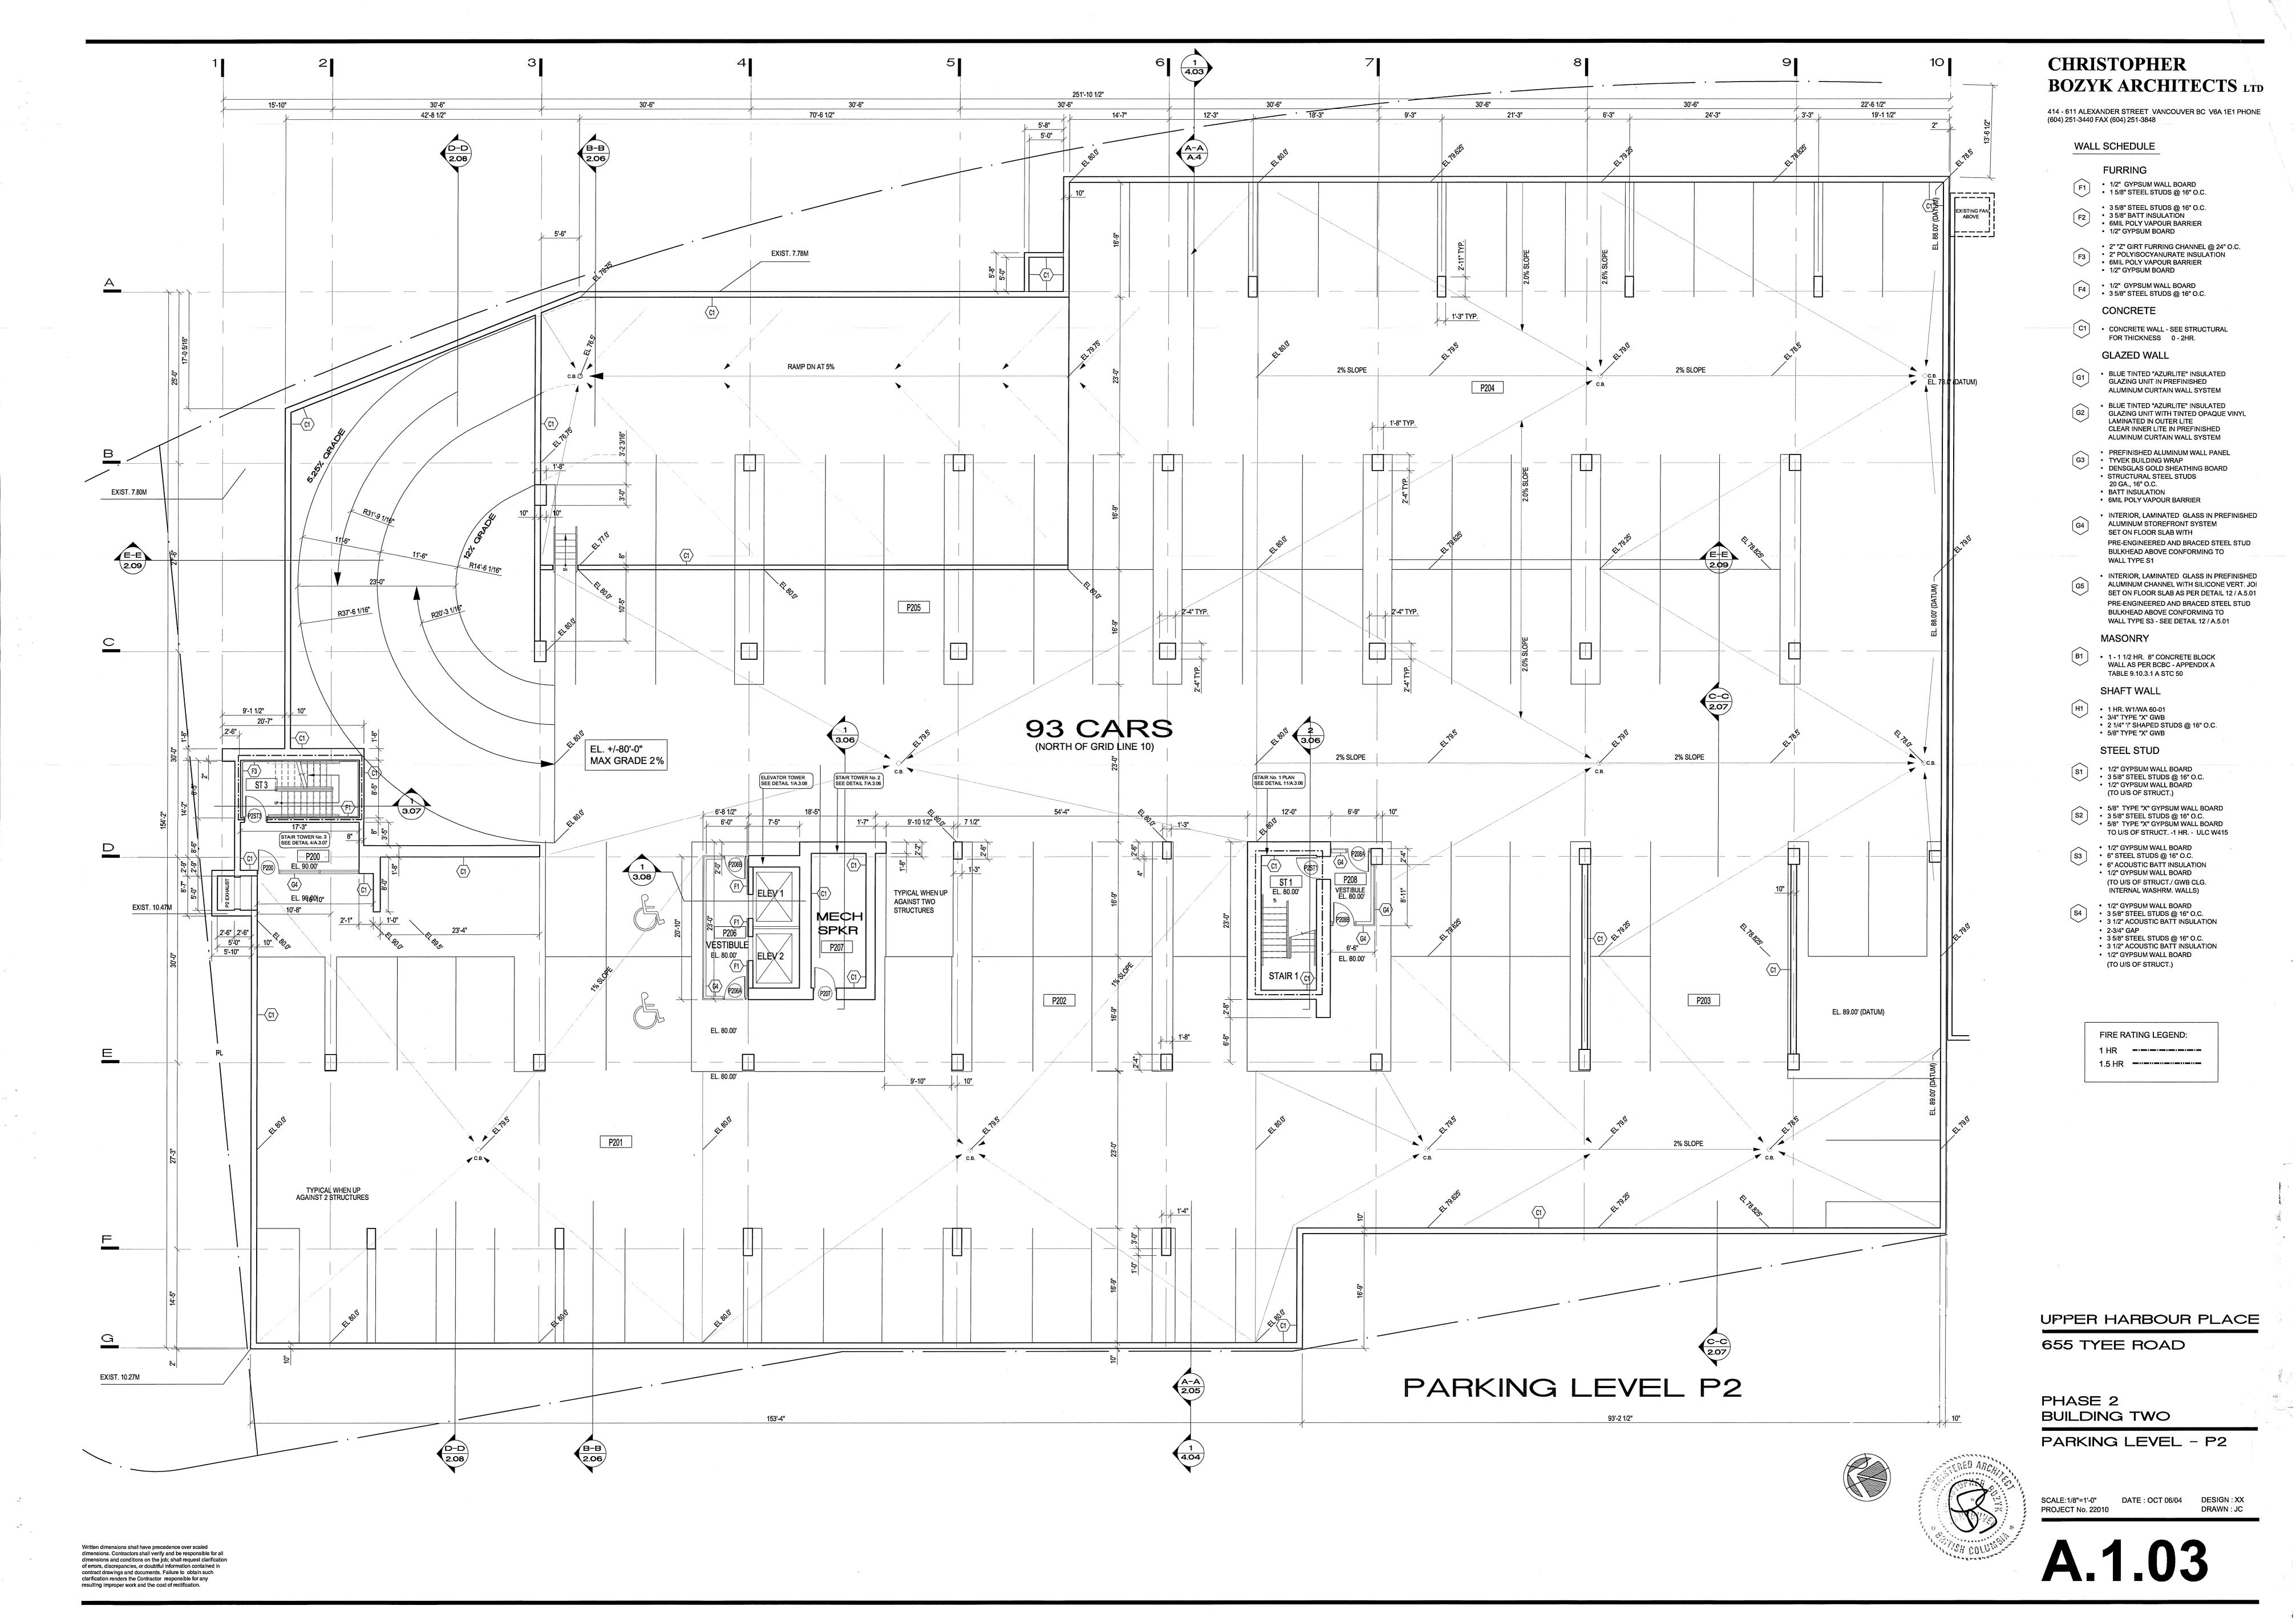

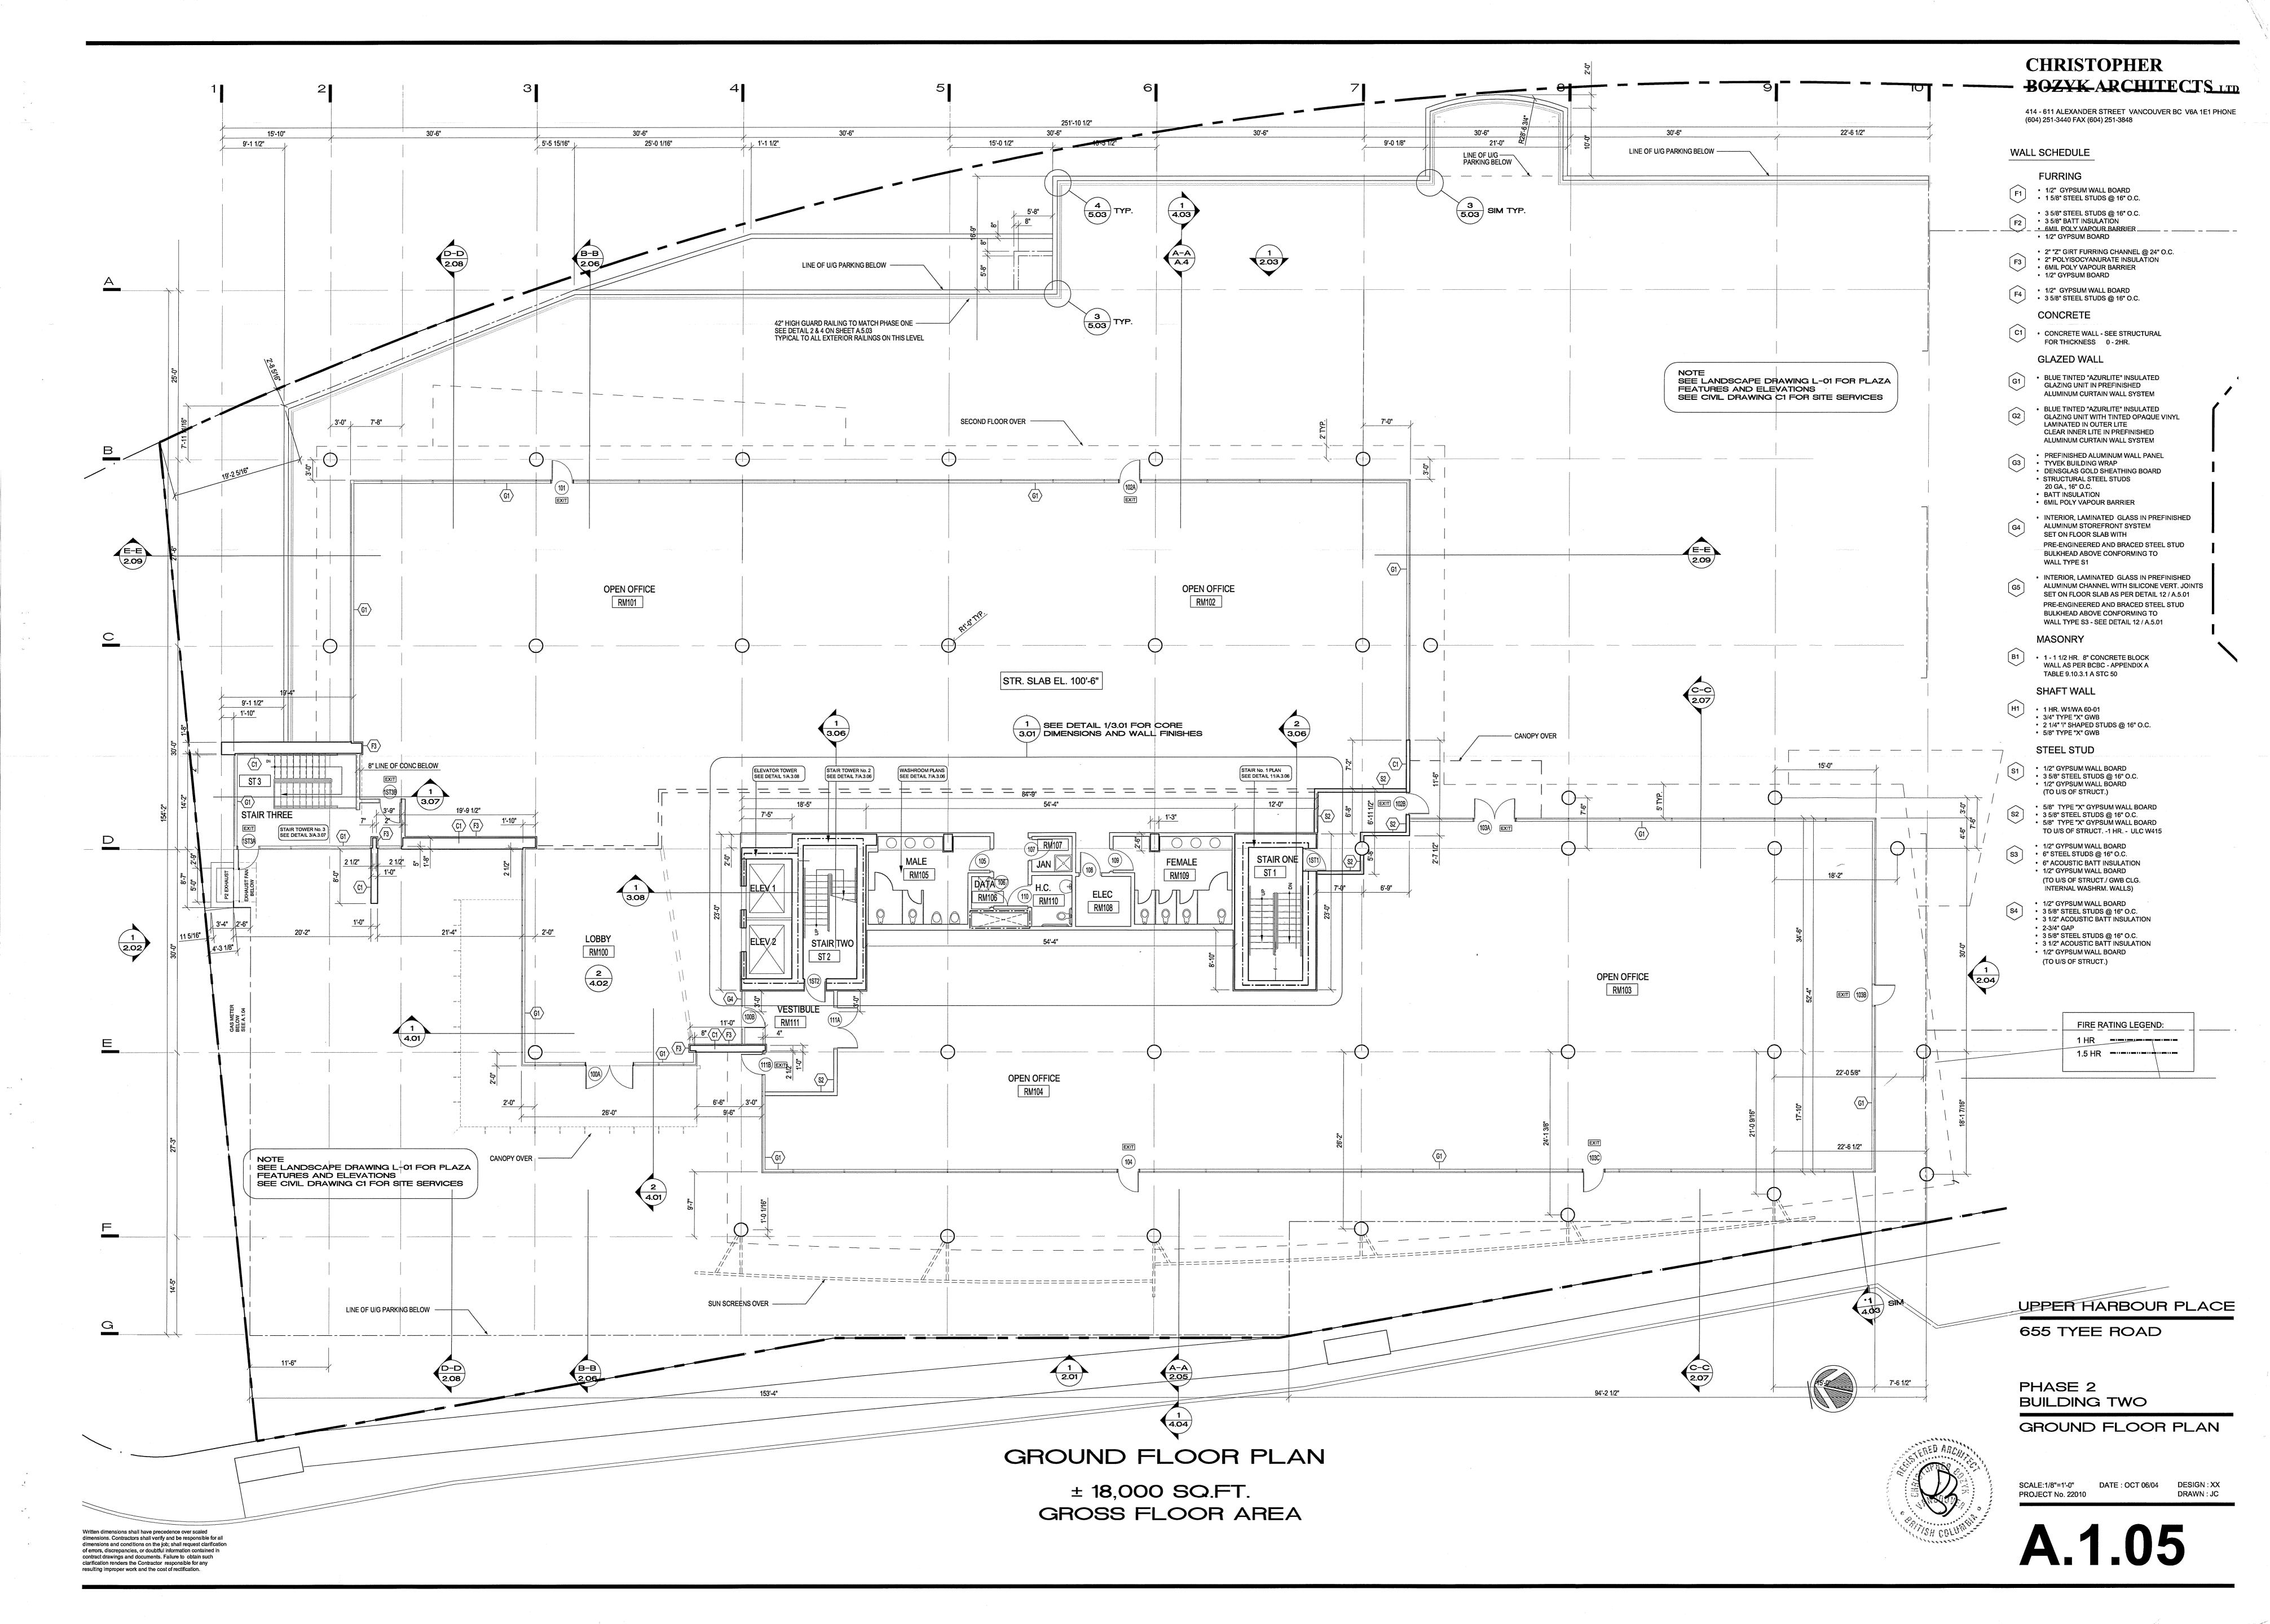


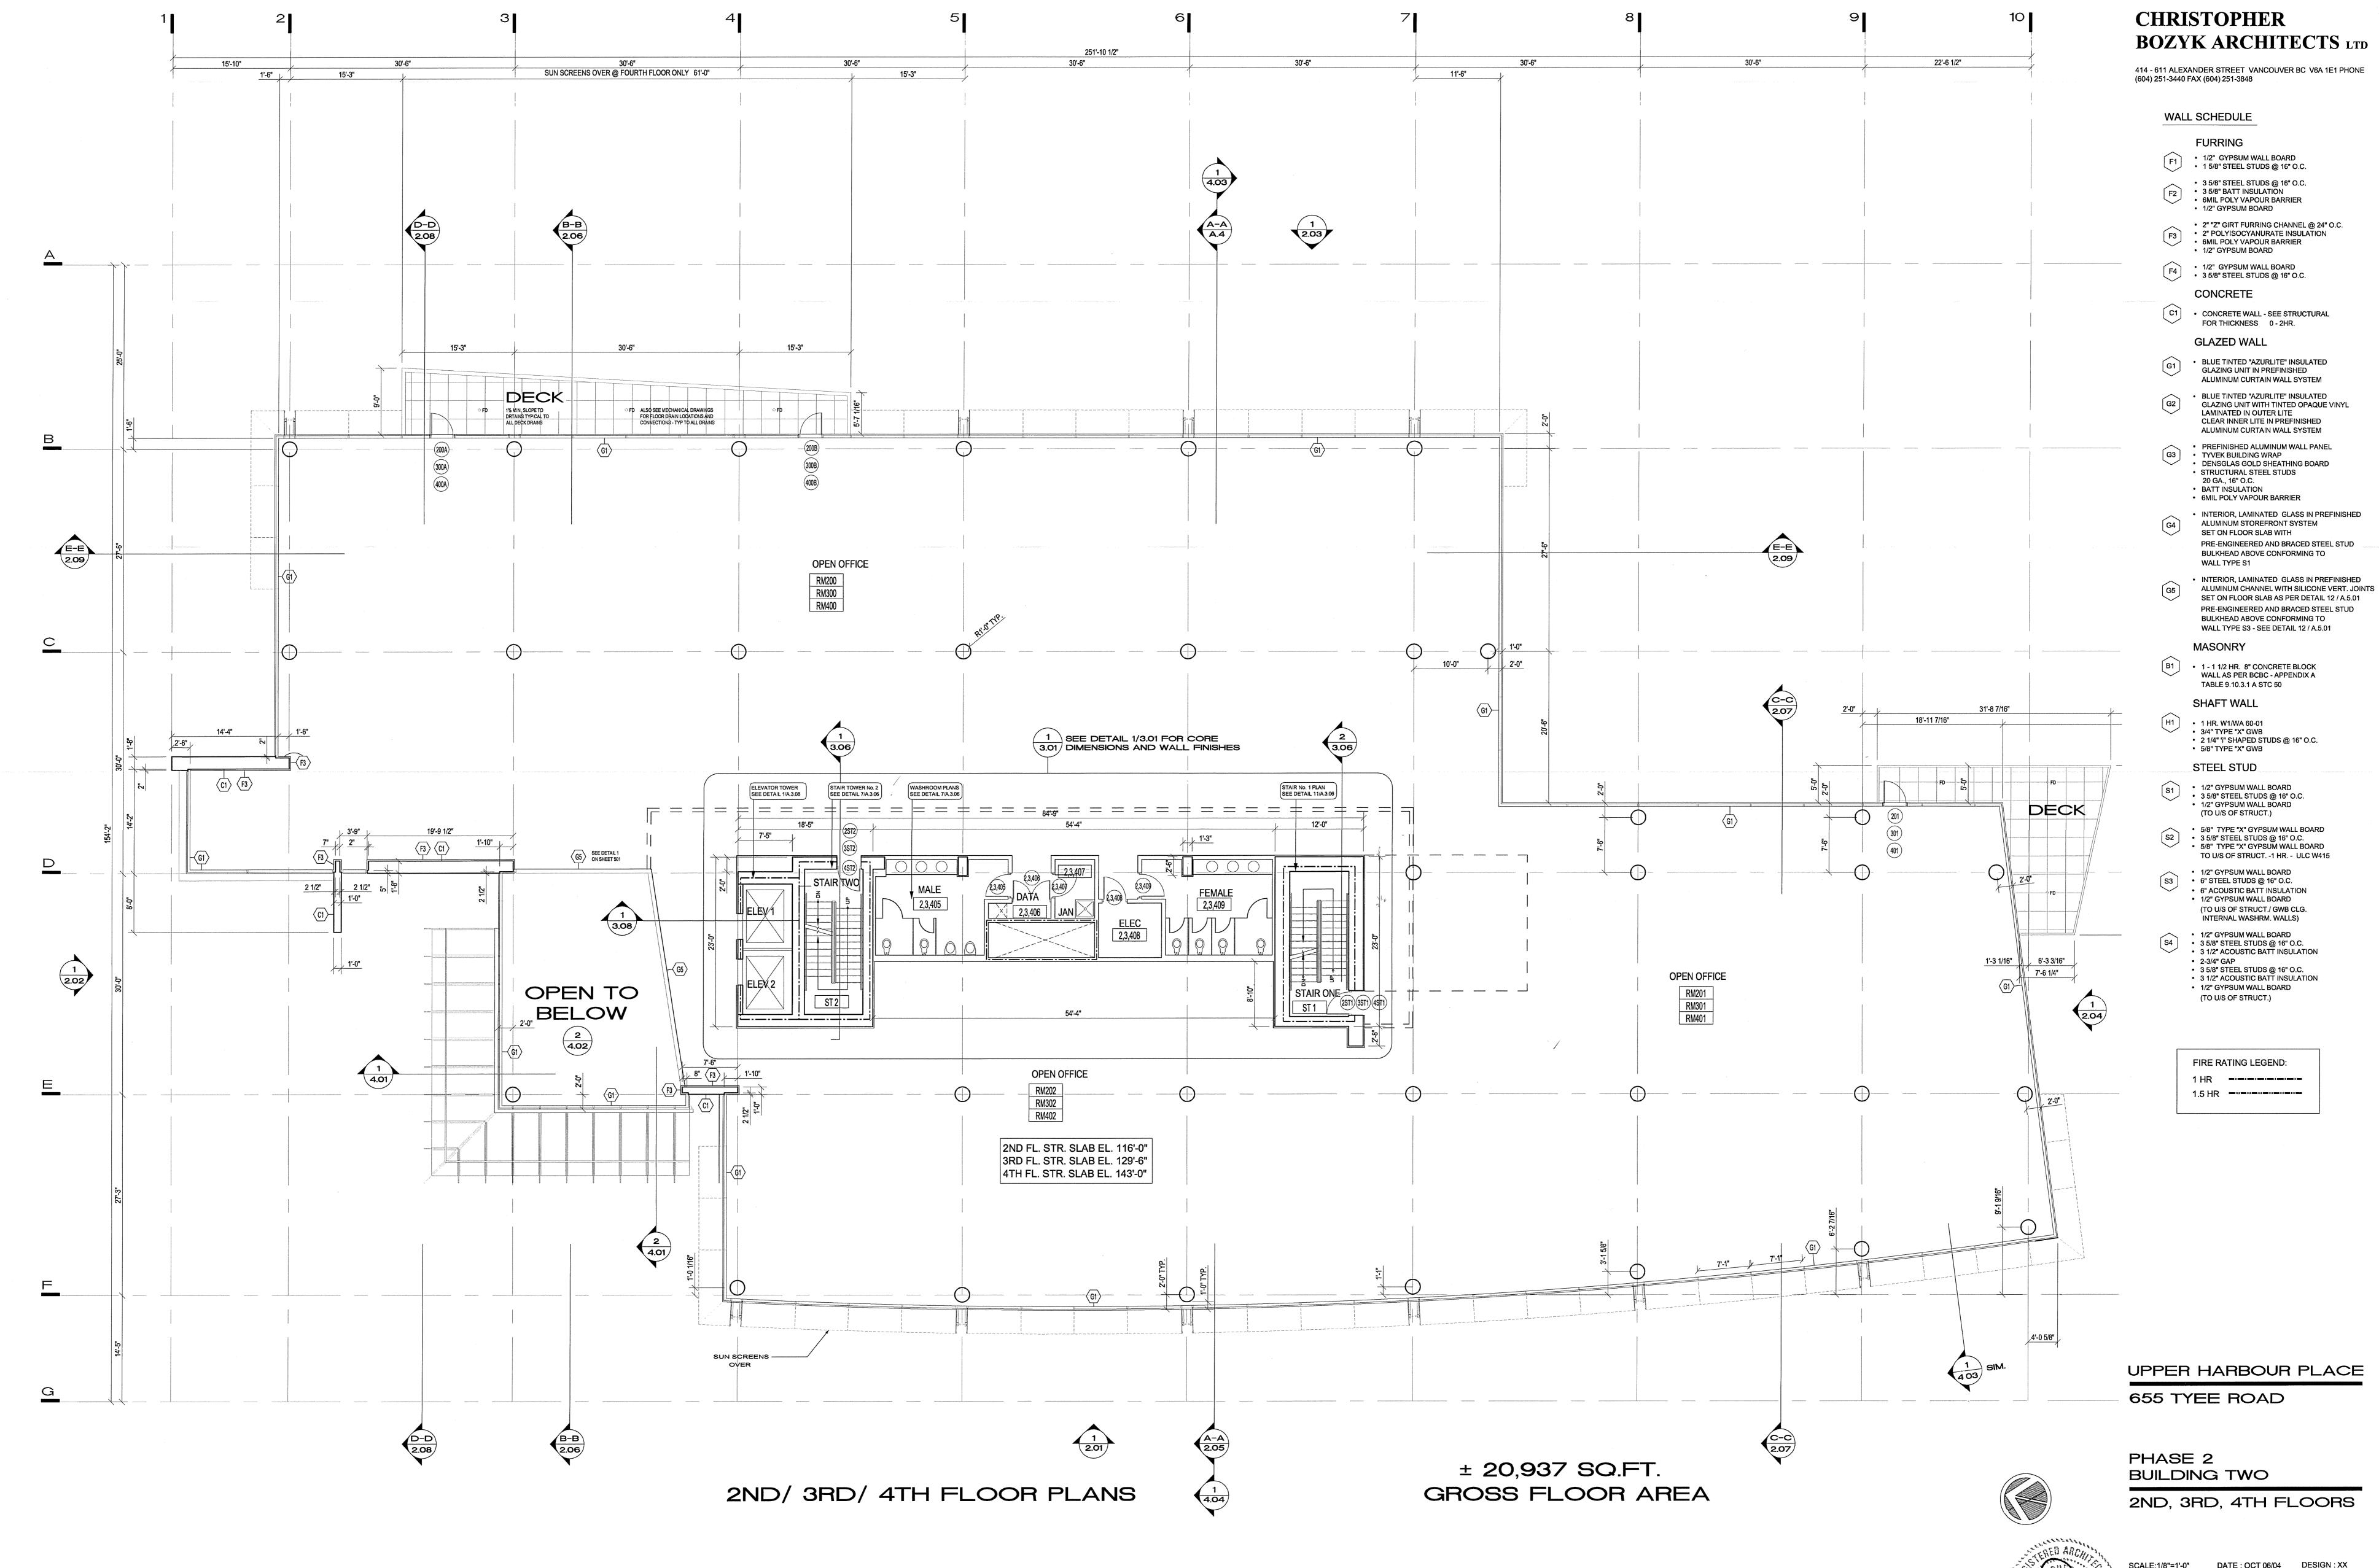


SCALE:1/8"=1'-0" DATE: OCT 06/04 DESIGN: XX PROJECT No. 22010

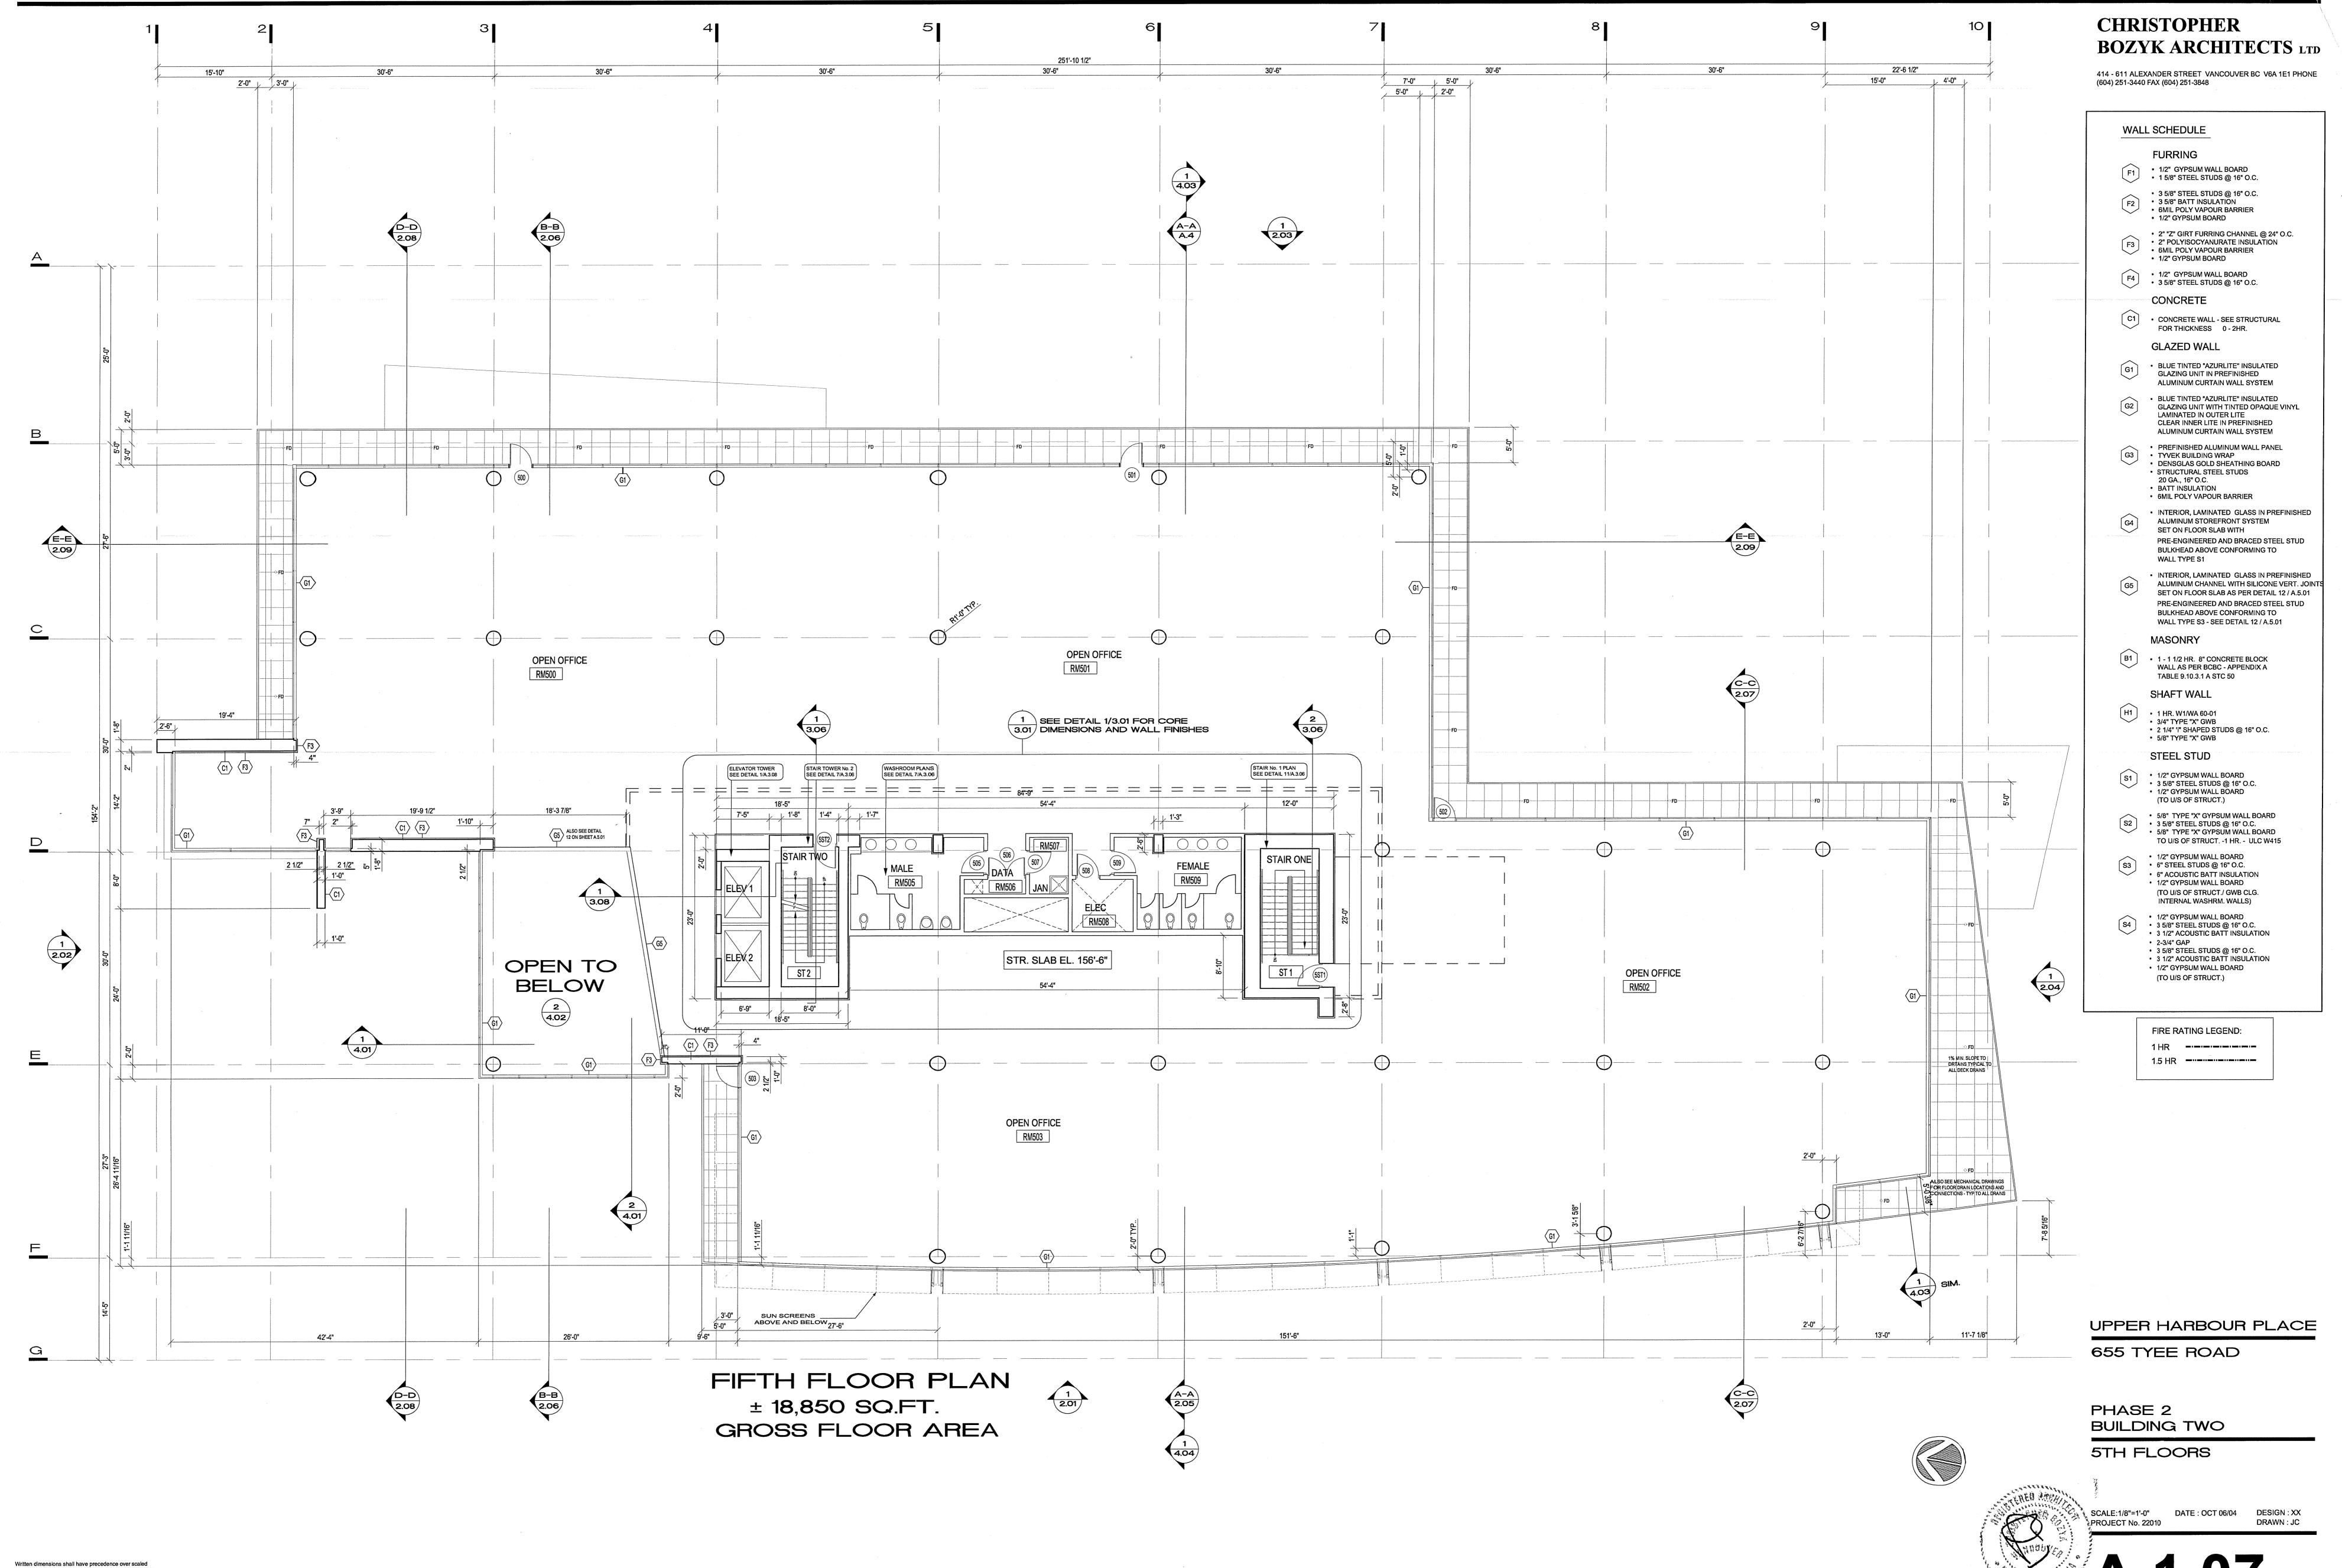

dimensions. Contractors shall verify and be responsible for all dimensions and conditions on the job; shall request clarification of errors, discrepancies, or doubtful information contained in contract drawings and documents. Fallure to obtain such clarification renders the Contractor responsible for any resulting improper work and the cost of rectification.

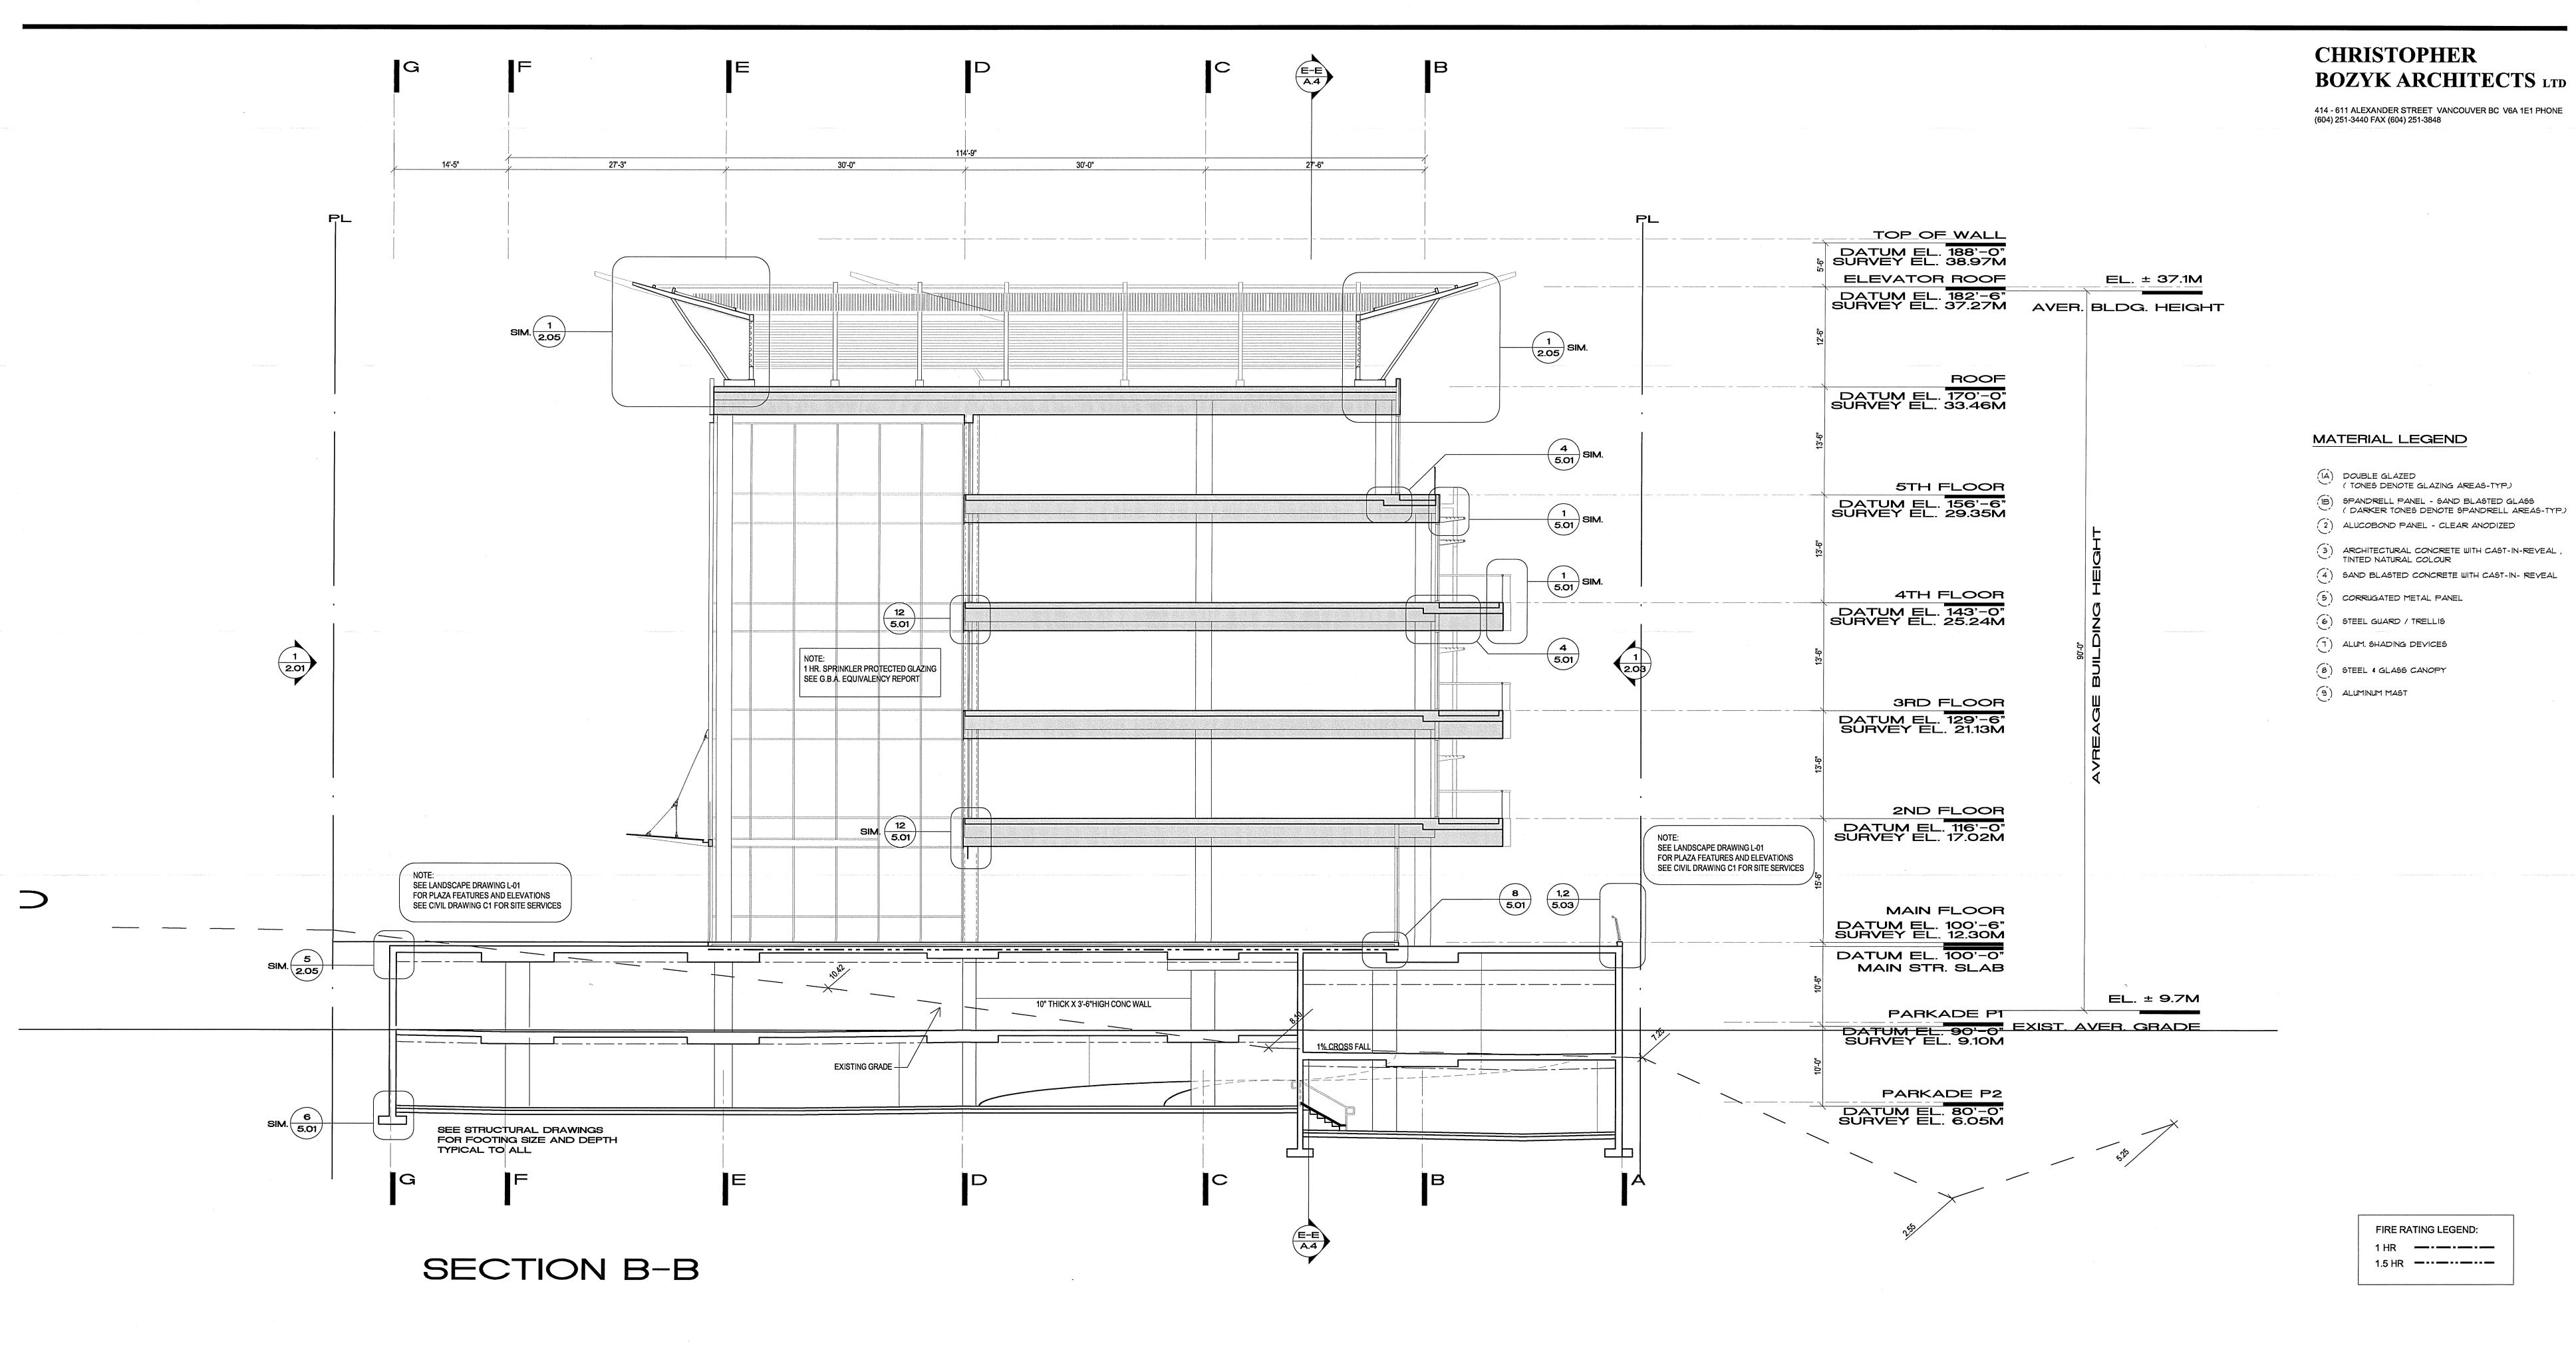

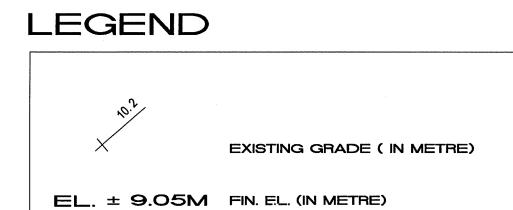

REV	DATE	DESCRIPTION
01	04.11.01	ISSUED FOR REVIEW
02	04.12.10	ISSUED FOR DESIGN COORDINATION
03	05.01.17	ISSUED FOR DESIGN COORDINATION
04	05.02.09	ISSUED FOR BUILDING PERMIT

UPPER HARBOUR PLACE

655 TYEE ROAD



PHASE 2 BUILDING TWO

BUILDING SECTION B-B

SCALE:1/8"=1'-0" DATE : OCT 06/04 DESIGN : XX PROJECT No. 22010 DRAWN : JC

A.2.06