BICYCLE PARKING LONG TERM 1: SHORT TERM 3: TOTAL 2:

PROJECT INFORMATION			VICTORIA ZONING BYLAW SUMMARY	
CIVIC ADDRESS 1230 GRANT STREET 1209,1218,1219,1220, an 1219 VINING STREET 1235 CALEDONIA AVENU	H 1226 NORTH PAI	RK STREET	ZONING R-K R-2	
1211 GLADSTONE AVEN	UE		USE RESIDENTIAL	
LEGAL DESCRIPTION LOT 4 VIP205 SECTION : LOT 5 VIP205 SECTION :	SR VICTORIA SR VICTORIA		FLOOR SPACE RATIO GROSS BUILDING FLOOR AREA (ZONING) / SITE AREA 11193/8881.1 = 1.29	
LEGAL DESCRIPTION LOT 4 VIP205 SECTION: LOT 5 VIP205 SECTION: LOT 6 VIP205 SECTION: LOT 6 VIP205 SECTION: N 56' OF LOT 8 VIP205 SECTION: REM LOT 8 VIP205 SECTION: LOT 18 VIP205 SECTION:	SR VICTORIA ECTION SR VICTO FION SR VICTORIA SR VICTORIA I SR VICTORIA	DRIA	SITE COVERAGE (SEE A202b FOR CALCULATION) AREA OF LOT OCCUPIED BY ANY STRUCTURE/ SITE AREA 4957/8681.1 = 57%	
SITE AREA	ING KIDGE, VIP55	528	OPEN SITE SPACE	
PROJECT DESCRIPTION THE PROJECT INVOLVE AFFORDABLE HOUSING	I S THE DEVELOPM	IENT OF 158	(SEE A202c FOR CALCULATION) SITE AREA - (BUILDING AREA + SURFACE PARKING AREA) 8681.1 - 5225 = 3456.1 OPEN SITE SPACE/ SITE AREA 3456.1/888.11 = 40%	
FACILITIES IN 2 APARTN OVER ONE BASEMENT I	IENT AND 3 TOWN	HOUSE BUILDINGS	AVERAGE GRADE (GEODETIC) (SEE A202a FOR CALCULATION)	
BUILDING HEIGHTS APARTMENT 1	BCBC 4 STOREYS	ZONING	APARTMENT 1	
APARTMENT 1 APARTMENT 2 TOWNHOUSE 1 TOWNHOUSE 2 TOWNHOUSE 3	4 STOREYS 5 STOREYS 3 STOREYS 3 STOREYS 3 STOREYS	4 STOREYS, 12.30 M 5 STOREYS, 14.98 M 4 STOREYS, 11.05 M 3 STOREYS, 10.65 M 3 STOREYS, 9.40 M	APARTMENT 2 TOWNHOUSE 1 TOWNHOUSE 3 PORTION OF PARKADE ABOVE NATURAL GRADE (>33,2 M BUILDING 1 33,2 M	u i
BUILDING AREAS APARTMENT 1	BCBC 872 SM		TOWNHOUSE 2 BUILDING 2 32.6 M	
APARTMENT 2 TOWNHOUSE 1 TOWNHOUSE 2	875 SM 653 SM			
TOWNHOUSE 2 TOWNHOUSE 3	652 SM 260 SM		HEIGHT OF BUILDINGS (AS MEASURED FROM AVERAGE GRADE). APARTMENT 1 12.300 M APARTMENT 2 14.980 M	
GROSS BUILDING AREA PARKADE	S BCBC 3905 SM	ZONING 275 SM*	TOWNHOUSE 1 11.050 M TOWNHOUSE 2 10.650 M	
PARKADE * AREA OF PARKADE E) AND BICYCLE PARKING	CLUDING EXTER AND CIRCULATIO	IOR WALLS, VEHICLE N.	TOWNHOUSE 2 10.650 M	
APARTMENT 1			VEHICLE PARKING < 45 SM 2 X 14 = 2 8	
APARTMENT 1 LEVEL 1 LEVEL 2 LEVEL 3	800 SM 872 SM	776 SM 850 SM	< 45 SM	
LEVEL 3	872 SM 723 SM	850 SM 704 SM	SUBTOTAL 96.3 (96)	
LEVEL 4 TOTAL	3267 SM	3180 SM	VISITOR ,1 X 158 = 15,8 (16) TOTAL REQUIRED 112	
APARTMENT 2	789 SM	765 SM	PROVIDED 117	
LEVEL 2	656 SM	637 SM	BICYCLE PARKING LONG TERM	
LEVEL 3 LEVEL 4	831 SM 831 SM	809 SM 809 SM	< 45 SM 14 X 11 = 14	- 1
APARTMENT 2 LEVEL 1 LEVEL 2 LEVEL 3 LEVEL 4 LEVEL 5 TOTAL	690 SM 3797 SM	672 SM 3692 SM	> 45 SM 1.25 X 144 = 180 TOTAL LONG TERM REQUIRED 194 TOTAL PROVIDED 194	
TOMANHOUSE 4			SHORT TERM	
LEVEL 0 LEVEL 1 LEVEL 2	601 SM 603 SM	566 SM** 581 SM	RESIDENTIAL (THE GREATER OF) .1 X 158 OR 6 X 5	
LEVEL 2	608 SM	592 SM	TOTAL SHORT TERM REQUIRED 30 TOTAL PROVIDED 30	
LEVEL 3 TOTAL ** DOES NOT CONTRIB	645 SM 2457 SM	633 SM 2372 SM		
	UTE TO FSR.			
TOWNHOUSE 2 LEVEL 0	645 SM	606 SM**		
LEVEL 0 LEVEL 1 LEVEL 2	607 SM 607 SM	590 SM 590 SM		
LEVEL 3	645 SM 2504 SM	632 SM 2418 SM		
LEVEL 3 TOTAL ** DOES NOT CONTRIB	UTE TO FSR.	2410 SM		
TOWNHOUSE 3	231 SM	222 SM		
LEVEL 1 LEVEL 2	243 SM	235 SM		
LEVEL 3 TOTAL	253 SM 727 SM	246 SM 703 SM		
RESIDENTIAL UNIT SUN	IMARY			
APARTMENTS 1 & 2 14 STUDIO @	34 SM			
38 ONE BED @ 7 ACCESSIBLE ONE BED	47 - 49 SM 0@ 53 SM			
15 TWO BED @ 5 ACCESSIBI E TWO BEI	61 - 78 SM			
11 THREE BED @ 1 ACCESSIBLE THREE E	88 - 98 SM			
1 ACCESSIBLE THREE E 6 FOUR BED @ 97 TOTAL	98 - 118 SM	Í.		
TOMMHOUSES 1 -3				
55 TWO BED @ 2 ACCESSIBLE TWO BEI	81 - 90 SM D@ 104 SM			
2 THREE BED @ 2 FOUR BED @ 61 TOTAL	118 SM 130 SM			
61 TOTAL	IJU OM			
VEHICLE PARKING PARKADE 112 SURFACE 5 TOTAL 117				
DIOVOLE DADIONO				

CODE ANALYSIS

REFERENCE DOCUMENT BORD 2018

PARKADE
OCCUPANCY CLASSIFICATIONS (TABLE 3.1.2.1)
BELOW GRADE PARKADE GROUP F, DIVISION 3 - LOW HAZARD INDUSTRIAL

OCCUPANCY SEPARATIONS (TABLE 3.1.3.1)
BELOW GRADE PARKADE CONSIDERED AS A SEPARATE BUILDING AND
SEPARATED FROM THE FLOORS OF ALL BUILDINGS ABOVE BY A 2 HOUR
FIRE SEPARATION IN ACCORDANCE WITH 3.2.1.2.

BUILDING SIZE AND CONSTRUCTION RELATIVE TO OCCUPANCY 3.2.2.78 - GROUP F, DIVISION 3 - ANY HEIGHT, ANY AREA, SPRINKLERED FIRE SUPPRESSION - FULL SPRINKLERED ALLOWABLE HEIGHT - ANY HEIGHT

CONSTRUCTION - NON COMBUSTIBLE FLOOR ASSEMBLIES - 2 HOUR SUPPORTING WALLS AND STRUCTURE - 2 HOUR

ALLOWABLE AREA - ANY AREA

ACTUAL SIZE AND CONSTRUCTION
FIRE SUPPRESSION - FULL SPRINKLERED
HEIGHT - 1 STOREY
AREA - 3905 SM
CONSTRUCTION - NON COMBUSTIBLE
FLOOR ASSEMBLY - 2 HOUR
SUPPORTING WALLS AND STRUCTURE - 2 HOUR

APARTMENT 1
OCCUPANCY CLASSIFICATIONS (TABLE 3.1.2.1)
GROUP C - RESIDENTIAL

OCCUPANCY SEPARATIONS (TABLE 3.1.3.1)

BUILDING SIZE AND CONSTRUCTION RELATIVE TO OCCUPANCY 3.2.2.51 - GROUP C, UP TO 4 STOREYS, SPRINKLERED FIRE SUPPRESSION - FULLY SPRINKLERED ALLOWABLE HEIGHT - 4 STOREYS ALLOWABLE HEIGHT - 4 STOREYS ALLOWABLE AREA - 1800 SM (BASED ON FOUR STOREYS) CONSTRUCTION - COMBUSTIBLE OR NON COMBUSTIBLE FLOOR ASSEMBLIES - 1 HOUR SUPPORTING WALLS AND STRUCTURE - 1 HOUR ROPOF ASSEMBLY - NONE

ACTUAL SIZE AND CONSTRUCTION FIRE SUPPRESSION - FULLY SPRINKLERED HEIGHT - 4 STOREYS AREA - 872 SM AREA - 8/2 SM CONSTRUCTION - COMBUSTIBLE FLOOR ASSEMBLY - 1 HOUR SUPPORTING WALLS AND STRUCTURE - 1 HOUR ROOF ASSEMBLY - NONE

APARTMENT 2 OCCUPANCY CLASSIFICATIONS (TABLE 3.1.2.1)

GROUP C - RESIDENTIAL

OCCUPANCY SEPARATIONS (TABLE 3.1.3.1)

BUILDING SIZE AND CONSTRUCTION RELATIVE TO OCCUPANCY 3.2.2.50 - GROUP C, UP TO 6 STOREYS, SPRINKLERED FIRE SUPPRESSION - FLULY SPRINKLERED ALLOWABLE HEIGHT - 6 STOREYS & 16 M ALLOWABLE AREA - 1800 SM (BASED ON FIVE STOREYS) CONSTRUCTION - COMBUSTIBLE OR NON COMBUSTIBLE FLOOR ASSEMBLES - 1 HOUR SUPPORTING WALLE AND STRUCTURE - 1 HOUR ROOF ASSEMBLY - 1 HOUR

ACTUAL SIZE AND CONSTRUCTION FIRE SUPPRESSION - FULLY SPRINKLERED HEIGHT - 5 STOREYS, 14.96 M AREA - 831 SM

CONSTRUCTION - COMBUSTIBLE FLOOR ASSEMBLY - 1 HOUR SUPPORTING WALLS AND STRUCTURE - 1 HOUR ROOF ASSEMBLY - 1 HOUR

CODE ANALYSIS CONTINUED

TOWNHOUSE 1 OCCUPANCY CLASSIFICATIONS (TABLE 3.1.2.1) GROUP C - RESIDENTIAL

OCCUPANCY SEPARATIONS (TABLE 3.1.3.1)

BUILDING SIZE AND CONSTRUCTION RELATIVE TO OCCUPANCY 3.22.54-GROUP C. UPTO 3 STOREYS, SPRINKLERED FIRE SUPPRESSION - FULLY SPRINKLERED ALLOWABLE HIEIGHT - 3 STOREYS ALLOWABLE AREA - 1800 SM (BASED ON THREE STOREYS) CONSTRUCTION - COMBUSTIBLE OR NON COMBUSTIBLE FLOOR ASSEMBLIES - 45 MIN. SUPPORTING WALLS AND STRUCTURE - 45 MIN. ROOF - NONE

ACTUAL SIZE AND CONSTRUCTION FIRE SUPPRESSION - FULLY SPRINKLERED HEIGHT - 3 STOREYS WITH BASEMENT AREA - 645 SM AREA - 645 SM CONSTRUCTION - COMBUSTIBLE FLOOR ASSEMBLY - 45 MIN. SUPPORTING WALLS AND STRUCTURE - 45 MIN. ROOF ASSEMBLY - NONE

TOWNHOUSE 2
OCCUPANCY CLASSIFICATIONS (TABLE 3.1.2.1)
GROUP C - RESIDENTIAL

OCCUPANCY SEPARATIONS (TABLE 3.1,3.1)

BUILDING SIZE AND CONSTRUCTION RELATIVE TO OCCUPANCY

3.2.2.54 - GROUP C, UP TO 3 STOREYS, SPRINKLERED FIRE SUPPRESSION - FULLY SPRINKLERED ALLOWABLE HEIGHT - 3 STOREYS ALLOWABLE AREA - 1800 SM (BASED ON THREE STOREYS CONSTRUCTION - COMBUSTIBLE OR NON COMBUSTIBLE FLOOR ASSEMBLIES - 45 MIN. SUPPORTING WALLS AND STRUCTURE - 45 MIN.

ACTUAL SIZE AND CONSTRUCTION
FIRE SUPPRESSION - FULLY SPRINKLERED
HIRE SUPPRESSION - FULLY SPRINKLERED
HIRE SUPPRESSION - FULLY SPRINKLERED
CONSTRUCTION - COMBUSTIBLE
FLOOR ASSEMBLY - 4 SMIN.
SUPPORTING WALLS AND STRUCTURE - 45 MIN.
ROOF ASSEMBLY - NOW.

TOWNHOUSE 3
OCCUPANCY CLASSIFICATIONS (TABLE 9,10,2,1) GROUP C - RESIDENTIAL

FIRE-RESISTANCE RATINGS (TABLE 9.10.8.1) USE - RESIDENTIAL (GROUP C

MAXIMUM HEIGHT - 3 STOREYS MAXIMUM AREA - 600 SM MAXIMUM AREA - 600 SM CONSTRUCTION - COMBUSTIBLE OR NON COMBUSTIBLE FLOOR ASSEMBLIES - 45 MIN. SUPPORTING WALLS AND STRUCTURE - 45 MIN. ROOF ASSEMBLY - NONE

ACTUAL SIZE AND CONSTRUCTION FIRE SUPPRESSION - FULLY SPRINKLERED HEIGHT - 3 STOREYS WITH BASEMENT AREA - 253 SM CONSTRUCTION - COMBUSTIBLE

FLOOR ASSEMBLY - 45 MIN. SUPPORTING WALLS AND STRUCTURE - 45 MIN. ROOF ASSEMBLY - NONE

DRAWING INDEX

ARCHITECTURAL A001 PROJECT INFORMATION A002 SURVEY

A101 PARKADE PLAN

A201 ARCHITECTURAL SITE PLAN A202a AVERAGE GRADE CALCULATIONS A202b SITE COVERAGE CALCULATIONS A202c OPEN SPACE CALCULATIONS A203 L1 PLAN A204 L2 PLAN A205 L3 PLAN A206 L4 PLAN A207 L5 PLAN A208 ROOF PLAN

A301 FLEVATIONS - APARTMENT 1 A301 ELEVATIONS - APARTIMENT 1
A302 ELEVATIONS - APARTIMENT 2
A303 ELEVATIONS - APARTIMENT 2
A303 ELEVATIONS - APARTIMENT 2
A304 ELEVATIONS - TOWN-HOUSE 2
A304 ELEVATIONS - TOWN-HOUSE 3
A307 SHEWAND STUDIES
A308 VIEWANALYSIS
A309 VIEWANALYSIS
A310 VIEWANALYSIS
A311 PERSPECTIVE STUDIES
A311 PERSPECTIVE STUDIES

A312 PERSPECTIVE STUDIES A313 SKYLINE ANALYSIS

A401 BUILDING SECTIONS A402 BUILDING SECTIONS A403 BUILDING SECTIONS A404 BUILDING SECTIONS

ASO1 I 1 PLAN - APARTMENTS A602 L2 PLAN - APARTMENTS A603 L3 PLAN - APARTMENTS

A603 L3 PLAN - APARTMENTS A604 L4 PLAN - APARTMENTS A605 L5 PLAN - APARTMENTS A606 TOWNHOUSE 1 A607 TOWNHOUSE 2 A608 TOWNHOUSE 2 A608 TOWNHOUSE 2 A610 TOWNHOUSE 3

A701 APARTMENT UNIT PLANS
A702 APARTMENT UNIT PLANS
A703 TOWNHOUSE S 1 & 2 UNIT PLANS
A704 TOWNHOUSE S 1 UNIT PLANS
A705 AMENITY ROOM

19-028-REZONING CONCEPTUAL SERVICING

LANDSCAPE L1.01 LANDSCAPE OVERVIEW PLAN L1.02 LANDSCAPE MATERIALS SOUTH L1.03 LANDSCAPE MATERIALS NORTH L1.03 LANDSCAPE MATERIALS NORTH
L1.04 STORMWATER MANAGEMENT
L1.05 TREE RETENTION & REMOVAL PLAN
L3.01 PLANTING PLAN SOUTH
L5.02 PLANTING PLAN NORTH
L5.01 LANDSCAPE SECTIONS

> Revisions Received Date:


> > May 28, 2021

ISSUED FOR DP & REZONING




5




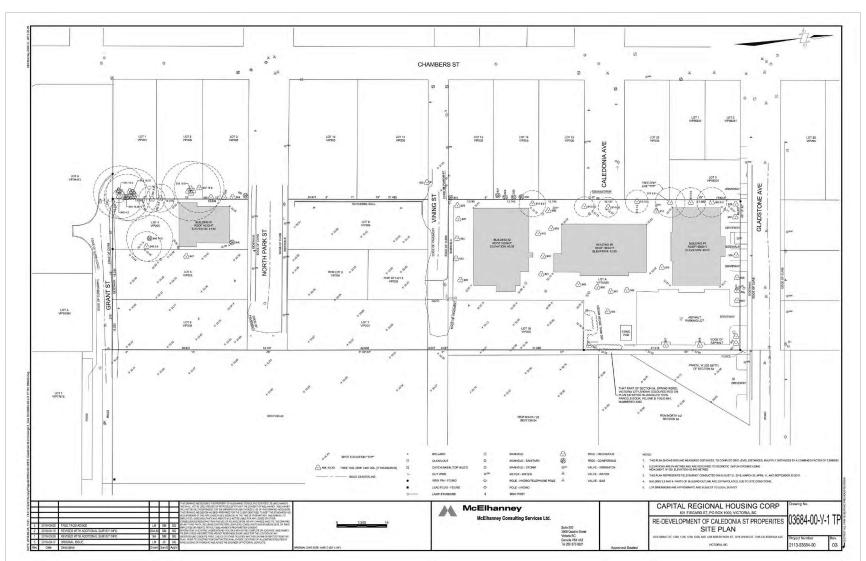


in .	tue .	Description .	
	18/12/16	96	S PONSE TO PLANNING REVIEW
2	289710		BSUED FOR ADE
	12/03/06		pauso for coty
4	(2/03/12		RE-INGUIGO FOR COTW
5	20/9901		RE-ISSUED FOR COTV.

d-Ka	dHKarchitects
VECTORM OFFICE BIT Frit Street Victoria BC VSV DHO T 1-250-658-2967	NAMEDOCFFEE 102-51F0 DUBLIN WAY NAMED TO VOTICE T 1-250-595-5910
pojednimi	
Caledonia	
Victoria, BC	
swyth.	
Survey	

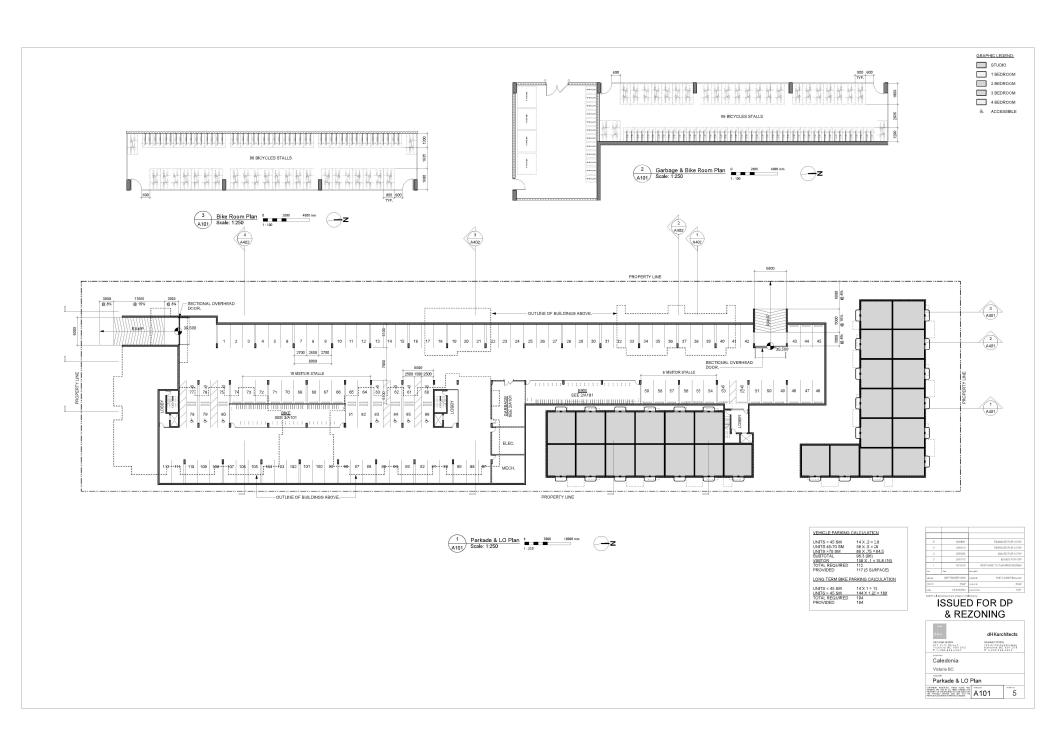

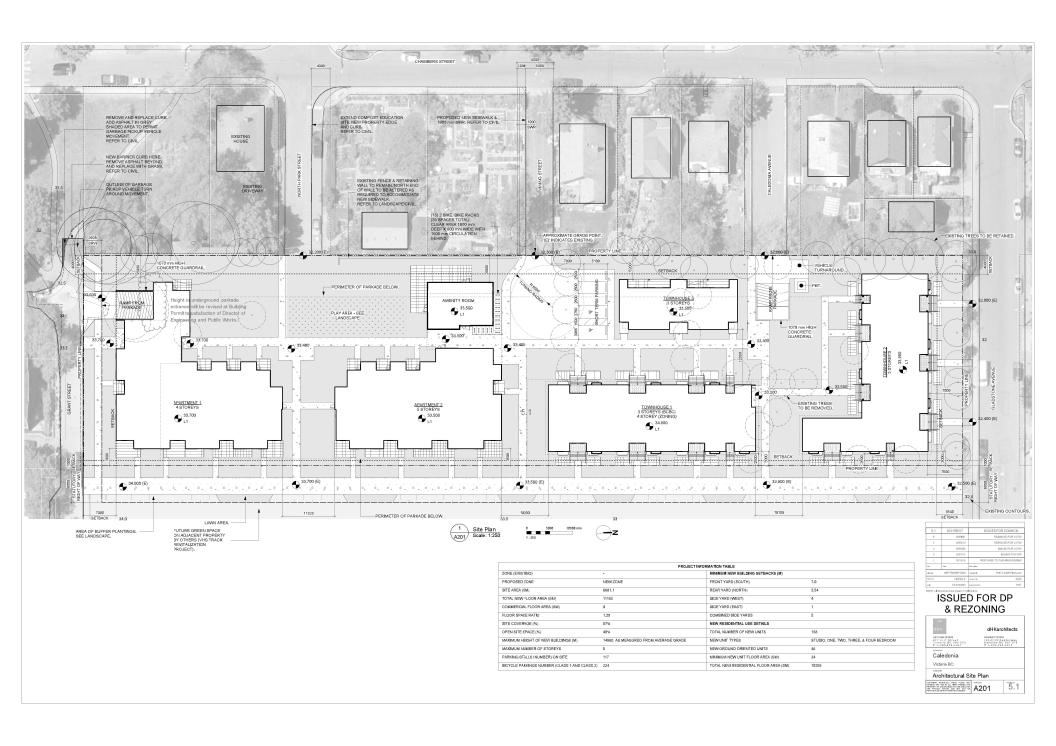

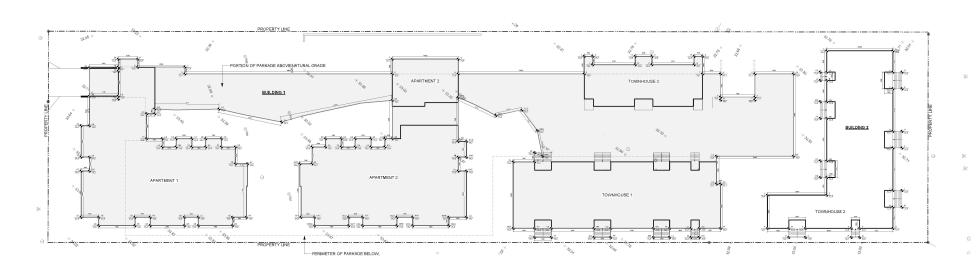

BUILDING 1 - AVERAGE GRADE CALCULATION

INCLUDES SUM OF ALL PORTION OF EUILDINGS OVER PARKADE :

- 1.) APARTMENT 1 2.) APARTMENT 2 3.) TOWN-HOUSE 1 4.) TOWN-HOUSE 3 5.) PORTION OF PARKADE ABOVE NATURAL GRADE (>33.2 m)

side	corner	+ corner grade point	12	average grade per side	X length of side	TOTAL
	grade point					
A&B	32.5	32.6	2	32.6	1.8	57.0
B&C	32.6	32.6	2	32.6	10.3	335.8
C&D	32.6	32.7	2	32.7	1.5	49.0
D&E	32,7	32,8	2	32,8	44,9	1470,5
E&F	32.8	32.7	2	32.8	3.2	104.8
F&G	32.7	32.8	2	32.8	14.2	465.1
G&H	32.8	32.9	2	32.9	3.2	105.1
H&I	32.9	32.6	2	32.8	27.3	894.1
I&J	32,6	32,6	2	32,6	3,8	123,9
J&K	32.6	32.6	2	32.6	1.8	58.7
K&L	32.6	32.6	2	32.6	1.8	58.7
L&M	32.6	32.8	2	32.7	9.2	300.8
M&N	32,8	32,8	2	32,8	1,8	59,0
N&O	32.8	32.8	2	32.8	3.6	118.1
O&P	32.8	32.8	2	32.8	1.8	59.0
P&Q	32.8	33.1	2	33.0	9.2	303.1
Q&R	33.1	33.0	2	33.1	1.8	59.5
RAS	33,0	33,0	2	33,0	1,8	59,4
T&R	33.0	33.1	2	33.1	3.8	125.6
T&U	33.1	33.1	2	33.1	3.9	129.1
U&V	33.1	33.1	2	33.1	5.0	165.5
V&W	33.1	30.5	2	31.8	0.0	0.0
WEX	30,5	30,5	2	30,5	7,4	225,7
X&Y	30.5	33.1	2	31.8	0.0	0.0
Y&Z	33.1	33.1	2	33.1	5.0	165.5
Z&AA	33.1	32.9	2	33.0	8.3	273.9
AA&BB	32,9	32,8	2	32,9	17,8	584,7
BB&CC	32.8	33.0	2	32.9	16.6	546.1
CCADD	33.0	32.7	2	32.9	6.0	197.1
DO&EE	32.7	32.7	2	32.7	0.9	29.4
EE&FF	32.7	32.8	2	32.8	9.6	314.4
FF&GG	32,8	32,8	2	32,8	4,6	150,9
GG&HH	32.8	32.8	2	32.8	2.0	64.3
HH&II	32.8	32.8	2	32.8	1.8	59.0
H&JJ	32.8	32.8	2	32.8	2.0	64.3
JJ&KK	32,8	32,8	2	32,8	4,6	150,9
KKALL	32,8	32,8	2	32,8	2,0	64,3
LL&MM	32.8	32.8	2	32.8	3.6	118.1
MM&NN	32.8	32.8	2	32.8	2.0	64.3
NN&OD	32.8	32.9	2	32.9	9.2	302.2
OO&PP	32,9	32,8	2	32,9	2,0	64.4
PP&QQ	32.8	33.0	2	32.9	3.6	118.4
QQ&RR	33.0	33.0	2	33.0	2.0	64.7
RRASS	33.0	33.2	2	33.1	9.2	304.5
SS&TT	33.2	33.2	2	33.2	2.0	65.1
TT&UU	33,2	33,3	2	33,3	3,6	119,7
UU&VV	33.3	33.3	2	33.3	2.0	65.3
VW&VV	33.3	33.4	2	33.4	4.6	153.4
WW8XX	33.4	33,6	2	33.5	14,4	482.4
YYSXX	33,6	33,5	2	33,6	4,6	154,3
YYAZZ	33.5	33,4	2	33.5	2.0	65.6

ZZ&AAA	33.4	33.2	2	33.3	1.8	61.3
AAA&BBB	33.2	33.2	2	33.2	5.6	187.4
BBB&CCC	33,2	33,2	2	33,2	5,6	184,8
CCC&DDD	33,2	33,2	2	33,2	5,7	189,2
CCC&EEE	33.2	33.2	2	33.2	9.1	303.1
EEE&FFF	33.2	33.8	2	33.5	9.5	318.3
FFF&GGG	33.8	33.7	2	33.8	1.8	60.8
GGG&HHH	33,7	33,9	2	33,8	3,4	114,9
HHAIII	33,9	34,0	2	34,0	1,8	61,1
III&JJJ	34.0	33.9	2	34.0	3.0	101.9
JJJ&KKK	33.9	33.9	2	33.9	1.8	61.0
KKK&LLL	33.9	33.7	2	33.8	10.0	338.0
LLL&MMM	33.7	33.8	2	33.8	3.8	128.3
MMMS NAN	33,8	33,8	2	33,8	1,8	8,08
0003/4/4	33.8	33.8	2	33.8	7.8	263.6
OOO&PPP	33.8	33.8	2	33.8	1.8	8.03
PPP&QQQ	33.8	33.8	2	33.8	3.4	114.9
QQQ&RRR	33,8	33,8	2	33,8	1,8	8,03
RRR&SSS	33.8	33.8	2	33.8	7.4	250.1
SSSATTT	33.8	33.8	2	33.8	1.6	60.8
TTT&UUU	33.8	33.8	2	33.8	3.0	101.4
VVV&UUU	33.8	33.8	2	33.8	1.8	60.8
WWWSVVV	33,8	33,8	2	33,8	7,4	250,1
WWWBXXX	33.8	33.8	2	33.8	1.8	60.8
YYYSXXX	33.8	33.8	2	33.8	3.0	101.4
YYY&ZZZ	33.8	33.6	2	33.7	11.6	389.7
ZZZ&A4	33.6	33.7	2	33.7	2.6	88.8
A48B4	33,7	33,5	2	33,6	3,6	122,1
B4&C4	33.5	33.6	2	33.6	3.0	100.7
C4&D4	33.6	33.5	2	33.6	1.8	60.4
D48E4	33.5	33.5	2	33.5	3.4	113.9
E48F4	33,5	33.6	2	33,6	1.8	60,4
F4&G4	33.6	33.6	2	33.6	3.0	100.8
G48H4	33.6	33,6	2	33.6	1.8	60.5
H4814	33.6	33.6	2	33.6	3.4	114.2
148.J4	33.6	33.6	2	33.6	1.8	60.5
J48K4	33,6	33.6	2	33,6	3.0	100,8
K48L4	33.6	33.6	2	33.6	1.8	60.5
L481//4	33.6	33.6	2	33.6	1.6	53.8
M48N4	33.6	33.2	2	33.4	8.3	276.7
N4&O4	33.2	33.2	2	33.2	24.5	811.9
O4&P4	33,2	33.2	2	33,2	13.8	458,5
P4&Q4	33.2	33.2	2	33.2	13.9	460.5
Q48R4	33.2	33.3	2	33.3	1.1	35.2
R4&S4	33.3	33.3	2	33.3	1.8	59.9
S4&T4	33,3	33.8	2	33,6	5.4	181.2
T48.U4	33.8	33.6	2	33.7	3.4	114.6
U4&V4	33.6	33.5	2	33.6	1.8	60.4
V48W4	33.5	33.4	2	33.5	3.0	100.4
W48.X4	33.4	33.5	2	33.5	1.8	80.2
X48Y4	33,5	33.4	2	33,5	3,4	113.7
Y48Z4	33.4	33.4	2	33.4	1.8	60.1
Z4&A5	33.4	33.4	2	33.4	3.0	100.2

CONTINUED

58.G5	33.3 33.5	33.5 33.5	2 2	33.4 33.5
35& H5	33.5	33.8	2	33.7
15 &15	33.8	33.8	2	33.8
5&J5	33.8	33.8	2	33.8
J5&K5	33.8	33.8	2	33.8
<5&L5	33,8	33,8	2	33,8
.58.M5	33.8	33.8	2	33.8
458.N5	33.8	33.8	2	33.8
V58-O5	33.8	33.8	2	33.8
D5&P5	33.8	33.8	2	33.8
P58Q5	33.8	33.8	2	33.8
258.R5	33.8	33.8	2	33.8
258.95	33.8	33.9	2	33.9
35&T5	33.9	33.9	2	33.9
15&U5	33.9	33.9	2	33.9
J58V5	33.9	34.0	2	34,0
/58W5	34.0	34.2	2	34.0
M58X5	34.0	34.2	2	34.2
166A5 K58Y5	34.2	34.0		34.1
58Z5			2 2	
	34,0	34,0		34,0
25&A6	34.0	34.0	2	34.0
46&B6	34.0	33.0	2	33.5
368/06	33.0	32.9	2	33.0
278D6	32,9	30,5	2	31,7
068E6	30.5	30.5	2	30.5
588F6	30.5	32.6	2	31.6
-68 G6	32.6	32.5	2	32.6
36&H6	32.5	32.6	2	32.6
-16&16	32,6	32,5	2	32,6
6&A	32.5	32.5	2	32.5

X length of side TOTAL

BUILDING 2 - AVERAGE GRADE CALCULATION

INCLUDES: 1.) TOWNHOUSE 2


	corner	+ corner		average grade	X length of	
side	grade point	grade point	12	per side	side	TOTAL
A&B	32,7	32,6	2	32,7	14,4	471,6
B&C	32.6	32.6	2	32.6	4.6	150.0
C&D	32.6	32.6	2	32.6	2.0	63.9
D&E	32.6	32.6	2	32.6	3.6	117.4
E&F	32,6	32,6	2	32,6	2,0	63,9
F&G	32,6	32,6	2	32,6	9,2	299,9
G&H	32.6	32.6	2	32.6	2.0	63.9
H&I	32.6	32.6	2	32.6	3.6	117.4
l&J	32.6	32.6	2	32.6	2.0	63.9
J&K	32,6	32,4	2	32,5	9,2	299,0
K&L	32.4	32.4	2	32.4	2.0	63.5
L&M	32.4	32.4	2	32.4	3.6	116.6
M&N	32.4	32.4	2	32.4	2.0	63.5
N&O	32.4	32.5	2	32.5	4.6	149.3
O&P	32,5	32,5	2	32,5	7,2	234,0
P&Q	32.5	32.8	2	32.7	2.0	64.0
Q&R	32.8	32.7	2	32.8	1.8	59.0
R&S	32.7	32.5	2	32.6	2.0	63.9
S&T	32,5	32,5	2	32,5	10,0	325,0
T&U	32.5	32.8	2	32.7	2.0	64.0
U&V	32.8	32.8	2	32.8	3.6	118.1
V&W	32.8	32.6	2	32.7	2.0	64.1
Wax	32.6	32.7	2	32.7	4.6	150.2
X&Y	32,7	32,6	2	32,7	7,2	235,1
Y&Z	32.6	32.4	2	32.5	12.8	416.0
Z&AA	32.4	32.4	2	32.4	3.8	123.1
AA&BB	32.4	32.5	2	32.5	1.6	51.9
BB&CC	32,5	32,5	2	32,5	3,6	117.0
CCⅅ	32.5	32.5	2	32.5	1.6	52.0
DD&EE	32.5	32.8	2	32.7	9.2	300.4
EE&FF	32.8	32.8	2	32.8	1.6	52.5
FF&GG	32.8	32.8	2	32.8	3.6	118.1
GG&HH	32,8	32,8	2	32,8	1,6	52,5
HBII	32.8	32.8	2	32.8	4.6	150.9
II&JJ	32.8	32.8	2	32.8	1.6	52.5
JJ&KK	32.8	32.8	2	32.8	1.8	59.0
KK&LL	32,8	32,8	2	32,8	1,6	52,5
LL&A	32,8	32,7	2	32,8	4,6	150,7

AVERAGE GRADE FOR BUILDING 2

	X length of side	TOTAL	
			GRADE = TOTAL Perimeter
Perimeter	160.4	5230.0	32.6

akran.	NEPTEMBER 1000	Taran Sa	1957 7 A 205 Plans own
	18/12/16	Property Security	NISC TO FORMANIO REVIEW
-	18/13/16	00000	MRE TO PLANNING REVIEW
	28/97/10		B3080 FOR 40
- 2	12/13/06		\$6000 FOR COTA
4	28/8313		RE-RISURD FOR COTW
5	23/59/01		RE-ISSUED FOR COTV.

d-Ka	dHKarchitect
VICTORM OFFICE BIT First Street Victoria BC VEV DHO T 1-150-658-1967	NAMEDO OFFICE 102-5170 DUBLIO WAY NAMED DO VOTOK TI-250-595-5915
Caledonia	
Victoria BC	
Victoria BC Average Grade	Calculations

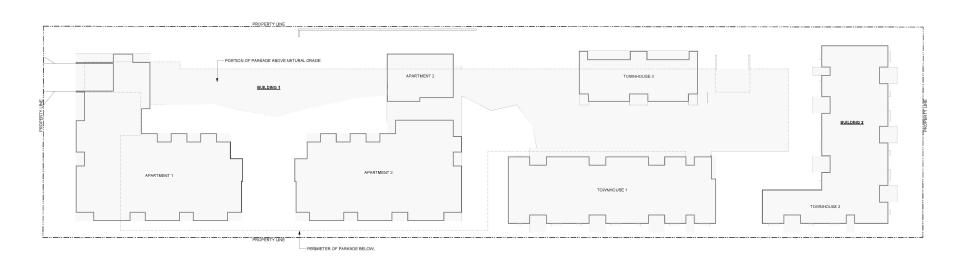

SITE COVERAGE - CALCULATION


SUM OF GROSS AREA OF LOT OCCUPED BY ANY STRUCTURE INCLUDING:

1.) APARTMENT 1
2.) APARTMENT 2
3.) TOWNHOUSE 1
4.) TOWNHOUSE 3
5.) PORTION OF PARKADE ABOVE NATURAL GRADE (>33.2 m)

CURRENT: BUILDING AREA 4,957 m²/LOT 8681.14 m² = 57%

at on	8EPTEMBER 2500	many 1987.2 A 208 Plonsows
Per	Dep	Description
	1871316	RESPONSE TO PLANNING REVIEW
2	28/97/10	BBUED FOR ADE
- 2	12/03/06	\$6000 FOR COTA
4	(849)13	RE-B9UED FOR COTA
5	20/9901	RE-INNUED FOR COTA

dHKar	hitect
103-51700	Vet ak
Calculations	
Among	marks to
	dHKare Residence of the control of

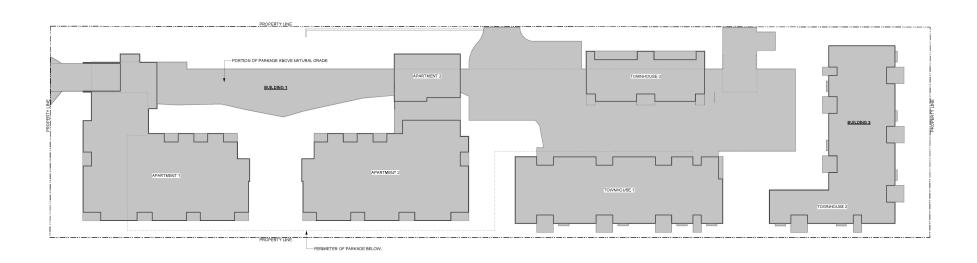

OPEN SITE SPACE - CALCULATION

PORTION OF THAT'S LANDSCAPED AND NOT OCCUPIED OR OBSTRUCTED LOT OCCUPIED BY ANY BUILDING OR PORTION OF BUILDING.

AREA INCLUDES


- 1.) APARTMENT 1 2.) APARTMENT 2 3.) TOWN-HOUSE 1 4.) TOWN-HOUSE 3 5.) PORTION OF PARKADE ABOVE NATURAL GRADE (>33.2 m)


 $\frac{\text{CURRENT:}}{\text{LOT 8,681.1} \text{m}^2 - \text{BUILDINGS, DRIVEWAYS \& SURFACE PARKING 5,225 m}^2 = 3,456.1 \text{ m}^2/8681.1 = 40\%$


NLC	dutot k	P5//
8EPTEMBER 2000	may to 1937;	A208 Plansove
Dep	benights	
18/13/16	RESPONSE TO PU	MIND REVIEW
28/97/10	15	BUED FOR ADE
22/03/05	\$66	JED FOR COTY
28/83/19	8649	JED FOR COTY
29/89/01	85-833	/60 FOR COTV
	28/83/19 22/83/06 28/83/10 18/13/16 040 86/11EM/60/9 25/20	289312 RF-RG9 289305 RG9 289305 BS9 187306 RS9 PARRE TO PLA 500 BS9 PARR


VECTARRA OFFICE BIT Fit Street Victoria BC VEV DMG T 1-250-658-2967	103-5170 O/ Nataino 60 T 1-250-583	
		1 V9T 1H
Caledonia		
Victoria BC		
Open Site Space	Calculatio	ns




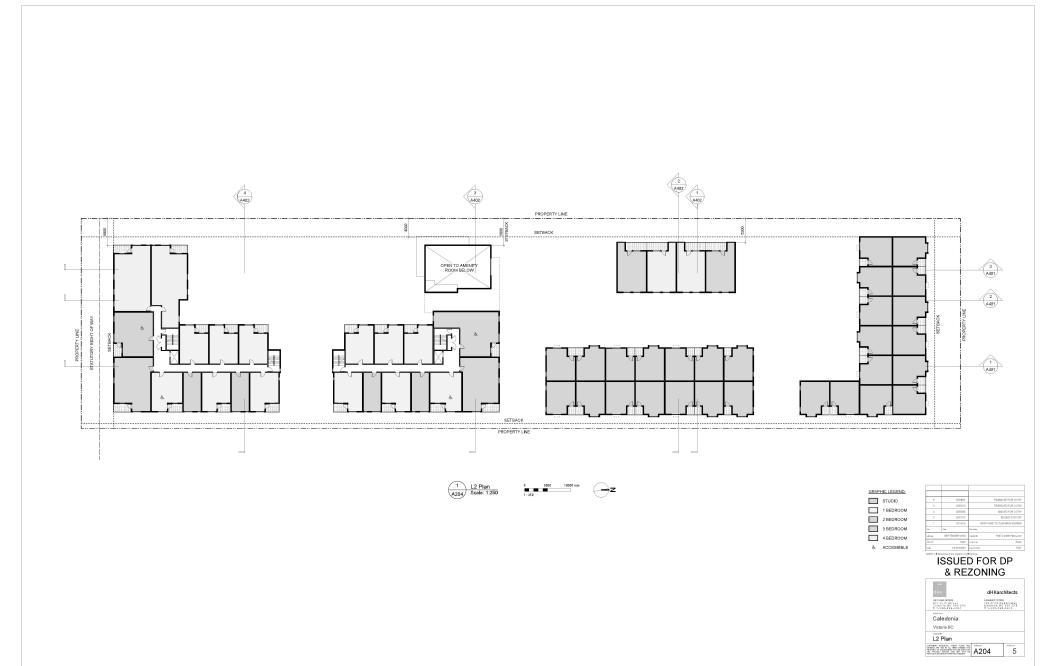

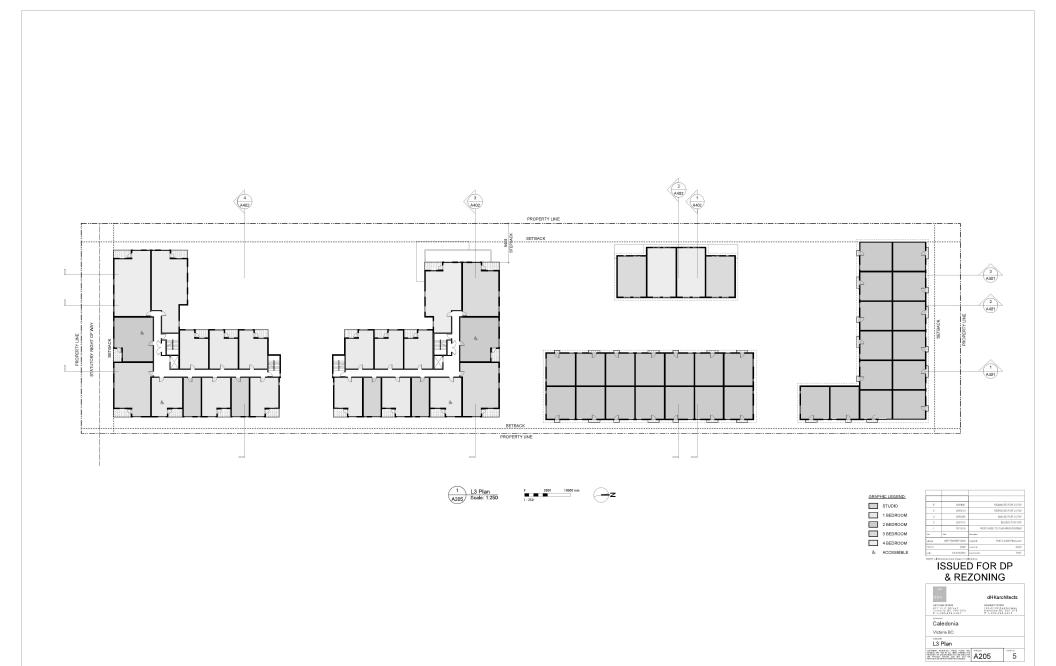

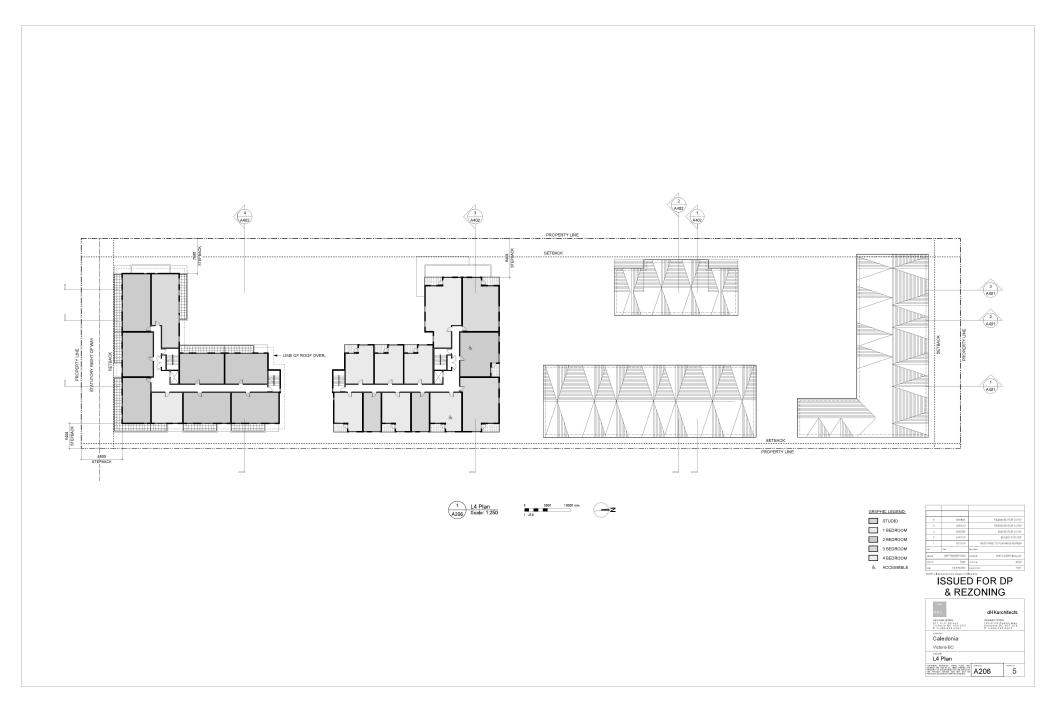

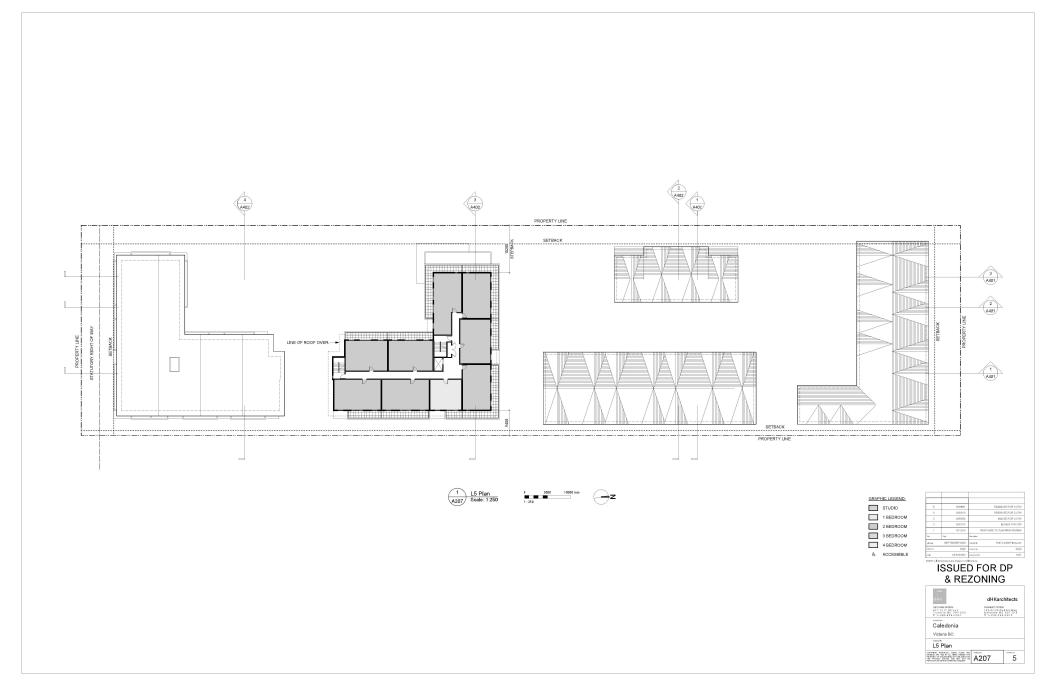

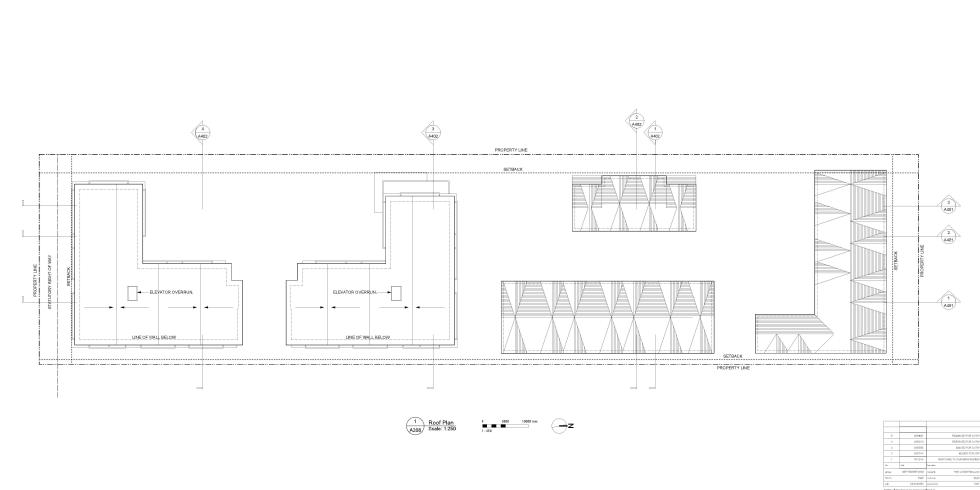

— d-Ka	dHKa	rchitects
VECTARA OFFICE WIT Full Street Victoria BC VEV DHO T 1-20-658-2967	RAMAROOF	Facel Dualin way
Caledonia		
Victoria BC		
Roof Plan		
COPARIOR SERVICE, THESE FLACE NO DESIGNATIONS NOW ALL THESE PERSONS THE PROJECT SHOWN NO MAY NOT SE PROJECT SHOWN NO MAY NOT SE PROTECTIONS NOW WAY NOT SE	A208	5







Apartment 2 - South
Scale: 1:100

COLOUR & MATERIALS LEGEND

- BRICK VENEER Red Apartment 1 Only
- 2 FIBRE CEMENT PANEL Teal
- 3 VINYL WINDOWS & DOORS Teel
- PREFINISHED ALUMINUM GLARD, FRAME & PICKETS Teal
- 5 METAL FLASHING Teel
- 6 ACCENT PAINT COLOUR Rust
- 7 FIBRE CEMENT LAP SIDING Soft Brown
- 8 FIBRE CEMENT PANEL Warm Grey Apartment 2 Only
- 9 SOFFIT Warm Grey Apartment 2 Only
 10 PAINTED CONCRETE Warm Grey
- 11 FIBRE CEMENT PANEL Werm White
- 12) SOFFIT Warm White
- 13 FIBRE CEMENT LAP SIDING Medium Blue-Grey

- 14) FIBRE CEMENT LAP SIDING White
- 15 VINYL WINDOWS & DOORS Dark Grey
- PREFINISHED ALUMINUM GUARD & FRAME Dark Grey
- 17 METAL FLASHING Dark Grey
- 18 ASPHALT SHINGLES Warm Grey
- 19 FIBRE CEMENT SHINGLES Warm Grey
- 20 VINYL WINDOWS & DOORS White
- 21 METAL DOWNSPOUT & FLASHING Light Warm Grey
- 22 FIBRE CEMENT PANEL Dark Grey
- 23 FIBRE CEMENT PANEL Light Grey
- 24 ACCENT PAINT COLOUR Bright Grange
 25 ACCENT PAINT COLOUR Bright Blue
- 28 ACCENT PAINT COLOUR Chartreuse



		1:100	
NEASSUED FOR COT		200901	,
REMEMBER FOR COTA		2009/13	14
BISUED FOR COTA		20/00/06	3
BSUED FOR AD		20/0/015	
POISE TO PLAINING REVEN	nese	19/12/18	1
	breite	1 m	fm .
1987.2.4200 Filmsum	the high	SOFTEWER 2009	acto
PAV.	chelled by	MLC.	there by
191	payment	AS SHOWN	ice.

-		
dнка	dHKa	architects
VECTORA OFFICE STT FOIL STIFFE Victoria De Velvaka T 1-250-658-2257	NOMEMO DE 102-9193 Nonzimo 7 1-250-	DUDIES WAY
Caledonia		
Victoria BC		
Elevations - Ap	artment 2	
COPYRIGHT PETERVISO, THESE PLANT HAS DESCRIBED HAS HAD AT ALL THESE PERMAN THE PROPERTY OF THE HAS AND HAVE FOR THE PETERVISOR HAS HAVE BEEN AND HAVE BEEN REPORTED HERE.	A302	5







Apartment 2 - West Scale: 1:100

COLOUR & MATERIALS LEGEND

- BRICK VENEER Red Apartment 1 Only
- 2 FIBRE CEMENT PANEL Teal
- 3 VINYL WINDOWS & DOORS Teal
- PREFINISHED ALUMINUM GUARD, FRAME & PICKETS Tool
- 5 METAL FLASHING Teal
- 6 ACCENT PAINT COLOUR Rust
- 7 FIBRE CEMENT LAP SIDING Soft Brown
- 8 FIBRE CEMENT PANEL Warm Grey Apartment 2 Only
- 9 SOFFIT Warm Grey Apartment 2 Only 10 PAINTED CONCRETE - Warm Grey
- 11) FIBRE CEMENT PANEL Warm White
- 12 SOFFIT Warm White
- 13 FIBRE CEMENT LAP SIDING Medium Blue-Grey

- 14) FIBRE CEMENT LAP SIDING White
- 15 VINYL WINDOWS & DOORS Dark Grey
- PREFINISHED ALUMINUM GUARD & FRAME Dark Grey
- METAL FLASHING Dark Grey
- 18 ASPHALT SHINGLES Warm Grey
- 19 FIBRE CEMENT SHINGLES Warm Grey
- 20 VINYL WINDOWS & DOORS White
- 21) METAL DOWNSPOUT & FLASHING Light Warm Grey 22 FIBRE CEMENT PANEL - Dark Grey
- 23 FIBRE CEMENT PANEL Light Grey
- 24 ACCENT PAINT COLCUR Bright Grange 25 ACCENT PAINT COLOUR - Bright Blue
- 28 ACCENT PAINT COLGUR Chartreuse




		1:100	
NEASSUED FOR COTY		2009/01	
RE49EUED FOR COTV		20/09/13	14
BISUED FOR COTV		20/0/66	2
BSUED FOR AD		20/01/15	
ORSE TO PLANNING MEVIEW	nesec	19/12/18	
	Designa	lan.	fm .
1987.2.3350 Planson	many the	SIGNTEMBER 2028	acto
RW	shell of Se	NLC	there by
190	popularies	AS SHOWN	ice.

dHKa	dHKa	architects
VICTORIA GIPROE STT FOIL BLOCK VICTORIA DE VINVORCO T 1-200-008-2287	NAME OF THE PARTY	PROB DUDITE WAS DO VATION DESTRACTOR
Caledonia		
Victoria BC		
Elevations - Ap	artment 2	
COPYRIGHT PETERVIO, THESE REACH HIS DESIGNED HIS HIS AT ALL THIRD REMAIN THE PROPERTY OF SHAME WITCH TO BE USED FOR	A303	5





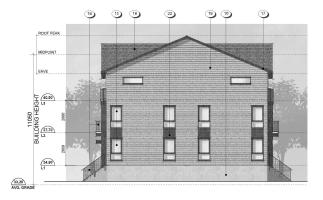

Townhouse 1 - South Scale: 1:100



Townhouse 1 - East Scale: 1:100



Townhouse 1 - West Scale: 1:100

COLOUR & MATERIALS LEGEND

- 1 BRICK VENEER Red Apartment 1 Only
- 2 FIBRE CEMENT PANE. Teel
- 3 VINYL WINDOWS & DOORS Teal
- PREFINISHED ALUMINUM GUARD, FRAME & PICKETS Test
- 5 METAL FLASHING Teel
- ACCENT PAINT COLOJR Rust
- 7 FIBRE CEMENT LAP SIDING Soft Brown
- 8 FIBRE CEMENT PANE. Warm Grey Apartment 2 On
- 9 SOFFIT Warm Grey Apartment 2 Only
- 10 PAINTED CONCRETE Warm Grey
- FIBRE CEMENT PANEL Warm White
 SOFFIT Warm White
- 13 FIBRE CEMENT LAP SIDING Medium Blue-Grey

- 14) FIBRE CEMENT LAP SIDING WHIte
- 15 VINYL WINDOWS & DOORS Dark Grey
- 16) PREFINISHED ALUMINUM GUARD & FRAME- Dark Grey
- 17 METAL FLASHING Dark Grey
- 18 ASPHALT SHINGLES Warm Grey
- 19 FIBRE CEMENT SHINGLES Warm Grey
- VINYL WINDOWS & DOORS White
- 21 METAL DOWNSPOUT & FLASHING Light Wirm Grey
- 22 FIBRE CEMENT PANEL Dark Grey
 23 FIBRE CEMENT PANEL Light Grey
- 24) ACCENT PAINT COLOUR Bright Or
- 25 ACCENT PAINT COLOUR Bright Blue
- 26 ACCENT PAINT COLOUR Chartreuse



ISSUED FOR DP & REZONING

-	
dHKa	dHKarchitects
VECTORA OFFICE STT FOIL STIPPE VICTORIA DE VEVIDES T 1-210-618-2351	NOMINO OFFEE 102-5180 DUDIN WAY NOTHING BC VETTICE T1-250-588-5810
Caledonia	
Victoria BC	

Elevations - Townhouse 1

Correct PELEVIC, 1405 Kind Ind.
Corr





Townhouse 2 - East Scale: 1:100



Townhouse 2 - South Scale: 1:100



Townhouse 2 - West Scale: 1:100

COLOUR & MATERIALS LEGEND

- BRICK VENEER Red Apartment 1 Only
- 2 FIBRE CEMENT PANEL Teal
- 3 VINYL WINDOWS & DOORS Teal
- PREFINISHED ALUMINUM GUARD, FRAME & PICKETS Teal
- 5 METAL FLASHING Teal
- 6 ACCENT PAINT COLOUR Rust
 7 FIBRE CEMENT LAP SIGNG Soft Brown
- 8 FIBRE CEMENT PANEL Warm Grey Apr
- 9 SOFFIT Warm Grey Apartment 2 Only 10 PAINTED CONCRETE - Warm Grey
- 11) FIBRE CEMENT PANEL Warm White
- 12 SOFFIT Warm White
- 13 FIBRE CEMENT LAP SIGNG Medium Blue-Grey


- 14 FIBRE CEMENT LAP SIDING WINTE
- 15 VINYL WINDOWS & DOORS Dark Grey
- 16 PREFINISHED ALUMINUM GUARD & FRAME Dark Grey
- ASPHALT SHINGLES Warm Grey
- 19 FIBRE CEMENT SHINGLES Warm Grey
- 20 VINYL WINDOWS & DOORS White
- 21) METAL DOWNSPOUT & FLASHING Light Warm Grey
- 22 FIBRE CEMENT PANEL Dark Grey 23) FIBRE CEMENT PANEL - Light Grey
- 25 ACCENT PAINT COLOUR Bright Blue
- 26 ACCENT PAINT COLOUR Chartreuse

	1:100	
- 1	20/08/01	NEASEURD FOR COT
- 4	20/09/13	REMEDICAL COTS
	2010/08	INSUED FOR COT.
2.	20/0/015	BSUED FOR AD
1	19/12/16	RESPONSE TO PLANNING REVISA
fer.	tot.	Irraylar
jac tox	SEPTEMBER 2028	month 1907.2 A200 Planson
there'ry	NLC	shows by RW

ISSUED FOR DP & REZONING

— d-Ka	dHKarchitects
VECTORN OFFICE STT FULL Billion Victoria DG VBV acca T 1-210-618-2387	NAMED OFFICE 102-\$150 DUBLIF WAY NATION BY VET 2KP T 1-250-581-5810
Caledonia	
Victoria BC	
Aware He	

Elevations - Townhouse 2 COPYRIGHT PETER/RD, THEN FASC MO DESIGNANT THE PETER CONTROL OF THE PETE

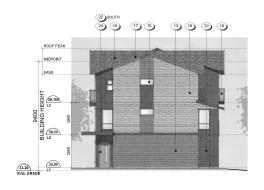



Townhouse 3 - North (South sim.)
Scale: 1:100

Townhouse 3 - East A306 Scale: 1:100



Townhouse 3 - West Scale: 1:100

COLOUR & MATERIALS LEGEND

1 BRICK VENEER - Red - Apartment 1 Only 2 FIBRE CEMENT PANE. - Test

3 VINYL WINDOWS & DOORS - Teal

PREFINISHED ALUMINUM GUARD, FRAME & PICKETS - Teal

5 METAL FLASHING - Teel

ACCENT PAINT COLOUR - Rust
 FIBRE CEMENT LAP SIDING - Soft Brown
 FIBRE CEMENT PANE. - Warm Grey - Apertment 2 Only

9 SOFFIT - Warm Grey - Apartment 2 Only

10 PAINTED CONCRETE - Warm Grey

11) FIBRE CEMENT PANEL - Warm White 12 SOFFIT - Warm White

13 FIBRE CEMENT LAP SIDING - Medium Blue-Grey

14 FIBRE CEMENT LAP SIDING - White

15 VINYL WINDOWS & DOORS - Dark Grey

18 ASPHALT SHINGLES - Warm Grey 19 FIBRE CEMENT SHINGLES - Warm Grey

20 VINYL WINDOWS & DOORS - White

21) METAL DOWNSPOUT & FLASHING - Light Warm Grey

22 FIBRE CEMENT PANEL - Dark Grey

23 FIBRE CEMENT PANEL - Light Grey


24 ACCENT PAINT COLOUR - Bright Orange

25 ACCENT PAINT COLOUR - Bright Blue


26 ACCENT PAINT COLOUR - Chartreuse


NEWSTREEN COMM		TOTAL	-,-
REASEUED FOR CUTV		2009/13	4
BRUED FOR COTA		2090/06	- 7
BSUED FOR ADE		20/01/15	
AISE TO PLANNING REVIEW	Mesero	1912/18	
	breite	tie.	fm .
1987.2.8300 Plans year	riscing the	SOFTEWER 2028	acto
RAVA	photostic	NLC.	there by
1997	mart boder	AS SHOWN	10

dHKa	dHKarchitects
VECTORAL OFFICE STT FOIL STIPET VICTORIS DC VEV SKS T 1-210-618-2251	NOW MED OFFICE 102-8180 DUDIES WAS NORTHED BY VATION \$ 1-250-588-5810
Caledonia	
Victoria BC	
Elevations - Toy	mhouse 3

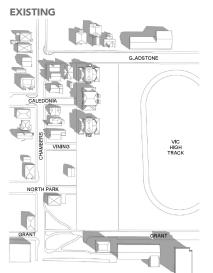


9:00AM - SEPTEMBER 21ST

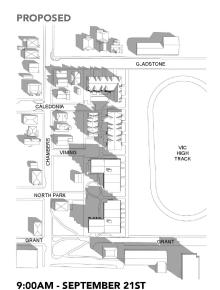


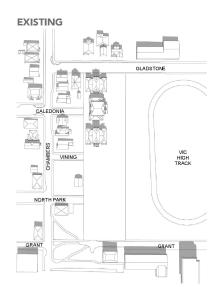


12:00PM - SEPTEMBER 21ST

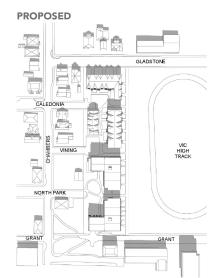

12:00PM - SEPTEMBER 21ST

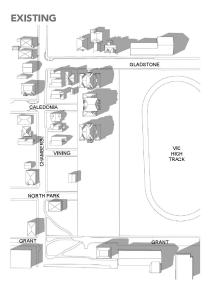

4:00PM - SEPTEMBER 21ST

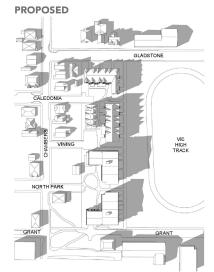

4:00PM - SEPTEMBER 21ST

4 389319 SERVICE PORT OF THE TOTAL OF THE TO
9 388306 \$64500 FOR COTA. 2 388315 \$85000 FOR COTA. 1 \$87306 \$85000 FOR COTA. Per \$100 \$85000 FOR COTA. Per \$100 \$85000 FOR COTA.
9 364366 BBANDFOR COTA 2 268310 BBNED FOR ADR 1 167216 RESPONSE TO PLANNING REVIEW
2 28/03/05 B94/50/FOR COTW. 2 28/03/10 B39/20/FOR ADR
a saleses permotor conv.
4 SMENTS RE-RESURD FOR COTA
6 SMINGT REASONED FOR COTTA

ISSUED FOR DP & REZONING

d-Ka	dHKarchite	cts
VICTORA OFFICE STT Filt Street Victoria BC VSV SHO T 1-150-658-1967	HAMMEDO OFFICE 102-5 190 DUBLIN Namalina BC VO T 1-250-595-59	
Caledonia		
Victoria BC		
Shadow Studies		



BEFORE - LOOKING WEST - FROM VIC HIGH



AFTER - LOOKING WEST - FROM VIC HIGH

NLC	manuta; PAN
86PTEMB69 2000	managrik 1907 A367 Sharkov Studies, vvo
0 mar	Description
18/13/16	RESPONSE TO PLANNING REVIEW
29/97/10	BBUED FOR ADI
22/03/06	paugo for conv
28/83/19	RE-INGUIGO FOR COTA
29/89/01	RE-ISSUED FOR COTV
	28/9313 22/9304 23/9315 18/1318





BEFORE LOOKING WEST - FROM GRANT STREET



BEFORE - LOOKING WEST - FROM GLADSTONE AVENUE



AFTER LOOKING WEST - FROM GRANT STREET



AFTER LOOKING WEST - FROM GLADSTONE AVENUE

RE-BISSUED FOR COTV.		23/59/01	- 5
REIDGUED FOR COTW		28/83/13	4.
\$60 FOR COTA		22/03/06	- 2
BBUED FOR ADP		28/87/10	2
POUSE TO PLANNING REVIEW	RE	18/12/16	
	Description	t ear	Per
1907 A367 Shadow Studies, wo	nany fi	BEPTEMBER 2000	i de mo
RSW	Product No.	NLC	desde
1807	and electric	70.5%	***

d-Ka	dHKarchitects
VICTORIA OFFICE	NAMES OF SEC.
STT Filt Street Victoria BC VSV DKD	Natalitie BC V9T 2KB
T 1-250-658-296T	T 1-250-595-5910
pojednami	
Caledonia	
Victoria BC	

N 100 K AL TRUS FIRMS THE ASIA ASIA ASIA



BEFORE LOOKING EAST - FROM CALEDONIA AVE.



AFTER LOOKING EAST - FROM CALEDONIA AVE.



BEFORE LOOKING EAST - FROM NORTH PARK ST.



AFTER LOOKING EAST - FROM NORTH PARK ST.

REASOURD FOR COTW		20/09/01	5
RE-ISSUED FOR COTW		28/83/13	4
BIGURD FOR COTW		12/03/06	- 2
BSUED FOR ADP		28/87/10	2
SPONSE TO PLANNING REVIEW	91	18/12/16	
	Description	t-se	Per
1907 A367 Shadow Studies, www	marky %	BEPTEMBER 2000	i de mos
RAV	(feel) of \$1	NLC	desde
1907	poperturate	70.5%	***

Section of Page 1 Standard Confess 1 Standard Confe	d-Ka	dHKa	rchitect
Caledonia Victoria BC	Victoria BC VEV DHO	102-51401	Dustin Way
	Victoria BC		
View Analysis	View Amelysis		



LOOKING SOUTH - GLADSTONE AVENUE



LOOKING EAST - NORTH PARK STREET



8EPTEM 8EP 2000	nway to 1907 A307 Shadow Studies, we
tea.	Description
18/13/16	RESPONSE TO PLANNING REVIEW
20/07/10	BBUED FOR ADI
22/03/06	paugo for conv
28/83/19	RE-INGUIGO FOR COTA
29/9901	RE-ISSUED FOR COTV
	28/93/3 26/93/6 26/93/6 18/13/18

-		
d-Ka	dHKaro	hitec
VICTARIA OFFICE PTT Filt Street Victoria BC VEV DRO T 1-250-658-2967	103-5170 DE 103-5170 DE Natalino SO T 1-250-595	stin wa
Caledonia		
Victoria BC		
Perspective St	udies	
COPPORT SERVICE, THERE FLARE MOD DESIGNED AND MODIFICATION FROM THE PROPERTY OF SHADOWERCH TO BE SERVICED FOR THE PRODUCT SHADOW MOD MAY NOT BE PROTOCOLOGIC NOTWART ME COMMENT	A311	POTEN N

LOOKING EAST - VINING STREET



TOWNHOUSES - AT GLADSTONE AVENUE



APARTMENT - AT GRANT STREET





PLAYGROUND & AMENITY AREA - LOOKING NORTH

BEPTEMBER 2000 NLC	may in 1907 A367 Shadow Studies, wo
t-on	Description
18/13/16	RESPONSE TO PLANNING REVIEW
28/97/10	BBUED FOR ADE
10/03/06	\$6000 FOR COTA
28/8319	RE-INGUISD FOR COTW
55/99/01	REASSUED FOR COTV
	284919 284906 284910 187218

d -Ka	dHKarchitect
VICTORIA OFFICE BTT Filt Street Victoria BC VBV DHO T 1-250-654-1967	HAMMED OFFICE 102-5170 DUELIN WA HAMETING BC VOT 2K T 1-250-595-5915
Caledonia	


Perspective Studies
Correct Status - real Falls for St





Context Elevations
Scale: 1: 300

	200900		NEWSCHOOL COM-
		_	
14	2009/13		REABSUED FOR COTA
- 3	2090/06		BINGS FOR COTA
. 2	20/01/15		BSUED FOR ADE
	1912/18	nesro	AISE TO PLANNING REVIEW
In	tue.	Designa	
packer.	SOFTEMBER 2028	ducing the	1987.2 A200 Plansues
there by	PAPING	chebathy.	RAV
ua.	45 5H 26N	mart boder	1981


dHK	architect
192-1110 Nonzino	PROE DUDIN WA- DC VATIK EES-SSIO
ations	
Barry to,	bell to its
	NAME AND THE PARTY OF THE PARTY

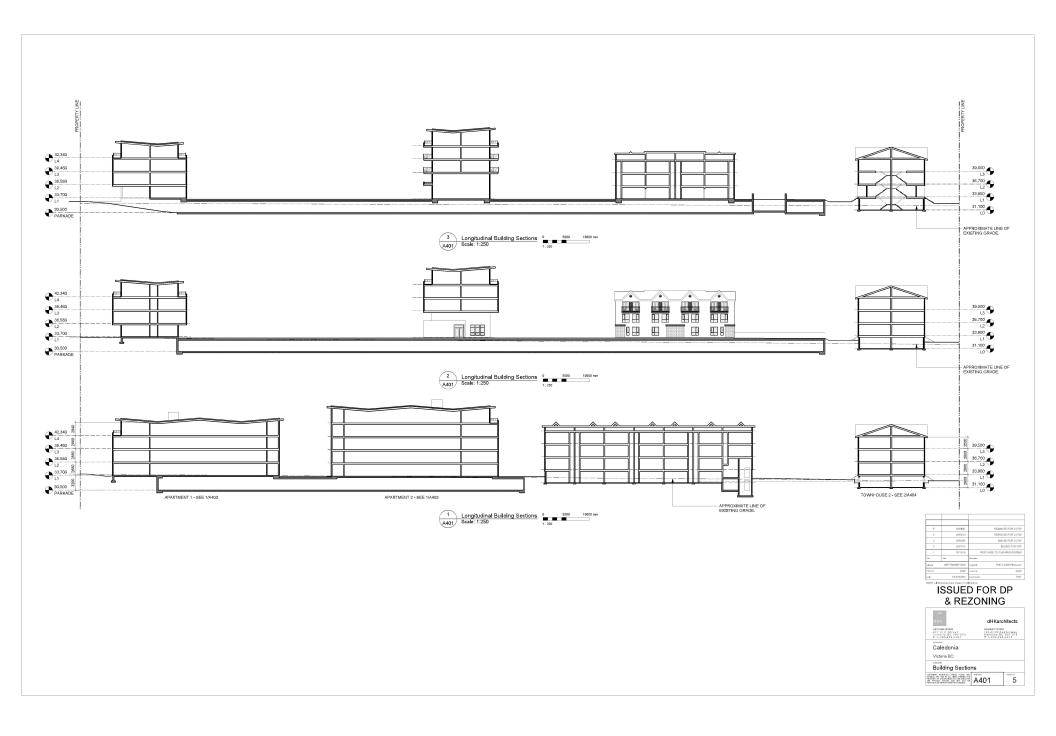

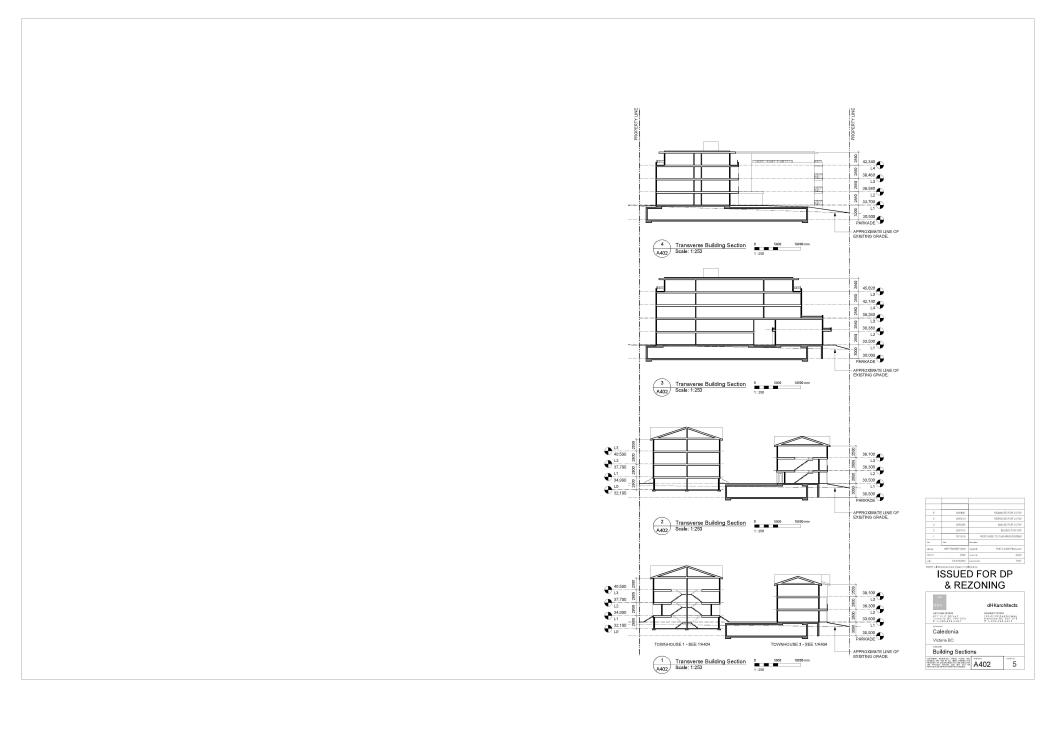

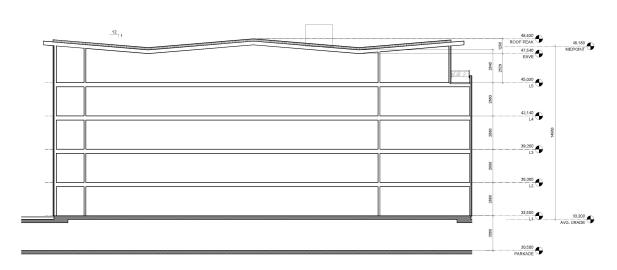




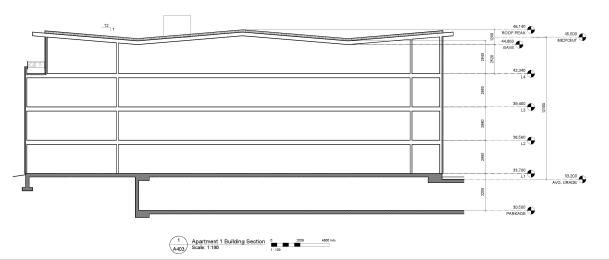


-	BEPTEMBER 2020 FWPNLD	manages 1957/2/A205 Plants/
Per		
-	Delar .	Description .
,		Description
- 1	18/13/16	RESPONSE TO PLANNING REVIE
2	29/87/10	BSUED FOR A
- 2	10/03/01	paugo por con
4	28/83/12	RE-INSUED FOR COT
5	20/09/01	RE-BISSUED FOR COT

HAMMED OFFEE 102-5170 DA Name TO DO T 1-250-595	alio way
	PATRICE.
	403

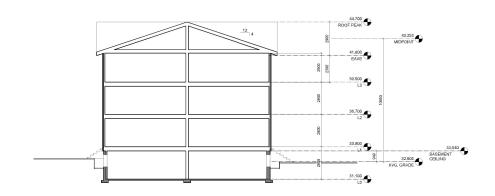




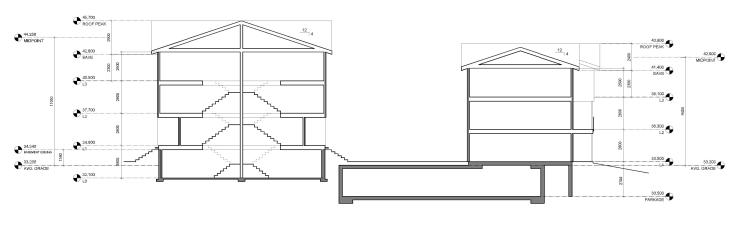


Per	two .	Description	
	18/12/16	RESPI	HISE TO PLANNING REVIEW
	28/97/10		BBUSD FOR ADR
- 2	22/03/06		BIGURD FOR COTA
4	(8491)		RE-INGUIGO FOR COTW
5	23/59/01		RE-ISSUED FOR COTV.


d-Ka	dHKa	rchitects
VECTARRA OFFICE FIT Full Street Victoria BC VEV DRO T 1-250-658-2967	HAMMEDO CE 102-5190 Hammino # 1-250-1	Dustin Way
Caledonia		
Victoria BC		
Building Section	ns	
COPARDAT SERVICES, THESE PLANE MOD DESIDENT AND MICH ALL TRADE FROM THE PROJECT OF SHADOLESCIE STAR WISCOME THE PROJECT SHOWN MICH MAY NOT BE	A404	5



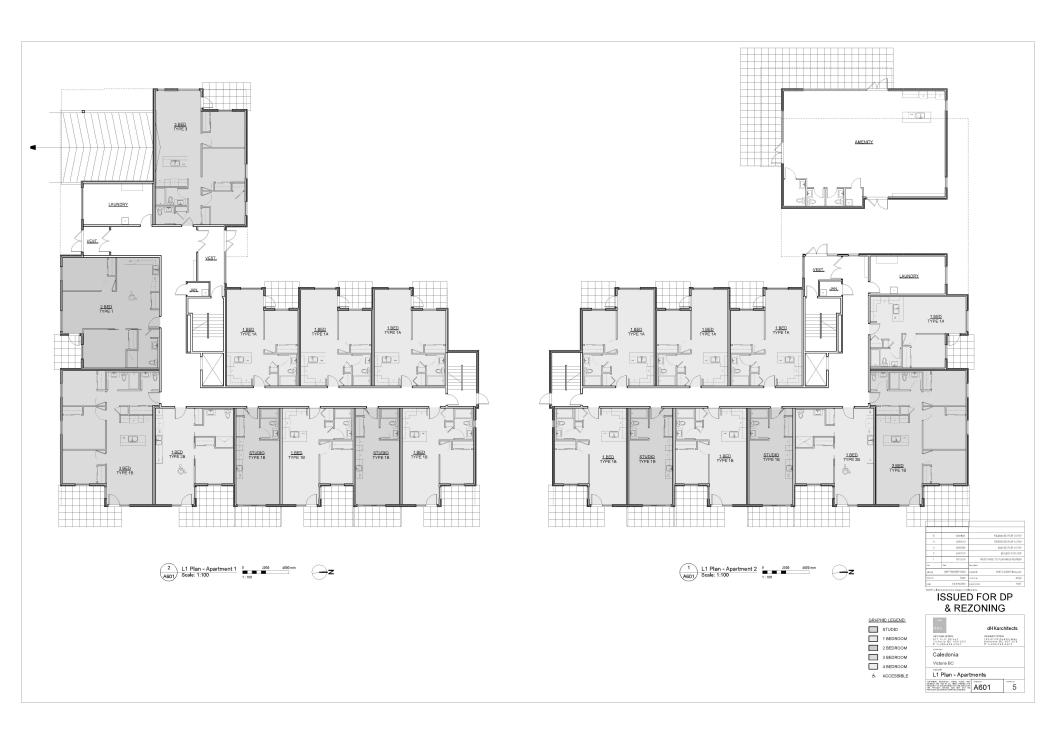

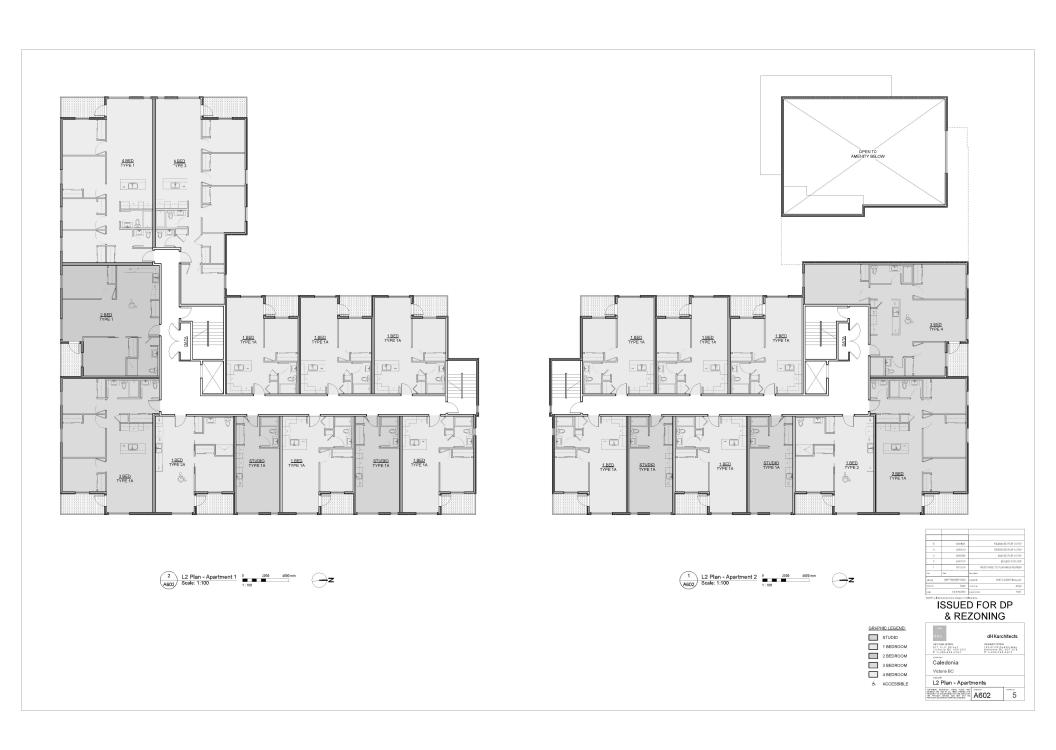



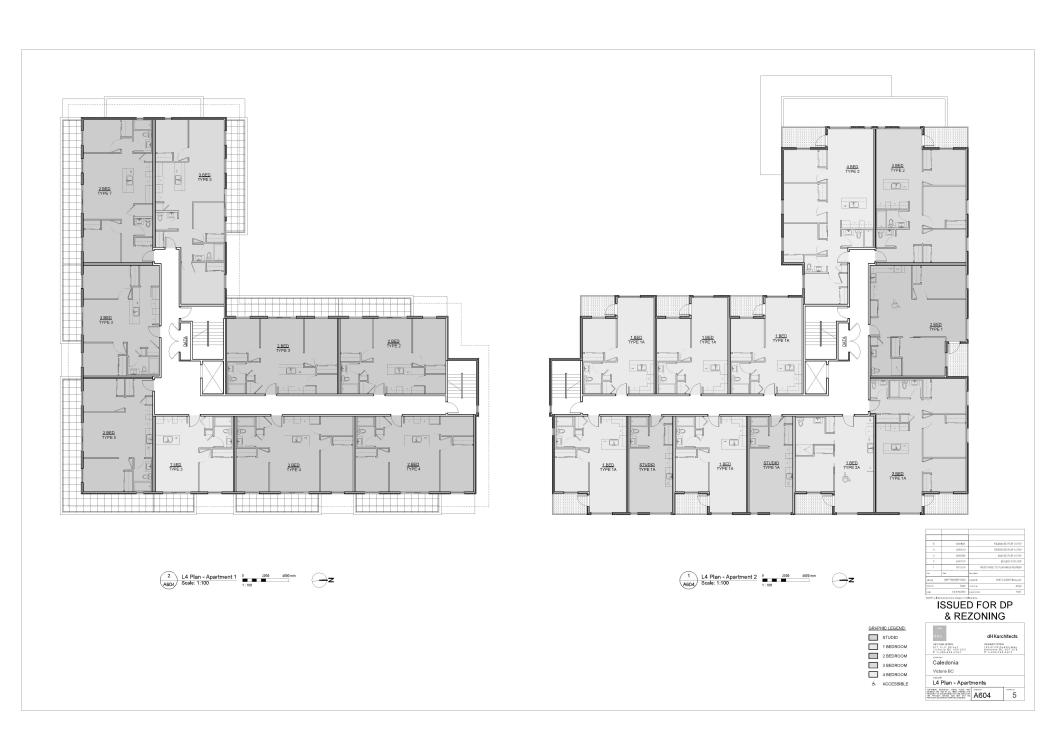






RE-BSLED FOR COTA		20/09/01	5
RE-INSURO FOR COTA		28/83/12	4
paugo for con-		28/83/05	- 2
BBUED FOR AD		29/87/10	2
POURE TO PLANNING REVIEW	RESPO	18/13/16	
	Description	Delar .	Per
1987.2 A 208 Plansow	rang ta	8EPTEMBER 2000	i de mos
PA	money by	PWP	desire
181	toletome.	AS SHOWN	era.

GRAPHIC LEGEND:	_	
STUDIO	d-Ka	dHKarchitects
1 BEDROOM	VECTORIN OFFECTI PTT FAIT STORE VICTORIA VICTORIA BO VEV DEC	INMARO OFFICE 102-51F0 DUBLIS Way Namalina BC VOTOKE
2 BEDROOM	T 1-250-658-2967	T 1-250-595-5910
3 BEDROOM	Caledonia	
4 BEDROOM	Victoria BC	
 ACCESSIBLE 	L5 Plan - Apartm	nents

Victoria BC VEV DNO T 1-250-658-2967	102-5190 Natalitio T 1-250-	BC VOT 2KB
Caledonia		
Victoria BC		
L5 Plan - Apart	ments	
COPPER SHARE THE SHARE NO	transm.	MATERIAL NO.
PROPERTY OF SHALKFO-BESCHE TO BE USED FOR THE PROJECT SHOOM HAS NOT NOT BE PERFORMED ON PARTIES CONSIST.	A605	5

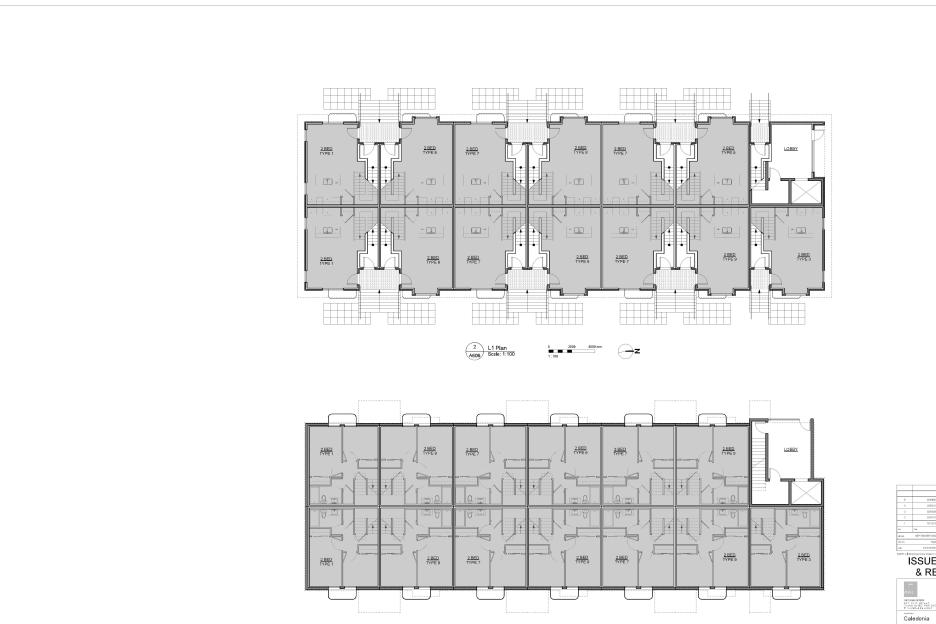

0 2000 4000 mm


\$ 35947 ASANCO FA COTO
\$ 35150 ASANCO ASCORD
\$ 35150 A

STUDIO


1 BEDROOM
2 BEDROOM
3 BEDROOM
4 BEDROOM
ACCESSIBLE

dHKar	chited
103-51900	Vet a
ницеля.	PATRIX
	NAMARO CEFE 102-5170 D Namalino GI T 1-250-58



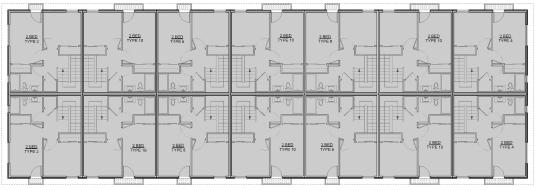



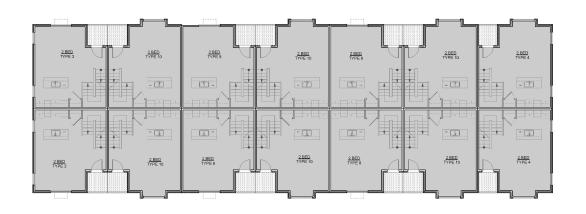

REPTEMBER 2523	ready the	1987.2 A 208 Plansowe RAW
8EPTEMBER 2000	many %	1937.2 A 208 Plansove
0 ear	Description	
18/13/16	RESPONSE	TO PLANNING REVIEW
29/97/10		BSUED FOR ADP
22/03/06		BIGUED FOR COTY
28/83/19		RE-M91/60 FOR COTA
29/9/01		RE-ISSUED FOR COTV
	284919 284906 284910 1871218	28/83/19 28/83/04 28/83/10 18/13/16 RESPONSE

GRAPHIC LEGEND:















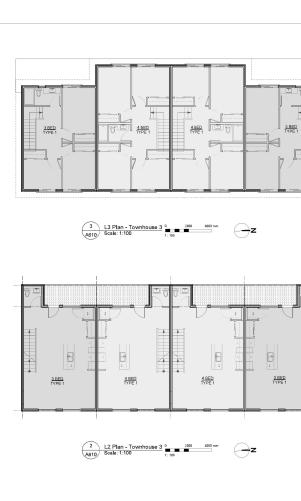

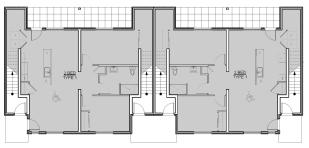



2 369305 B66500 FOR CO	Per plant men	REPTEMBER 2020	mang the 1997/2/A208 Plansows
2 288305 B6450 FOR CO 2 289310 183400 FOR C 1 18450 FOR C 1 1871215 RESPONDE TO PLANMING REVI Pro 100	Per		
2 58/8305 B64/RD FOR CO 2 28/8316 B54/RD FOR CO 1 187/216 RES FORRE TO PLANMING REVIOUS		Dear .	Description
2 38/200			
9 98/09/06 BIGURD FOR CO		18/13/16	RESPONSE TO PLANNING REVIEW
	2	28/87/10	BSUED FOR AD
4 SAMATO REMOVED FOR CO	- 2	22/03/06	paugo for conv
	4	28/83/19	RE-INGUIGO FOR COTA
5 SMINOT REASONED FOR CO	5	29/89/01	RE-ISSUED FOR COTV

GRAPHIC LEGEND:

STUDIO

1 BEDROOM


2 BEDROOM


3 BEDROOM

4 BEDROOM

& ACCESSIBLE

d-Ka	dHKarc	hitec
VSCTANNACFFSCH STT Filt Street Victoria BC VSV SHO T 1-250-658-2961	102-5100 00FREE 102-5100 DU N 8 9 8 9 9 0 0 T 1-250-595	Howa Versi
Caledonia		
Victoria BC		
Townhouse 3		

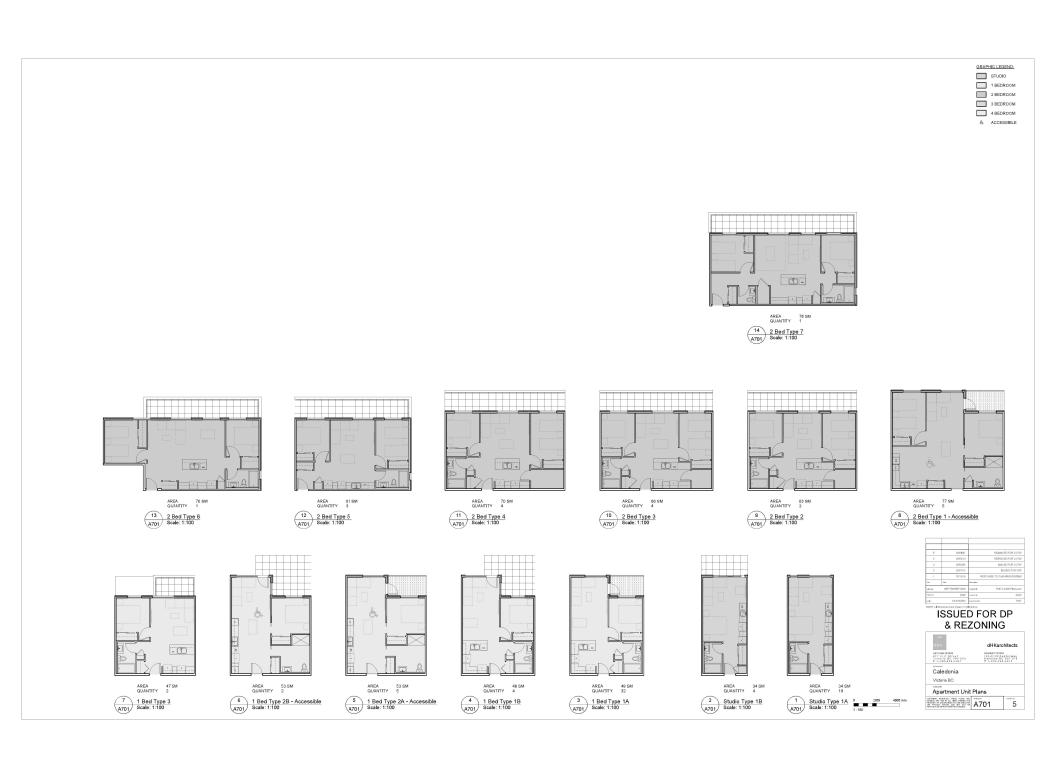

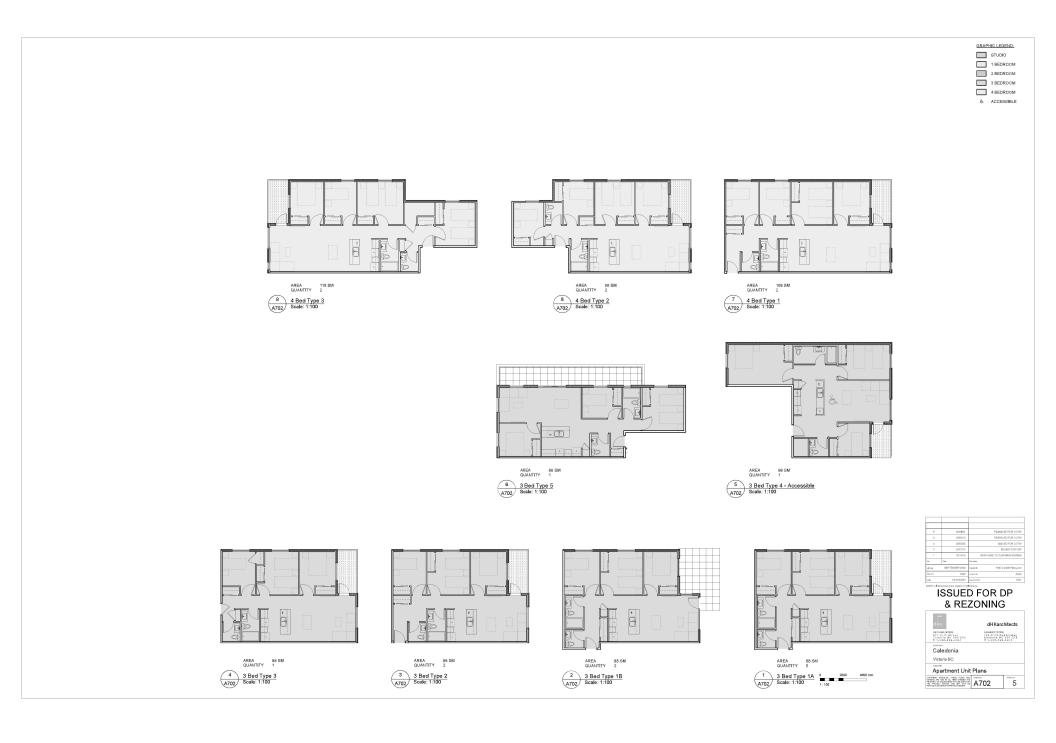











LG - FIRST FLOOR



AREA QUANTITY 2 118 SM QUANTITY 2 3 Bed Type 1 Scale: 1:100



L0 - FIRST FLOOR




	AREA QUANTITY	104 SM 2			
1	2 Bed Typ	e 1 - Accessible	0	2000	4000 m
A704	Scale: 1:10	0	1:100	_	


0 24/03/05 BSMSD FOR CO 2 26/03/15 BSMSD FOR S 1 16/12/16 REFPORE TO PLANKING REVI Per 600 3mm/mm		FWE	martin RW
2 28/03/05 B64/00/FOR D0 2 28/03/10 B59/00/80 TO PLANSING REVI	er on	8EPTEMBER 2000	management 1997/2/A208 Plansows
2 28/200	Per	tea	Description
2 20/2001 BIGUID FOR CO		18/1816	RESPONSE TO PLANNING REVIEW
- 1000000000000000000000000000000000000	2	28/97/10	BSUED FOR ADI
4 28/93/19 RE-BR9URD FOR CO	- 2	22/03/06	paugo for conv
	- 8	28/83/19	RE-BROUGD FOR COTA
6 SMINOT REASOURCE FOR CO	5	29/89/01	RE-ISSUED FOR COTV


yetoan office HAMARO CHEE IT 1 STORE OF THE TOTAL TO DUE HIN WE TO THE TOTAL TO DUE HIN WE TO THE TOTAL THE TOTAL TO THE TOTAL TH		
	FIT Filt Street	Natalitie BC VOT 2KB
Victoria BC	Victoria BC	



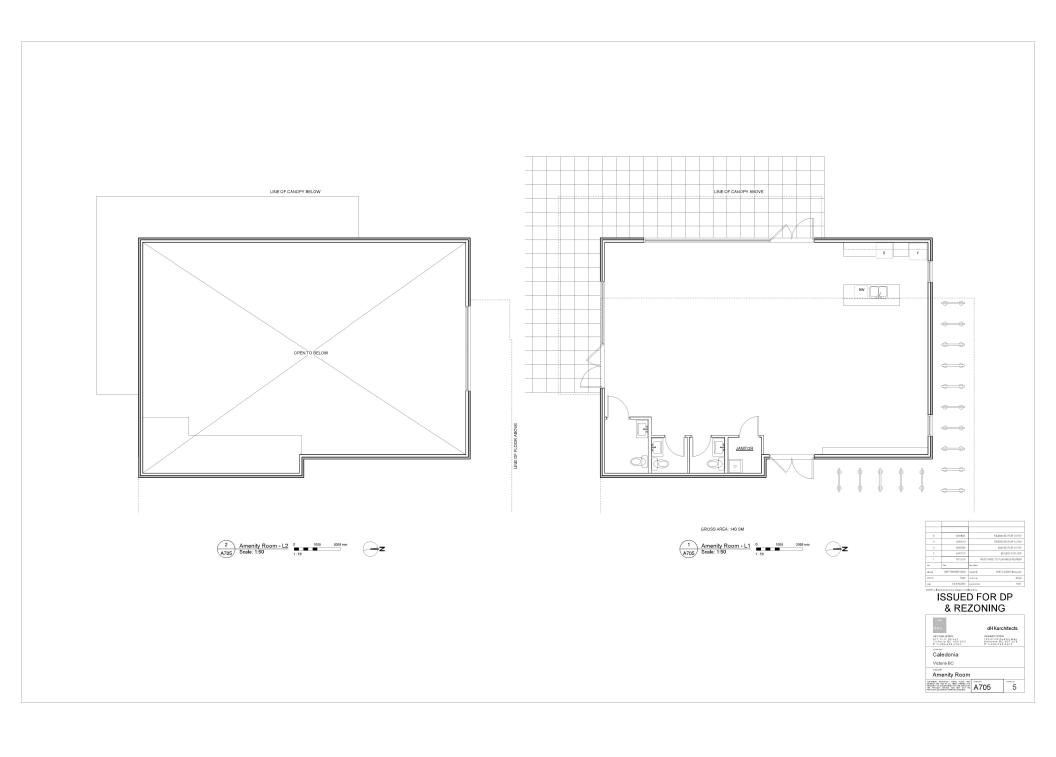

APARTMENTS 1 & 2

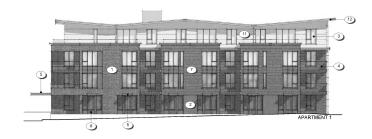

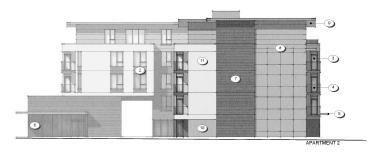













COLOUR & MATERIAL LEGEND

- BRICK VENEER Red Apartment 1 Only
- FIBRE CEMENT PANEL Teal
- VINYL WINDOWS & DOORS Teal
- PREFINISHED ALUMINUM GUARD, FRAME & PICKETS Teal
- METAL FLASHING Teal
- ACCENT PAINT COLOUR Rust
- FIBRE CEMENT LAP SIDING Soft Brown
- FIBRE CEMENT PANEL Warm Grey Apartment 2 Only
- SOFFIT Warm Grey Apartment 2 Only
- PAINTED CONCRETE Warm Grey
- FIBRE CEMENT PANEL Warm White
- SOFFIT Warm White
- ⁽³⁾ FIBRE CEMENT LAP SIDING Medium Blue-Grey

TOWNHOUSES 1, 2 & 3















14	CIDDE	CEMENT	LAP SIDING -	\A/bita
	FIBRE	CENENI	LAP SILING -	· vvnire

- **SOLUTION** VINYL WINDOWS & DOORS Dark Grey
- PREFINISHED ALUMINUM GUARD & FRAME Dark Grey
- METAL FLASHING Dark Grey
- ASPHALT SHINGLES Warm Grey
- FIBRE CEMENT SHINGLES Warm Grey
- ²⁰ VINYL WINDOWS & DOORS White
- METAL DOWNSPOUT & FLASHING Light Warm Grey
- FIBRE CEMENT PANEL Dark Grey
- FIBRE CEMENT PANEL Light Grey
- ACCENT PAINT COLOUR Bright Orange
- ACCENT PAINT COLOUR Bright Blue
- ACCENT PAINT COLOUR Chartreuse

dHKa	dHKa	rchitect
VICTORN OFFICE STT FOIL STIPPE VICTORIA DC VEVINCE T 1-210-618-2281	NAME (MODE) 102-1190 Name (mo 11-250-5	DUBLIE WAS
Caledonia		
Caledonia		
Victoria BC		
Colours & Mate	riale	

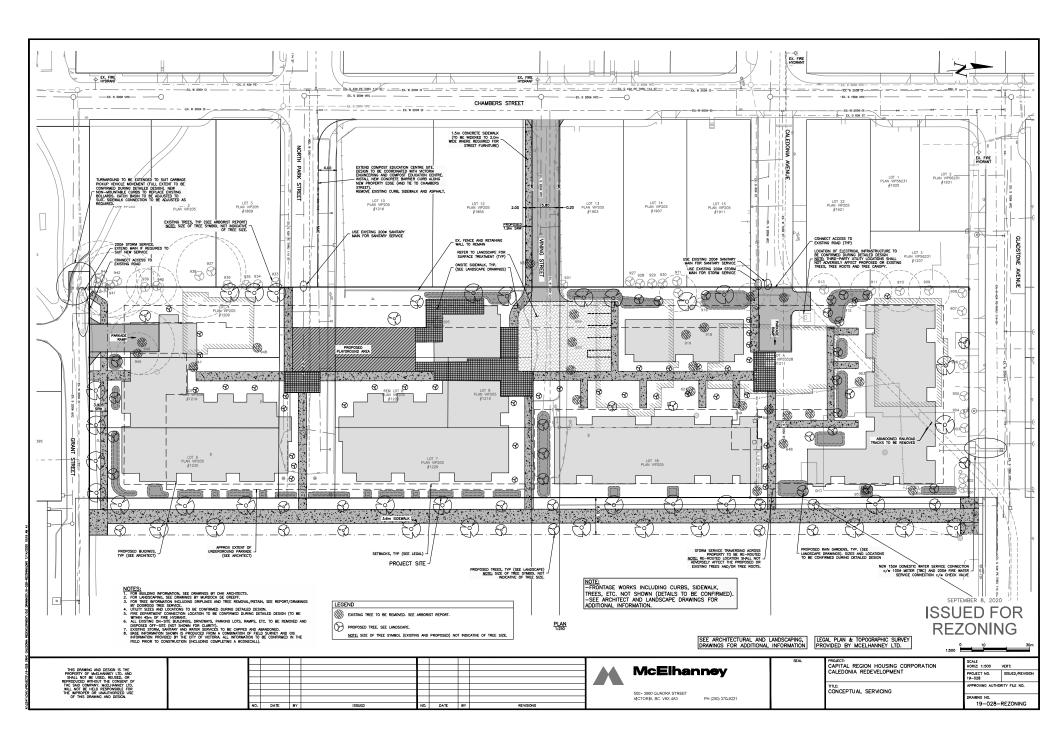

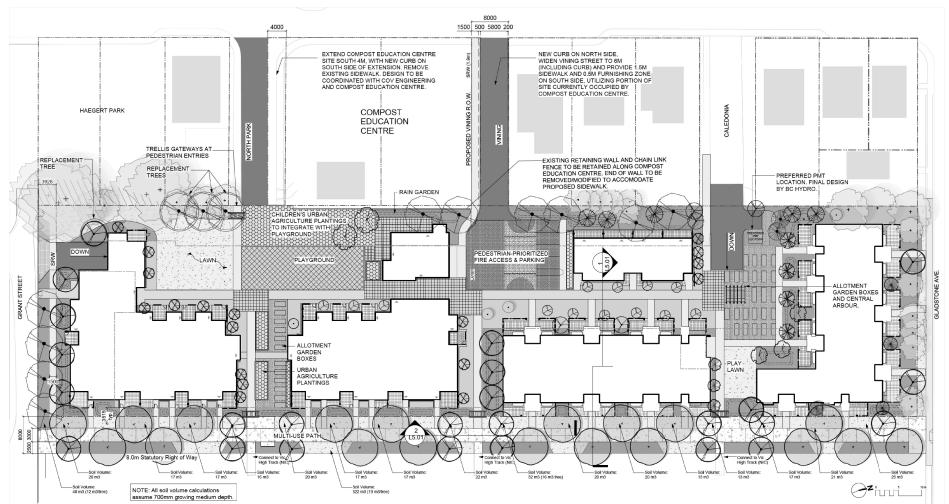

LANDSCAPE TYPOLOGIES



PLAY PLACES that foster fun and



RAIN GARDENS that slow 8 cleanse rainwater



PERSONAL OUTDOOR AREAS that can be modified, beautified and funkified.





GATHERING PLACES that help neighbours get to know each other and support each other.



BICYCLE FACILITIES that make it easy for people of all ages to hop on their bikes.



PLANTINGS that provide food for birds, bees and butterflies.



OUTDOOR SOCIAL SPACES for gethering and sharing food.



PLANTINGS that provide beauty and food for people



ACTIVE PLAY SPACES that support community sports.



PUBLIC ART that celebrates Fernwood's artistic spirit.



COMMUNITY GARDEN PLOTS that boost local food

NOT FOR CONSTRUCTION

rev no	description	date
1.	Rezoning/DP	19.09.26
2	RZ/DP Revision	19.12.16
3	Issued for ADP	20.01.15
4	Issued for ADP	20.01.15
5	For COTW	20.02.04
6	RZ/DP Revision	20.04.03
7	RZ/DP Revision	20.04.07
8	RZ/DP Revision	20.04.27
9	RZ/DP Revision	20.07.10
10	RZ/DP Revision	20.11.24






CRD Housing Corporation

631 Fisgard Ave. Victoria, BC Caledonia Redevelopment

Caledonia Ave. Victoria, BC

Landscape Overview Plan

project no.		119.18
scale	1: 250	@ 24"x36"
drawn by		TB
checked by		PdG
revison no.	sheet no.	
10	L	1.01

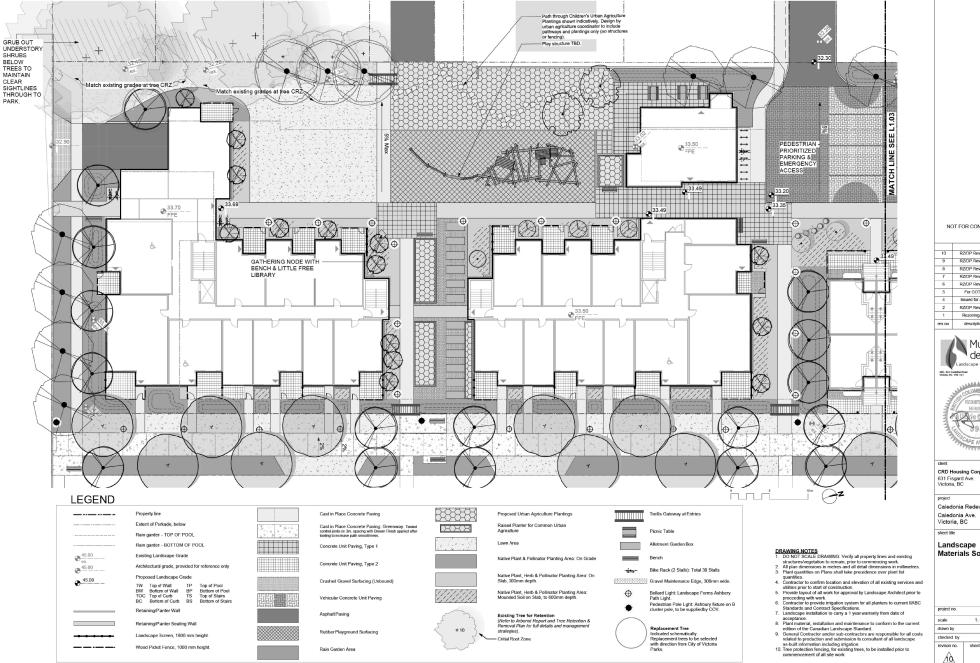

NOT FOR CONSTRUCTION

10	RZ/DP Revision	20.11.24
9	RZ/DP Revision	20.07.10
8	RZ/DP Revision	20.04.27
7	RZ/DP Revision	20.04.07
6	RZ/DP Revision	20.04.03
5	For COTW	20.02.04
4	Issued for ADP	20.01.15
2	RZ/DP Revision	19.12.16
1	Rezoning/DP	19.09.26
rev no	description	date







CRD Housing Corporation

Caledonia Redevelopment

Materials South

project no.		119.18
scale	1: 150	@ 24"x36"
drawn by		TB
checked by		PdG
revison no.	sheet no.	
<u>10</u>	L	1.02

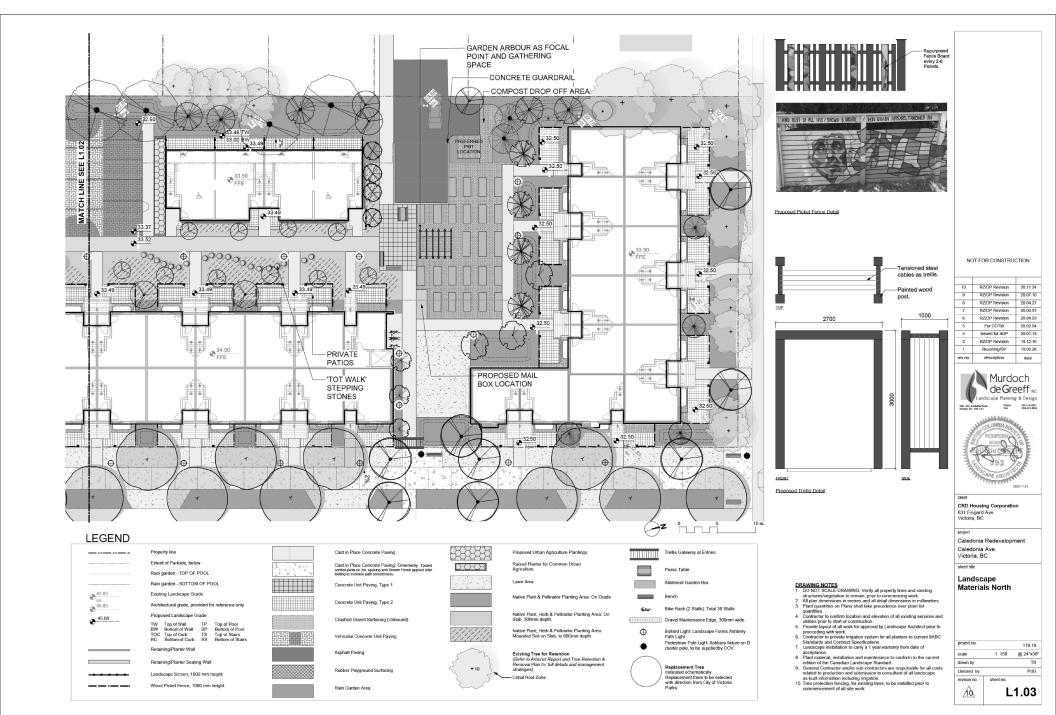

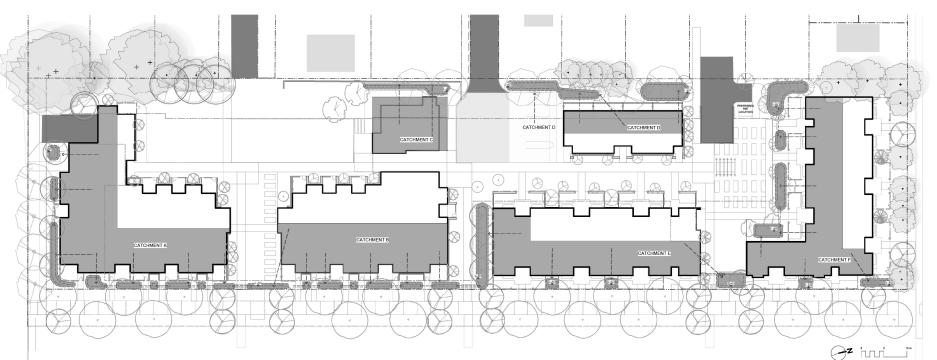

Rain Garden Ca	pacity Calculations							
Catchment Area	Contributing Impervious Area	Design Storm Runoff Volume Contributing to Rain Garden	Planter Growing Medium Depth	Stormwater Treatment Capacity per sq. m. of Rain Garden	Rain Garden Area	Rain Garden Capacity	Excess (+) or Deficient (-) Capacity	Soil Volume
	(sq. m.)	(cu. m./day)	(m.)	(cu. m./day)	(sq. m.)	(cu. m./day)	(cu.m./day)	(cu.m.)
Catchment A	560.0	28.0	0.60	0.8	40.0	30.0	2.0	24.0
Catchment B	360.0	18.0	0.60	0.8	25.0	18.8	0.8	15.0
Catchment C	190.0	9.5	0.60	0.8	13.0	9.8	0.3	7.8
Catchment D	280.0	14.0	0.60	0.8	30.0	22.5	8.5	18.0
Catchment E	365.0	18.3	0.60	0.8	33.0	18.5	0.3	19.8
Catchment F	415.0	20.8	0.60	0.8	63.0	47.3	26.5	37.8
total	2170.0	108.5			204.0	146.8	38.3	122.4

- Assumptions
- Design storm is a 2 year storm event which equals 5 cm of water, in a 24 hr period.
- 2 Rain Garden design based on 150 mm live ponding plus 20% of the sand/ compost growing medium volume (assuming growing medium has 20% void space) with a minimum infiltration rate of 2 cm/hour (or 48 cm per day), via perforated underdrain.

RAIN WATER MANAGEMENT NOTES

Water collected from portions of the building roofs flow to the rain gardens located throughout the site. Rain gardens have been situated on-grade.


Rain gardens are designed to capture, slow flows, and treat runoff. Rain gardens will be designed with underdrains and a high: capacity overflow drain that will be connected to the onsite piped drainage system. The rain gardens are sized such that the bottom of the rain garden a 5% of the impervious area, which is the area required to manage Victoria's 2 year storm event.

Walkways will be sloped to drain to adjacent absorbant landscape. Larger paved areas such as driveways and turnarounds will be drained directly to the storm system.

Portions of the roof which cannot be easily connected to rain gardens will be drained directly to the storm system. The roof catchments are shown schematically and will be refined during detailed design.


RAIN GARDEN MATERIALS

- AIN GARDEN MATERIALS
 Overflow drain, 200 mm domed grate + adapter
 Composted mulch, 50 -70 mm depth
 Bio-retention growing medium, 600 mm depth
 Scariffedtitles subgrade, 900 mm depth
 Existing subgrade/native material
 100 mm diameter (mm) perforated pipe
 25 mm diameter drain rock, 100 mm depth

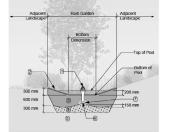

1 Typical Rain Garden

LEGEND

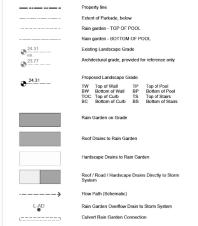

NOT FOR CONSTRUCTION

10	RZ/DP Revision	20.11.24
9	RZ/DP Revision	20.07.10
8	RZ/DP Revision	20.04.27
7	RZ/DP Revision	20.04.07
6	RZ/DP Revision	20.04.03
5	For COTW	20.02.04
4	Issued for ADP	20.01.15
2	RZ/DP Revision	19.12.16
1	Rezoning/DP	19.09.26
rev no	description	date






CRD Housing Corporation 631 Fisgard Ave. Victoria, BC

Caledonia Redevelopment Caledonia Ave. Victoria, BC

Stormwater Management

project no.		119.18	
cale	1: ###	@ 24"x36	
frawn by		TB	
hecked by	PdG		
evison no.	sheet no.		

L1.04 10

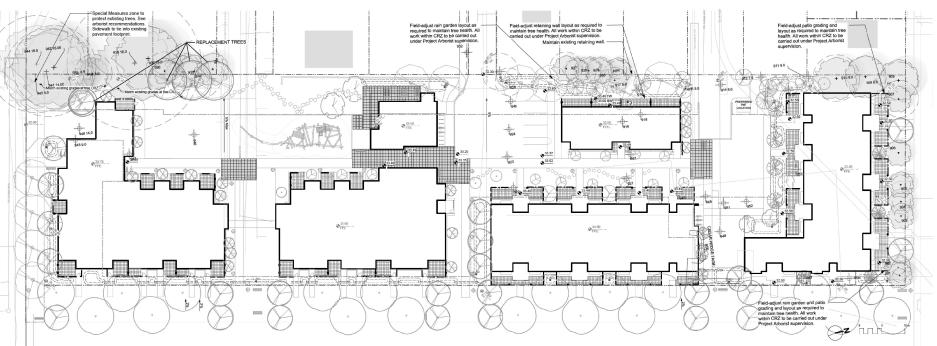

- DRAWING NOTES

 1. DO NOT SCALE DRAWING: Verify all property lines and existing
- DO NOT SOURCE PROVINTON. Yelly all property lines and existing structures/vegetation to remain, prior to commencing work.

 All plan dimensions in metries and detail dimensions in millimetres.
 Plant quantities on Plans shall talk precedence over plant list quantities.
 Contractor to confirm location and elevation of all existing services and
- Unitation to continue to cannot aim elevation or all existing services and utilities prior to start of construction.
 Provide layout of all work for approval by Landscape Architect prior to
- Provide layout of an work for approval by Candscape Adminest prior to proceeding with work
 Contractor to provide irrigation system for all planters to current IABC Standards and Contract Specifications.
 Landscape installation to carry a 1 year warranty from date of accontines.


- Landscape installation to carry a 1 year warranty from date of acceptance.
 Landscape in particular and an amelierance to conform to the current edition of the Canadian Landscape Standard.
 General Contractors are responsible for all costs related to production and submission to consultant of all landscape as built information including impation.
 Tree protection fencing, for existing trees, to be installed prior to commencement of all site work.

TREE SUMMARY*

TOTAL TREES TO BE REMOVED: TOTAL TREES TO BE RETAINED:	31 27	
TOTAL BYLAW-PROTECTED TREES TO BE REMOVED:	2	

* Based on Arborist's Report recieved from Talbot Mackenzie & Associates, 03/04/2020. Refer to Arborist report for details and Arborist recommendations

LEGEND

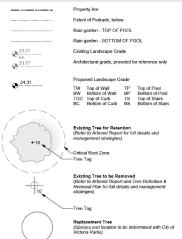

NOT FOR CONSTRUCTION

rev no	description	date
1	Rezoning/DP	19.09.26
2	RZ/DP Revision	19.12.16
4	Issued for ADP	20.01.15
5	For COTW	20.02.04
6	RZ/DP Revision	20.04.03
7	RZ/DP Revision	20.04.07
8	RZ/DP Revision	20.04.27
9	RZ/DP Revision	20.07.10
10	RZ/DP Revision	20.11.24







CRD Housing Corporation 631 Fisgard Ave. Victoria, BC

Caledonia Redevelopment Caledonia Ave. Victoria, BC

Tree Retention & Removal Plan

project no.		119.18
scale	1: 250	@ 24"x36"
drawn by		TB
checked by		PdG
revison no.	sheet no.	
10	L	1.05

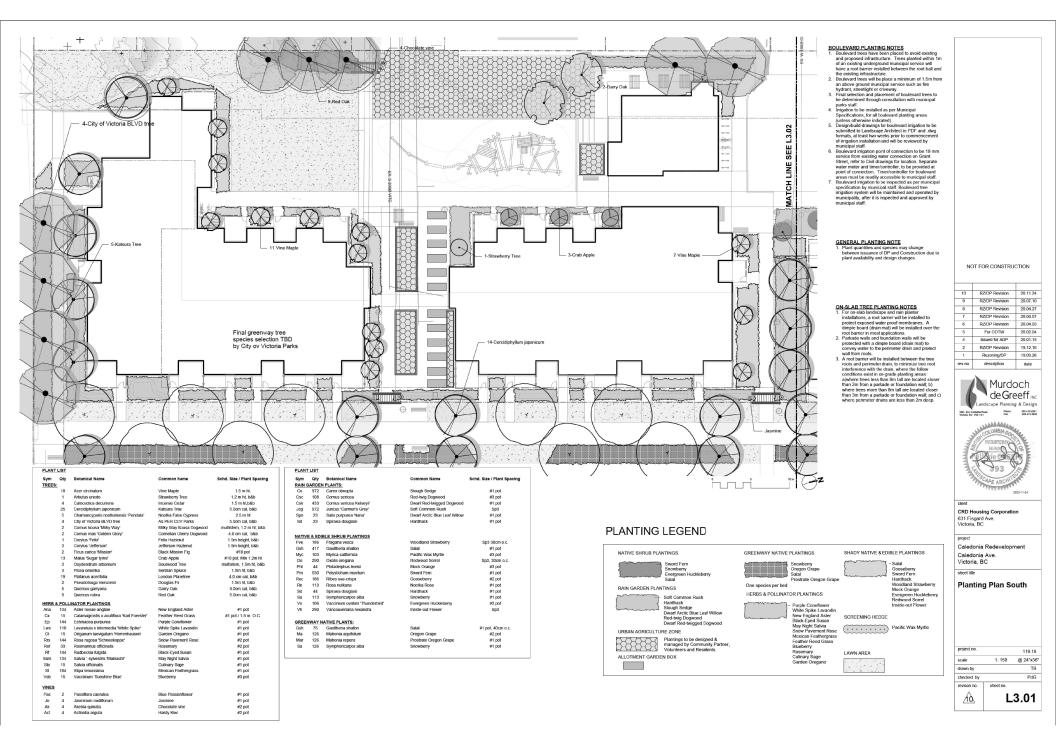

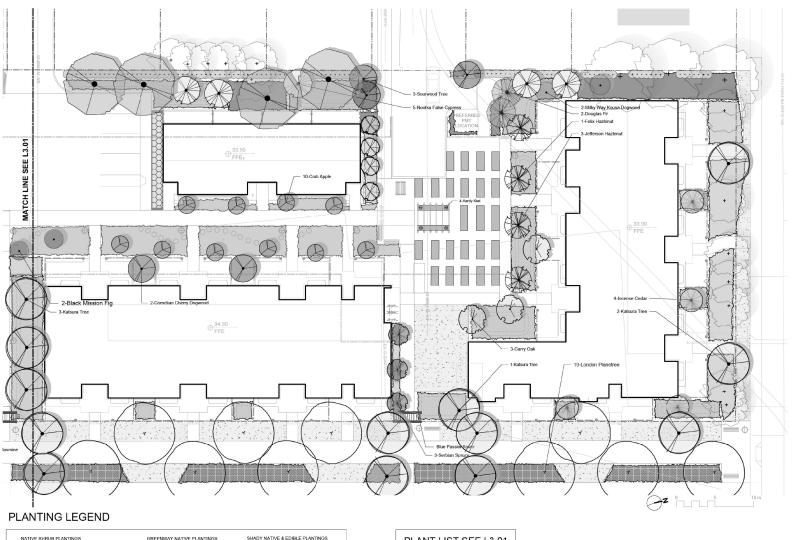

BOULEVARD PLANTING NOTES

- BOULEVARD PLANTING NOTES

 1. Boulevard trees have been placed to avoid existing and opposed infrastructure. Trees, and opposed infrastructure. Trees are also as a second of the place and place and the place and place

GENERAL PLANTING NOTE

Plant quantities and species may change between issuance of DP and Construction due to plant availability and design changes.

ON-SLAB TREE PLANTING NOTES

1. For on-slab landscape and rain planter installations, a root barrier will be installed to protect exposed water proof membranes. A dimple board (drain mat) will be installed over the root barrier in most

- will be disclaimed over the foot darine in most applications.

 2. Parkade walls and foundation walls will be protected with a dimple board (drain mat) to convey water to the perimeter drain and protect wall from roots.

 3. A root barrier will be installed between the tree nots and perimeter drain, to minimize the root interference with the drain, where the follow interference with the drain, where the follow conditions exist in on-grade planting areas: a)where trees less than 8m tall are located closer than 2m from a parkade or froundation wall; b) where trees more than 8m tall are located closer than 3m from a parkade or foundation wall; and c) where perimeter drains are less than 2m deep.

NOT FOR CONSTRUCTION

10	RZ/DP Revision	20.11.24
9	RZ/DP Revision	20.11.24
8	RZ/DP Revision	20.07.10
7	RZ/DP Revision	20.04.27
6	RZ/DP Revision	20.04.07
5	For COTW	20.04.03
4	Issued for ADP	20.02.04
2	RZ/DP Revision	19 12 16
1	Rezoning/DP	19.09.26
rev no	description	date





CRD Housing Corporation 631 Fisgard Ave. Victoria, BC

Caledonia Redevelopment Caledonia Ave. Victoria, BC

Planting Plan North

project no.		119.18
scale	1: 150	@ 24"x36"
drawn by		TB
checked by		PdG
revison no.	sheet no.	

L3.02 10

PLANT LIST SEE L3.01

Sword Fern

RAIN GARDEN PLANTINGS

- Soft Common Rush Hardhack Slough Sedge Dwarf Arctic Blue Leaf Willow Red-twig Dogwood Dwarf Red-twigged Dogwood

URBAN AGRICULTURE ZONE Plantings to be designed & managed by Community Partner, Volunteers and Residents.

ALLOTMENT GARDEN BOX

GREENWAY NATIVE PLANTINGS


Prostrate Oregon Grape One species per bed HERBS & POLLINATOR PLANTINGS

Purple Coneflower
 White Spike Lavandin
 New England Aster
 Black-Eyed Susan
 May Night Salvia
 Snow Pavement Rose
 Mexican Feathergrass
 Feather Reed Grass
 Blueberry
 Rosemary
 Culinary Sage
 Garden Oregano

- Salal
Gooseberry
Sword Fem
Hardhack
Woodland Strawberry
Mock Orange
Evergreen Huckleberry
Redwood Sorrel
Inside-out Flower SCREENING HEDGE

Pacific Wax Myrtle

I AWN AREA

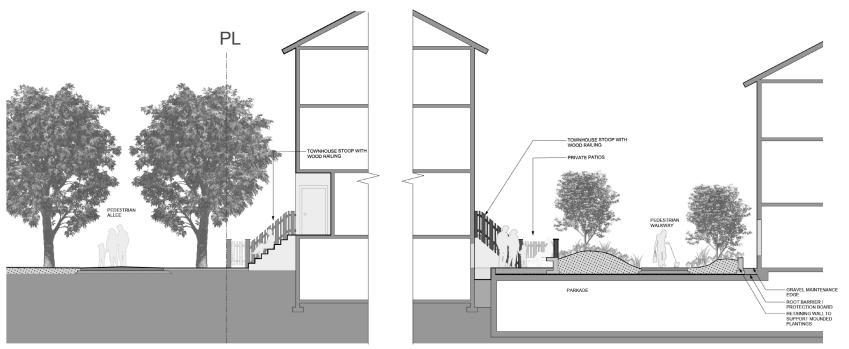

Section at Pedestrian Allee and Townhouses
Scale; 1:50



2 Section at Pedestrian Walkway Scale: 1:50

NOT FOR CONSTRUCTION

rev no	description	date
1	Rezoning/DP	19.09.26
2	RZ/DP Revision	19.12.16
4	Issued for ADP	20.01.15
5	For COTW	20.02.04
6	RZ/DP Revision	20.04.03
7	RZ/DP Revision	20.04.07
8	RZ/DP Revision	20.04.27
9	RZ/DP Revision	20.07.10
10	RZ/DP Revision	20.11.24



client

CRD Housing Corporation 631 Fisgard Ave. Victoria, BC

project Caledonia Redevelopment

Caledonia Ave. Victoria, BC

sheet title

Landscape Sections

10	L	5.01
revison no.	sheet no.	
checked by		PdG
drawn by		TB
scale	1: 250	@ 24"x36"
project no.		119.18