## **FACTORY BLOCK**

#### **CIVIC ADDRESS:**

480 + 492 ESQUIMALT RD. VICTORIA, BC. V9A 3L1

#### **LEGAL ADDRESS:**

LOTS 3,4 + 6, PLAN 9705 and LOT B, PLAN 21975, SECTION 31, ESQUIMALT DISTRICT

#### REZONING AND DEVELOPMENT PERMIT RE-SUBMISSION

MAY 27th, 2022

#### DRAWING LIST

**COVER SHEET** 

PROJECT DATA

PUBLIC REALM AND CONTEXT SCALE

EXISTING CONTEXT / SITE PLAN

SITE ANALYSIS + CONCEPT

CONCEPT & DIAGRAMS

SUN STUDIES A0.06 MATERIALS

3D VIEWS

3D VIEW - NORTH SIDE

3D VIEW - COURTYARD + ROOFTOP

CONTEXT ELEVATIONS

SITE SURVEY

STATUTORY R.O.W. & SETBACKS

AVERAGE GRADE PLAN SITE PLAN PROPOSED

P2 FLOOR PLAN A2.00

P1 FLOOR PLAN

L1 FLOOR PLAN

L1-MEZZ FLOOR PLAN

L2-6 FLOOR PLAN

A2.05 **ROOF PLAN** 

**BUILDING SECTIONS** A4.00

**BUILDING SECTIONS** 

**BUILDING SECTIONS** 

SOUTH ELEVATION A5.00 A5.01 NORTH ELEVATION

WEST ELEVATION

**EAST ELEVATION** A5.03





## Revisions

**Received Date:** May 31, 2022

**CLIENT** 

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JE Anderson CONTACT: ROSS TUCK

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#### CODE

**GHL Consultants** CONTACT : FRANKIE VICTOR

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480 + 492 ESQUIMALT RD



PROJECT I	NFORMATION SHEE	T		
CIVIC ADDRESS	480 + 492 ESQUIMALT ROAD, VICTORIA, BC, V9A 3L1			
LEGAL ADDRESS	LOTS 3 & 4, PLAN 9705 and LOT ESQUIMALT DISTRICT	B, PLAN 21975. ALL OF SECTION 31		
SITE INFORMATION	PERMITTED / REQUIRED	PROPOSED		
ZONING	M-1 ZONE, LIMITED LIGHT INDUSTRIAL DISTRICT	NEW ZONE		
USE	LIGHT INDUSTRIAL HIGH TECH WORK-LIVE SERVICE-COMMERCIAL LIMITED RETAIL	MULTIPLE DWELLING CAFÉ / RESTAURANT RETAIL OFFICE LIGHT INDUSTRIAL		
PROPERTY AREA (sq.m)	2,197.82			
NET DEVELOPABLE AREA (sq.m) AFTER SRW	2,063.64			
TOTAL FLOOR AREA (sq.m)	6,593.46	6,593.46		
FLOOR SPACE RATIO	3.00	3.00		
COMMERCIAL FLOOR AREA - GROSS (sq.m)		1,204.58		
COMMERCIAL FSR	1.4 MAX	0.55		
RETAIL SPECIFIC FSR		0.08		
MEZZANINE AREA (sq.m)	28.50%	27.4%		
RESIDENTIAL FLOOR AREA - GROSS (sq.m)		5,388.88		
SITE COVERAGE (%)		66.0%		
OPEN SITE SPACE (%)		34.0%		
BUILDING HEIGHT (AV. GRADE TO TOP OF ROOF)	20m MAX (OCP) 15m MAX (ZONING) 4m MAX (within 7.5m of RES ZONING)	20.24m		
BUILDING HEIGHT (AV. GRADE TO TOP OF MECH ROOF) *DOES NOT INCLUDE ELEV. OVERRUN		23.14m		
NUMBER OF STOREYS (PER BCBC)	6	6		
PARKING STALLS (NUMBER) ON SITE	121	63		
BICYCLE PARKING NUMBER (CLASS 1 AND CLASS 2)	CLASS 1 - 104 / CLASS 2 - 20	CLASS 1 - 135 / CLASS 2 - 24		
BUILDING SETBACKS (m)				
NORTH YARD (M-1 ADJACENCY)	No Required Setback	7.04-7.27 at L1, 9.39-9.62m above L2		
NORTH YARD (M-1 ADJACENCY)  NORTH YARD (R3-2 ADJACENCY)	3m at Residential Properties	0.1266m at L1, 3.0-3.92m above L2		
SOUTH YARD (K3-2 ADJACENCY)	No Required Setback	3.22-4.0m at L1, 1.14-3.83m above L2		
WEST YARD	No Required Setback	4.82m at L1, 3.78m above L2		
EAST YARD	No Required Setback	5.38m at L1, 4.01m above L2		
STREET CORNER (up to 3m)	3m Diagonal at Street Corner	8m x 8m Diagonal		
STREET CORNER (UP to SIII)	3111 Diagonal at Street Corner	OIII X OIII DIABOIIAI		
RESIDENTAL USE DETAILS				
TOTAL NUMBER OF UNITS		85		
MINIMUM UNIT FLOOR AREA (sq-m)		30.82sm / 330 sf		

DECIDENTIAL DADIVING				CLIDDEA	
RESIDENTIAL PARKING	N	D1-1	•	CURREN	
Unit Sizes	Number of Units	Parking Fac	ctor	Stalls Required	Provided
Less than 45m <sup>2</sup>	35	0.75		26.3	
BTW 45m <sup>2</sup> & 70m <sup>2</sup> Greater then 70m <sup>2</sup>	20	0.9		18.0	
Greater then 70m <sup>2</sup>	30	1.3		39.0	
Total Residential	85			84	43
Visitor Stalls	85	0.1		9	4
Total				93	47
COMMERCIAL PARKING					
Unit Type	<b>Unit Area</b>	Parking Factor	(sm)	Stalls Required	
UNIT 01 - Level 01 Indoor - Café	207.0	1	20	10.4	
UNIT 01 - Level 01 Outdoor - Café	45.8	1	20	2.3	
UNIT 01 - Mezzanine - Cowork	78.6	1	50	1.6	
Total Unit 01				14.2	
UNIT 02 - Level 01 - Office	281.5	1	50	5.6	
UNIT 02 - Mezzanine - Office	85.0		50	1.7	
Total Unit 02				7.3	
UNIT 03 - Level 01 South - Retail	169.0	1	37.5	4.5	
UNIT 03 - Level 01 North - Manufacturing	164.3	1	140	1.2	
UNIT 03 - Mezzanine - Office	87.6	1	50	1.8	
Total Unit 03				7.4	
Total Commercial Stalls				29	15*
			* Sha	red Commercial / \	isitor Stalls/
Dedicated Car Share Stall (3m x 5.5m)					1
Total Spaces Required				121	63
		Dif	ference :	58	
				52% o	f Required
COMMERCIAL LOADING					
Off Street Loading (4m x 9m)				1	1

BU	ILDING CODE SUMMARY				
REFERENCE CODE	BCBC 2018   PART 3				
CLASSIFICATION	3.2.2.50 GROUP C, UP TO 6 STOP 3.2.2.58 GROUP D, UP TO 6 STOP 3.2.2.15 STOREYS BELOW GROU	REYS, SPRINKLERED			
NUMBER OF STREETS	FACING TWO STREETS	FACING TWO STREETS			
SPRINKLERED	YES	YES			
EMERGENCY POWER	YES	YES			
FLOOR ASSEMBLY FIRE RATING	1 HR (2 HR PARKING)				
MEZZANINE FIRE RATING	1HR	1HR			
ROOF FIRE RATING	1HR				
	PERMITTED	PROPOSED			
CONSTRUCTION	NONCOMBUSTIBLE CONS. COMBUSTIBLE CONSTRUCTION	NC CONS. P2-L2 C CONS. L2-ROOF			
BUILDING AREA	1,500 sm	1,447.16 sm			
BUILDING HEIGHT	6 STOREYS	6 STOREYS (Above Grade) 2 STOREYS (Below Grade)			
OCCUPANCY	C - RESIDENTIAL A-2 - ASSEMBLY E - RETAIL D - OFFICE F-3 - PARKING	C - RESIDENTIAL A-2 - ASSEMBLY E - RETAIL D - OFFICE F-3 - PARKING			

RESI	DENTIAL BIKE	STALL R	EQI	JIREME	NTS	
				Long 1	Гerm	Short Term
Size of units	# of Units	Bike Stall Fac	tor		Required	Require
Units Below 45m²	35		1		35	
Units Above 45m²	50	-	L.25		63	
Short Term - 6 per building or	85		0.1			
Total Required Residential Stalls					98	
Total Provided Residential Stalls					123	1
				Required	Provided	
Minimum ground mounted horizonta	al stalls (1/3 of requir	ed)		33	54	
Minimum Oversize cargo stalls (10%	of required)			10	10	

			Long 7	Гerm	Short T	erm
Unit Type	<b>Unit Area</b>	Bike Stall Factor	(sm)	Required	(sm)	Require
UNIT 01 - Level 01 Indoor - Café	207.0	1	400	0.5	100	4.
UNIT 01 - Level 01 Outdoor - Café	45.8	1	400	0.1	100	4.
UNIT 01 - Mezzanine - Cowork	78.6	1	150	0.5	400	0.
Total Unit 01				1.2		8.
UNIT 02 - Level 01 - Office	281.5	1	150	1.9	400	0.
UNIT 02 - Mezzanine - Office	85.0		150	0.6	400	0.
Total Unit 02				2.4		0.
UNIT 03 - Level 01 South - Retail	169.0	1	200	0.8	200	1.
UNIT 03 - Level 01 North - Manufacturing	164.3	1	1200	0.1	6 space min	
UNIT 03 - Mezzanine - Office	87.6	1	150	0.6	400	0.
Total Unit 03				1.6		1.
Total Required Commercial Stalls				6		1

FACTORY B	LOCK FSR AR	EAS	
	FLOOR AREA (sm)	FLOOR AREA (sf)	FS
COMM CIRC. / GARBAGE	116.04	1,249	
COMM - EOT FACILITIES	15.68	169	
COMMERICAL 01 - CAFE	285.58	3,074	
COMMERICAL 02 - OFFICE	366.41	3,944	
COMMERICAL 03 - RETAIL	169.01	1,819	
COMM. 03 - MANUFACTURING / OFFICE	251.86	2,711	
COMMERICAL SUBTOTAL	1,204.58	12,966	0.5
RES CIRCULATION A	411.8	4,433	
RES LOBBY A	27.94	301	
RES M/E A	38.95	419	
RES UNITS A	2,084.71	22,440	
RES BLDG A SUBTOTAL	2,563.40	27,592	1.1
RES CIRCULATION B	428.72	4,615	
RES LOBBY B	28.7	309	
RES M/E B	55.55	598	
RES UNITS B	2,312.51	24,892	
RES BLDG B SUBTOTAL	2,825.48	30,413	1.2
RESIDENTIAL SUBTOTAL	5,388.88	58,005	2.4
BUILDING TOTAL	6,593.46	70,971	3.0
SITE AREA	2,197.82	23,657	

*FSR AREAS DO NOT INCLUDE ELEVATOR SHAFTS, BICYCLE STORAGE ROOMS, OR ANY
AREA BELOW LEVEL 1. AREAS ARE CALCULATED TO INSIDE FACE OF EXTERIOR WALLS.

		AREAS BY LEVEL	
EA (sf)	FSR	LEVEL FLOOR ARE	A (sr
1,249			
169		LEVEL 1 1,	,115.
3,074		LEVEL 1 MEZZANINE	305.
		LEVEL 2 1,	,018.
3,944		LEVEL 3 1,	,018.
1,819		LEVEL 4 1,	,018.
2,711		LEVEL 5 1,	,018.
		LEVEL 6 1,	,018.
12,966	0.55	ROOF LEVEL	80.
4,433		COMMERICAL SUBTOTAL 6,	,593.
301			
419		*AREAS INCLUDE MEZZANINE STAIRS	
22,440		** MEZZANINE AREA = 27.4% OF L1 AR	FΔ
27,592	1.17	111227 111112 7 1127 1177 GT 217111	, .
4,615			
309			
598			
24,892			
30,413	1.29		
58,005	2.45		

FLOOR AREA (sm)

1,115.96

6,593.46

305.96 1,018.17 1,018.17 1,018.17 1,018.17 1,018.17 80.69

RESIDENTIAL UNIT BREAKDOWN				
TYPE	SIZE RANGE (sf)	QUANTITY	PERCENTAGE	
STUDIO	330-370	25	29.4%	
1 BEDROOM	480-540	30	35.3%	
2 BEDROOM	780-870	30	35.3%	
TOTAL		85		


OUTDOOR AMENITY				
ТҮРЕ	AREA m²	AREA ft²		
RESIDENTIAL AMENITY (L6)	485.0	5,220		
PUBLIC AMENITY (L1)	634.16	6,826		
COMM. AMENITY (L1-MEZZ)	56.52	608		
COMMERCIAL AMENITY (L2)	132.4	1,425		
TOTAL		14,080		


FLOORPLATE SIZES				
ТҮРЕ	AREA m²	AREA ft²		
RESIDENTIAL A (RENTABLE)	454.0	4,887		
RESIDENTIAL A (M/E/CIRC)	76.0	818		
TOTAL RES. A	530.0	5,705		
RESIDENTIAL B (RENTABLE)	503.0	5,414		
RESIDENTIAL B (M/E/CIRC)	76.0	818		
TOTAL RES. B	579.0	6,232		

STORAGE LOCKERS			
# OF RES UNITS	# OF LOCKERS	PERCENTAGE	
85	52	61.2%	
		# OF RES UNITS # OF LOCKERS	


	GARB/	AGE + RECYCLING RO	OMS
		LOCATION	AREA ft²
COMMERCIAL		LEVEL 1	405
RESIDENTIAL		LEVEL P1	400



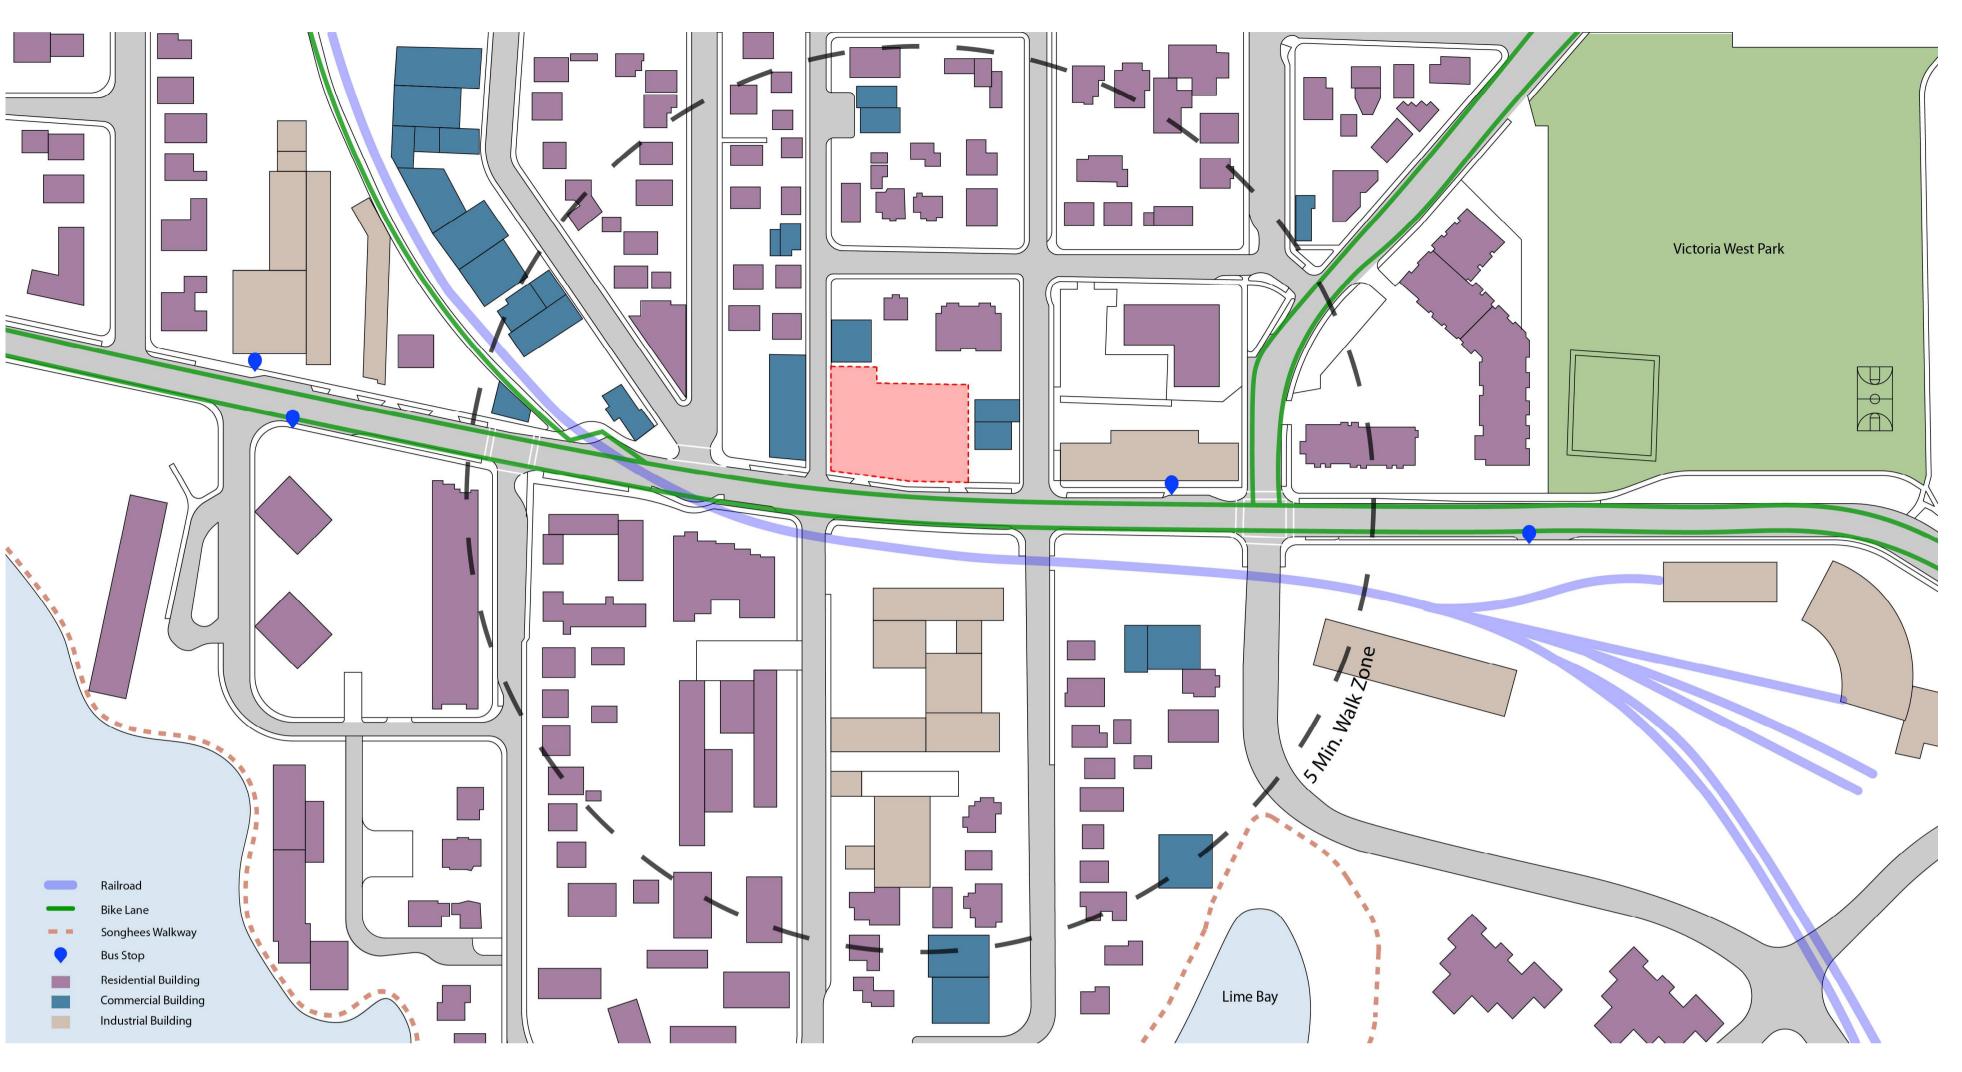

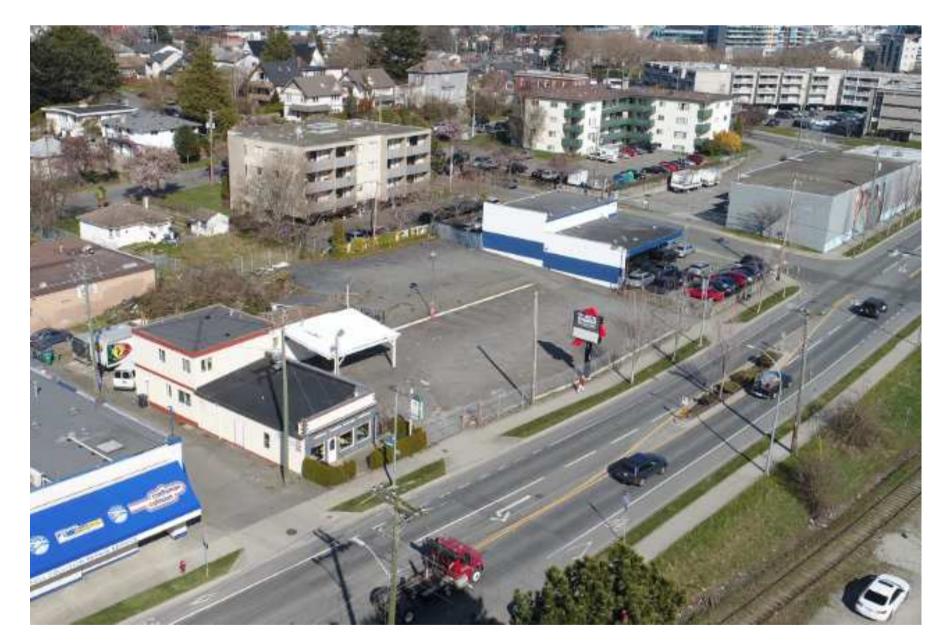




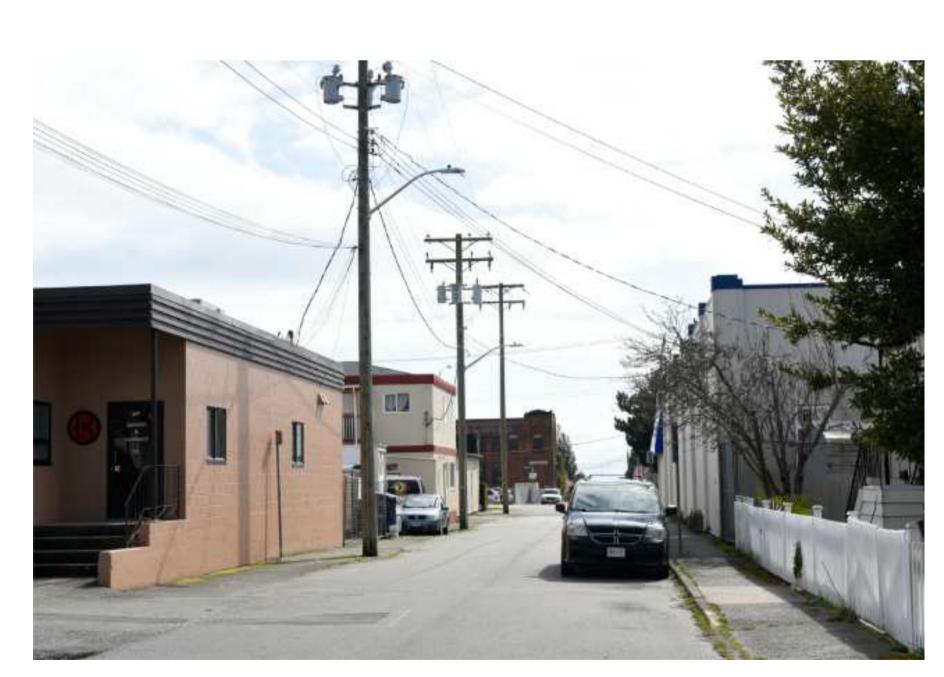


View from North of Russell St.



View from East of Esquimalt Rd.

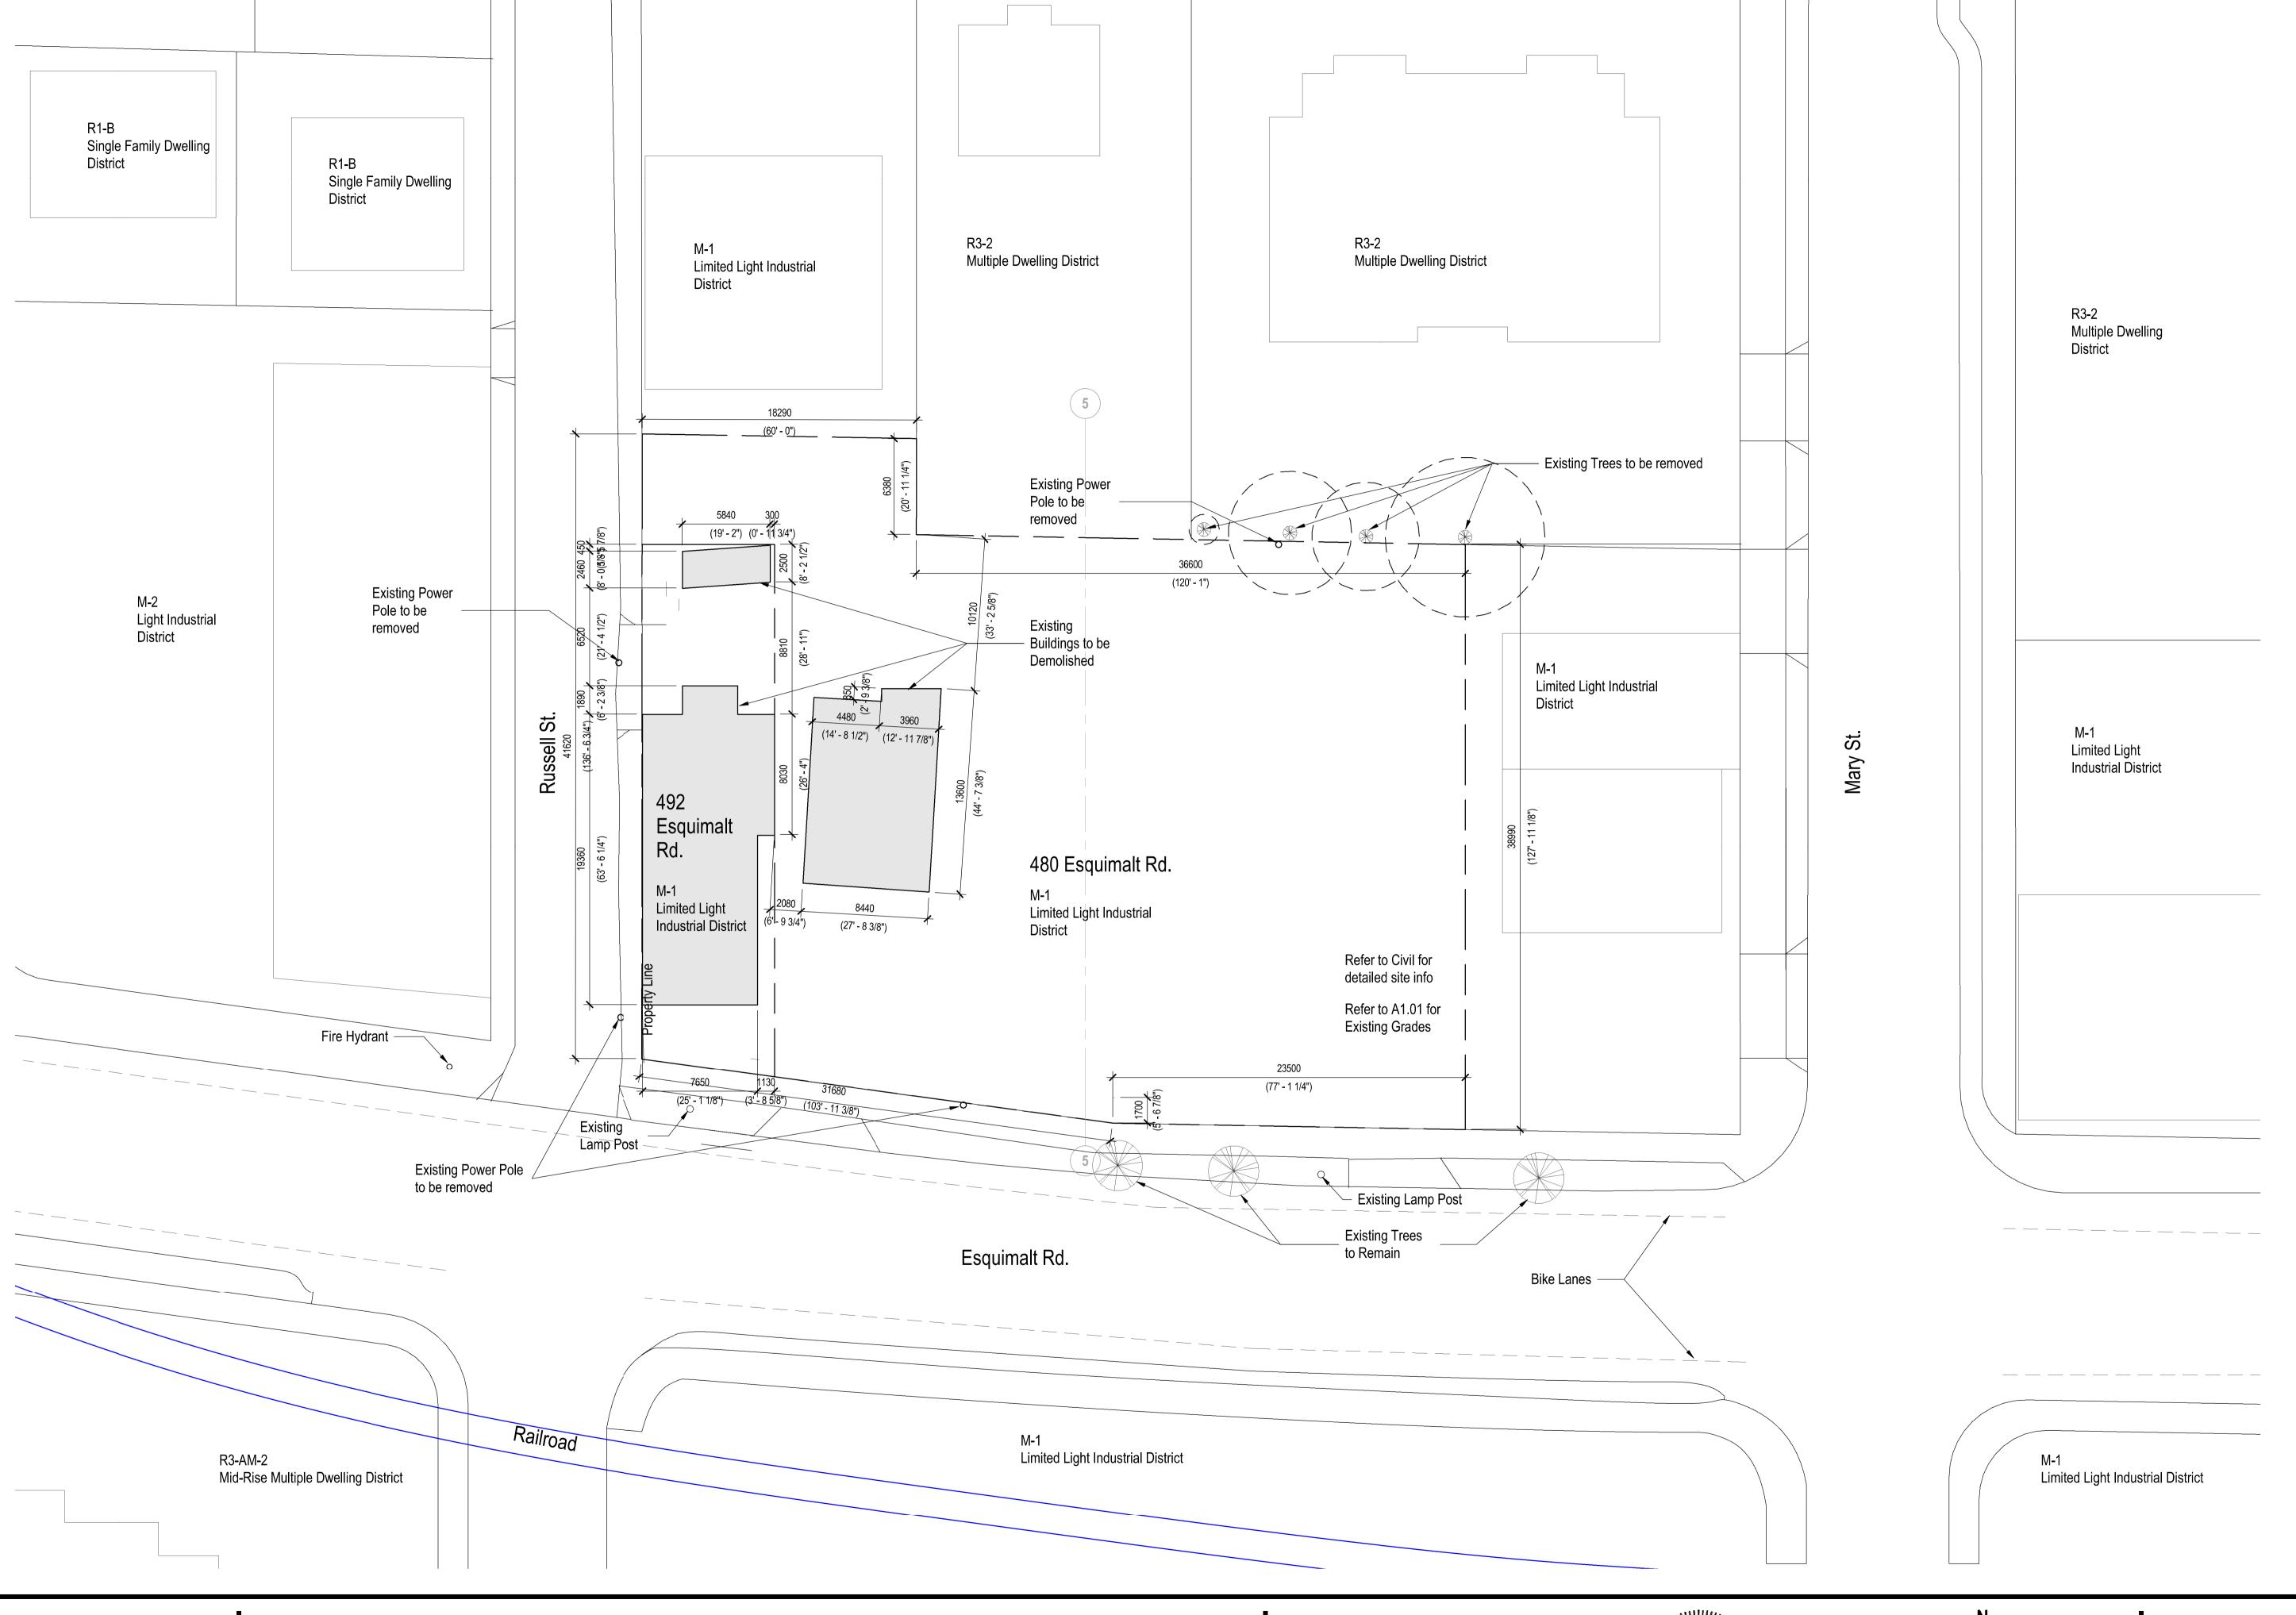



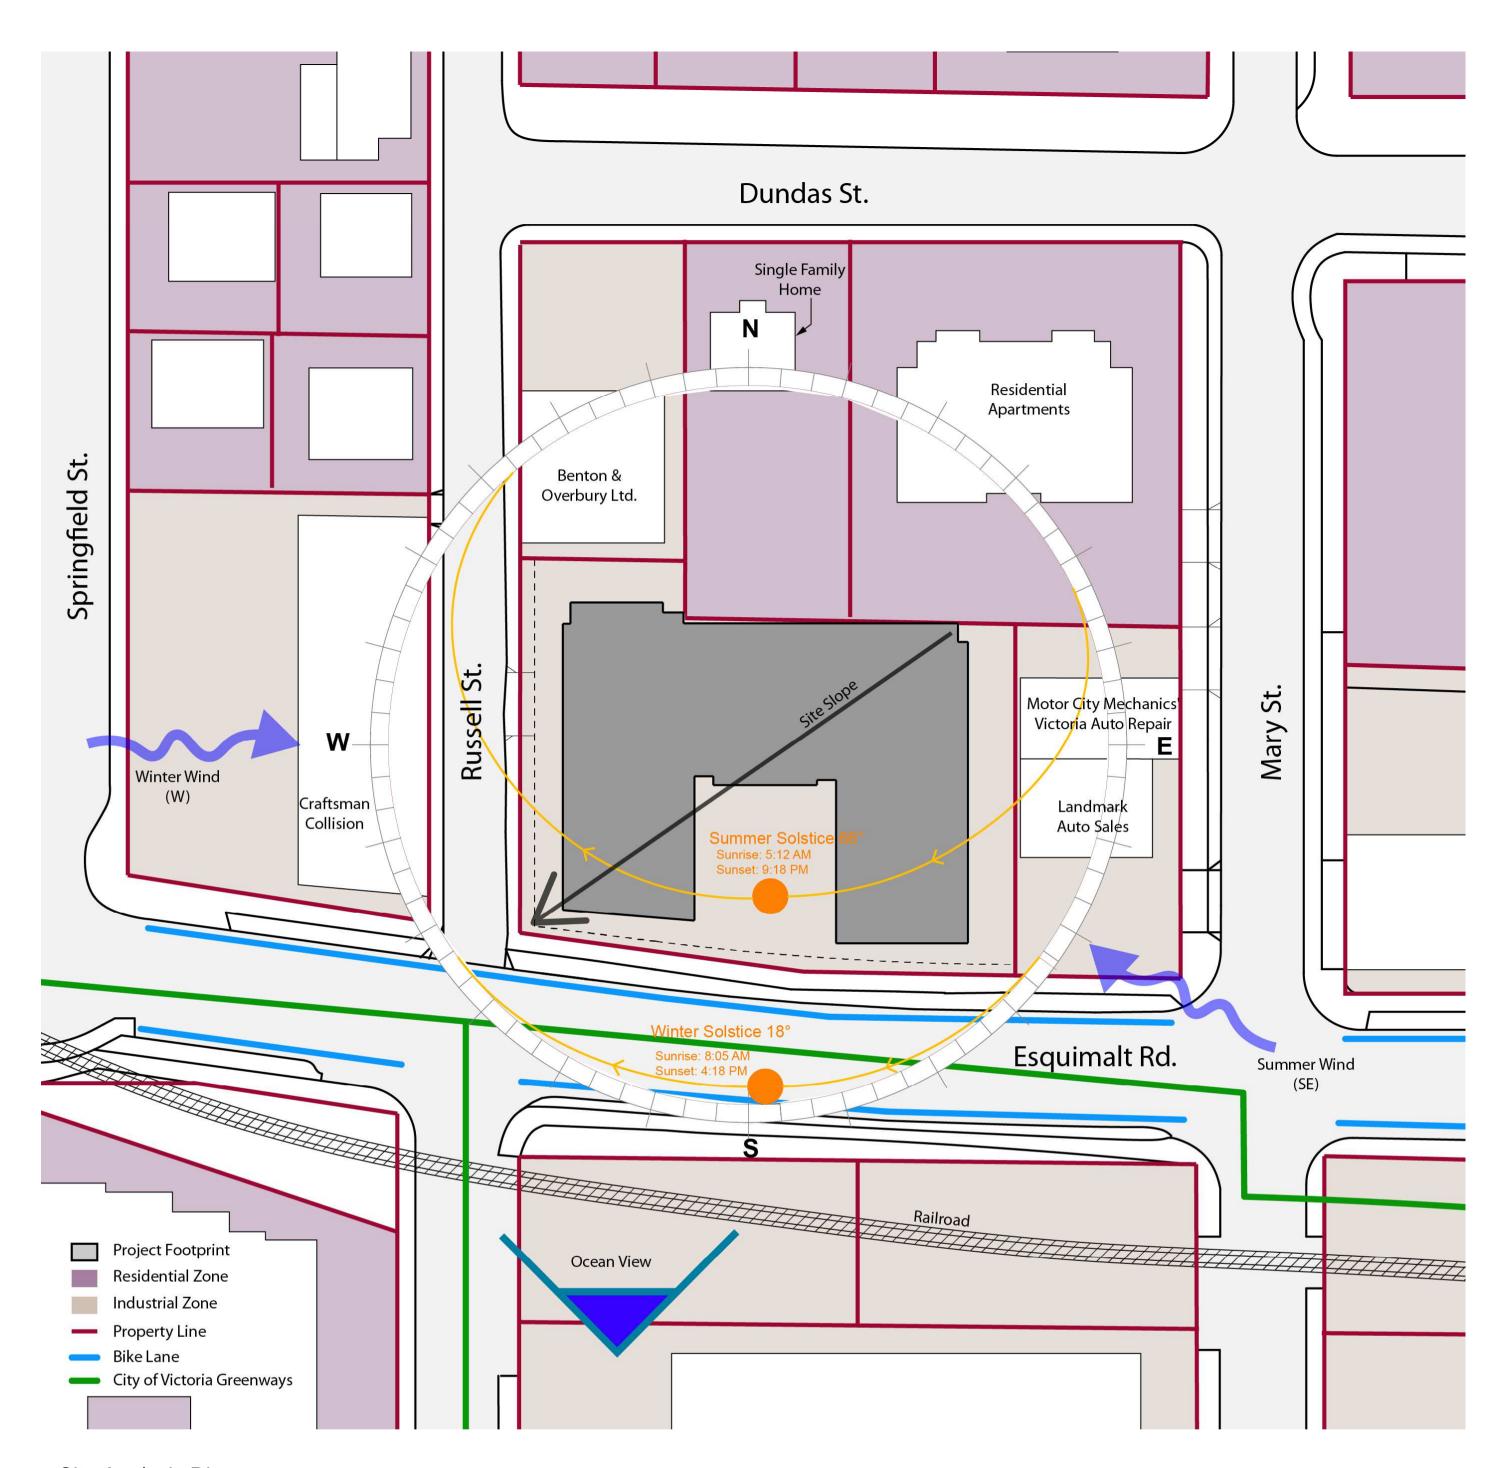

Site Analysis Diagram

#### **Project Overview**


Factory Block is a 6-storey, mixed use building nestled between a residential neighbourhood to the North, light industrial neighbours to the East and West, and a mix of both to the South. The project is a short walk away from the Songhees waterfront walking trail and the harbour and has ocean views to the South from a few floors up. The site is located along a greenway, bike lane and transit route, making it easy to commute into downtown Victoria and an ideal location for rental housing. The site has a 3m slope from the NE to the SW corners, which reduces the appearance of the overall building height from the adjacent neighbourhood.

The site is currently zoned as M-1 light industrial, and we will be seeking zoning to allow residential and commercial mixed-use. The ground floor will include cafe, office and retail uses with a generous landscaped courtyard facing Esquimalt road, that knits all of the uses together. Two 5-storey rental residential buildings with a total of 85 units, sit above the commercial spaces. An underground parkade pushes 1.5 storeys below grade and is accessed off of Russell street. The project seeks to find opportunities to integrate pockets of landscaping to provide areas for public and private outdoor use.

#### **Massing Split**

The parti diagram shows a mass split into two and pulled towards the East and West. This move was made in consideration of the neighbours to the North, increasing sunlight, maintaining views and breaking down the massing along Esquimalt Road. The mass to the West is set back from Russell street by 3.7m to allow a landscape buffer, and the mass to the East is held off from the neighbouring property line by 4m to increase light and landscaped area in between.

The resultant area in between the two masses presents an opportunity for shared outdoor spaces.

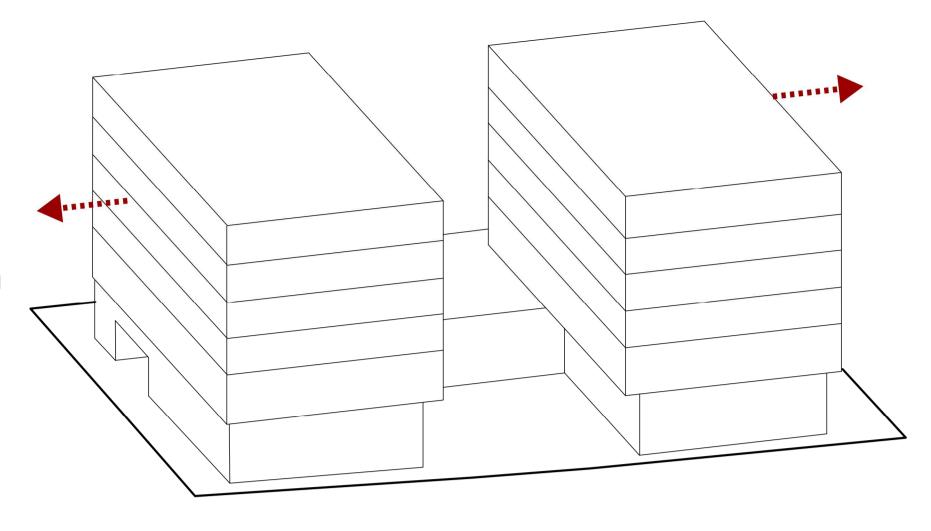


#### **Activated Ground Plane**

The two residential masses shift up and free up the ground floor for commercial uses which would both serve the residents above and the public. A variety of uses is planned for the site to maximize the activity generated within the courtyard.

The ceiling height at Level 1 is maximized in the commercial spaces to increase the amount glazing, drawing natural light into the spaces and people in from the street. The commercial spaces are set in from the residential building above, providing a sense of entry for the businesses and maximizing the area of the courtyard.

The underground parkade access is located off of Russell street, allowing the building facade along Esquimalt road to maintain a strong street edge. Loading and services are tucked away from the main commerical activity and sheltered from view due to the site slope to the North.

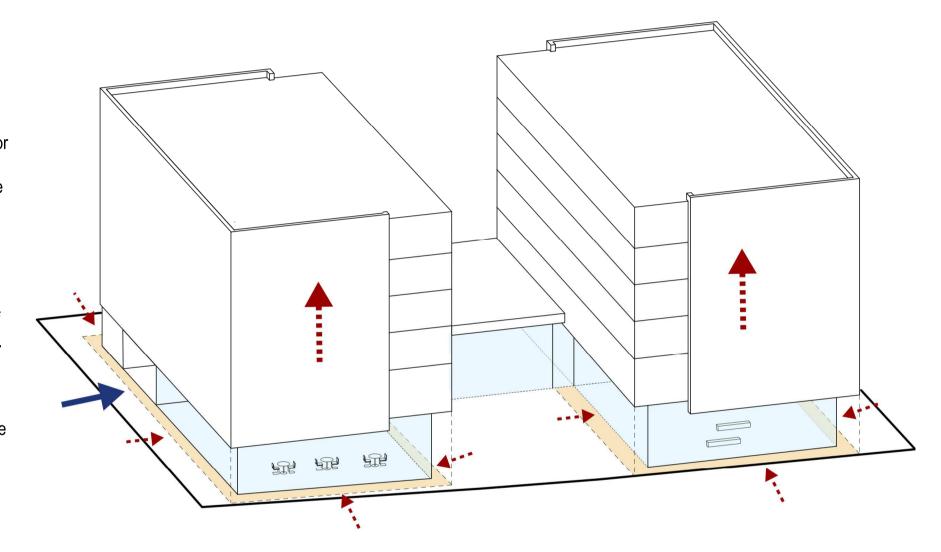


#### **Outdoor Spaces**

The public, centralized courtyard faces Esquimalt road, a major greenway, cycling route and transit route. This space acts as a place of respite while waiting for a bus, a coffee stop on your morning cycle, or a place to connect with neighbours or coworkers.

Concentrating the residential and commercial entrances in the courtyard ensures a high level of activity and crossover and provides 'eyes on the street' for all hours of the day, enhancing levels of safety and comfort.

The commerical tenant to the North has access to a private outdoor terrace at the mezzanine level, which subsequently draws light into the commerical space from the North. This tenant also has access to a private rooftop patio at Level 2, which simultaneously provides landscaped rooftop views for the residents above.

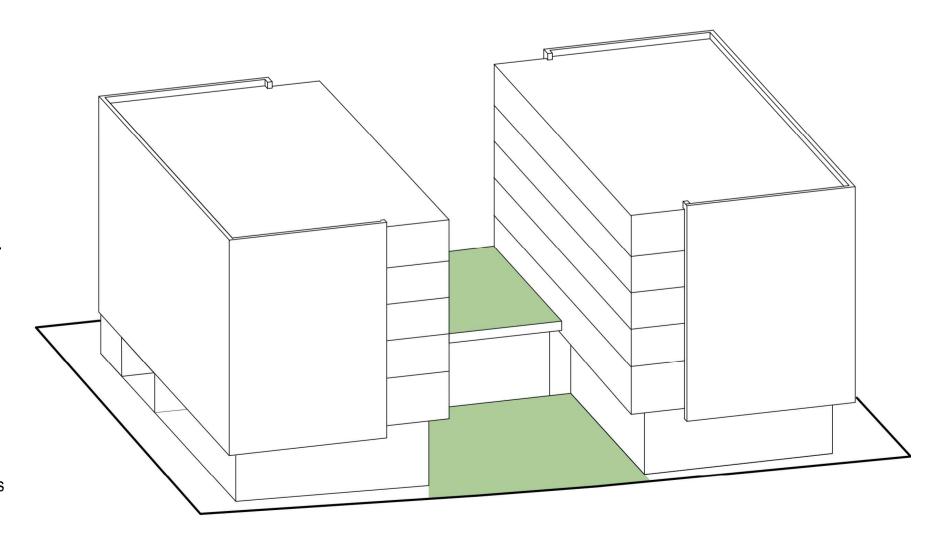



#### Core + Shell Facade

Dividing the mass creates two conditions - an inner core - which feeds off of the energy of the vibrant courtyard; and an outer shell - a calmer presence facing the quieter neighborhood.

Studios and smaller units face the inner courtyard, building a sense of community between single occupants, and larger units are located on the quieter, outer edges of the building.

In keeping with the industrial nature of the neighborhood, the material palette uses a variety of metal cladding rainscreen systems. The duality of the building is reflected in the way that the light grey cladding wraps around the outer edge. The proportions of the wrapping outer shell help to break down the scale of the massing from Esquimalt road and from the North. The grey, profiled metal cladding brings a residential scale and attitude to the simple mass. The inner core is clad with white corrugated metal panels which offer a casual, raw aesthetic and add a playfulness to the facade as the shadows move across the building.

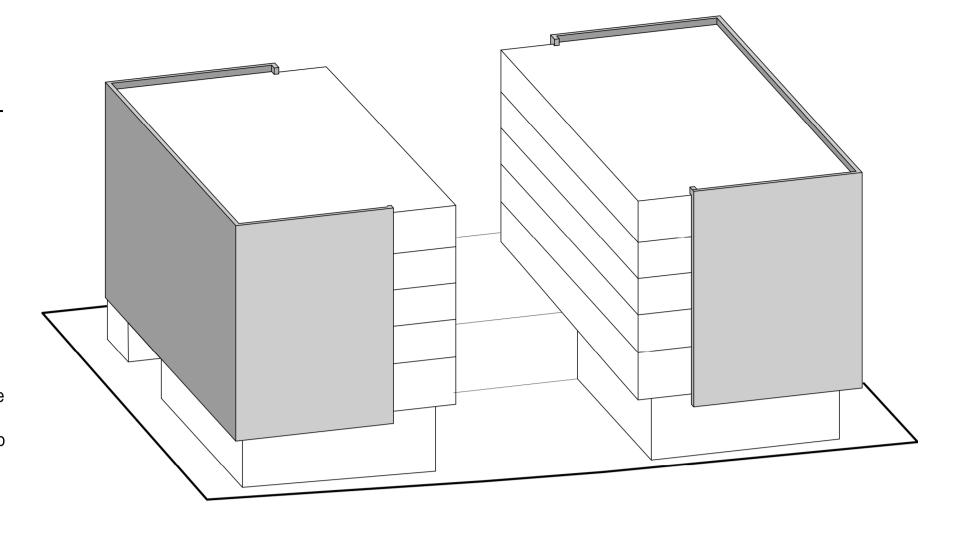

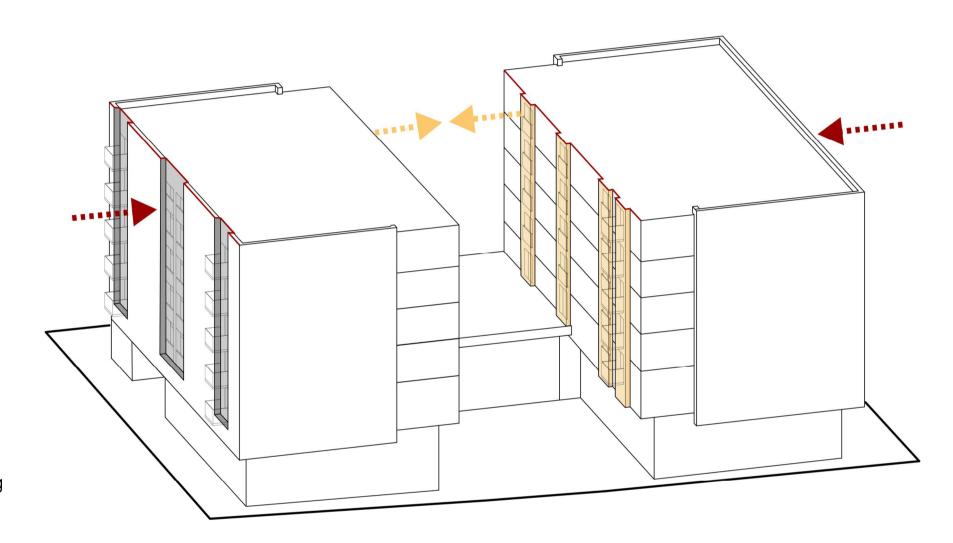

#### **Connection to Outdoors**

Balconies are accessed from each unit to maximize fresh air into the units. The 2 bedroom units are given full step-out balconies and other units are assigned juliets. Along the outer shell, the balconies are set back slightly to provide increased privacy, the inner units have courtyard facing juliets as though they're reaching towards the energy in the courtyard.

#### Glazing + Geometry

Simplicity in building from and glazing articulation is reflective of the warehouse and industrial nature of the neighborhood, and in line with the aesthetics of the residential low-rise buildings in the

The overall glazing ratio has been limited to 40% openings in the residential portions of the building, reducing heat gain and ensuring the building complies with the step 3 energy code requirements.

The window openings in the two facade conditions vary from monolithic linear punched openings on the outer shell, to a series of smaller openings on the inner facade - furthering the duality of two conditions.

At the ground level, screens have been introduced to mitigate solar heat gain along the south facade. The metal screens add another dimension to the industrial metal material palette and create interesting shadows within the spaces. Similar screens will be used on the juliet balconies in the inner facing facade creating a unifying element between all levels.



#### **Landscaped Amenities**


A - The landscaping in the public courtyard blurs the lines between indoor and outdoor by extending its paving and planting into the indoor commerical spaces. The courtyard acts as spill out space for the retail and commerical tenants. Centralized bicycle racks draw cyclists in from the main route, a canopy wrapping around the facade invites guests to occupy the outdoor space in any weather, and playful integration of lighting makes the space usable any time of day.

B - Along the East property line, the building has been set back to create a landscaped mews, providing a quiet place to step away from the busy street.

C - Along the northern edge, trees and planting provide a landscaped buffer for the properties to the North, softening the building facade. The rooftop of Level 2 offers private outdoor space to the tenant below.

D - At Level 6, residents can grow food in the communal garden plots, make dinner and enjoy the south facing ocean views with fellow neighbours from the landscaped, shared amenity rooftops.


E - Along the West property line, the building has been set back to extend the cafe patio to provide further seating and bicycle parking.

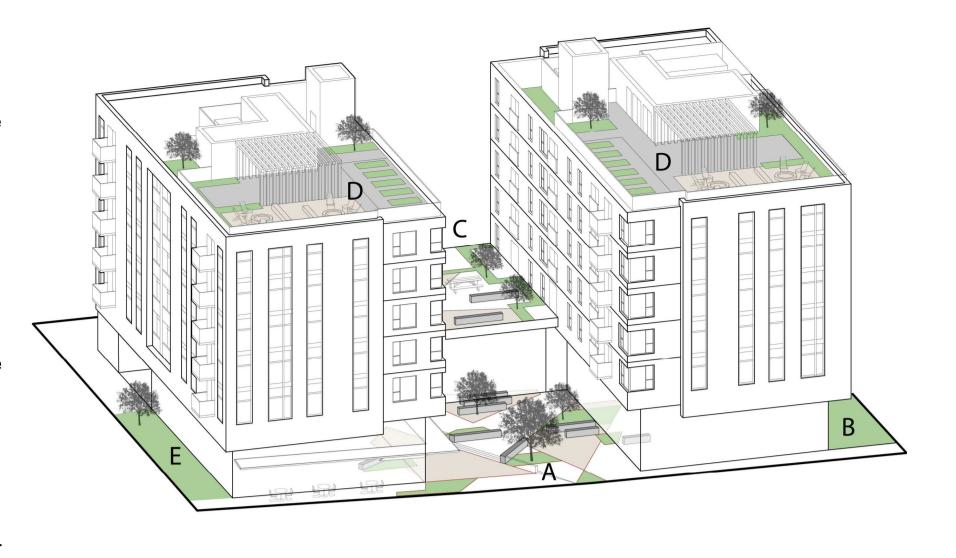

#### **Mixed-Use Programming**

The mixed-use nature of the building provides opportunity for chance meetings, collaboration and creates an energy on the site that will draw people in and encourage them to stay.

Concentrating the residential and commercial entrances in the centralized courtyard ensures a high level of activity and crossover. A variety of outdoor landscaped areas and amenities provides options for the residents to stay within the boundaries of the site and encourages the neighbours to visit.

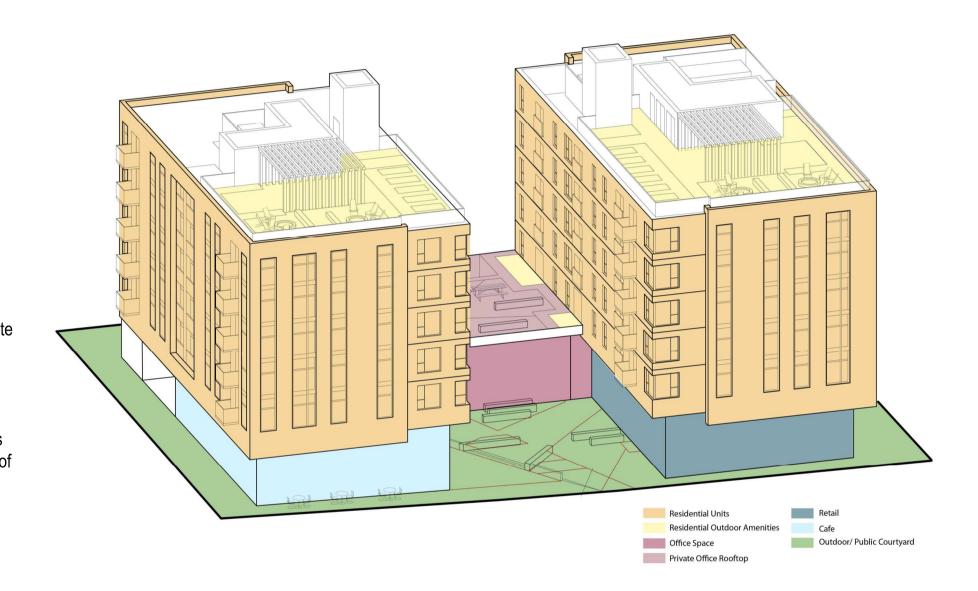


#### **Green Building Indicators**

- 1 Reduced car parking on site, modo car share vehicle and increased short term and long-term bicycle parking
- 2 Rooftop garden plots for communal food cultivation
- 3 Heat recovery within the building using air source heat pumps
- 4 Carefully designed envelope that targets a 40% window to wall ratio to meet step 3 of the building code
- 5 Increased tree count on site, green vertical surfaces, and planted courtyard and rooftops surround the building




## March 21

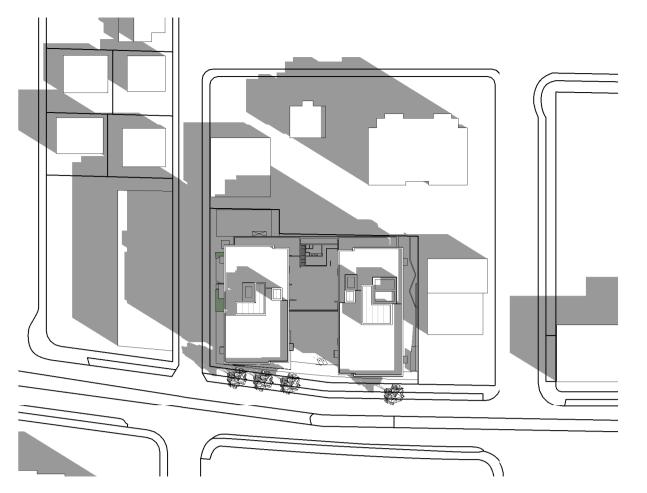


March - 9:00 AM

## June 21

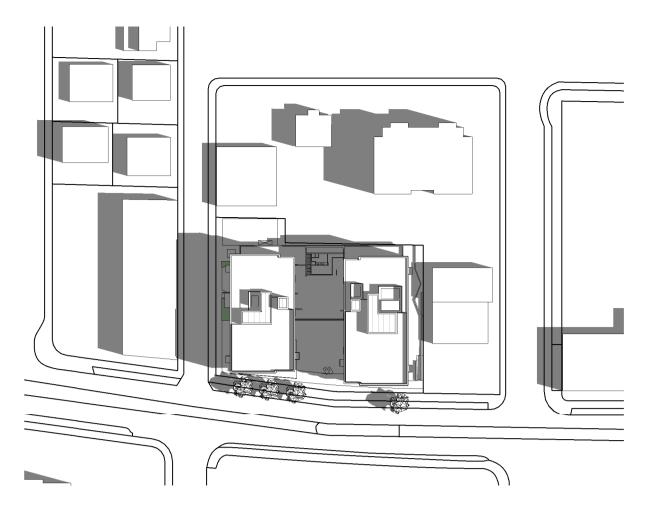


June - 9:00 AM

# September 21

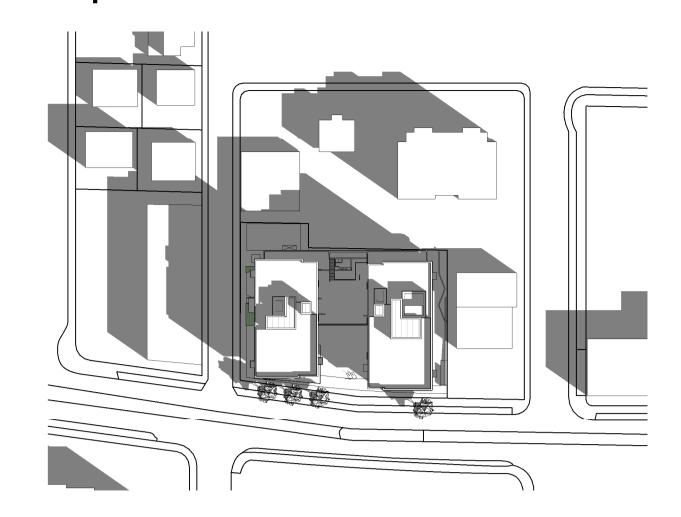

September - 9:00 AM


## December 21

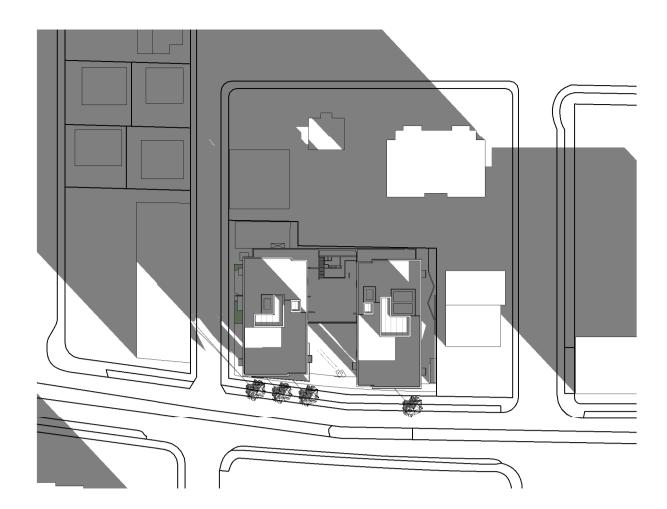


December - 9:00 AM



March - 12:00 PM

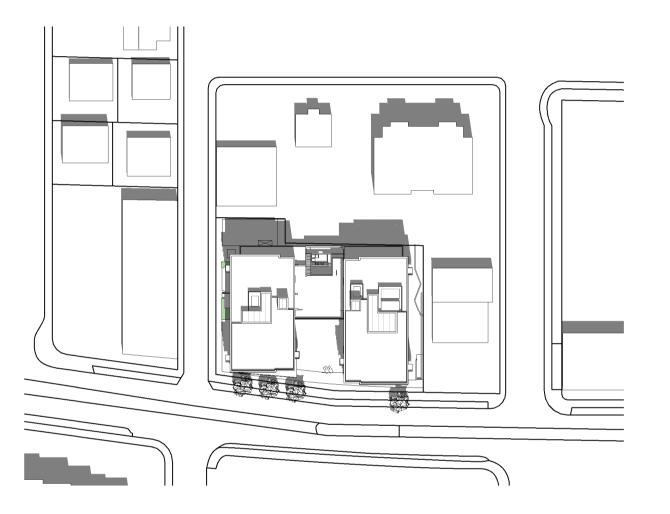


June - 12:00 PM

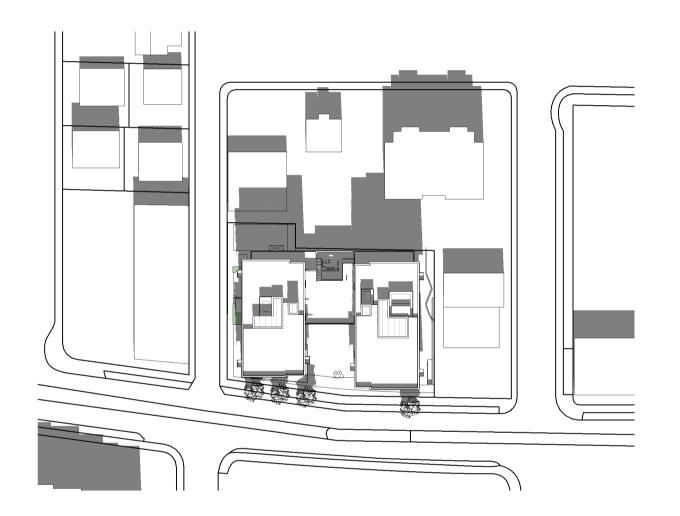


September - 12:00 PM




December - 12:00 PM

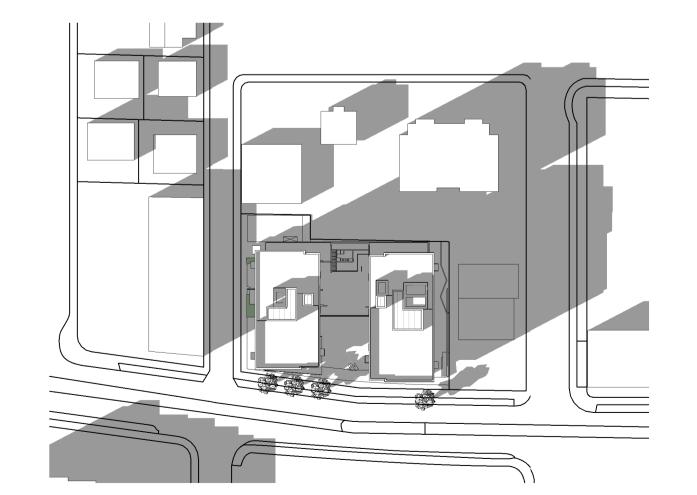


March - 4:00 PM

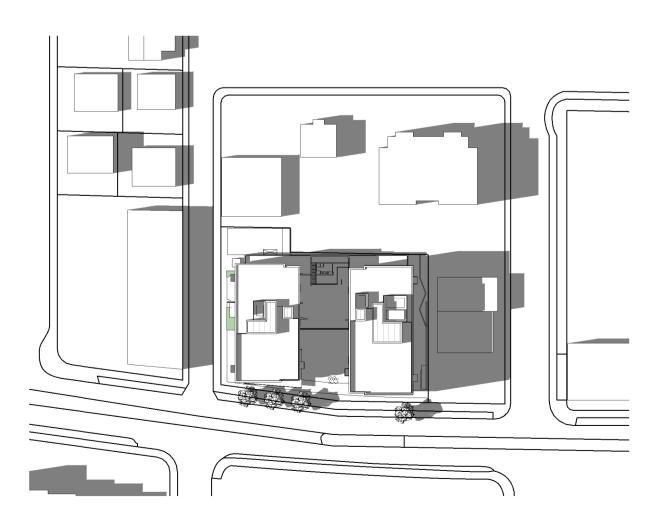

June - 4:00 PM

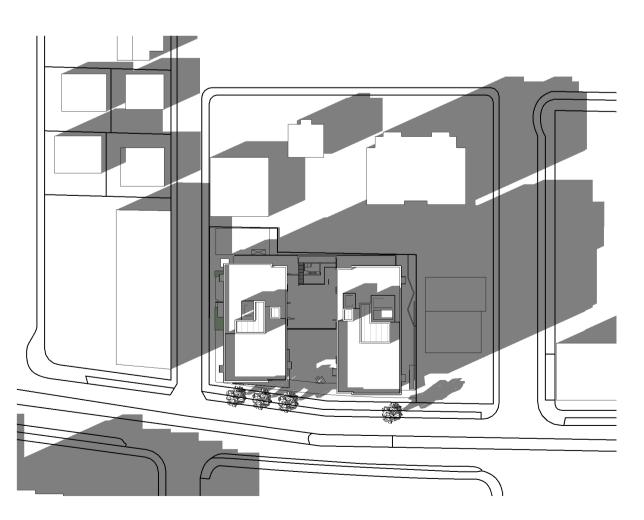

September - 4:00 PM

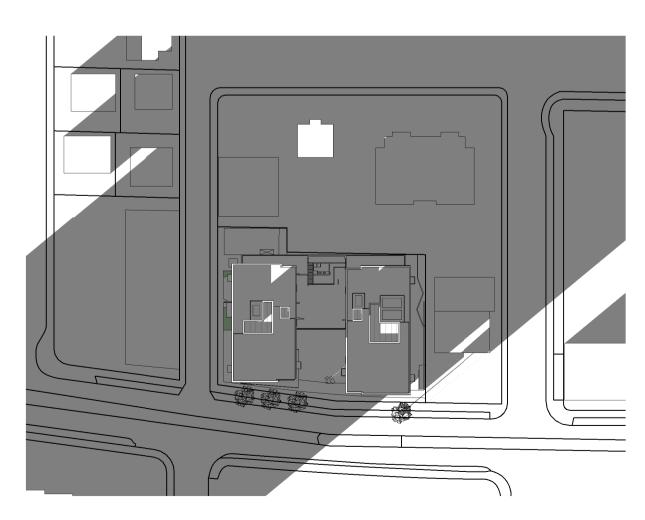

December - 4:00 PM





#### 1. - RESIDENTIAL FACADE


- 1.1 METAL PANEL WHITE CORRUGATED
   Rainscreen Assembly
   Corrugation vertically
- 1.2 METAL PANEL LIGHT GREY PROFILED- Rainscreen Assembly- Profiled Shingles
- 1.3 RESIDENTIAL GLAZING
  -Window Wall Glazing System

#### 2. COMMERCIAL MATERIALS


- 2.1 CONCRETE
   c/w Clear Sealer
- 2.2 MASS TIMBER
   Columns, Floors + Walls
- 2.3 CURTAIN WALL GLAZING
   c/w Profiled Mullion Caps

#### 3. GUARDS & SCREENS

- 3.1 GLASS GUARD C/W AL. HANDRAIL
  -C/W Aluminum Handrail + Posts
- **3.2a PERFORATED ALUMINUM SCREEN**-Powder Coated
- 3.2b PERFORATED ALUMINUM SCREEN GUARD -c/w Aluminum Handrail
- -Powder Coated
  3.3 ALUMINUM SCREEN W/ LANSCAPING
  - Powder Coated
  - Vines (refer to landscape)

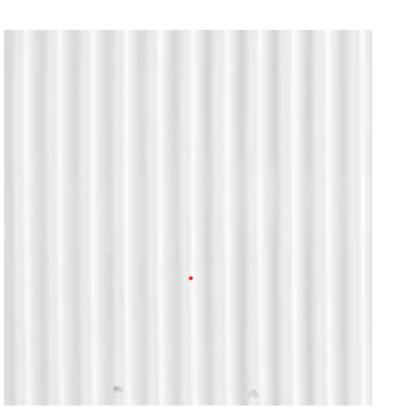

1.1 - Corrugated Metal - White

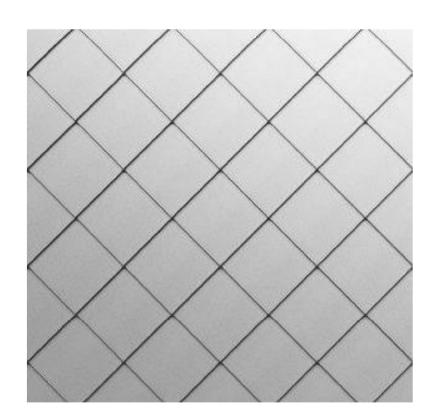

1.2 - Profiled Metal Shingle - Light



1.3 - Residential Glazing



2.1 - Concrete



2.2 - Mass Timber




2.3 - Commercial Glazing



3.1 - Rooftop Railings



3.2 - Architectural Perforated Panels

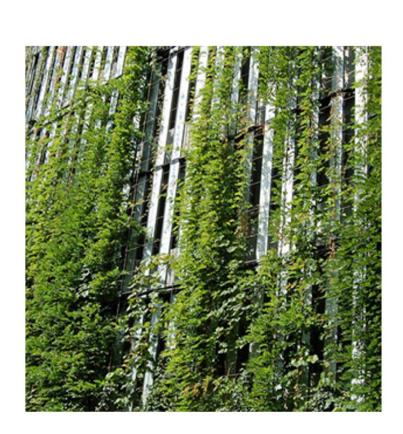

3.3 - Aluminum Screen w/ Vines





View Looking North from Esquimalt Rd.







View North West View from South West of Russell St.



View from Property to the North










Commercial Rooftop Terrace



Commercial Entrance




Public Courtyard

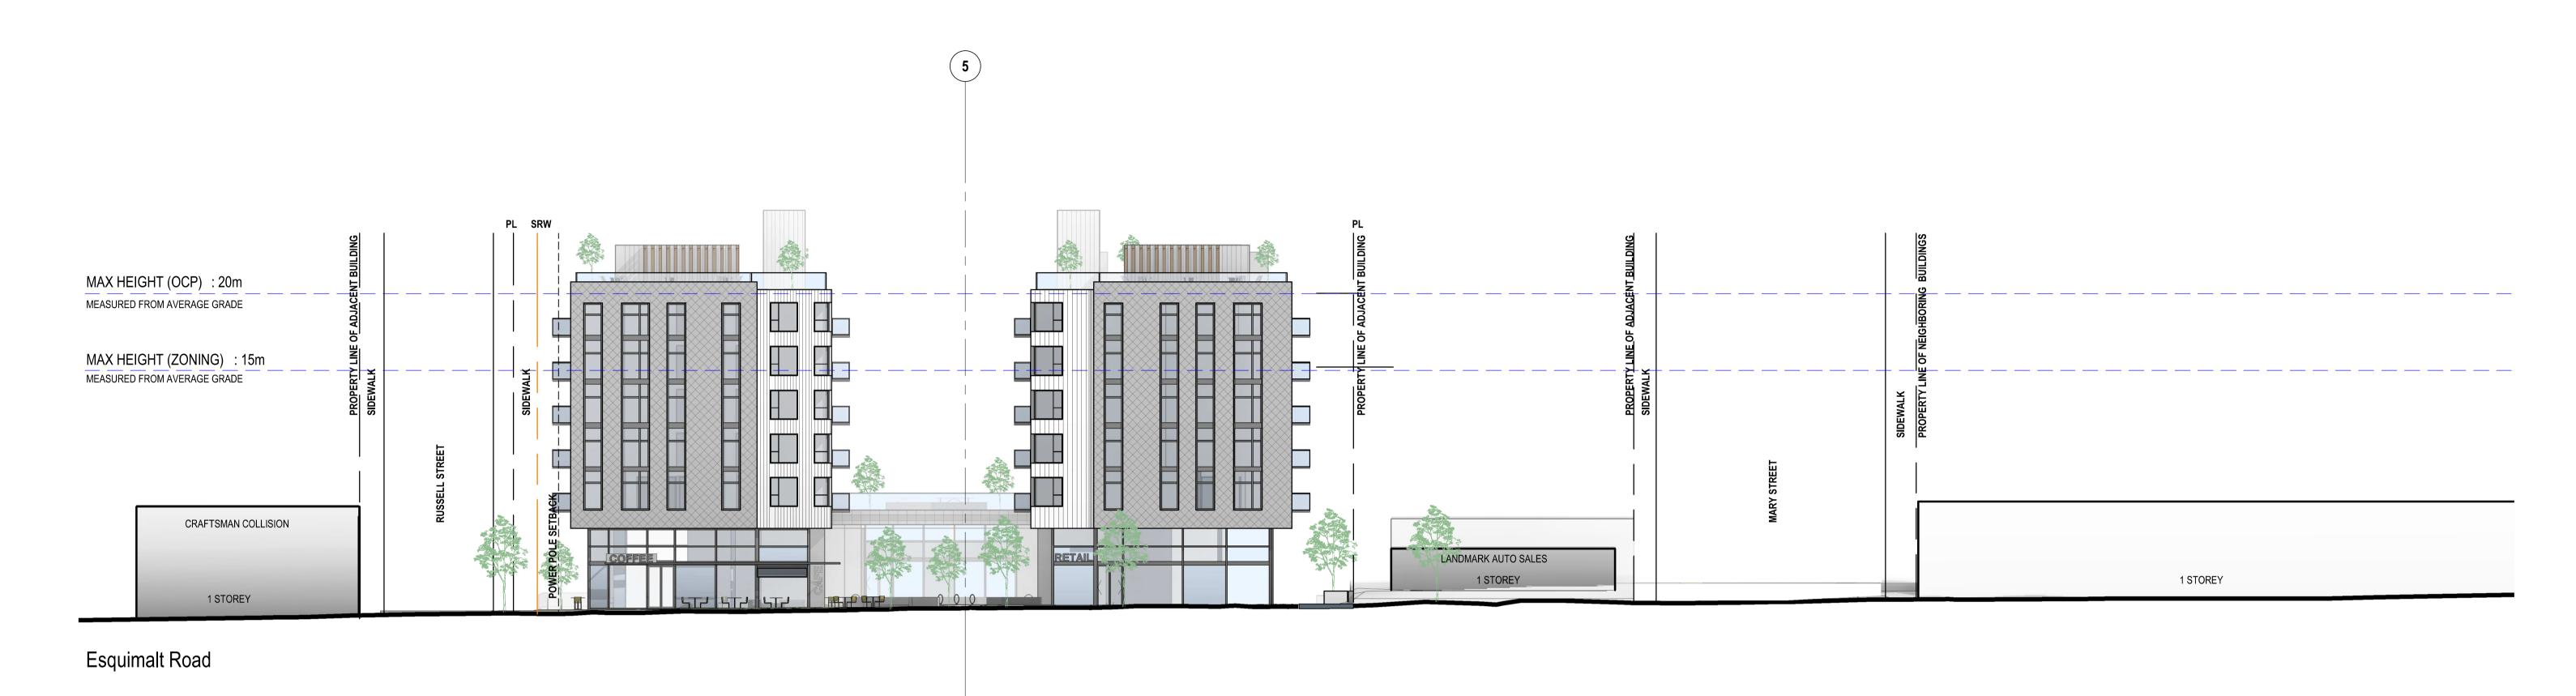





Russell Street

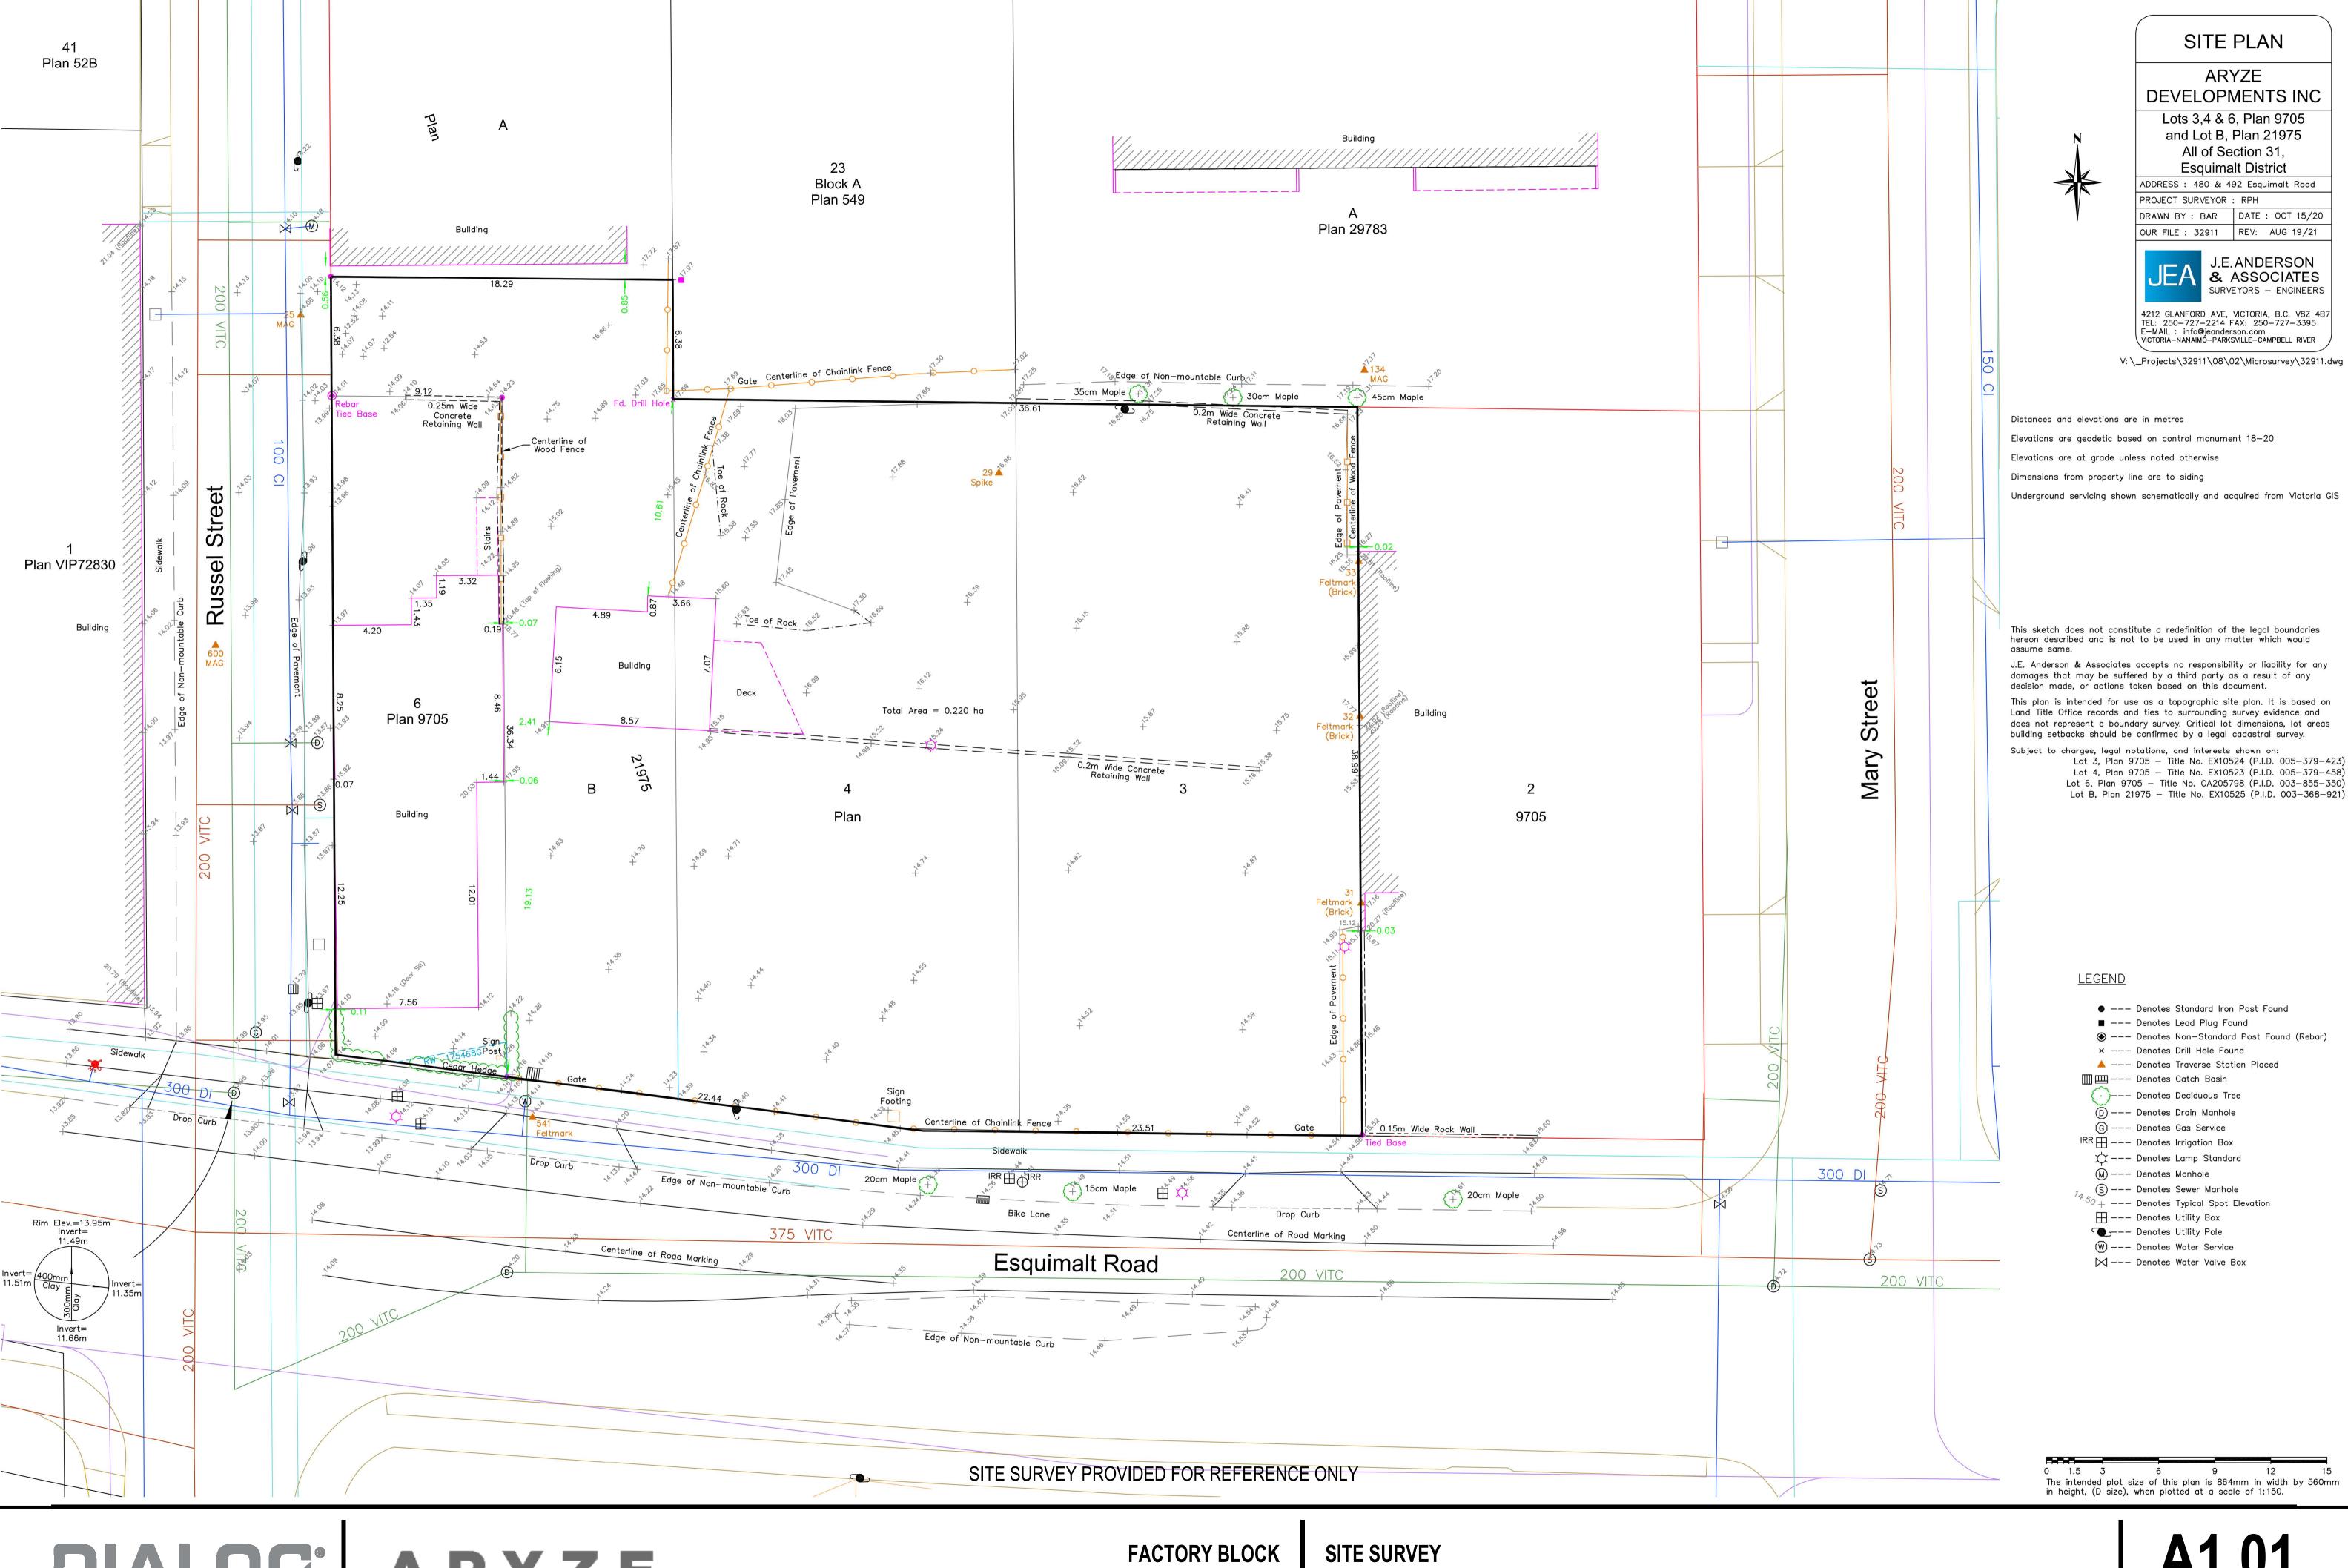

DIALOG® ARYZE

480 + 492 ESQUIMALT RD

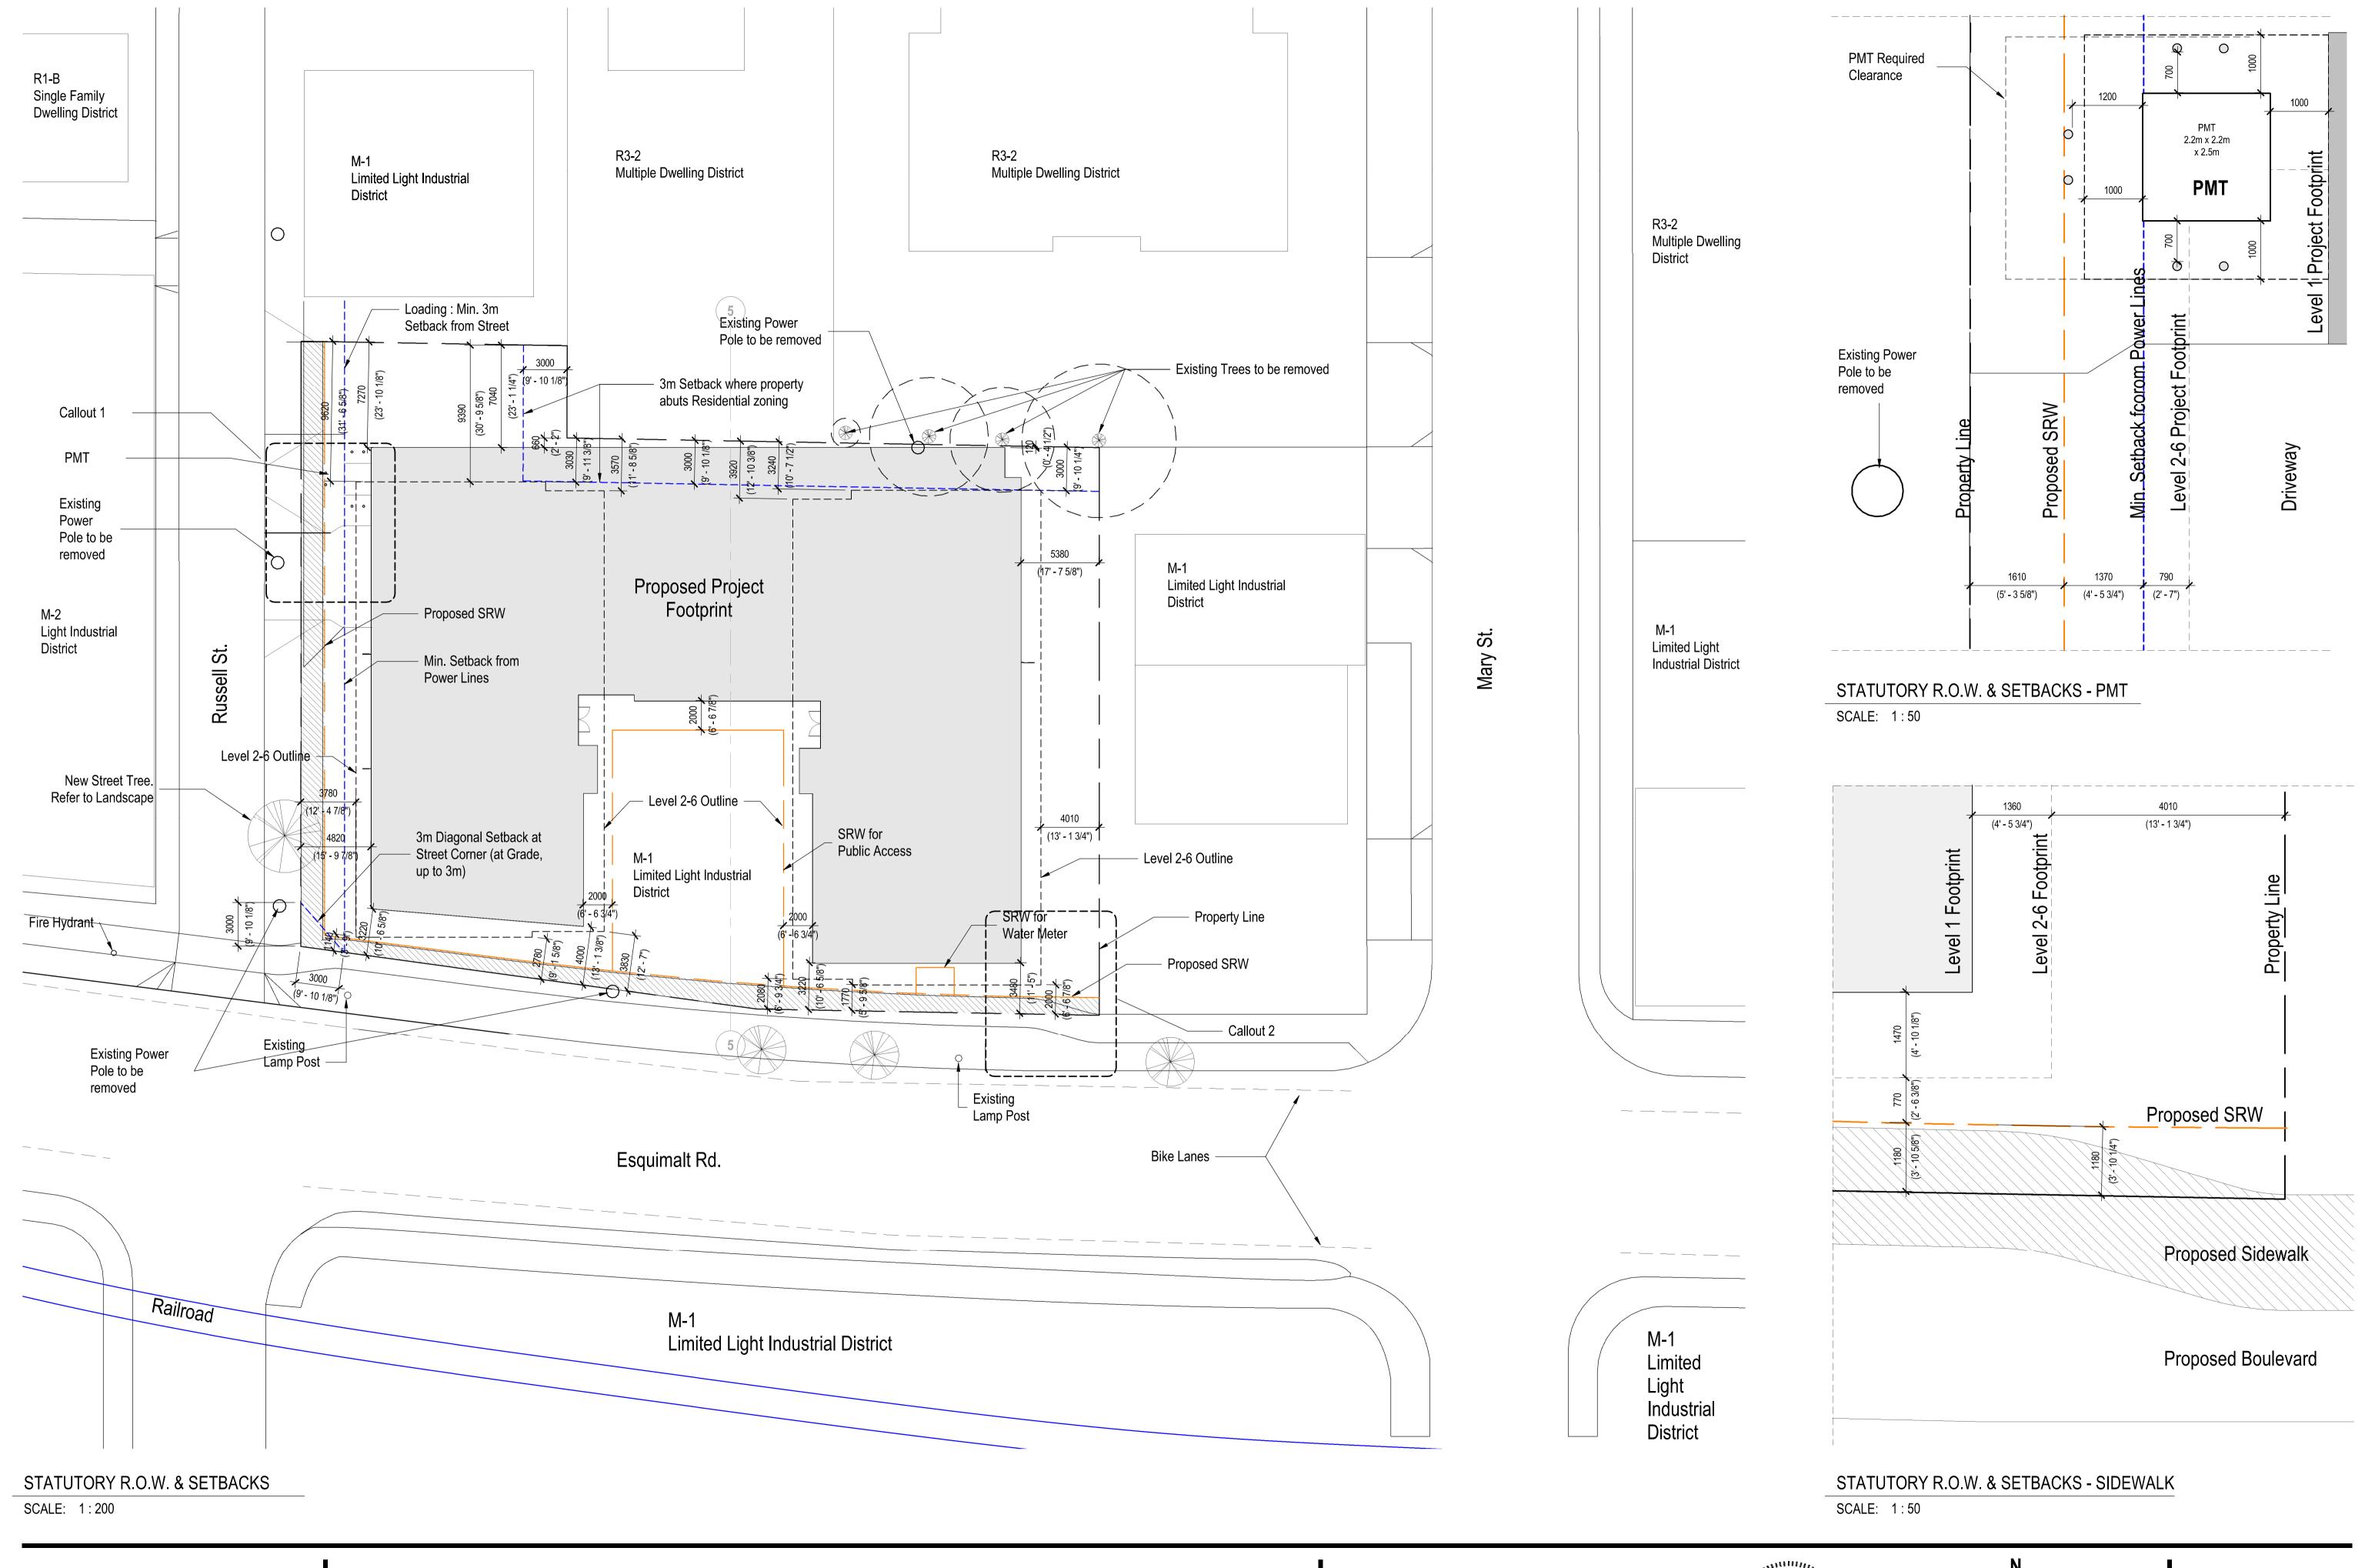

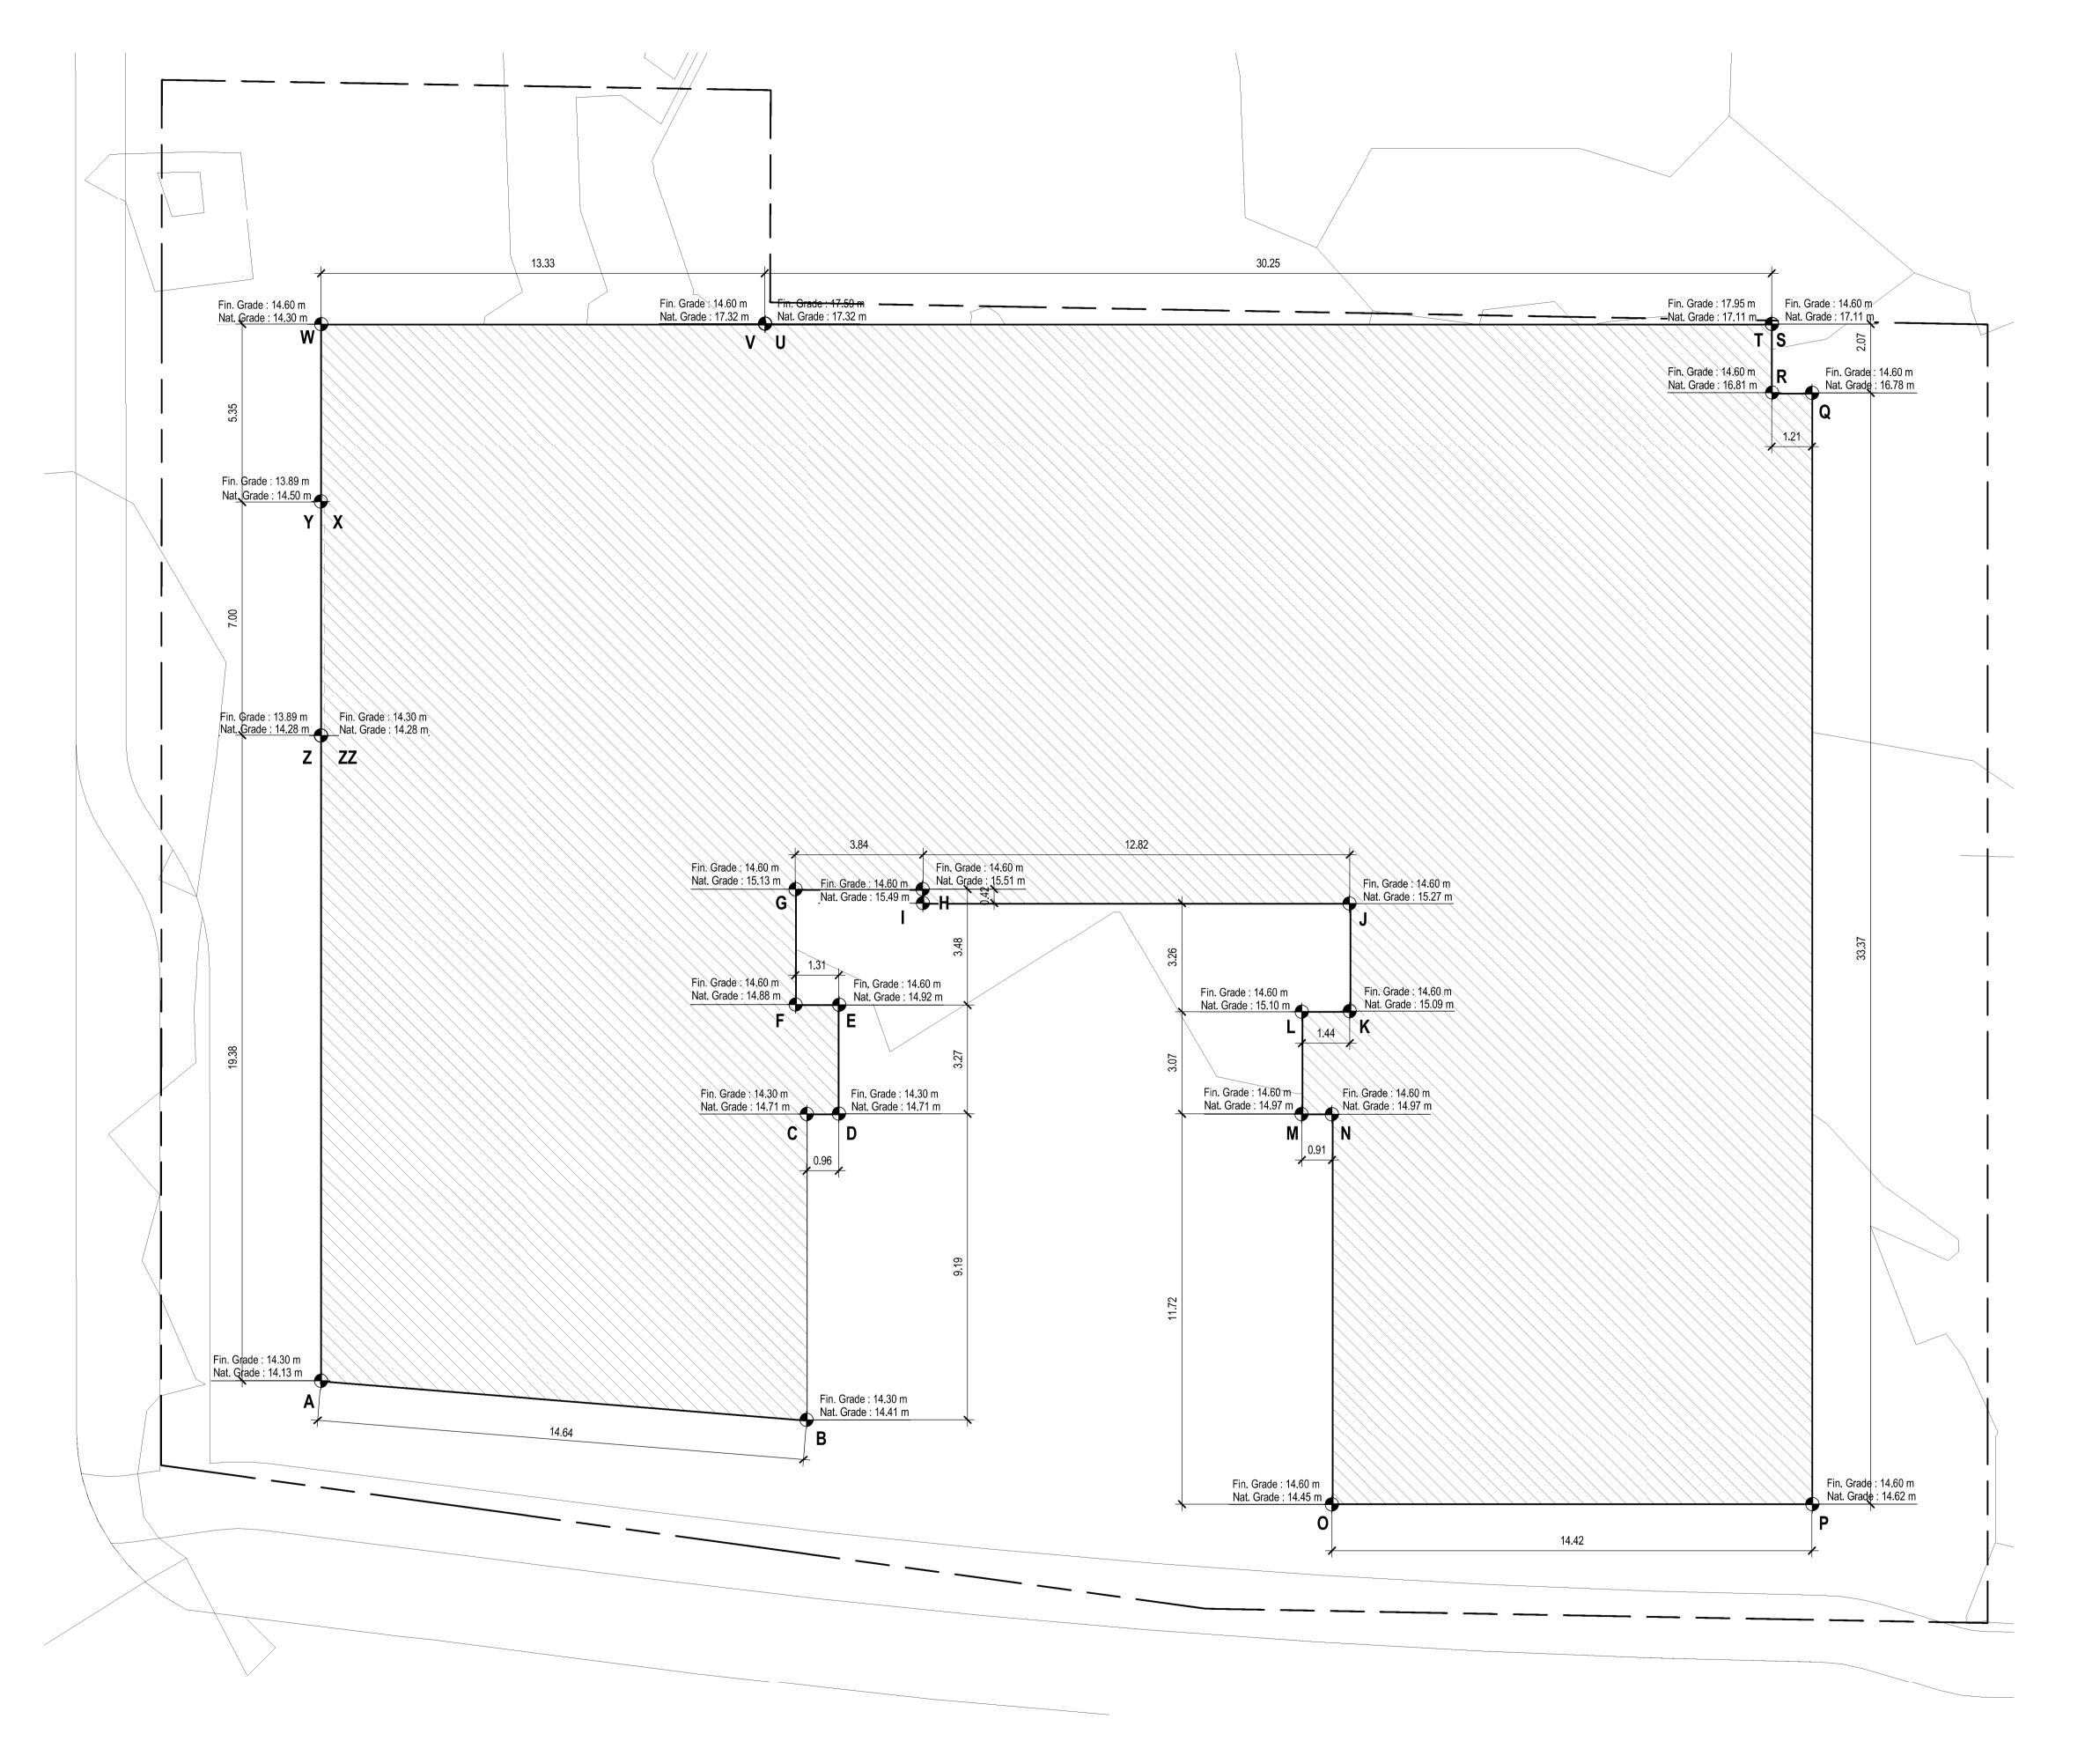

#### **GRADE POINTS**

_	NATURAL (m)	FINISHED (m)	LOW POINT
POINT A	14.13	14.30	14.13
POINT B	14.41	14.30	14.30
POINT C	14.71	14.30	14.30
POINT D	14.71	14.30	14.30
POINT E	14.92	14.60	14.60
POINT F	14.88	14.60	14.60
POINT G	15.13	14.60	14.60
POINT H	15.51	14.60	14.60
POINT I	15.49	14.60	14.60
POINT J	15.27	14.60	14.60
POINT K	15.09	14.60	14.60
POINT L	15.10	14.60	14.60
POINT M	14.97	14.60	14.60
POINT N	14.97	14.60	14.60
POINT O	14.46	14.60	14.46
POINT P	14.63	14.60	14.60
POINT Q	16.78	14.60	14.60
POINT R	16.81	14.60	14.60
POINT S	17.11	14.60	14.60
POINT T	17.11	17.59	17.11
POINT U	17.32	17.59	17.32
POINT V	17.32	14.60	14.60
POINT W	14.30	14.60	14.30
POINT X	14.50	14.60	14.50
POINT Y	14.50	13.89	13.89
POINT Z	14.28	13.89	13.89
POINT ZZ	14.28	14.30	14.30

#### **CoV - AVERAGE GRADE CALCULATION**


		ELEV. (m)			]	OIST. (m)		
POINTS A + B	(	<b>14.13</b> + <b>14.30</b> ) /		2	Х	14.64	=	208.1
POINTS B + C	(	14.30 + 14.30 ) /	- 4	2	Х	9.19	=	131.4
POINTS C + D	(	14.30 + 14.30 ) /	- ,	2	Х	0.96	=	13.8
POINTS D + E	(	14.30 + 14.60 ) /		2	Х	3.27	=	47.2
POINTS E + F	(	14.60 + 14.60 ) /	- ;	2	Х	1.31	=	19.1
POINTS F + G	(	<b>14.60 + 14.60</b> ) /		2	Х	3.48	=	50.9
POINTS G + H	(	14.60 + 14.60 ) /	:	2	Х	3.85	=	56.1
POINTS H + I	(	<b>14.60 + 14.60</b> ) /		2	Х	0.42	=	6.1
POINTS I + J	(	<b>14.60 + 14.60</b> ) /	-	2	X	12.82	=	187.1
POINTS J + K	(	14.60 + 14.60 ) /		2	X	3.27	=	47.7
POINTS K + L	(	<b>14.60 + 14.60</b> ) /		2	X	1.44	=	21.0
POINTS L + M	(	<b>14.60 + 14.60</b> ) /	2	2	X	3.07	=	44.7
POINTS M + N	(	<b>14.60 + 14.60</b> ) /		2	X	0.91	=	13.2
POINTS N + O	(	<b>14.60</b> + <b>14.46</b> ) /		2	X	11.72	=	170.3
POINTS O + P	(	<b>14.46</b> + <b>14.60</b> ) /		2	X	14.42	=	209.5
POINTS P + Q	(	<b>14.60 + 14.60</b> ) /		2	X	33.37	=	487.3
POINTS Q + R	(	<b>14.60</b> + <b>14.60</b> ) /	_ :	2	X	1.21	=	17.7
POINTS R + S	(	<b>14.60 + 14.60</b> ) /	_ :	2	X	2.07	=	30.2
POINTS T + U	(	<b>17.11</b> + <b>17.32</b> ) /		2	X	30.25	=	520.7
POINTS V + W	(	<b>14.60 + 14.30</b> ) /	,	2	X	13.33	=	192.6
POINTS W + X	(	<b>14.30</b> + <b>14.50</b> ) /	2	2	X	5.35	=	77.0
POINTS Y + Z	(	13.89 + 13.89 ) /		2	Х	7.00	=	97.2
POINTS ZZ + A	(	14.30 + 14.13 ) /		2	Х	19.38	=	275.6
		PERIMETER (	m	1)	=	196.70		2,924.4

**BCBC GRADE** ( 14.30 + 14.30 ) / 2 POINTS B + C


**AVERAGE GRADE (m)** 






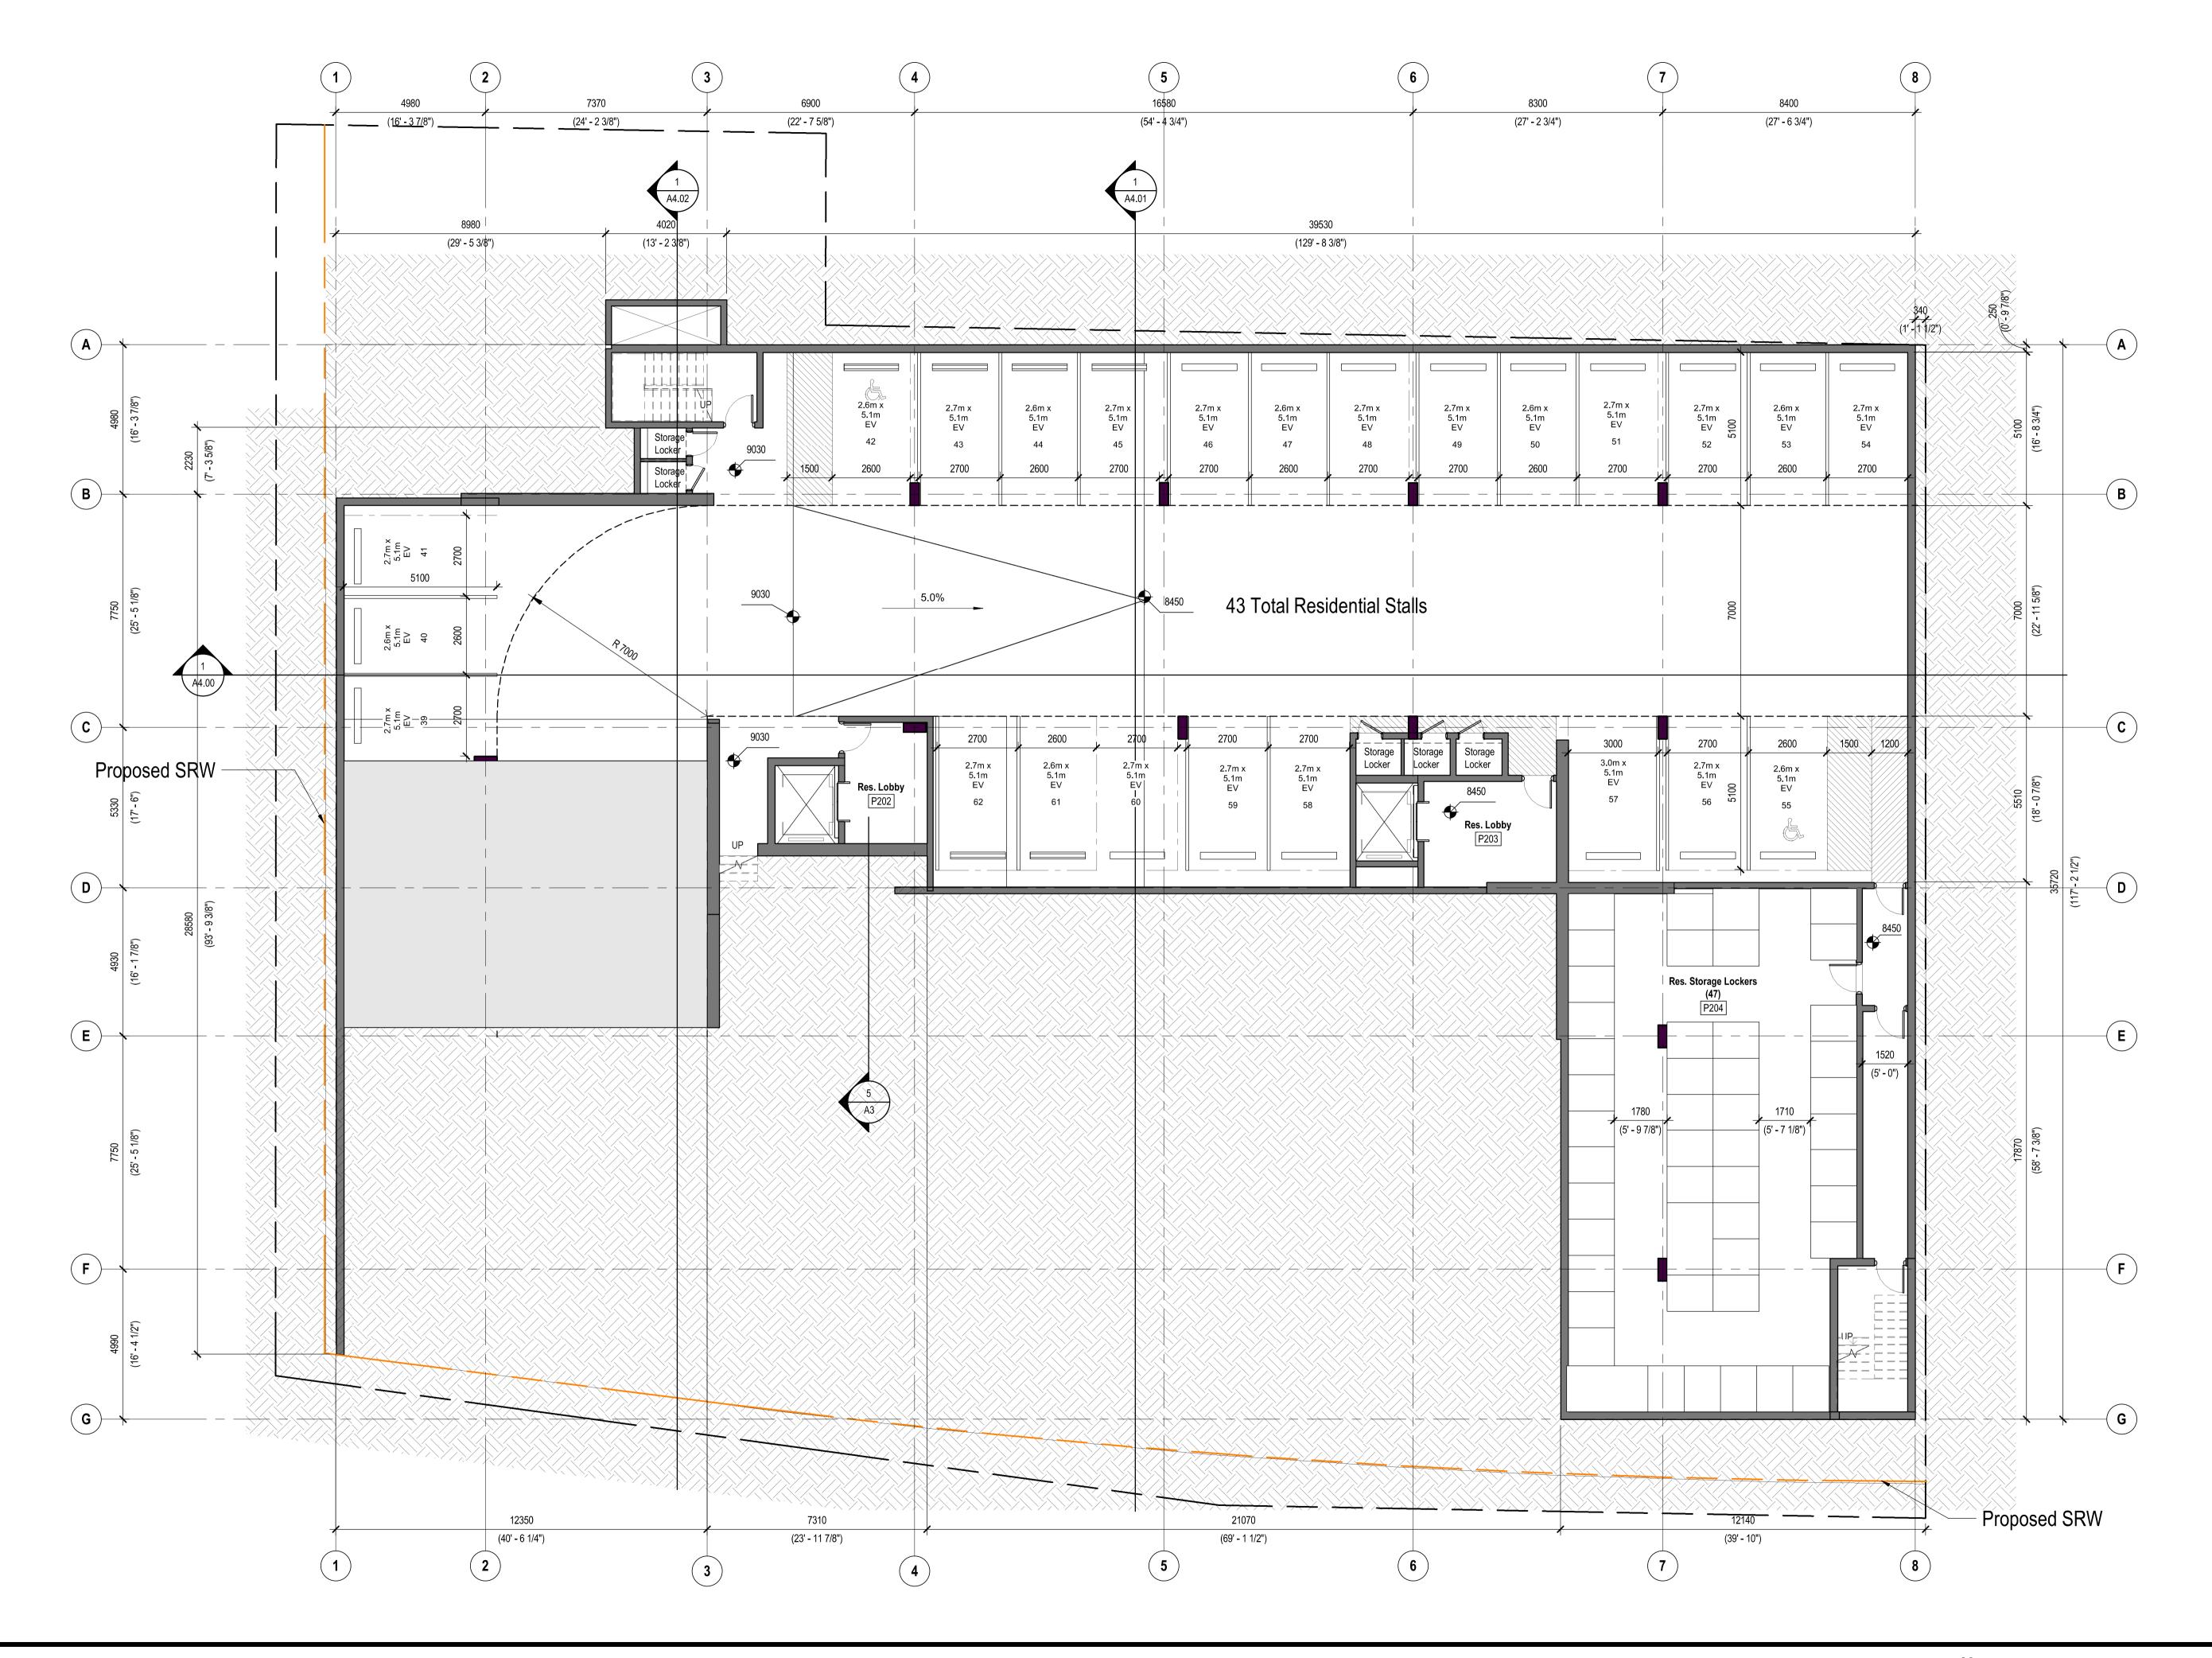



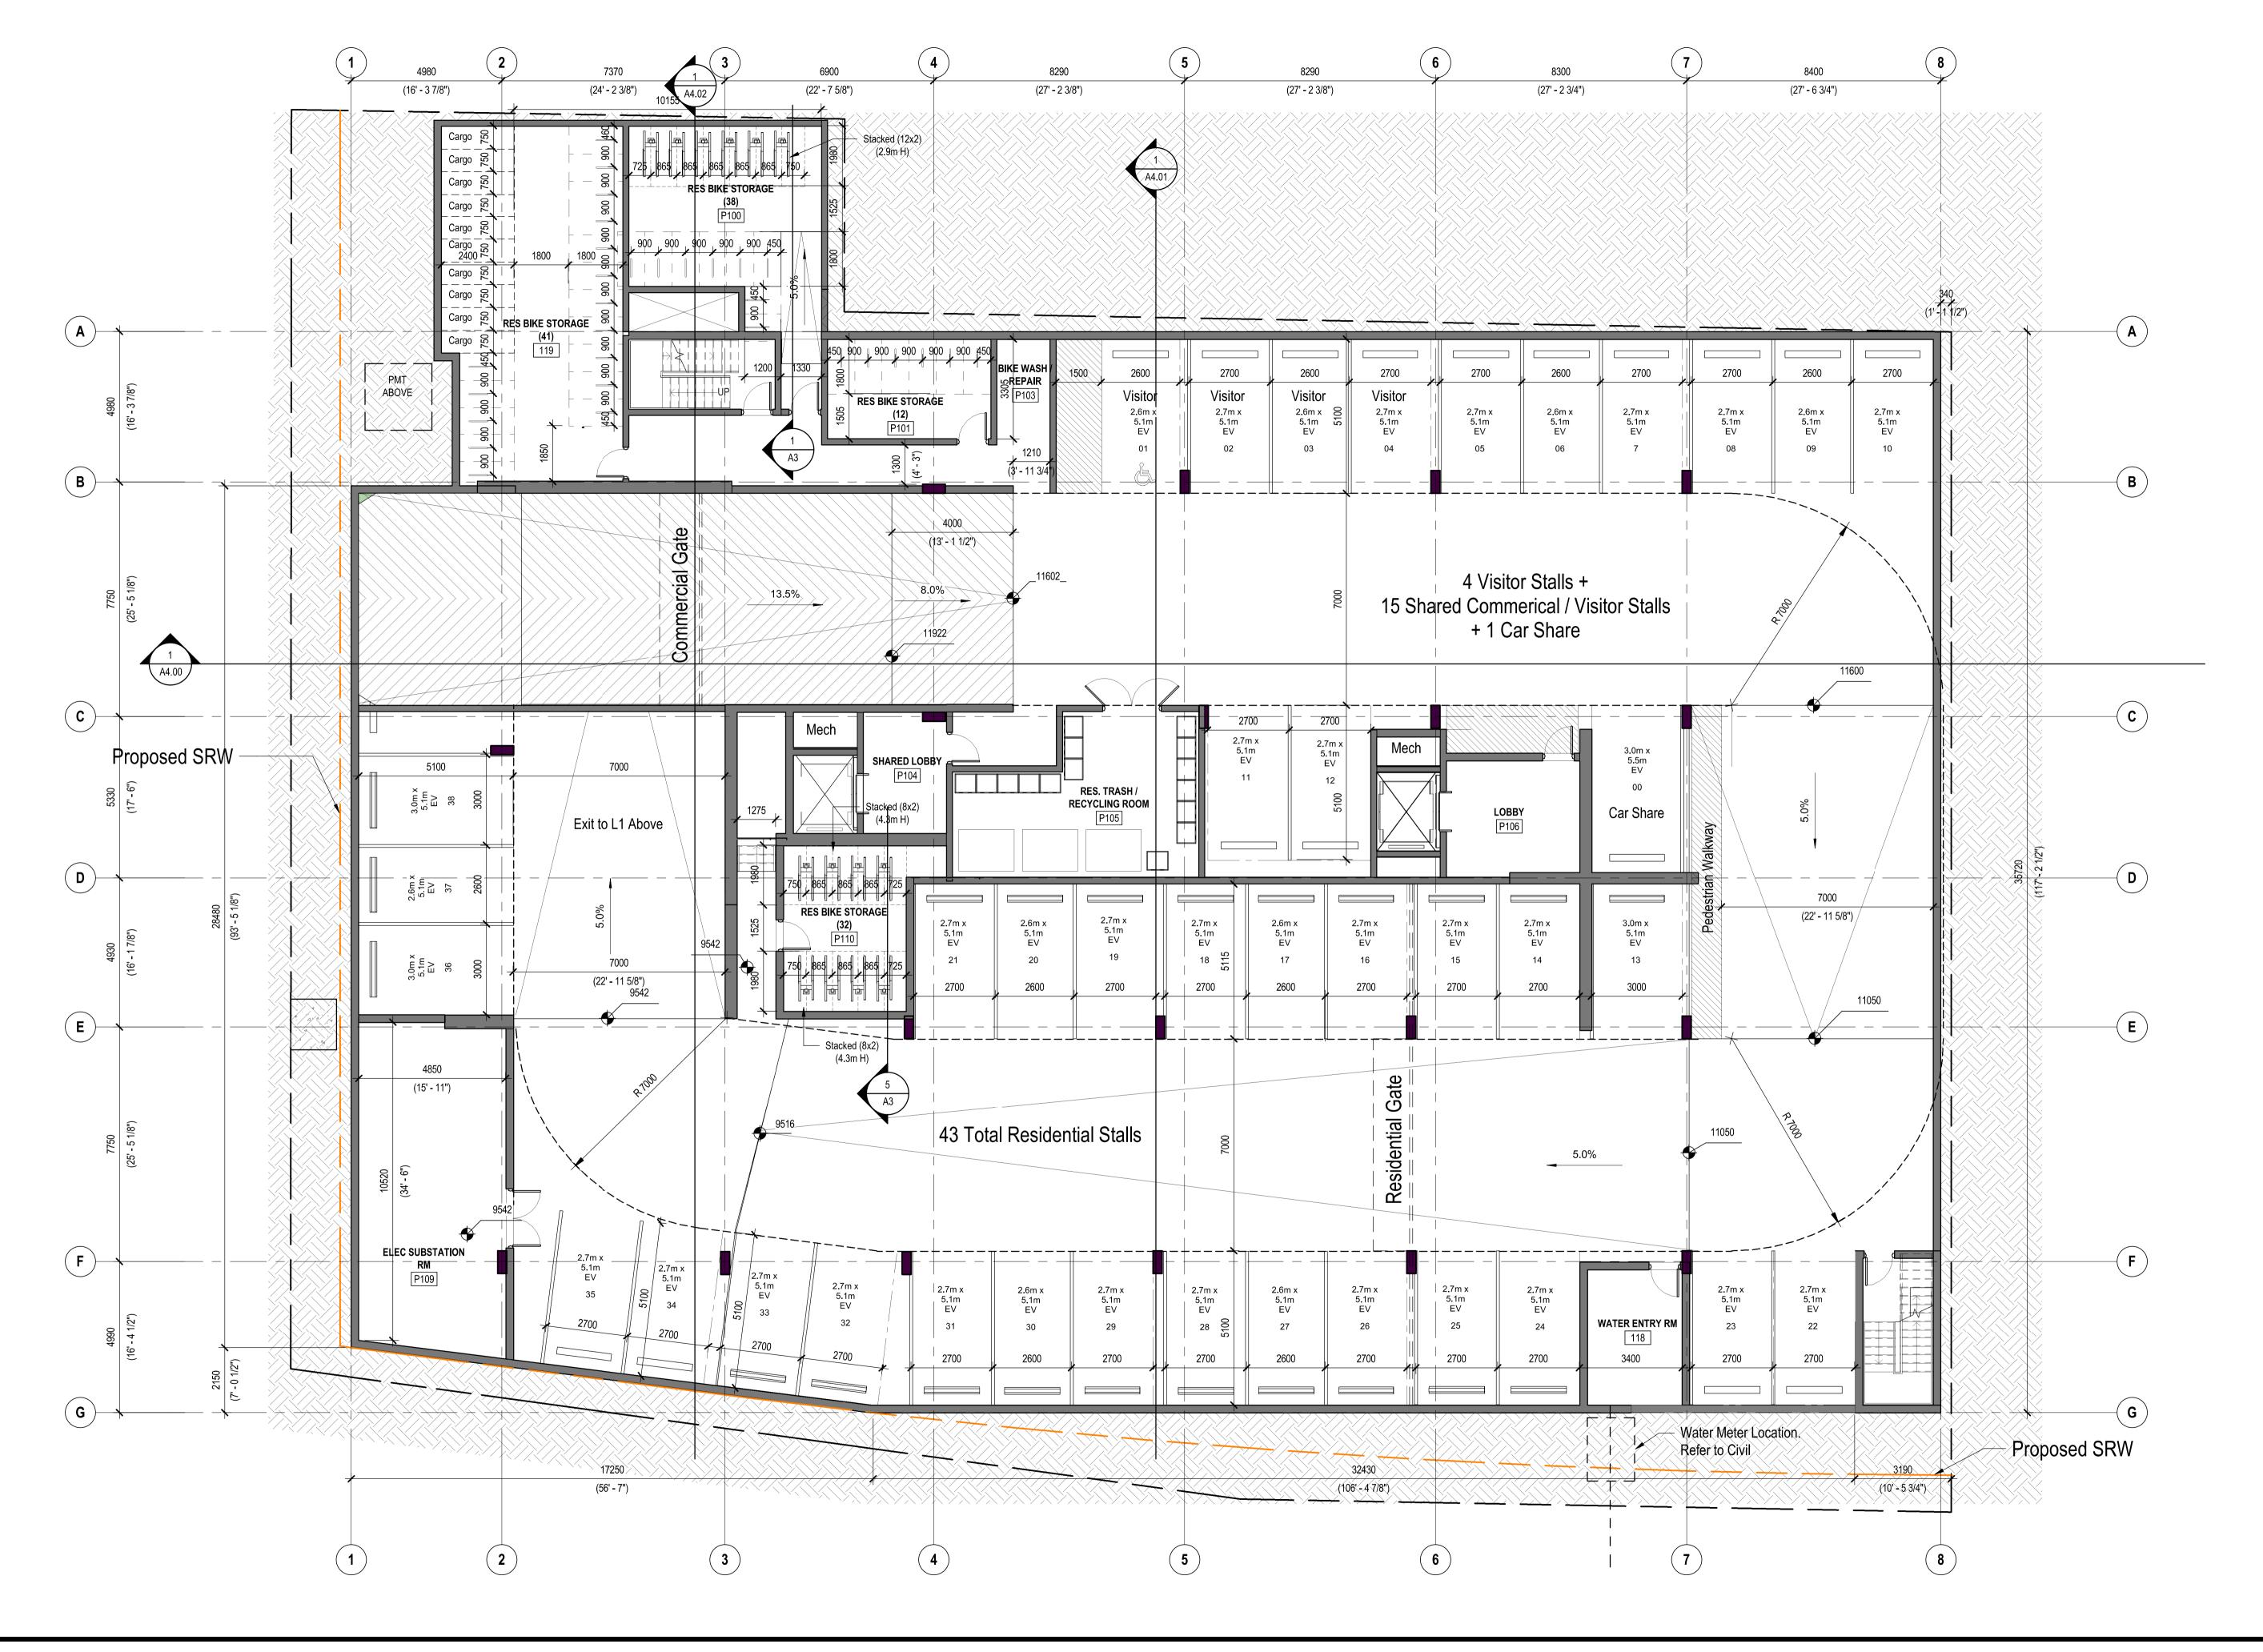



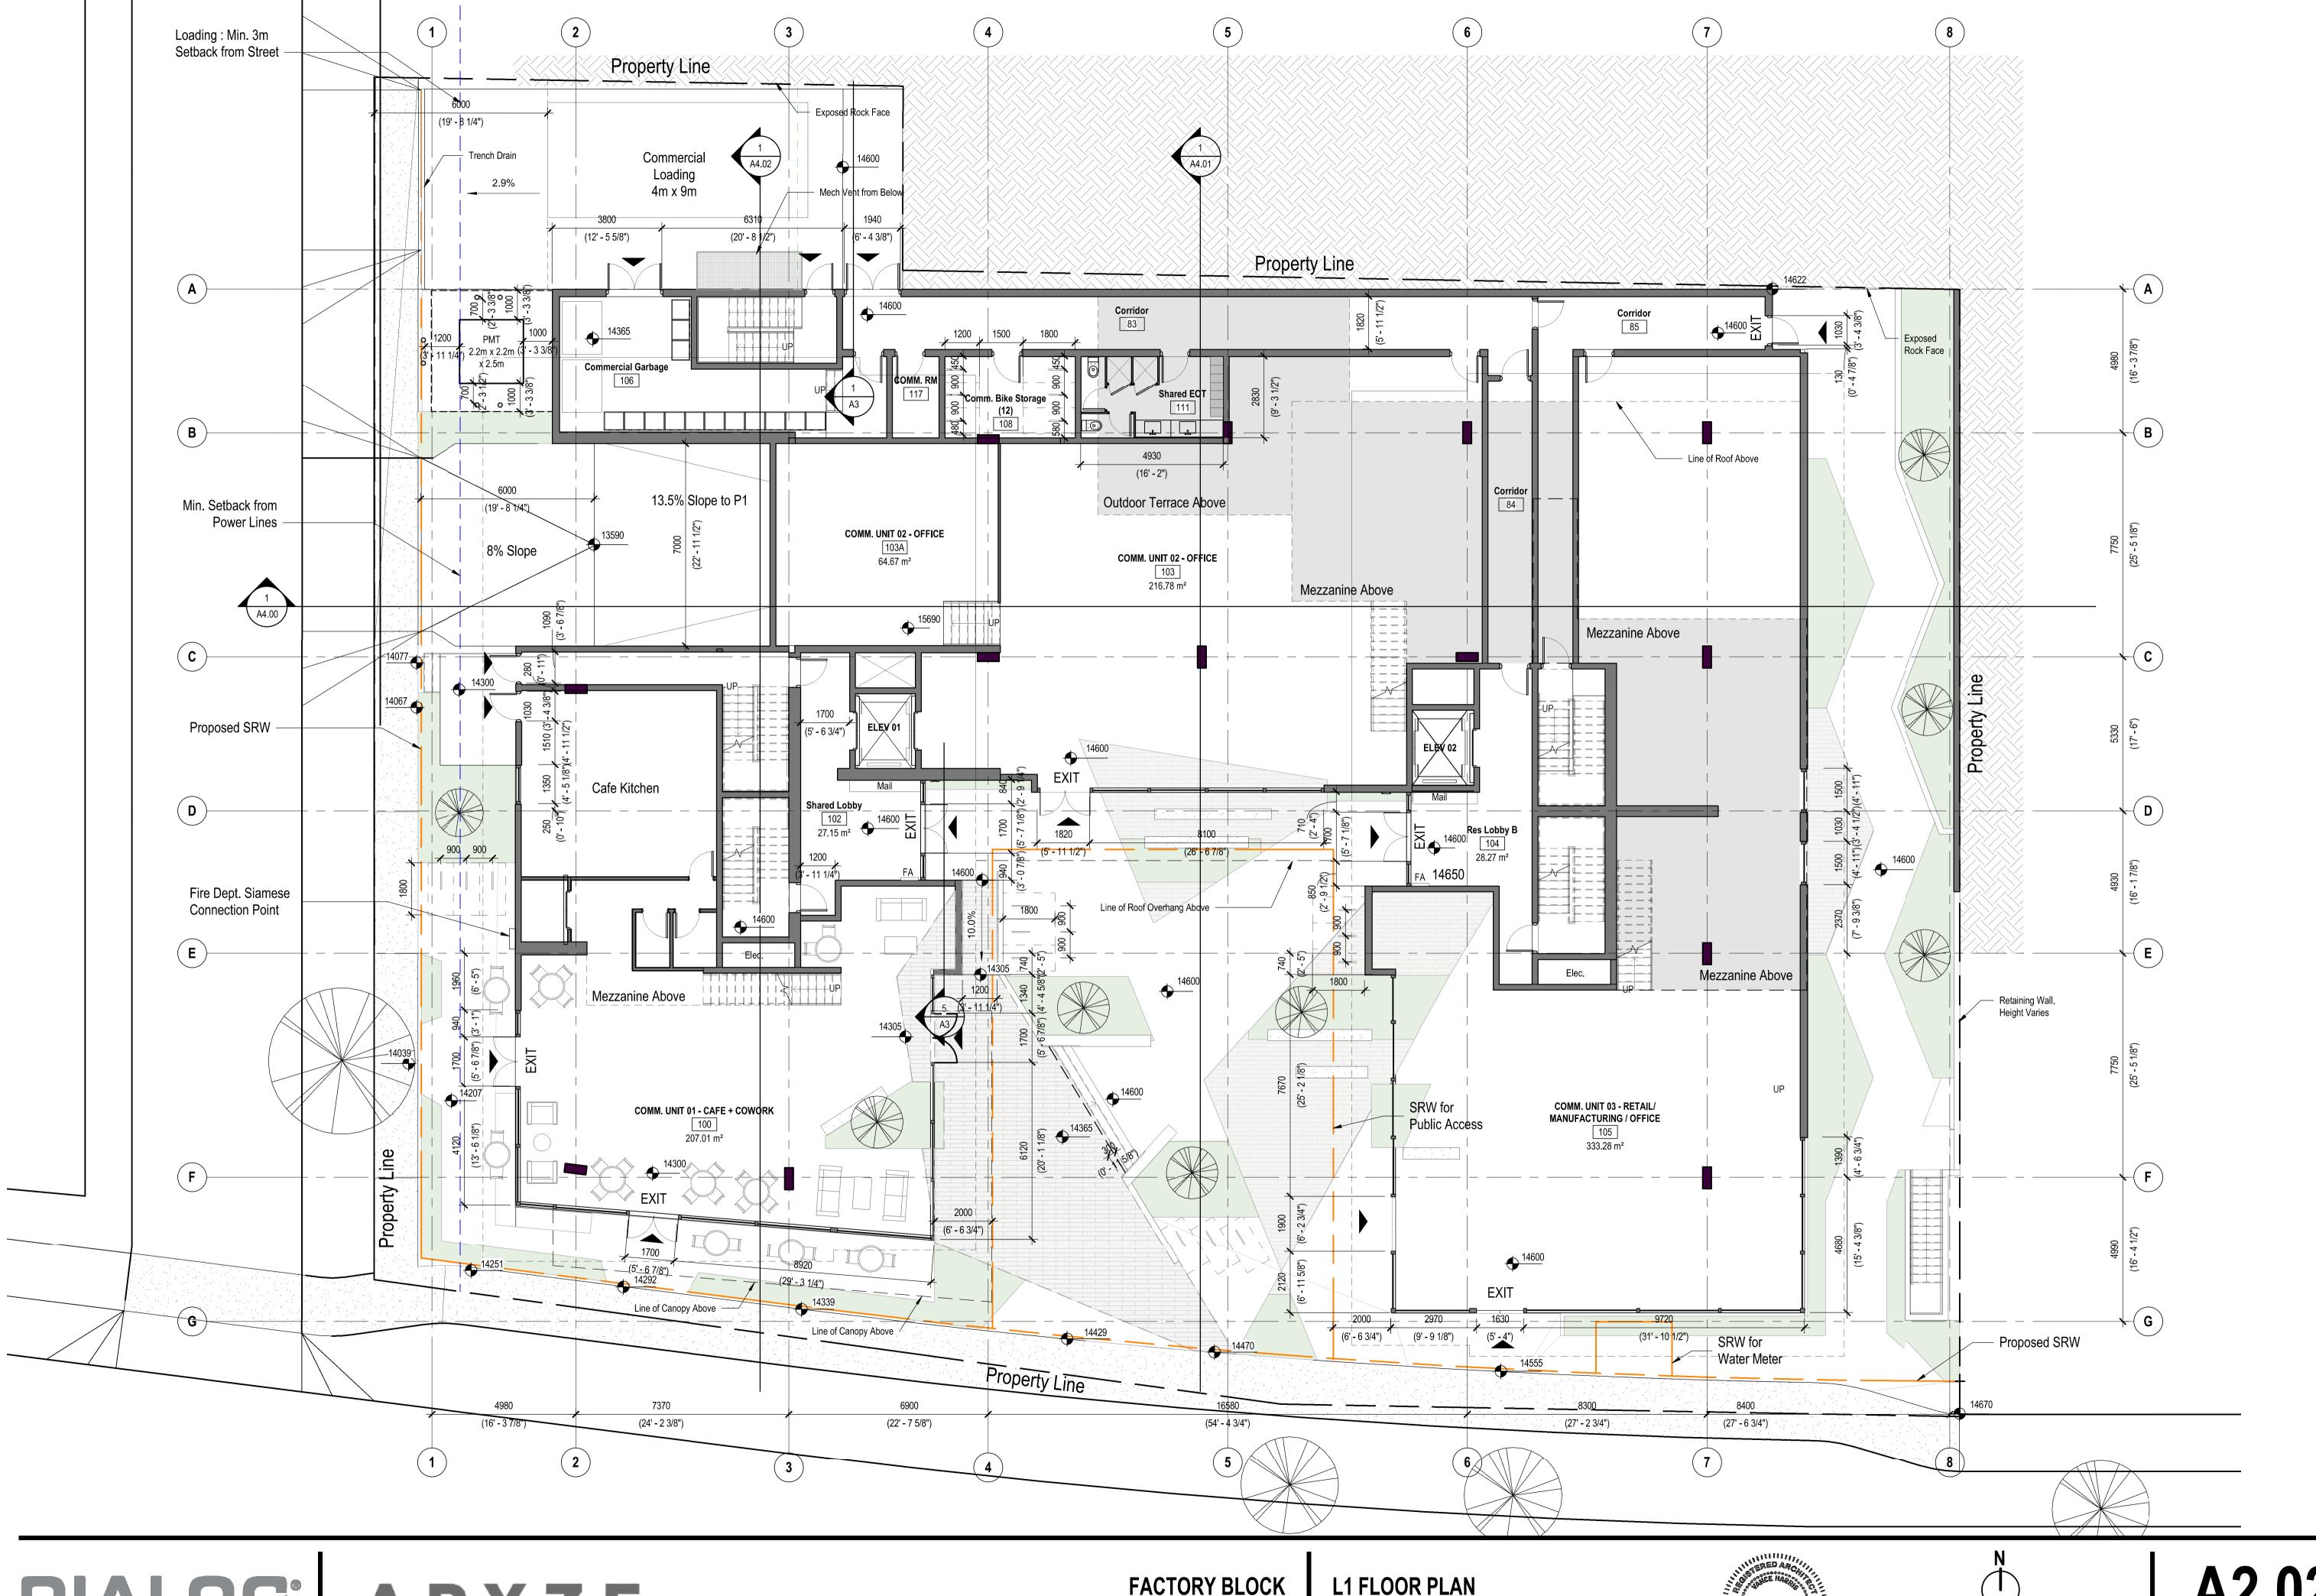


DIALOG° ARYZE


**FACTORY BLOCK** 480 + 492 ESQUIMALT RD

L1 FLOOR PLAN 2003557




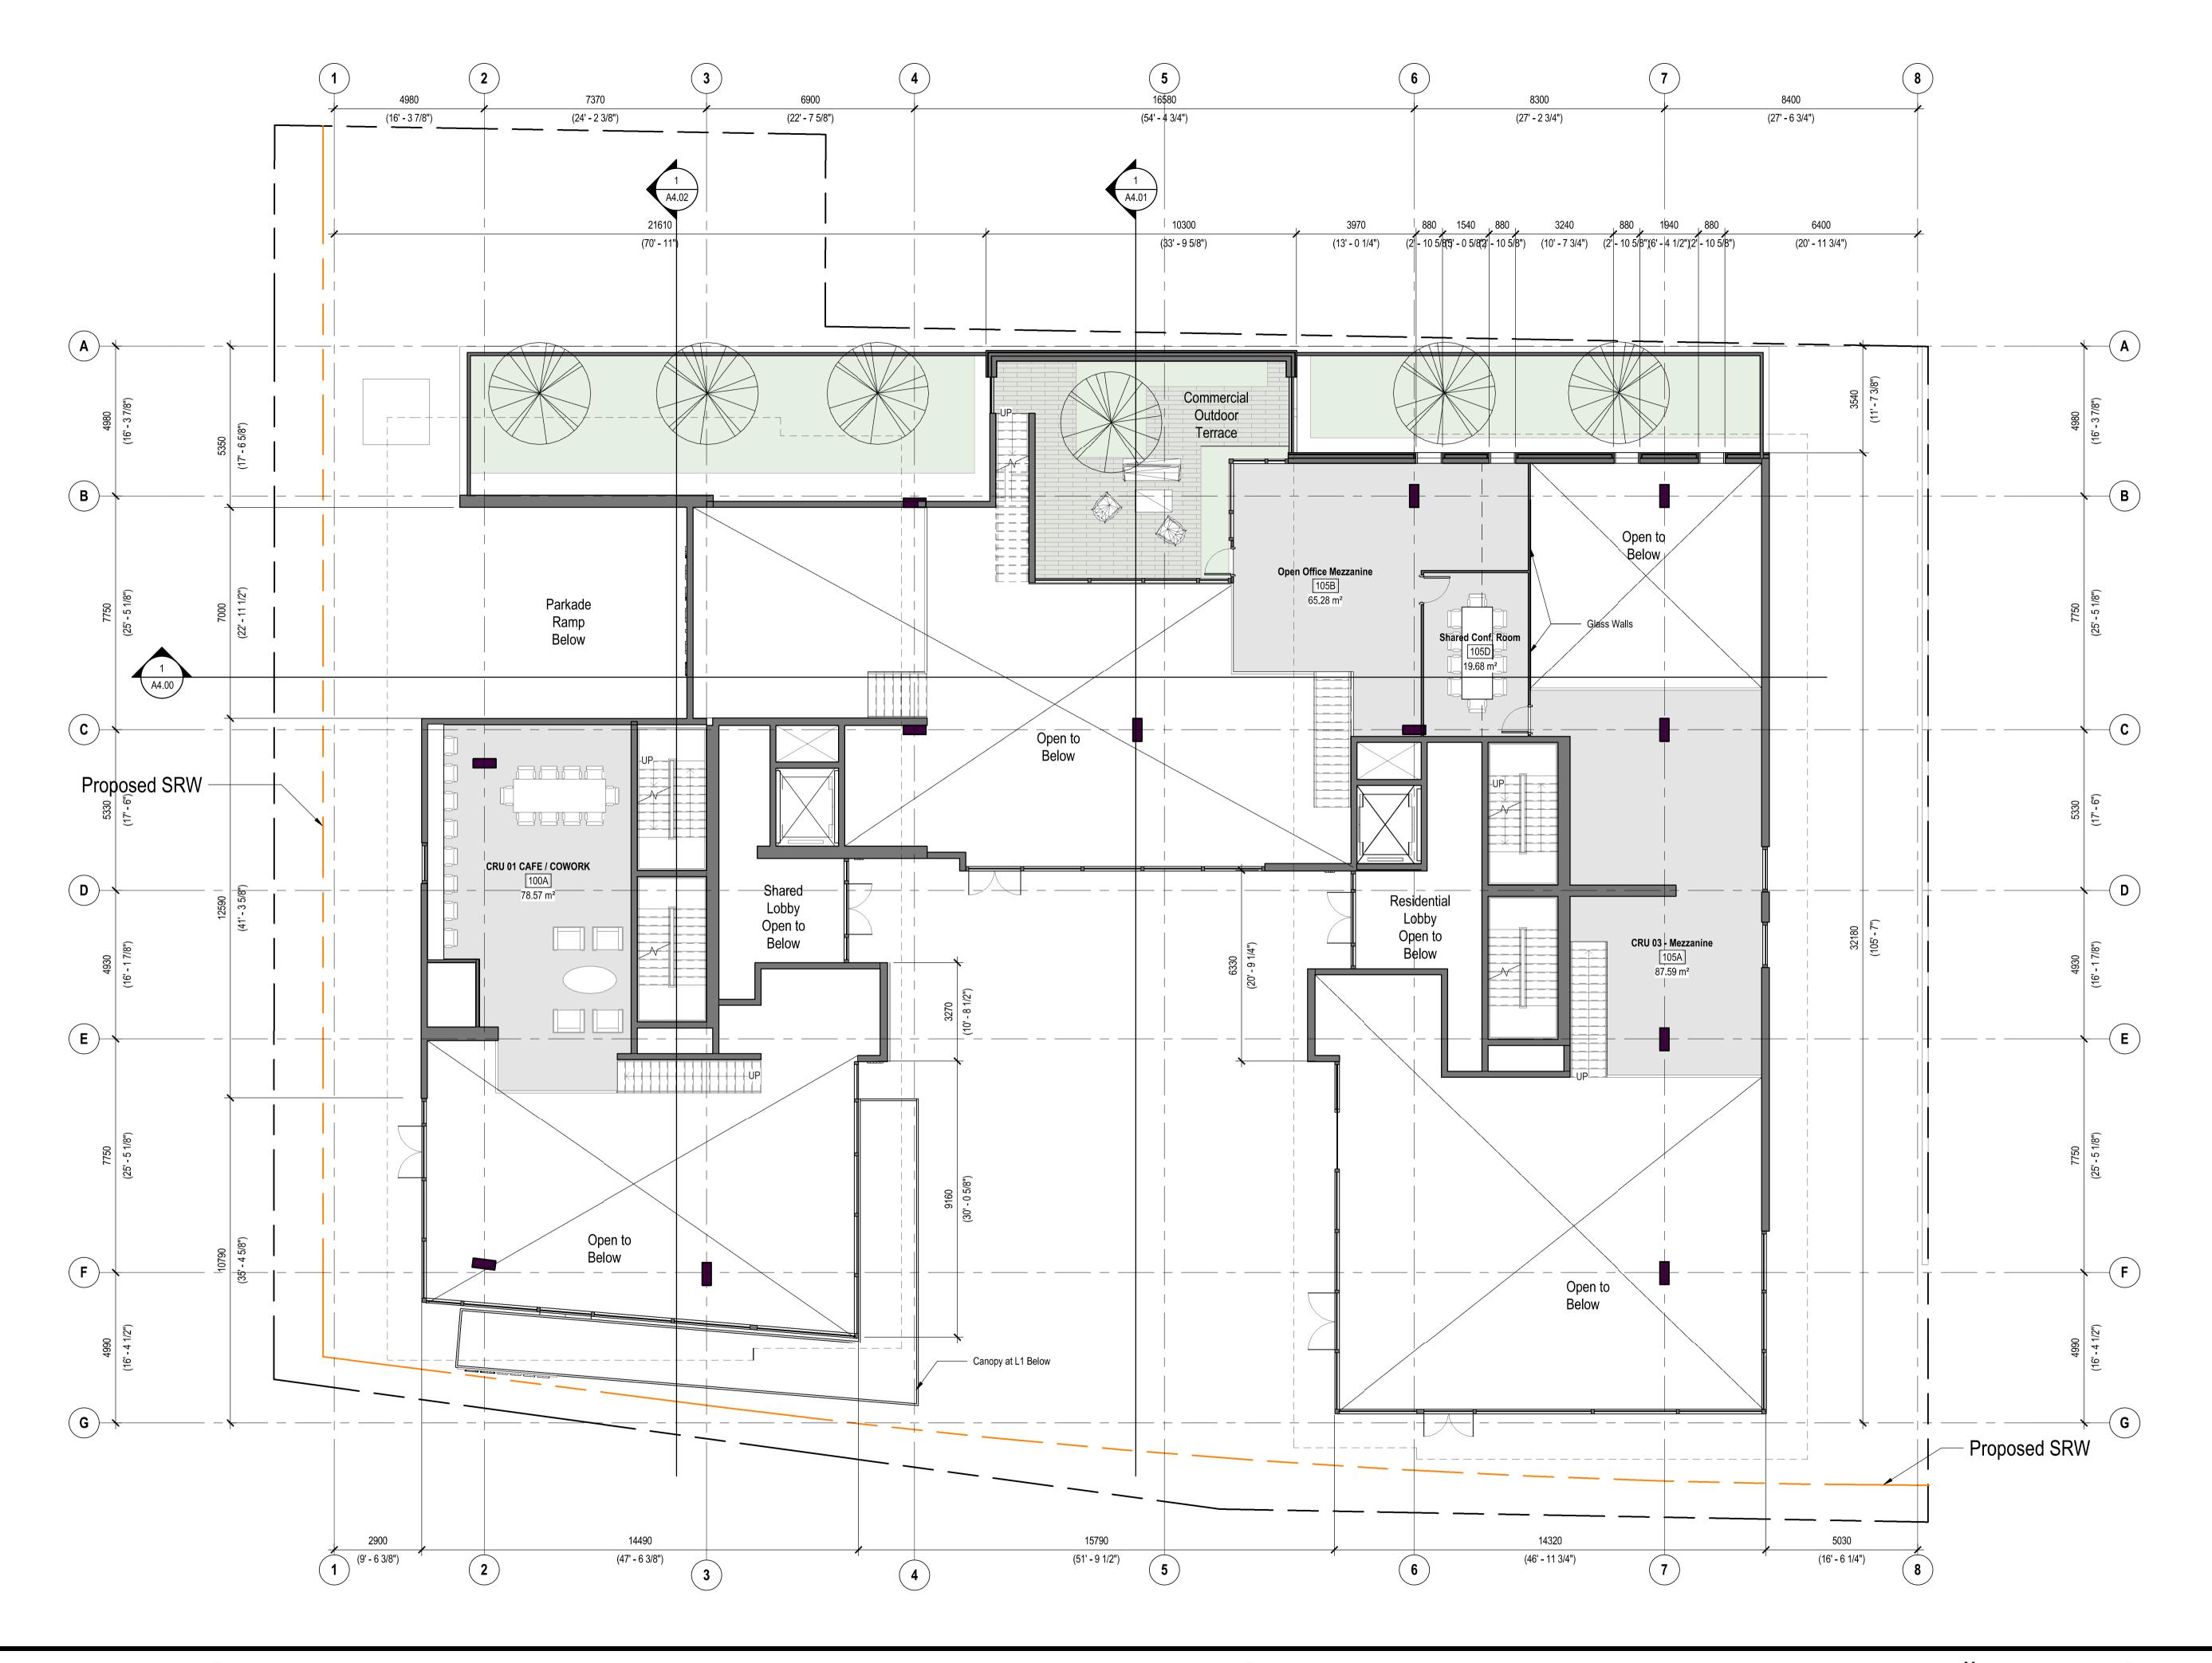




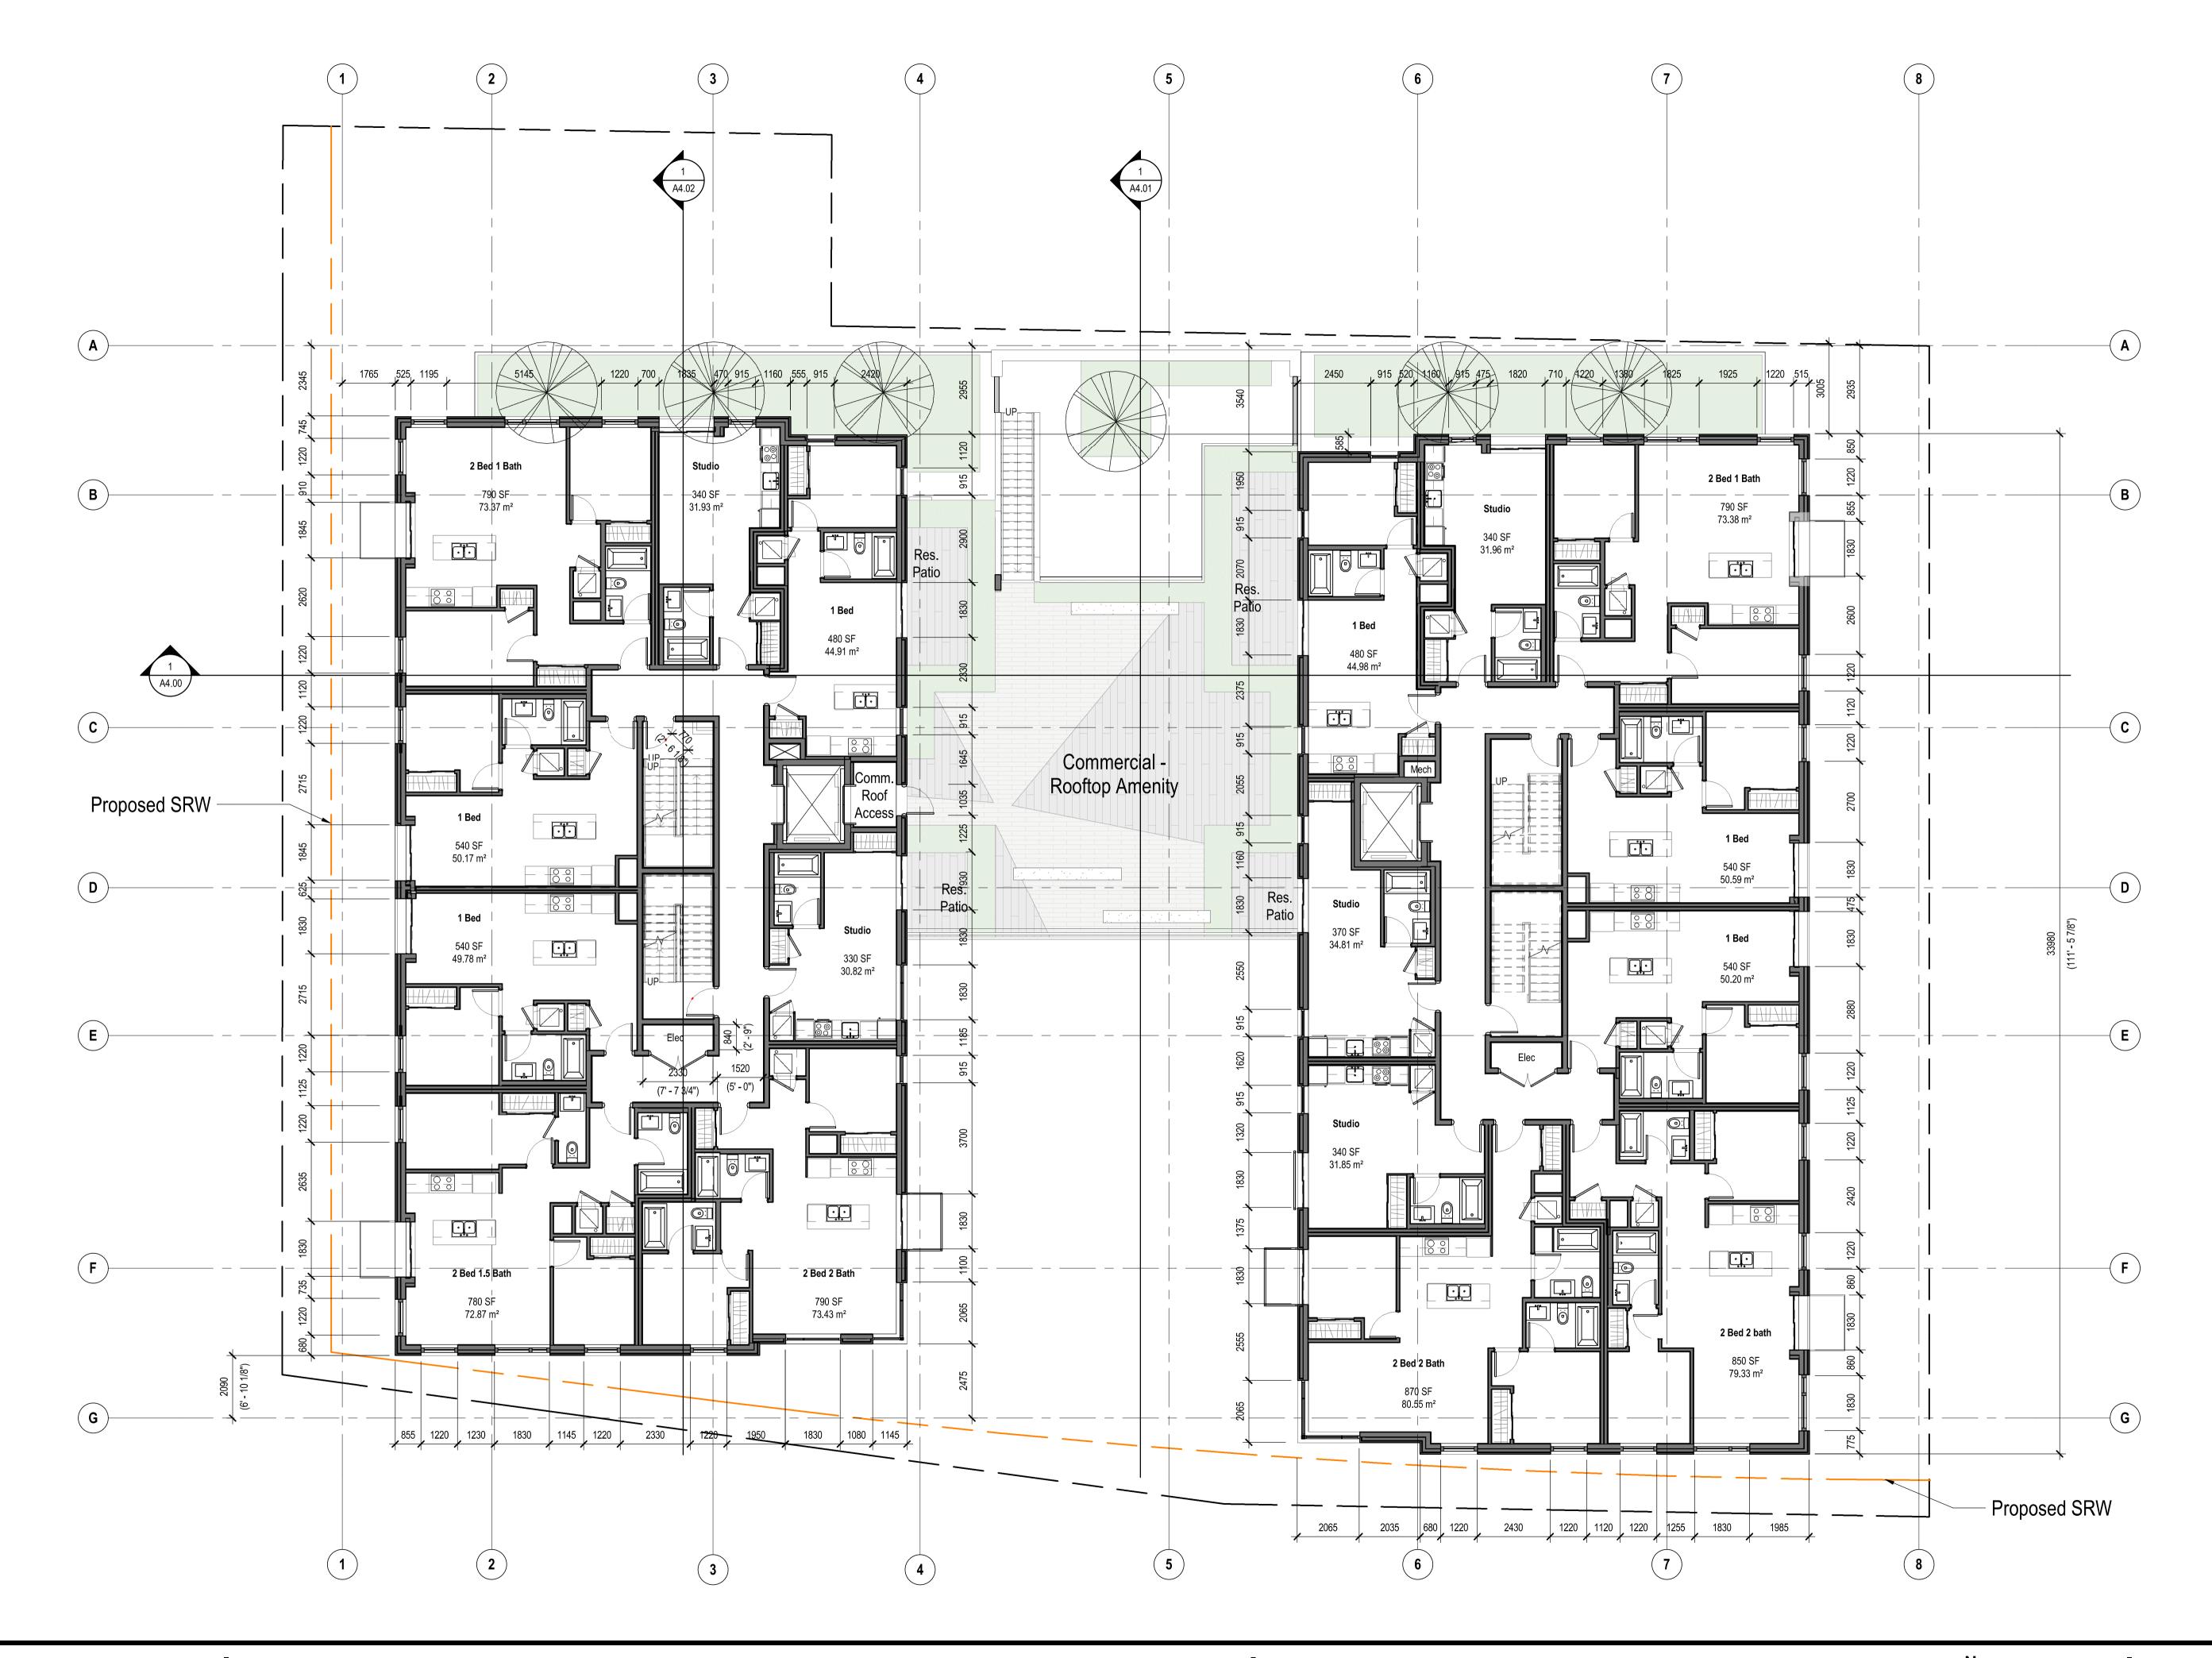



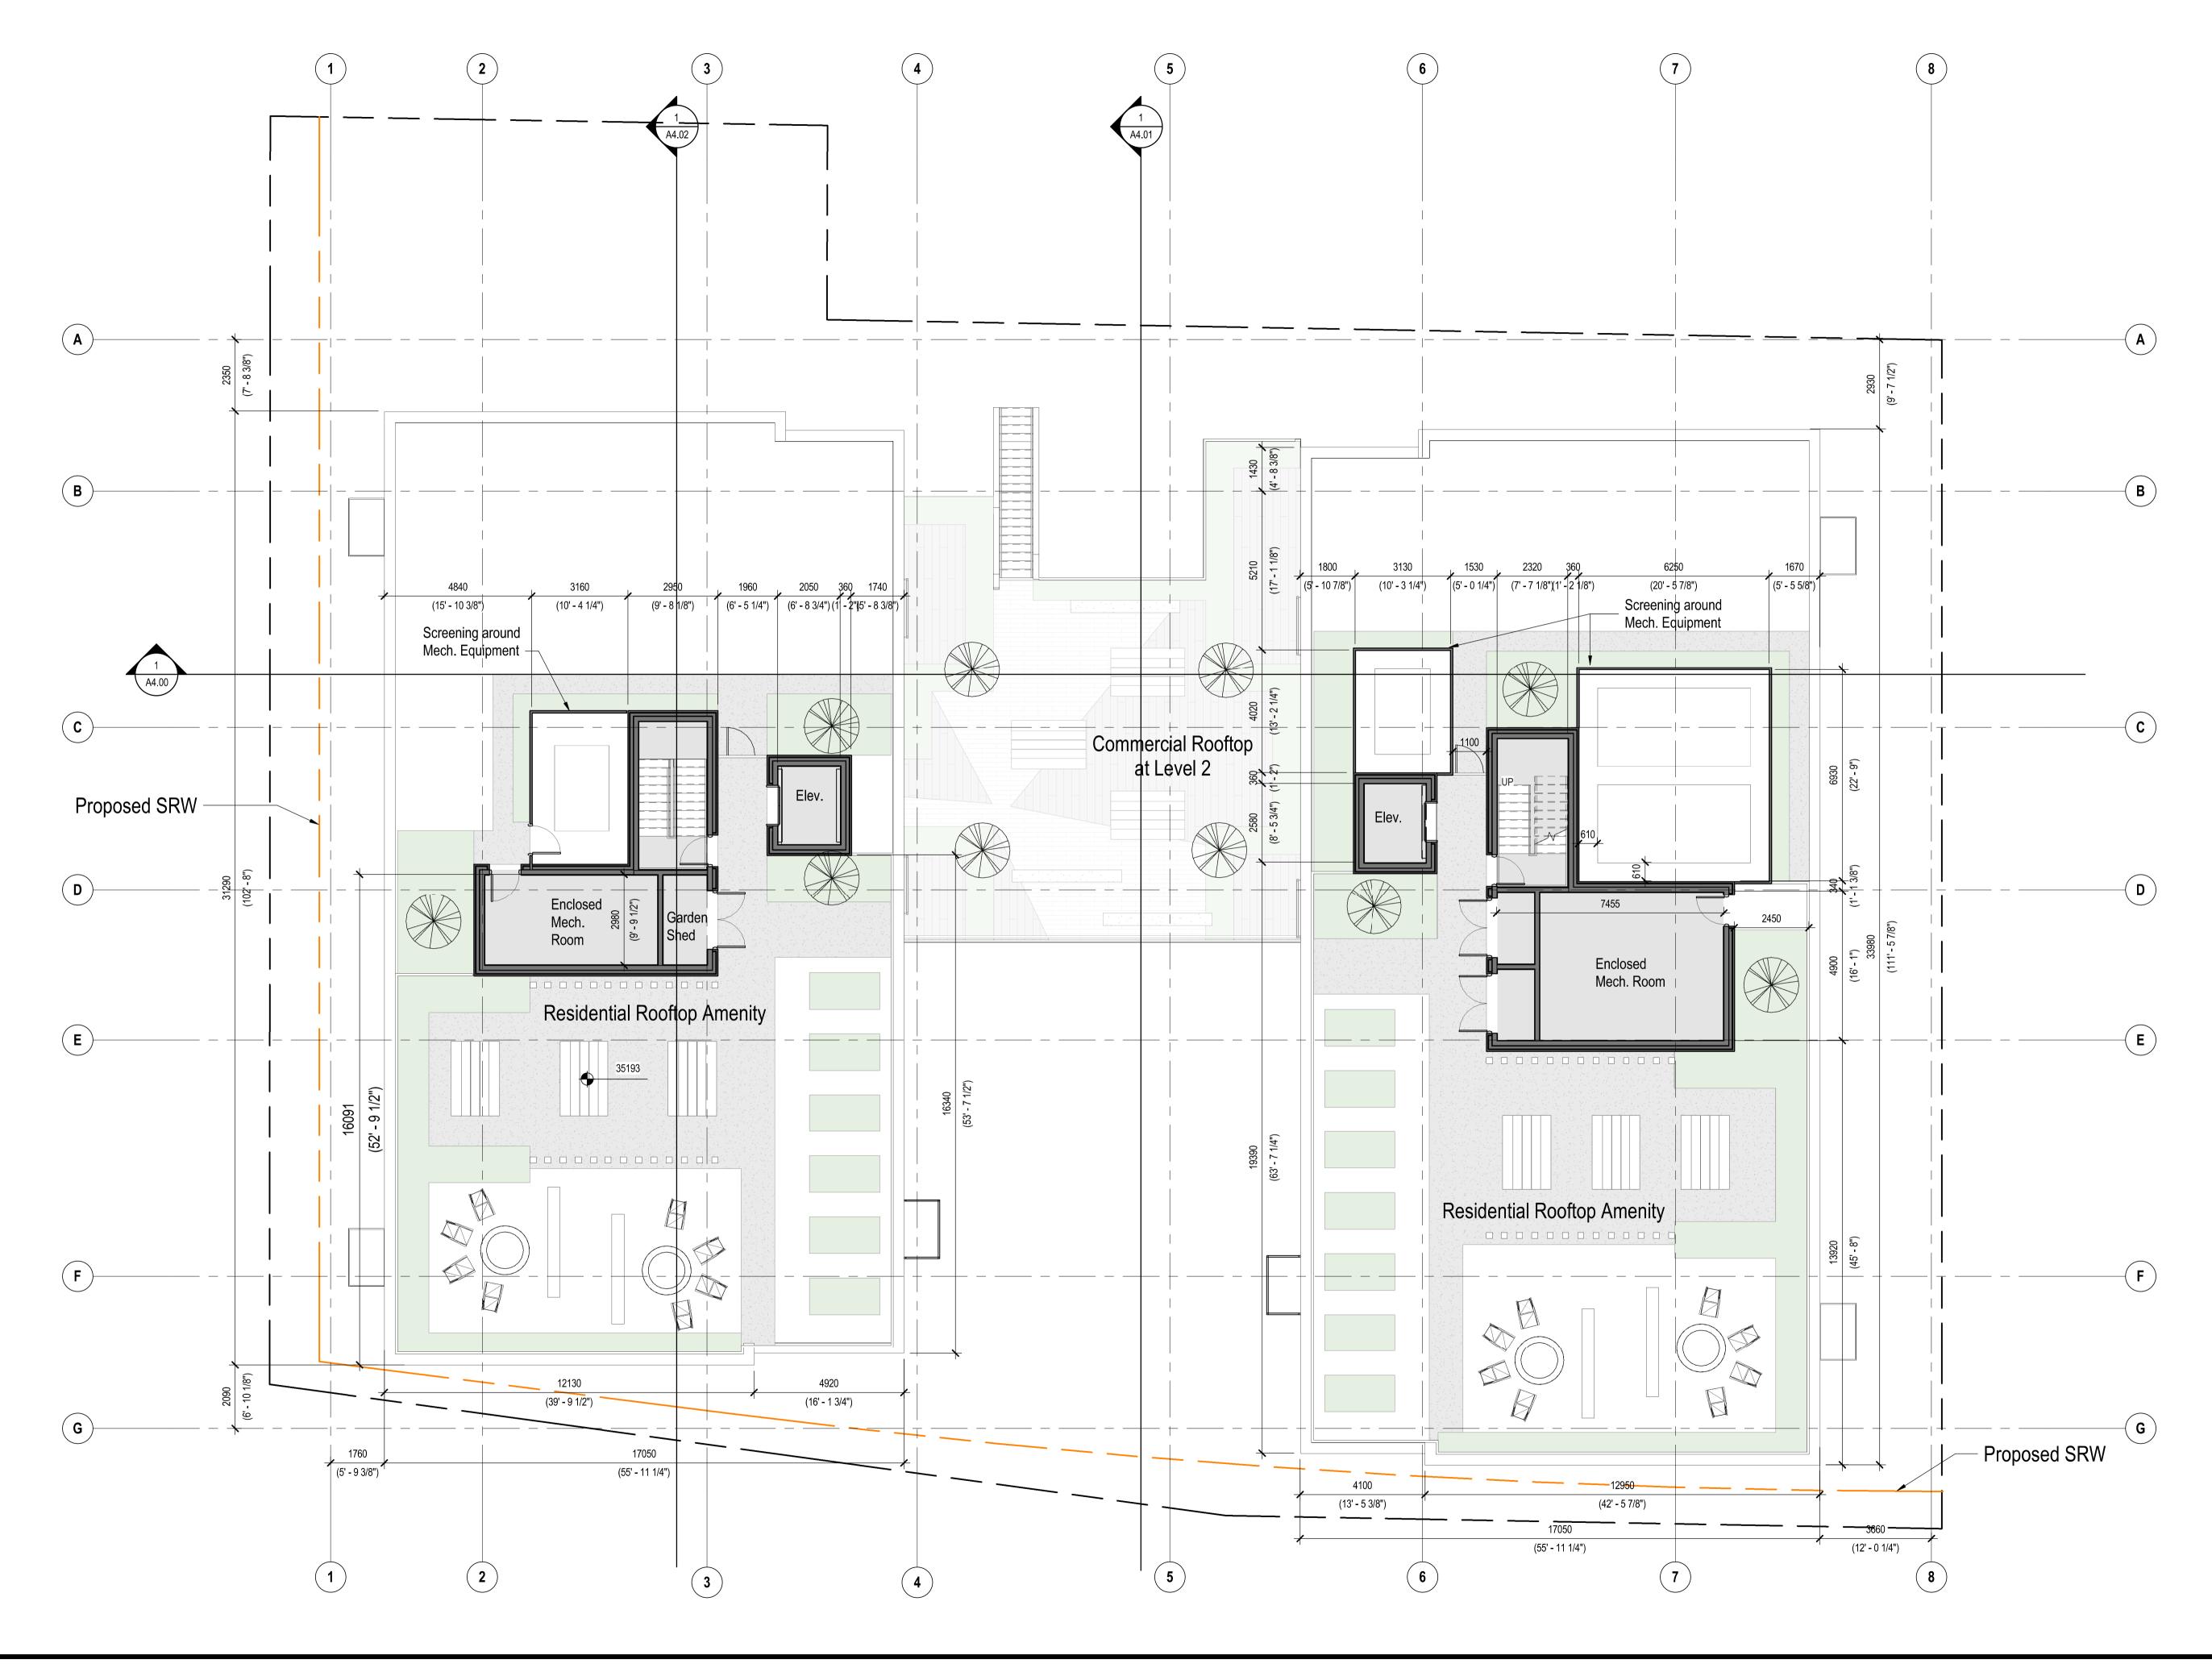




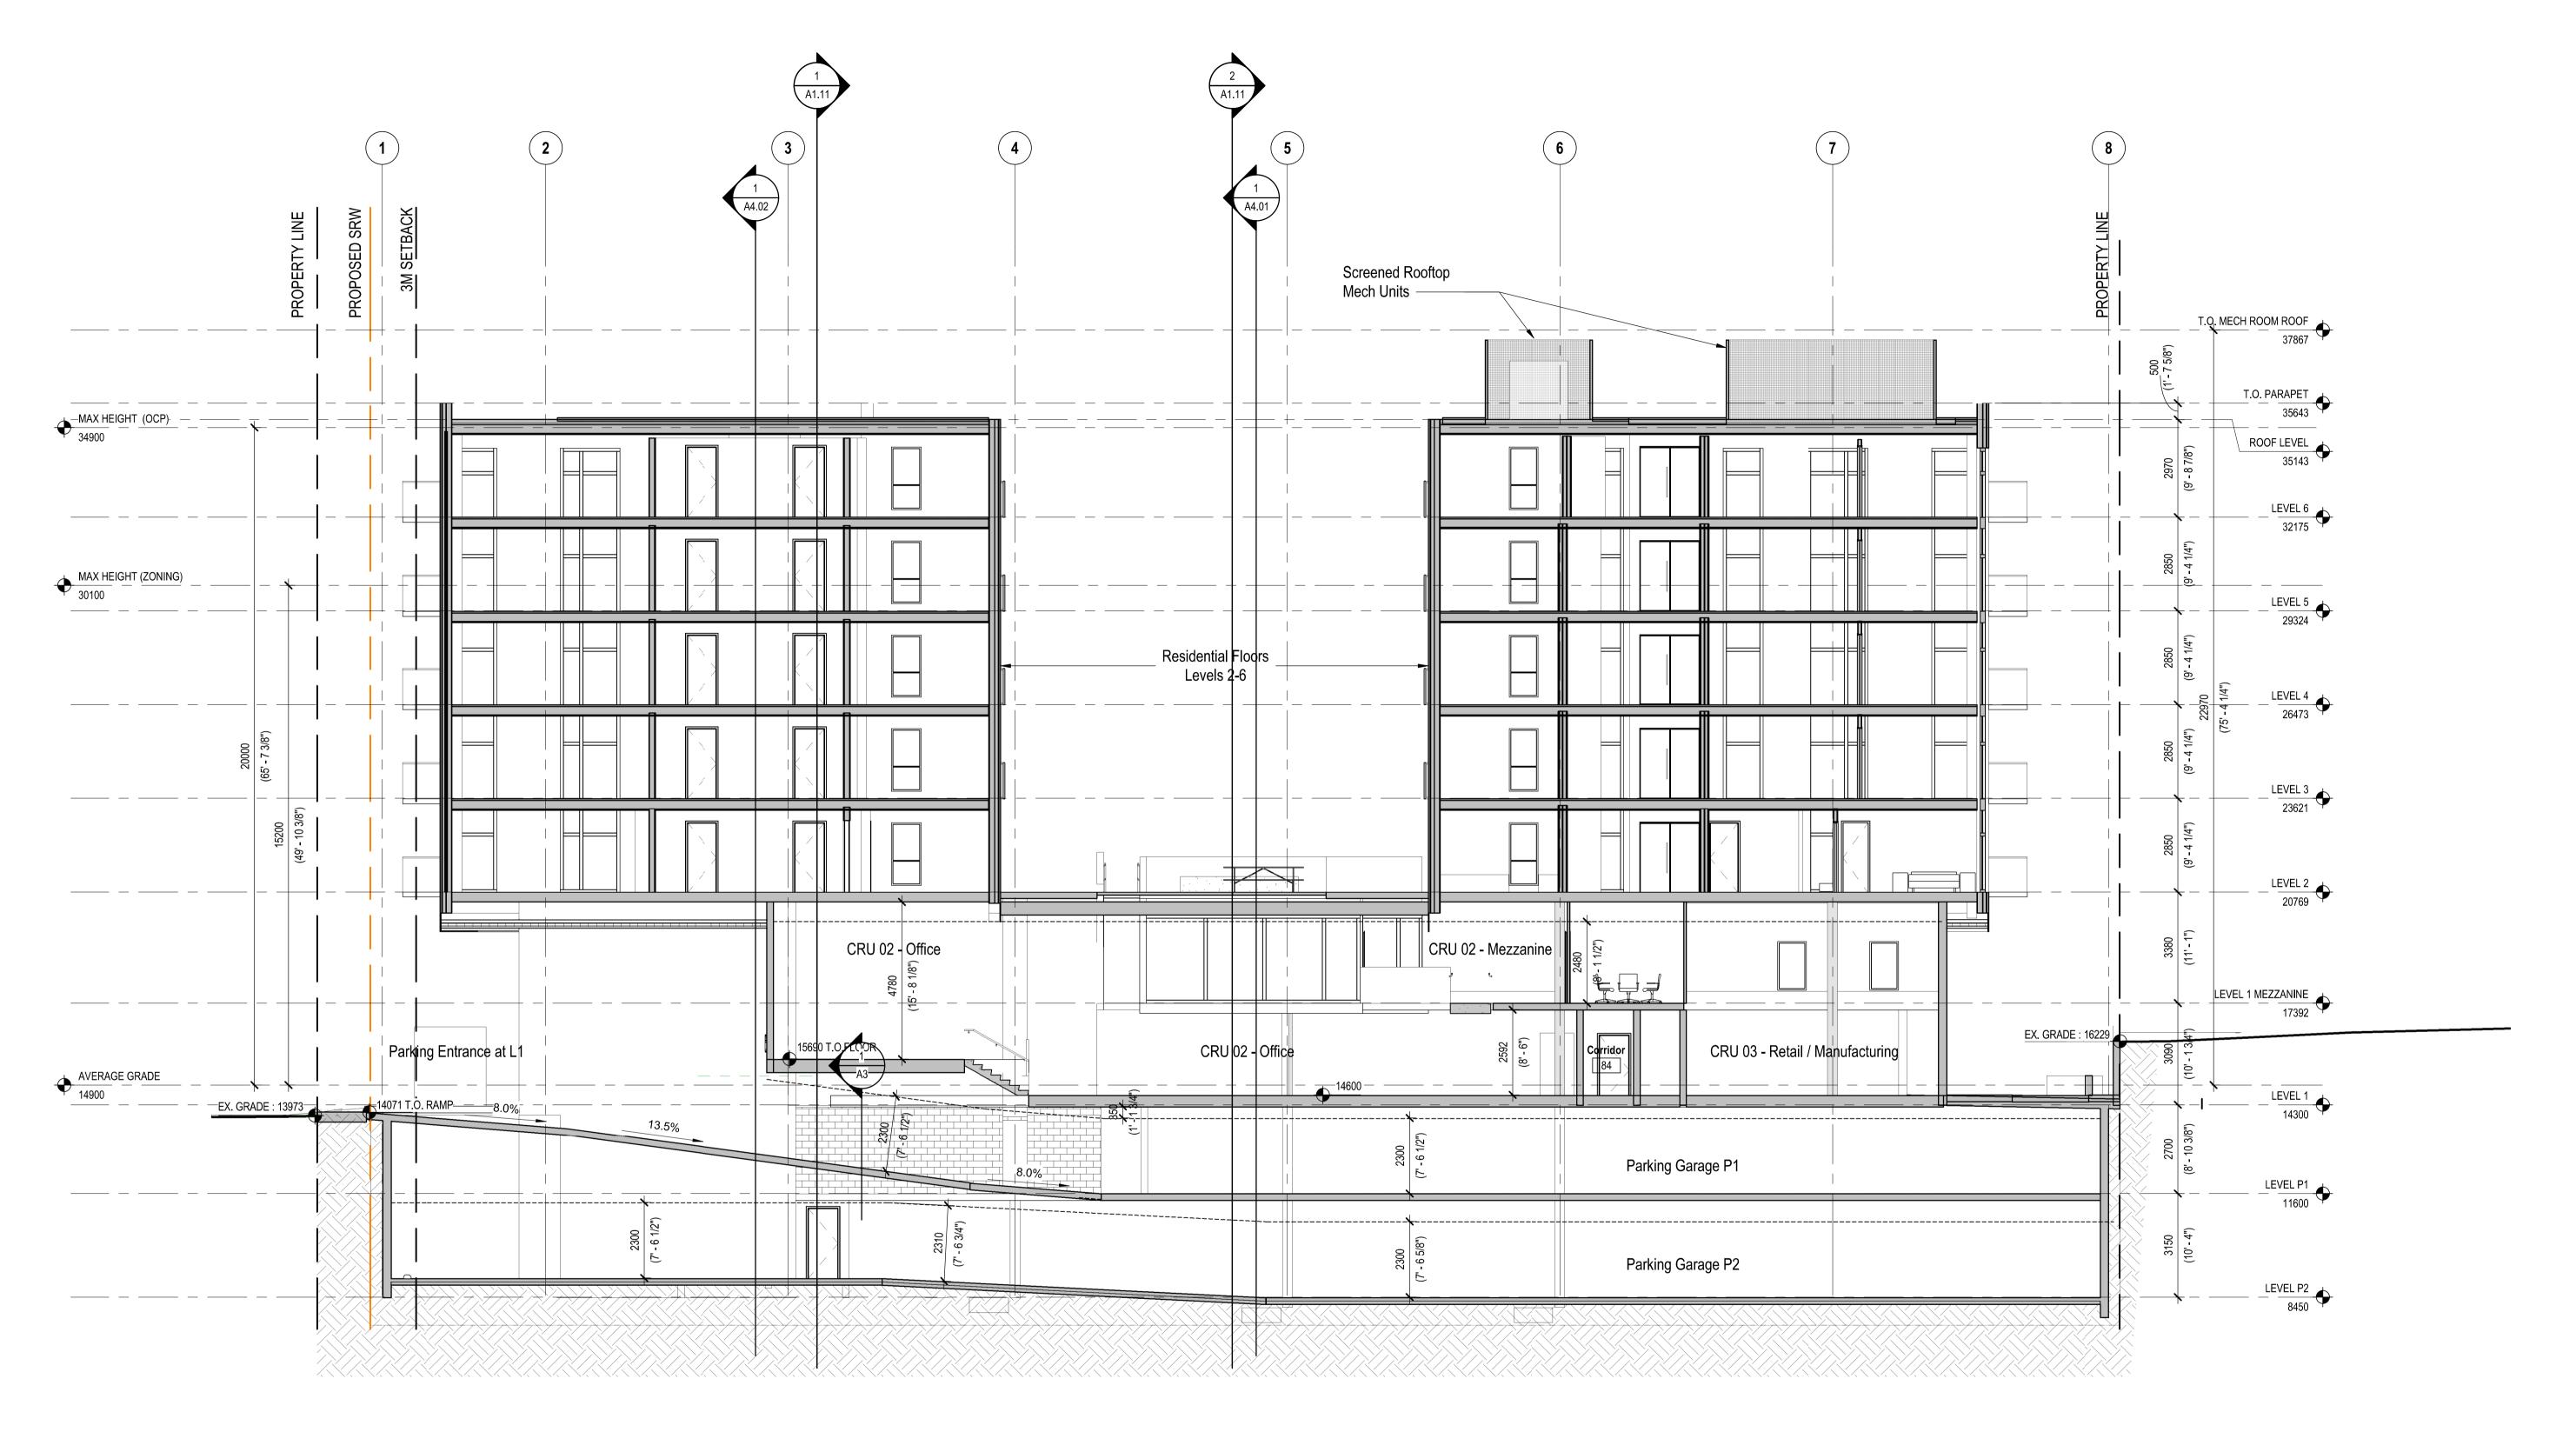


East - West Section 1

SCALE: 1:100

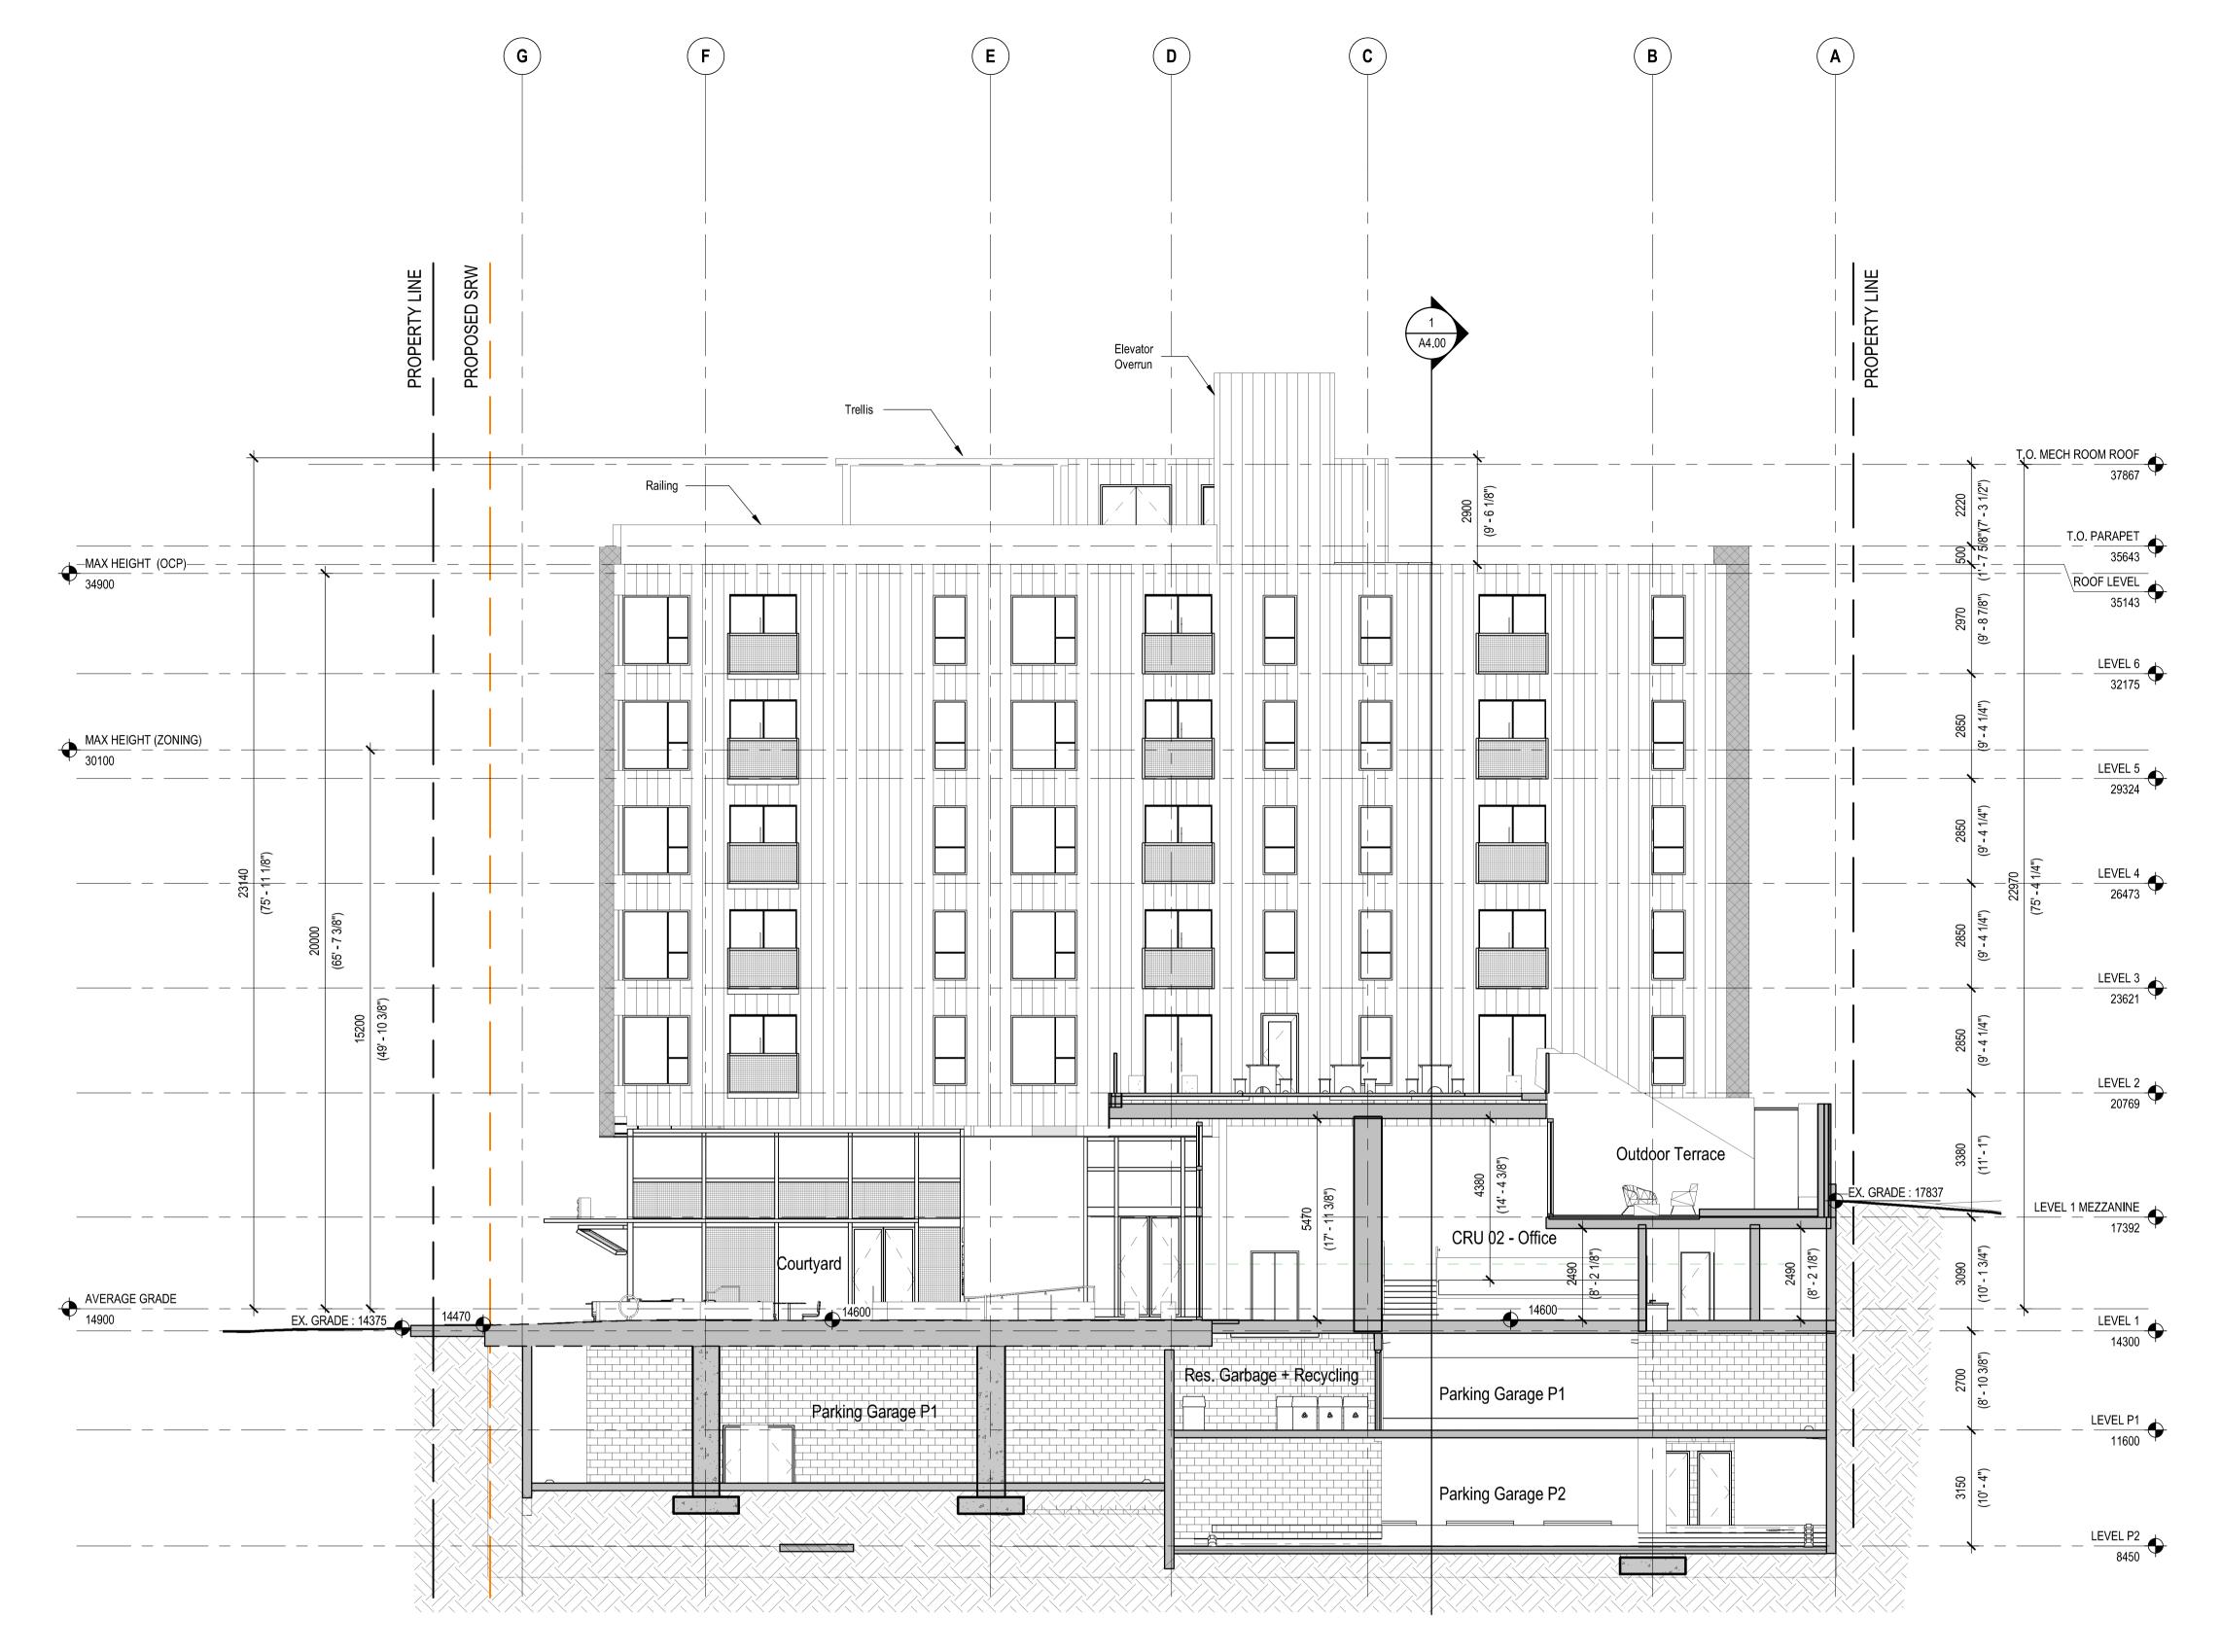

North - South Section 2

SCALE: 1:100

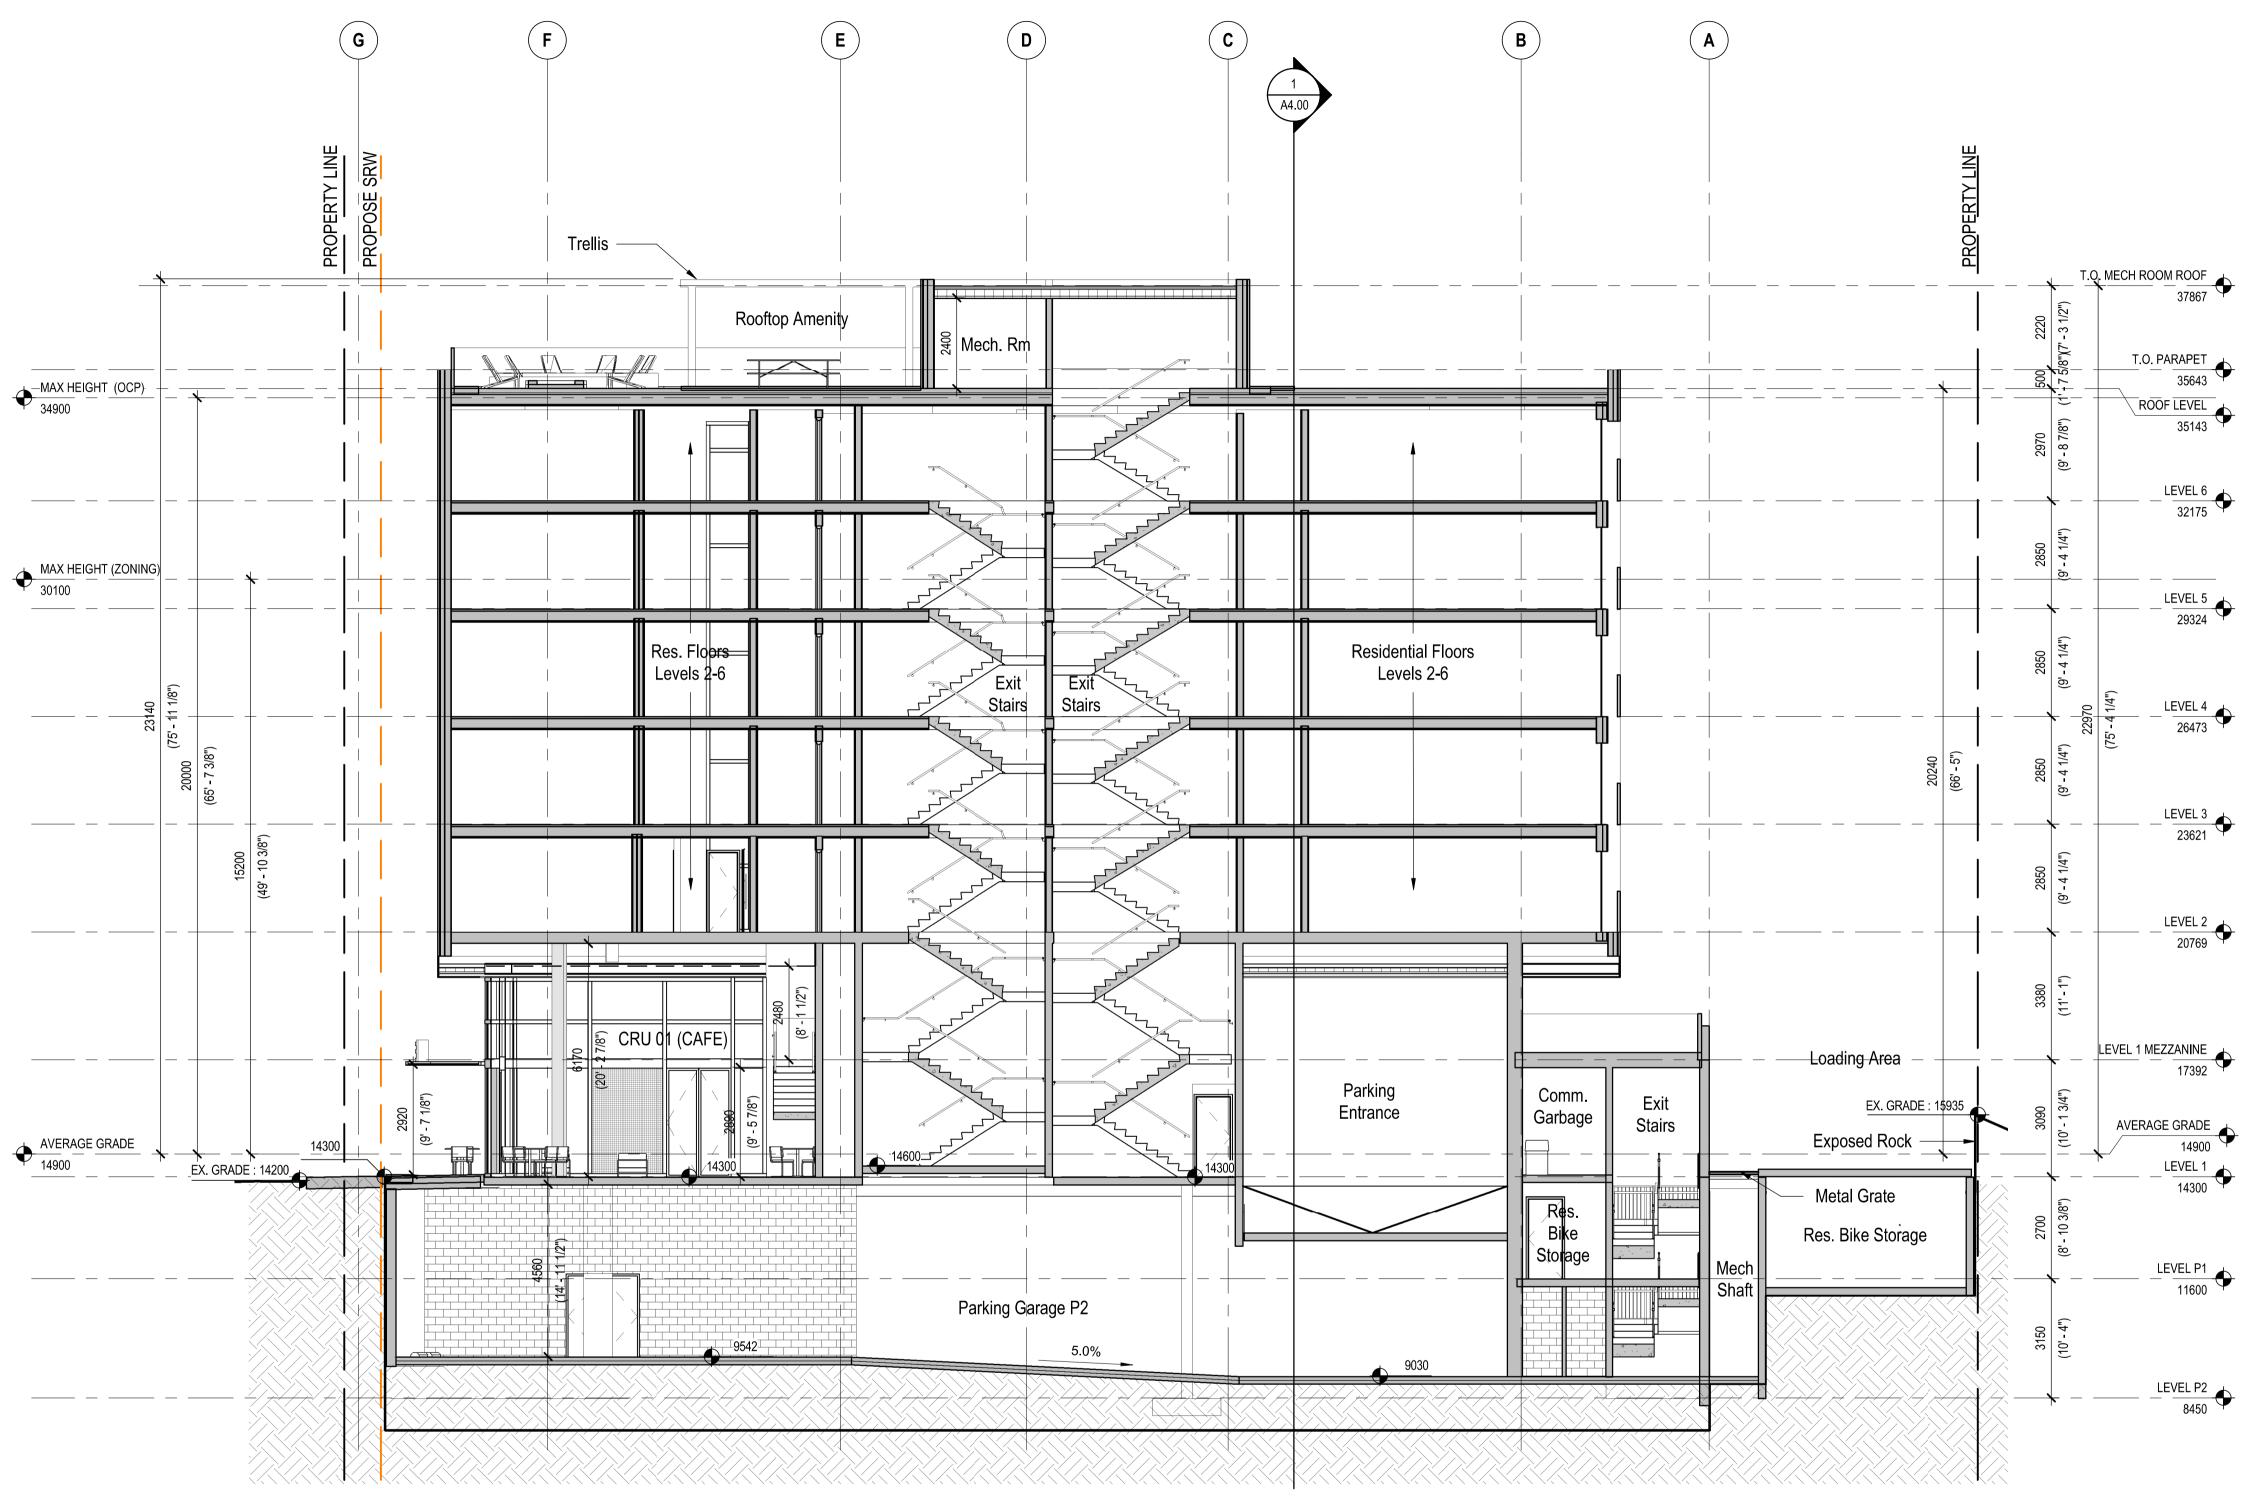


North - South Section 3
SCALE: 1:100









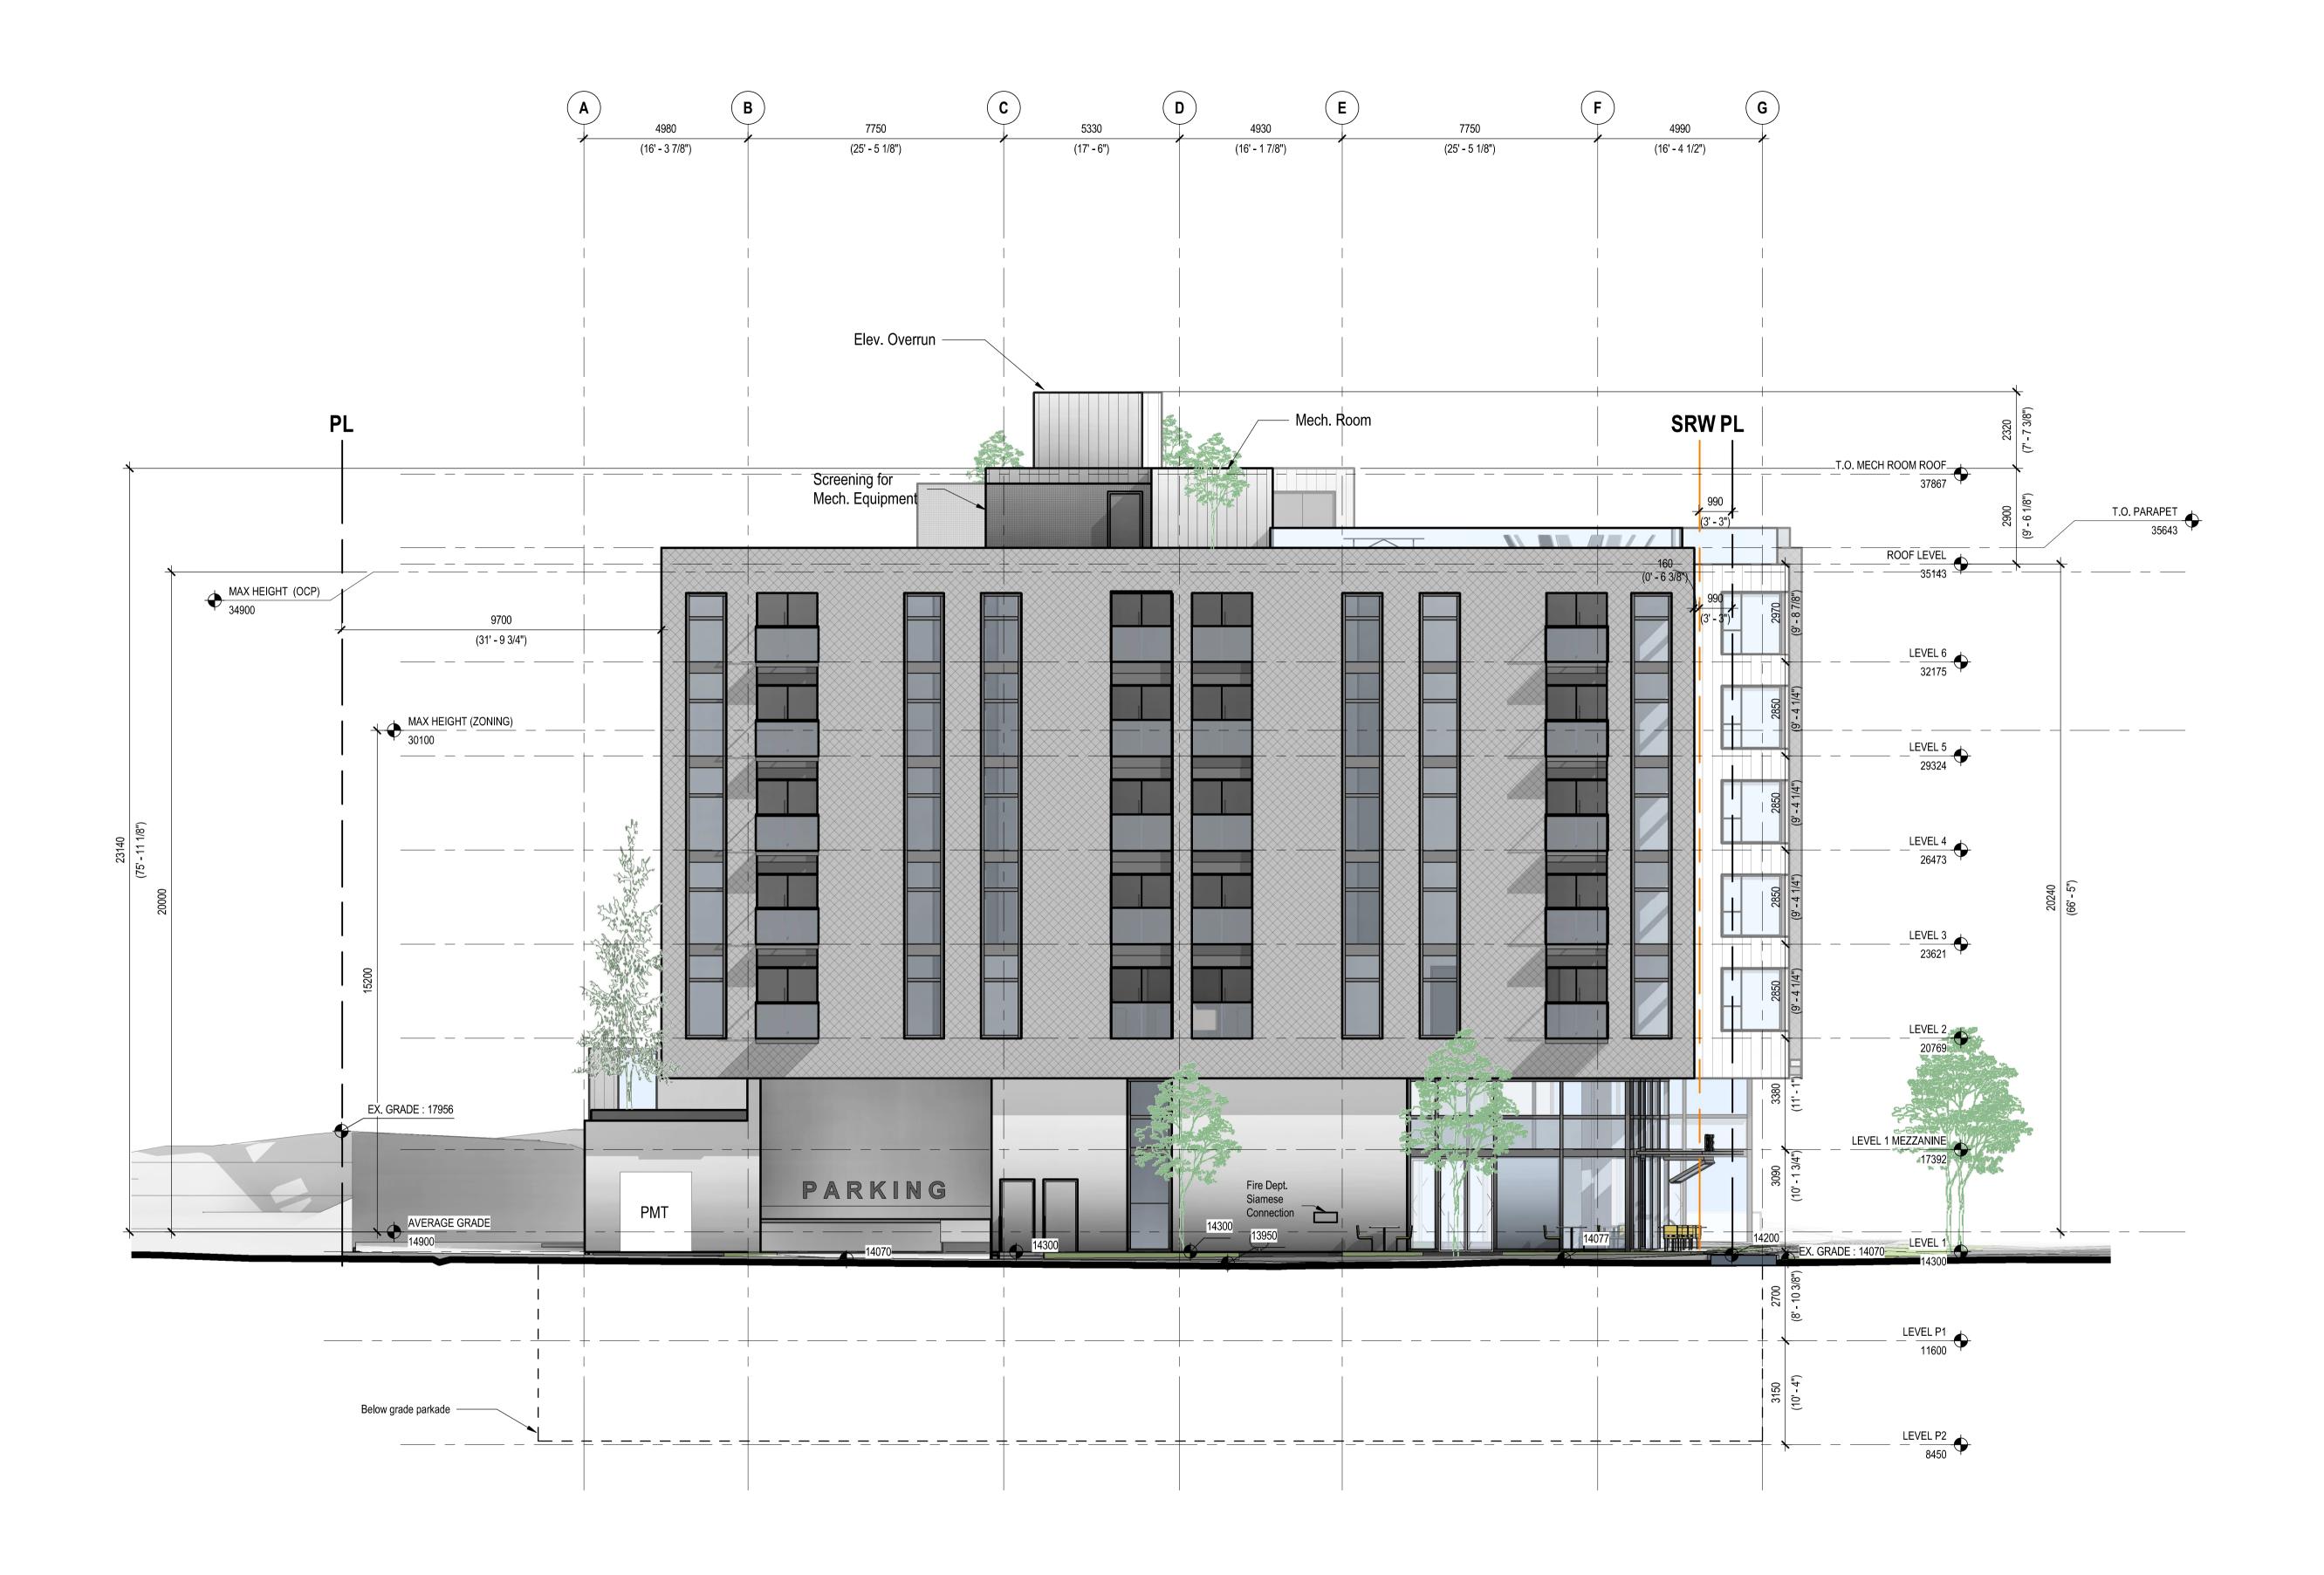









1:100

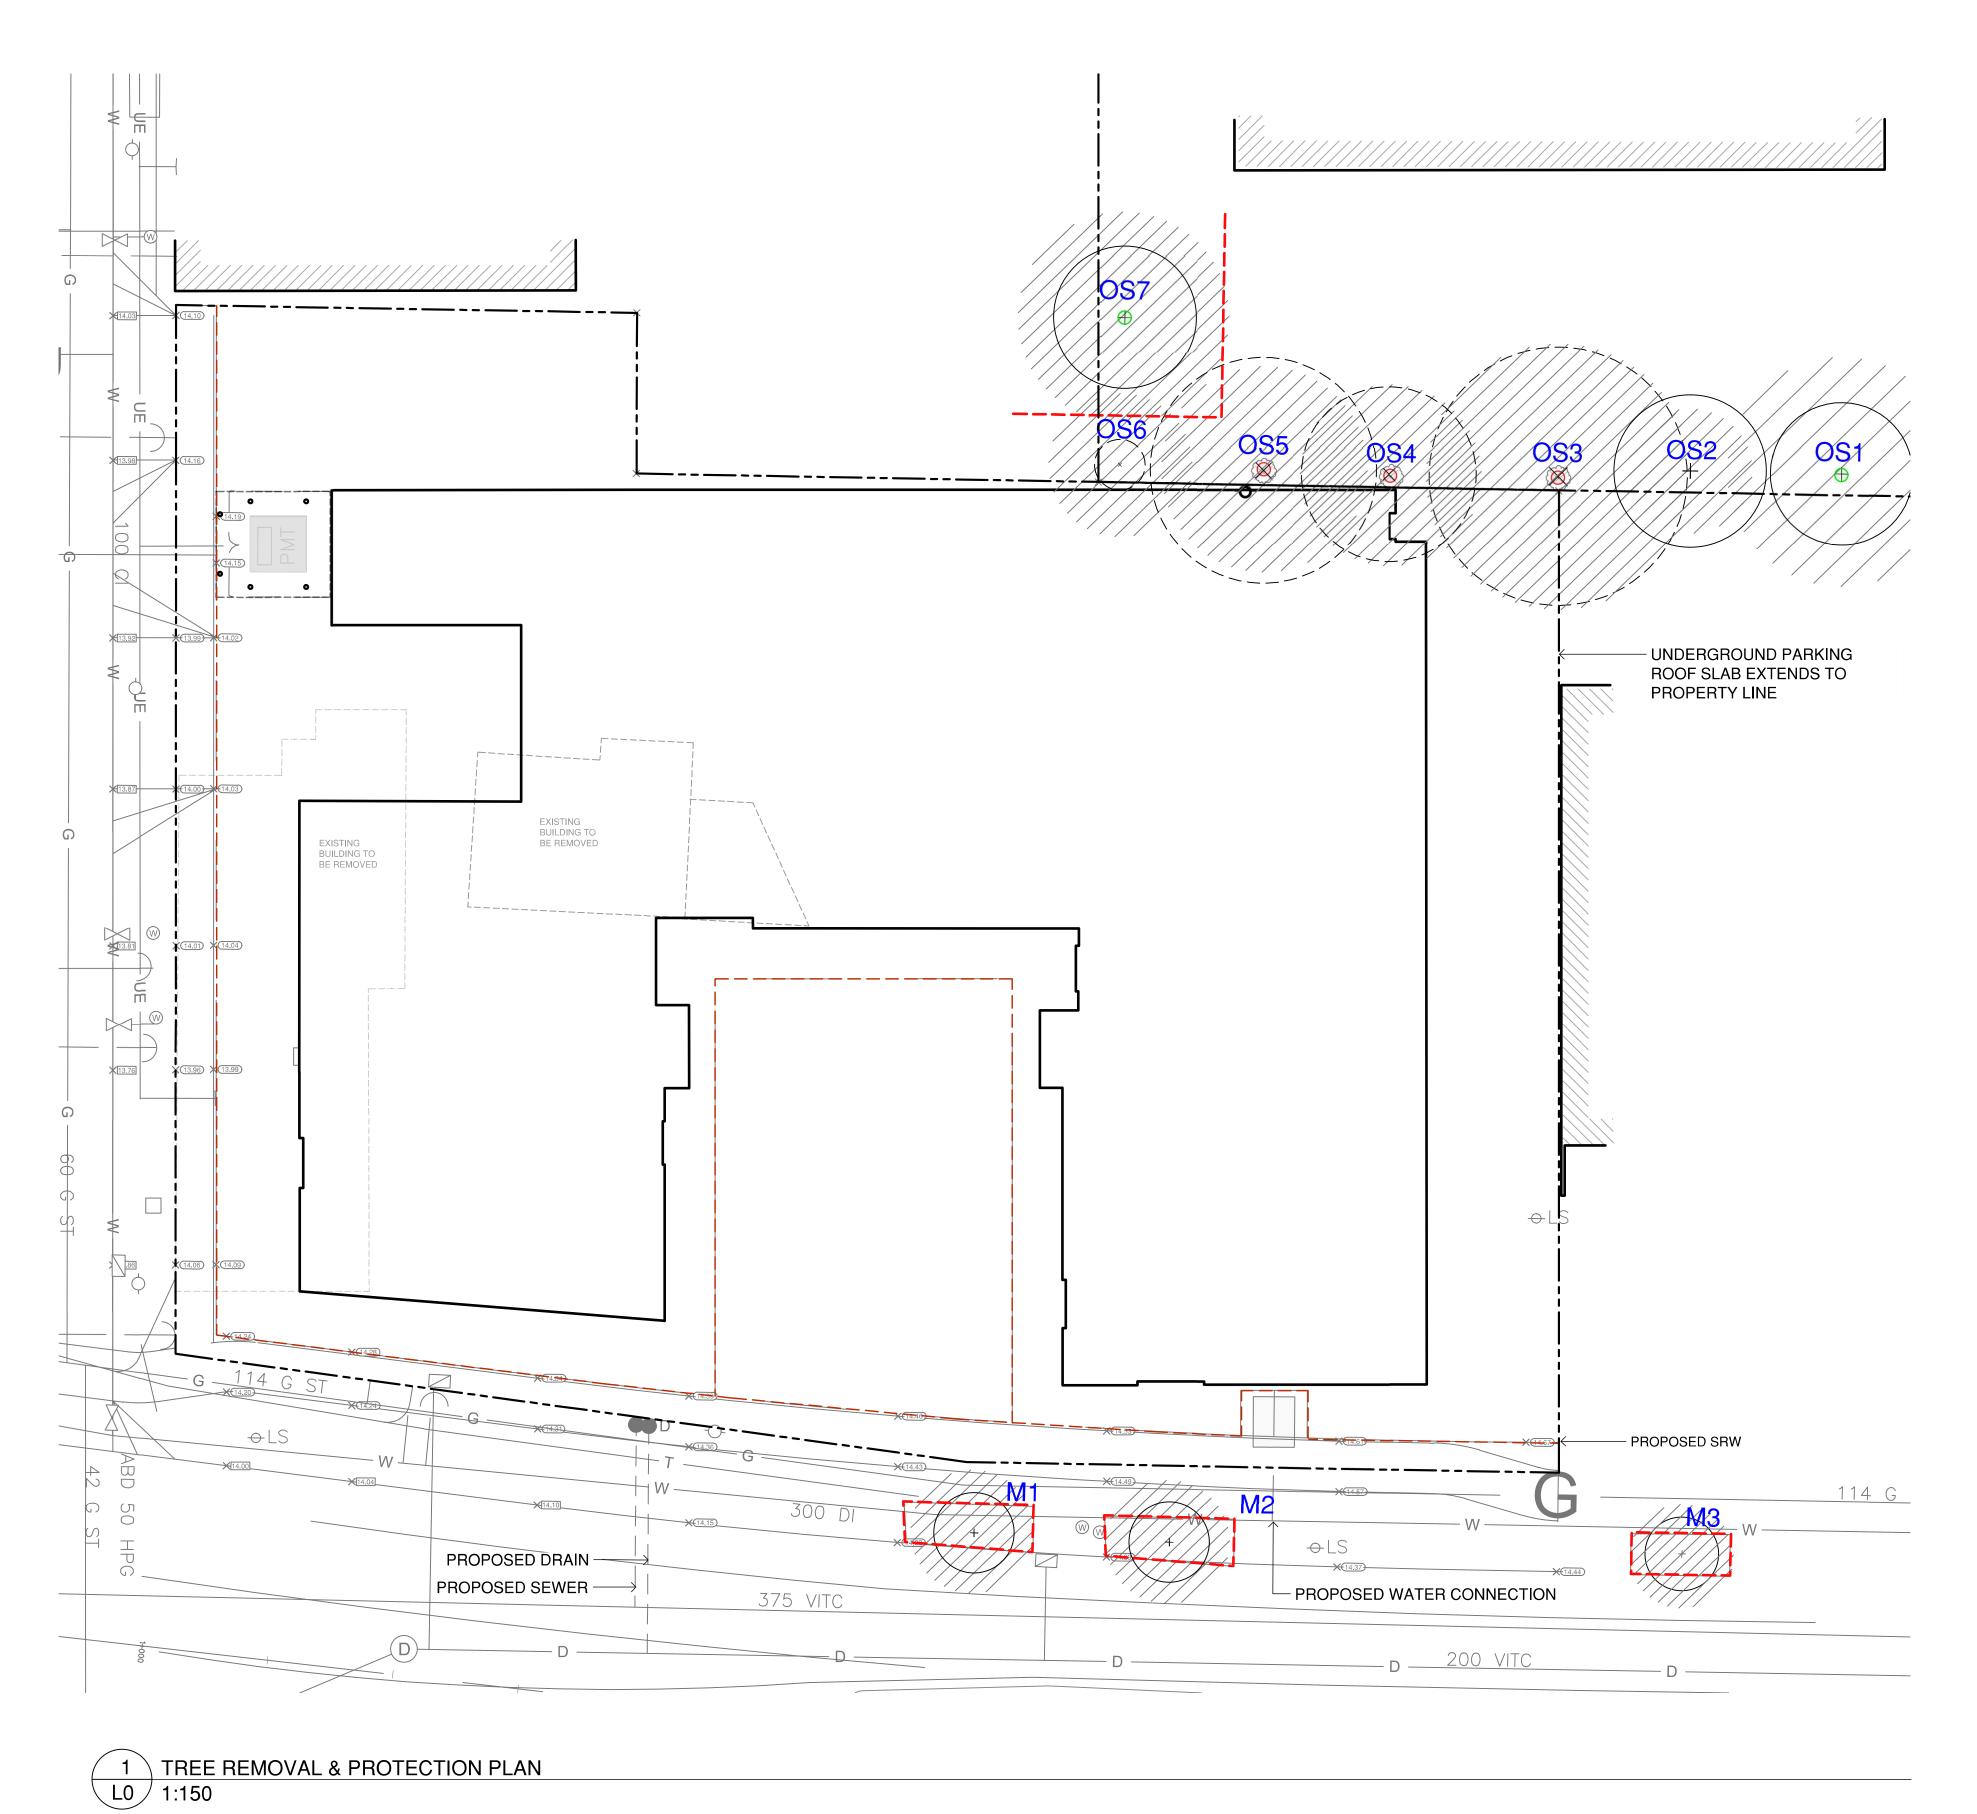

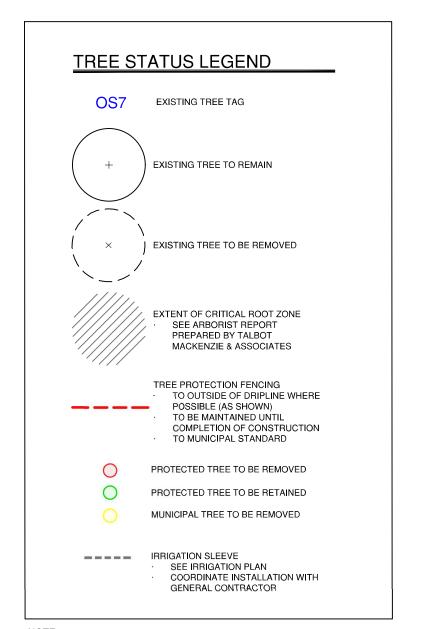

NOTE:

1. FOR COMPLETE TREE REMOVAL AND PROTECTION PROTOCOLS,
PLEASE REFER TO ARBORIST REPORT PREPARED BY TALMAC.

Tag or ID	Surveyed Location Bylaw							Dripline diameter	Conditio	n	Relative	General field	Tree retention/location	Retention
#	(Yes/No)	(On, Off, Shared, City)	protected ? (Yes/No)	Common	Botanical	dbh (cm)	root zone radius (m)	(m)	Health	Structural	tolerance	observations/remarks	comments	status
OS1	No	Off-site	Yes	Norway Maple	Acer platanoides	38 over ivy	4.6	8	Fair	Fair	Moderate	Topped historically.		Retain
082	No	Off-site	No	Norway Maple	Acer platanoides	21	2.5	6	Fair	Fair	Moderate	Deadwood.	May be impacted by OS3 stump removal. OS3 stump should be left intact.	Retain*
OS3	Yes	Off-site	Yes	Norway Maple	Acer platanoides	44	5.3	10	Fair	Fair	Moderate	Topped historically, included bark in unions.	Conflict with P1, P2.	x
084	Yes	Off-site	Yes	Norway Maple	Acer platanoides	30	3.6	7	Fair	Fair-poor	Moderate	Topped historically, included bark in unions, decay in pruning wounds.	Conflict with P1, P2.	x
<b>DS</b> 5	Yes	Off-site	Yes	Norway Maple	Acer platanoides	34	4.1	9	Fair	Fair-poor	Moderate	Topped historically, included bark in unions, epicormic growth, decay in pruning wounds.	Conflict with P1, P2.	x
OS6	No	Off-site	No	Pyramidal Cedar	Thuja occidentalis	11,9,9,6,5	2.8	2	Fair	Fair	Good	lvy on trunks.	Conflict with P1, P2.	x
087	No	Off-site	Yes	Norway Maple	Acer platanoides	36	4.3	7	Fair	Fair	Moderate	Approximately 5m north of PL.	May be impacted by excavation for P1, P2. The project arborits should be consulted if over excavation of the northern property line should occur.	Retain*
W1	Yes	Municipal	Municipal	Red Maple	Acer rubrum	20	2.4	3	Good	Fair-poor	Moderate	Included bark in unions.		Retain
		pu		. tod maplo	. iooi iubium		E T		5554	. an poor		manage server at alligher		a so sulli
M2	Yes	Municipal	Municipal	Red Maple	Acer rubrum	19	2.3	3	Good	Fair-poor	Moderate	Included bark in unions.		Retain
М3	Yes	Municipal	Municipal	Red Maple	Acer rubrum	18	2.2	3	Good	Fair-poor	Moderate	Included bark in unions.		Retain

### TREE IMPACT & PRESERVATION SUMMARY

	Α	В	С	D	
Tree Status	Total # of	# Of Trees	# Of NEW or	# Of EXISTING	NET
	Protected	to be	REPLACEMENT	non-protected	CHANGE
	Trees	REMOVE	Trees to be	Trees Counted	(A-
		D	Planted*	as Replacements	B+C+D)
Onsite Trees	0	0	12	0	+12
Private Offsite Trees	5	3	3	0	0
Municipal Trees	3	0	1	N/A	+1
Total	8	3	16	0	+13



1608 Camosun Street, Victoria BC V8T 3E6 Info@biophiliacollective.ca 250 590 1156

ARYZE Developments

PROJECT NAME: FACTORY BLOCK


PROJECT ADDRESS:

480 + 492 Esquimalt Rd. Victoria, BC

DESIGNED BY: **BIANCA BODLEY** DRAWN BY: **KARIANNE HOWARTH** 

3	REVISED AND RE-ISSUED FOR RZ/DP	22/05/27
2	RE-ISSUED FOR RZ/DP	22/01/12
1	ISSUED FOR RZ & DP	21/09/17
NO.	ISSUE	YY/MM/DD




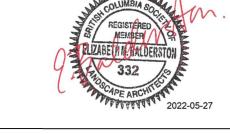




DRAWING TITLE:

TREE REMOVAL & PROTECTION PLAN

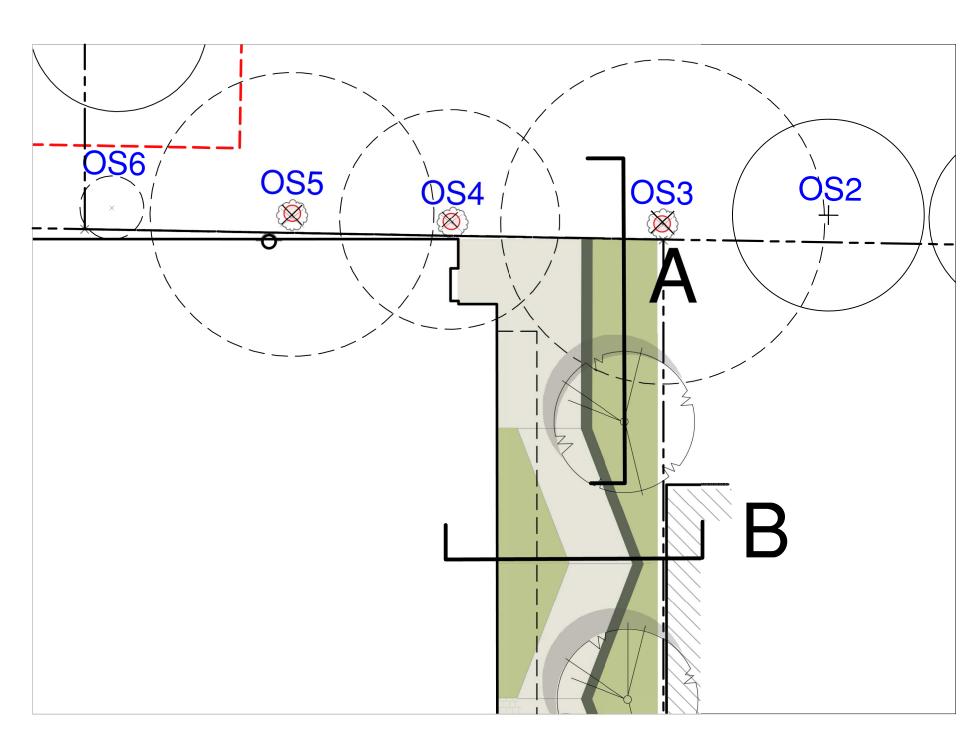


#### SECTION KEY

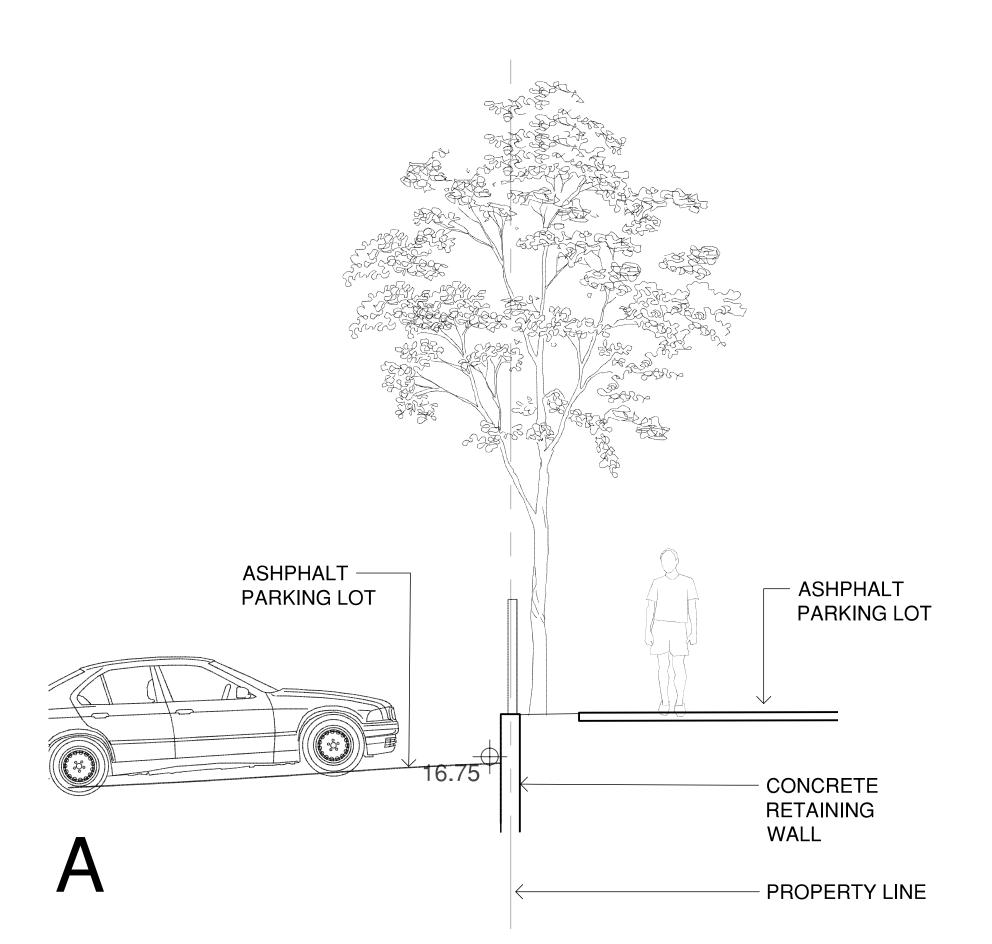


#### **EXISTING CONDITIONS:**

EXISTING TREES ON NEIGHBOURING PROPERTY AT THE NE PROPERTY LINE CURRENTLY SURVIVING AGAINST RETAINING WALL AND BESIDE A ASPHALT PARKING LOT. APPROX 1 FOOT OF SOIL FROM TRUNK TO PAVEMENT EDGE. REMOVAL OF RETAINING WALL AND EXCAVATION OF BUILDING WILL REQUIRE THAT THESE TREES BE REMOVED.

TREES & SHRUBS PLANTED ON TERRACE AND LOWER WALKWAY ARE INTENDED TO REPLACE VEGETATIVE SCREEN PROVIDED BY EXISTING TREES.

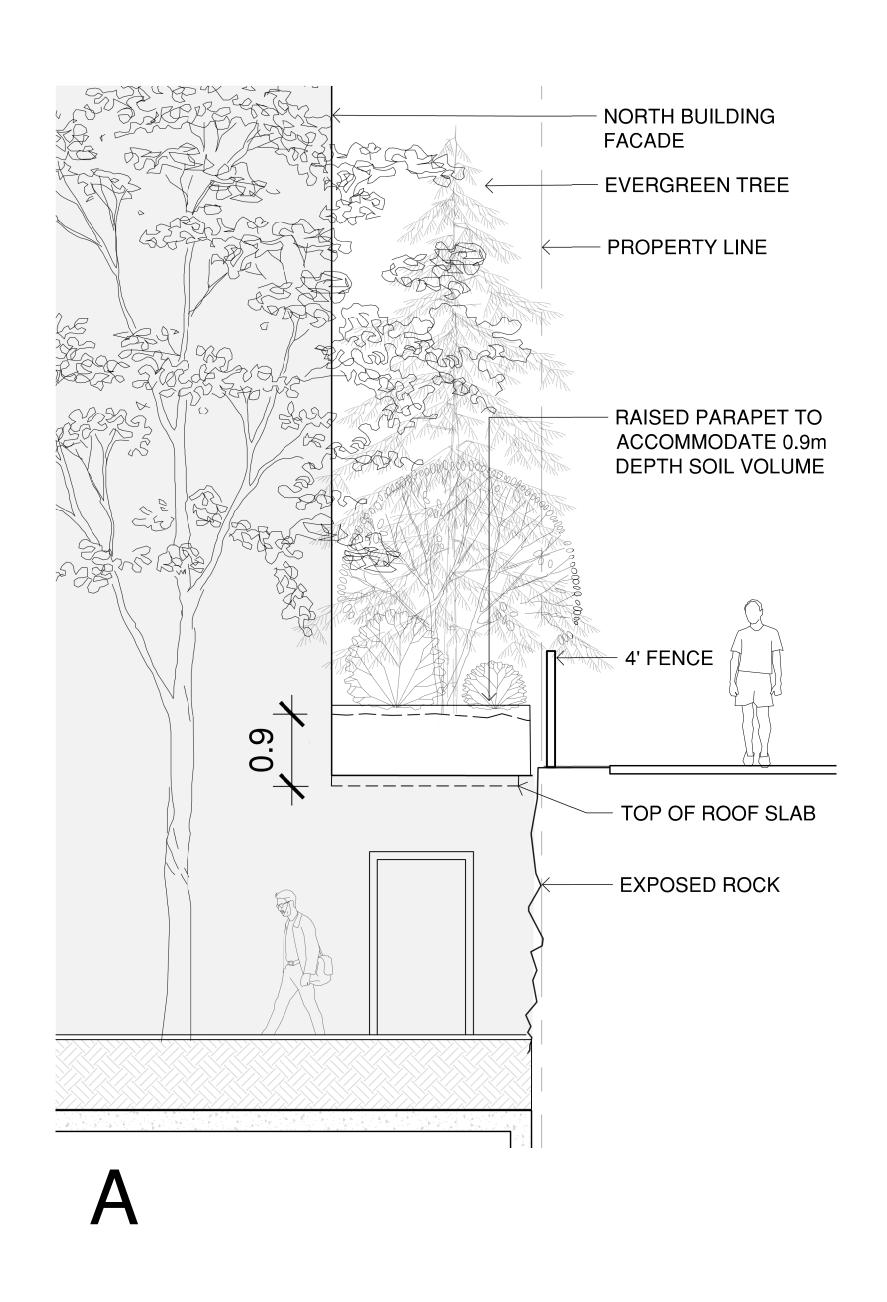

PROPOSED

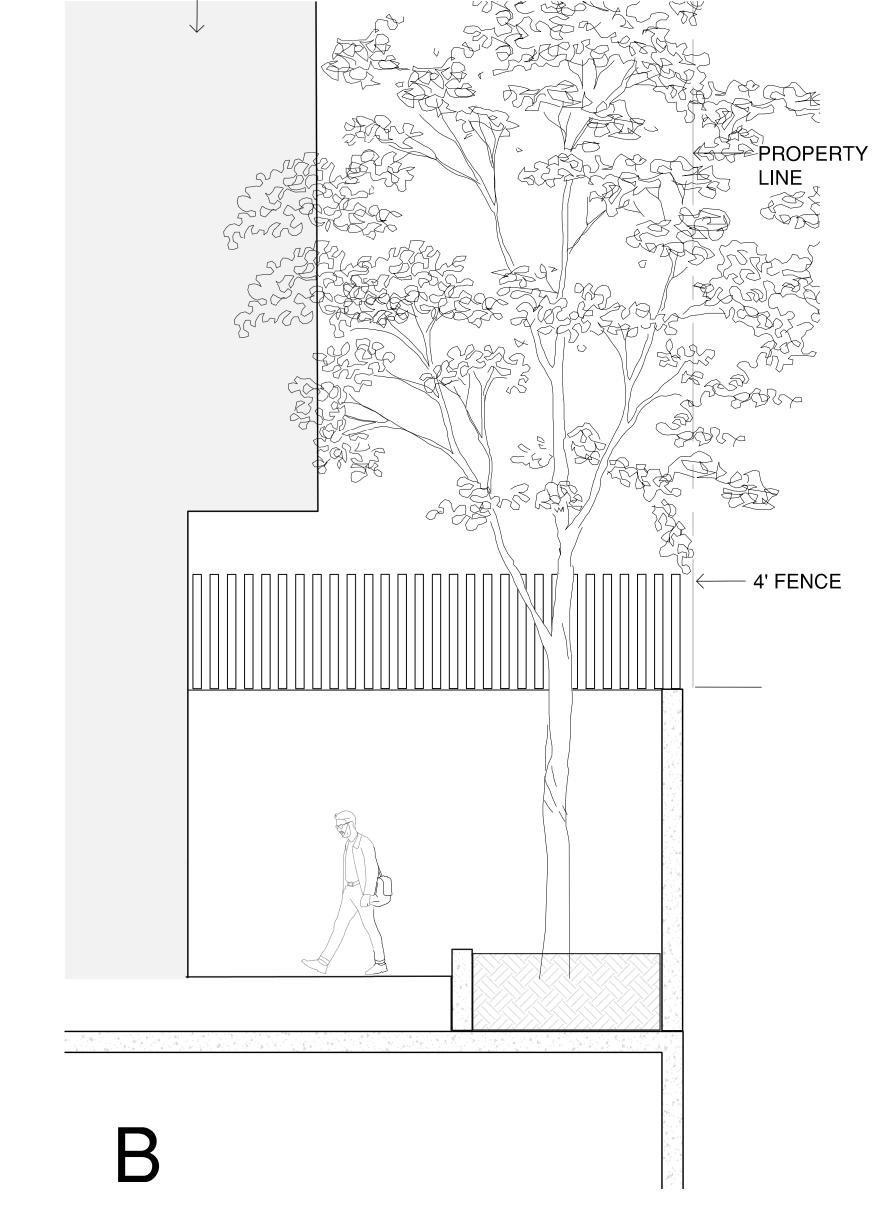

PROPOSED

- EAST BUILDING FACADE



1608 Camosun Street, Victoria BC V8T 3E6 Info@biophiliacollective.ca 250 590 1156

OWNER/CLIENT:

ARYZE Developments

PROJECT NAME:

FACTORY BLOCK

PROJECT ADDRESS:

480 + 492 Esquimalt Rd. Victoria, BC

DESIGNED BY: **BIANCA BODLEY** DRAWN BY: **KARIANNE HOWARTH** 

3 REVISED AND RE-ISSUED FOR RZ/DP 22/05/27
2 RE-ISSUED FOR RZ/DP 22/01/12
1 ISSUED FOR RZ & DP 21/09/17
NO. ISSUE YY/MM/D







DRAWING TITLE:

NE CORNER SECTION / ELEVATIONS



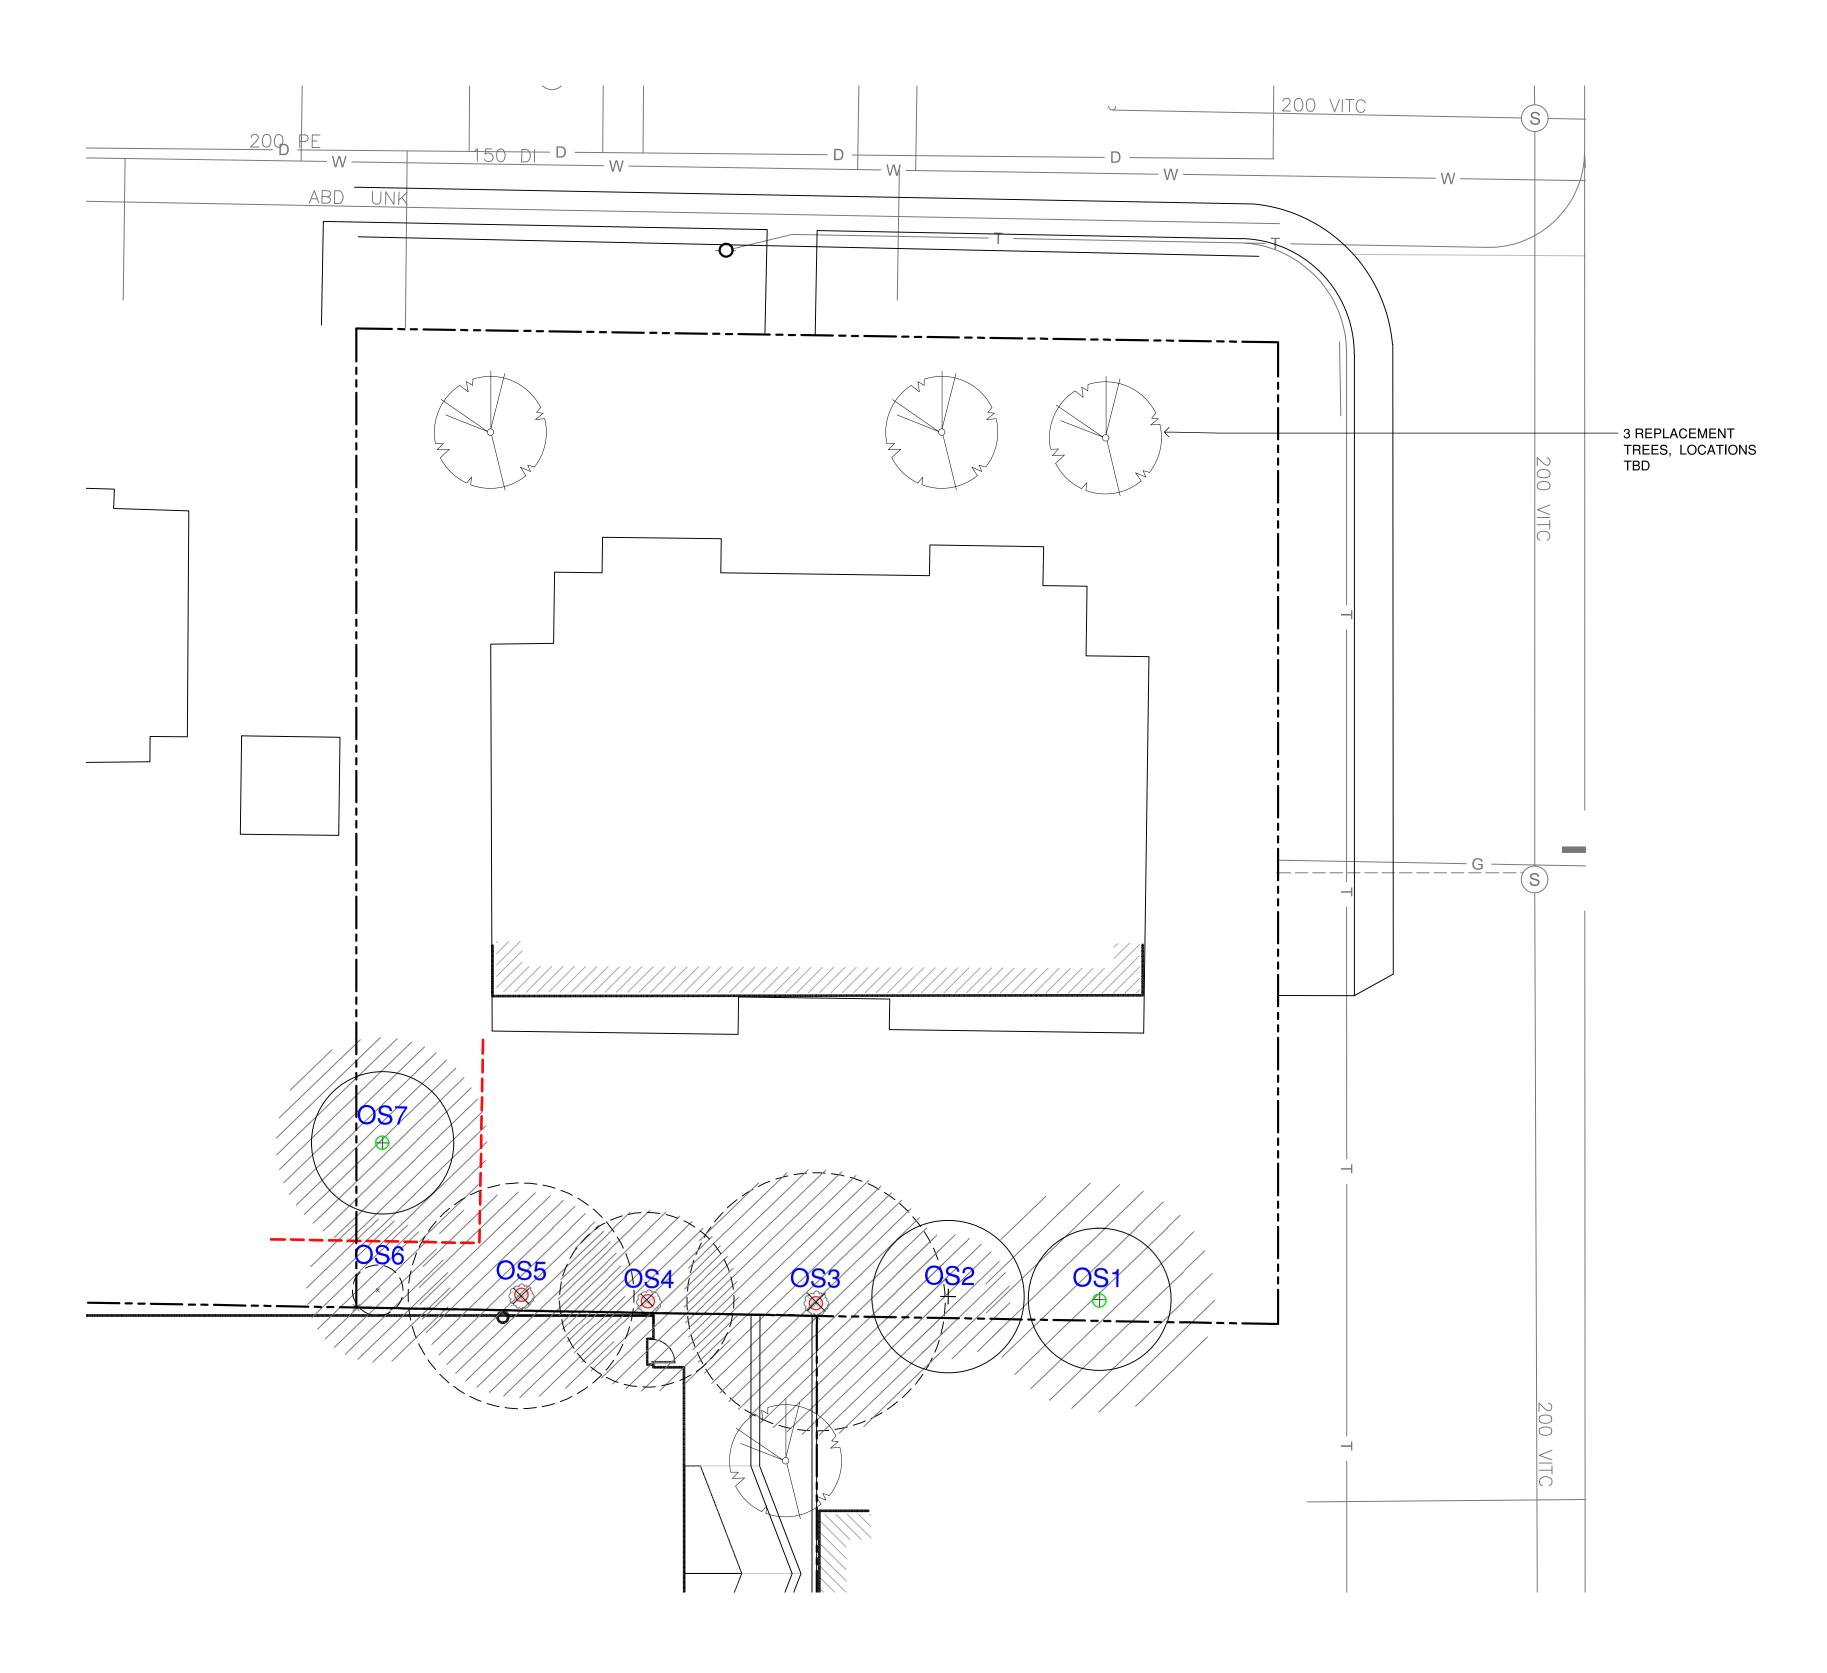

1 ADJACENT SITE TREE REMOVAL, PROTECTION & REPLACEMENT PLAN L0 1:150

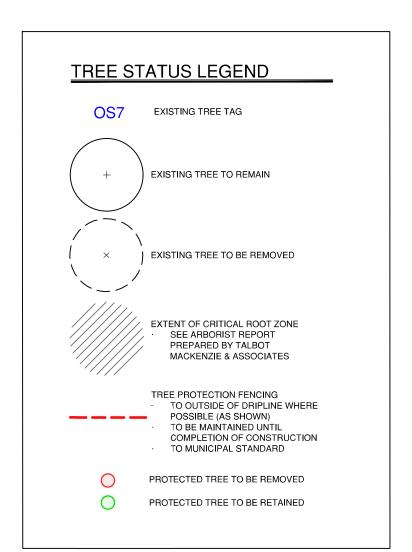

NOTE:

#### **REPLACEMENT TREES FOR OS3-5:**

A REPLACEMENT TREE PLANTING PLAN ON THE ADJACENT SITE WILL BE PROVIDED PRIOR TO PUBLIC HEARING.



1608 Camosun Street, Victoria BC V8T 3E6 Info@biophiliacollective.ca 250 590 1156

OWNER/CLIENT:

PROJECT NAME:

**ARYZE** Developments

FACTORY BLOCK

PROJECT ADDRESS:

480 + 492 Esquimalt Rd. Victoria, BC

DESIGNED BY: **BIANCA BODLEY** DRAWN BY: **KARIANNE HOWARTH** 


REVISED AND RE-ISSUED FOR RZ/DP 22/05/27 RE-ISSUED FOR RZ/DP ISSUED FOR RZ & DP





DRAWING TITLE:

ADJACENT SITE TREE REMOVAL, PROTECTION & REPLACEMENT PLAN

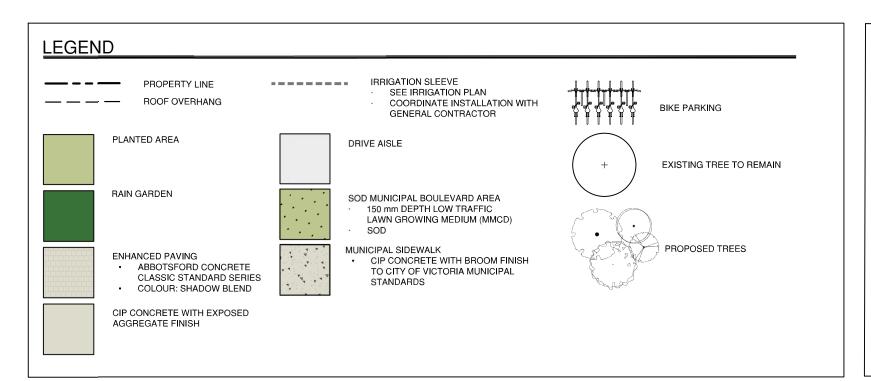

# IRRIGATION SEE DETAILED IRRIGATION PLAN TO BE SUBMITTED AT BP STAGE. ALL ON-SITE PLANTED BEDS AND TREES TO BE IRRIGATED. AUTOMATIC UNDERGROUND IRRIGATION SYSTEM DESIGNED BY AN IIABC CERTIFIED IRRIGATION DESIGNER AND INSTALLED TO IIABC STANDARDS WATER WISE MP ROTATOR SPRAY HEADS & DRIP IRRIGATION BACK-FLOW PREVENTION DEVICE AND WINTERIZATION BLOW OUT WIFI TIMER PROPOSED BOULEVARD TREES TREES PROJES TO BE COODDINATED WITH PARKS PRIOR TO PLANTING TREES MUST HAVE ONE DOMINANT CENTRAL LEADER OR SINGLE STRAIGHT TRUNK, 5-8 cm DIAMETER, CALIPER MEASURED 15 cm ABOVE GROUND, WELL BALANCED CROWN WITH BRANCHING STARTING AT 1.5m-2.5m ABOVE GROUND COVERS (32 93 01 MMCD 2009 AND CITY OF VICTORIA SUPPLEMENTAL DRAWINGS SD P3 AND SD P4) PARKS WILL REQUIRE (3) INSPECTION FOR TREE PLANTING: 1)INSPECTION OF SOIL AND PLANTING AREA, 2) INSPECTION OF STOCK UPON DELIVERY, 3) INSPECTION OF INSTALLED TREE WITH MULCH AND STAKING. TRUNK FLARE MUST BE VISIBLE AND PLANTED AT OR SLIGHTLY ABOVE GRADE UPON INSPECTION. THE APPLICANT MUST MAINTAIN THE TREE IN GOOD HEALTH AND STRUCTURAL CONDITION FOR 1 YEAR FROM THE SUBSTANTIAL COMPLETION TO BE ELIGIBLE FOR DEPOSIT RETURN. BOULEAVARD IRRIGATION SEE IRRIGATION PLAN MUNICIPAL BOULEVARD TO BE IRRIGATED BY A SEPARATE SYSTEM FROM A SEPARATE CITY SOURCE CONFORMING TO THE CITY OF VICTORIA SUPPLEMENTARY

DRAWINGS SHOULD INDICATE ALL COMPONENTS, MODELS AND MATERIALS FROM WATER SUPPLY TO IRRIGATION HEADS.
THE CITY WILL REQUIRE 4 INSPECTIONS FOR IRRIGATION INSTALLATION: 1)SLEEVING, 2) OPEN TRENCH MAINLINE AND PRESSURE TEST, 3) OPEN TRENCH AND LATERAL LINE, 4) OPERATION AND COVERAGE, AND BACKFLOW PREVENTER ASSEMBLY TEST REPORT.

SPECIFICATIONS FOR STREET TREES AND IRRIGATION SCHEDULE C TO BYLAW 12-042, SUBDIVISION BYLAW. IRRIGATION DESIGN DRAWINGS MUST BE SENT TO PARKS FOR REVIEW 30 DAYS PRIOR TO INSTALLATION.




**DESIGN INSPIRATION** 








ENHANCED PAVING CONCEPT ('COBBLESTONE FEEL') : ABBOTSFORD CONCRETE PAVERS IN SHADOW BLEND

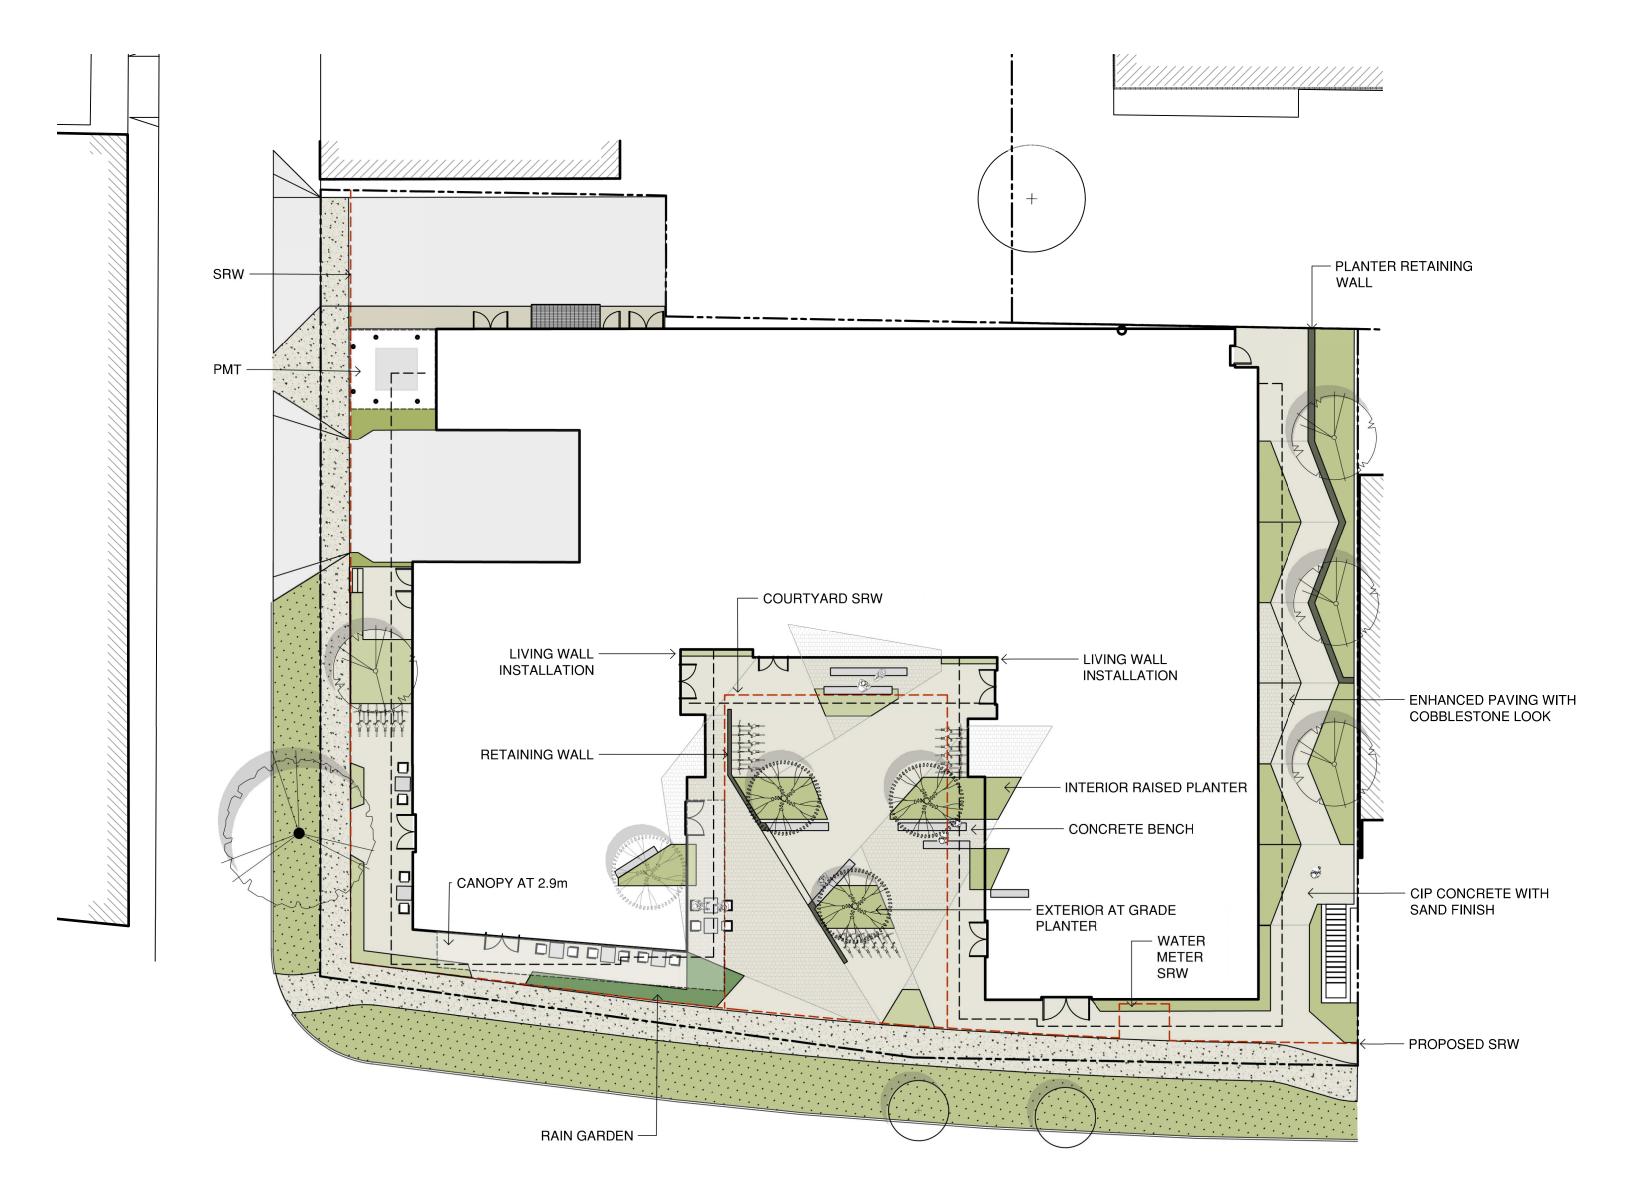

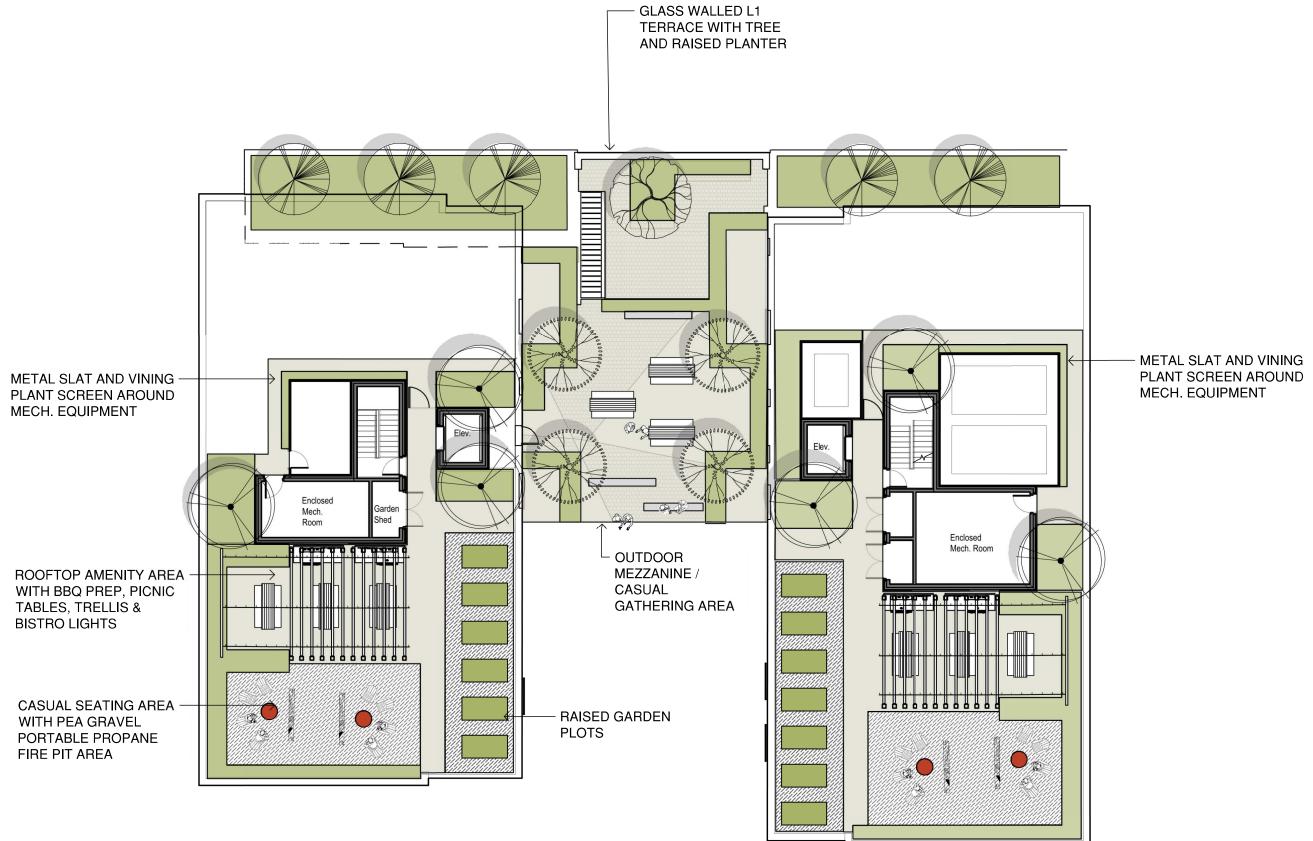





DROUGHT TOLERANT LOW MAINTENANCE PLANT SELECTION FOR PART SHADE AREAS





DROUGHT TOLERANT HARDY PLANT SELECTION FOR EXPOSED ROOF TOP ENVIRONMENT



1608 Camosun Street, Victoria BC V8T 3E6 Info@biophiliacollective.ca 250 590 1156

OWNER/CLIENT:

**ARYZE** Developments


PROJECT NAME:

FACTORY BLOCK

PROJECT ADDRESS:

480 + 492 Esquimalt Rd. Victoria, BC

DESIGNED BY: BIANCA BODLEY
DRAWN BY: KARIANNE HOWARTH

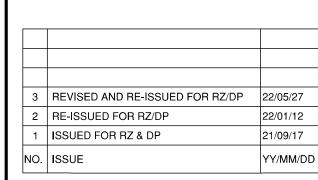





DRAWING TITLE:

LANDSCAPE SITE PLAN

DWG NO:


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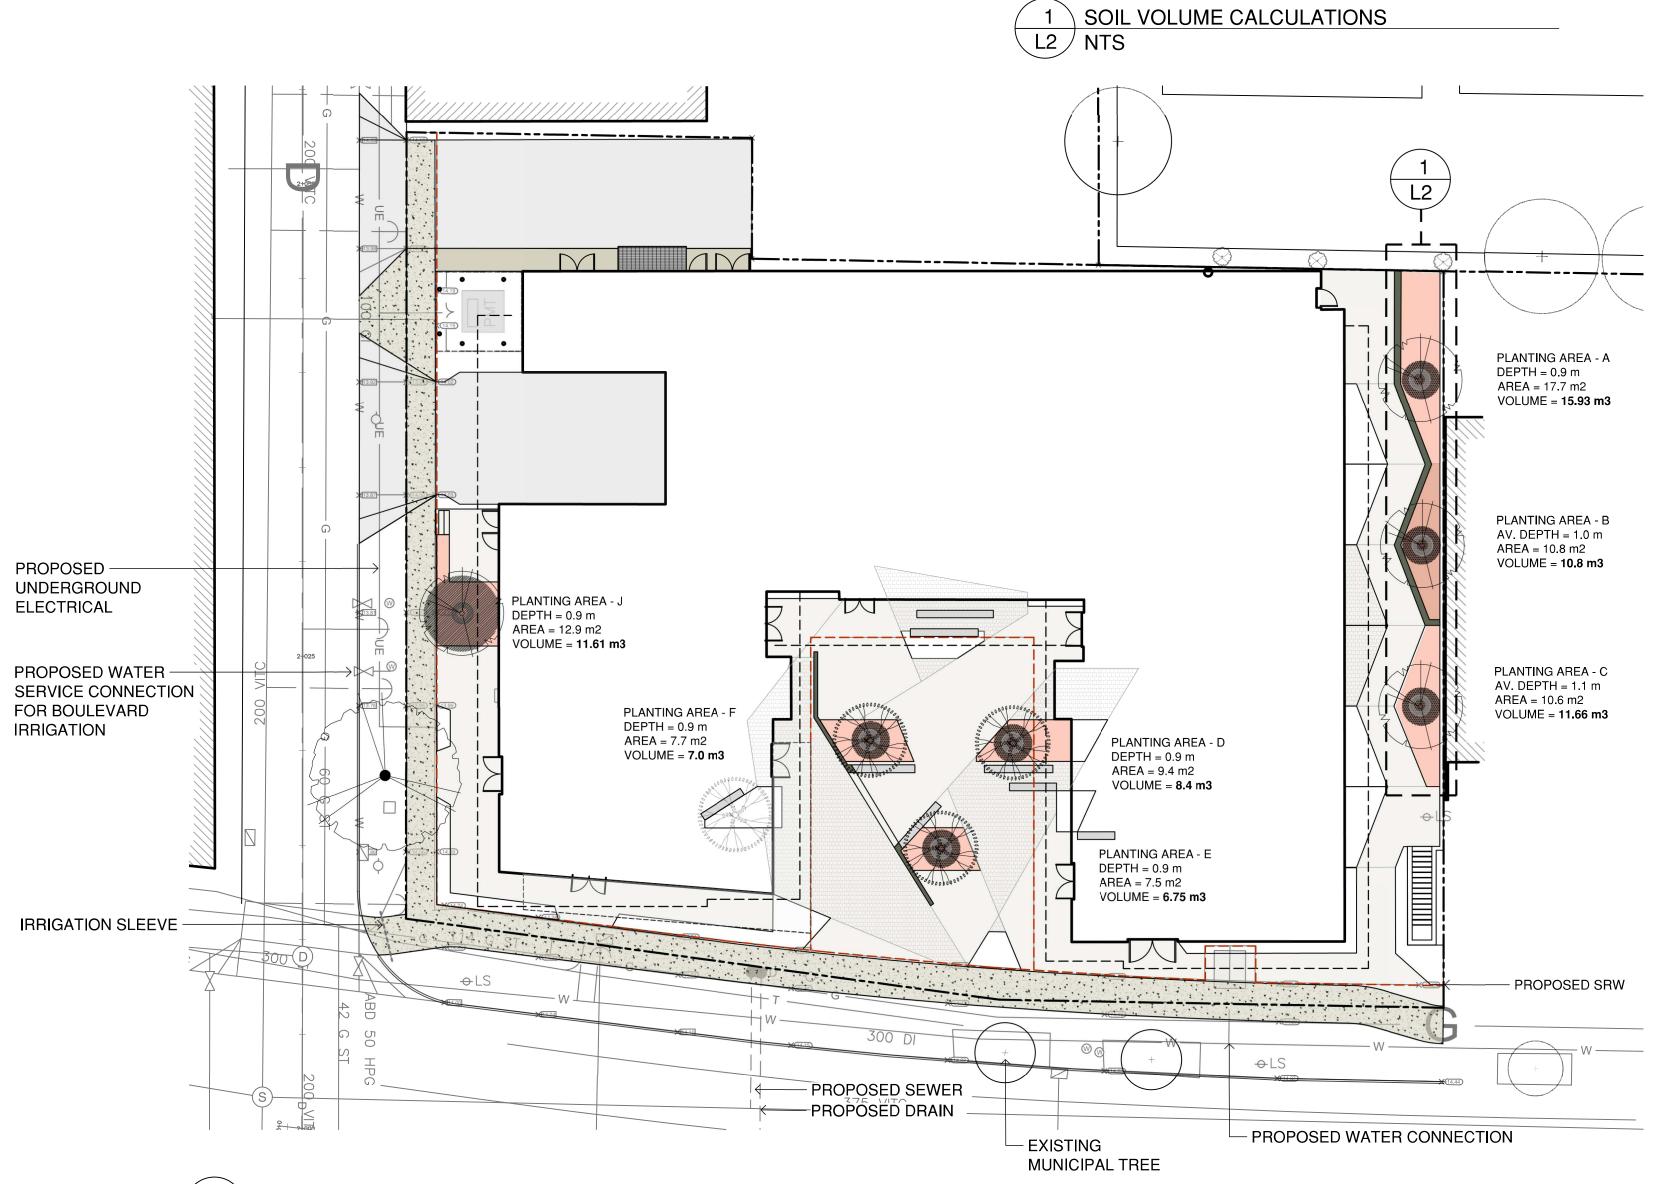
# LEGEND — — — ROOF OVERHANG PROPOSED 'REPLACEMENT TREE' 1.0 m OFFSET FROM UTILITY, PAVED AREA OR PROPERTY LINE 2.0m OFFSET FROM BUILDING FOUNDATION PLANTING AREA FOR SOIL VOLUME CALCULATIONS

#### TREE IMPACT & PRESERVATION SUMMARY


Tree Status	A Total # of Protected Trees	B # Of Trees to be REMOVE	C # Of NEW or REPLACEMENT Trees to be	D # Of EXISTING non-protected Trees Counted	NET CHANGE (A-
		D	Planted*	as Replacements	B+C+D)
Onsite Trees	0	0	12	0	+12
Private Offsite Trees	5	3	3	0	0
Municipal Trees	3	0	1	N/A	+ 1
Total	8	3	16	0	+13

LANDSCAPE NOTES	PLANTING AREA - A DEPTH = 0.9 m AREA = 17.7 m2 VOLUME = <b>15.93 m3</b>
IRRIGATION  SEE DETAILED IRRIGATION PLAN TO BE SUBMITTED AT BP STAGE.  ALL ON-SITE PLANTED BEDS AND TREES TO BE IRRIGATED.  AUTOMATIC UNDERGROUND IRRIGATION SYSTEM DESIGNED BY AN IIABC CERTIFIED IRRIGATION DESIGNER AND INSTALLED TO IIABC STANDARDS.  WATER WISE MP ROTATOR SPRAY HEADS & DRIP IRRIGATION  BACK-FLOW PREVENTION DEVICE AND WINTERIZATION BLOW OUT.  WIFI TIMER  PROPOSED BOULEVARD TREES  TREE SPECIES TO BE COORDINATED WITH PARKS PRIOR TO PLANTING  TREES MUST HAVE ONE DOMINANT CENTRAL LEADER OR SINGLE STRAIGHT TRUNK, 5-8 cm DIAMETER, CALIPER MEASURED 15 cm ABOVE GROUND, WELL BALANCED CROWN WITH BRANCHING STARTING AT 1.8m-2.5m ABOVE GROUND  TREES TO BE PLANTED AS PER PLANTIG OF TREES, SHRUBS AND GROUND COVERS (32 93 01 MMCD 2009 AND CITY OF VICTORIA SUPPLEMENTAL DRAWINGS SD P3 AND SD P4)	
<ul> <li>P3 AND SD P4)</li> <li>PARKS WILL REQUIRE (3) INSPECTIONS FOR TREE PLANTING: 1)INSPECTION OF SOIL AND PLANTING AREA, 2) INSPECTION OF STOCK UPON DELIVERY, 3) INSPECTION OF INSTALLED TREE WITH MULCH AND STAKING. TRUNK FLARE MUST BE VISIBLE AND PLANTED AT OR SLIGHTLY ABOVE GRADE UPON INSPECTION.</li> <li>THE APPLICANT MUST MAINTAIN THE TREE IN GOOD HEALTH AND STRUCTURAL CONDITION FOR 1 YEAR FROM THE SUBSTANTIAL COMPLETION TO BE ELIGIBLE FOR DEPOSIT RETURN.</li> </ul>	
BOULEAVARD IRRIGATION  SEE IRRIGATION PLAN  MUNICIPAL BOULEVARD TO BE IRRIGATED BY A SEPARATE SYSTEM FROM A SEPARATE CITY SOURCE CONFORMING TO THE CITY OF VICTORIA SUPPLEMENTARY SPECIFICATIONS FOR STREET TREES AND IRRIGATION SCHEDULE C TO BYLAW 12-042, SUBDIVISION BYLAW. IRRIGATION DESIGN DRAWINGS MUST BE SENT TO PARKS FOR REVIEW 30 DAYS PRIOR TO INSTALLATION. DRAWINGS SHOULD INDICATE ALL COMPONENTS, MODELS AND MATERIALS FROM WATER SUPPLY TO IRRIGATION HEADS. THE CITY WILL REQUIRE 4 INSPECTIONS FOR IRRIGATION INSTALLATION: 1)SLEEVING, 2) OPEN TRENCH MAINLINE AND PRESSURE TEST, 3) OPEN TRENCH AND LATERAL LINE, 4) OPERATION AND COVERAGE, AND BACKFLOW PREVENTER ASSEMBLY TEST REPORT.	RAISED————————————————————————————————————
	0.911



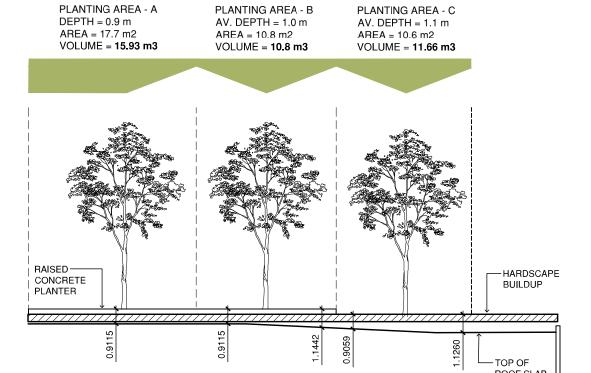

Symbol	Latin Name	Common Name	Container	Caliper	Size	Native
	Acer palmatum 'Seiryu'	Seiryu maple	B&B		4.5m	
	Acer circinatum	Vine Maple (Single stem)	B&B			у
	Amelanchier canadensis	Serviceberry	B&B			у
	Chamaecyparis nootkatensis 'Pendula'	Weeping Nootka cypress	B&B			
The state of the s	Magnolia 'Galaxy'	Galaxy magnolia	B&B			
	BOULEVARD TREE TO BE DETERMINED BY PARKS AT BP		B&B	4cm		
	Symbol Sy	Acer palmatum 'Seiryu'  Acer circinatum  Amelanchier canadensis  Chamaecyparis nootkatensis 'Pendula'  BOULEVARD TREE TO BE DETERMINED BY	Acer palmatum 'Seiryu'  Acer circinatum  Amelanchier canadensis  Chamaecyparis nootkatensis 'Pendula'  Magnolia 'Galaxy'  BOULEVARD TREE TO BE DETERMINED BY  Seiryu maple  Vine Maple (Single stem)  Vine Maple (Single stem)  Weeping Nootka cypress  Galaxy magnolia	Acer palmatum 'Seiryu' Seiryu maple B&B  Acer circinatum Vine Maple (Single stem)  Amelanchier canadensis  Chamaecyparis nootkatensis 'Pendula'  Magnolia 'Galaxy'  Galaxy magnolia  B&B  B&B  BOULEVARD TREE TO BE DETERMINED BY  B&B	Acer palmatum 'Seiryu maple B&B  Acer circinatum Vine Maple (Single stem)  Amelanchier canadensis  Chamaecyparis nootkatensis 'Pendula'  Magnolia 'Galaxy'  Galaxy magnolia  BOULEVARD TREE TO BE DETERMINED BY  B&B  Seiryu maple  B&B  B&B  B&B  B&B  B&B  B&B  B&B  B	Acer palmatum 'Seiryu' Seiryu maple B&B 4.5m  Acer circinatum Vine Maple (Single stem) B&B  Amelanchier canadensis Serviceberry B&B  Chamaecyparis nootkatensis 'Pendula' Galaxy' Galaxy magnolia B&B  BOULEVARD TREE TO BE DETERMINED BY  B&B 4.5m

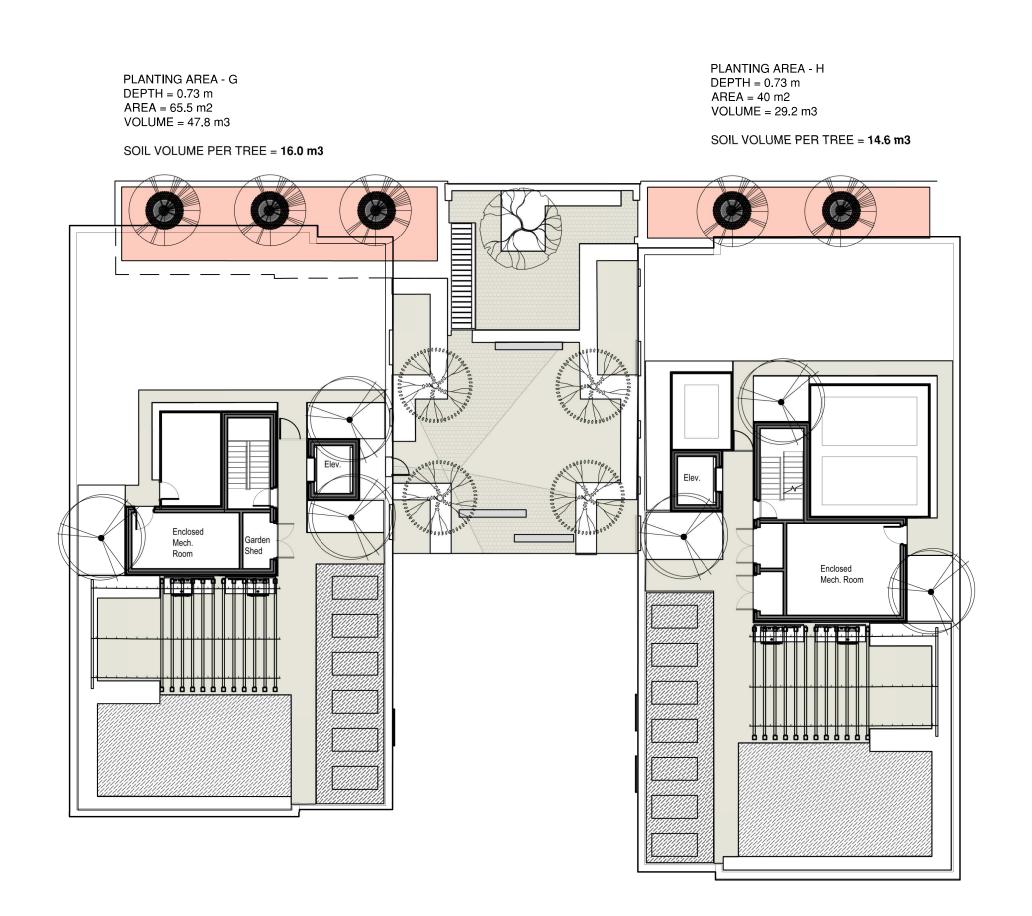





1608 Camosun Street, Victoria BC V8T 3E6 Info@biophiliacollective.ca 250 590 1156

OWNER/CLIENT:

ARYZE Developments

PROJECT NAME:

FACTORY BLOCK

480 + 492 Esquimalt Rd. Victoria, BC

DESIGNED BY: BIANCA BODLEY DRAWN BY: KARIANNE HOWARTH

3 REVISED AND RE-ISSUED FOR RZ/DP 22/05/27 2 RE-ISSUED FOR RZ/DP 21/09/17 1 ISSUED FOR RZ & DP



NORTH ARROW


DRAWING TITLE:

TREE PLANTING PLAN

DWG NO:

SCALE: 1:200



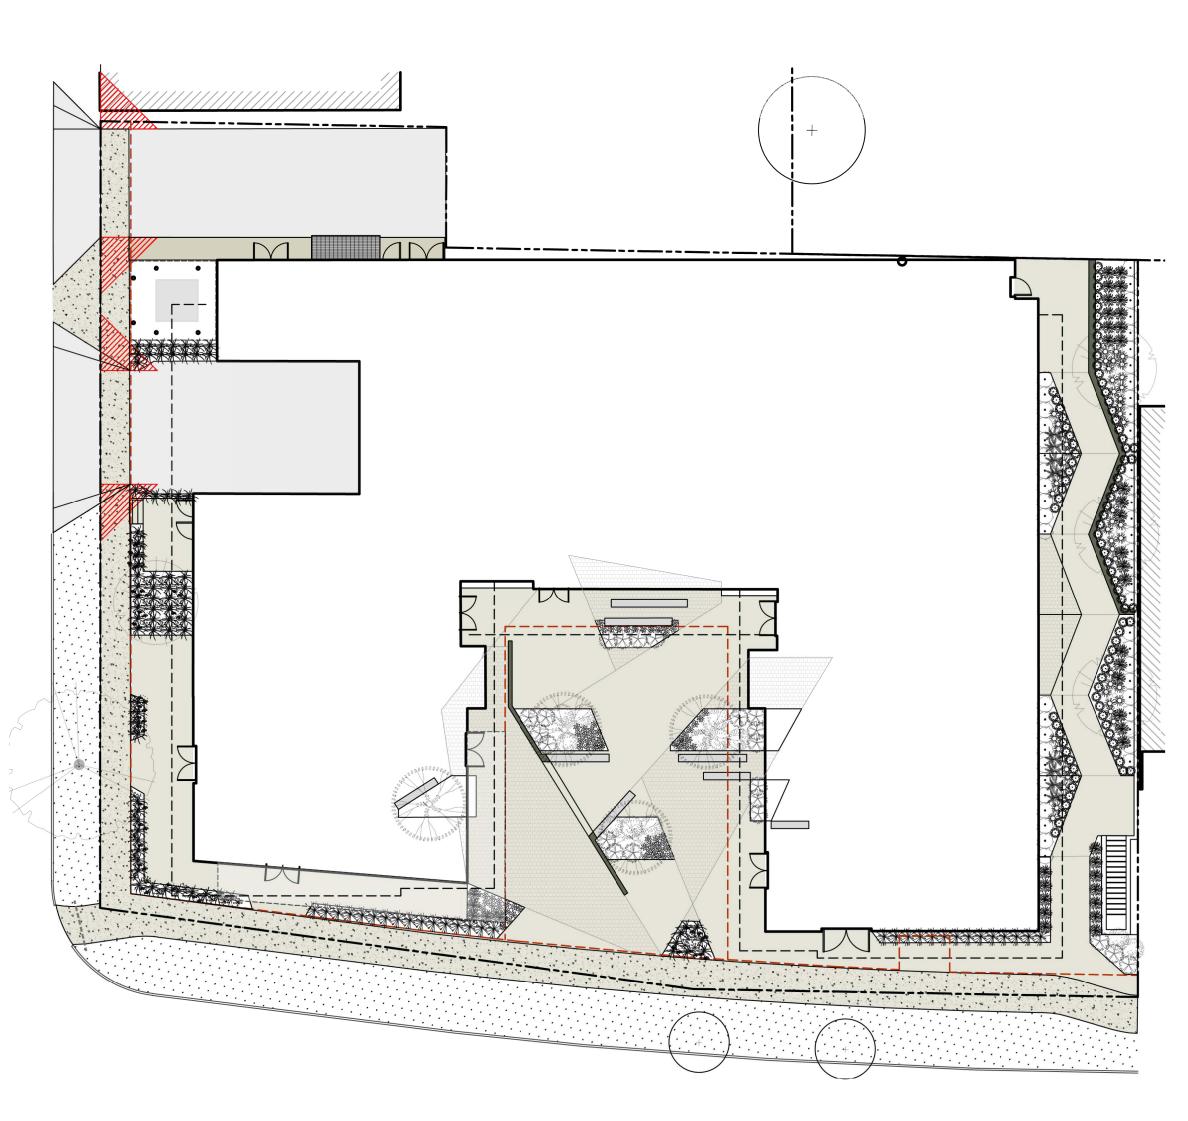

3 M SIGHT TRIANGLE: NO

PLANTINGS OVER 1m HIGH

1 AT GRADE PLANTING PLAN L3 / 1:200

|Quantity| Symbol Latin Name Anaphalis 28 margaritacea

AT GRADE PLANT SCHEDULE

Pearly everlasting #1 Astilbe chinensis Chinese astilbe #1 'Vision in White' Cephalotaxus Spreading Japanese harringtonia plum yew 'Prostrata' Salal #1 Gautheria shallon У Haconchola 'All Gold' Hakone grass All Gold 39 Hebe 'Hinerua' Hinerua Hebe #1 Lathyrus japonica Beach pea tray Leymus arenarius Blue Lyme Grass Ploystichum munitum | Western sword fern Dwarf Sweetbox Sarcococca humilis

Common Name

| Container | Native | Pollinator

#1

#2

1. PLANTS IN PLANT LISTS ARE SPECIFIED ACCORDING TO THE CANADIAN NURSERY LANDSCAPE ASSOCIATION CANADIAN STANDARDS FOR NURSERY STOCK AND SECTION 12, CONTAINER GROWN PLANTS FROM THE BC LANDSCAPE STANDARD, CURRENT EDITION.

Golden oats

'White Wands' Spike


Speedwell

Stipa gigantea

'White Wands'

Spike Speedwell


74

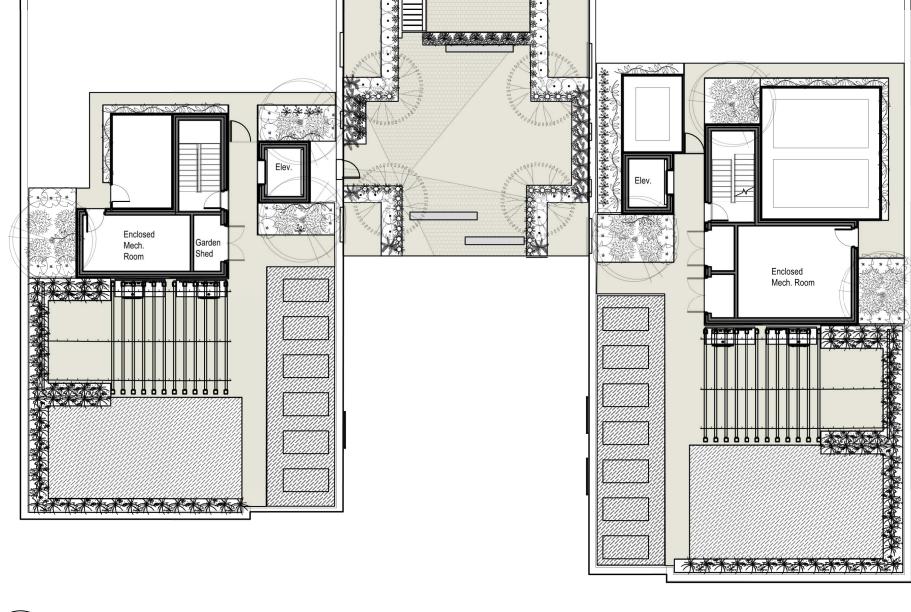

ANINE & TEF	RRACE PLANT SC	HEDULE			
Symbol	Latin Name	Common Name	Container	Native	Pollinator
*	Astilbe chinensis 'Vision in White'	Chinese astilbe	#1		у
	Gaultheria shallon	Salal		у	у
	Haconchola 'All Gold'	Hakone grass All Gold	#1		
×	Ploystichum munitum	Western sword fern	#1	у	
	Ligustrum texanum	Wax leaf privet	#3		
88 88 88 88 88 88 88	Vaccinium ovatum 'Scarlet Ovation'	Scarlet Ovation evergreen huckleberry	#1	у	у
*	Veronicastrum virginicum 'Erica'	Erica Veronica	#2		у
	Symbol  ***  ***  ***  ***  ***  ***  ***	Symbol  Astilbe chinensis 'Vision in White'  Gaultheria shallon  Haconchola 'All Gold'  Ploystichum munitum  Ligustrum texanum  Vaccinium ovatum 'Scarlet Ovation'  Veronicastrum	Astilbe chinensis 'Vision in White'  Gaultheria shallon  Salal  Haconchola 'All Gold'  Ploystichum munitum  Western sword fern  Ligustrum texanum  Vax leaf privet  Vaccinium ovatum 'Scarlet Ovation'  Veronicastrum  Frica Voronica	Symbol Latin Name Common Name Container  Astilbe chinensis 'Vision in White' Chinese astilbe #1  Gaultheria shallon Salal  Haconchola 'All Gold' Hakone grass All Gold #1  Ploystichum munitum Western sword fern #1  Ligustrum texanum Wax leaf privet #3  Vaccinium ovatum 'Scarlet Ovation evergreen huckleberry #1  Veronicastrum Erica Verenica #2	Symbol Latin Name Common Name Container Native  Astilbe chinensis 'Vision in White'  Gaultheria shallon Salal y  Haconchola 'All Gold' Hakone grass All Gold #1  Ploystichum munitum Western sword fern #1 y  Ligustrum texanum Wax leaf privet #3  Vaccinium ovatum 'Scarlet Ovation evergreen huckleberry  Veronicastrum  Frica Veronica #2

ROOFT	OP PLANT	SCHEDULE				
Quantity	Symbol	Latin Name	Common Name	Container	Native	Pollinator
64	ું <del>કે</del>	Anaphalis margaritacea	Pearly everlasting	#1	у	у
3	%: ;;@	Lathyrus japonica	Beach pea	tray		у
94	*	Leymus arenarius	Blue Lyme grass	#1	у	
50	2006	Lonicera ciliosa	Trumpet Honeysuckle	#1	у	у
20		Pinus mugo	Dwarf Mugo pine	#2		у
26	*	Rosmarinus 'Collingwood Ingram'	Collingwood Ingram rosemary	#1		у

1. PLANTS IN PLANT LISTS ARE SPECIFIED ACCORDING TO THE CANADIAN NURSERY LANDSCAPE ASSOCIATION CANADIAN STANDARDS FOR NURSERY STOCK AND SECTION 12, CONTAINER GROWN PLANTS FROM THE BC LANDSCAPE STANDARD, CURRENT EDITION.

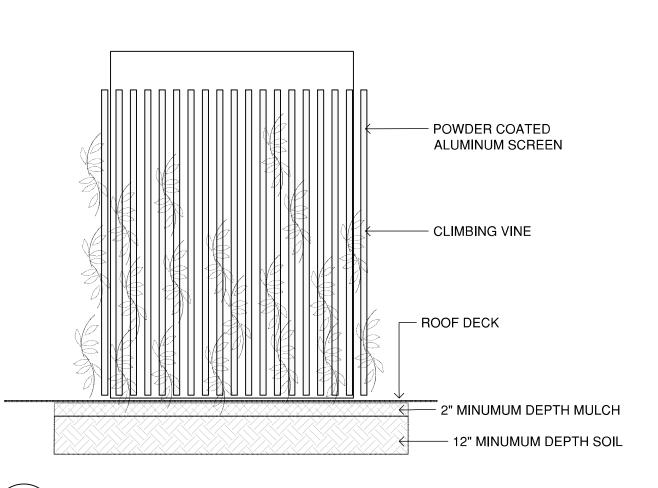

3 MECH. EQUIPMENT SCREEN CONCEPT



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DESIGNED BY: **BIANCA BODLEY** DRAWN BY: **KARIANNE HOWARTH** 

REVISED AND RE-ISSUED FOR RZ/DP 22/05/27 RE-ISSUED FOR RZ/DP 22/01/12 ISSUED FOR RZ & DP 21/09/17 YY/MM/DD



NORTH ARROW

PLANTING PLAN

DWG NO:

SCALE: 1:200

