



Le PARC

FAIRFIELD-KIPLING

9 - UNIT TOWN HOME DEVELOPMENT

1400 Fairfield Rd and 349 Kipling St, Victoria, BC

ATTACHMENT B

List of Architectural Drawings

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A5.1	Concept Renderings	NTS
28	Sheets in Set	

Team of Consultants

Architect

Sébastien Garon Architecture + Design Inc
Project No. 19.015
1018 Deep Cove Rd
North Vancouver BC
Sébastien Garon, Architect, AIBC
(604) 812-1869
sebastien@sgad.ca

Contractor

P. Cosgrave Construction Ltd.
Paul Cosgrave, Principal
(250) 886-1361
paul@cosgrave.ca

Landscape

BIOPHILIA design collective ltd

1501 Haultain St
Victoria BC V8R 2K1
Bianca Bodley
(250) 590-1156
bianca@biophiliacollective.ca

Surveyor

J.E.Anderson & Associates
Project No. 31517
4212 Glanford Ave
Victoria BC V8Z 4B7

(250) 727-2214
info@jeanderson.com

Arborist

Talbot Mackenzie & Associates
Noah Borges, ISA Certified Arborist
(250) 479-8733
tmreehelp@gmail.com

Civil Engineer

Westbrook Consulting Ltd.
Iva Kvartuc, B. Eng.
(250) 391-8592 ext. #235
IKvartuc@wbrook.ca

Geotechnical

Ryzuk Geotechnical
Scott Currie, P. Eng.
(250)-475-3131
scott@ryzuk.com

Structural

Skyline Engineering
Wade Griffin
(250)-590-4133 Ext. 103
wgriffi@seng.ca

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Sébastien GARON

ARCHITECTURE + DESIGN

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(604) 812-1869 info@SGAD.ca
www.SGAD.ca

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Seal

Revisions

Received Date:
December 19, 2022

Issued

2021-07-20	Revised & Re-Issued for DP
2021-11-21	Revised & Re-Issued for DP
2021-12-16	Revised & Re-Issued for DP
2022-03-30	Revised & Re-Issued for DP
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2022-11-25	Revised & Re-Issued for DP

Cover Sheet

Project Name:

Fairfield-Kipling
Development

Civic:

1400 Fairfield Rd &
349 Kipling St

Legal:

PID:

Project No:

19.015

Drawn By:

SG/TD

Plot Date:

Nov 29, 2022

Scale:

NTS

Sheet No:

A1.0

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Survey Plan

Project Name:

Fairfield-Kipling
Development

Civic: 1400 Fairfield Rd &
349 Kipling St

Legal:

PID:

Project No: 19.015


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Plot Date: Nov 29, 2022

Scale: NTS

Sheet No:

A1.1

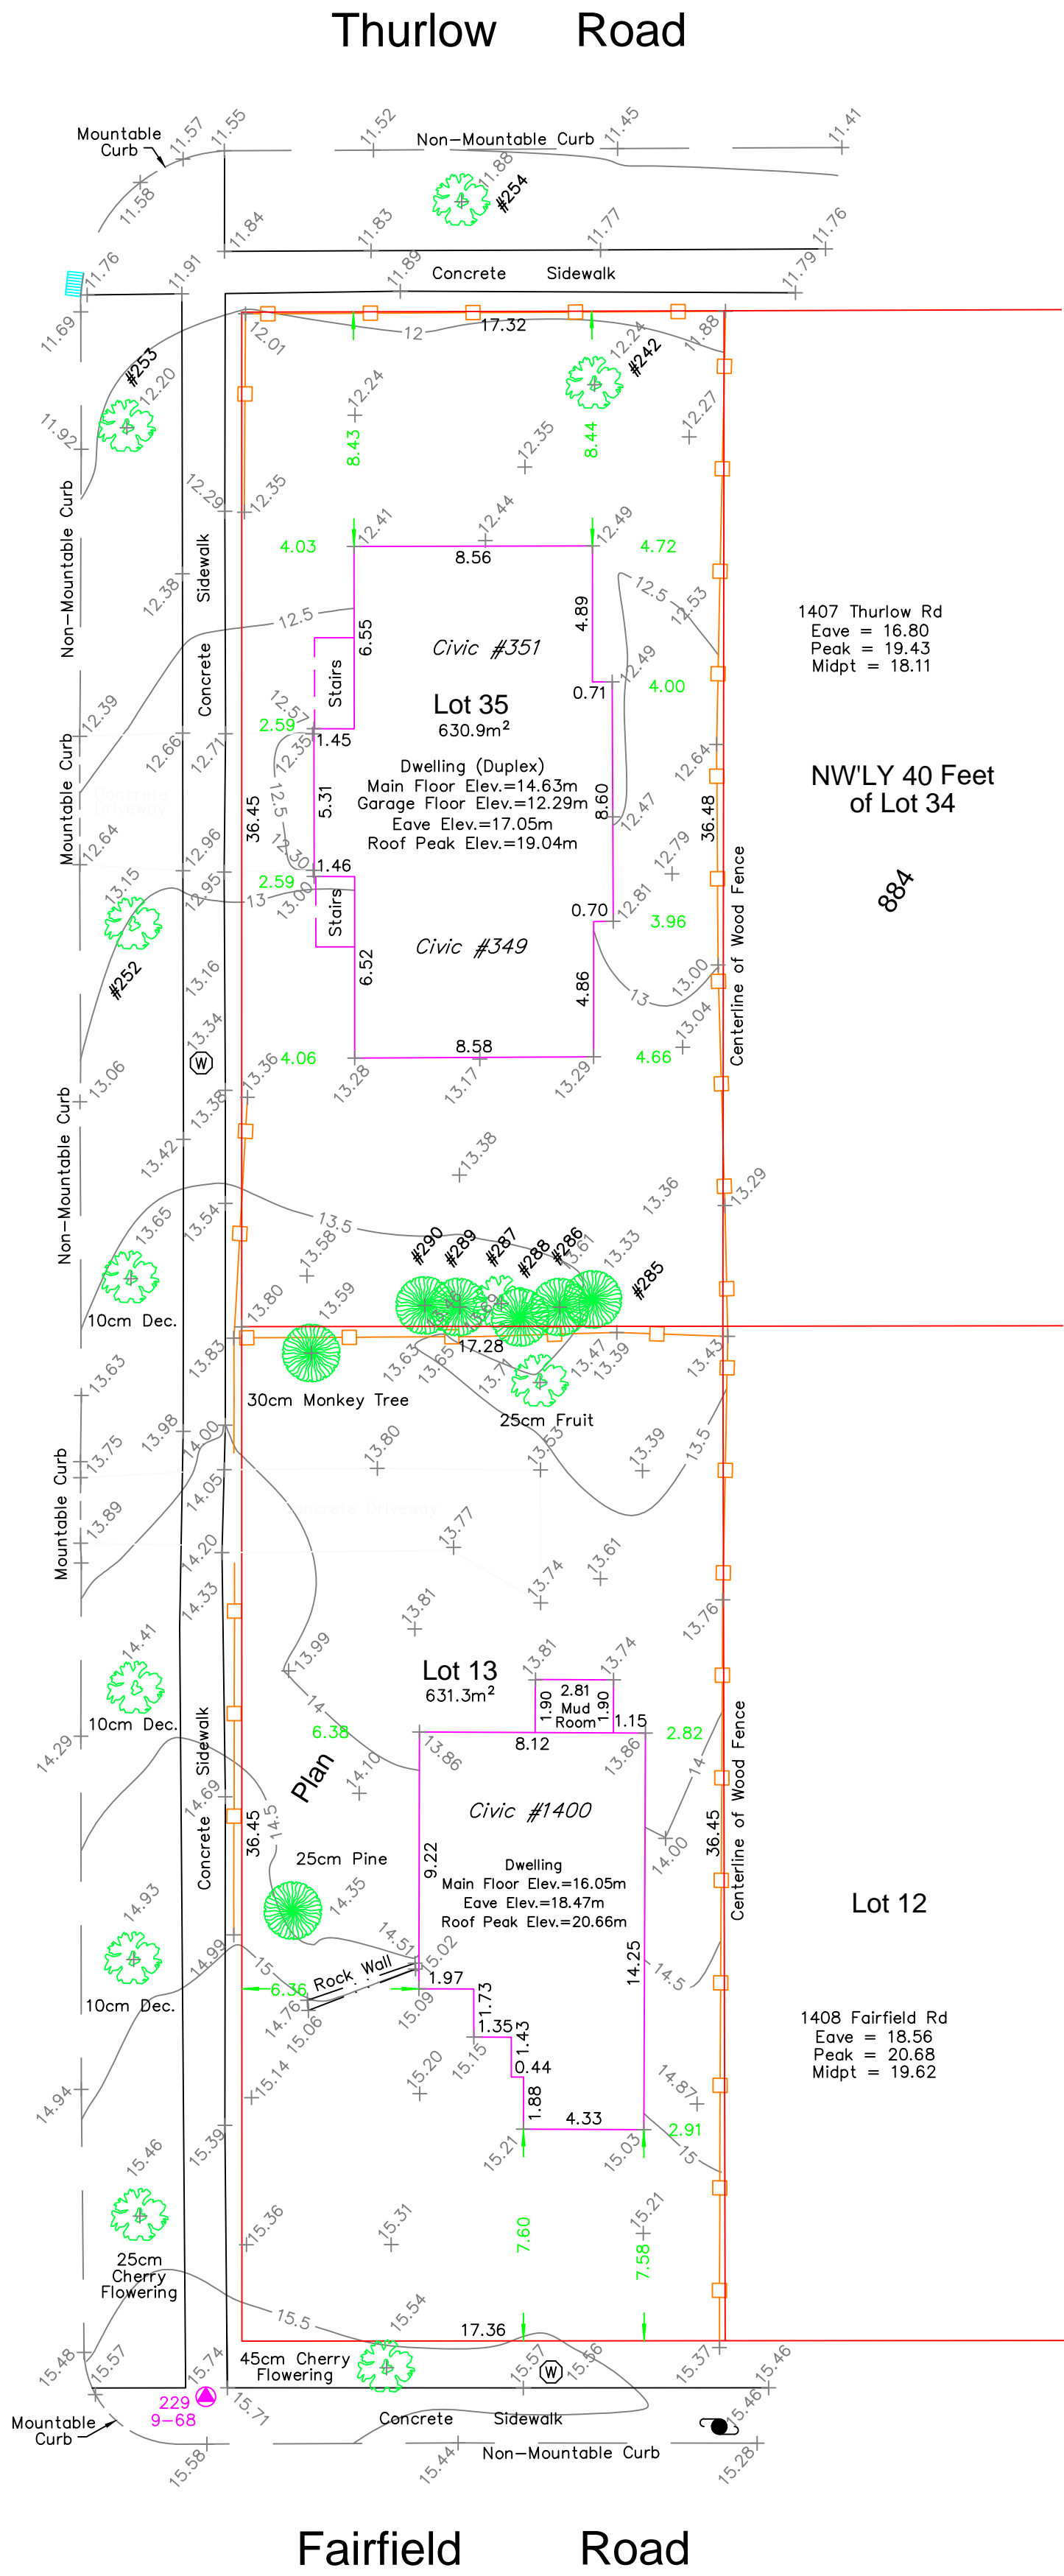

SITE PLAN

BART JOHNSON

Lots 13 & 35, Fairfield Farm Estate, Victoria City, Plan 884

ADDRESS : 1400 Fairfield/ 351 Kipling

PROJECT SURVEYOR : PJW

DRAWN BY : BAR DATE : OCT 2/18

OUR FILE : 31517 REVISION :

JEA

J.E. ANDERSON & ASSOCIATES
SURVEYORS – ENGINEERS

4212 GLANFORD AVE, VICTORIA, B.C. V8Z 4B7
TEL: 250-727-2214 FAX: 250-727-3395
E-MAIL : info@jeanderson.com
VICTORIA-NANAIMO-PARKSVILLE-CAMPBELL RIVER


LEGEND

- Denotes Control Monument Found
- Denotes Traverse Station Placed
- Denotes Catch Basin
- Denotes Coniferous Tree
- Denotes Deciduous Tree
- Denotes Typical Spot Elevation
- Denotes Utility Pole
- Denotes Water Service

Table of Tree Descriptions


Tag #	Species	Diameter
#242	Deciduous	60cm
#252	Deciduous	45cm
#253	Deciduous	50cm
#254	Deciduous	30cm
#285	Cedar	40cm
#286	Cedar	40cm
#287	Deciduous	30cm (Twin)
#288	Cedar	30cm (Twin)
#289	Cedar	30cm
#290	Cedar	45cm (Twin)
No tag	Monkey	30cm
No tag	Fruit	25cm
No tag	Deciduous	10cm
No tag	Deciduous	10cm
No tag	Cherry	25cm
No tag	Cherry	45cm
No tag	Pine	25cm

Legal boundaries are derived from field survey
Distances and elevations are in metres.
Elevations are geodetic based on control monument 9-68.
Elevations are at grade unless noted otherwise.
Building dimensions and offsets to property lines are shown to exterior of building walls.

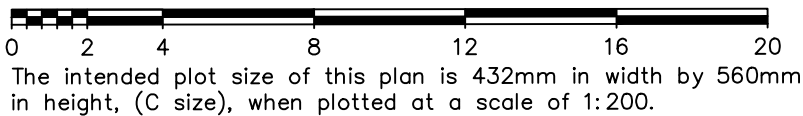

FOR DEVELOPMENT APPLICATION ONLY

This sketch does not constitute a redefinition of the legal boundaries hereon described and is not to be used in any matter which would assume same.
J.E. Anderson & Associates accepts no responsibility or liability for any damages that may be suffered by a third party as a result of any decision made, or actions taken based on this document.
Subject to charges, legal notations, and interests shown on: Title No. ET59777 (P.I.D. 008-292-345) Lot 13
Title No. CA6094211 (P.I.D. 005-209-510) Lot 35
V:_Projects\31517\08\02\Microsurvey\31517.dwg

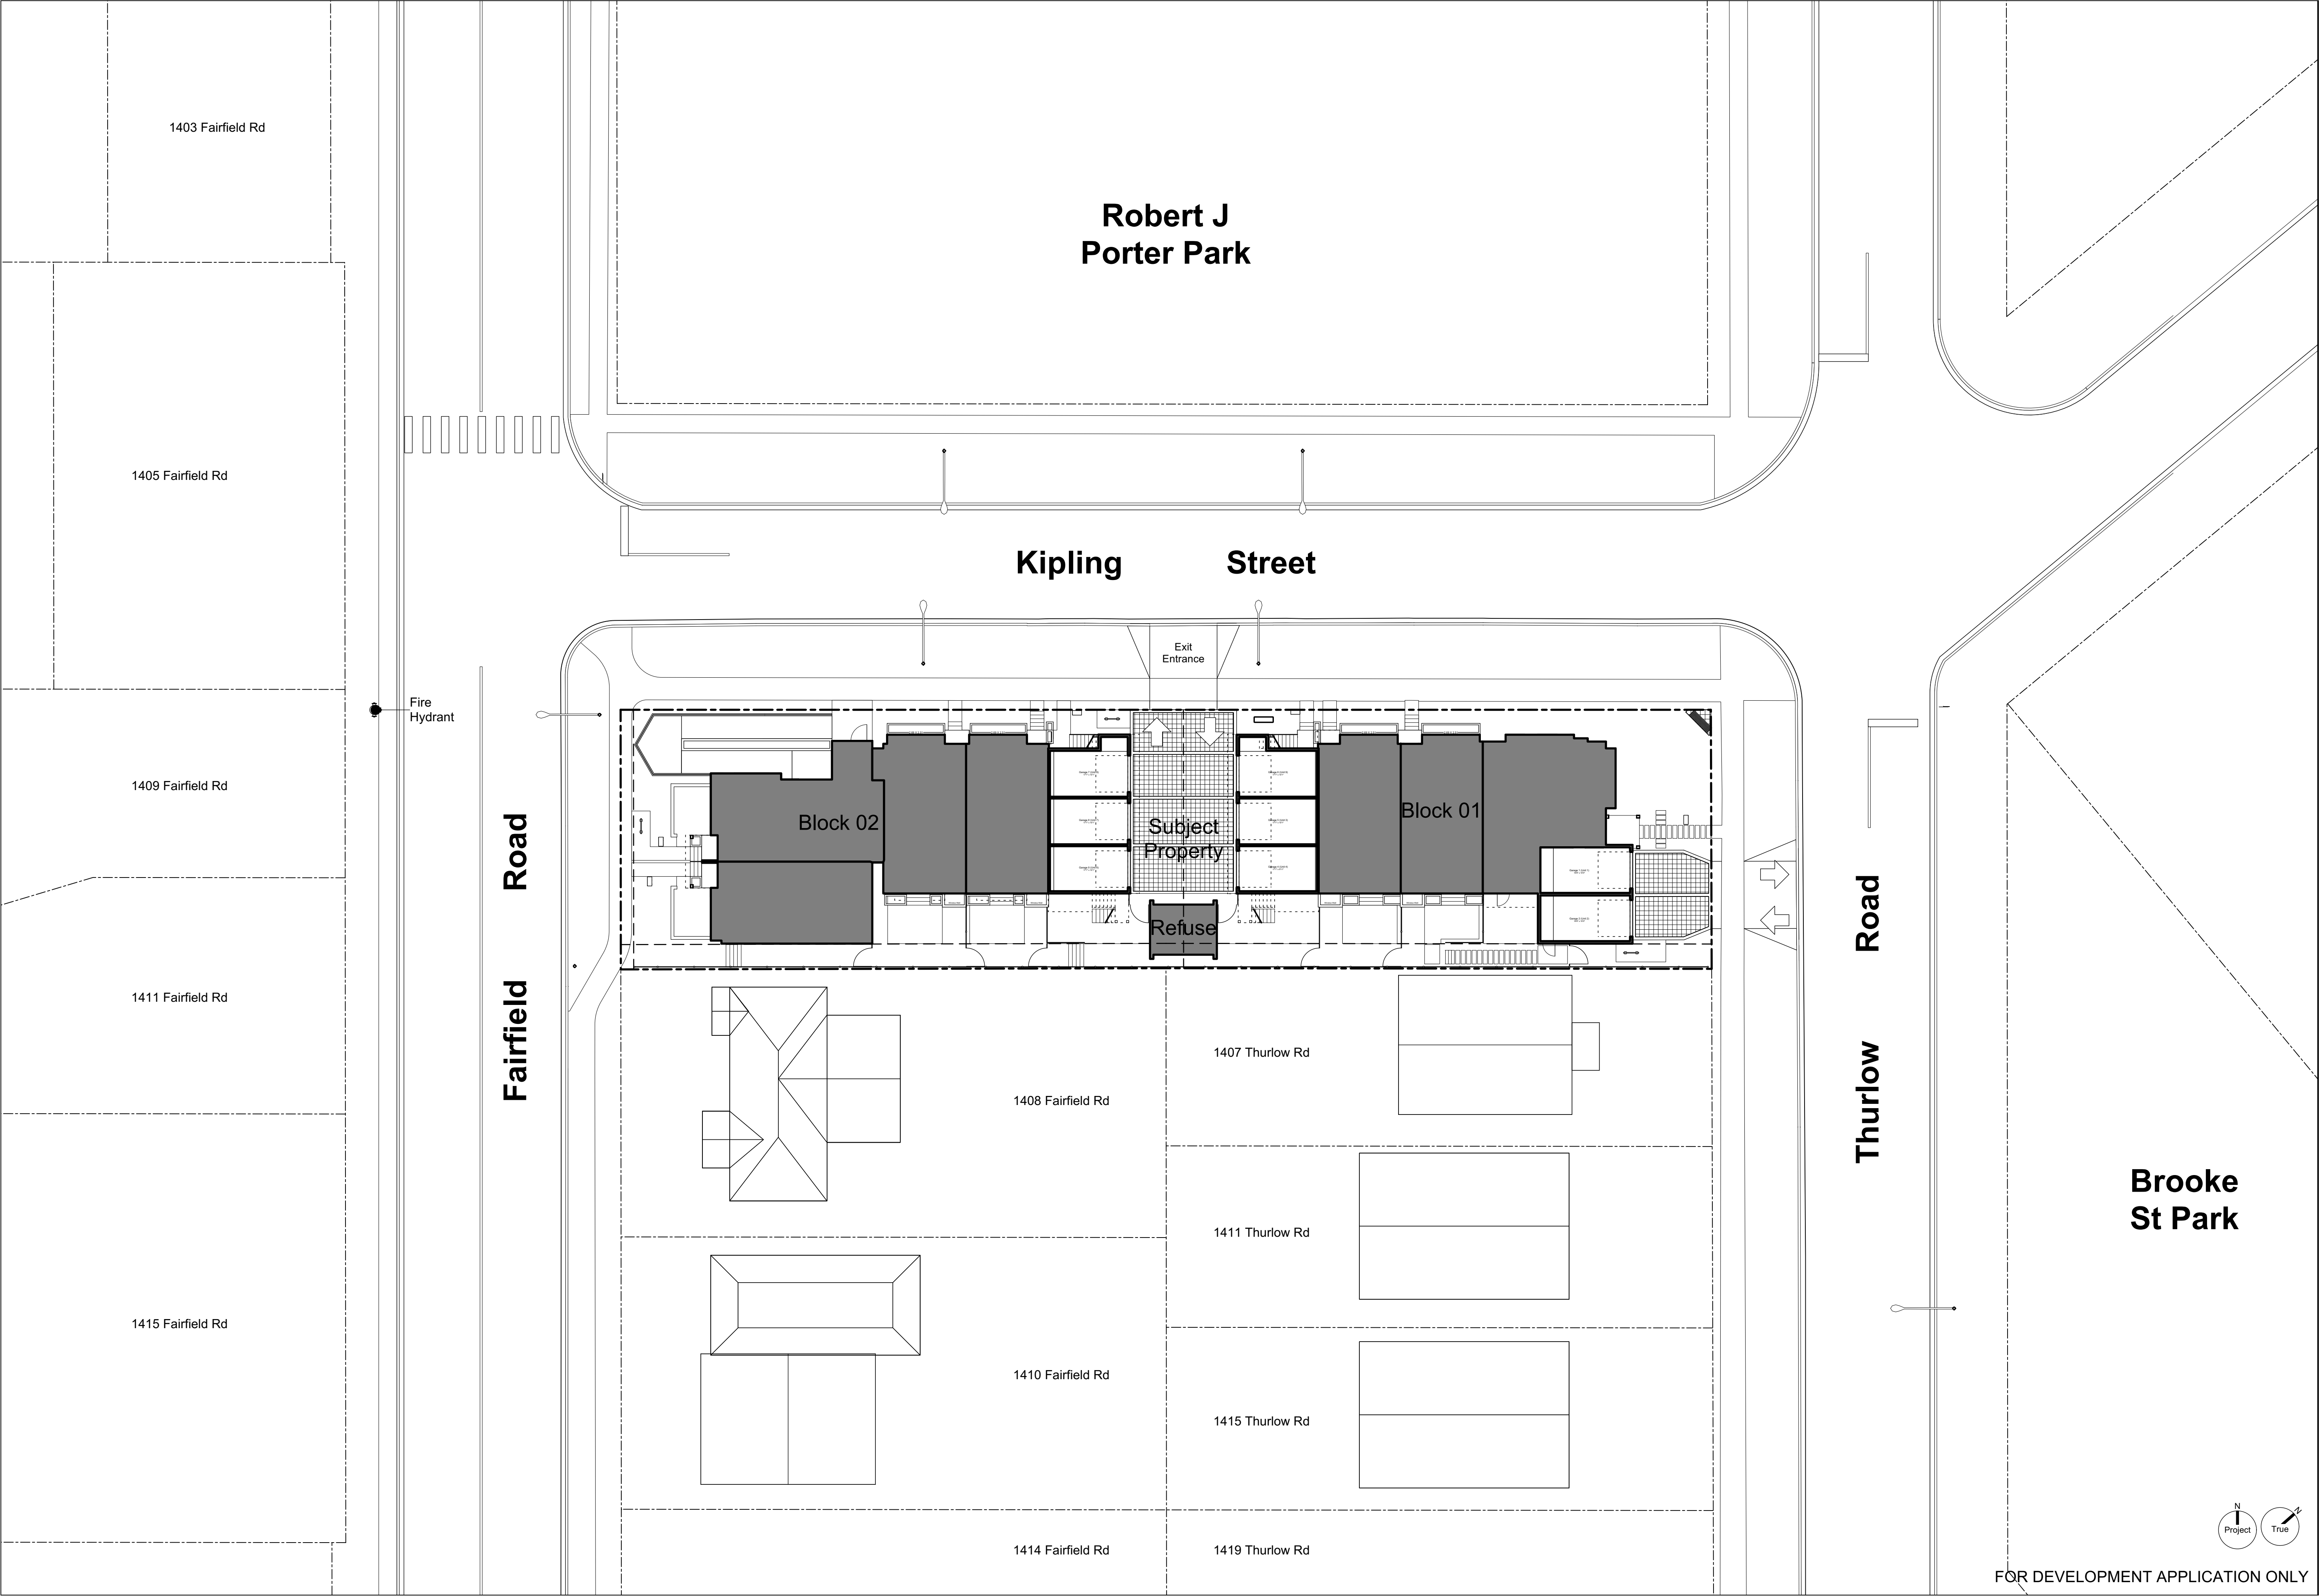

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Context Plan

Project Name:

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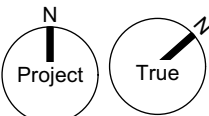
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Plot Date: Nov 29, 2022


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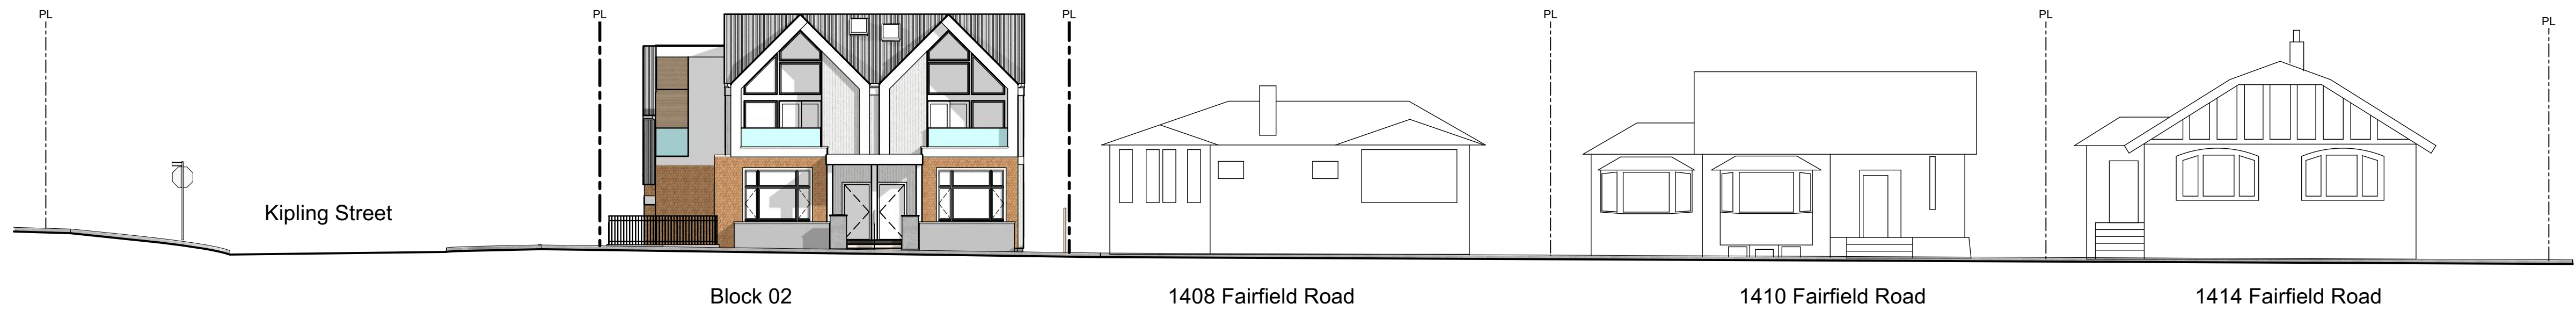


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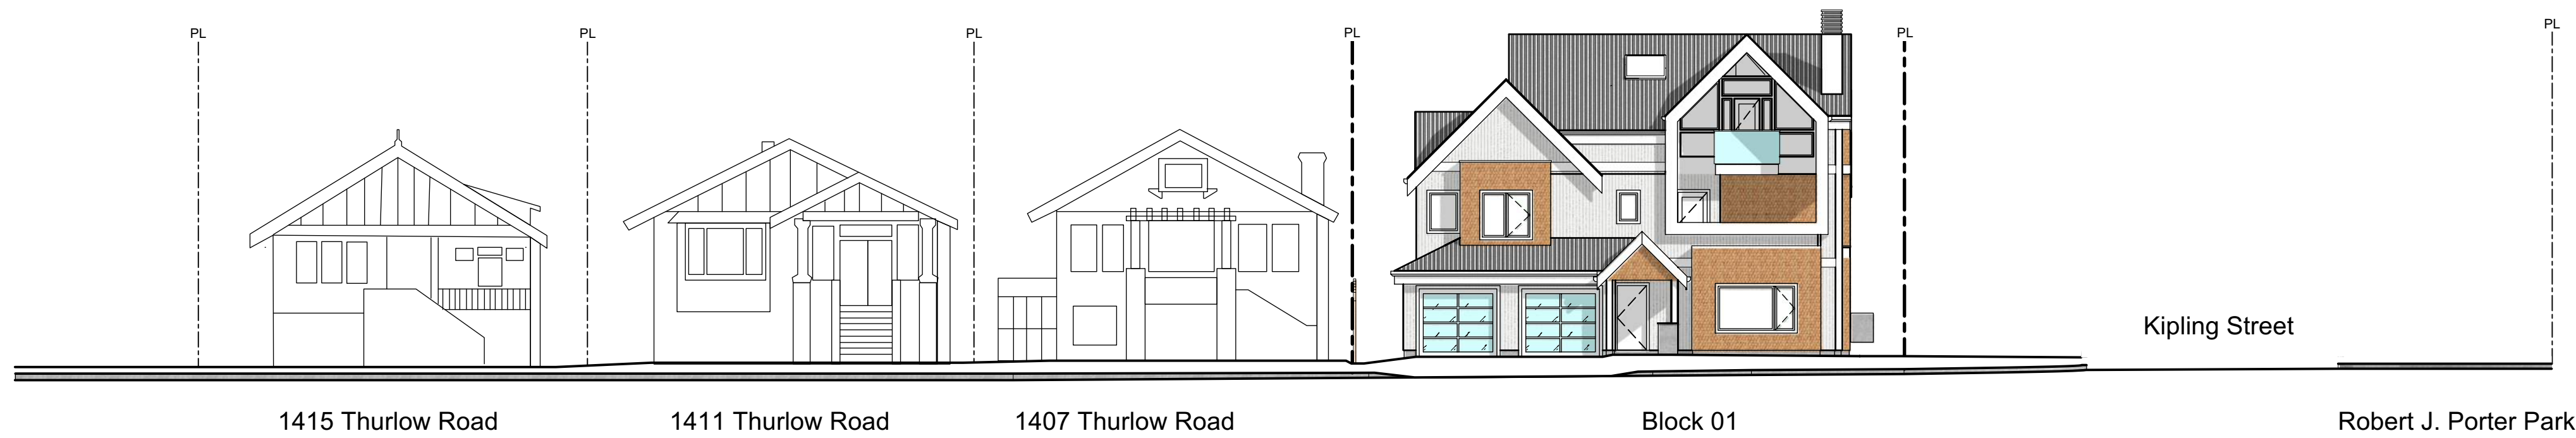
Brooke St. Park



1 Streetscape Kipling Street
Scale: 1:150

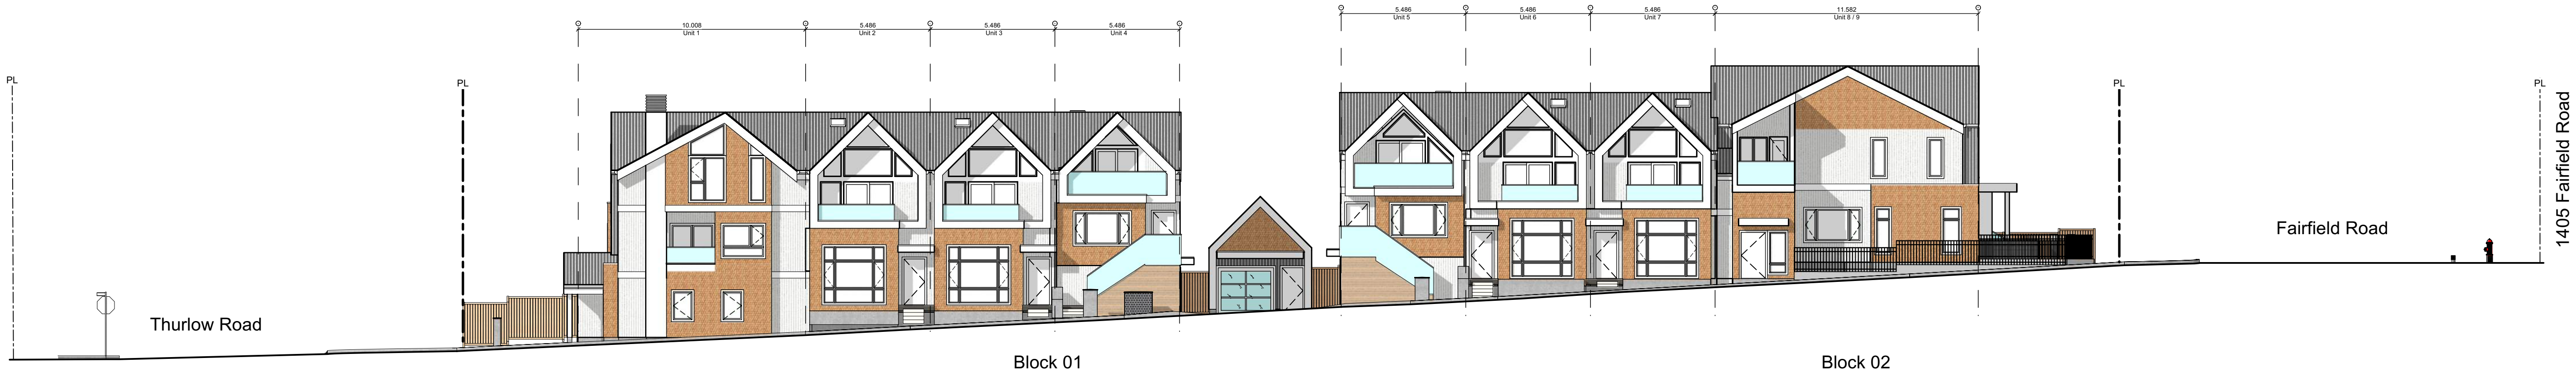

2 Streetscape Fairfield Road
Scale: 1:150



3 Streetscape Thurlow Road
Scale: 1:150

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Context Streetscape

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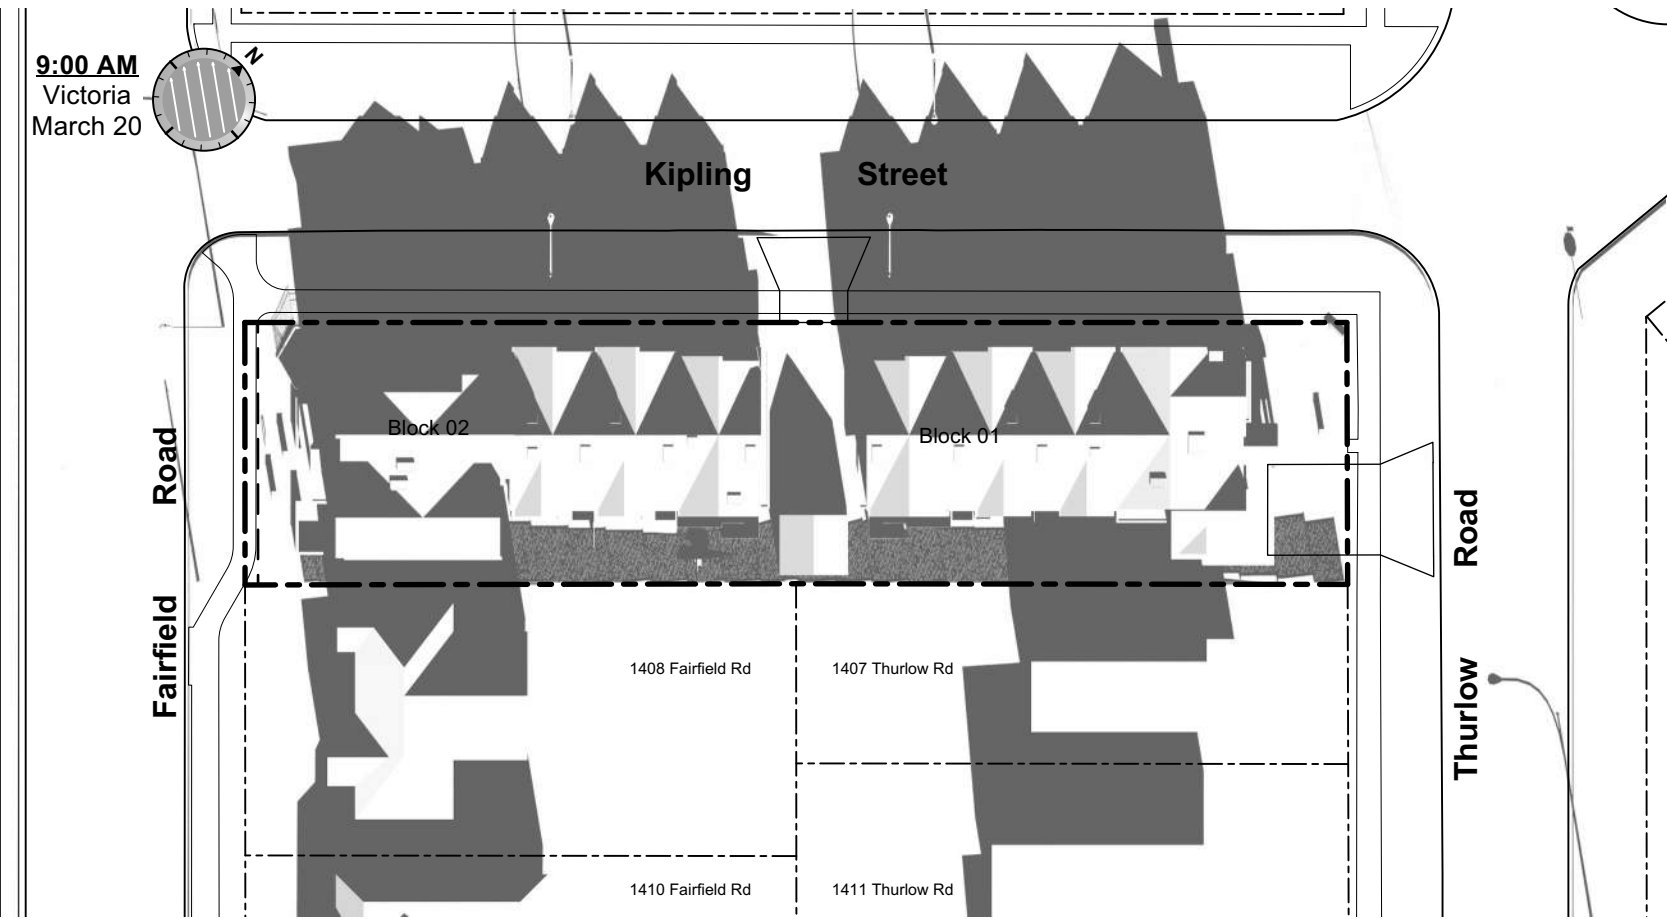
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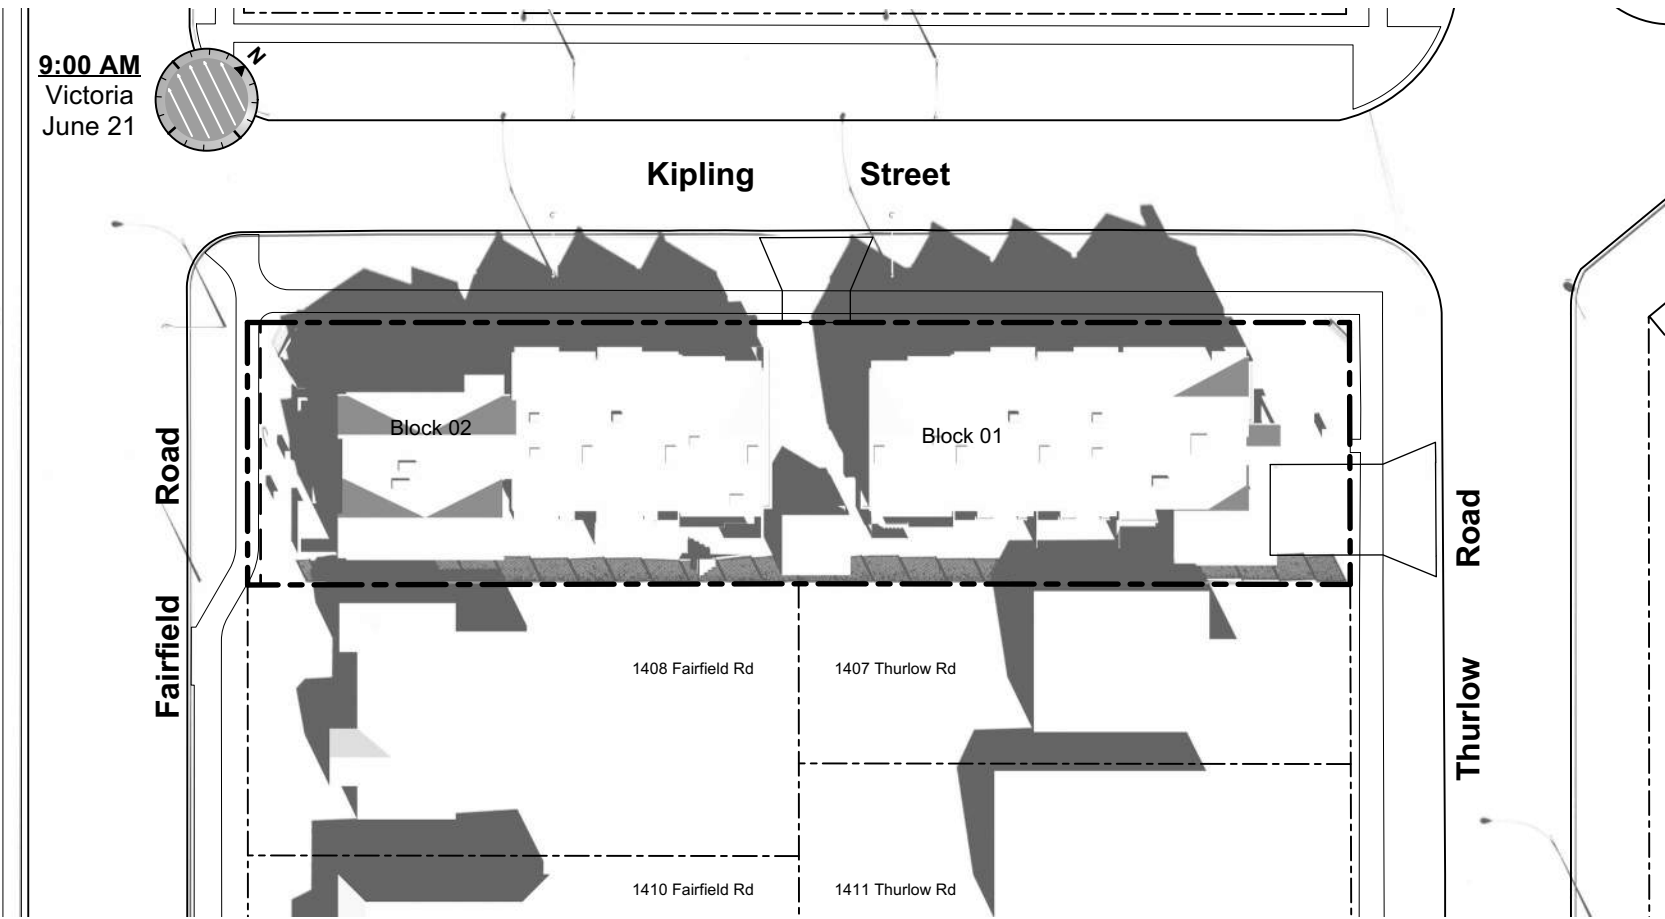
A1.3

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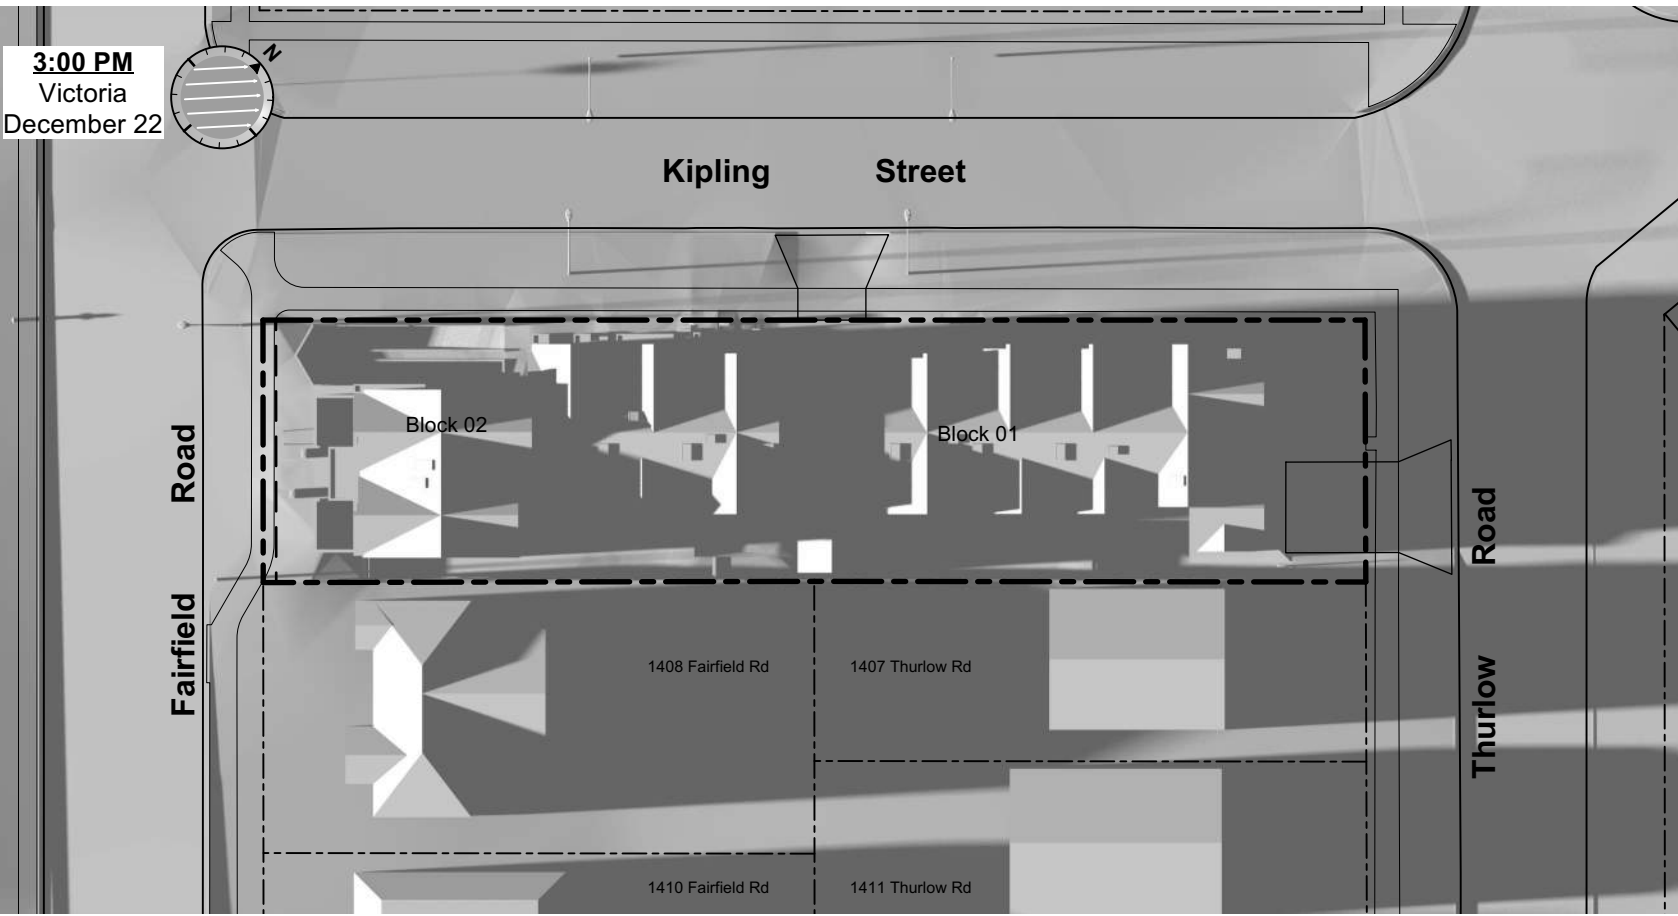
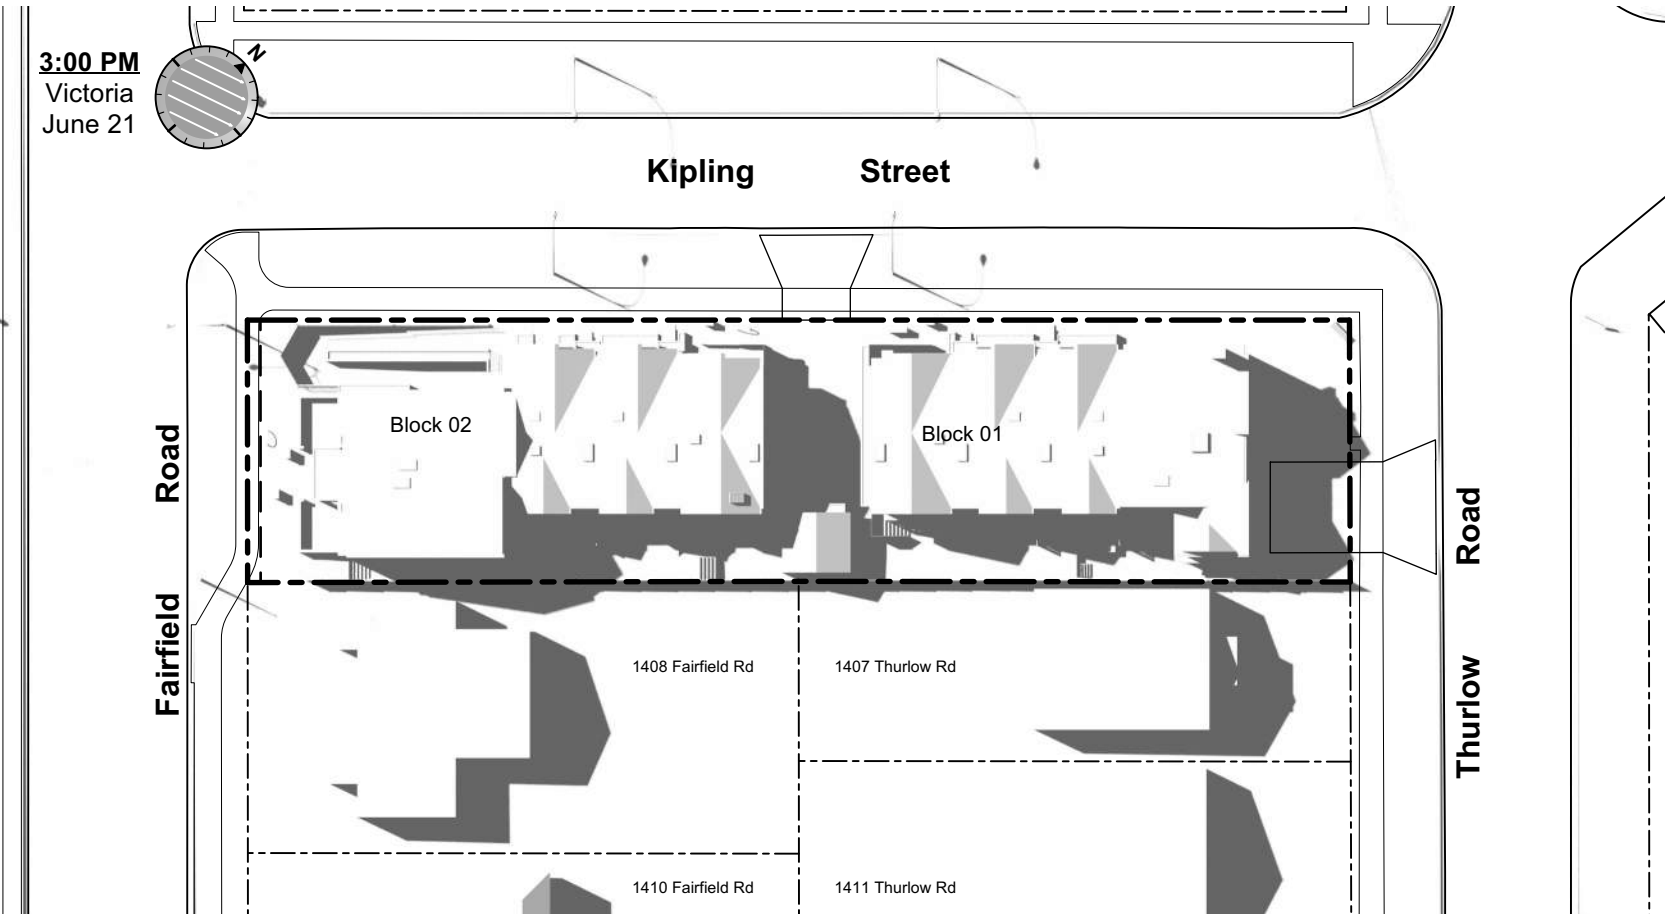
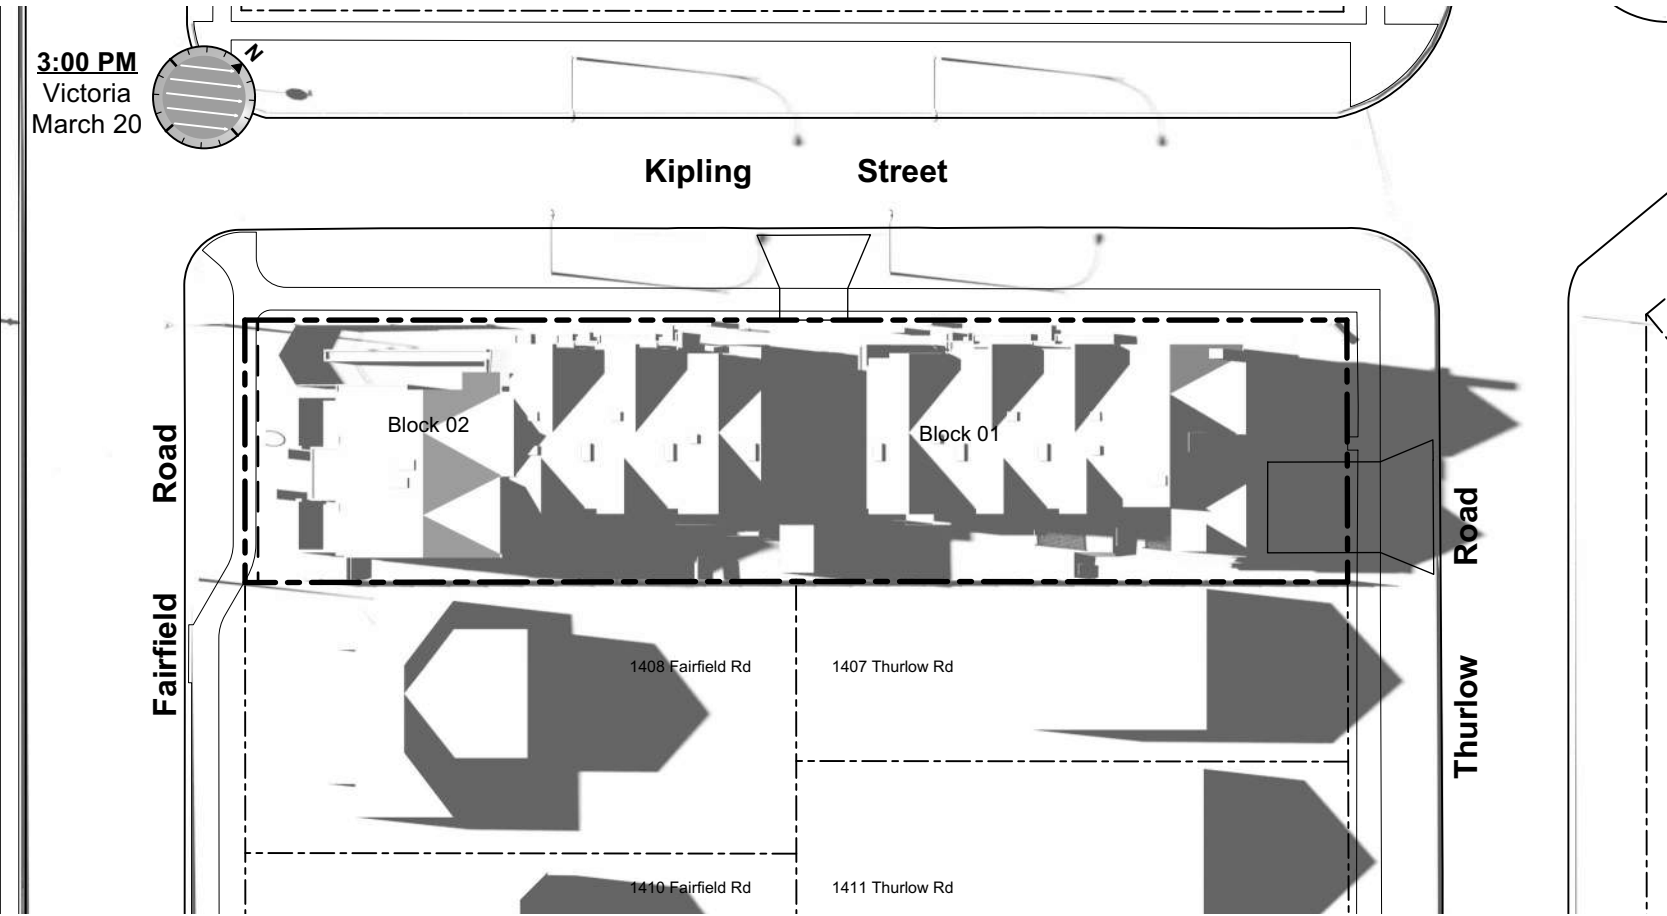
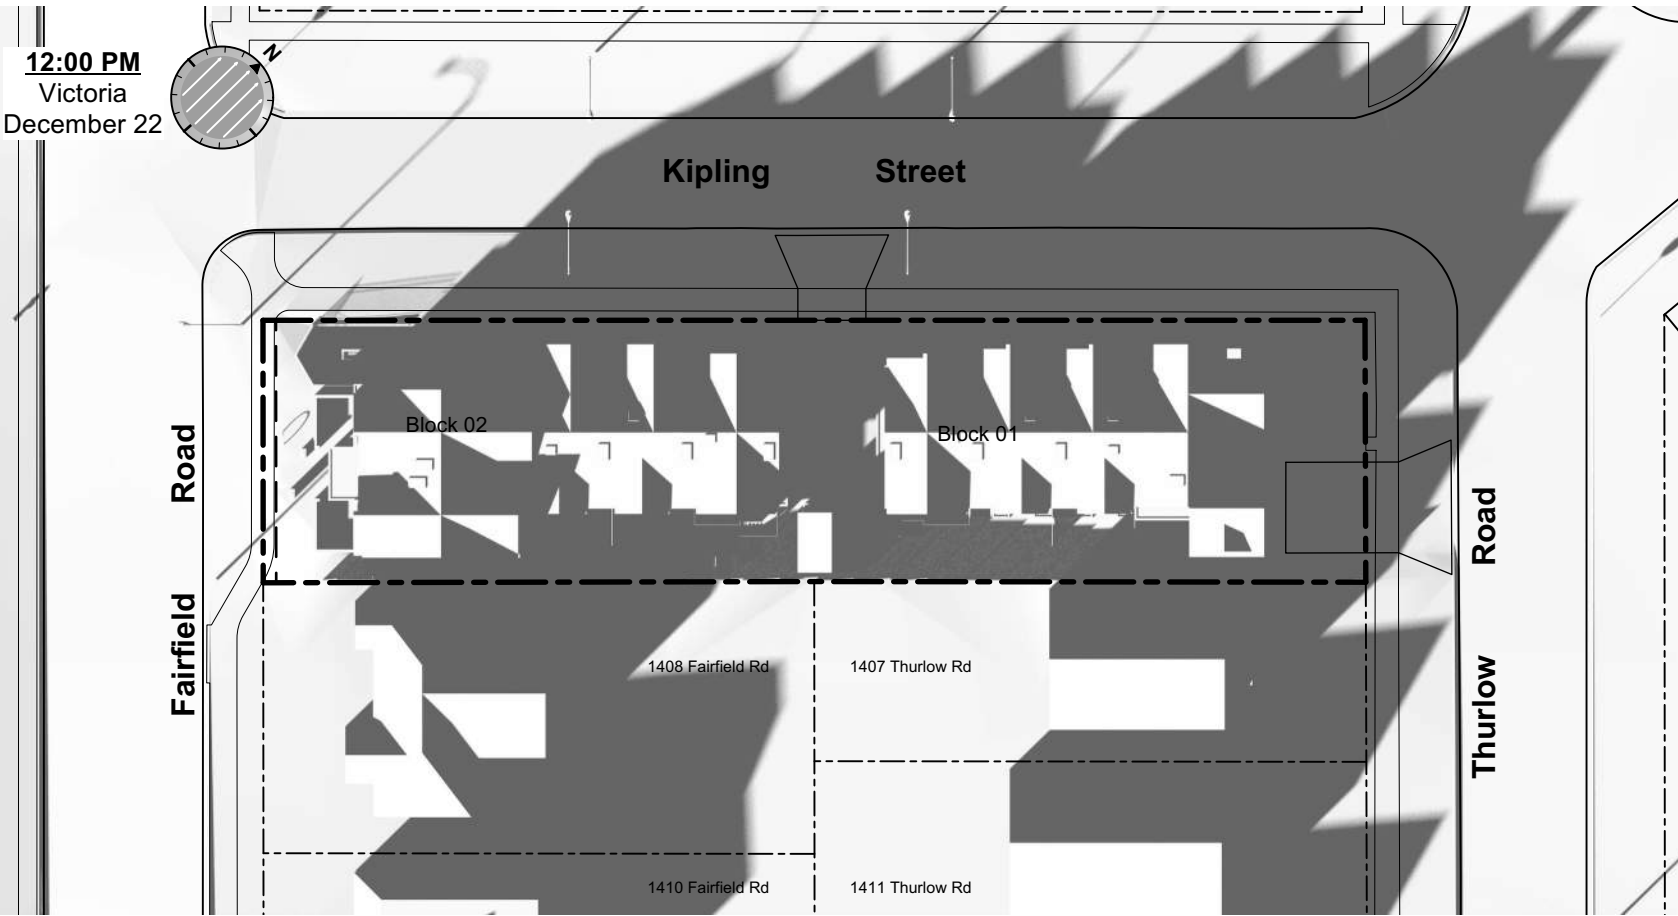
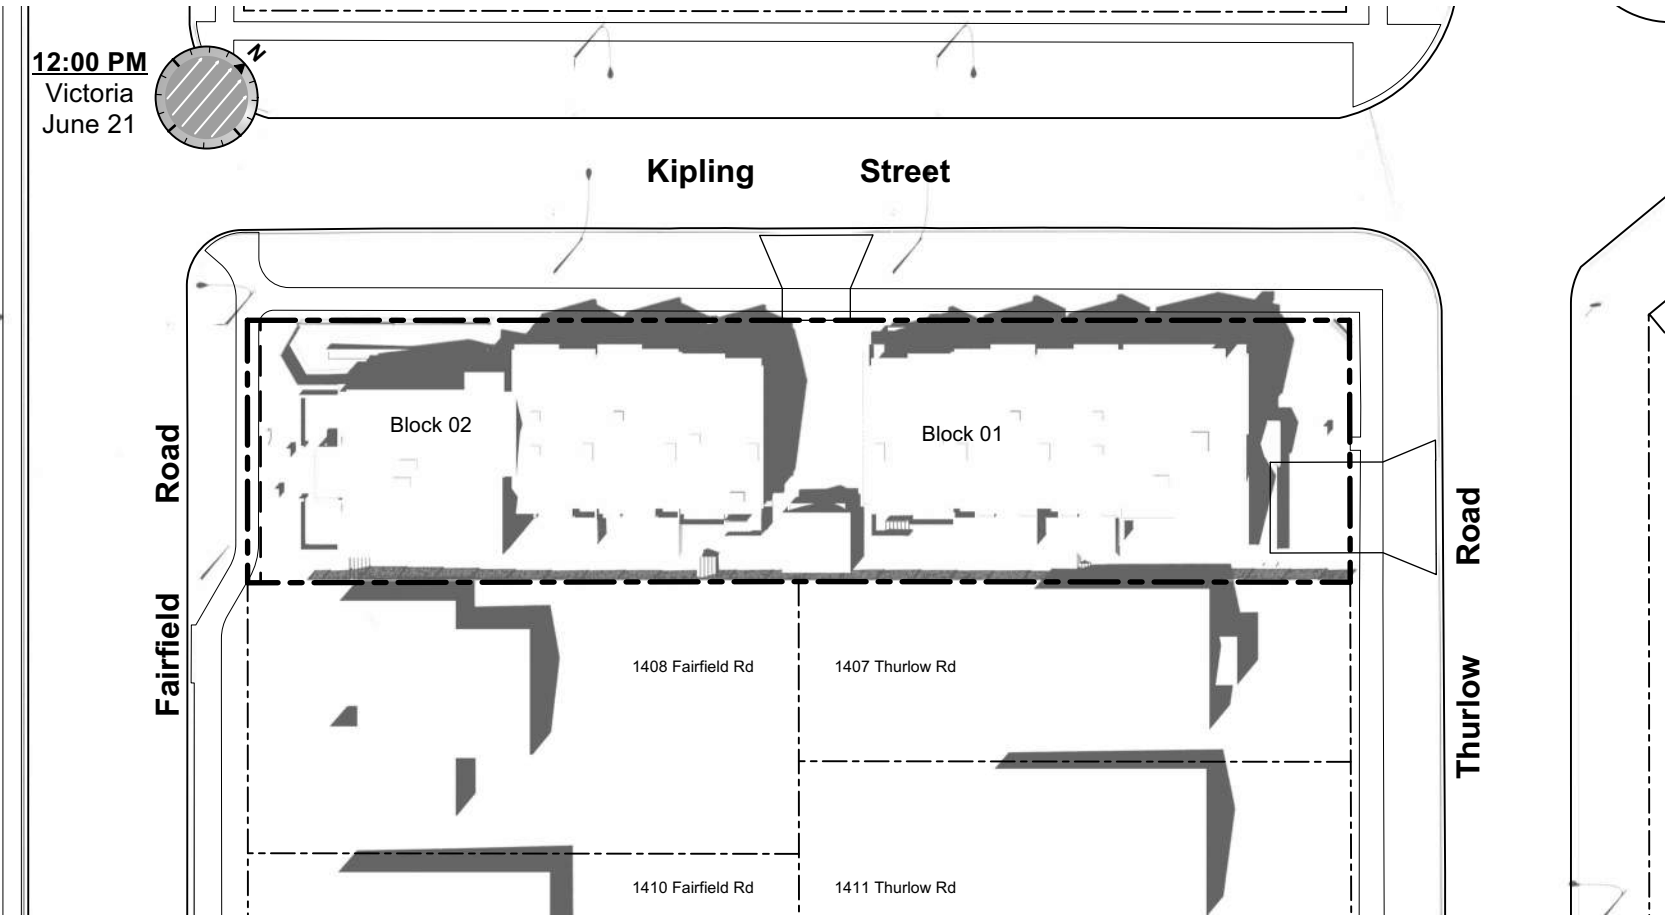
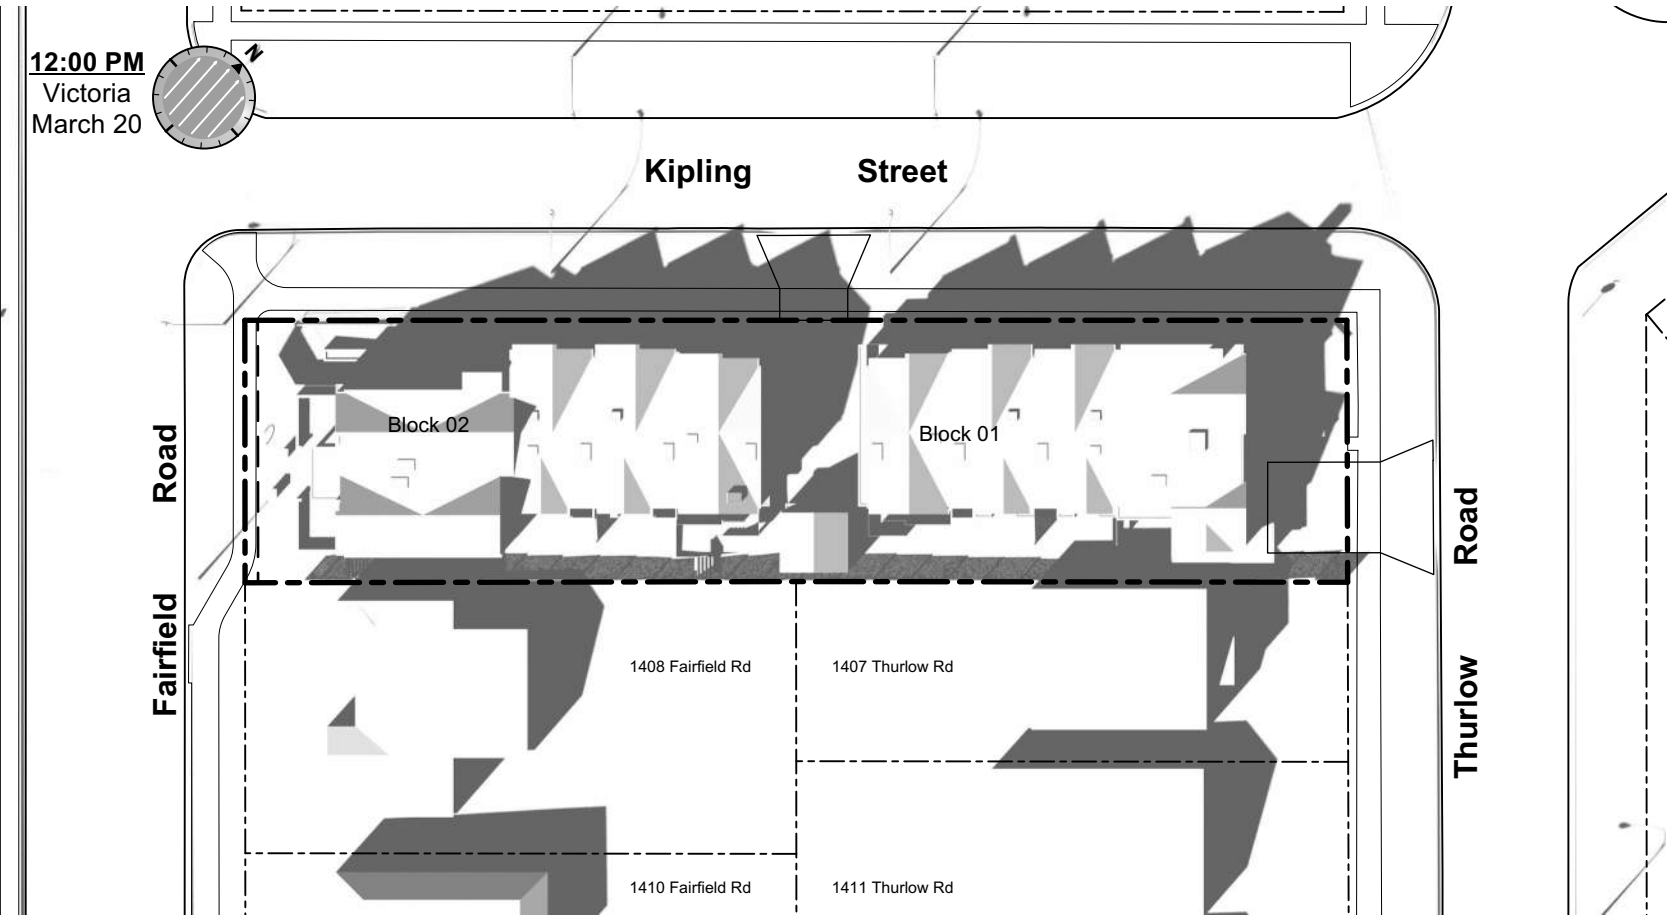
March Equinox



June Solstice



December Solstice



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Project Name:

**Fairfield-Kipling
Development**

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349 Kipling St

Legal:

PID:

Project No: 19.015

Drawn By: SG/TD

Plot Date: Nov 29, 2022

Scale: (1:120) 1" = 10'-0"

Sheet No:

Solar Study



- Legend
- | No. | Description |
|-----|--|
| 1 | Ready for solar panels (rough-in) |
| 2 | Ready for electric car charging outlets (rough-in) |
| 3 | Water efficient landscaping |
| 4 | Enhanced Bike Parking |
| 5 | Enhanced natural light |
| 6 | Energy efficient light fixtures |
| 7 | Water efficient plumbing fixtures |
| 8 | Low-VOC interior finishes |

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Sustainability Strategy

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Fairfield-Kipling
Development

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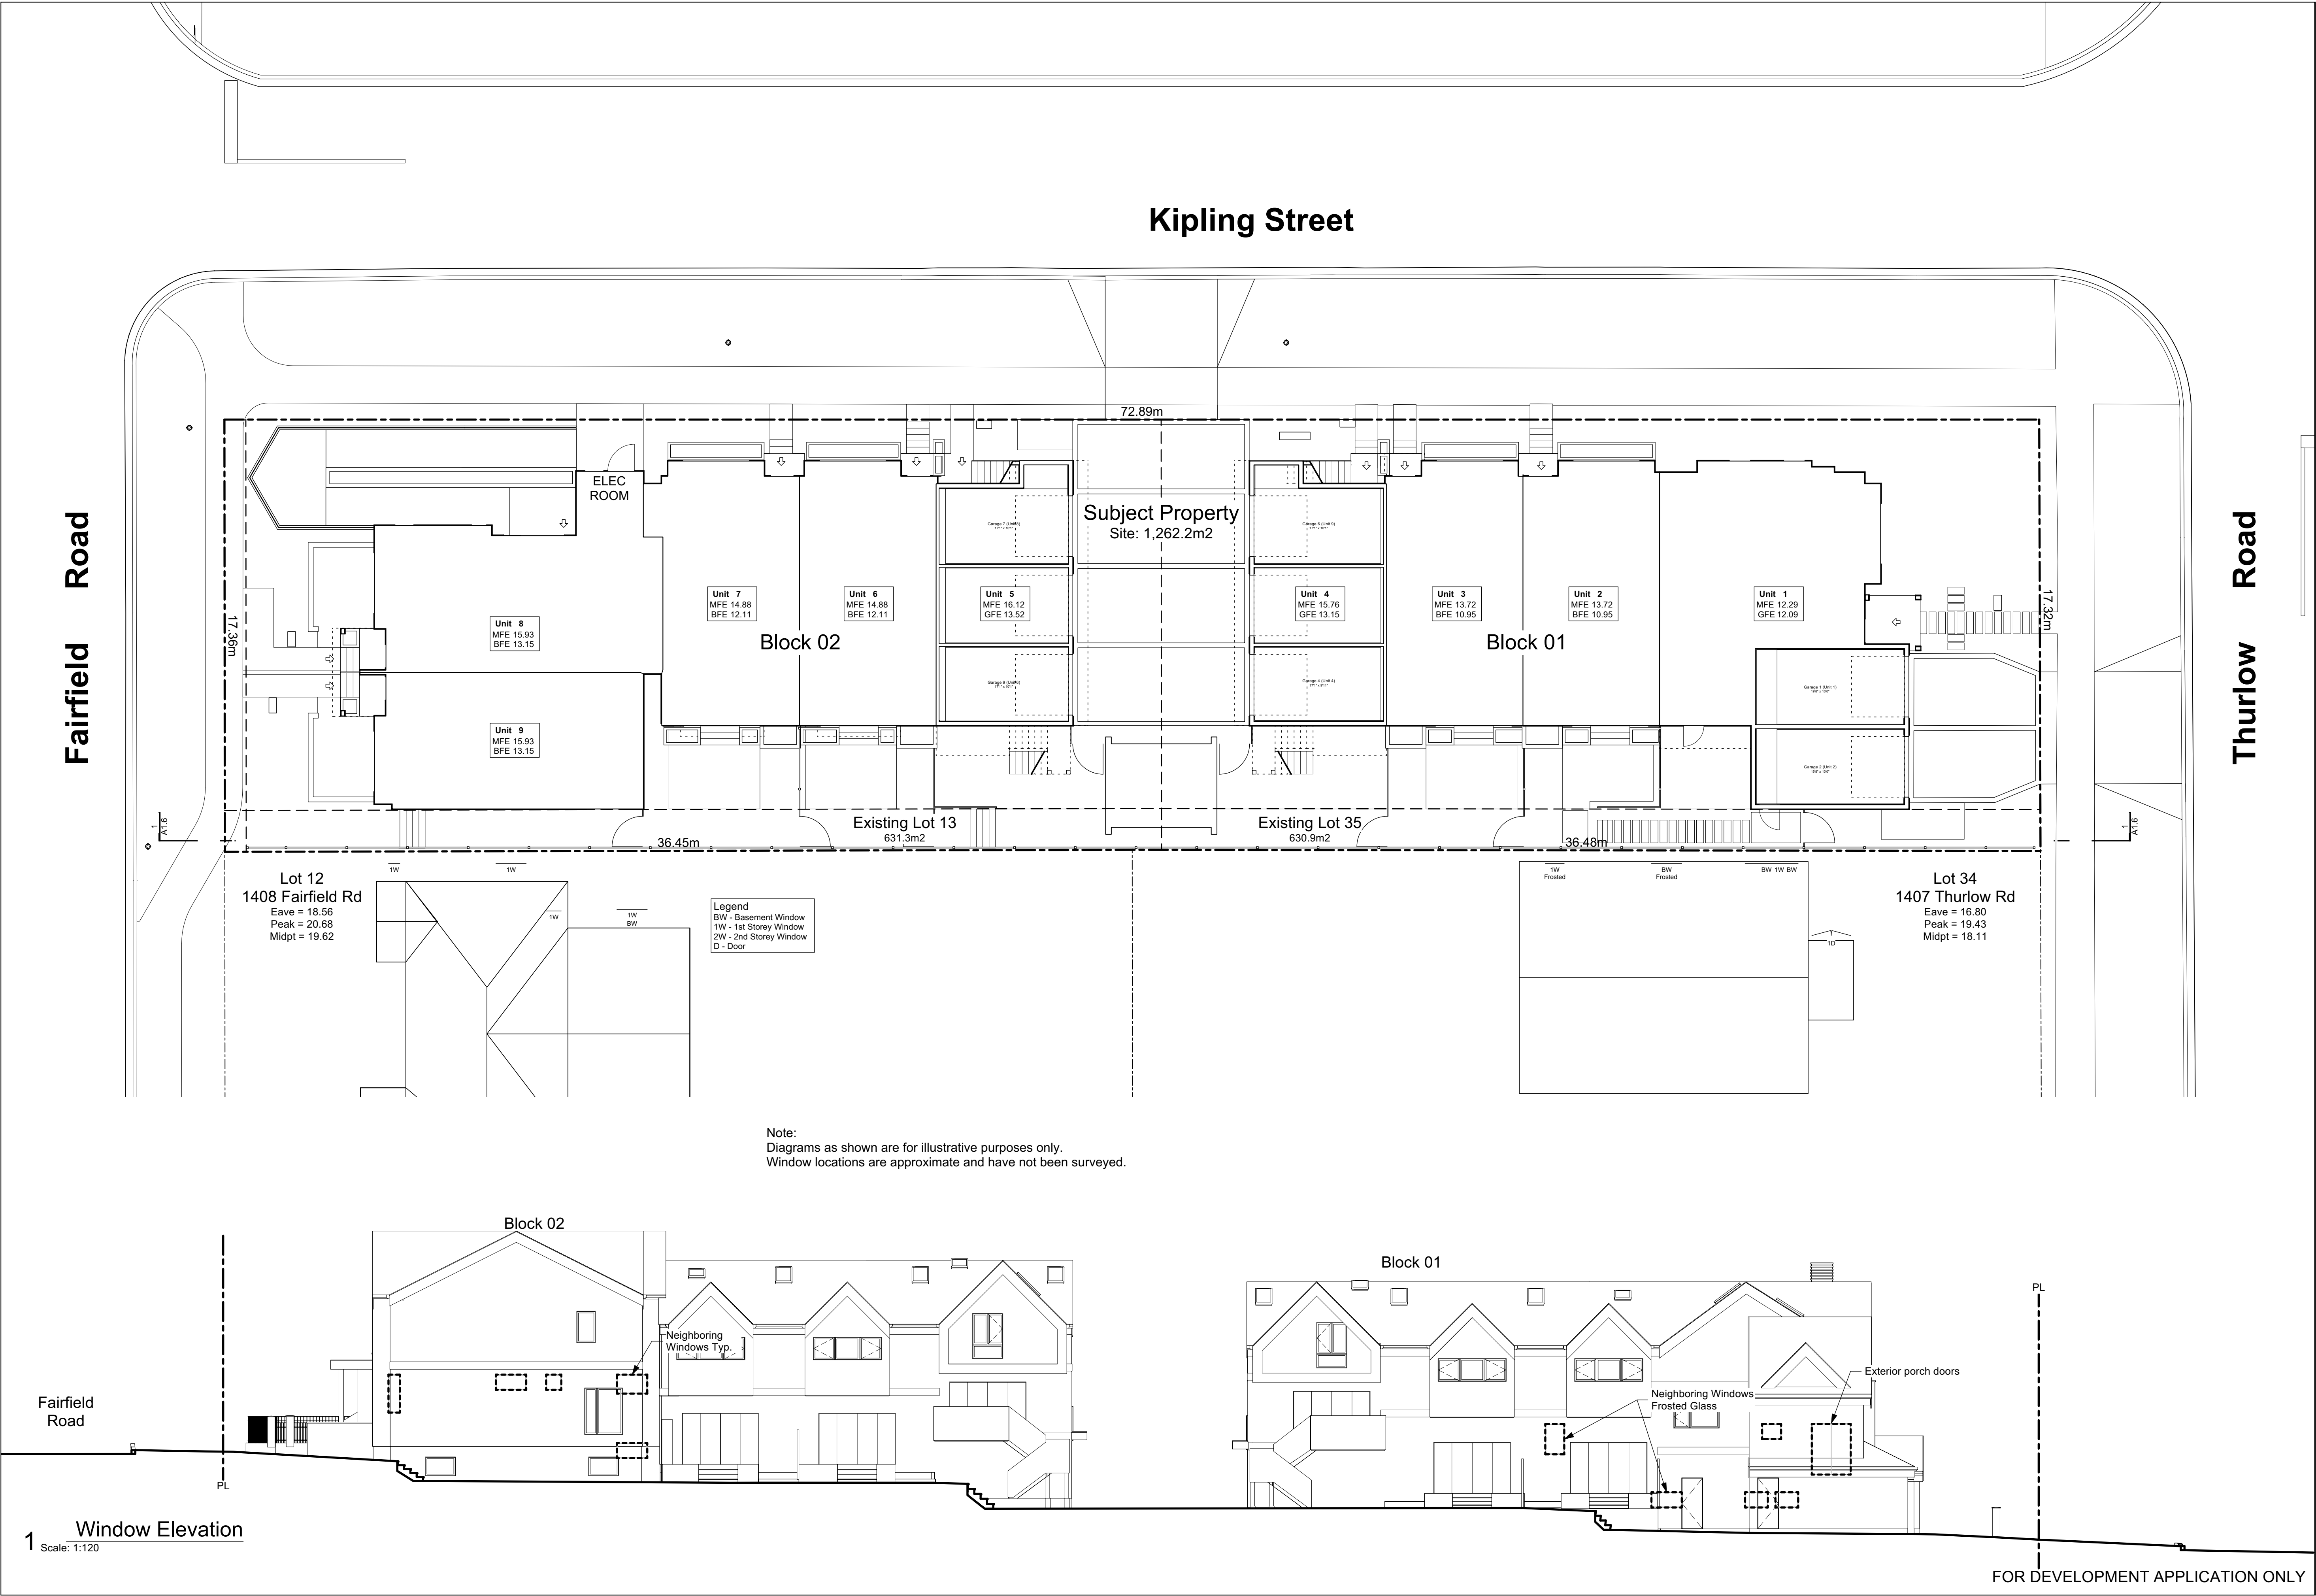
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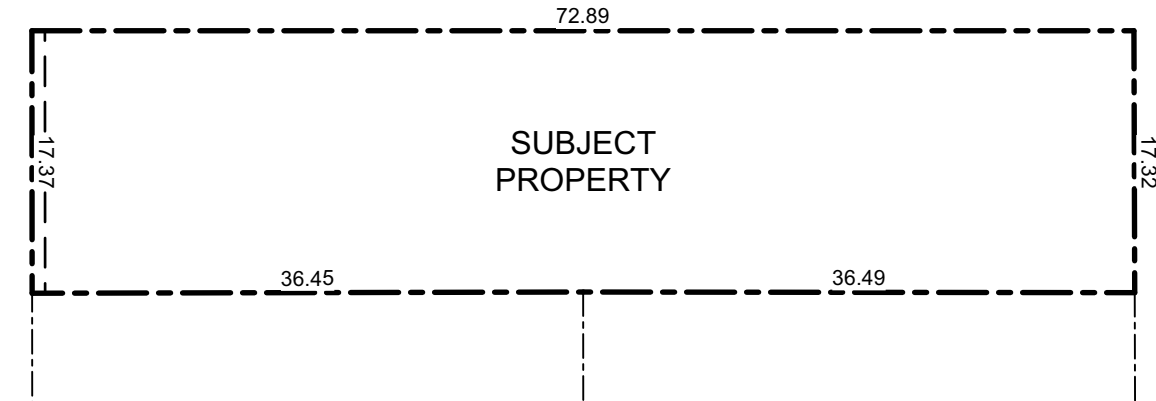
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Neighbouring
Window Overlay

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1 Proposed Consolidated Lot
Scale: 1:500

Existing Tree Schedule

See Arborist Report Prepared by Talbot Mackenzie & Associates:

Tag	Name	Action	DBH (cm)	Spread (m)
695	Apple	Remove	4.0	3.5
799	Monkey Puzzle	Remove	31.0	5.0
800	Blue Spruce	Remove	25.0	5.0
898	Western Red Cedar	Remove	42.0	5.0
903	Western Red Cedar	Remove	42.0	4.0
912	Big Leaf Maple	Remove	46.0	12.0
913	Western Red Cedar	Remove	37.0	5.0
914	Western Red Cedar	Remove	33.0	4.0
915	Western Red Cedar	Remove	51.0	10.0
916	Ash	Remove	55.0	14.0
NT1	Japanese Cherry	Remove	48.0	8.0
NT3	Ginkgo	Retain	7.0	2.0
NT4	Ash	Remove	3.0	1.0
NT5	Red Maple	Retain	8.0	2.0
NT6	Scarlet Oak	Remove	4.0	2.0
NT7	Red Maple	Retain	47.0	10.0
NT8	Red Maple	Retain	49.0	10.0
NT9	Japanese Cherry	Retain	30.0	5.0
NT2	Cherry Plum	Removed by City	28.0	3.0

Project Data

	GFA Area (SF)	Zoning Area (SF)	Habitable Half Storey	Site Area (SF)	FAR	Bedrms
Block 01 (Unit 1-4)						
Thurlow Cluster	8,598	5,558		6,791	0.81	11
Basement	1,239	0				
Main Floor	3,270	2,042				
Second Floor	2,615	2,476				
Half Storey	1,473	1,039	50.9% = (Half Storey / Main Floor)			
Garage	679	0				
Block 02 (Unit 5-9)						
Fairfield Cluster	10,063	5,815		6,796	0.85	15
Basement	2,541	0				
Main Floor	3,370	2,526				
Second Floor	2,950	2,822				
Half Storey	518	467	18.5% = (Half Storey / Main Floor)			
Garage	685	0				
Refuse	143	0				
Electrical Room	74	74				
Total	18,803	11,447		13,587	0.84	

Zoning Reconciliation

Lot Description	Property 1	Property 2	
Civic Address:	1400 Fairfield Rd.	349 Kipling St.	
Legal Address:	Lot 13 Plan 884 Section Fld Victoria R1-B	Lot 35 Fairfield Farm Estate Victoria VIP884 R1-B	
Existing Zoning:			
Site Area:	631.3 M2	630.9 M2	Total: 1262.3 M2
FSR			Proposed: 0.84
Block 01	Theoretical Site	631.3 M2	4 Units
Block 02	Theoretical Site	630.9 M2	5 Units
Site Open Space			39.3% 495.23 M2
Block 01	Theoretical Site	631.3 M2	17.4% 218.39 M2
Block 02	Theoretical Site	630.9 M2	22.0% 276.83 M2
Lot Coverage			51.1% 644.79 M2
Block 01	Theoretical Site	631.3 M2	24.3% 306.56 M2
Block 02	Theoretical Site	630.9 M2	25.6% 322.98 M2
Refuse	Full Site	1262.3 M2	1.3% 15.24 M2
Setbacks			Proposed
Side Yard Corner Lot (Kipling St.)			1.67 m 5.48 FT
Front Yard (Fairfield Rd.)			4.65 m 15.26 FT
Rear Yard (Thurlow Rd.)			4.80 m 15.75 FT
Interior Side Yard			1.66 m 5.45 FT
Building Height	Maximum		Proposed
Block 01	8.30 m	2.5 Stories	8.27 m 2.5 Stories
Block 02	10.50 m	2.5 Stories	8.94 m 2.5 Stories
Vehicle Parking	Required:	9.9 stalls	Proposed: 8 stalls
Dwelling Unit < 45m2	0.85 / Unit	0.0 stalls	0 stalls
Dwelling Unit 45m2 - 70m2	1.00 / Unit	0.0 stalls	0 stalls
Dwelling Unit > 70m2	1.45 / Unit	** 9.00 stalls	8 stalls
Visitor	0.10 / Unit	0.90 stalls	0 stalls
** In line with attached dwelling parking requirements of 1.0 stall per dwelling unit			
Bicycle Parking	Required:	17 stalls	Proposed: 40 stalls
Long Term	1.25 / Unit	11 stalls	34 stalls
Short Term		6 stalls	6 stalls


Kipling Street

Fairfield Road

Thurlow Road

2 Site Plan

Scale: 1:120

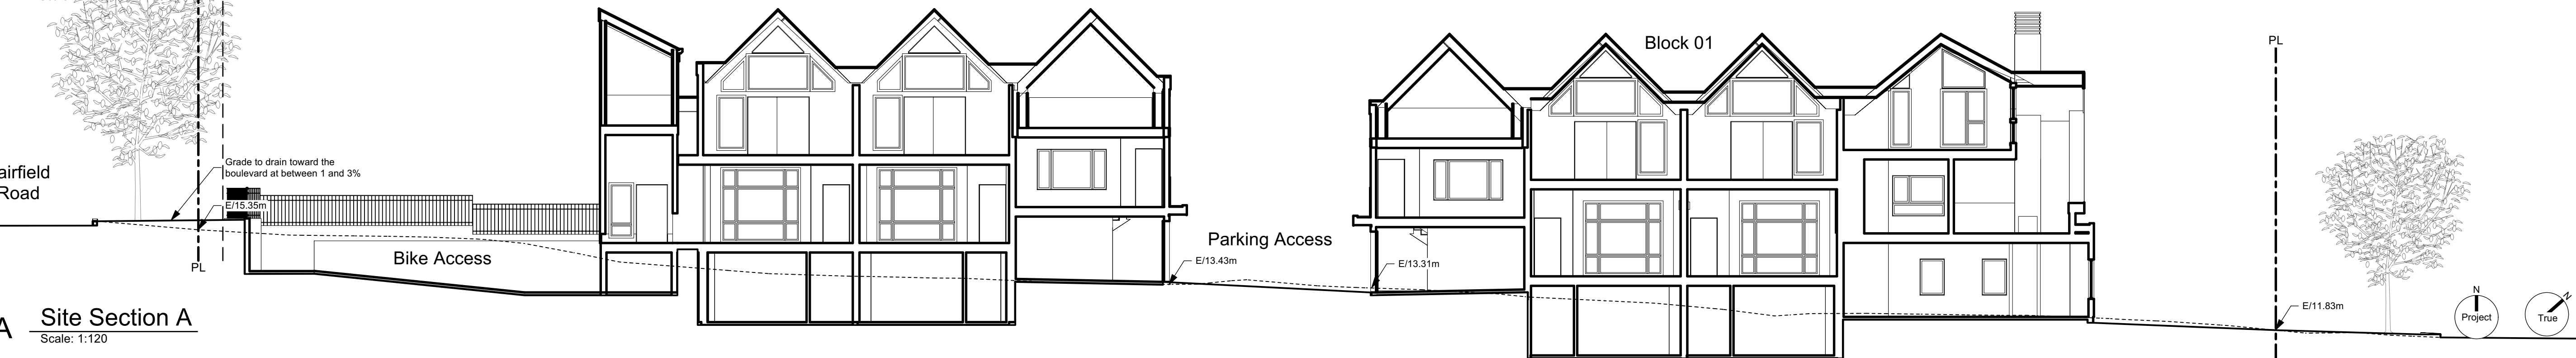

A Site Section A
Scale: 1:120

Floor Area Calculations Unit 1				
	Gross Floor Area	Zoning Floor Area	Bedrms	
Basement Floor	No Basement as per zoning definition			
Main Floor	1,243 sq ft	115.5 m2	801 sq ft	74.4 m2
Second Floor	873 sq ft	81.1 m2	813 sq ft	75.5 m2
Half Storey	955 sq ft	88.8 m2	579 sq ft	53.8 m2
Totals:	3,072 sq ft	285.4 m2	2,193 sq ft	203.7 m2
Garage	168 sq ft	15.7 m2		

Floor Area Calculations Unit 2				
	Gross Floor Area	Zoning Floor Area	Bedrms	
Basement Floor	622 sq ft	57.8 m2	0 sq ft	0.0 m2
Main Floor	617 sq ft	57.3 m2	629 sq ft	58.5 m2
Second Floor	589 sq ft	54.8 m2	568 sq ft	52.8 m2
Half Storey				
Totals:	1,828 sq ft	169.9 m2	1,198 sq ft	111.3 m2
Garage	168 sq ft	15.7 m2		

Floor Area Calculations Unit 3				
	Gross Floor Area	Zoning Floor Area	Bedrms	
Basement Floor	617 sq ft	57.3 m2	0 sq ft	0.0 m2
Main Floor	616 sq ft	57.3 m2	605 sq ft	56.2 m2
Second Floor	589 sq ft	54.8 m2	568 sq ft	52.8 m2
Half Storey				
Totals:	1,823 sq ft	169.3 m2	1,173 sq ft	109.0 m2
Garage	172 sq ft	16.0 m2		

Floor Area Calculations Unit 4				
	Gross Floor Area	Zoning Floor Area	Bedrms	
Basement Floor	No Basement as per zoning definition			
Main Floor	794 sq ft	73.8 m2	7 sq ft	0.6 m2
Second Floor	563 sq ft	52.3 m2	527 sq ft	48.9 m2
Half Storey	518 sq ft	48.1 m2	460 sq ft	42.8 m2
Totals:	1,875 sq ft	174.2 m2	994 sq ft	92.3 m2
Garage	170 sq ft	15.8 m2		


Floor Area Calculations Unit 5				
	Gross Floor Area	Zoning Floor Area	Bedrms	
Basement Floor	No Basement as per zoning definition			
Main Floor	794 sq ft	73.7 m2	0 sq ft	0.0 m2
Second Floor	563 sq ft	52.3 m2	527 sq ft	48.9 m2
Half Storey	518 sq ft	48.1 m2	467 sq ft	43.4 m2
Totals:	1,875 sq ft	174.2 m2	994 sq ft	92.4 m2
Garage	0 sq ft	0.0 m2		

Floor Area Calculations Unit 6				
	Gross Floor Area	Zoning Floor Area	Bedrms	
Basement Floor	627 sq ft	58.3 m2	0 sq ft	0.0 m2
Main Floor	616 sq ft	57.3 m2	601 sq ft	55.9 m2
Second Floor	589 sq ft	54.8 m2	581 sq ft	53.9 m2
Half Storey				
Totals:	1,833 sq ft	170.3 m2	1,182 sq ft	109.8 m2
Garage	169 sq ft	15.7 m2		

Floor Area Calculations Unit 7				
	Gross Floor Area	Zoning Floor Area	Bedrms	
Basement Floor	619 sq ft	57.5 m2	0 sq ft	0.0 m2
Main Floor	636 sq ft	59.1 m2	621 sq ft	57.7 m2
Second Floor	589 sq ft	54.8 m2	572 sq ft	53.2 m2
Half Storey				
Totals:	1,844 sq ft	171.4 m2	1,193 sq ft	110.8 m2
Garage	172 sq ft	16.0 m2		

Floor Area Calculations Unit 8				
	Gross Floor Area	Zoning Floor Area	Bedrms	
Basement Floor	678 sq ft	63.0 m2	0 sq ft	0.0 m2
Main Floor	696 sq ft	64.7 m2	691 sq ft	64.2 m2
Second Floor	626 sq ft	58.2 m2	598 sq ft	55.6 m2
Half Storey				
Totals:	2,001 sq ft	185.9 m2	1,289 sq ft	119.8 m2
Garage	172 sq ft	16.0 m2		

Floor Area Calculations Unit 9				
	Gross Floor Area	Zoning Floor Area	Bedrms	
Basement Floor	616 sq ft	57.2 m2	0 sq ft	0.0 m2
Main Floor	627 sq ft	58.3 m2	613 sq ft	56.9 m2
Second Floor	581 sq ft	54.0 m2	544 sq ft	50.6 m2
Half Storey				
Totals:	1,825 sq ft	169.5 m2	1,157 sq ft	107.5 m2
Garage	172 sq ft	16.0 m2		

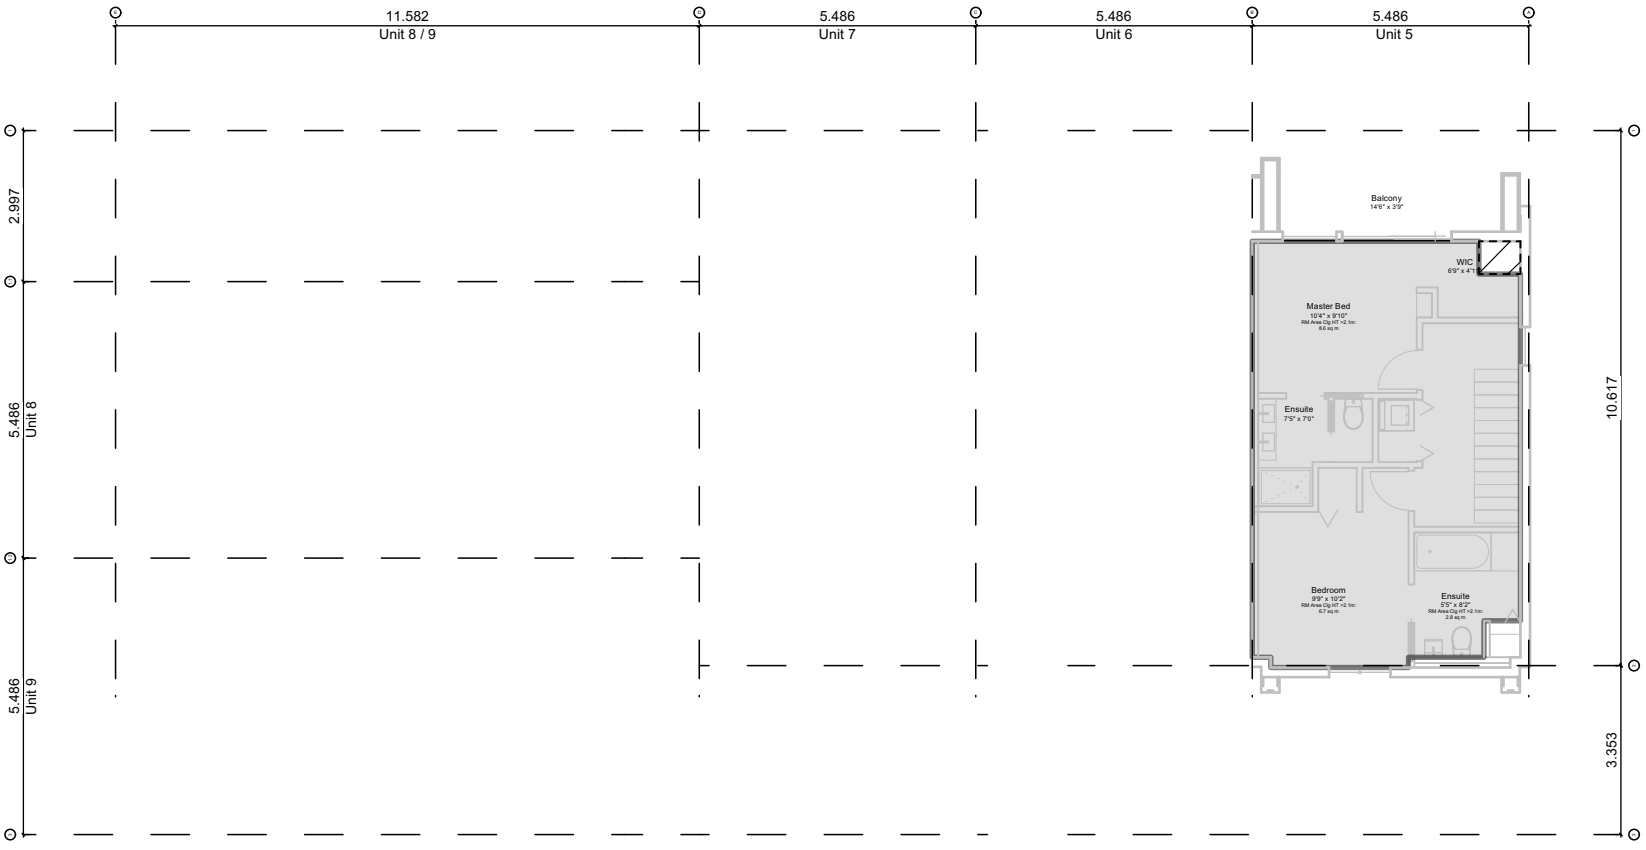


2.3 Block 02 - Floor 3 (Half Storey)
Scale: 1:150




2.2 Block 02 - Floor 2
Scale: 1:150



2.1 Block 02 - Floor 1
Scale: 1:150

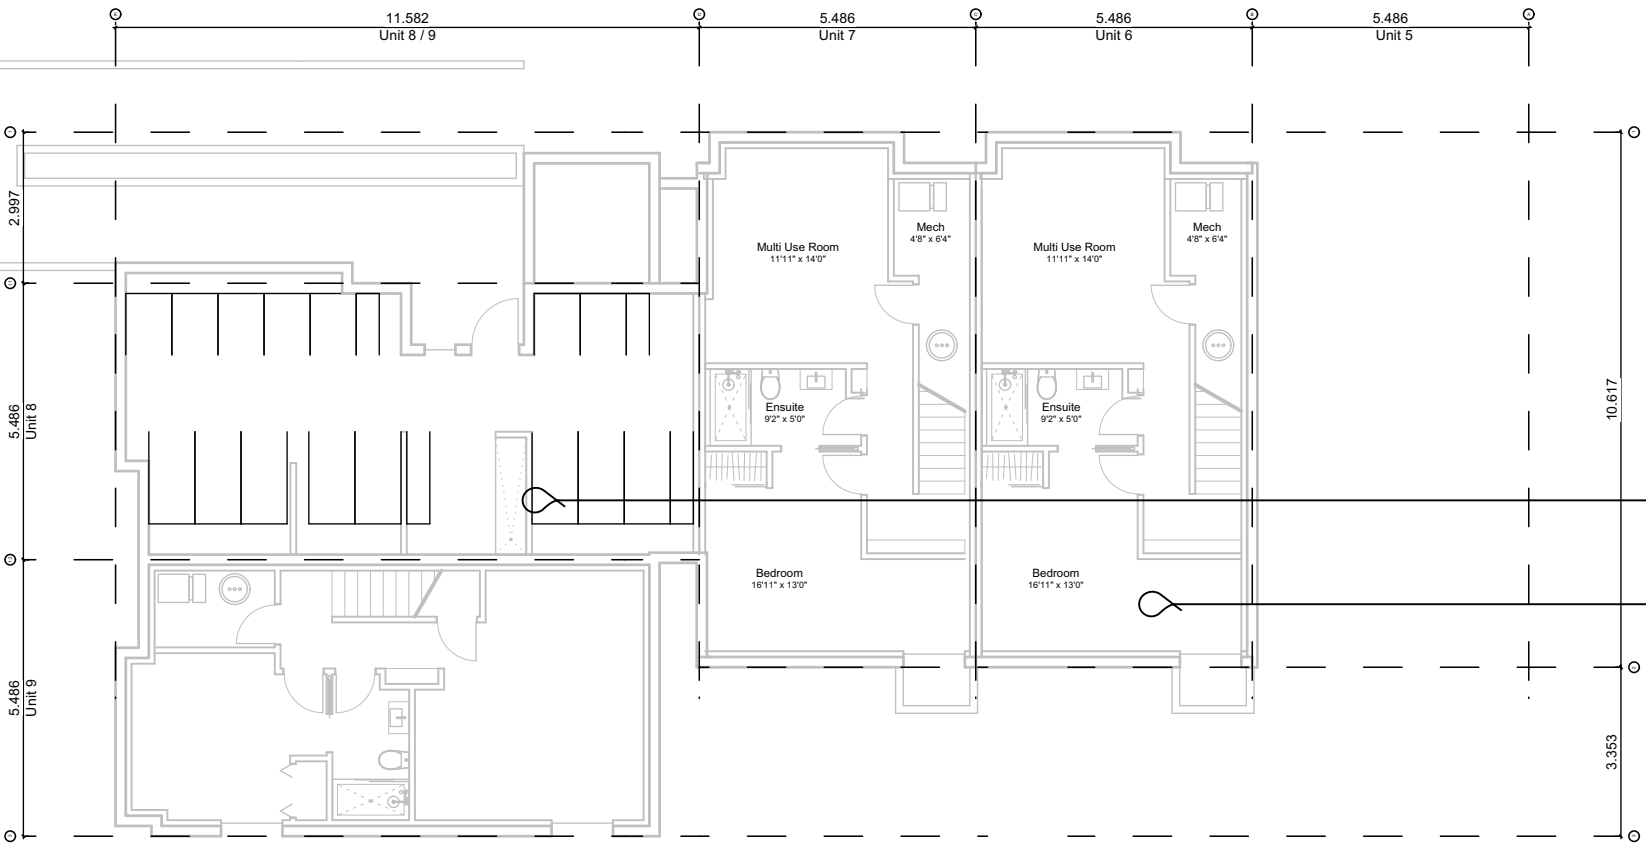

2.0 Block 02 - Basement
Scale: 1:150

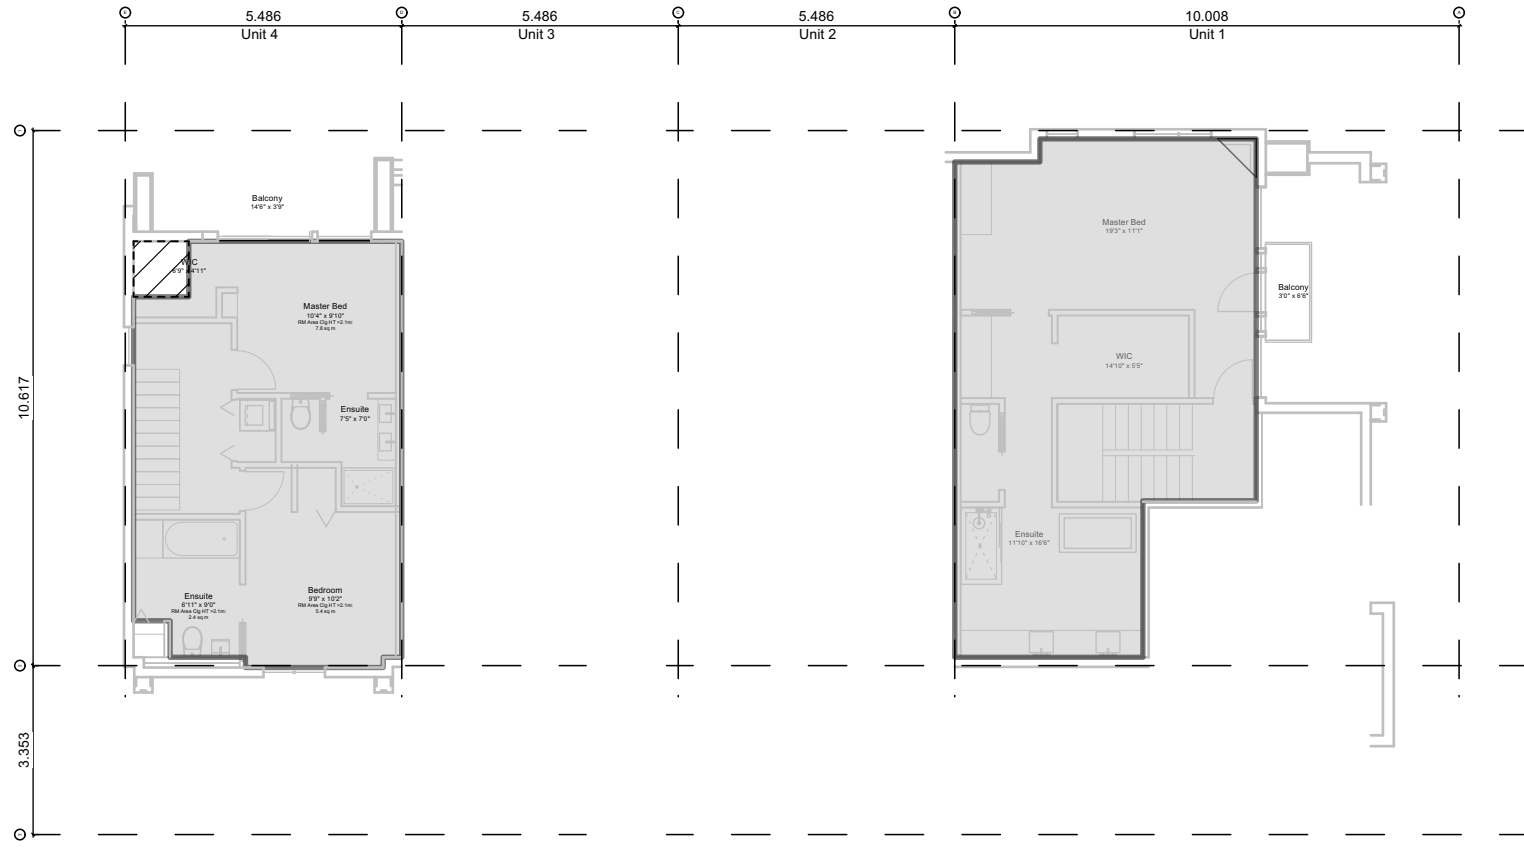


1.3 Block 01 - Floor 3 (Half Storey)
Scale: 1:150



1.2 Block 01 - Floor 2
Scale: 1:150




1.1 Block 01 - Floor 1
Scale: 1:150

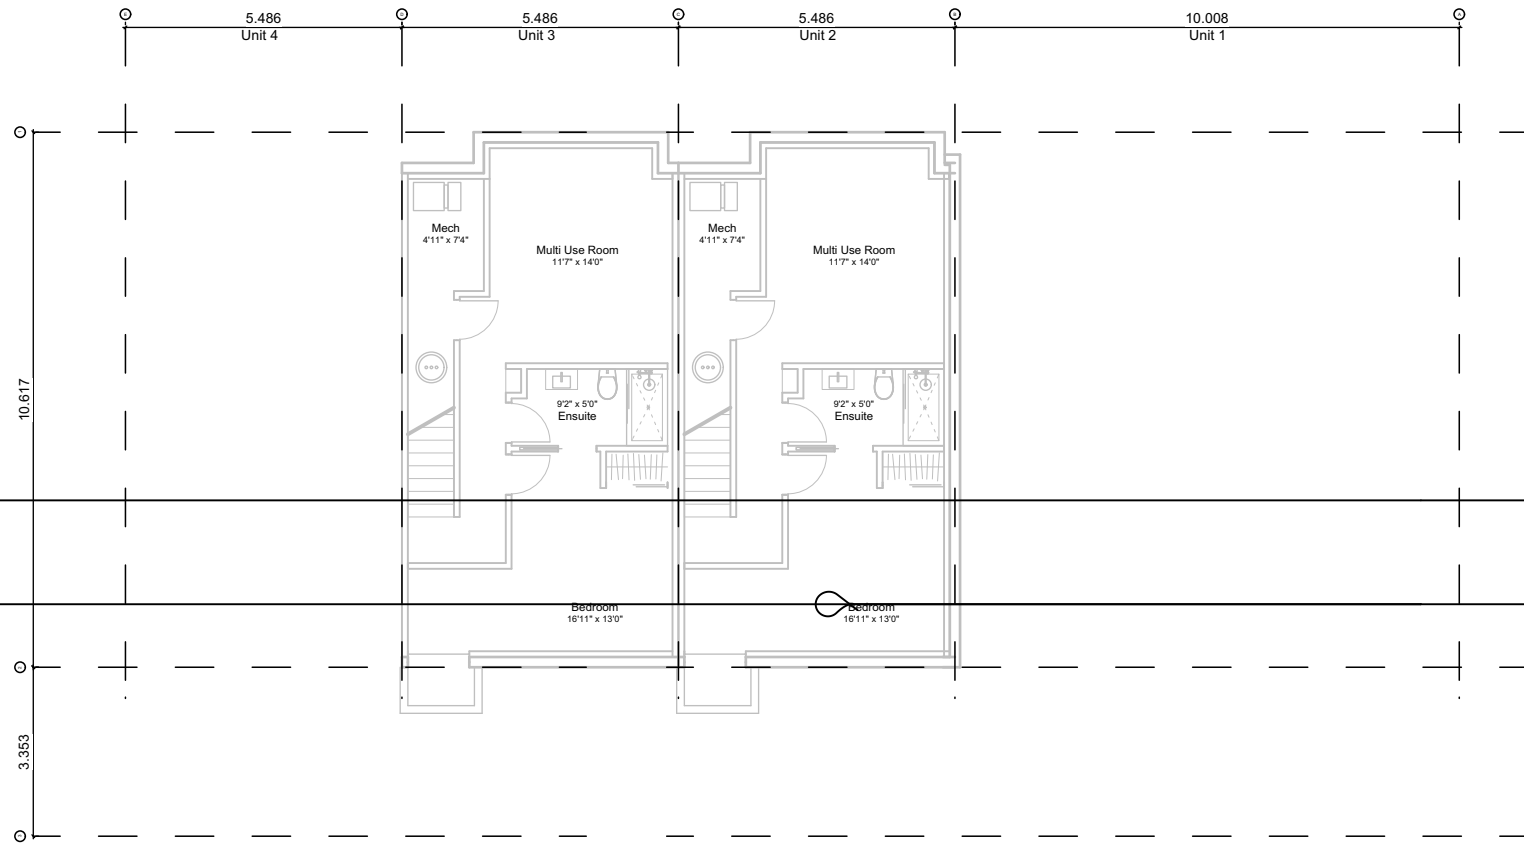

1.0 Block 01 - Basement
Scale: 1:150


"Area" when used in reference to a floor of a storey of a building means the entire area which in plan is enclosed by the interior walls of the exterior walls of the storey at floor level plus the area enclosed by any cantilevered element that is within that storey and that is above floor level, but does not include of the following areas:

- the area used or intended to be used for required parking or movement of motor vehicles, as set out in this bylaw, which is calculated starting from the lowest level of the building;
- the area used or intended to be used for required Bicycle Parking, Long Term, as set out in this bylaw, which is calculated starting from the lowest level of the building;
- the area or areas of balconies, exposed decks, patios or roofs; and
- the area of elevator shafts.

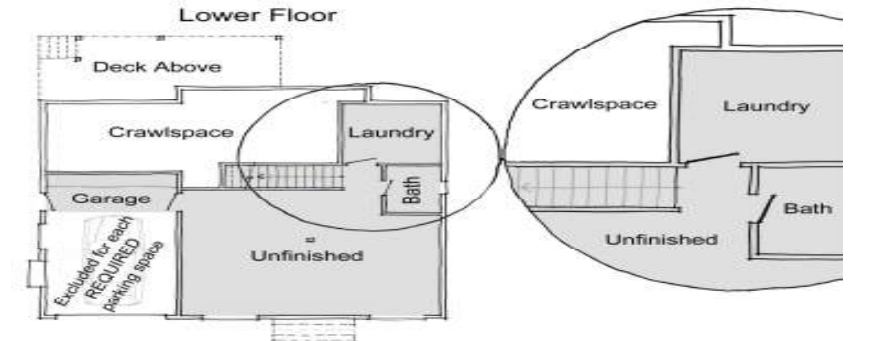

"First Storey" means the storey above the basement of a building without a basement, means the lowest storey.

"Floor Space Ratio" means the ratio of the total floor area of a building to the area of the lot on which it is situated.

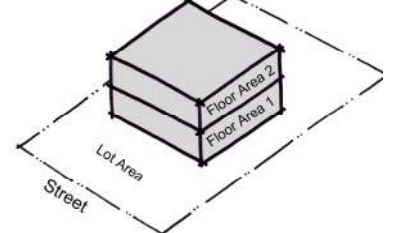

"Habitable Room" means a room in a dwelling unit other than a kitchen, storage room, toilet, bathroom, sauna room, hallway, or stairway.

"Half Storey" means that part of any building wholly or partly within the framing of the roof, where the habitable floor area is not more than 70% of the ground floor area of the building.

"Storey" means the space between two floors or between any other two floors, including a basement or a crawlspace.


"Total Floor Area" means the sum of the areas of all floors of a building, including the area of space under a ceiling which is less than 1.8m above grade.

Project Data

	GFA Area (SF)	Zoning Area (SF)	Habitable Half Storey	Site Area (SF)	FAR	Bedrms
Block 01 (Unit 1-4)						
Thurlow Cluster	8,598	5,558		6,791	0.81	11
Basement	1,239	0				
Main Floor	3,270	2,042				
Second Floor	2,615	2,476				
Half Storey	1,473	1,039	50.9% = (Half Storey / Main Floor)			
Garage	679	0				
Block 02 (Unit 5-9)						
Fairfield Cluster	10,063	5,815		6,796	0.85	15
Basement	2,541	0				
Main Floor	3,370	2,526				
Second Floor	2,950	2,822				
Half Storey	518	467	18.5% = (Half Storey / Main Floor)			
Garage	685	0				
Refuse	143	0				
Electrical Room	74	74				
Total	18,803	11,447		13,587	0.84	

Floor Space Ratio; The building area is measured to the interior side of the exterior wall and interior face of demising walls. Basements excluded.

"Basement" means any part of a building between two floor levels that is partially or completely below grade and has a finished ceiling that is no more than 1.2m above grade.

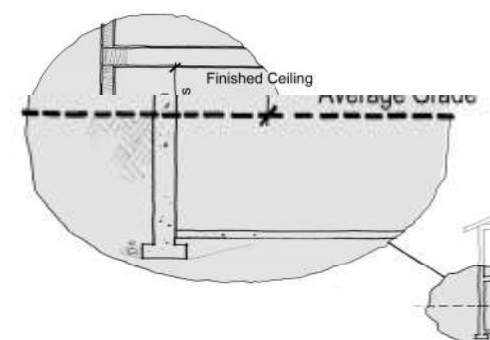


Floor Area Legend

- Area counted towards zoning floor ratio
- Area of refuse
- Area of garage
- Area of electrical room
- Area Less than 1.8m ceiling height

Bicycle parking excluded

All basements are less than 1.8m below grade, excluded. See sections

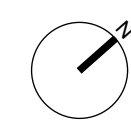


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2021-07-20	Revised & Re-issued for DP
2021-11-21	Revised & Re-issued for DP
2021-12-16	Revised & Re-issued for DP
2022-03-30	Revised & Re-issued for DP
2022-04-11	Revised & Re-issued for DP
2022-05-10	Revised & Re-issued for DP
2022-10-06	Revised & Re-issued for DP
2022-11-04	Revised & Re-issued for DP
2022-11-14	Revised & Re-issued for DP
2022-11-25	Revised & Re-issued for DP

Fairfield Road


Thurlow Road

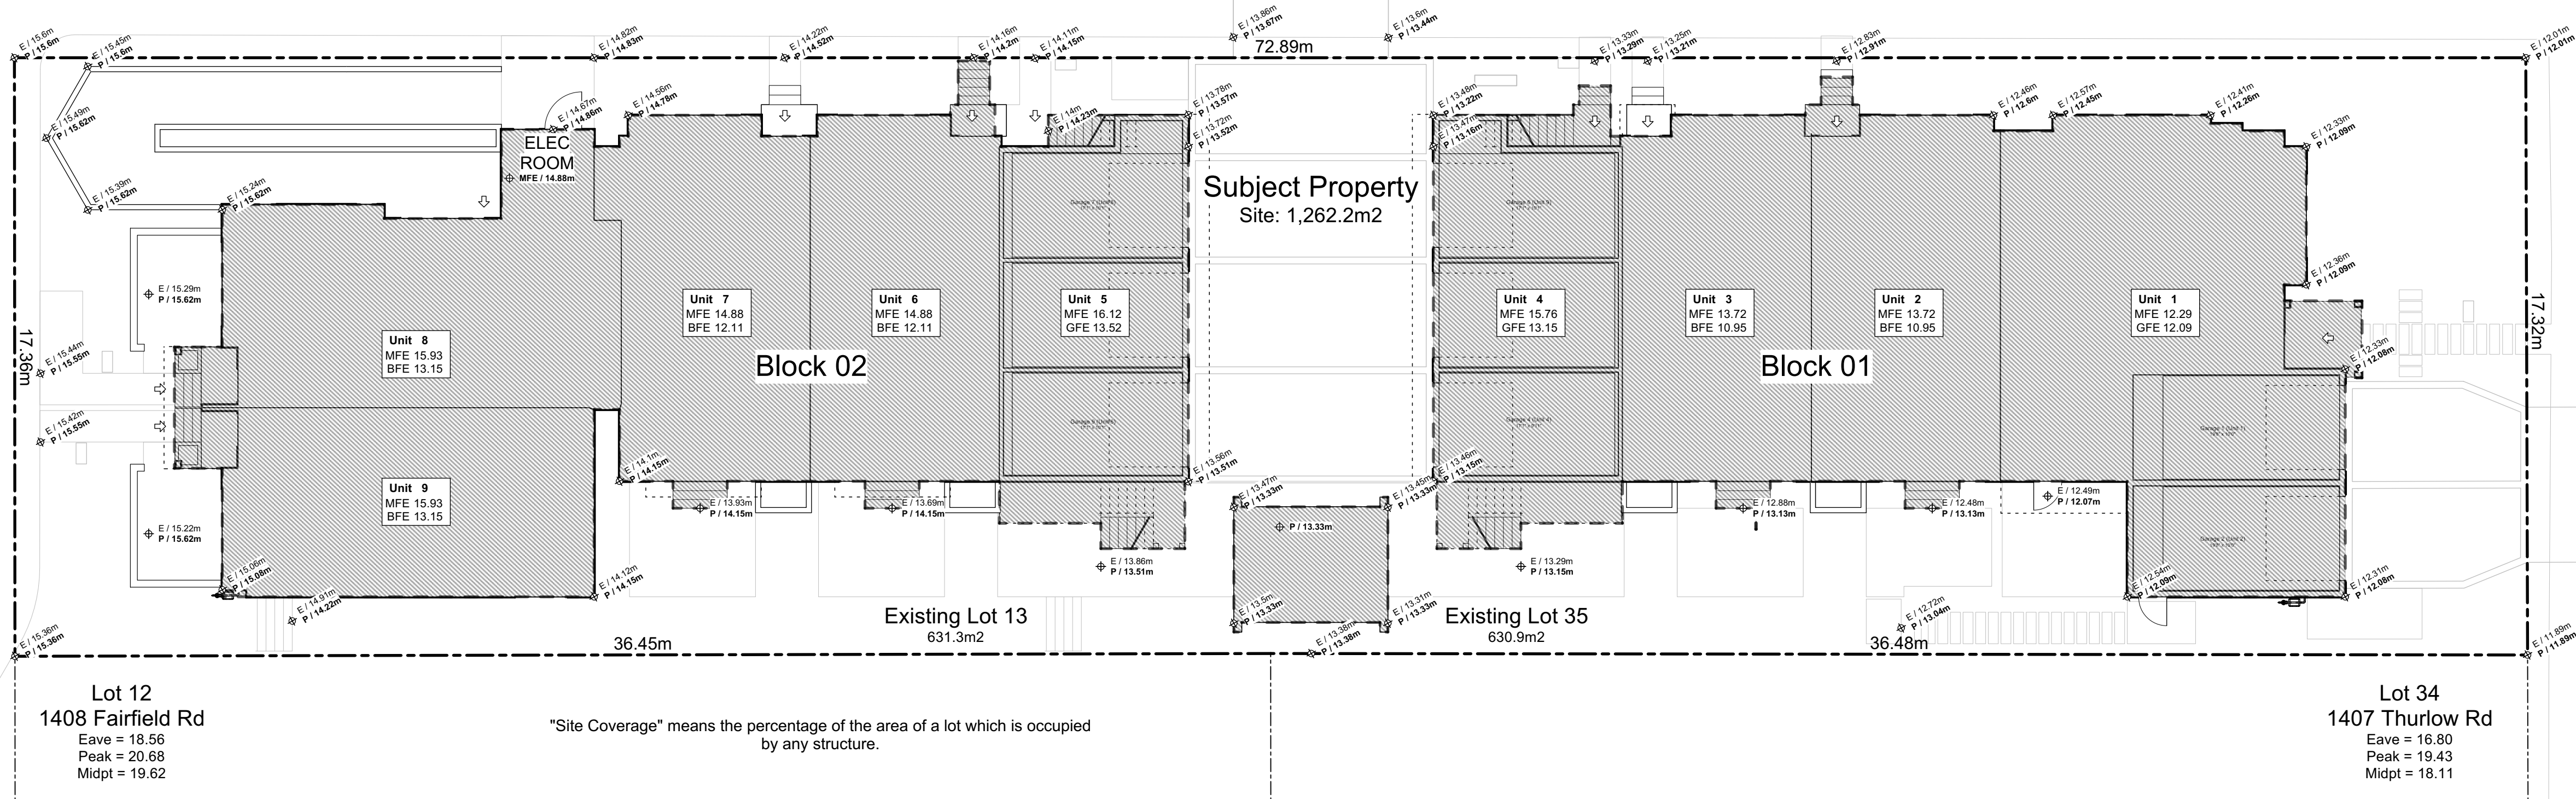

2 Lot Coverage
Scale: 1:120

Fairfield Road

Thurlow Road

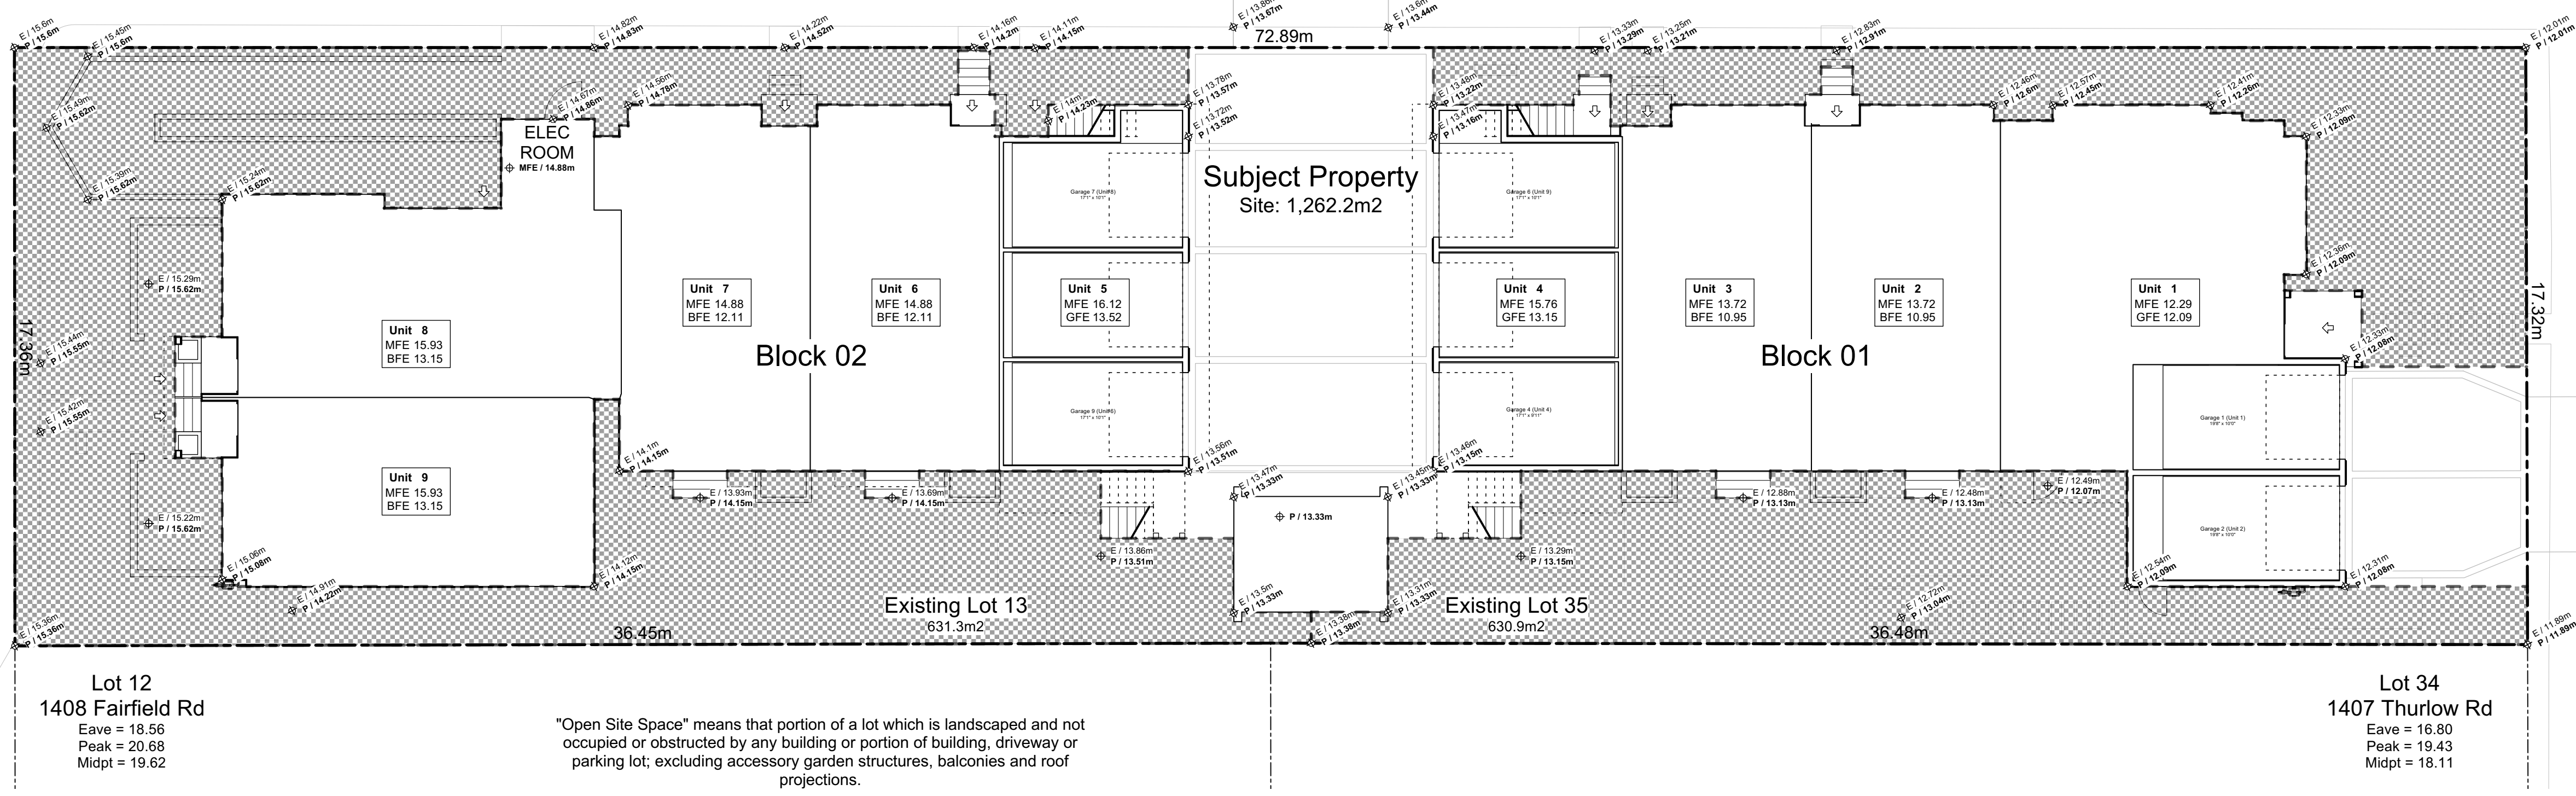

1 Open Site Space
Scale: 1:120

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2022-05-10	Revised & Re-Issued for DP
2022-10-06	Revised & Re-Issued for DP
2022-11-04	Revised & Re-Issued for DP
2022-11-14	Revised & Re-Issued for DP
2022-11-25	Revised & Re-Issued for DP

Graphical
Site Coverage &
Open Site Space

Project Name:

Fairfield-Kipling
Development

Civic: 1400 Fairfield Rd &
349 Kipling St

Legal:

PID:

Project No: 19.015

Drawn By: SG/TD



Plot Date: Nov 29, 2022

Scale: (1:120) 1" = 10'-0"

Sheet No:



"Grade" means the elevation calculated by averaging the elevation of natural grade or finished grade, whichever is lower at any points at which any part of a building comes into contact with the surface of a lot, excluding any artificial mounds of earth or rocks placed at or near the wall of a building, and excluding the minimum window well width and depth required by the *British Columbia Building Code*."

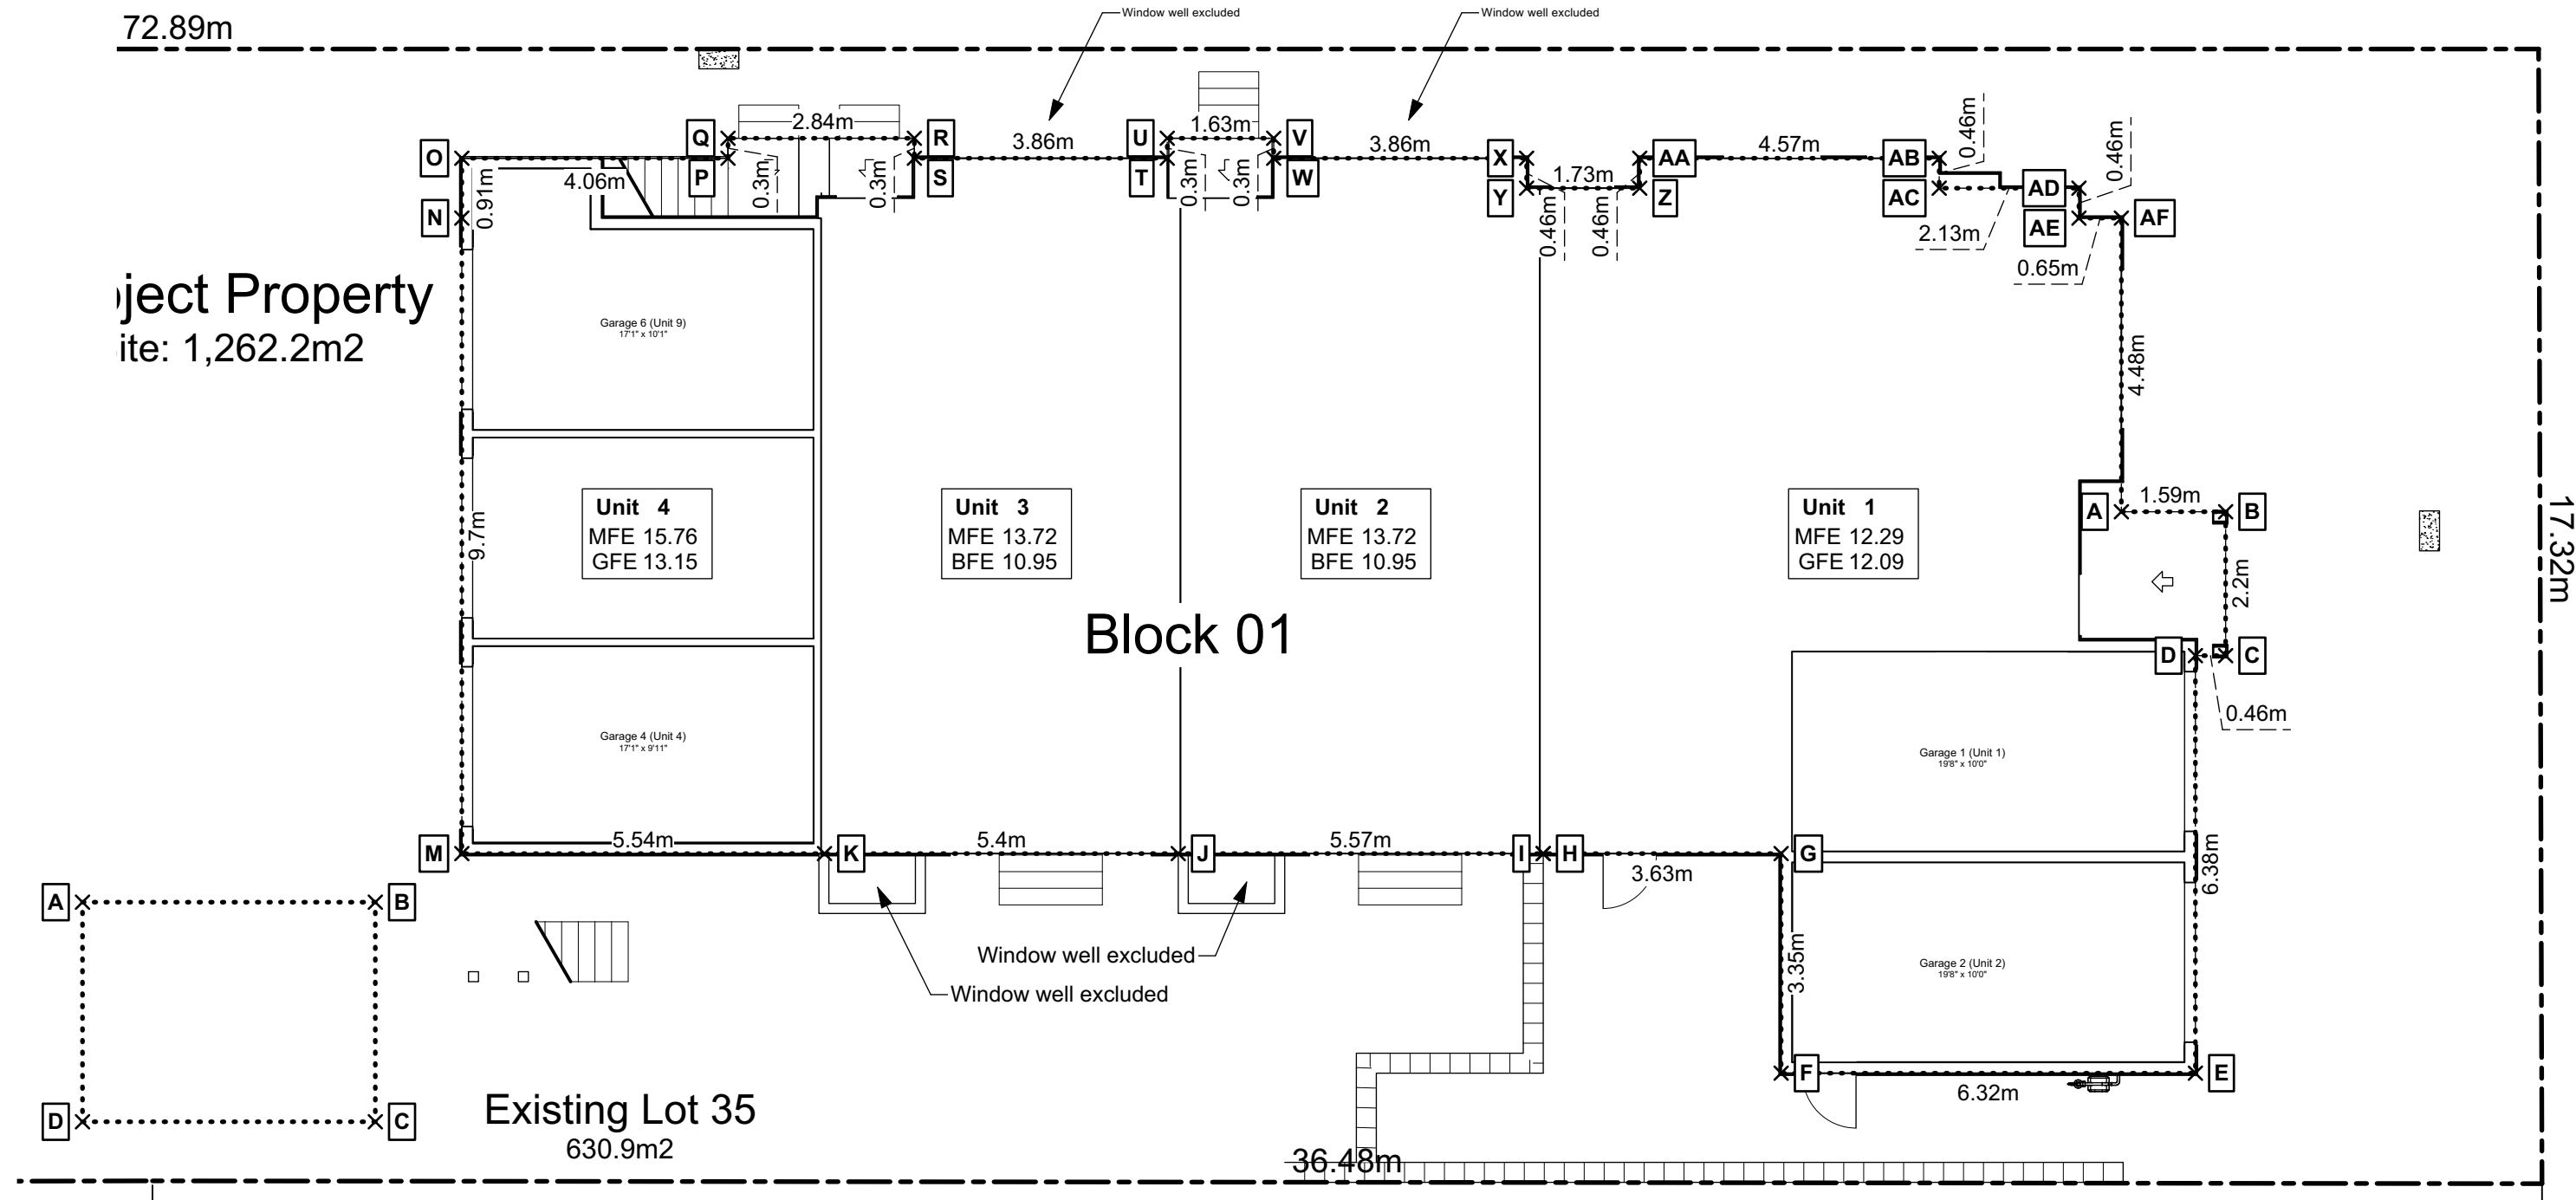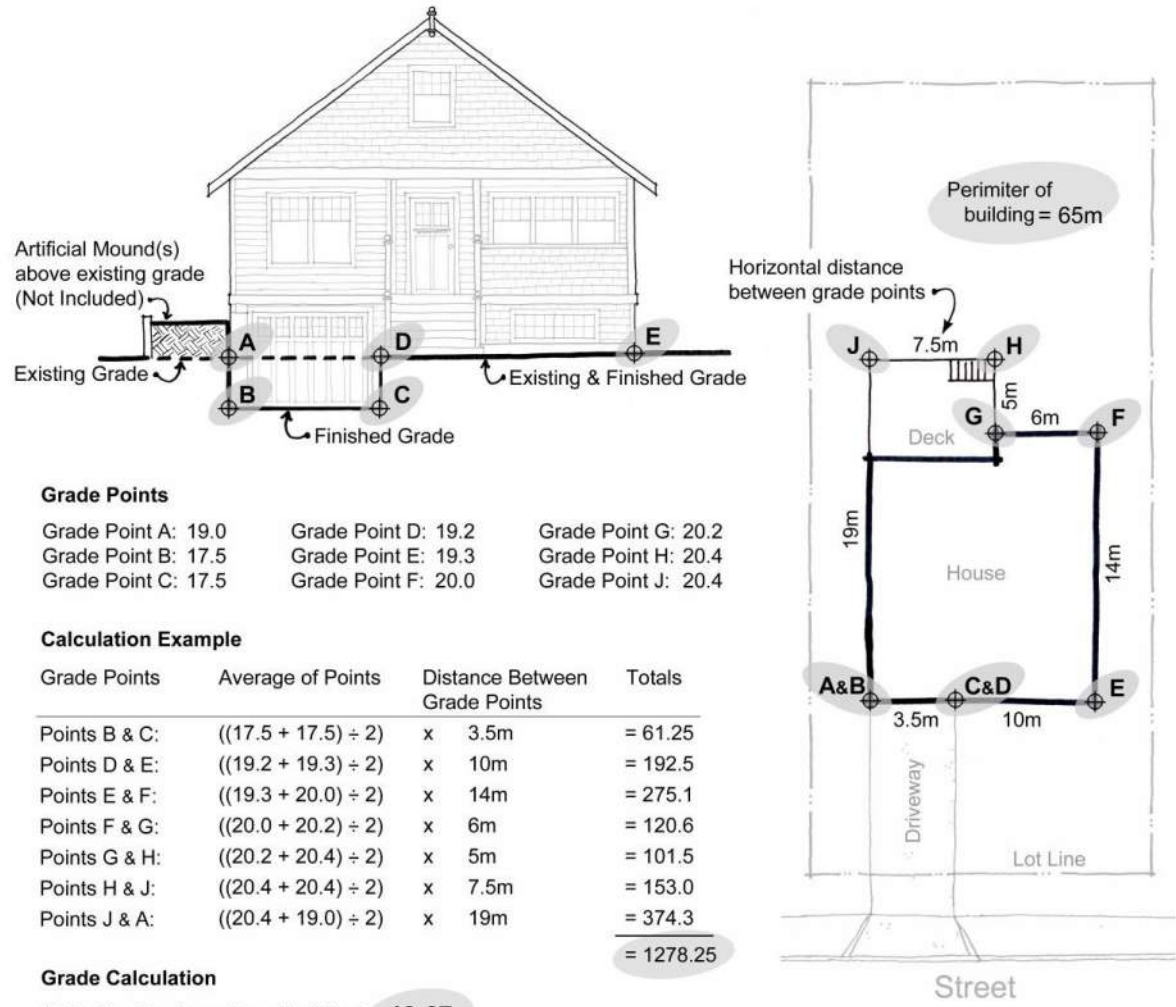


1 Block 01 Average Grade

Scale: 1:100

Grade Calculations - Accessory Refuse

PT	Natural Grade	Finished Grade	Lowest Grade	PT	Lowest Grade	Average	Distance	Total
A	13.47 m	13.33 m	13.33 m →	B	13.33 m	13.33 m	x 4.47 m	59.59
B	13.45 m	13.33 m	13.33 m →	C	13.31 m	13.32 m	x 3.35 m	44.63
C	13.31 m	13.33 m	13.31 m →	D	13.33 m	13.32 m	x 4.47 m	59.55
D	13.50 m	13.33 m	13.33 m →	A	13.33 m	13.33 m	x 3.35 m	44.66
A	13.47 m	13.33 m	13.33 m					
Sub-Total:								208.41
Perimeter of Building								15.64 m
Average Grade								13.33 m

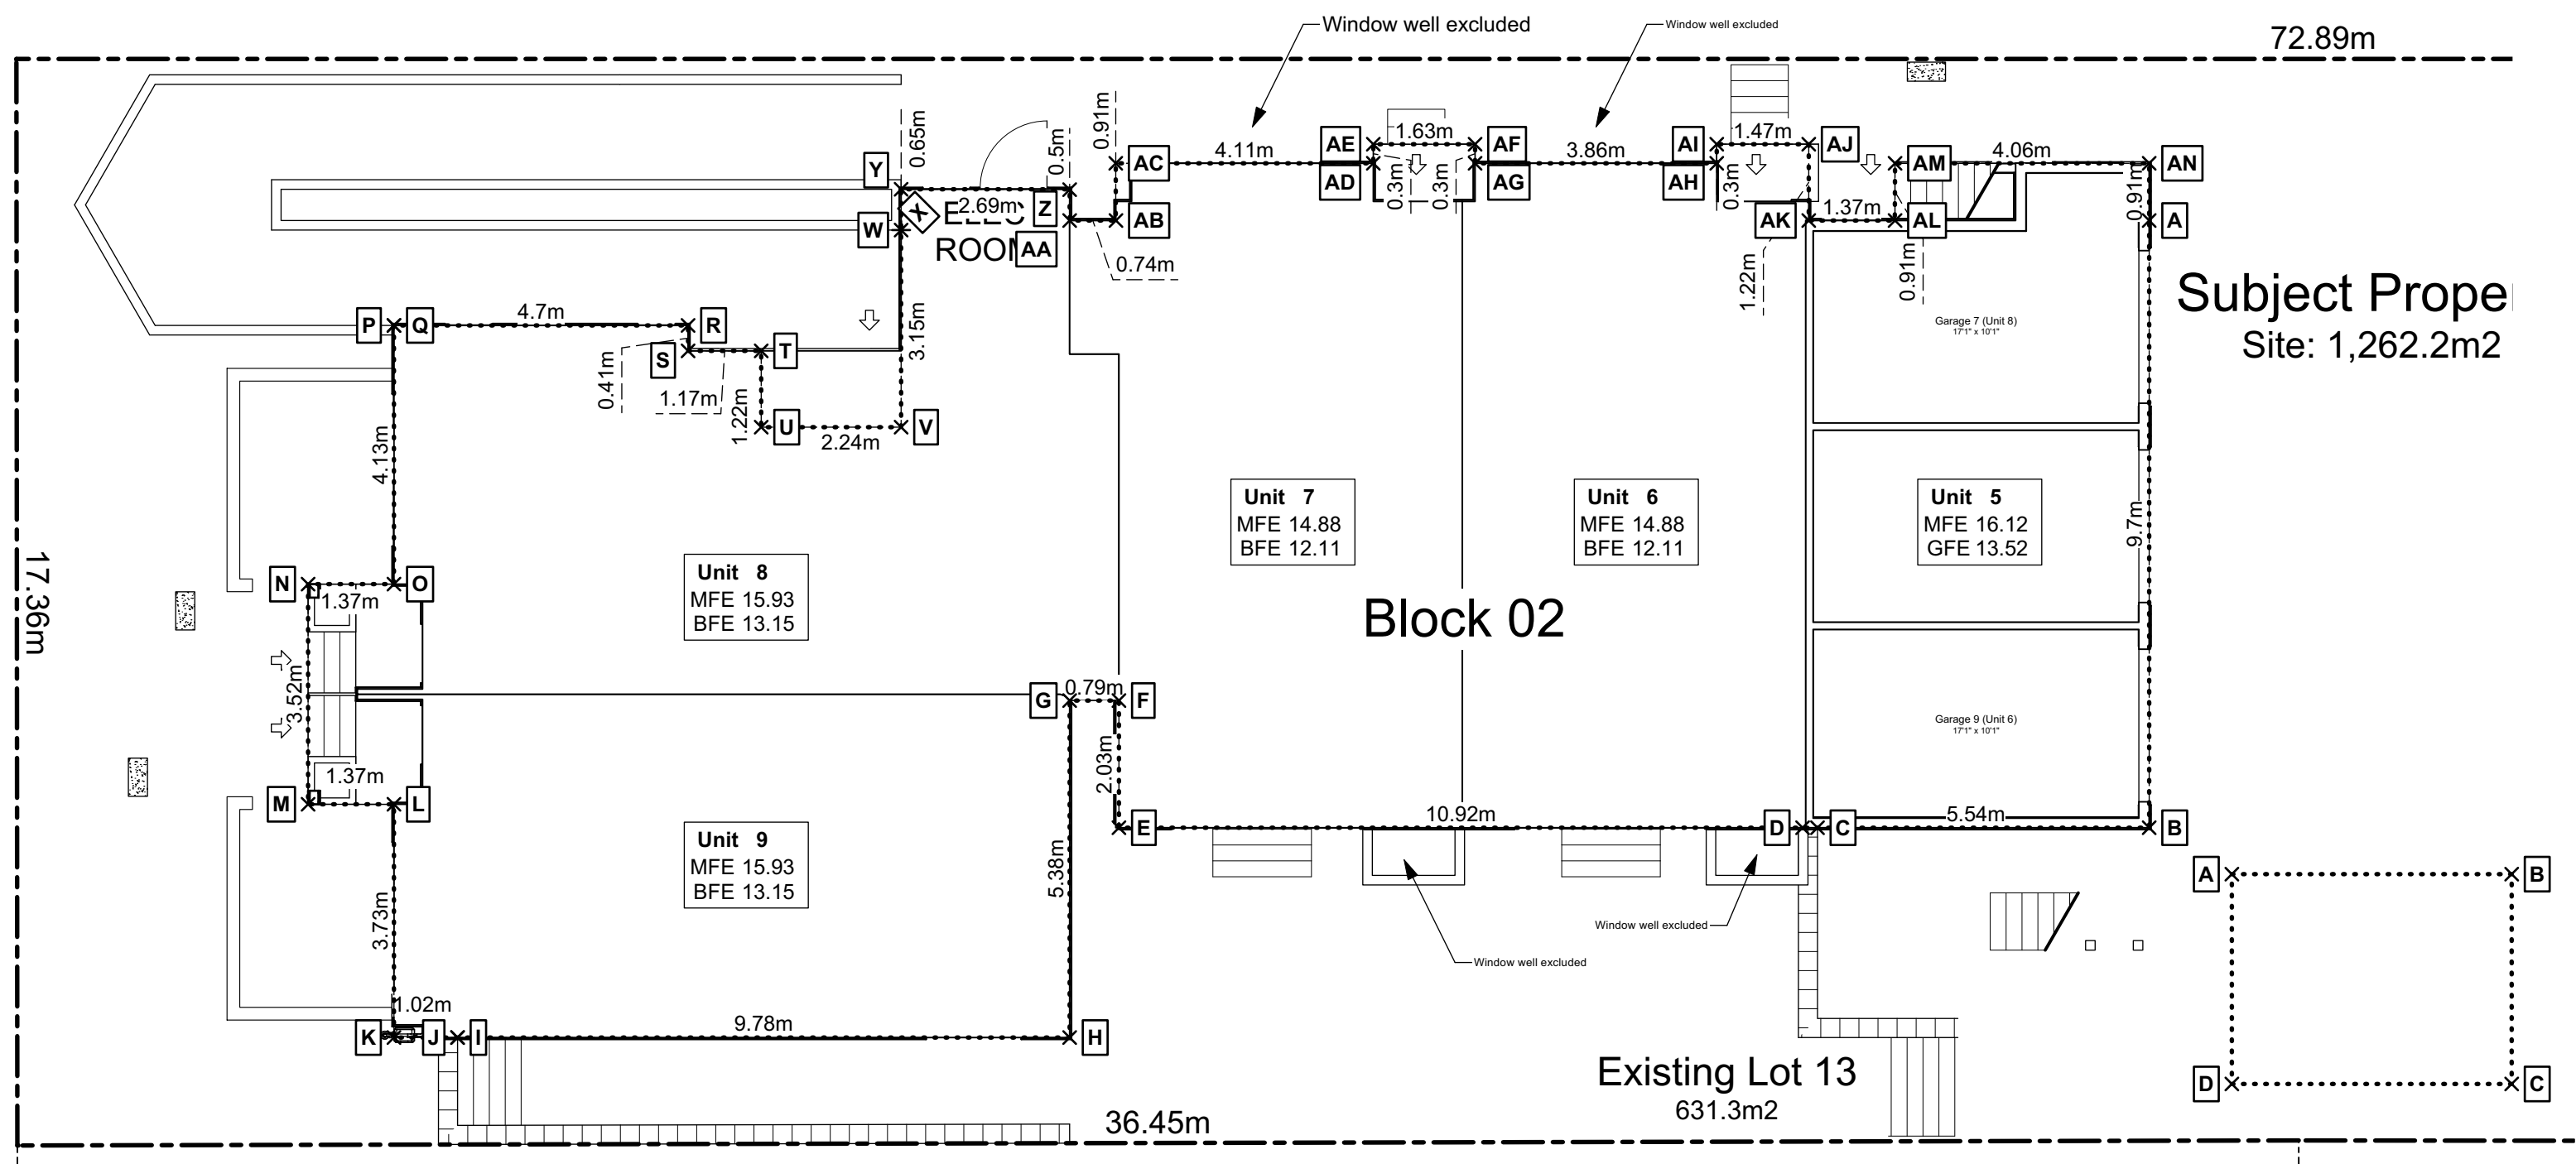

2 Block 02 Average Grade


Scale: 1:100

Grade Calculations - Block 01

PT	Natural Grade	Finished Grade	Lowest Grade	PT	Lowest Grade	Average	Distance	Total
A	12.36 m	12.09 m	12.09 m →	B	12.09 m	12.09 m	x 1.59 m	19.22
B	12.30 m	12.09 m	12.09 m →	C	12.06 m	12.08 m	x 2.20 m	26.57
C	12.30 m	12.06 m	12.06 m →	D	12.09 m	12.08 m	x 0.46 m	5.55
D	12.33 m	12.09 m	12.09 m →	E	12.09 m	12.09 m	x 6.38 m	77.13
E	12.30 m	12.09 m	12.09 m →	F	12.09 m	12.09 m	x 6.32 m	76.41
F	12.52 m	12.09 m	12.09 m →	G	12.09 m	12.09 m	x 3.35 m	40.50
G	12.49 m	12.09 m	12.09 m →	H	12.09 m	12.09 m	x 3.63 m	43.89
H	12.49 m	12.09 m	12.09 m →	I	12.49 m	Step Up		
I	12.49 m	13.13 m	12.49 m →	J	12.73 m	12.61 m	x 5.57 m	70.22
J	12.73 m	13.13 m	12.73 m →	K	13.13 m	12.93 m	x 5.40 m	69.81
K	13.23 m	13.13 m	13.13 m →	M	13.15 m	13.14 m	x 3.35 m	44.02
M	13.44 m	13.15 m	13.15 m →	N	13.16 m	13.15 m	x 13.06 m	171.79
N	13.47 m	13.16 m	13.16 m →	O	13.22 m	13.19 m	x 0.91 m	12.00
O	13.48 m	13.22 m	13.22 m →	P	13.27 m	13.25 m	x 4.06 m	53.78
P	13.33 m	13.27 m	13.27 m →	Q	13.28 m	13.27 m	x 0.30 m	3.98
Q	13.35 m	13.28 m	13.28 m →	R	13.16 m	13.22 m	x 2.84 m	37.54
R	13.21 m	13.16 m	13.16 m →	S	13.15 m	13.15 m	x 0.30 m	3.95
S	13.21 m	13.15 m	13.15 m →	T	12.95 m	13.05 m	x 3.86 m	50.38
T	13.03 m	12.95 m	12.95 m →	U	12.95 m	12.95 m	x 0.30 m	3.88
U	13.01 m	12.95 m	12.95 m →	V	12.60 m	12.77 m	x 1.63 m	20.82
V	12.60 m	12.90 m	12.60 m →	W	12.36 m	12.48 m	x 0.30 m	3.74
W	12.36 m	12.90 m	12.36 m →	X	12.50 m	12.43 m	x 3.86 m	47.98
X	12.57 m	12.52 m	12.52 m →	Y	12.35 m	12.42 m	x 0.46 m	5.72
Y	12.35 m	12.60 m	12.35 m →	Z	12.52 m	12.43 m	x 1.73 m	21.51
Z	12.54 m	12.52 m	12.52 m →	AA	12.52 m	12.52 m	x 0.46 m	5.76
AA	12.57 m	12.52 m	12.52 m →	AB	12.27 m	12.40 m	x 4.57 m	56.65
AB	12.40 m	12.27 m	12.27 m →	AC	12.27 m	12.27 m	x 0.46 m	5.64
AC	12.42 m	12.27 m	12.27 m →	AD	12.09 m	12.18 m	x 2.13 m	25.94
AD	12.35 m	12.09 m	12.09 m →	AE	12.09 m	12.09 m	x 0.46 m	5.56
AE	12.36 m	12.09 m	12.09 m →	AF	12.09 m	12.09 m	x 0.65 m	7.86
AF	12.33 m	12.09 m	12.09 m					
Sub-Total:								1,017.82
Perimeter of Building								80.59 m
Average Grade								12.63 m

Grade Calculations - Block 02

PT	Natural Grade	Finished Grade	Lowest Grade	PT	Lowest Grade	Average	Distance	Total
A	13.68 m	13.52 m	13.52 m →	B	13.52 m	13.52 m	x 13.06 m	176.55
B	13.57 m	13.52 m	13.52 m →	C	13.52 m	13.52 m	x 5.54 m	74.89
C	13.59 m	13.52 m	13.52 m →	D	13.60 m	13.56 m	x 3.35 m	45.43
D	13.60 m	14.15 m	13.60 m →	E	14.08 m	13.84 m	x 10.92 m	151.15
E	14.08 m	14.15 m	14.08 m →	F	14.12 m	14.10 m	x 2.03 m	28.82
F	14.12 m	14.15 m	14.12 m →	G	14.15 m	14.13 m	x 0.79 m	11.16
G	14.18 m	14.15 m	14.15 m →	H	14.13 m	14.14 m	x 5.38 m	76.06
H	14.13 m	14.15 m	14.13 m →	I	14.22 m	14.18 m	x 9.78 m	138.64
I	14.96 m	14.22 m	14.22 m →	J	14.96 m	Step Up		
J	14.96 m	15.01 m	14.96 m →	K	15.02 m	14.99 m	x 1.02 m	15.29
K	15.02 m	15.09 m	15.02 m →	L	15.22 m	15.12 m	x 3.73 m	56.39
L	15.22 m	15.62 m	15.22 m →	M	15.23 m	15.22 m	x 1.37 m	20.86
M	15.23 m	15.62 m	15.23 m →	N	15.27 m	15.25 m	x 3.52 m	53.68
N	15.27 m	15.62 m	15.27 m →	O	15.25 m	15.26 m	x 1.37 m	20.90
O	15.25 m	15.62 m	15.25 m →	P	15.24 m	15.24 m	x 4.13 m	62.96
P	15.24 m	15.62 m	15.24 m →	Q	13.75 m	Step Down		
Q	15.24 m	13.75 m	13.75 m →	R	13.27 m	13.51 m	x 4.70 m	63.50
R	15.11 m	13.27 m	13.27 m →	S	13.27 m	13.27 m	x 0.41 m	5.44
S	15.13 m	13.27 m	13.27 m →	T	13.15 m	13.21 m	x 1.17 m	15.46
T	15.08 m	13.15 m	13.15 m →	U	13.15 m	13.15 m	x 1.22 m	16.04
U	15.11 m	13.15 m	13.15 m →	V	13.15 m	13.15 m	x 2.24 m	29.46
V	14.46 m	13.15 m	13.15 m →	W	13.15 m	13.15 m	x 3.15 m	41.42
W	14.64 m	13.15 m	13.15 m →	X	14.47 m	Step Up		
X	14.47 m	14.86 m	14.47 m →	Y	14.47 m	14.47 m	x 0.65 m	9.41
Y	14.47 m	14.86 m	14.47 m →	Z	14.38 m	14.42 m	x 2.69 m	38.80
Z	14.38 m	14.80 m	14.38 m →	AA	14.29 m	14.33 m	x 0.50 m	7.17
AA	14.29 m	14.80 m	14.29 m →	AB	14.29 m	14.29 m	x 0.74 m	10.57
AB	14.29 m	14.80 m	14.29 m →	AC	14.61 m	14.45 m	x 0.91 m	13.15
AC	14.61 m	14.78 m	14.61 m →	AD	14.11 m	14.36 m	x 4.11 m	59.01
AD	14.11 m	14.49 m	14.11 m →	AE	14.19 m	14.15 m	x 0.30 m	4.24
AE	14.19 m	14.50 m	14.19 m →	AF	14.09 m	14.14 m	x 1.63 m	23.04
AF	14.09 m	14.49 m	14.09 m →	AG	14.01 m	14.05 m	x 0.30 m	4.21
AG	14.01 m	14.49 m	14.01 m →	AH	14.04 m	14.02 m	x 3.86 m	54.14
AH	14.04 m	14.30 m	14.04 m →	AI	14.10 m	14.07 m	x 0.30 m	4.22
AI	14.10 m	14.28 m	14.10 m →	AJ	14.09 m	14.10 m	x 1.47 m	20.72
AJ	14.09 m	14.26 m	14.09 m →	AK	13.96 m	14.03 m	x 1.22 m	17.11
AK	13.96 m	14.30 m	13.96 m →	AL	13.94 m	13.95 m	x 1.37 m	19.11
AL	13.94 m	14.25 m	13.94 m →	AM	14.03 m	13.98 m	x 0.91 m	12.73
AM	14.03 m	14.21 m	14.03 m →	AN	13.58 m	13.81 m	x 4.06 m	56.06
AN	13.79 m	13.58 m	13.58 m					
Sub-Total:								1,457.59
Perimeter of Building								103.90 m
Average Grade								14.03 m

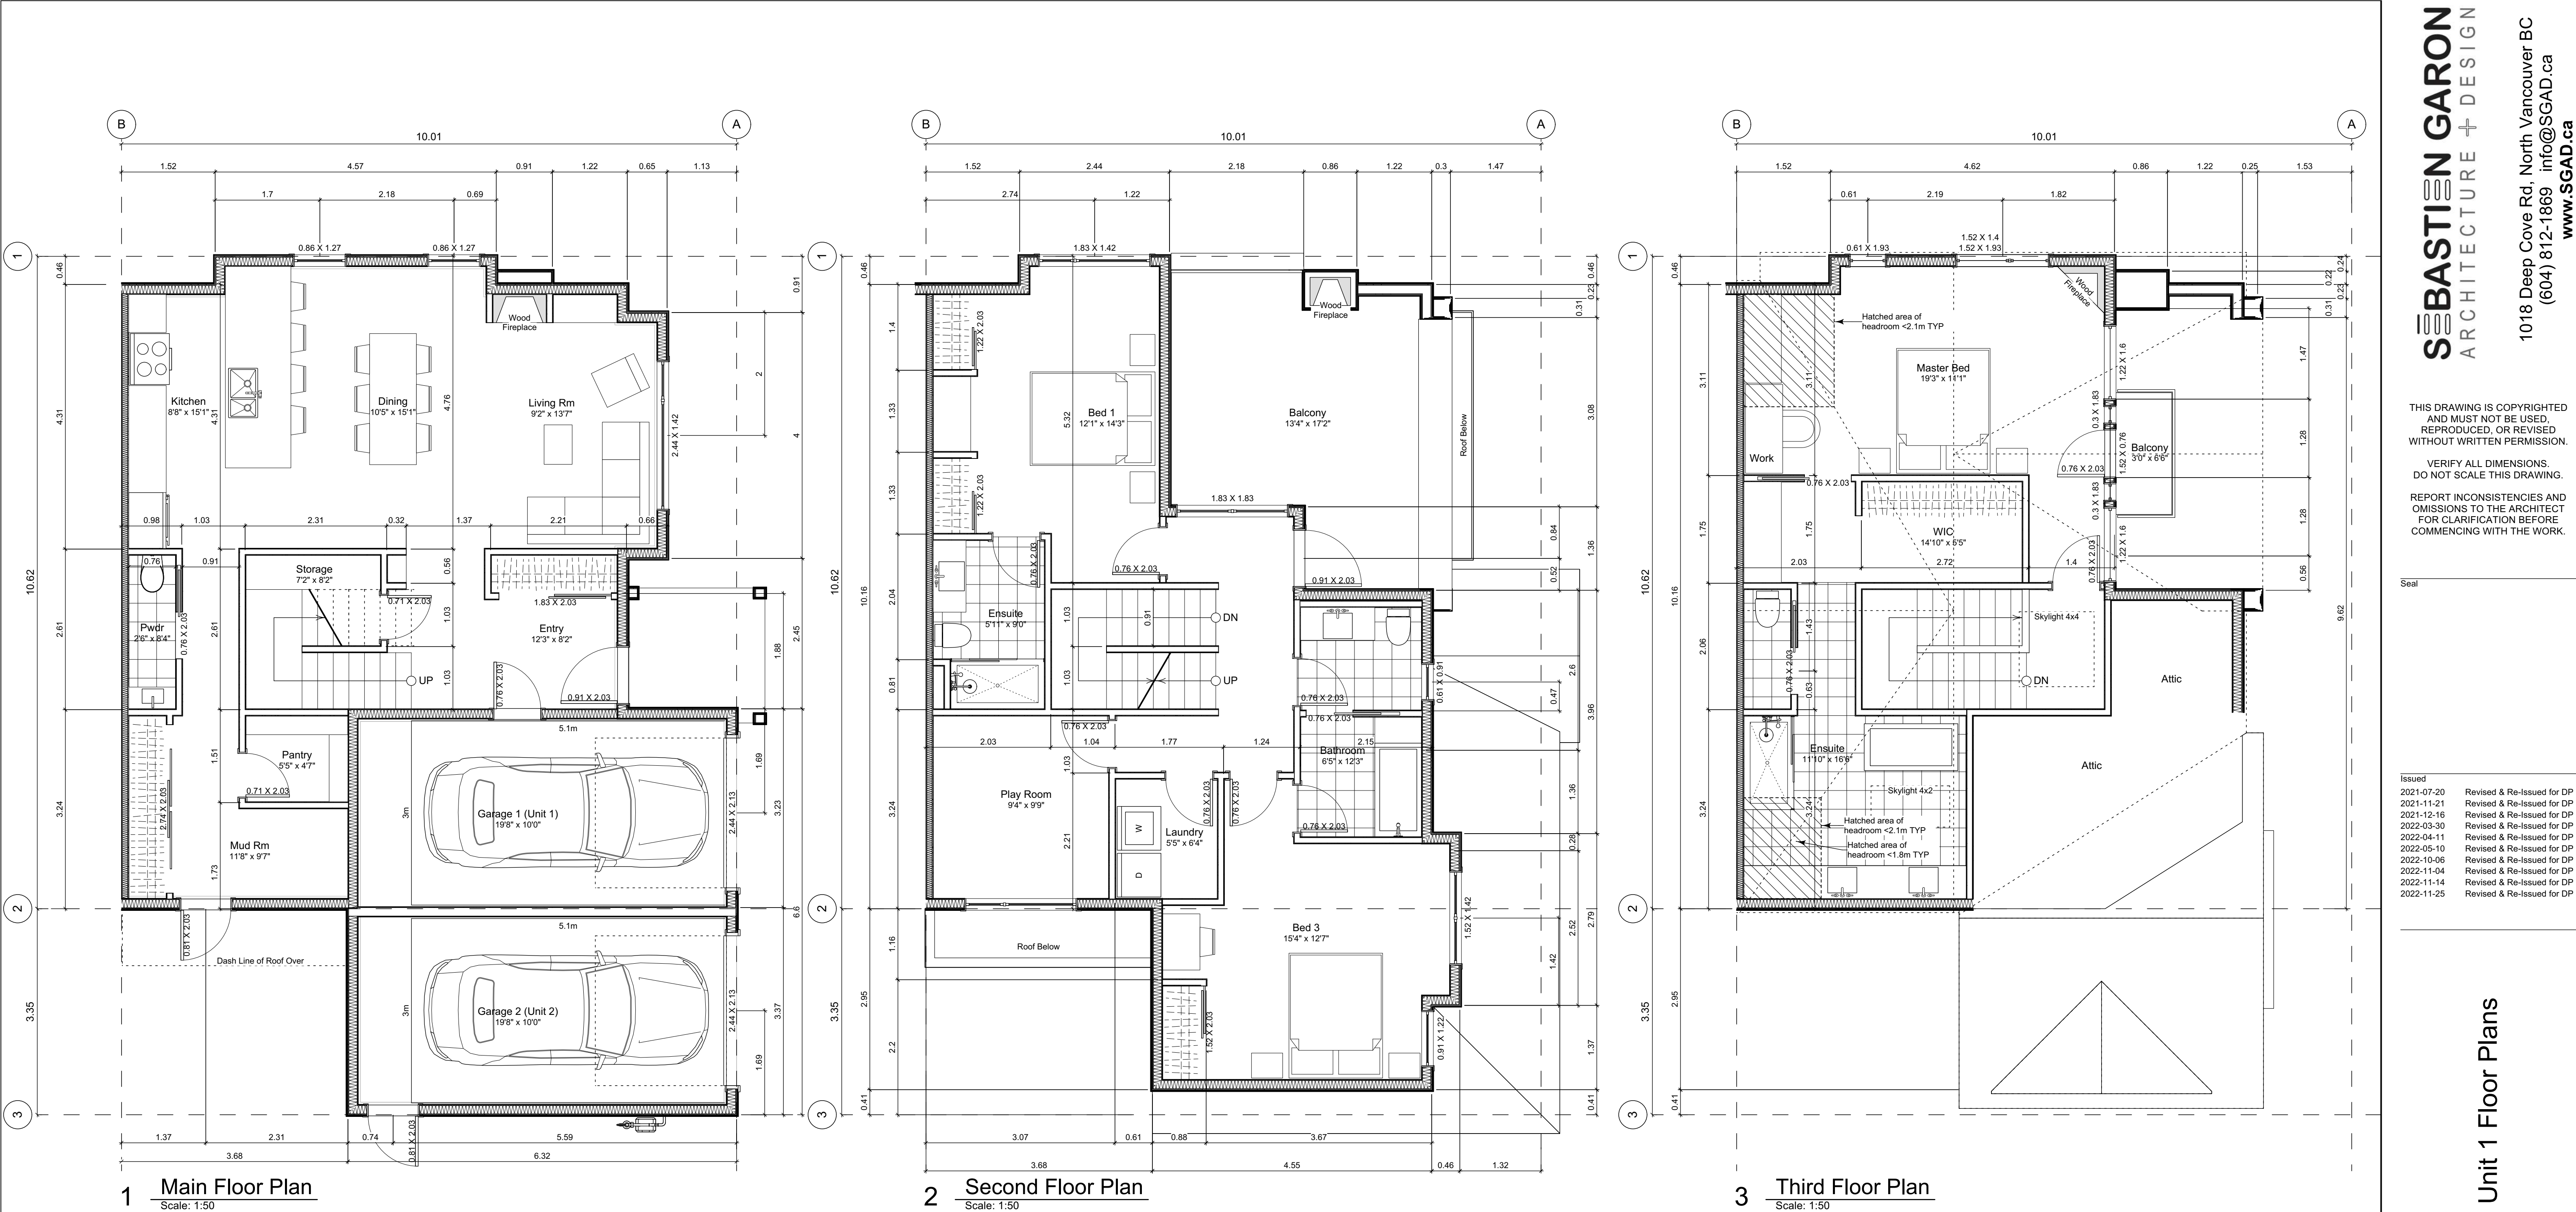

1 Main Floor Plan
Scale: 1:50

2 Second Floor Plan
Scale: 1:50

3 Third Floor Plan
Scale: 1:50

Unit Plan Notes:

See Block plan for foundation plan.

Grid Lines are to:
1) Outside face of plywood or
2) Centre line of demising wall.

Dimensions are to:
1) One side of interior stud,
2) Face of plywood, or face of concrete.

Floor Area Calculations

	Gross Floor Area		Zoning Floor Area		Bedrms
Basement Floor	No Basement as per zoning definition				
Main Floor	1,243 sq ft	115.5 m2	801 sq ft	74.4 m2	
Second Floor	873 sq ft	81.1 m2	813 sq ft	75.5 m2	
Half Storey	955 sq ft	88.8 m2	579 sq ft	53.8 m2	
Totals:	3,072 sq ft	285.4 m2	2,193 sq ft	203.7 m2	3
Garage	168 sq ft	15.7 m2			

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2022-11-04	Revised & Re-issued for DP
2022-11-14	Revised & Re-issued for DP
2022-11-25	Revised & Re-issued for DP

Unit 1 Floor Plans

Project Name:

Fairfield-Kipling
Development

Civic: 1400 Fairfield Rd &
349 Kipling St

Legal:

PID:


Project No: 19.015

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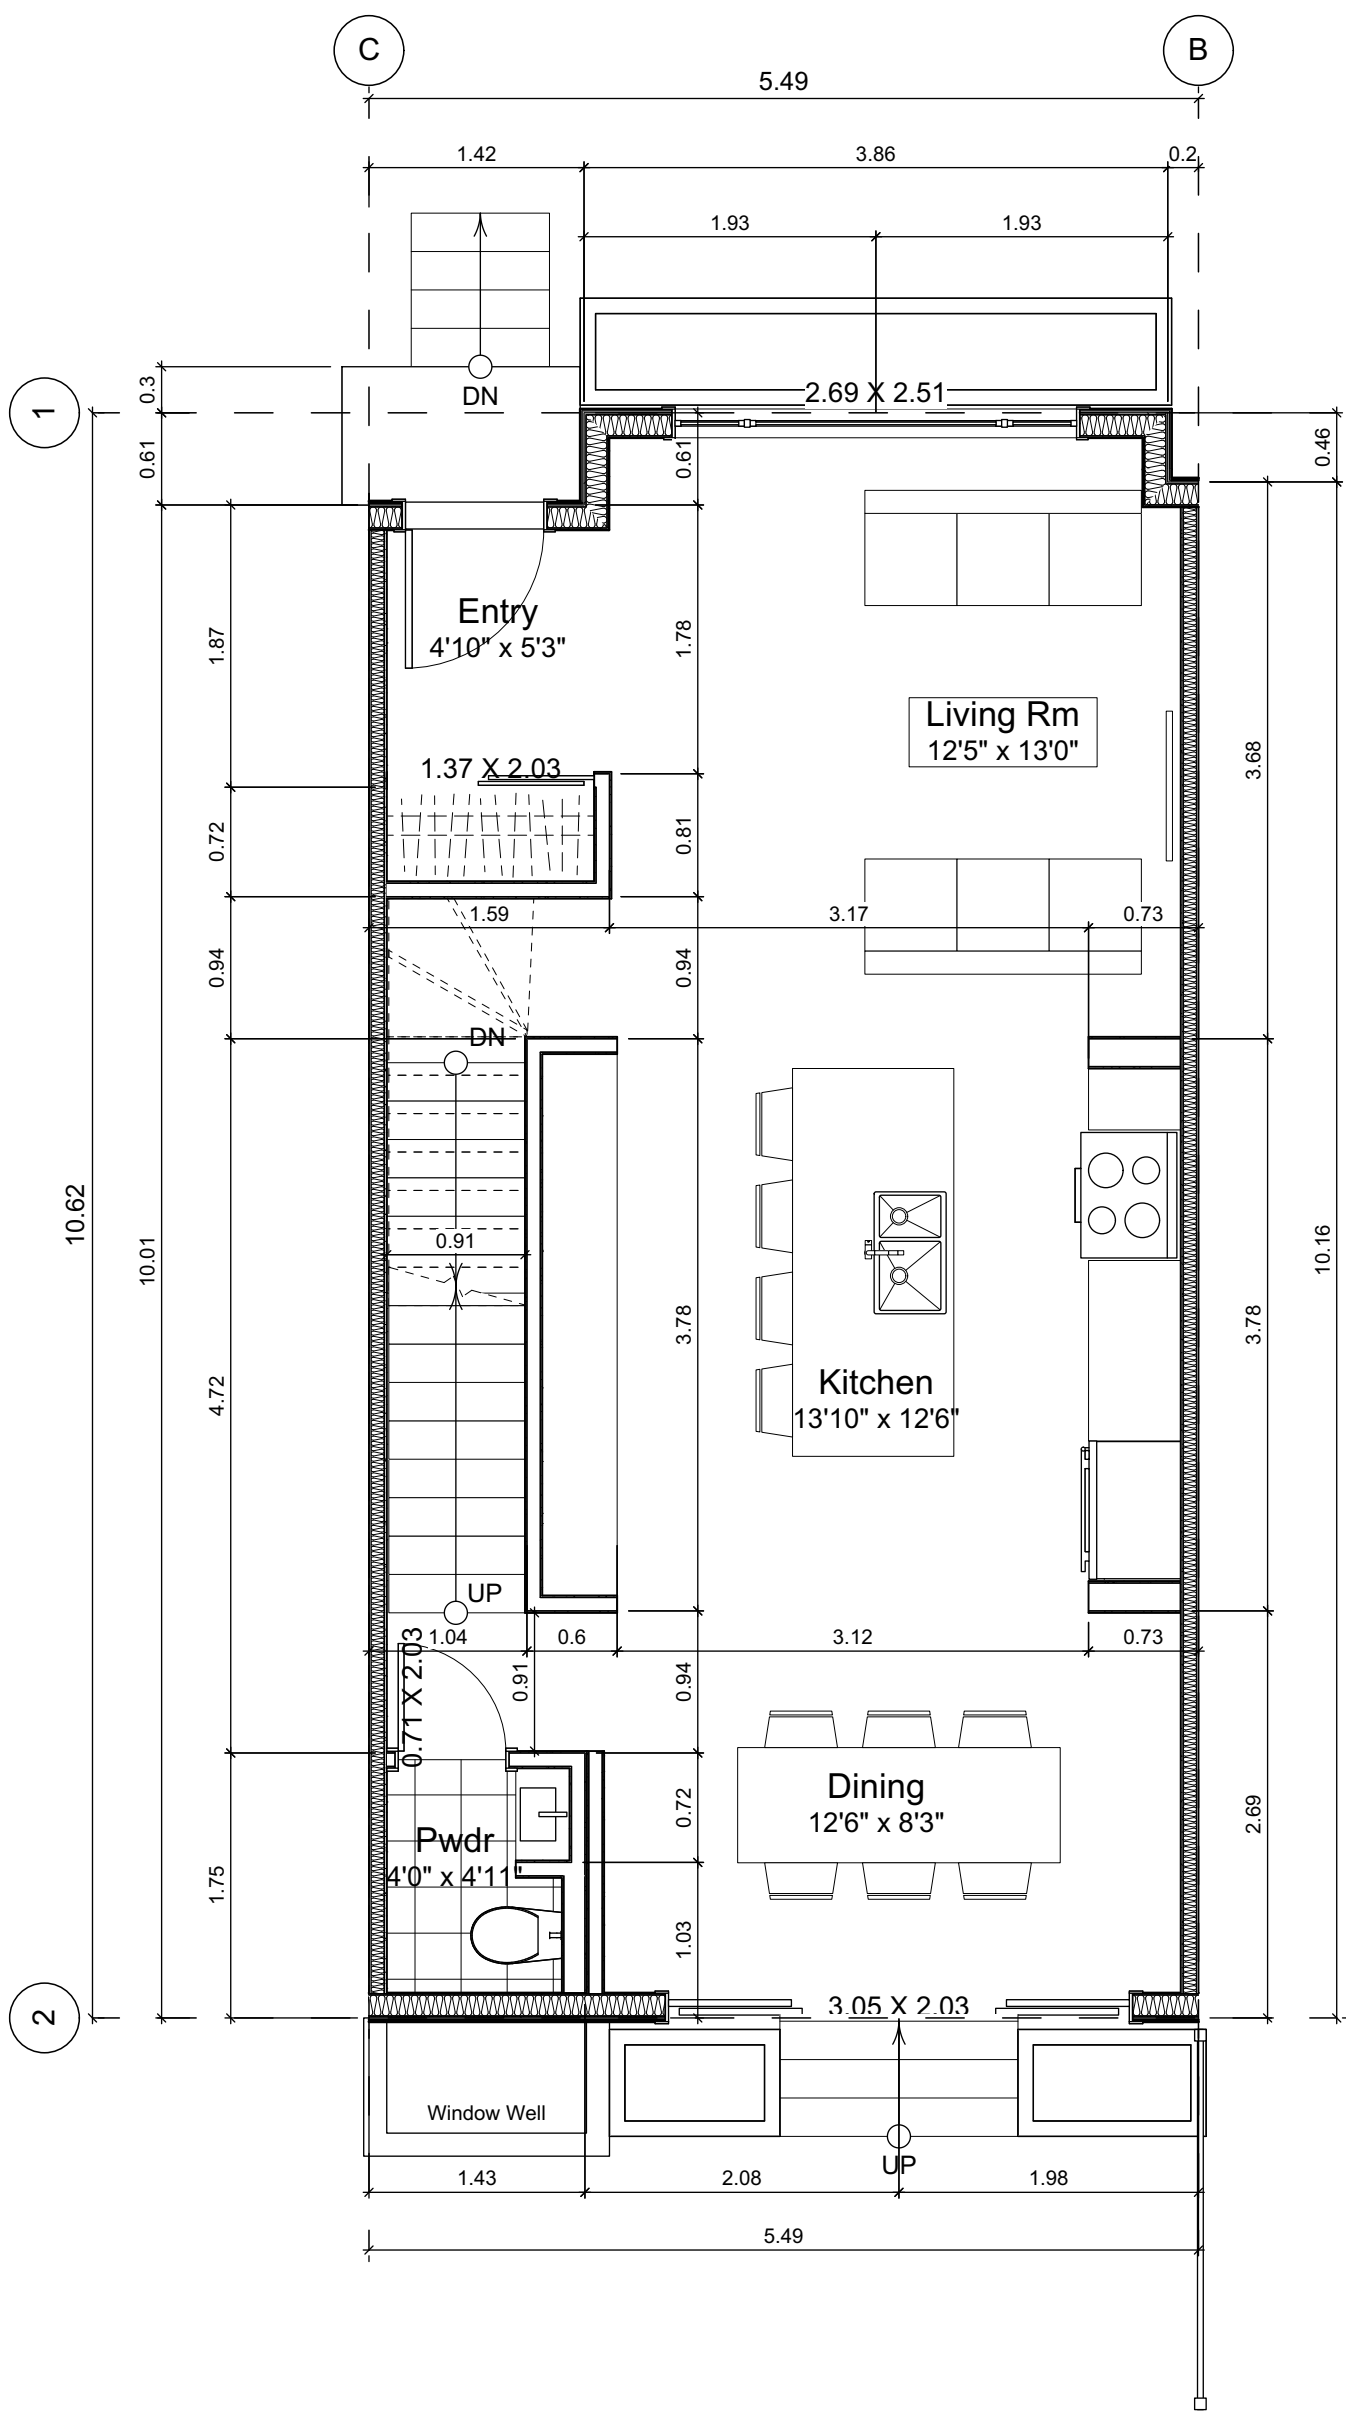
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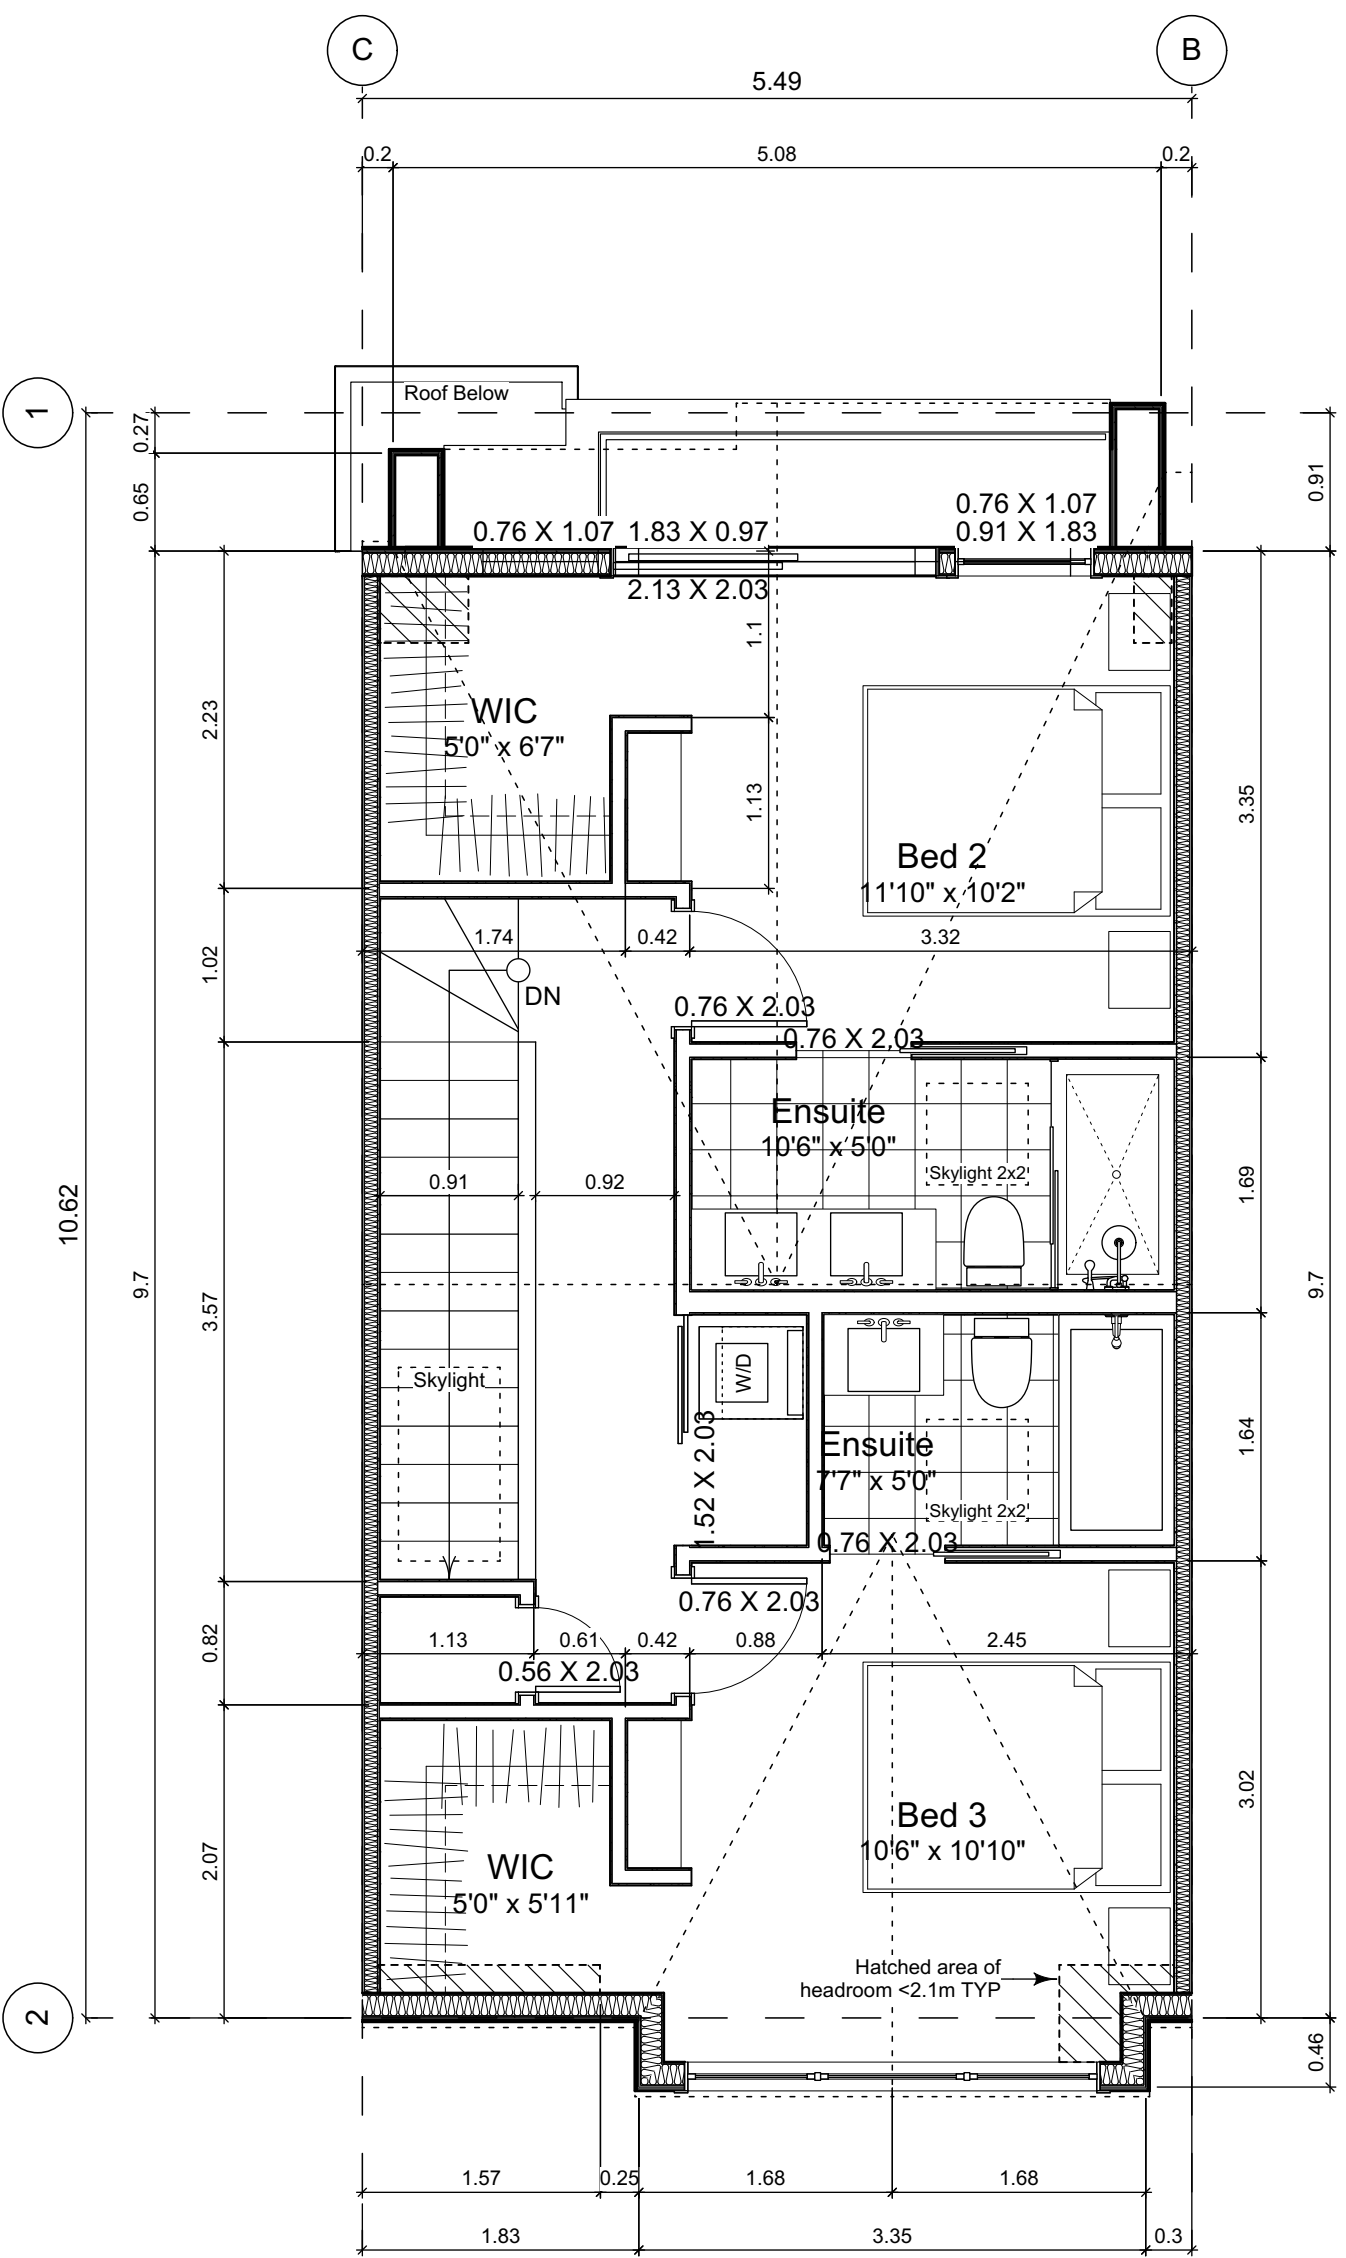
Sheet No:



0 Basement Floor Plan
Scale: 1:50

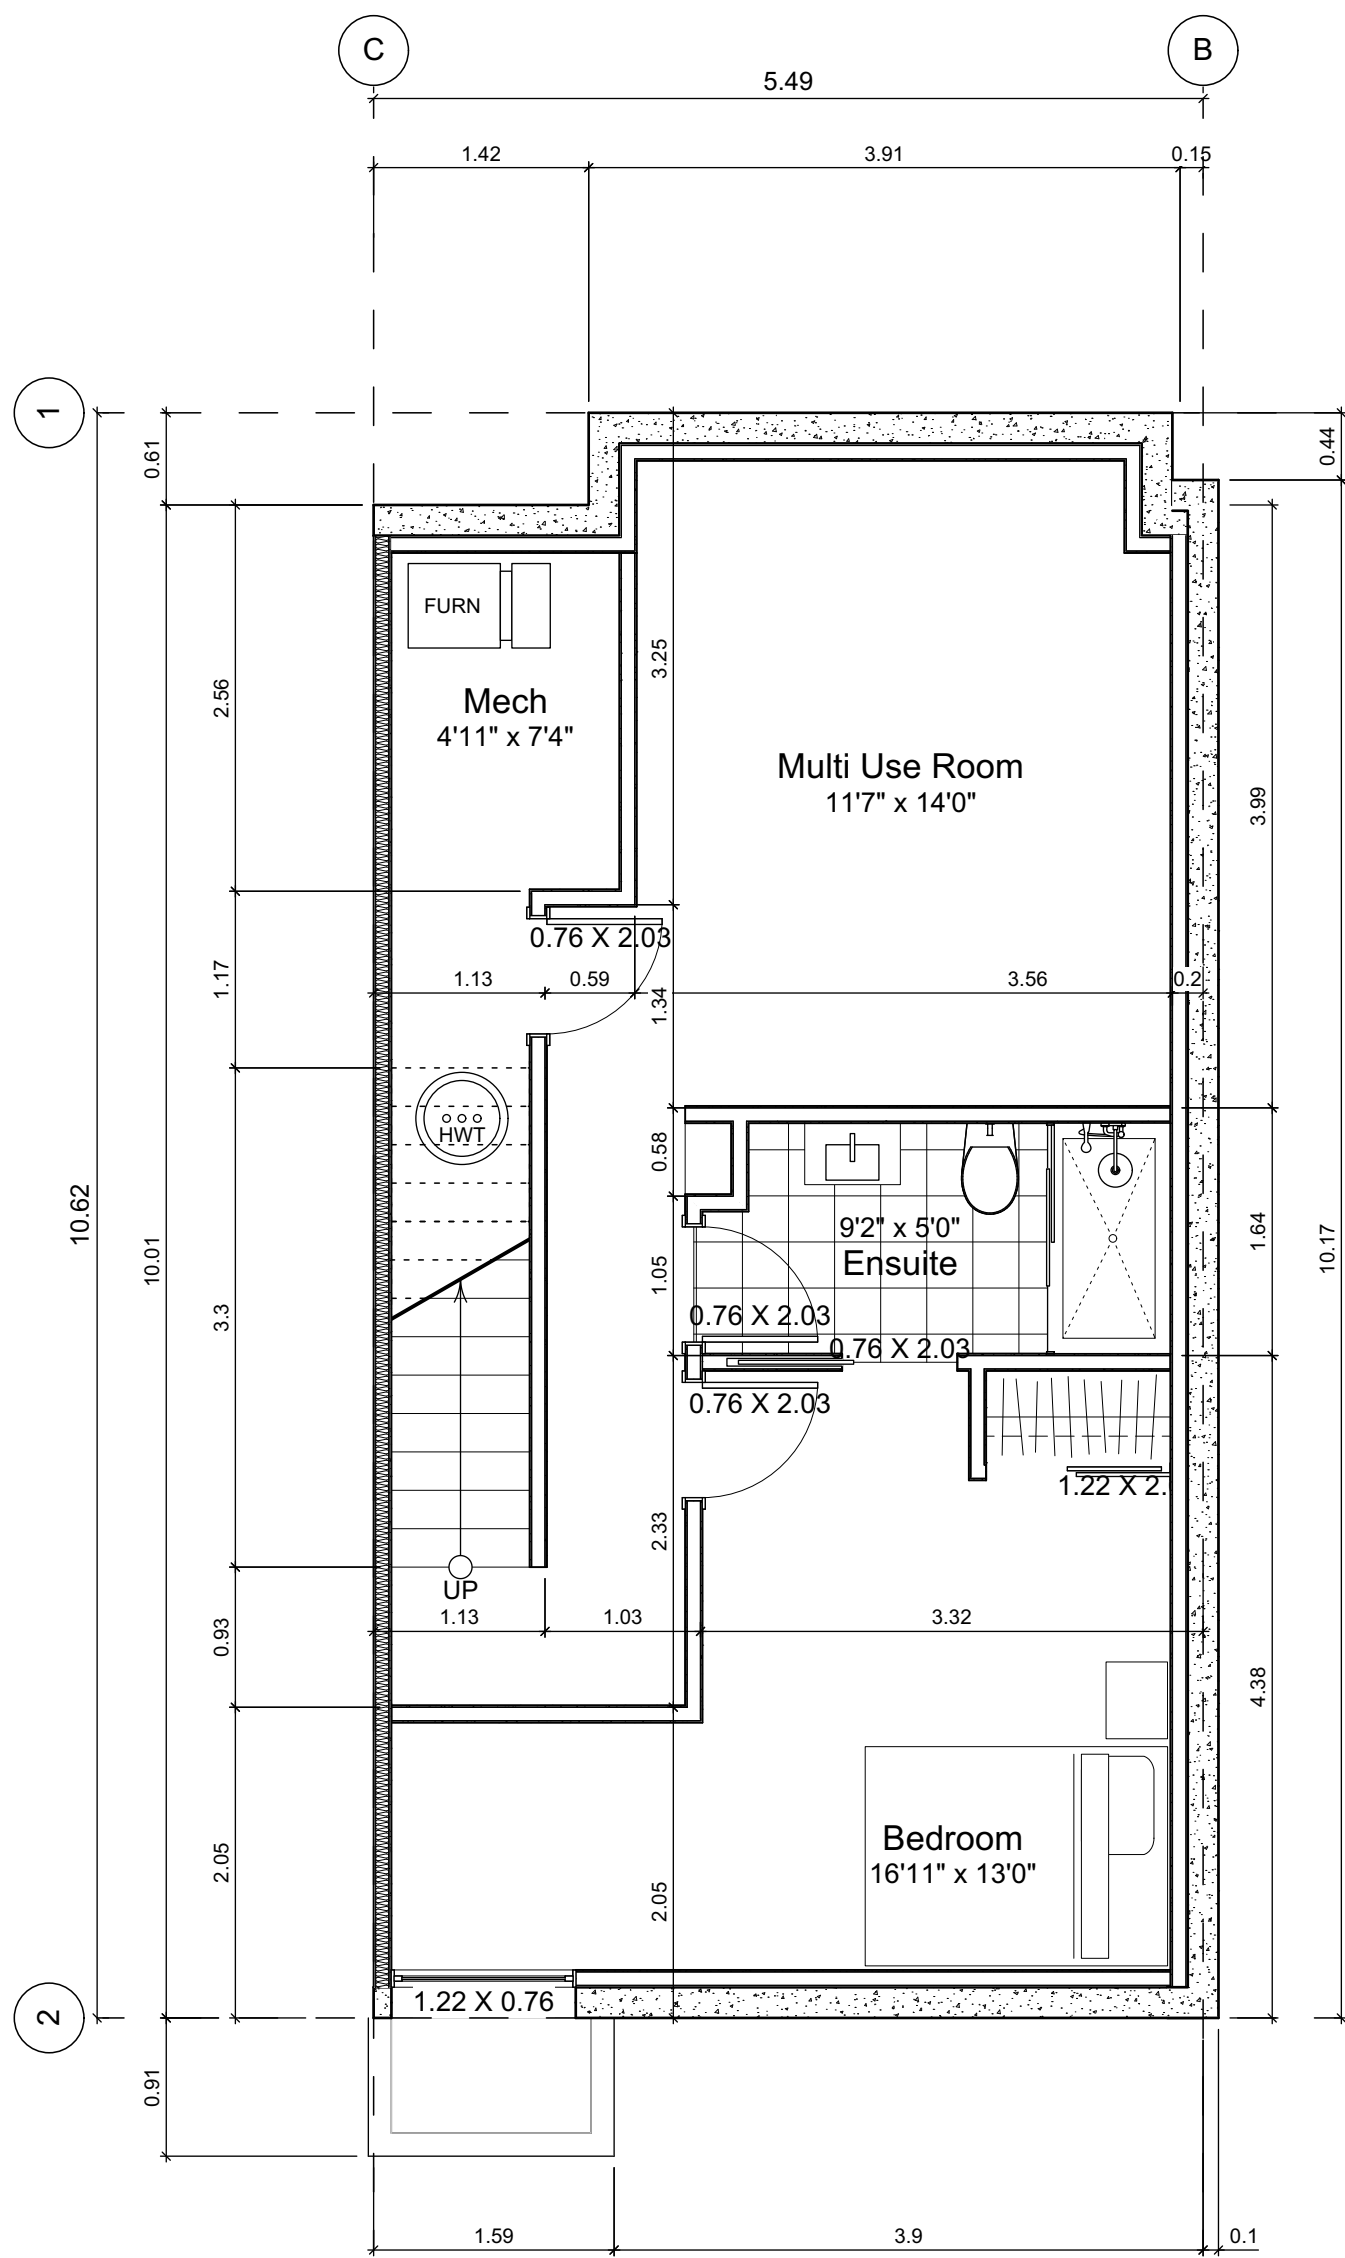

1 Main Floor Plan
Scale: 1:50



2 Second Floor Plan
Scale: 1:50

Unit Plan Notes:

See Block plan for foundation plan.

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Dimensions are to:
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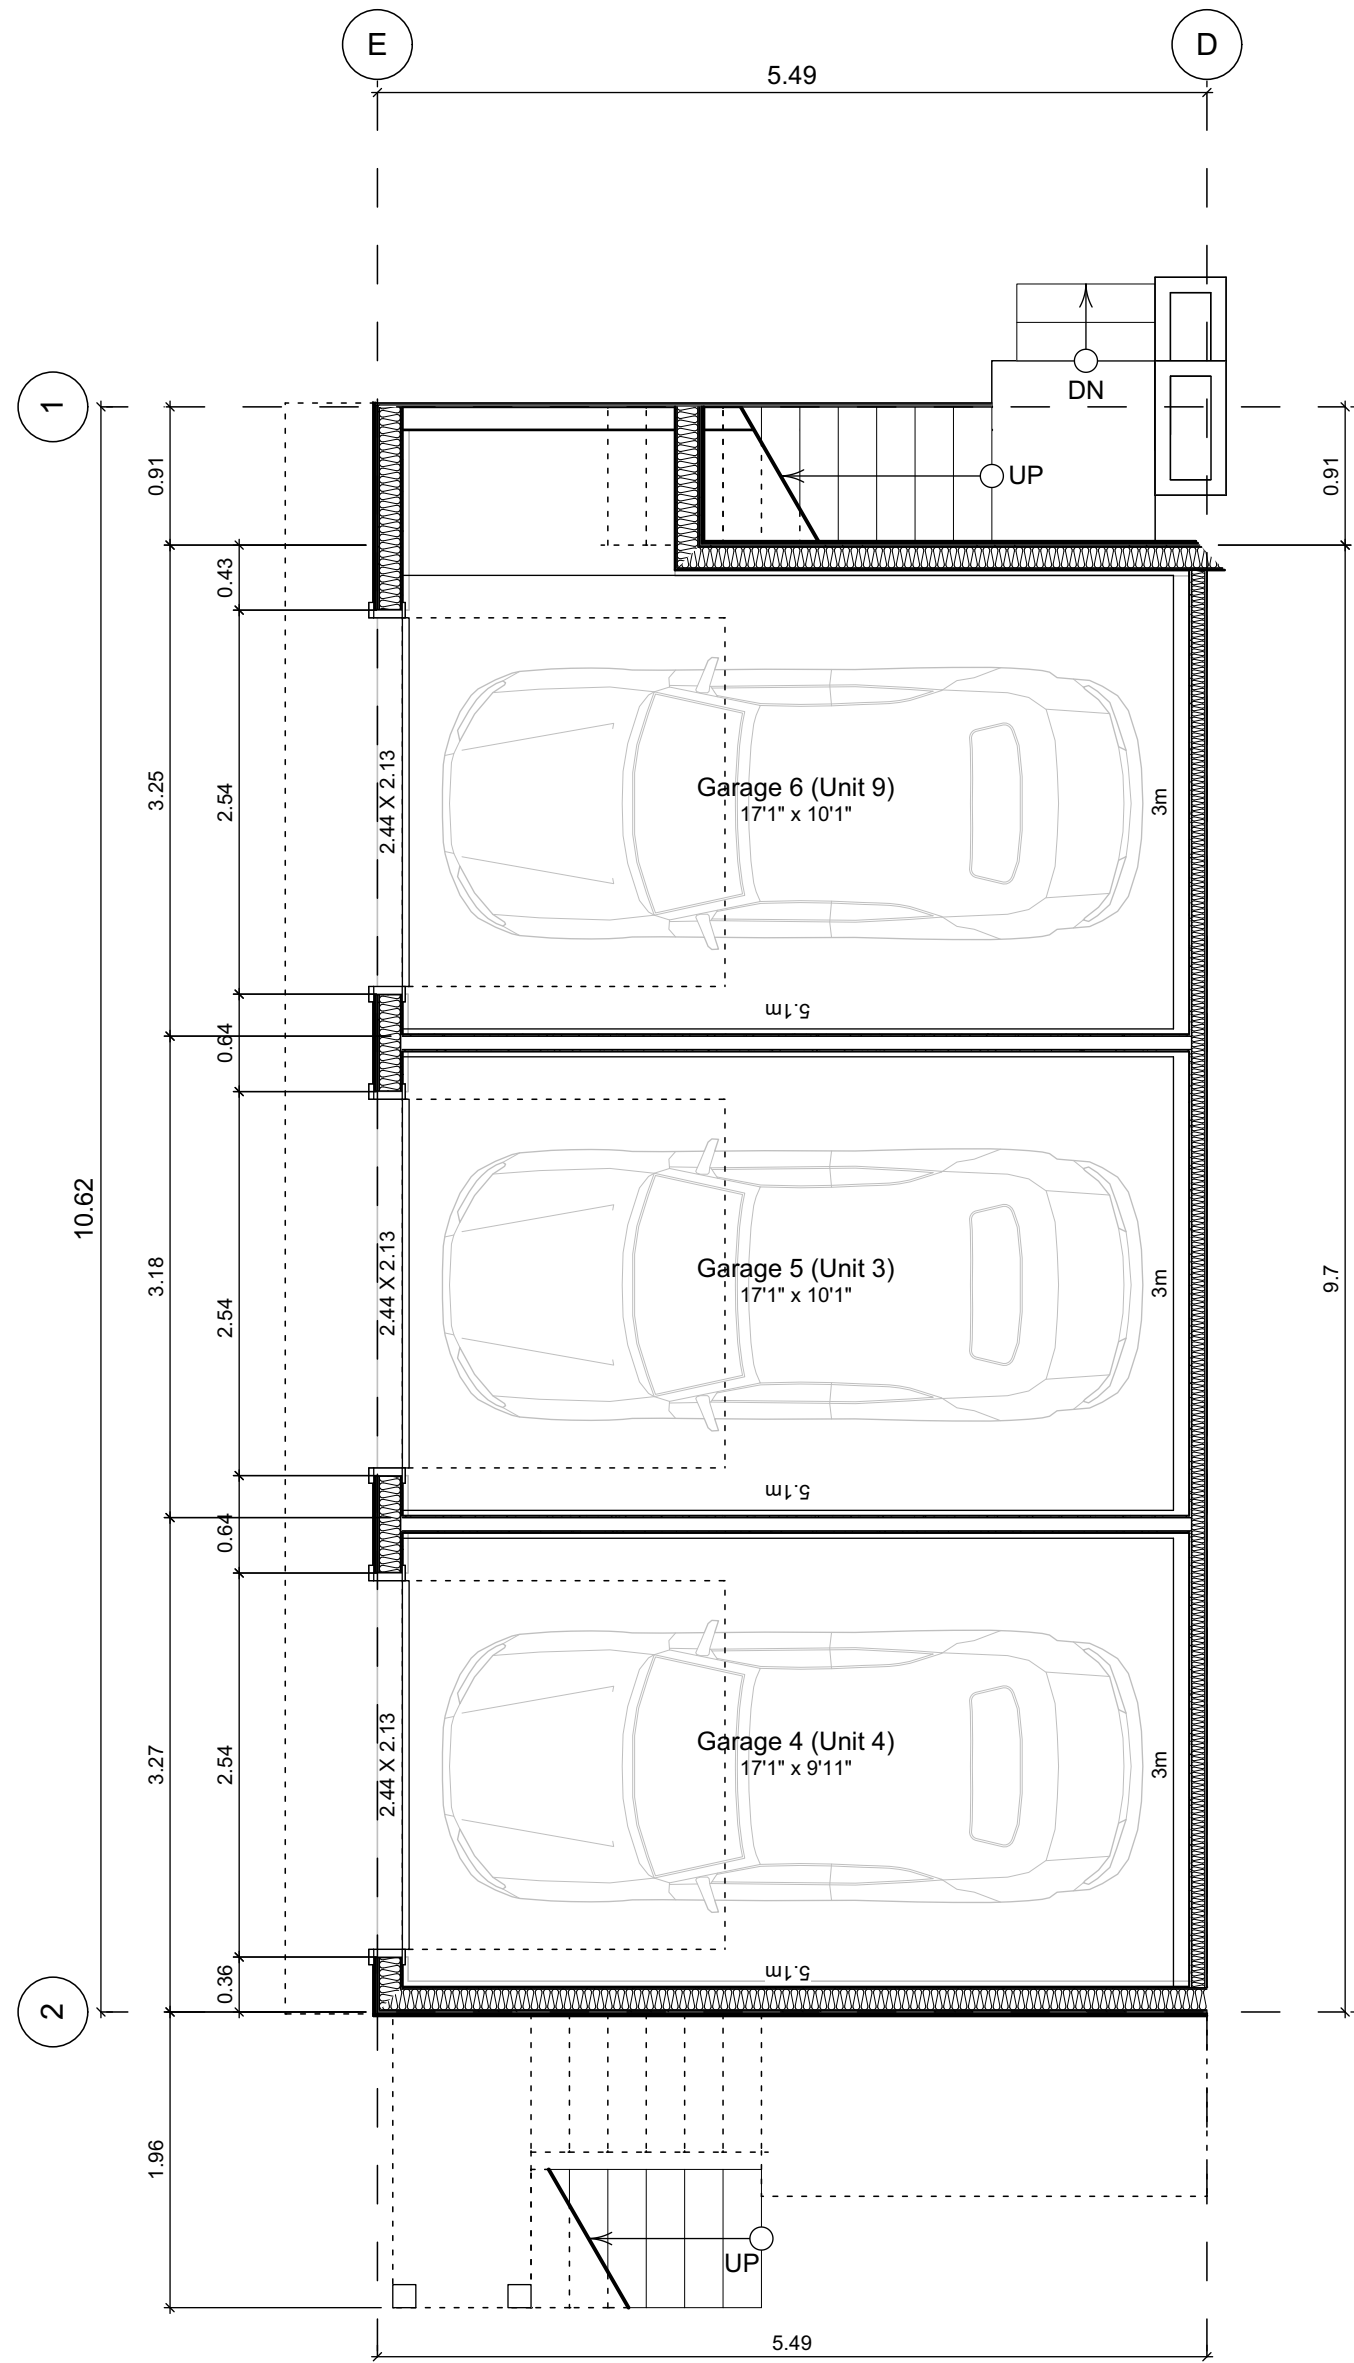
Floor Area Calculations

	Unit 3			
	Gross Floor Area		Zoning Floor Area	Bedrms
Basement Floor	617 sq ft	57.3 m2	0 sq ft	0.0 m2
Main Floor	616 sq ft	57.3 m2	605 sq ft	56.2 m2
Second Floor	589 sq ft	54.8 m2	568 sq ft	52.8 m2
Half Storey				
Totals:	1,823 sq ft	169.3 m2	1,173 sq ft	109.0 m2 3
Garage	172 sq ft	16.0 m2		


Floor Area Calculations

	Unit 2			
	Gross Floor Area		Zoning Floor Area	Bedrms
Basement Floor	622 sq ft	57.8 m2	0 sq ft	0.0 m2
Main Floor	617 sq ft	57.3 m2	629 sq ft	58.5 m2
Second Floor	589 sq ft	54.8 m2	568 sq ft	52.8 m2
Half Storey				
Totals:	1,828 sq ft	169.9 m2	1,198 sq ft	111.3 m2 3
Garage	168 sq ft	15.7 m2		


FOR DEVELOPMENT APPLICATION ONLY



4.1 Main Floor Plan
Scale: 1:50

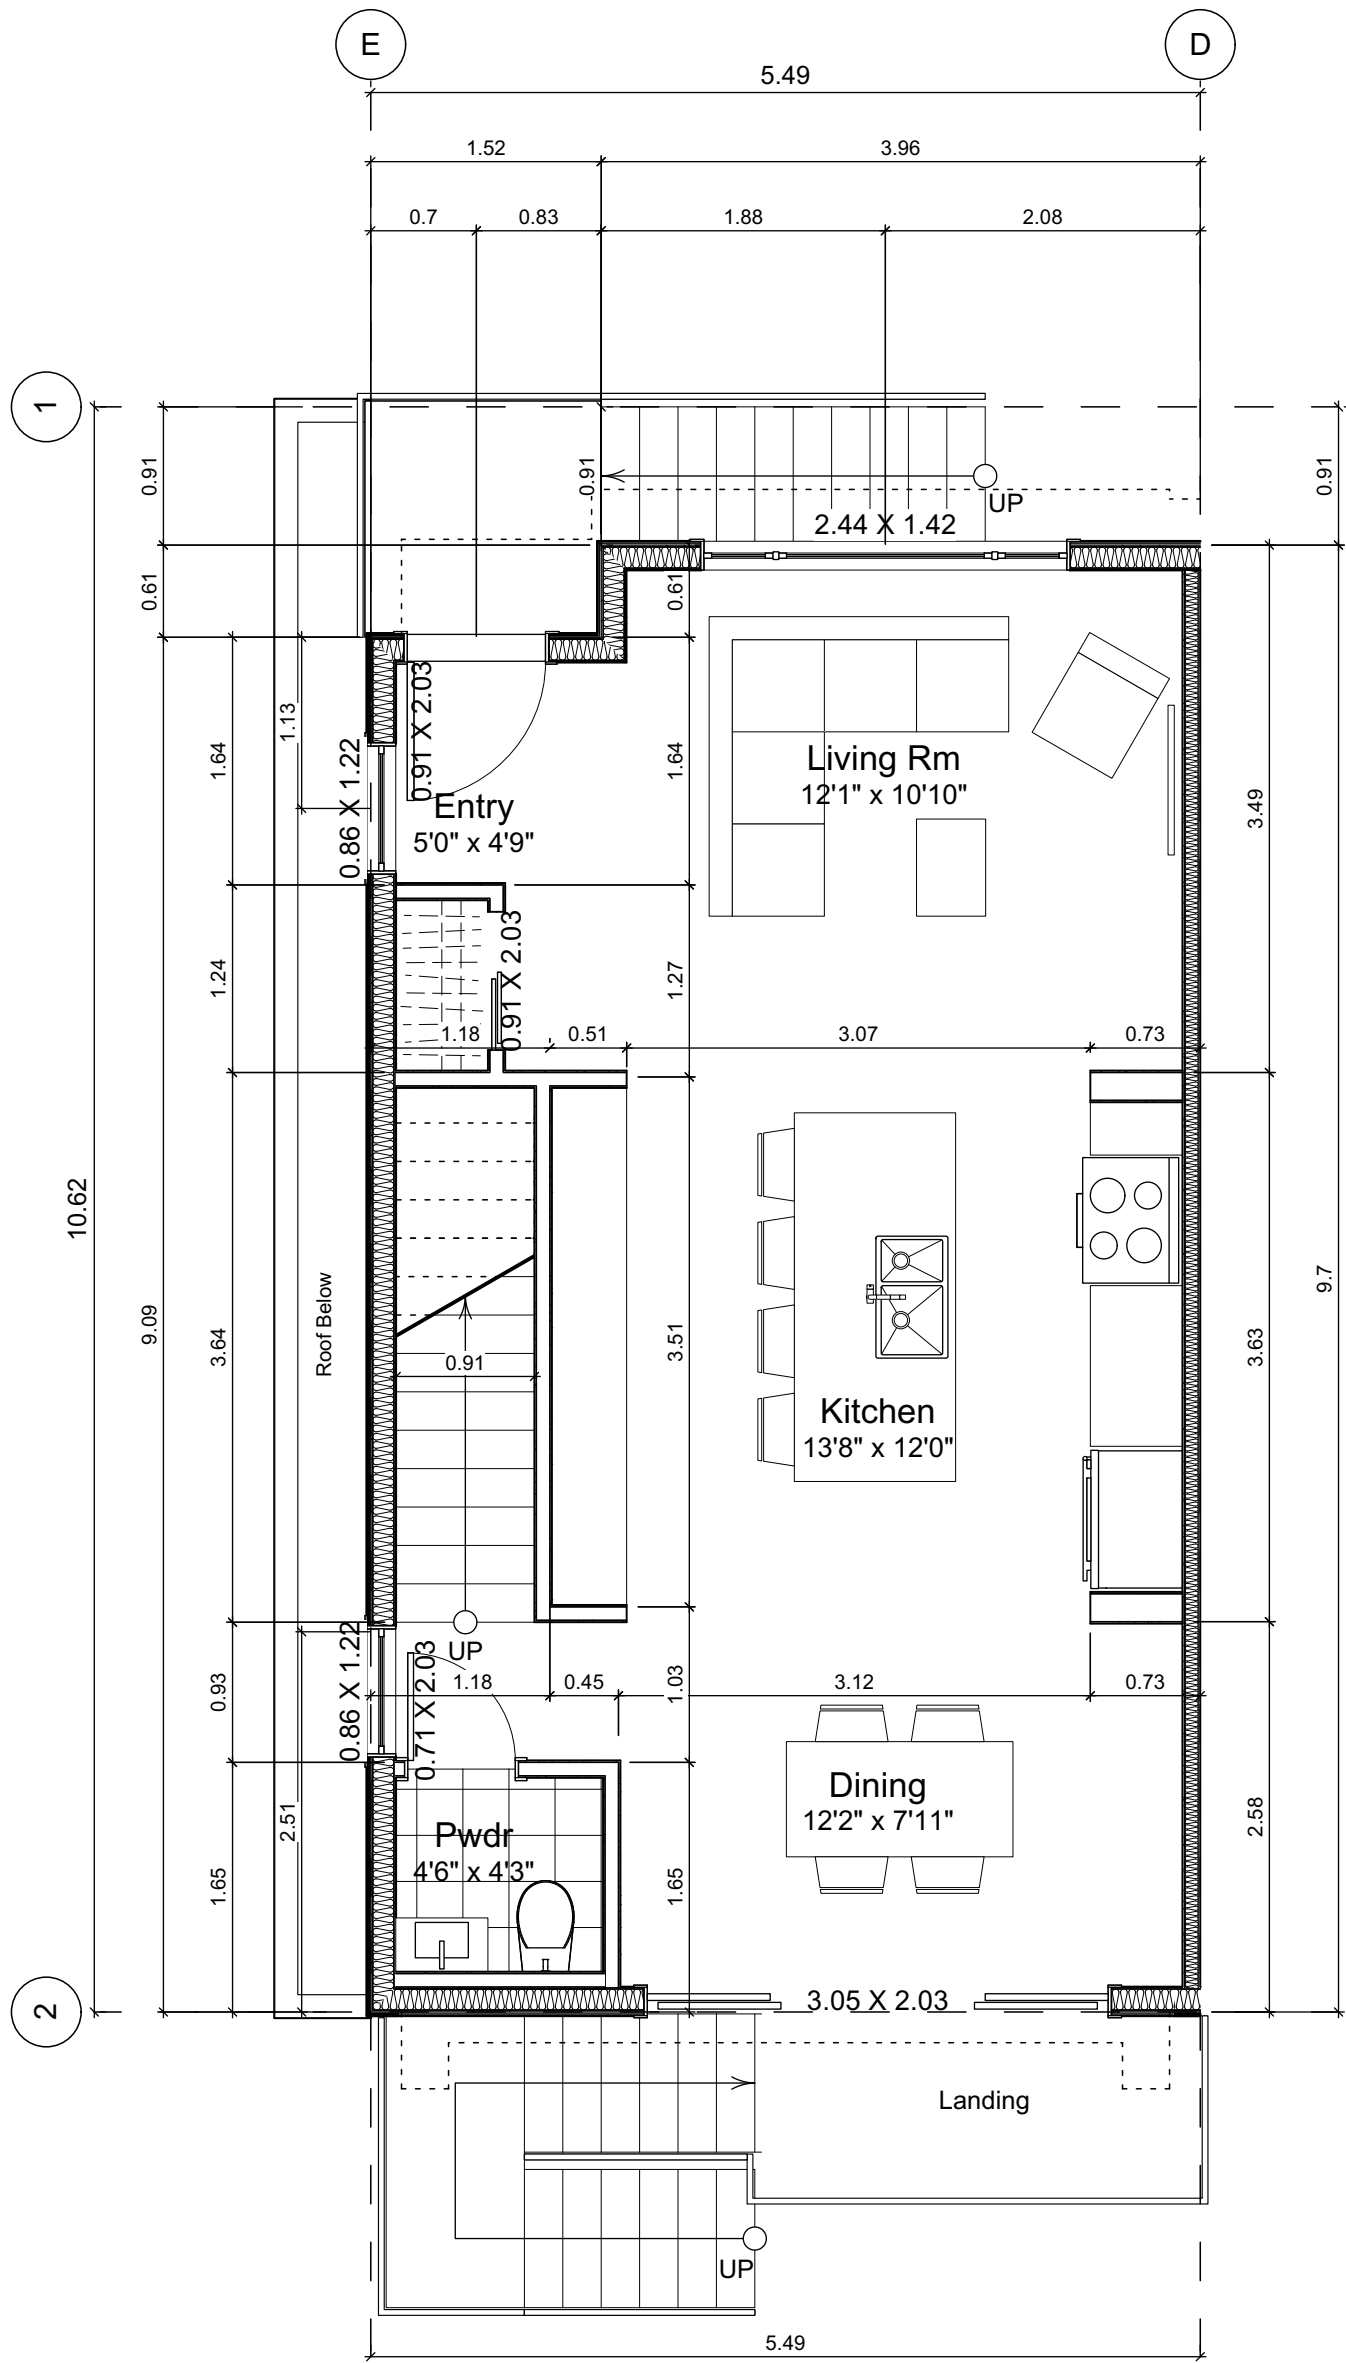

4.2 Second Floor Plan
Scale: 1:50

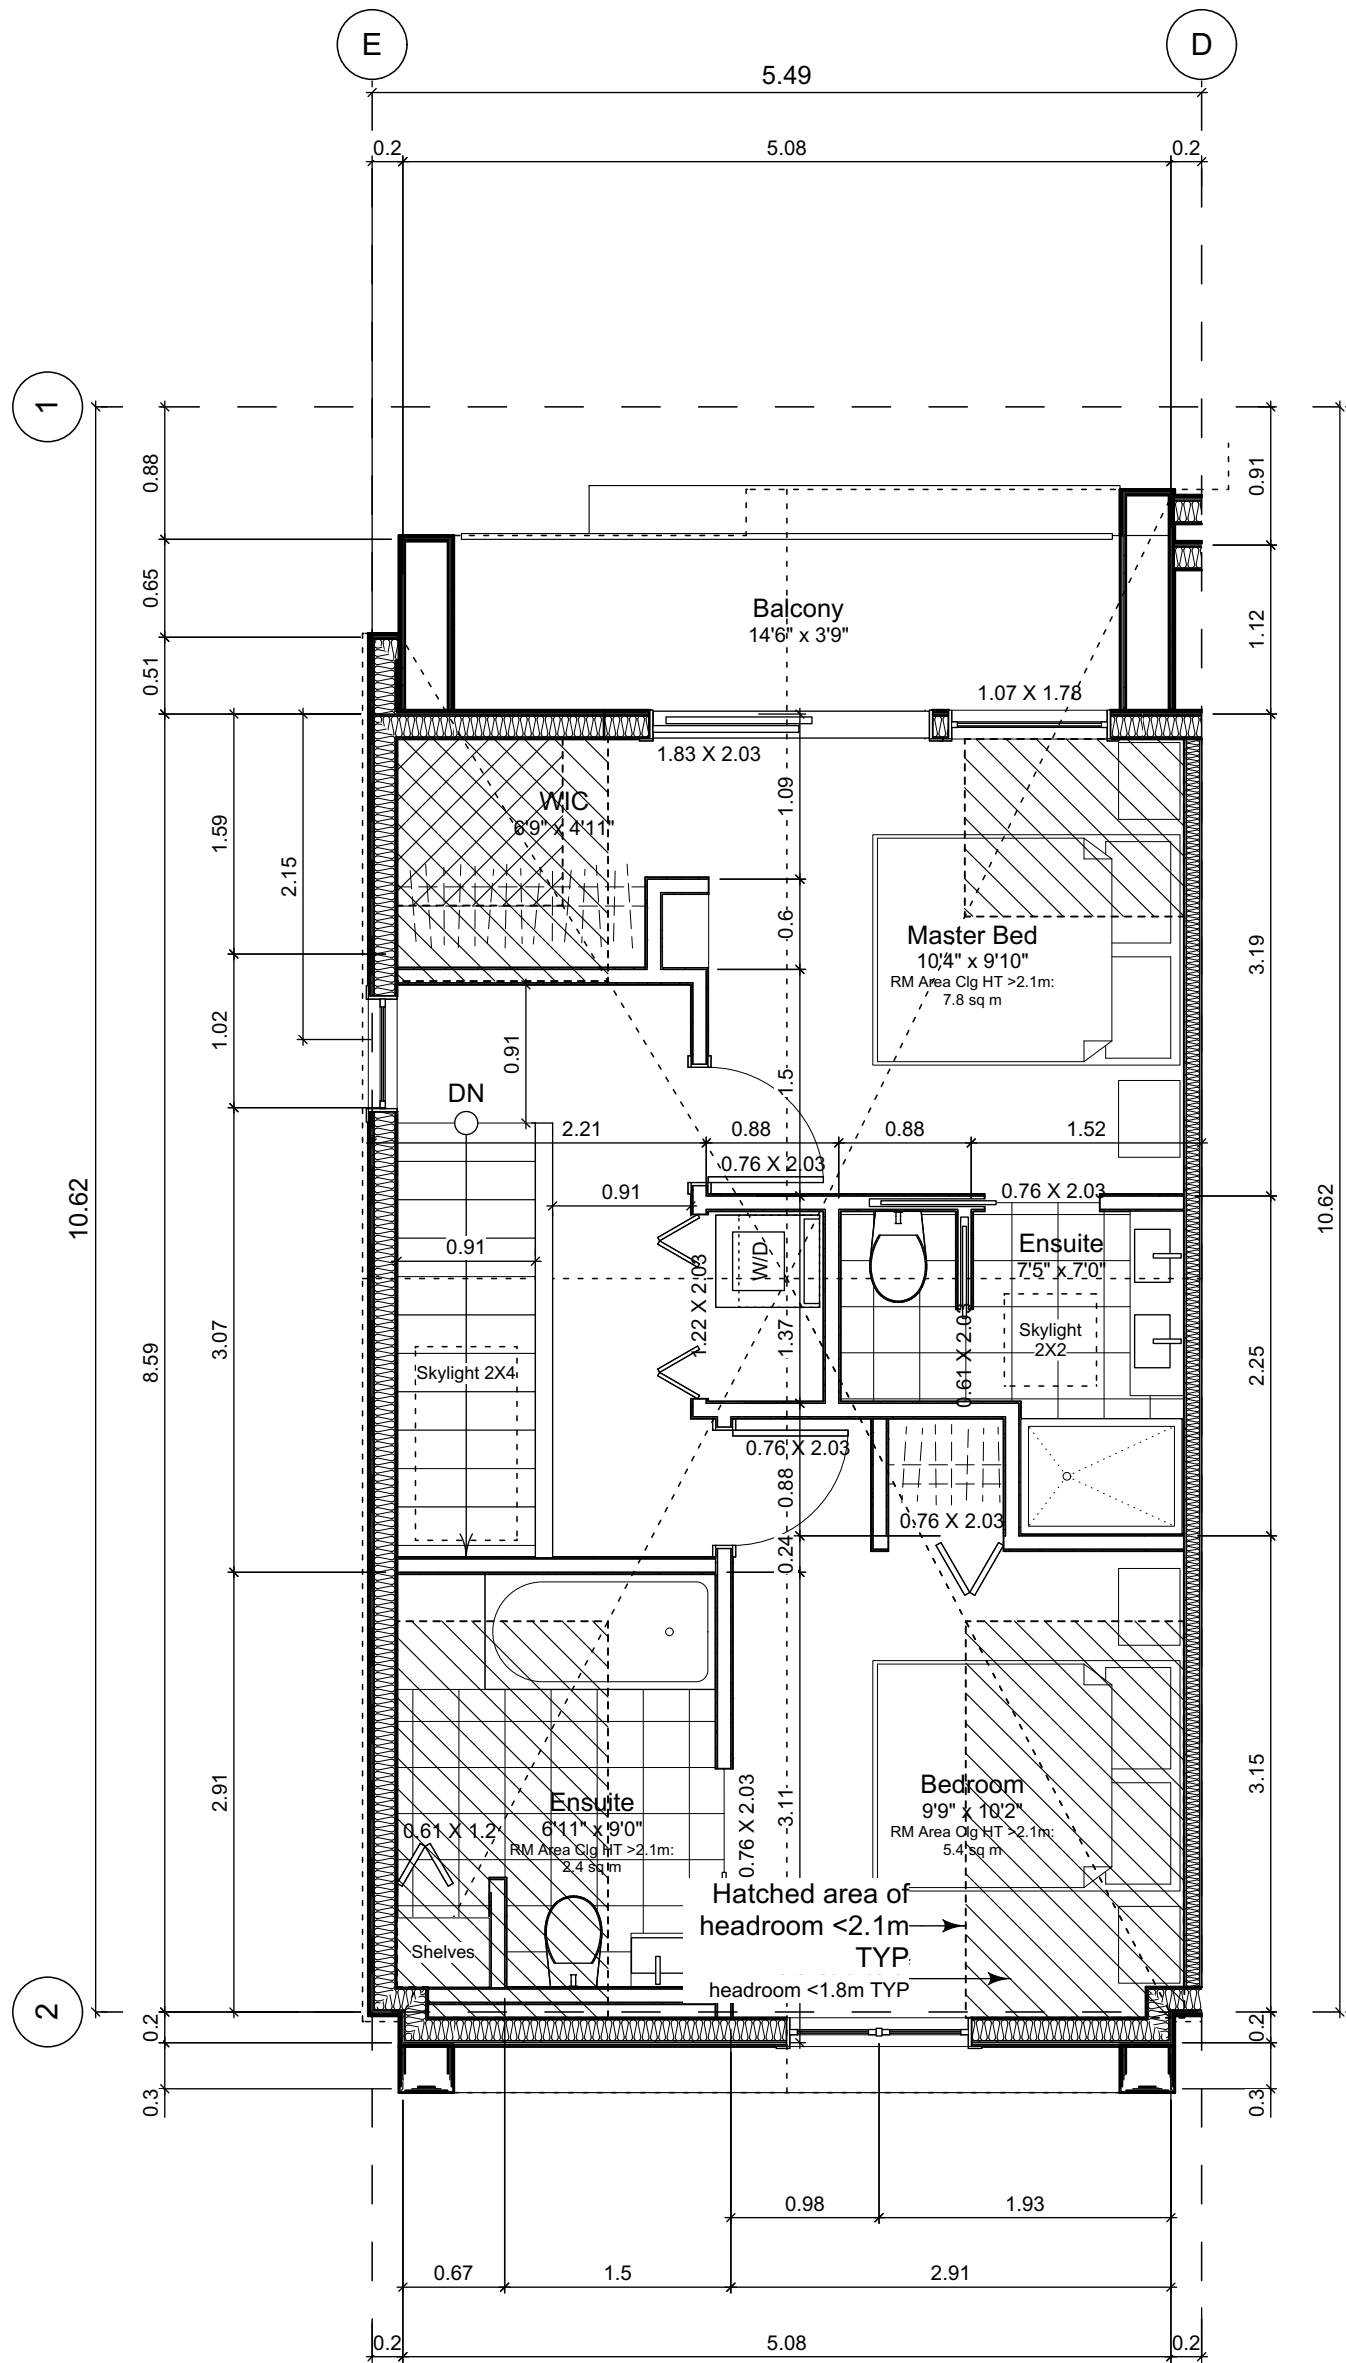

4.3 Third Floor Plan
Scale: 1:50

Unit Plan Notes:

See Block plan for foundation plan.

Grid Lines are to:
1) Outside face of plywood or
2) Centre line of demising wall.

Dimensions are to:
1) One side of interior stud,
2) Face of plywood, or face of concrete.

Floor Area Calculations

	Gross Floor Area		Zoning Floor Area		Bedrms
Basement Floor	No Basement as per zoning definition				
Main Floor	794 sq ft	73.8 m2	7 sq ft	0.6 m2	
Second Floor	563 sq ft	52.3 m2	527 sq ft	48.9 m2	
Half Storey	518 sq ft	48.1 m2	460 sq ft	42.8 m2	
Totals:	1,875 sq ft	174.2 m2	994 sq ft	92.3 m2	2
Garage	170 sq ft	15.8 m2			

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2022-04-11	Revised & Re-issued for DP
2022-05-10	Revised & Re-issued for DP
2022-10-06	Revised & Re-issued for DP
2022-11-04	Revised & Re-issued for DP
2022-11-14	Revised & Re-issued for DP
2022-11-25	Revised & Re-issued for DP

Unit 4 Floor Plans

Project Name:

Fairfield-Kipling
Development

Civic: 1400 Fairfield Rd &
349 Kipling St

Legal:

PID:


Project No: 19.015

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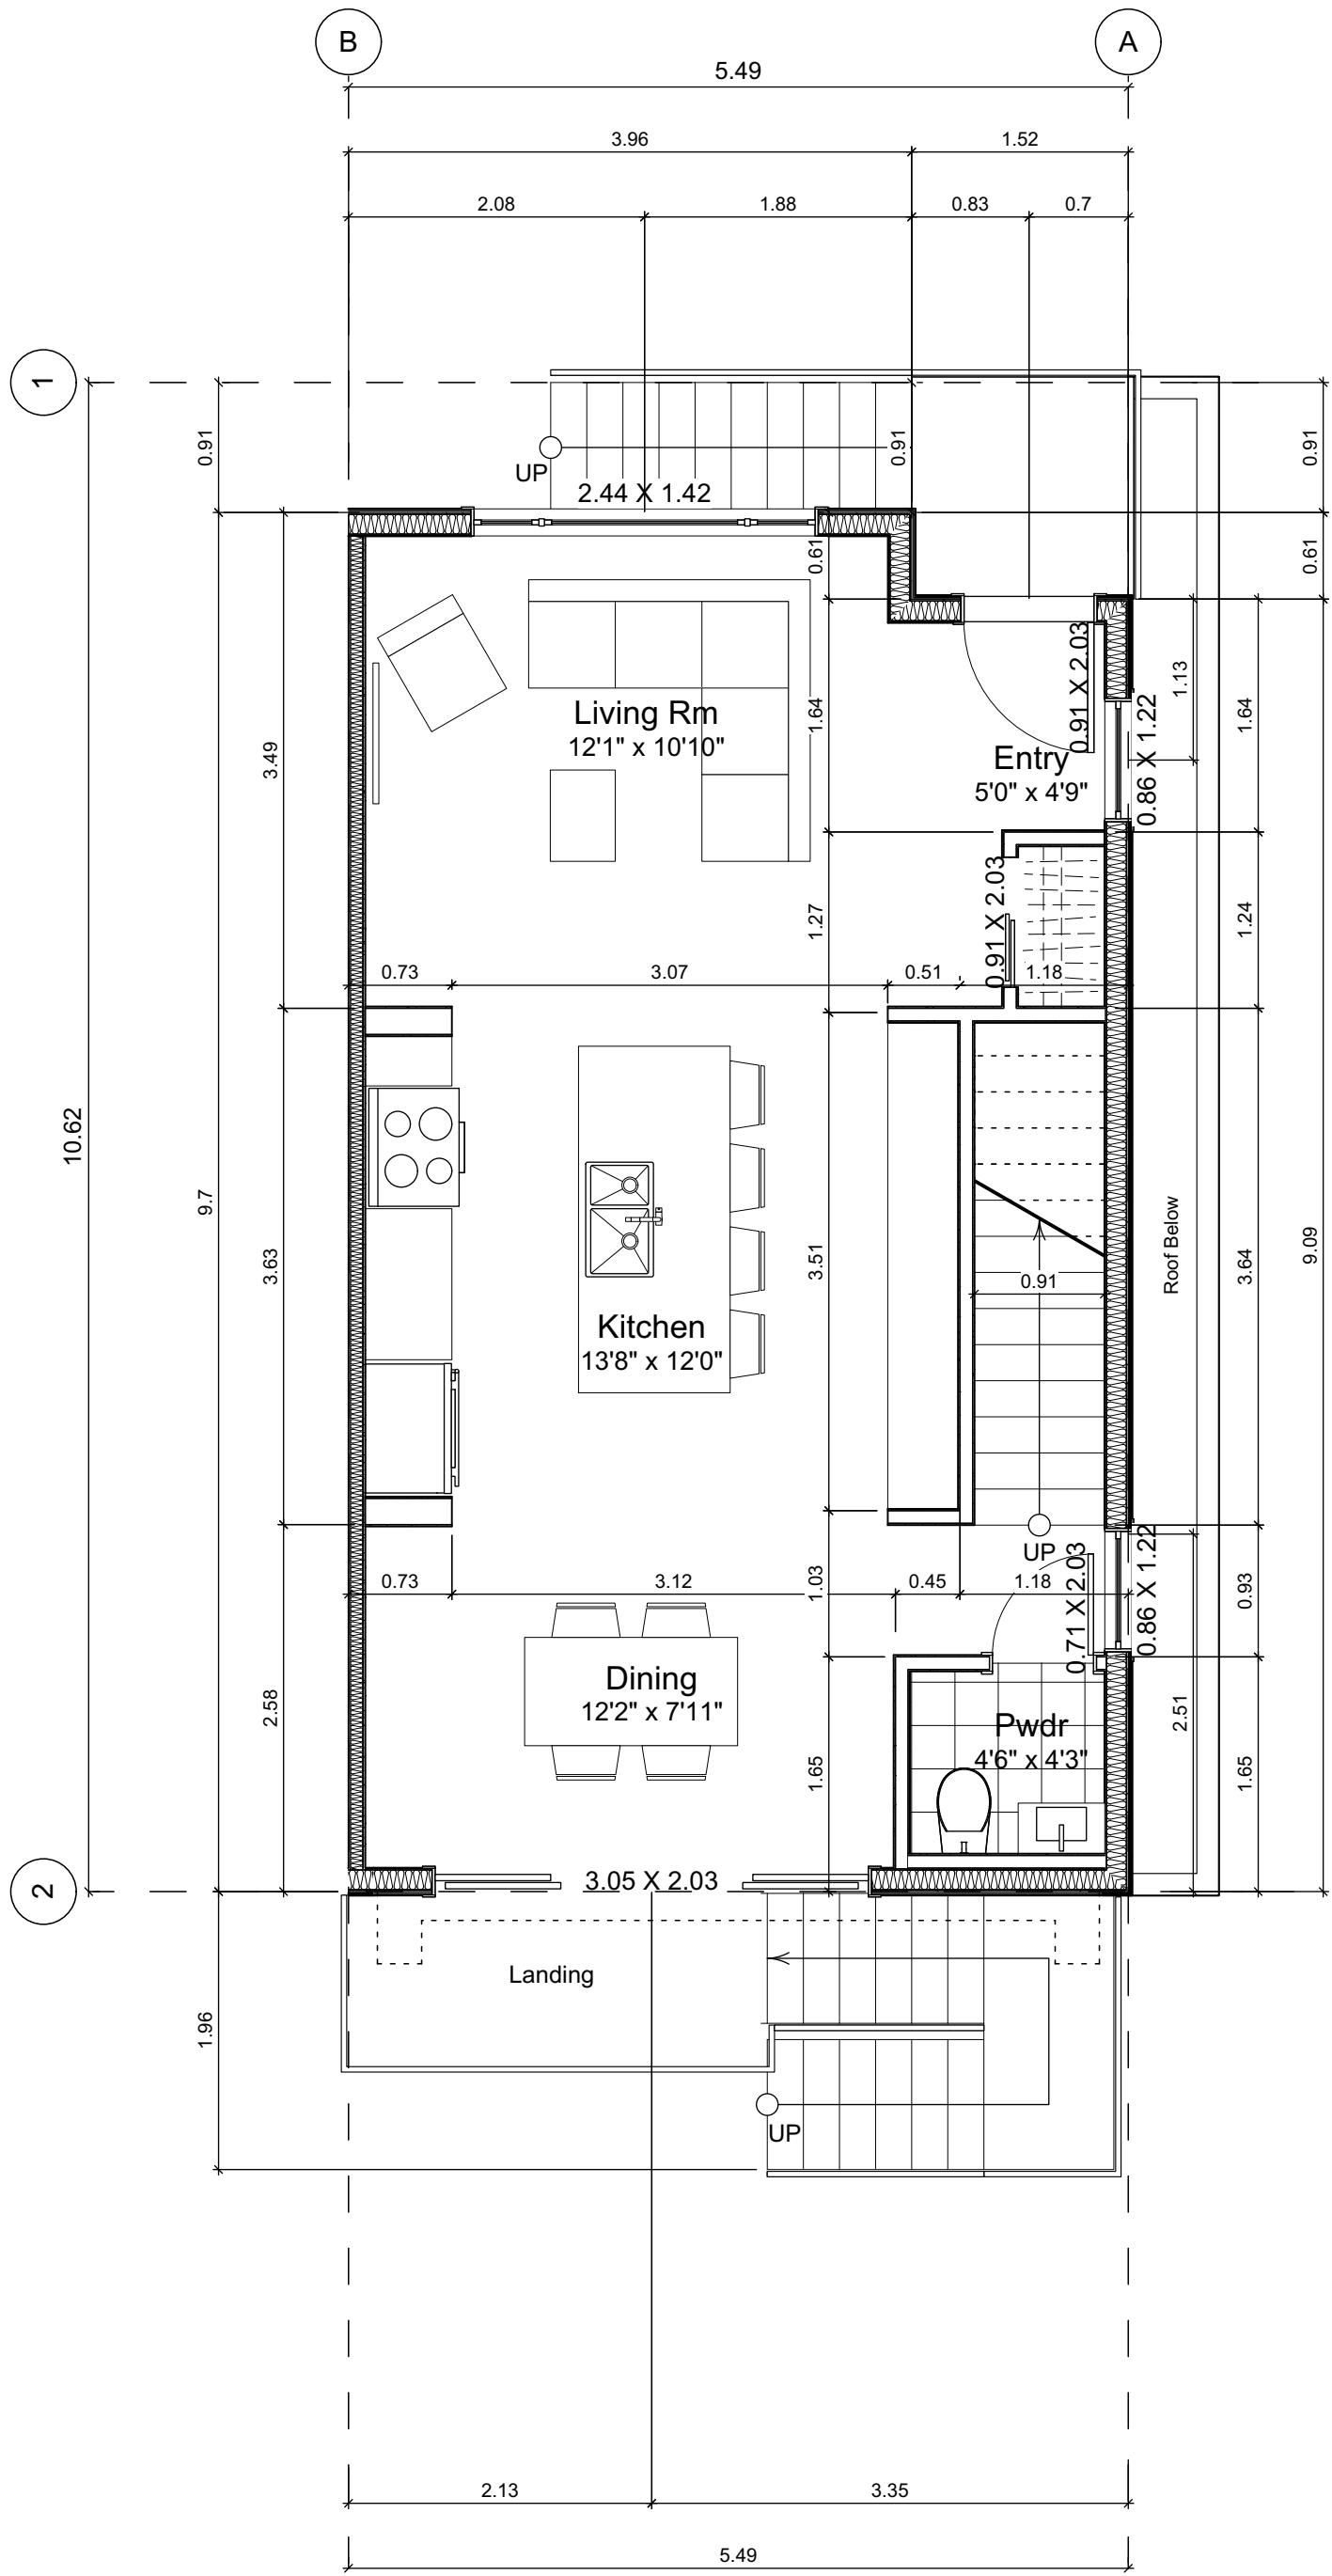
Plot Date: Nov 29, 2022

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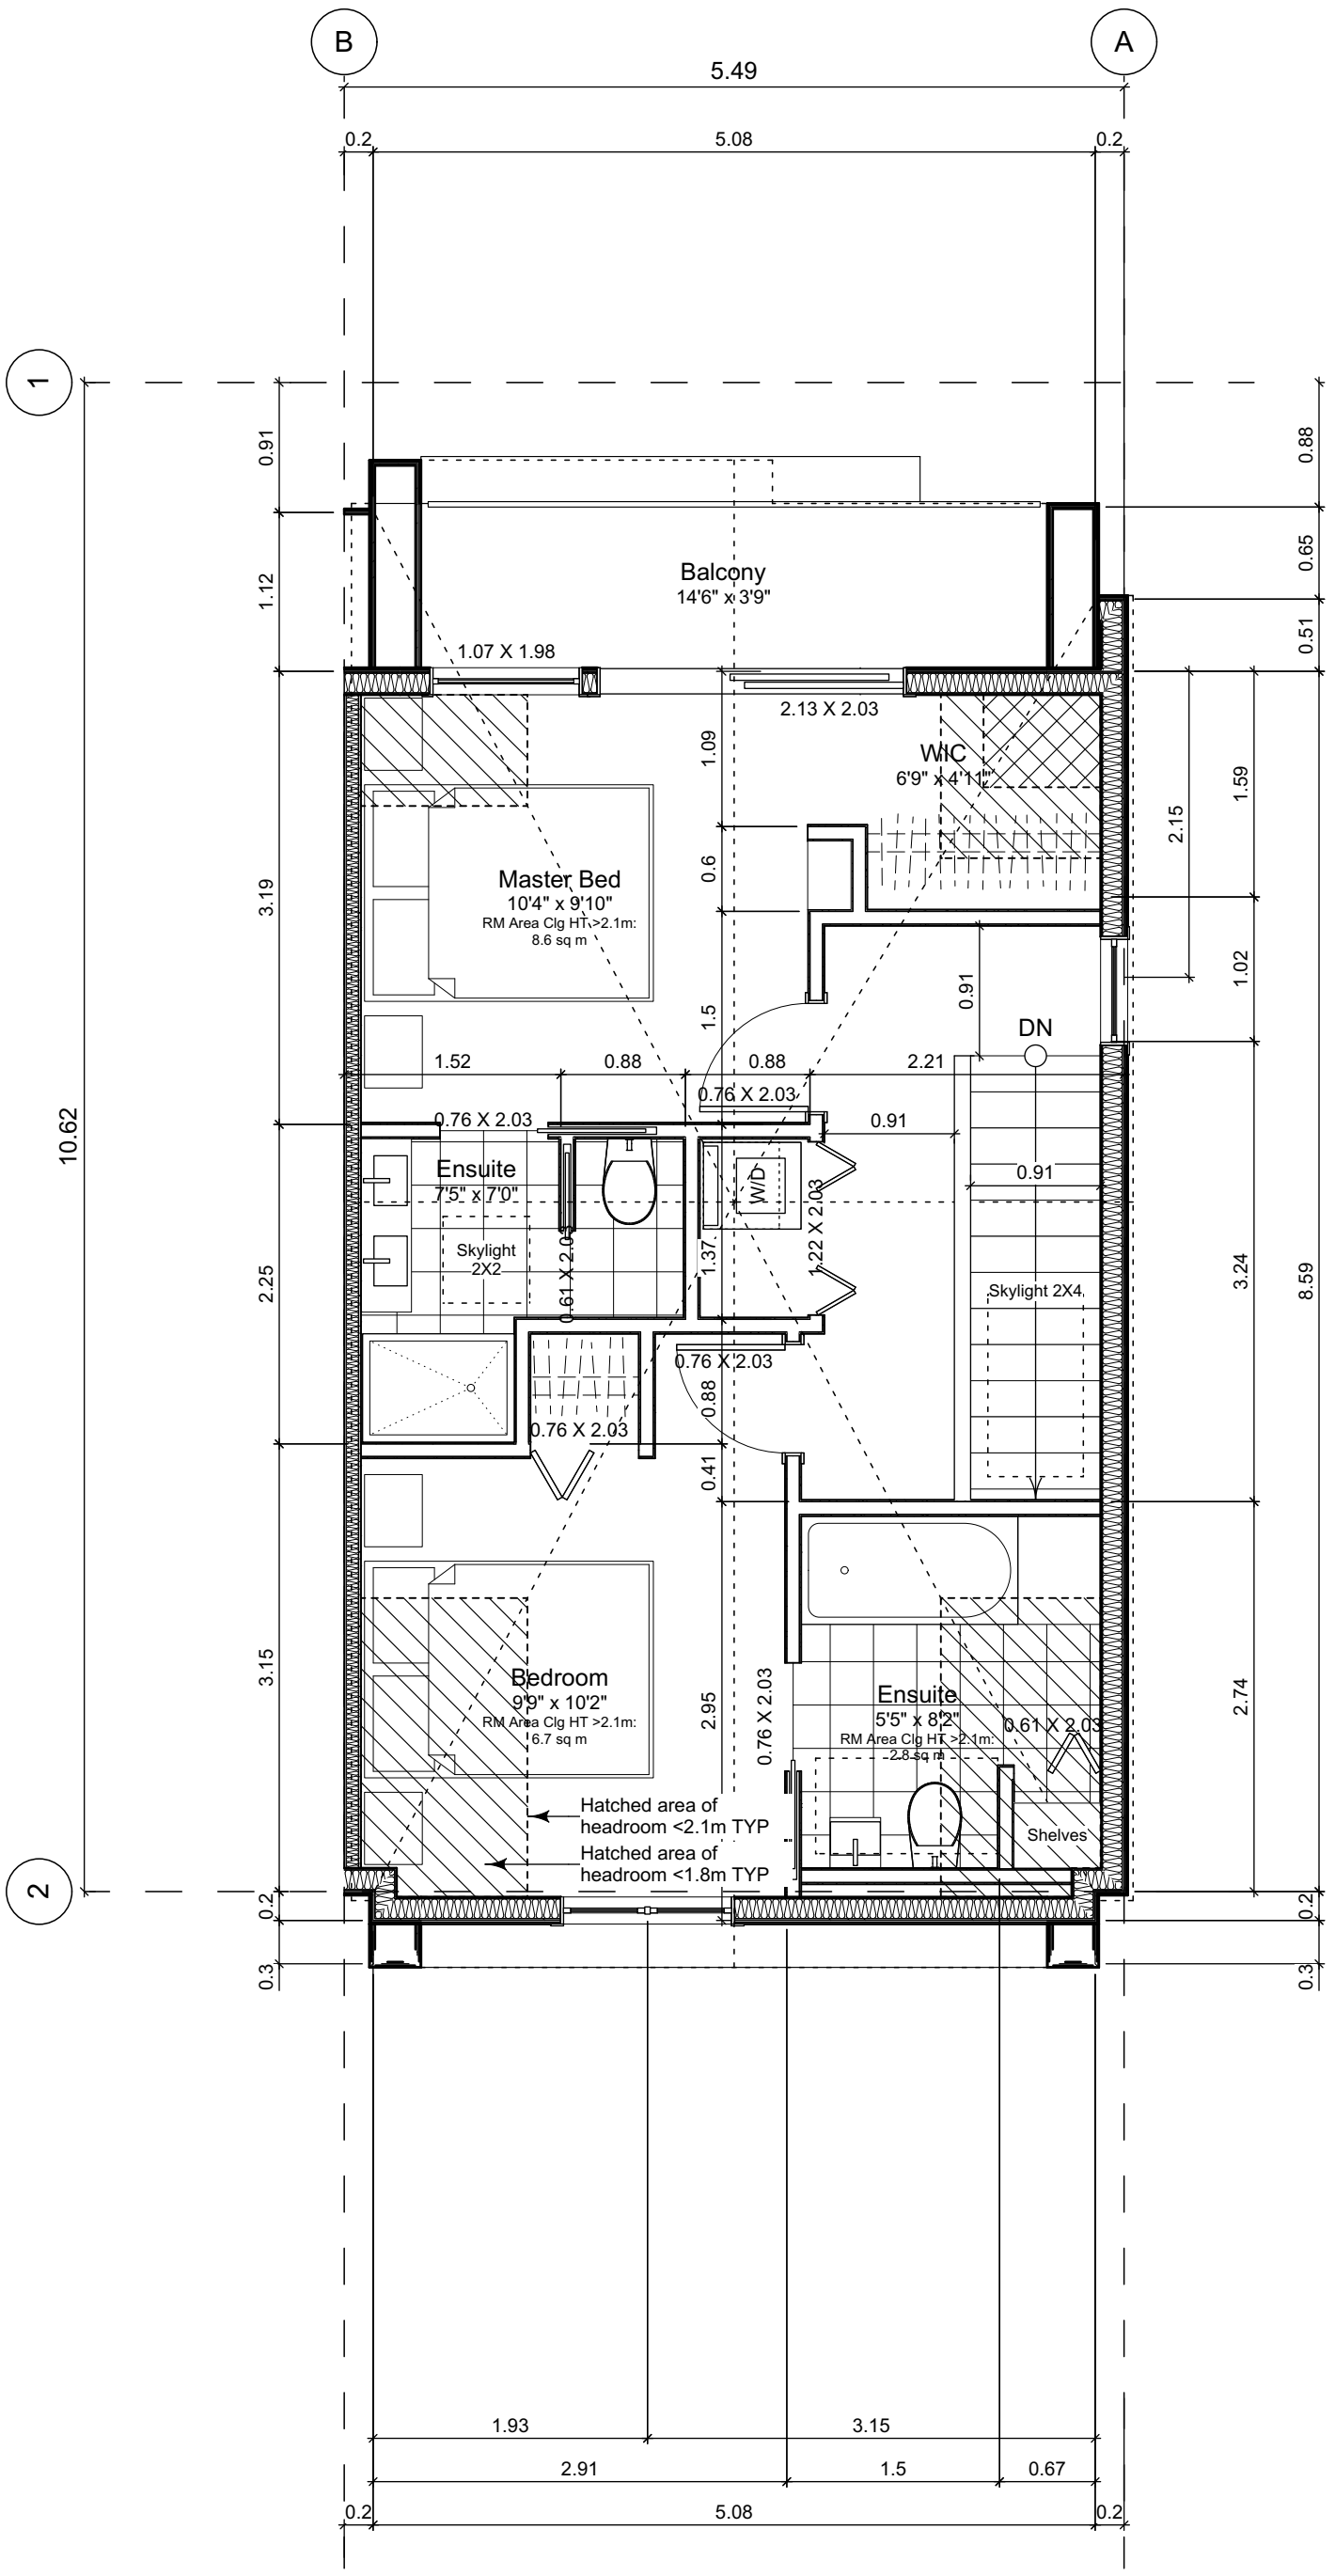
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5.1 Main Floor Plan
Scale: 1:50



5.2 Second Floor Plan
Scale: 1:50

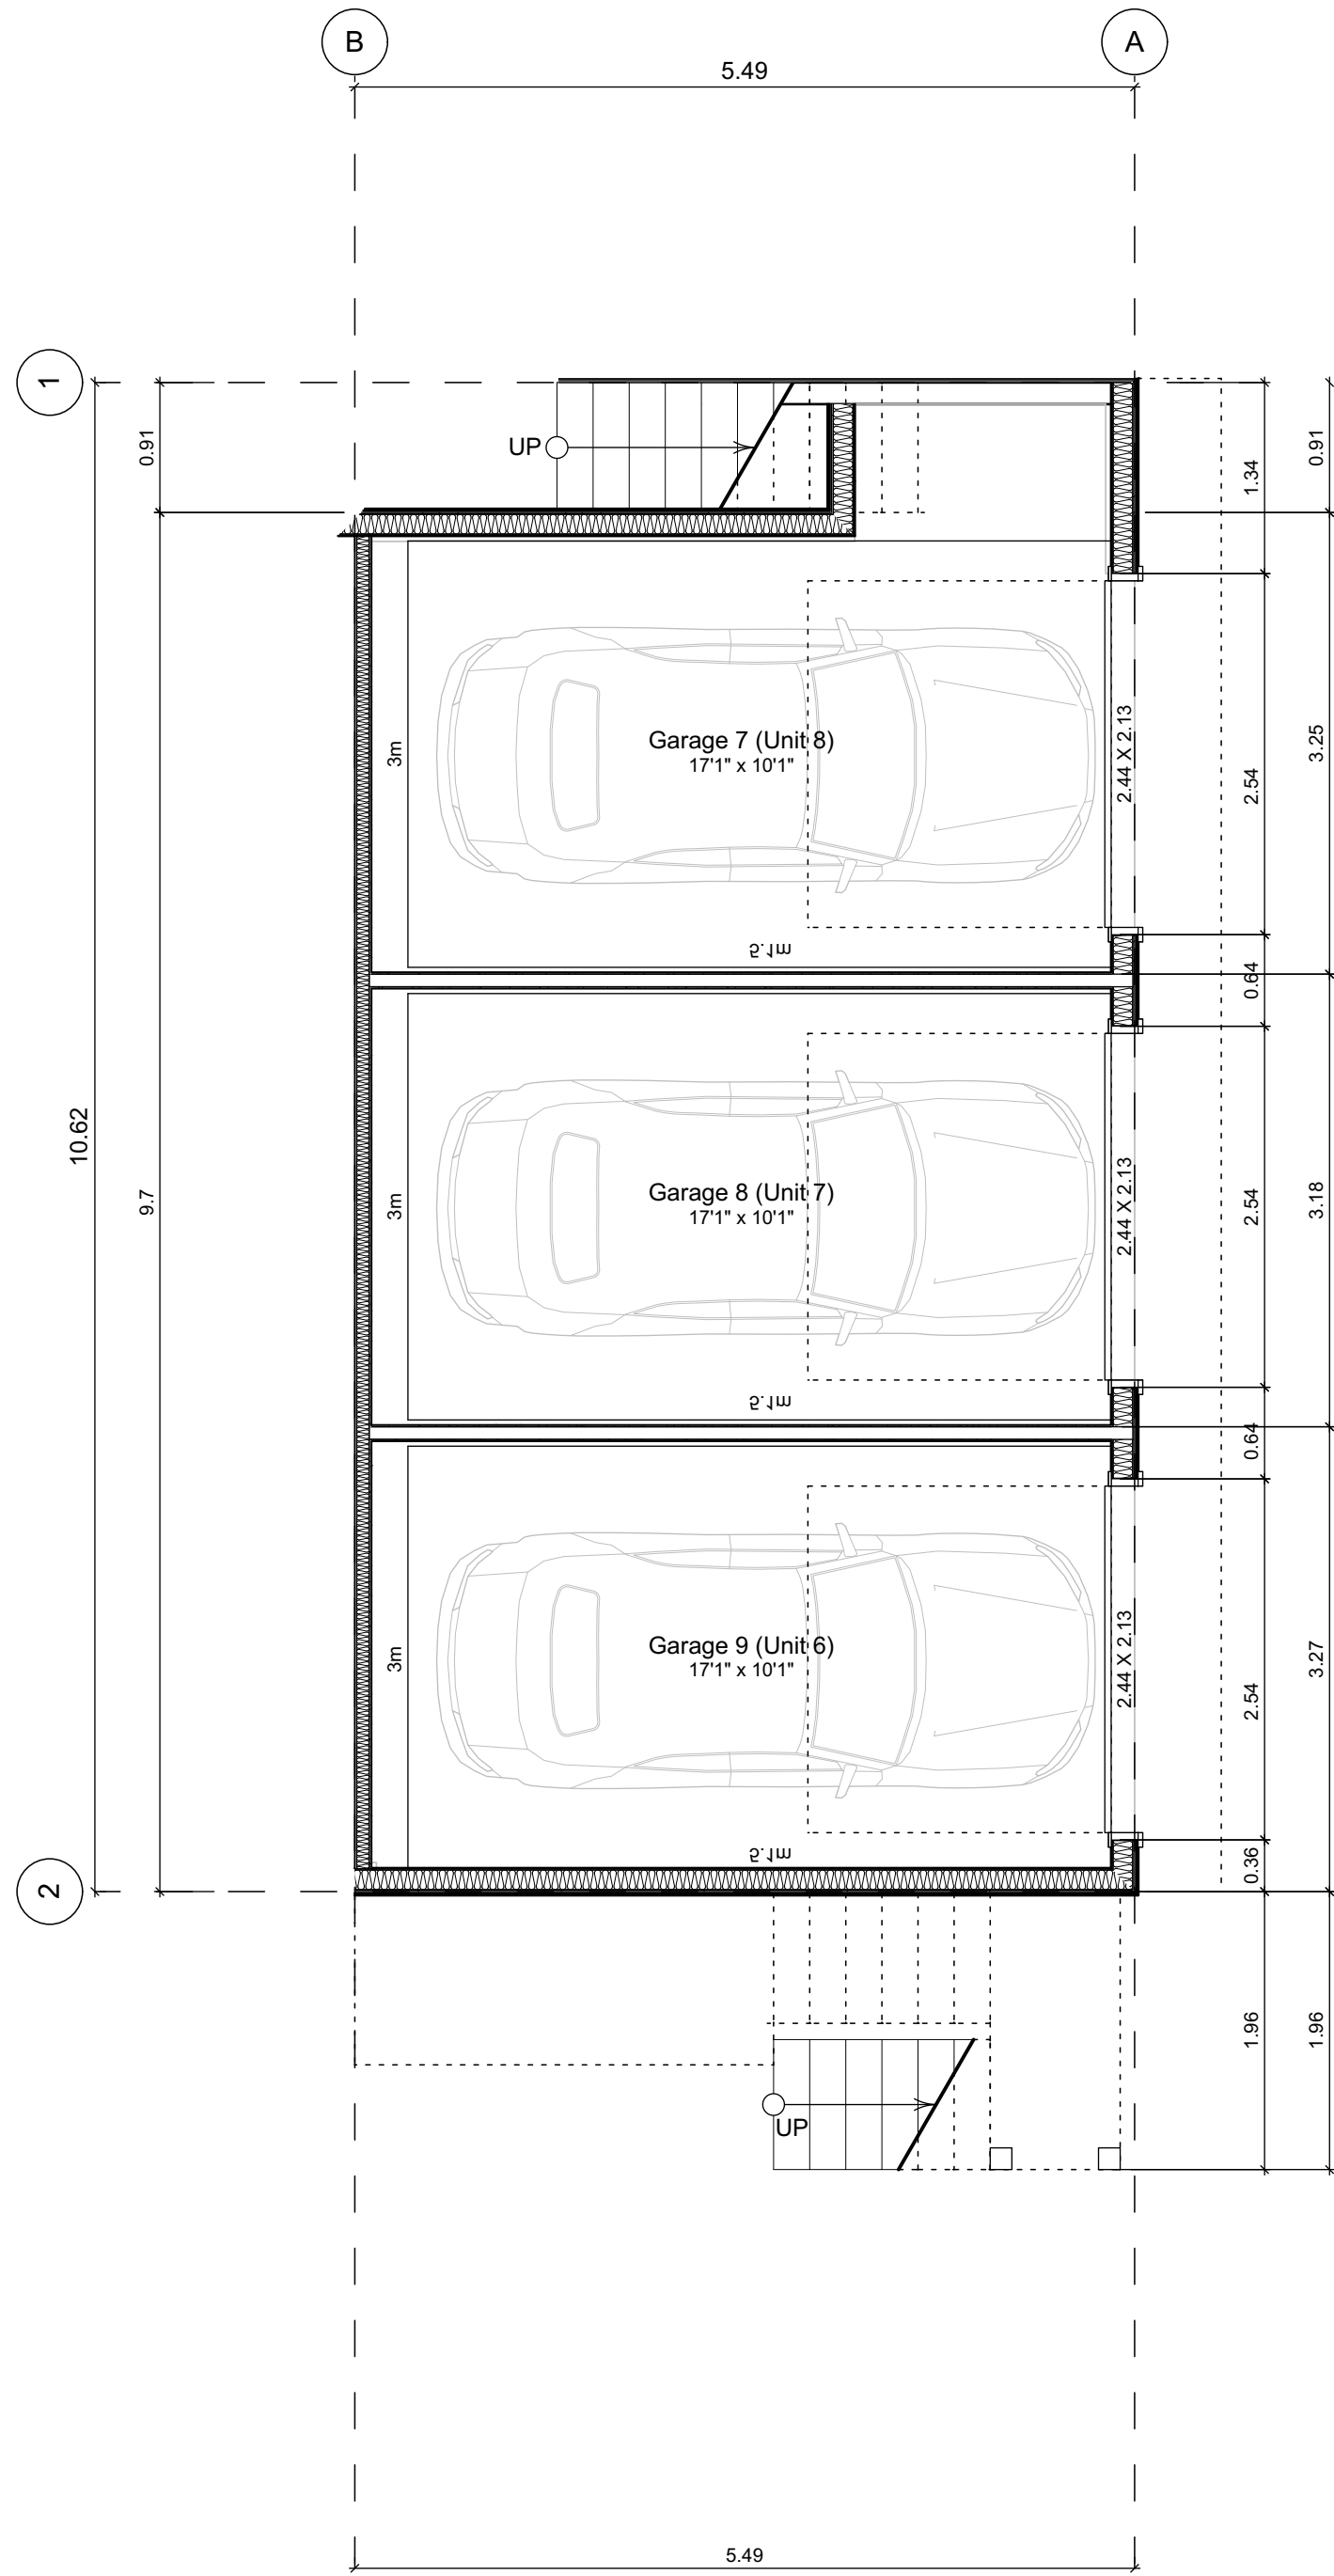

5.3 Third Floor Plan
Scale: 1:50

Unit Plan Notes:

See Block plan for foundation plan.

Grid Lines are to:
1) Outside face of plywood or
2) Centre line of demising wall.

Dimensions are to:
1) One side of interior stud,
2) Face of plywood, or face of concrete.

Floor Area Calculations

	Unit 5				
	Gross Floor Area	Zoning Floor Area	Bedrms		
Basement Floor	No Basement as per zoning definition				
Main Floor	794 sq ft	73.7 m2	0 sq ft	0.0 m2	
Second Floor	563 sq ft	52.3 m2	527 sq ft	48.9 m2	
Half Storey	518 sq ft	48.1 m2	467 sq ft	43.4 m2	
Totals:	1,875 sq ft	174.2 m2	994 sq ft	92.4 m2	2
Garage	0 sq ft	0.0 m2			

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2022-11-04	Revised & Re-issued for DP
2022-11-14	Revised & Re-issued for DP
2022-11-25	Revised & Re-issued for DP

Unit 5 Floor Plans

Project Name:

Fairfield-Kipling
Development

Civic: 1400 Fairfield Rd &
349 Kipling St

Legal:

PID:


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Drawn By: SG/TD


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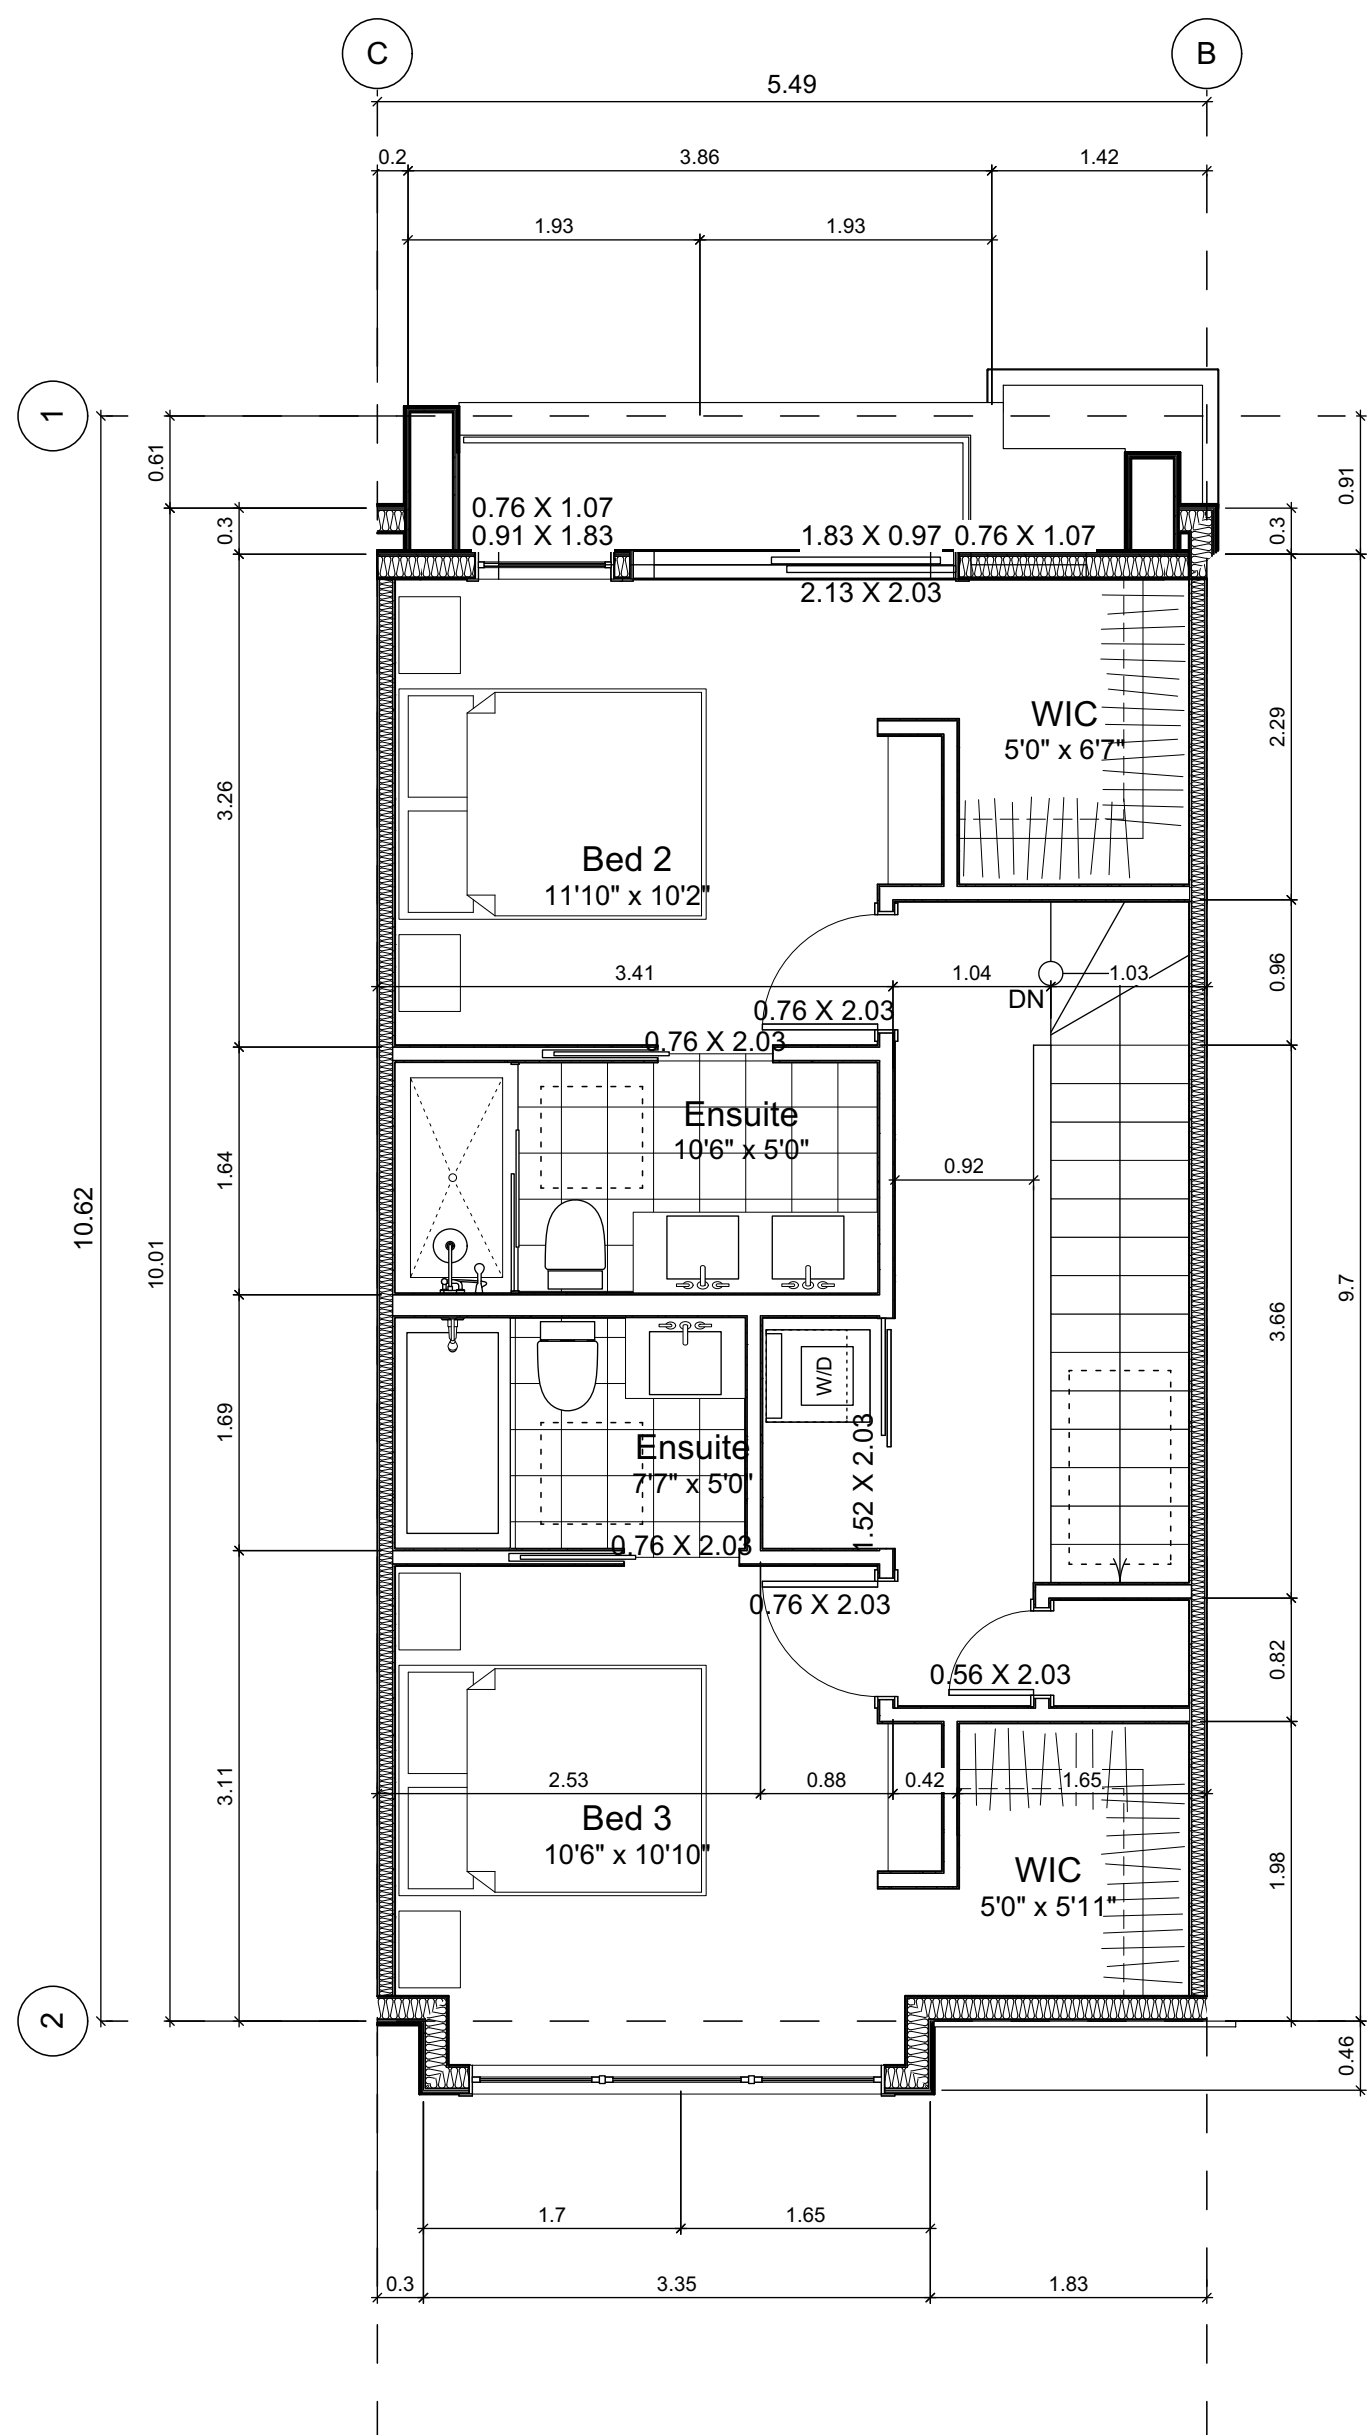
Sheet No:



6.1 Basement Floor Plan
Scale: 1:50

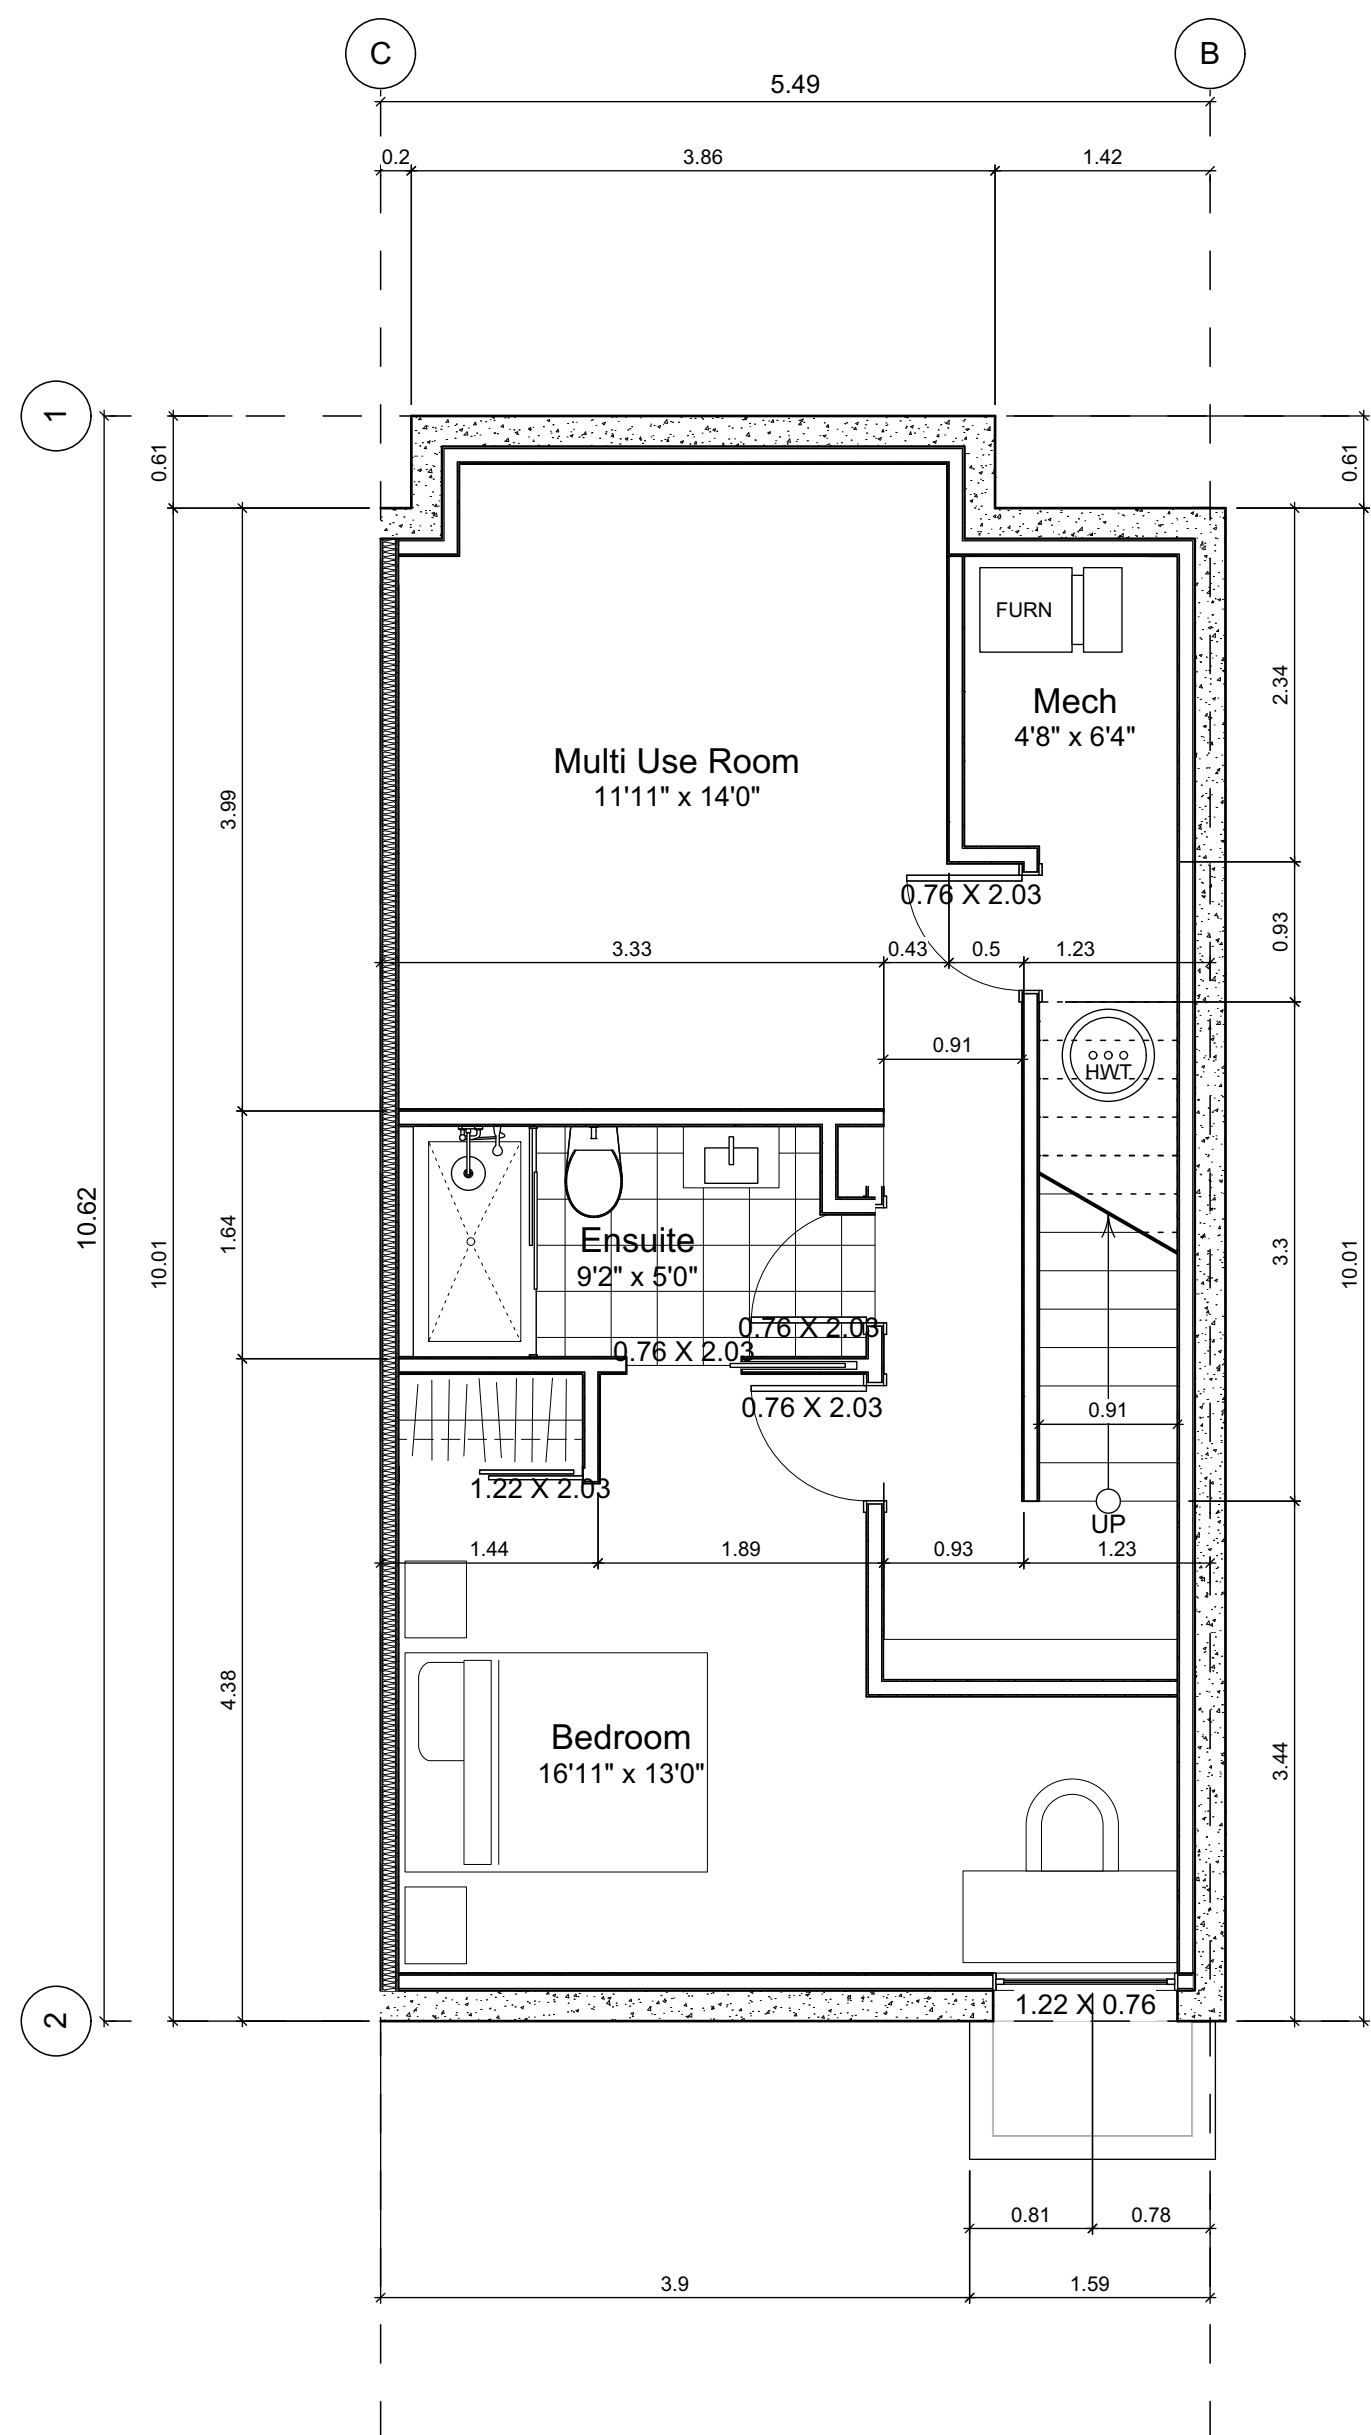

6.2 Main Floor Plan
Scale: 1:50

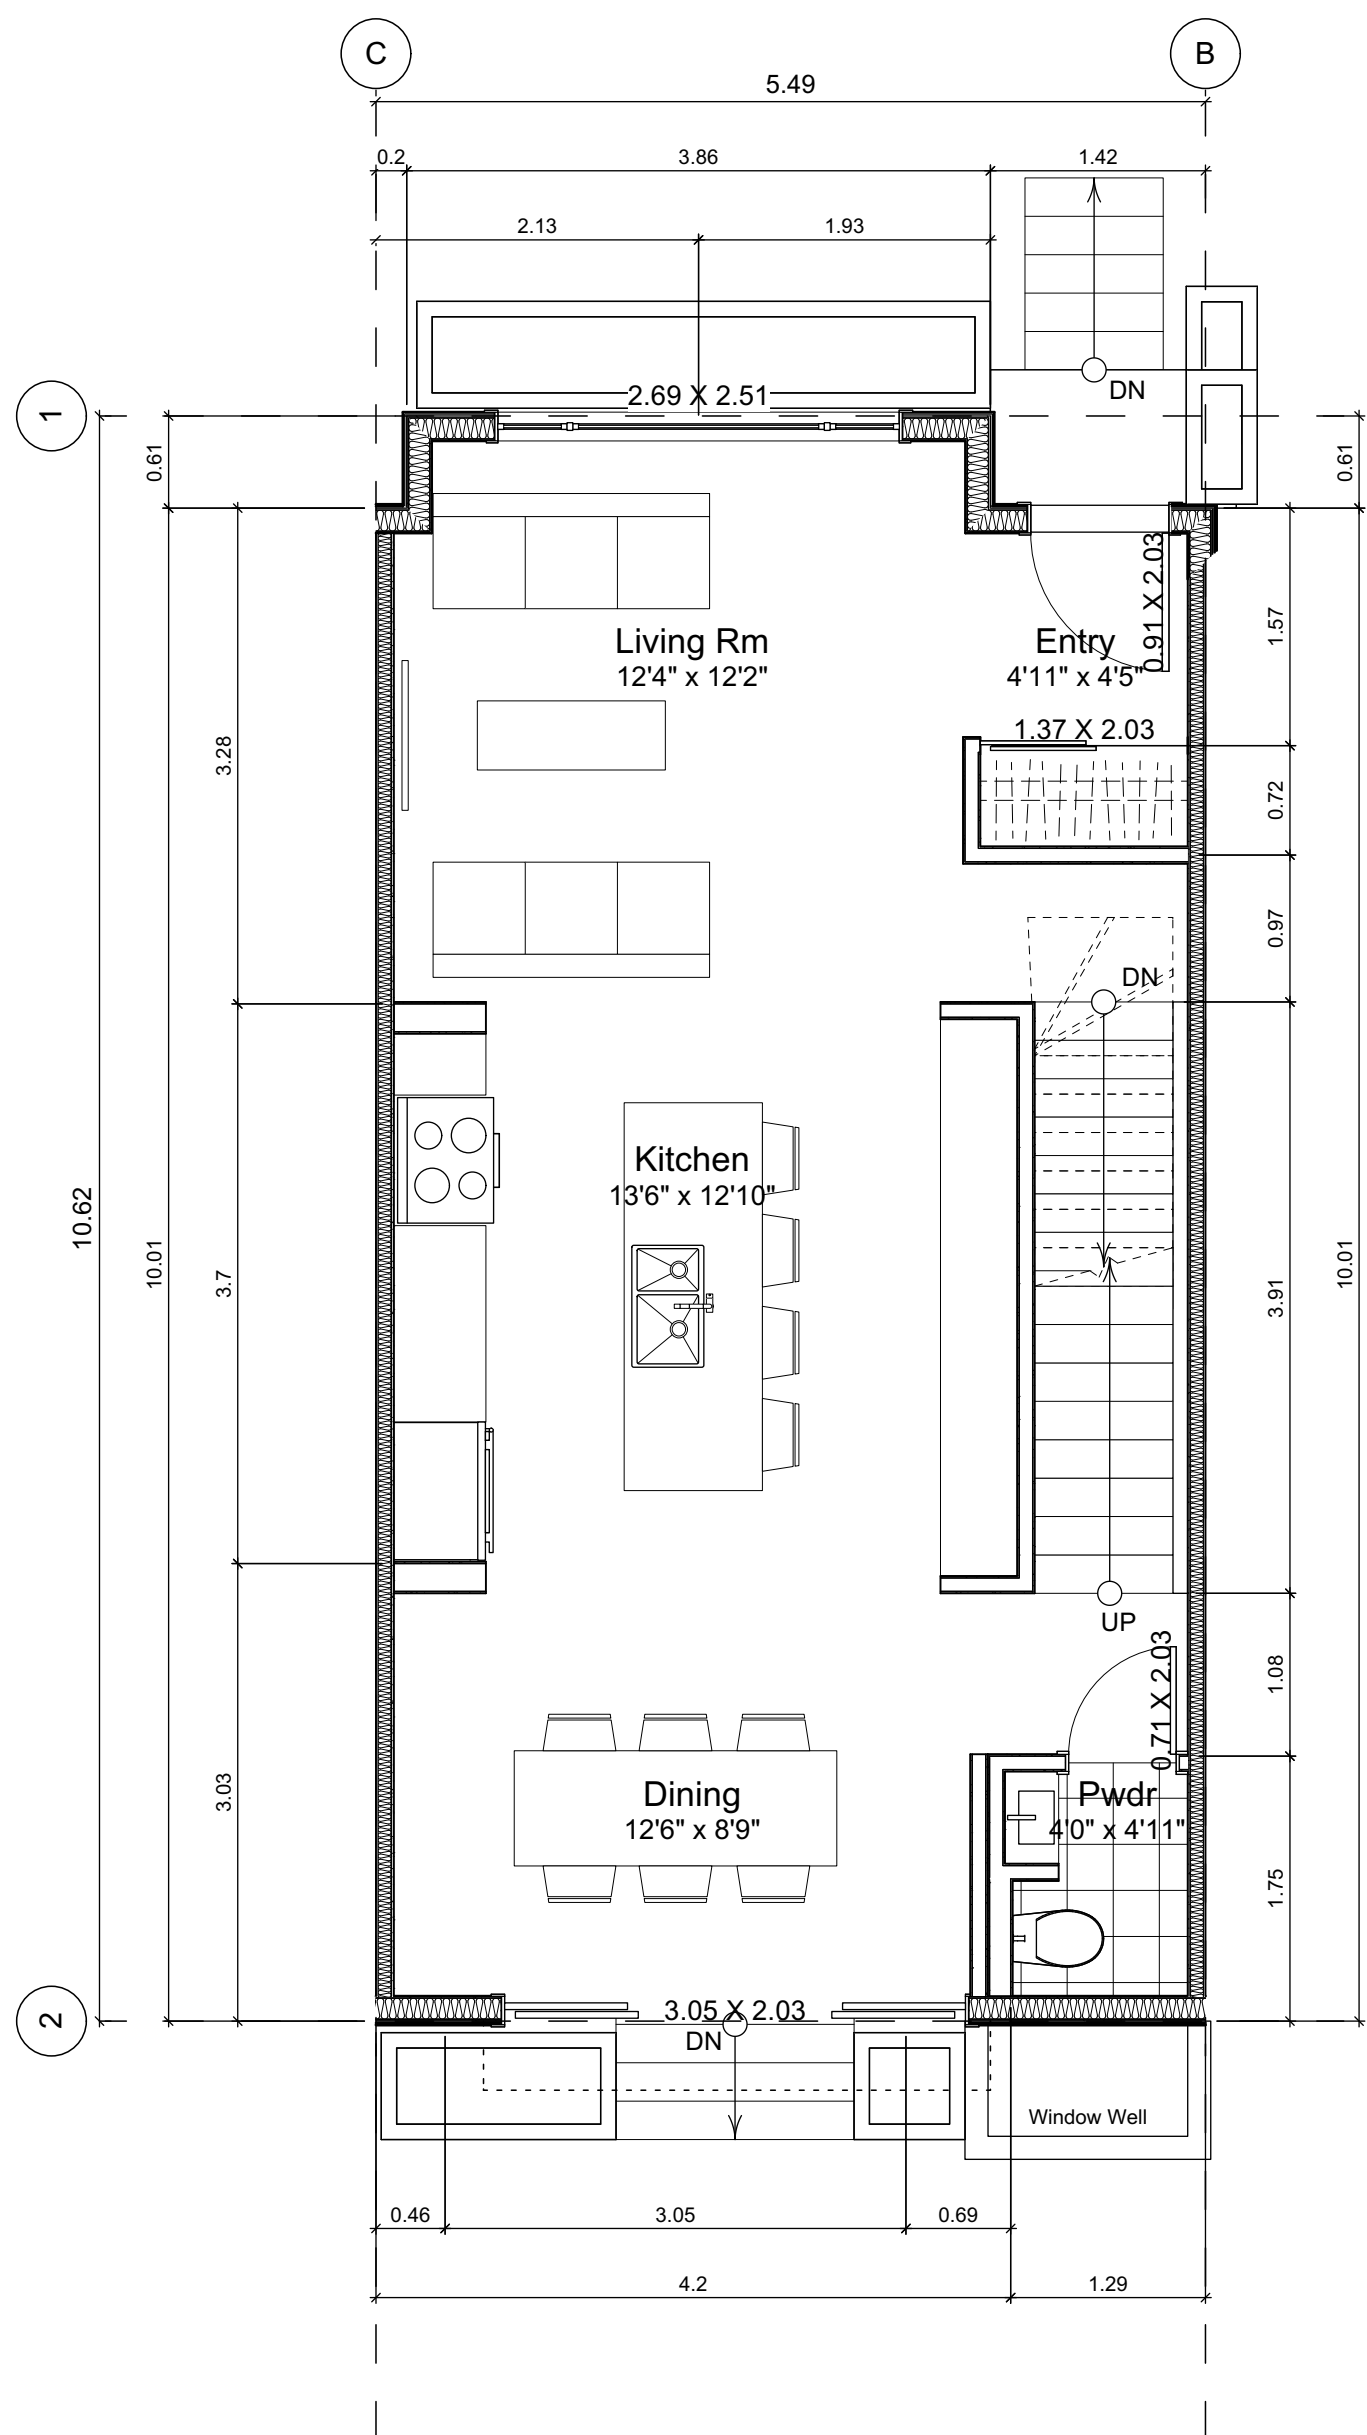

6.3 Second Floor Plan
Scale: 1:50

Unit Plan Notes:

See Block plan for foundation plan.

Grid Lines are to:
1) Outside face of plywood or
2) Centre line of demising wall.

Dimensions are to:
1) One side of interior stud,
2) Face of plywood, or face of concrete.

Floor Area Calculations

	Unit 6				
	Gross Floor Area		Zoning Floor Area	Bedrms	
Basement Floor	627 sq ft	58.3 m2	0 sq ft	0.0 m2	
Main Floor	616 sq ft	57.3 m2	601 sq ft	55.9 m2	
Second Floor	589 sq ft	54.8 m2	581 sq ft	53.9 m2	
Half Storey					
Totals:	1,833 sq ft	170.3 m2	1,182 sq ft	109.8 m2	4
Garage	169 sq ft	15.7 m2			

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2022-11-14	Revised & Re-issued for DP
2022-11-25	Revised & Re-issued for DP

Unit 6 Floor Plans

Project Name:

Fairfield-Kipling
Development

Civic: 1400 Fairfield Rd &
349 Kipling St

Legal:

PID:


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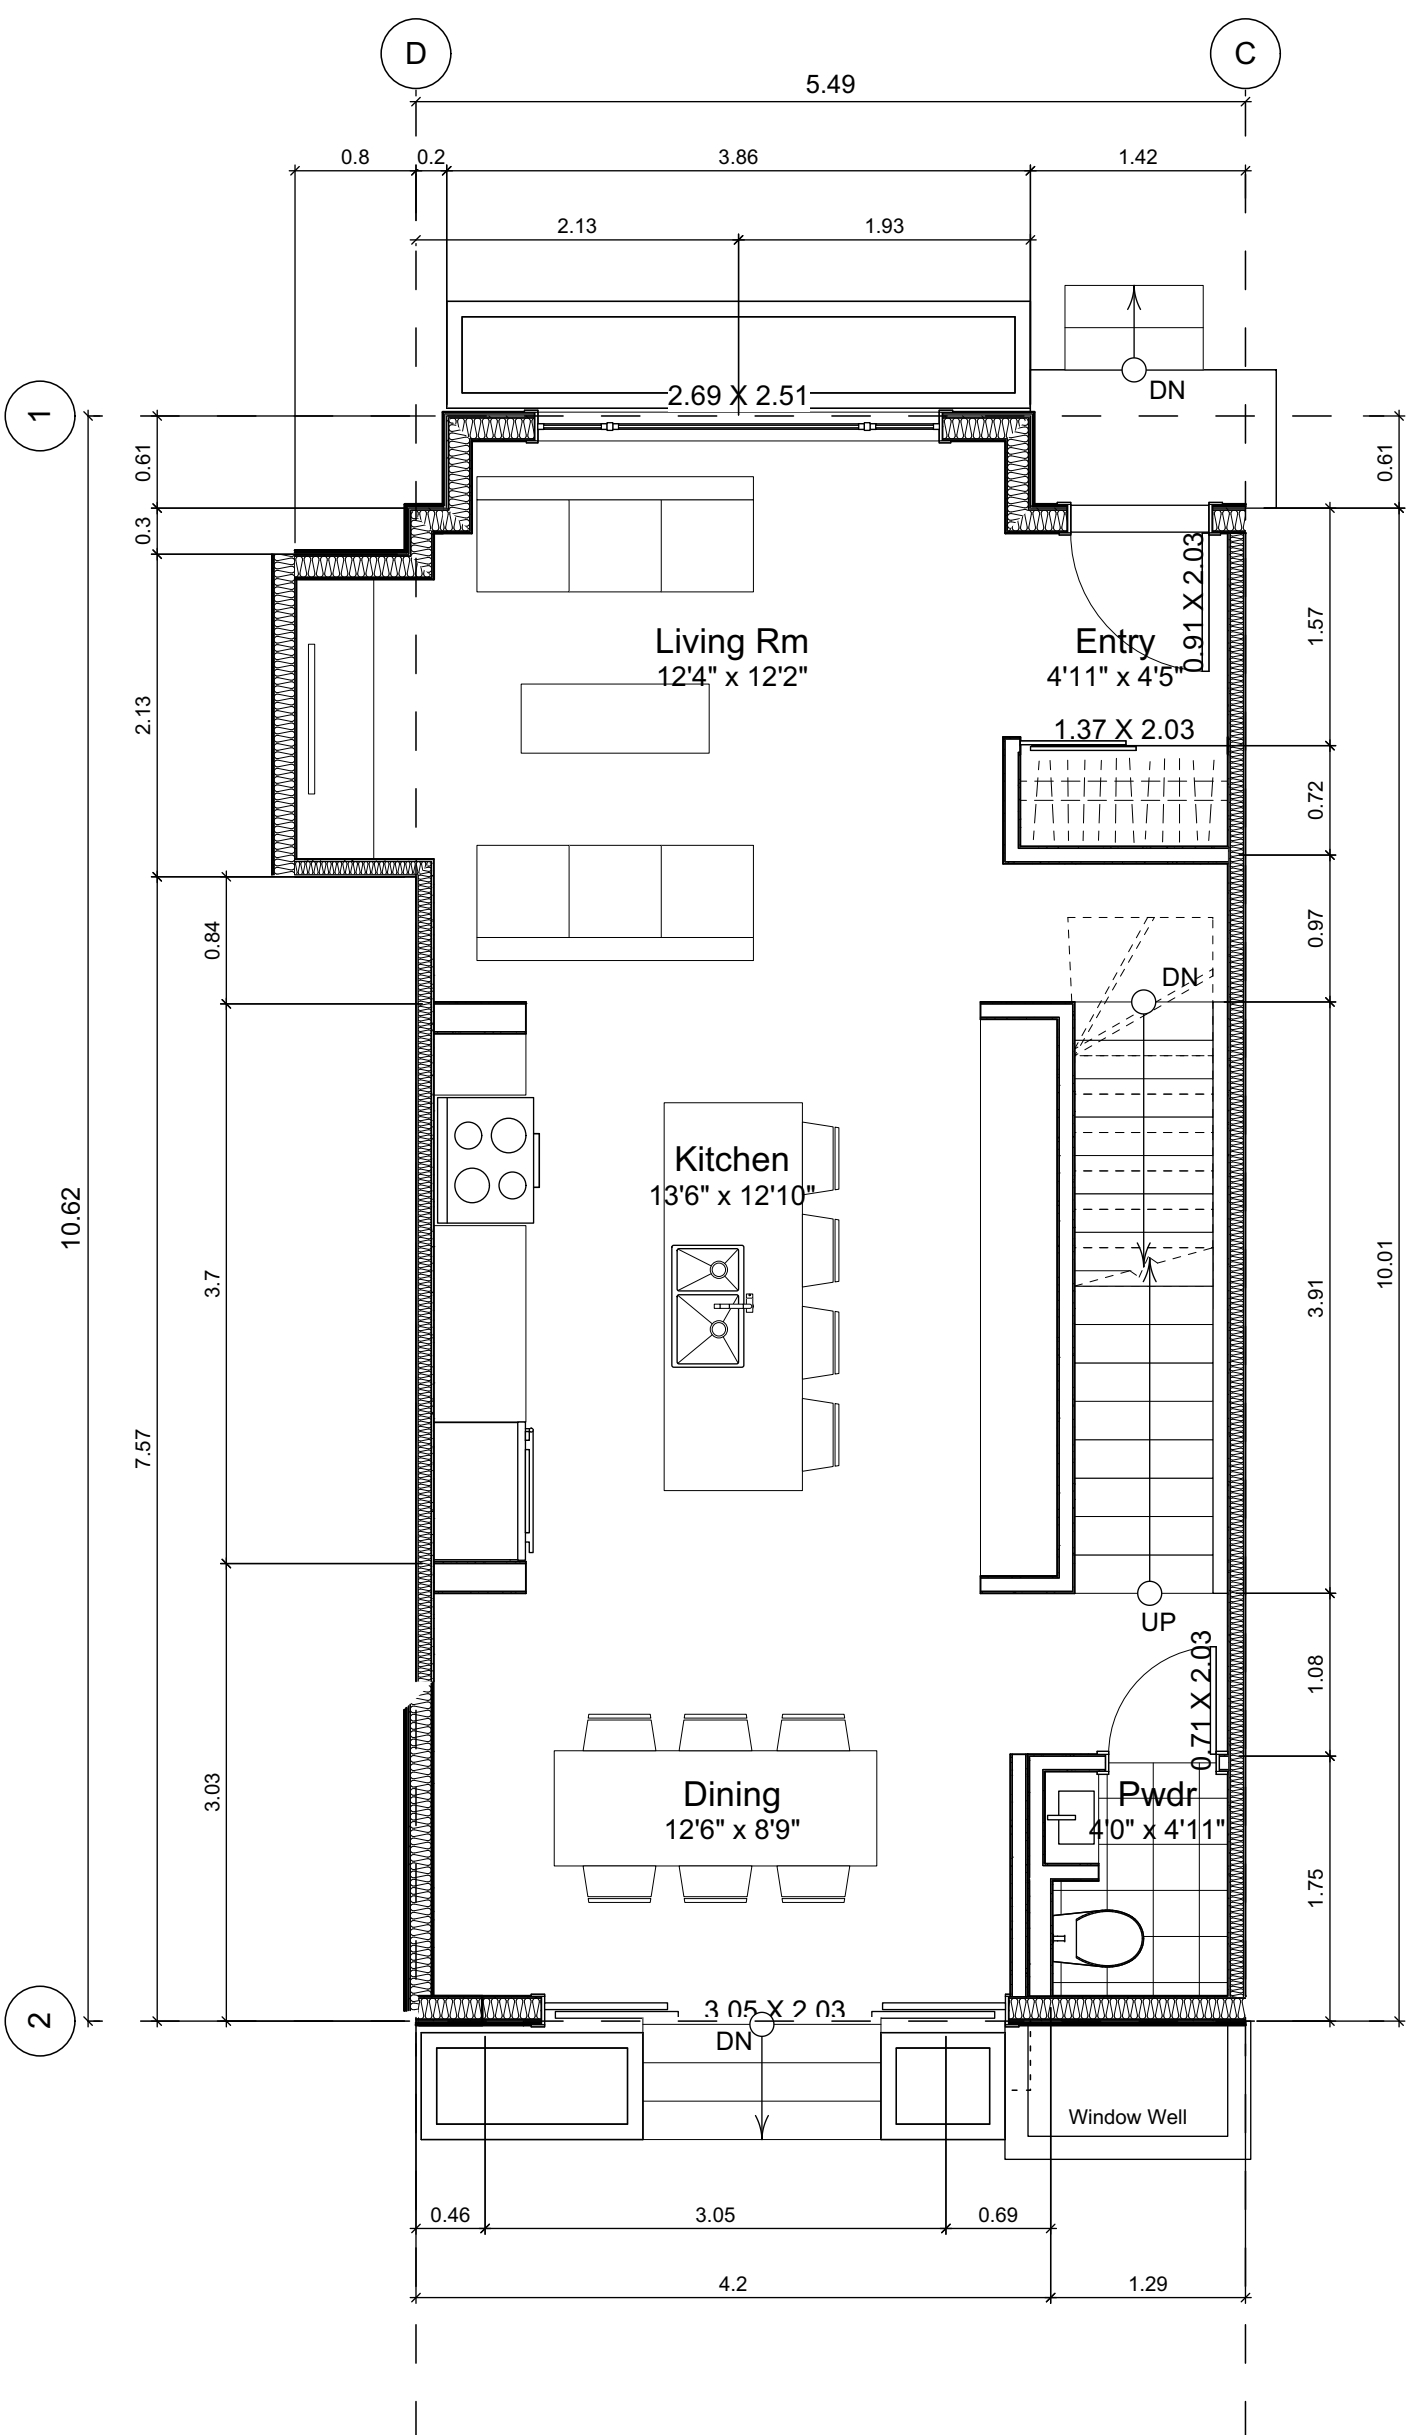
Plot Date: Nov 29, 2022

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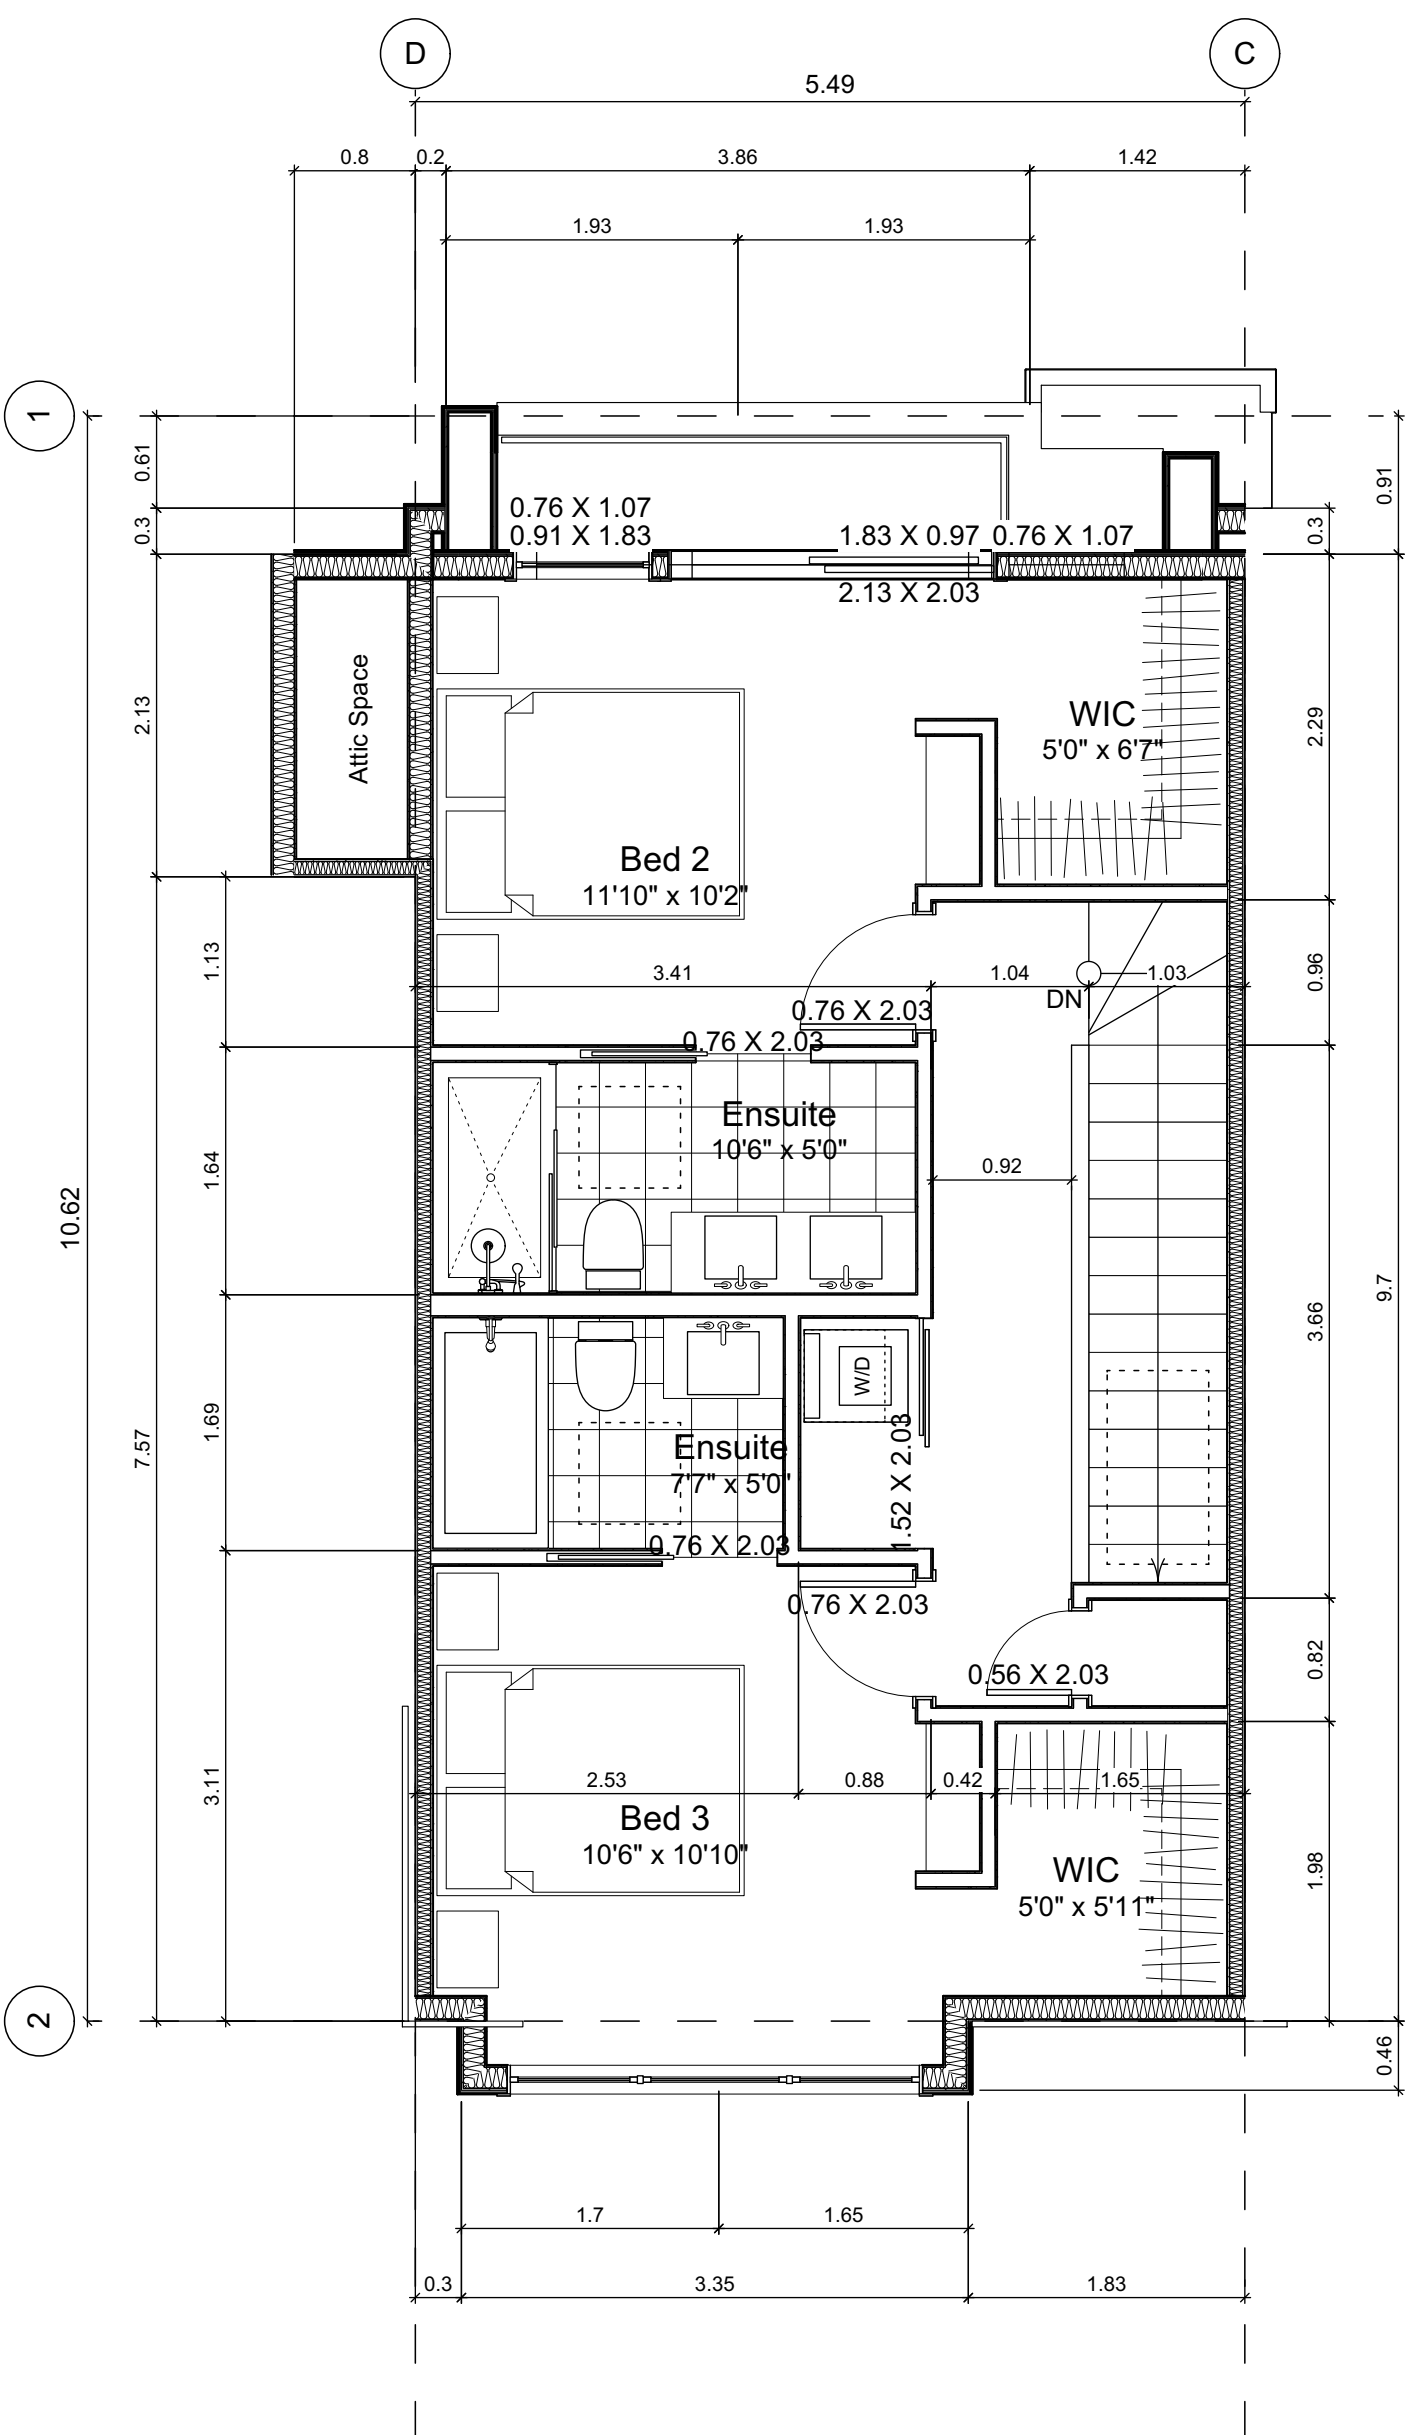
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7.1 Basement Floor Plan
Scale: 1:50



7.2 Main Floor Plan
Scale: 1:50

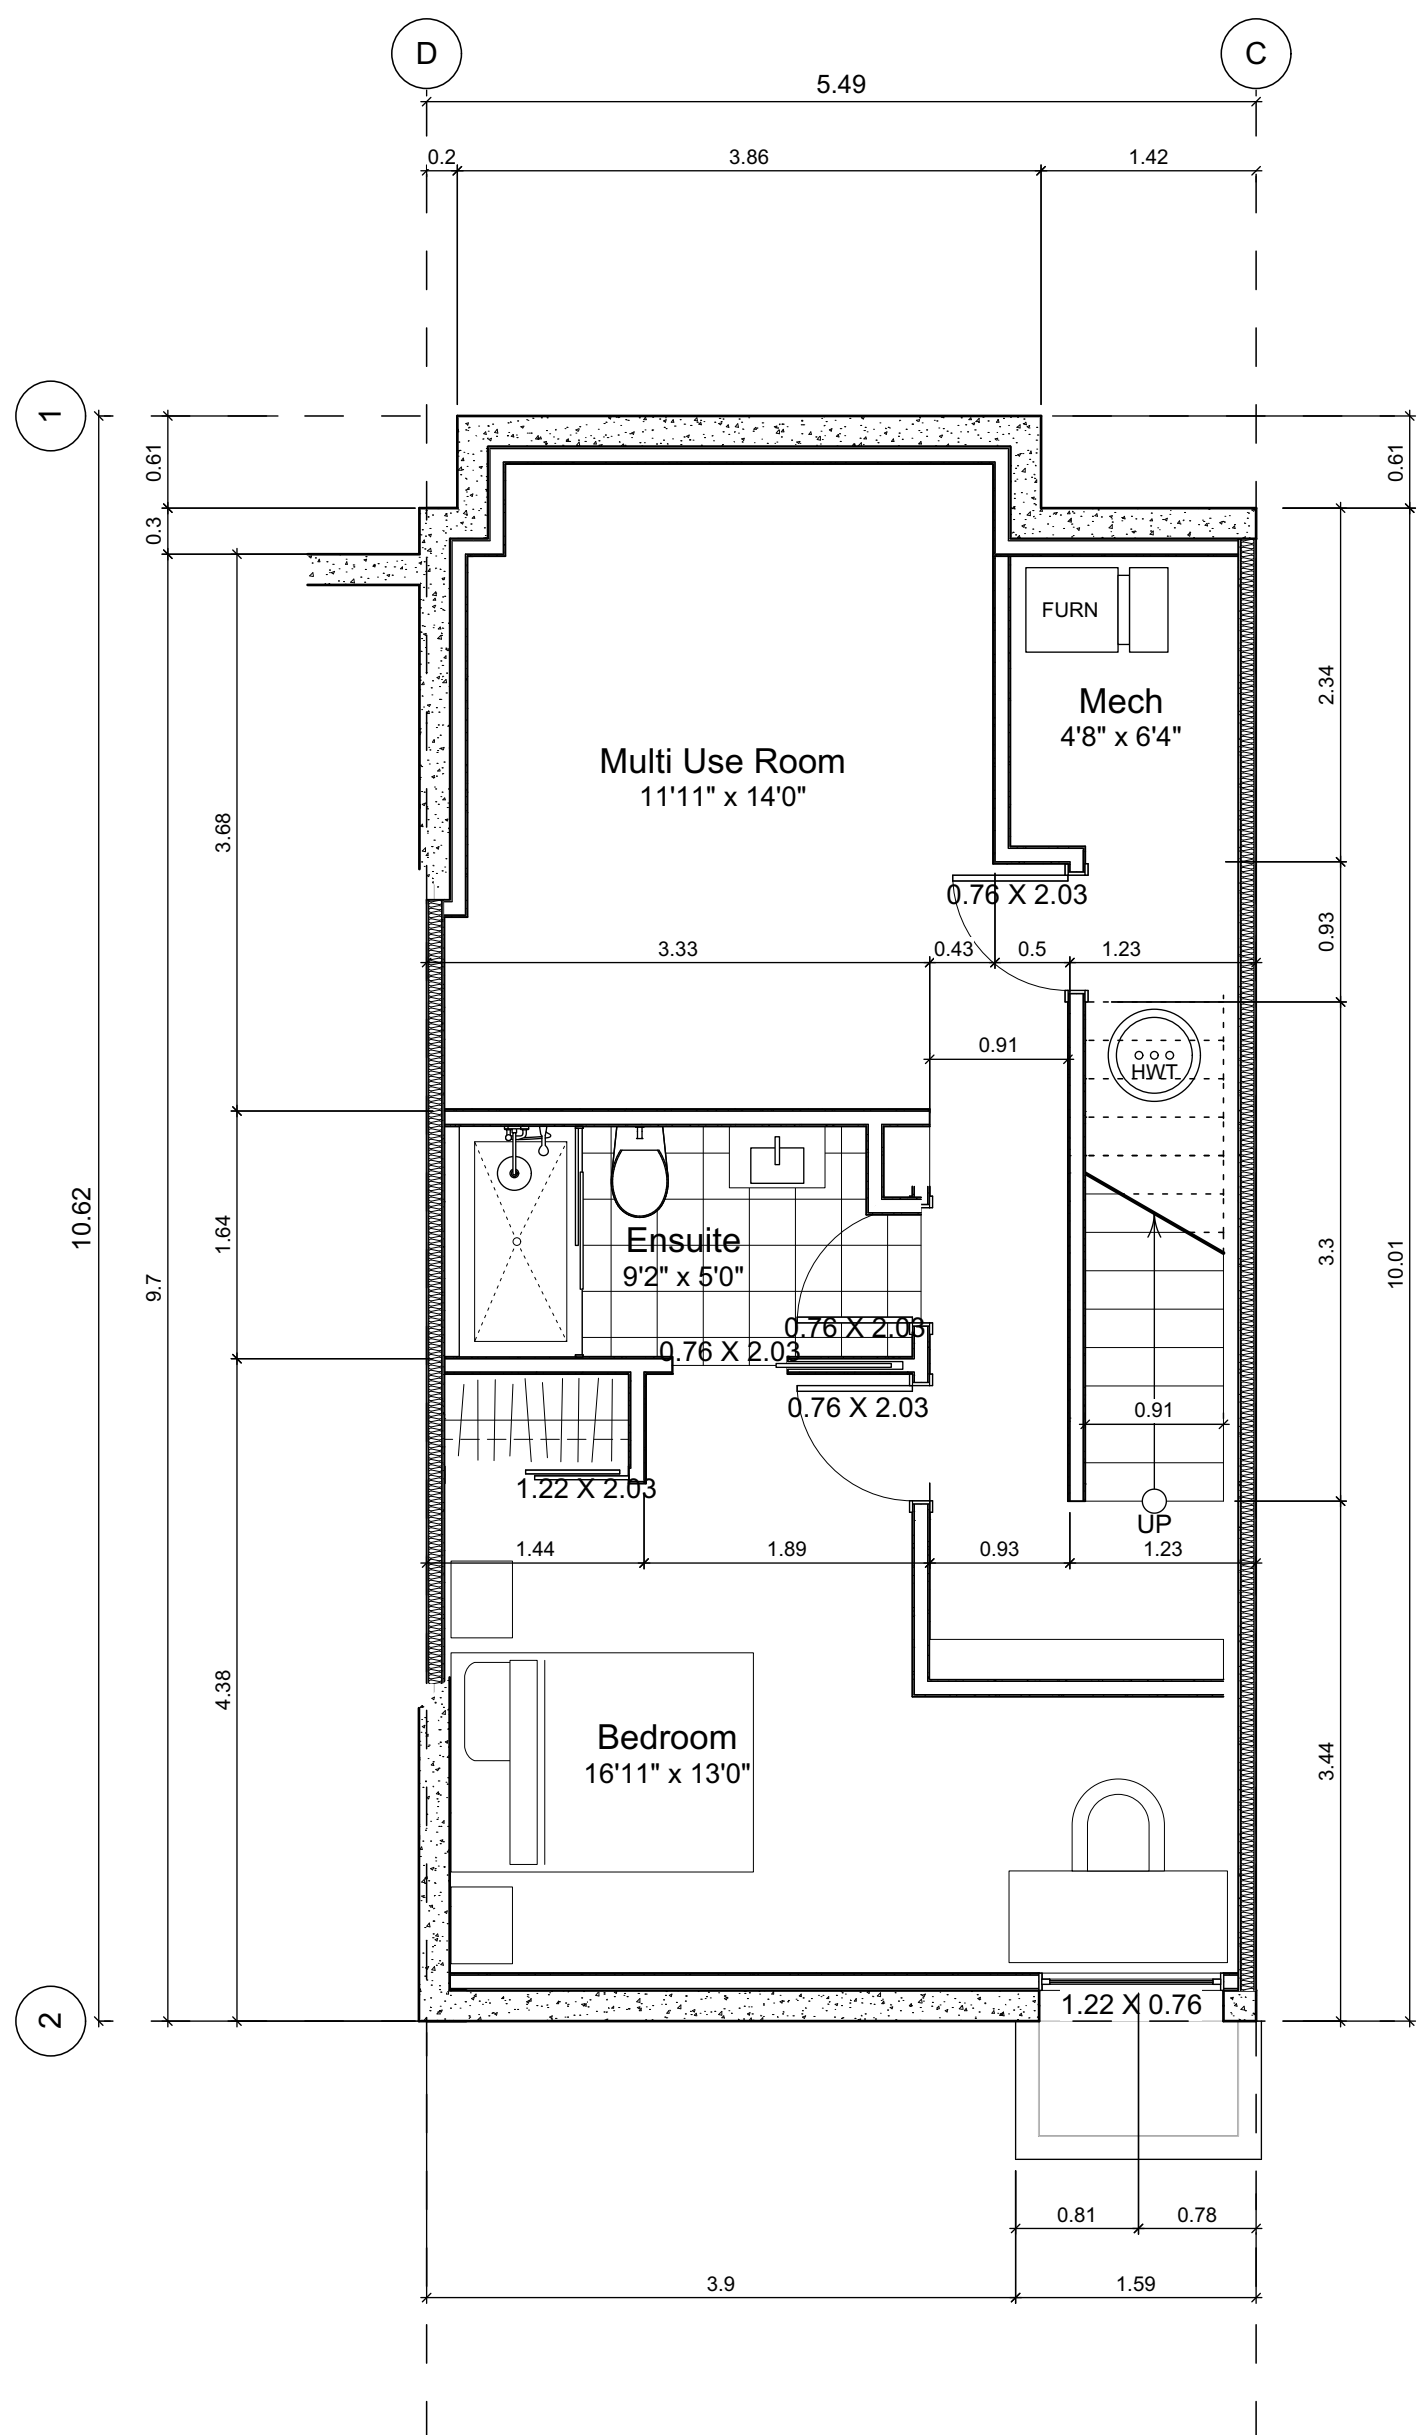

7.3 Second Floor Plan
Scale: 1:50

Unit Plan Notes:

See Block plan for foundation plan.

Grid Lines are to:
1) Outside face of plywood or
2) Centre line of demising wall.

Dimensions are to:
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2) Face of plywood, or face of concrete.

Floor Area Calculations

	Unit 7			
	Gross Floor Area		Zoning Floor Area	Bedrms
Basement Floor	619 sq ft	57.5 m2	0 sq ft	0.0 m2
Main Floor	636 sq ft	59.1 m2	621 sq ft	57.7 m2
Second Floor	589 sq ft	54.8 m2	572 sq ft	53.2 m2
Half Storey				
Totals:	1,844 sq ft	171.4 m2	1,193 sq ft	110.8 m2
Garage	172 sq ft	16.0 m2		4

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Unit 7 Floor Plans

Project Name:

Fairfield-Kipling
Development

Civic: 1400 Fairfield Rd &
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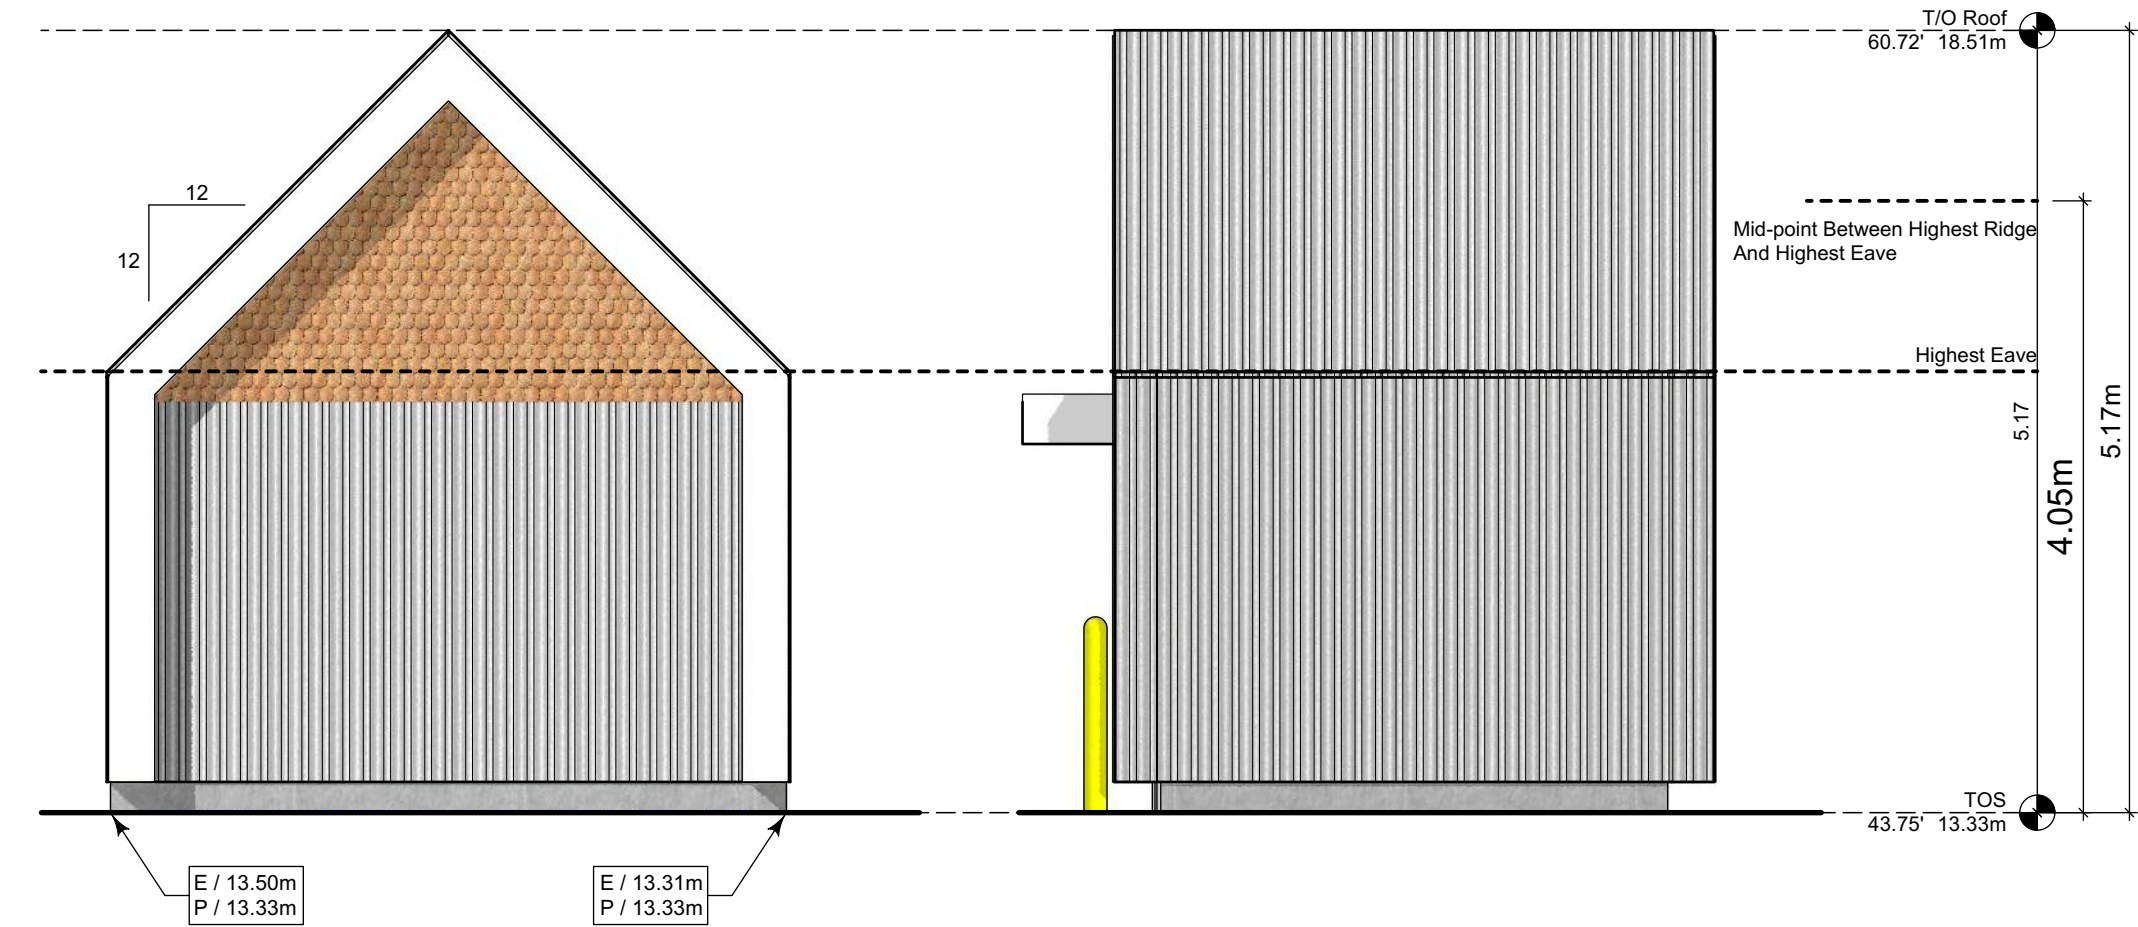
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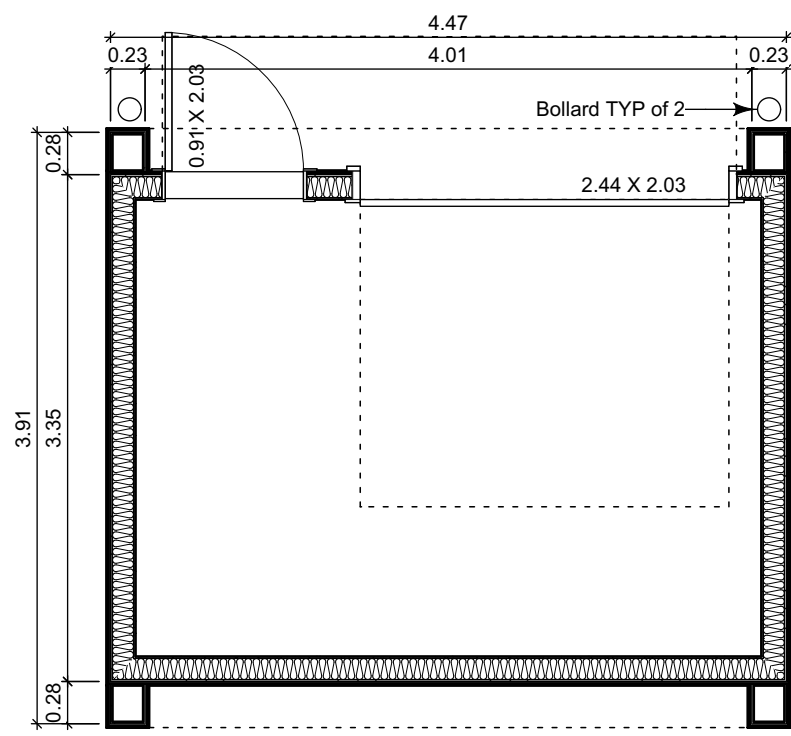
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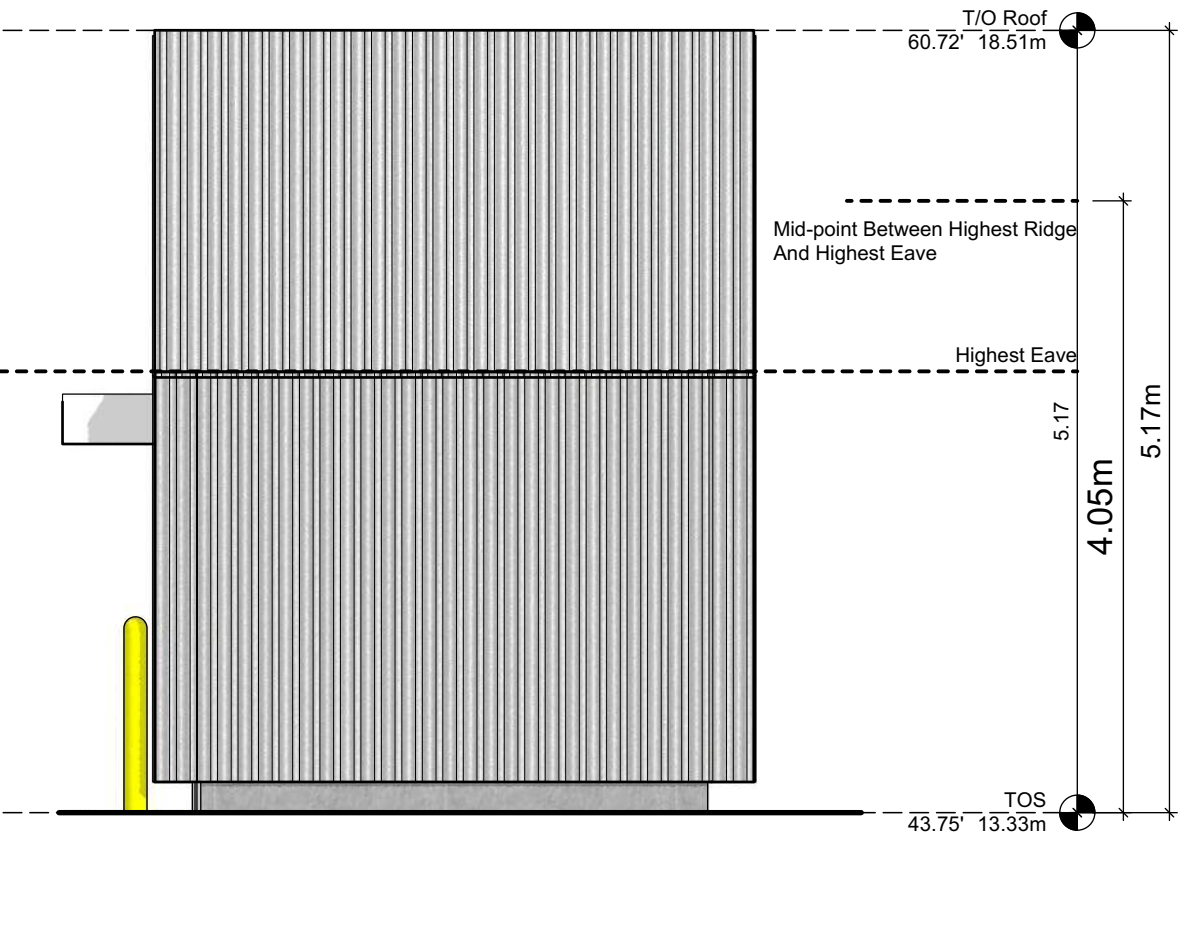
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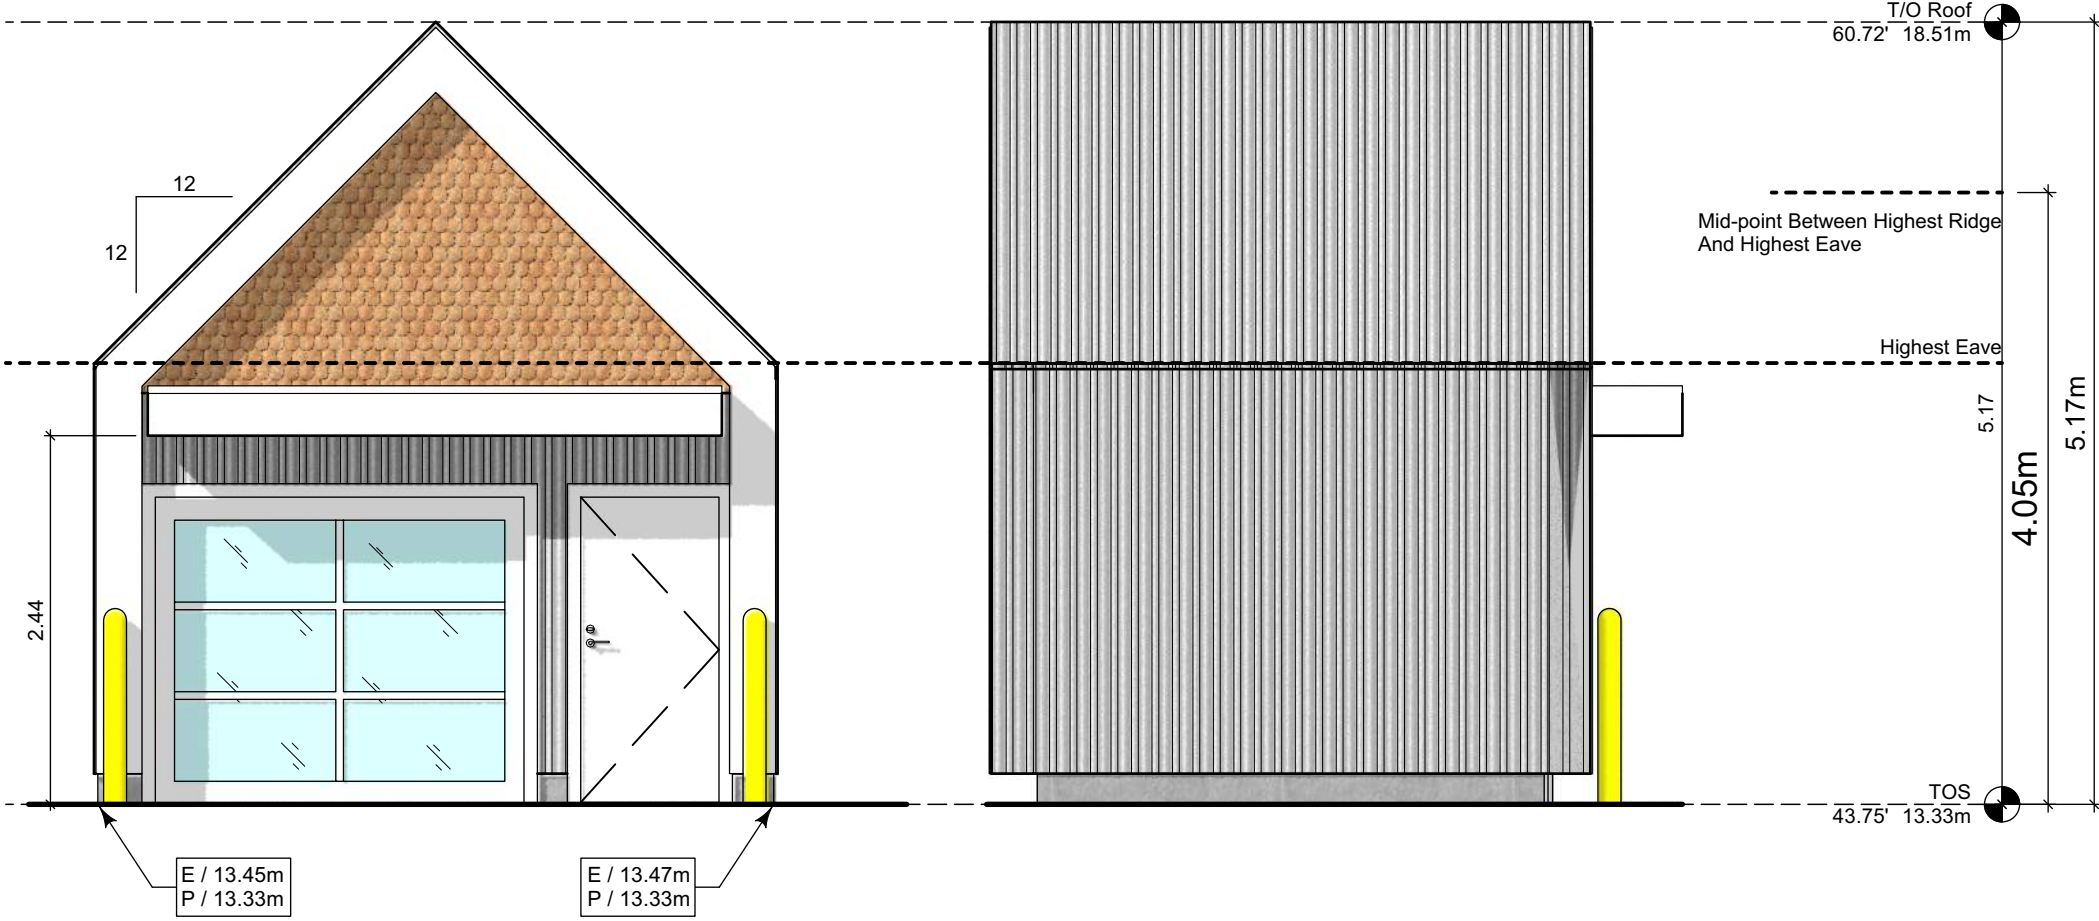
1.4 Rear Elevation
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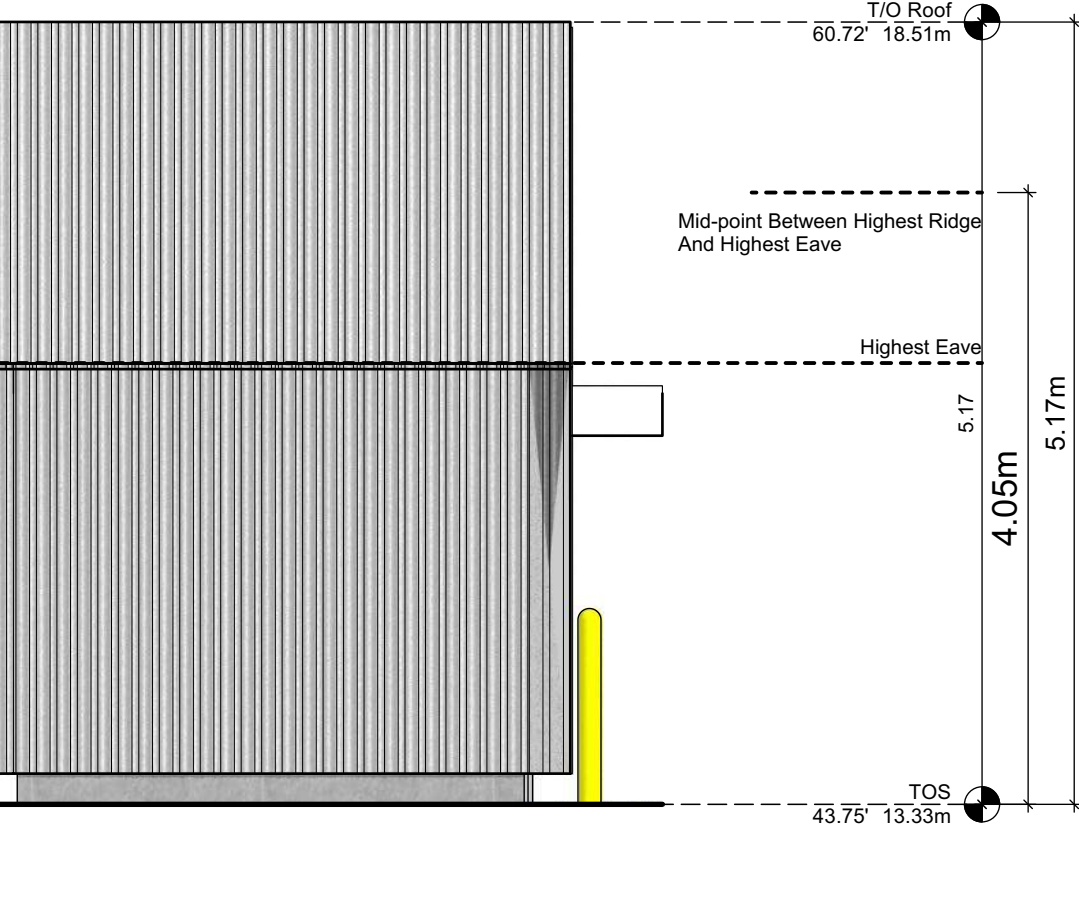
1.1 Refuse Floor Plan
Scale: 1:50




1.5 Left Elevation
Scale: 1:50



1.2 Front Elevation
Scale: 1:50



1.3 Right Elevation
Scale: 1:50

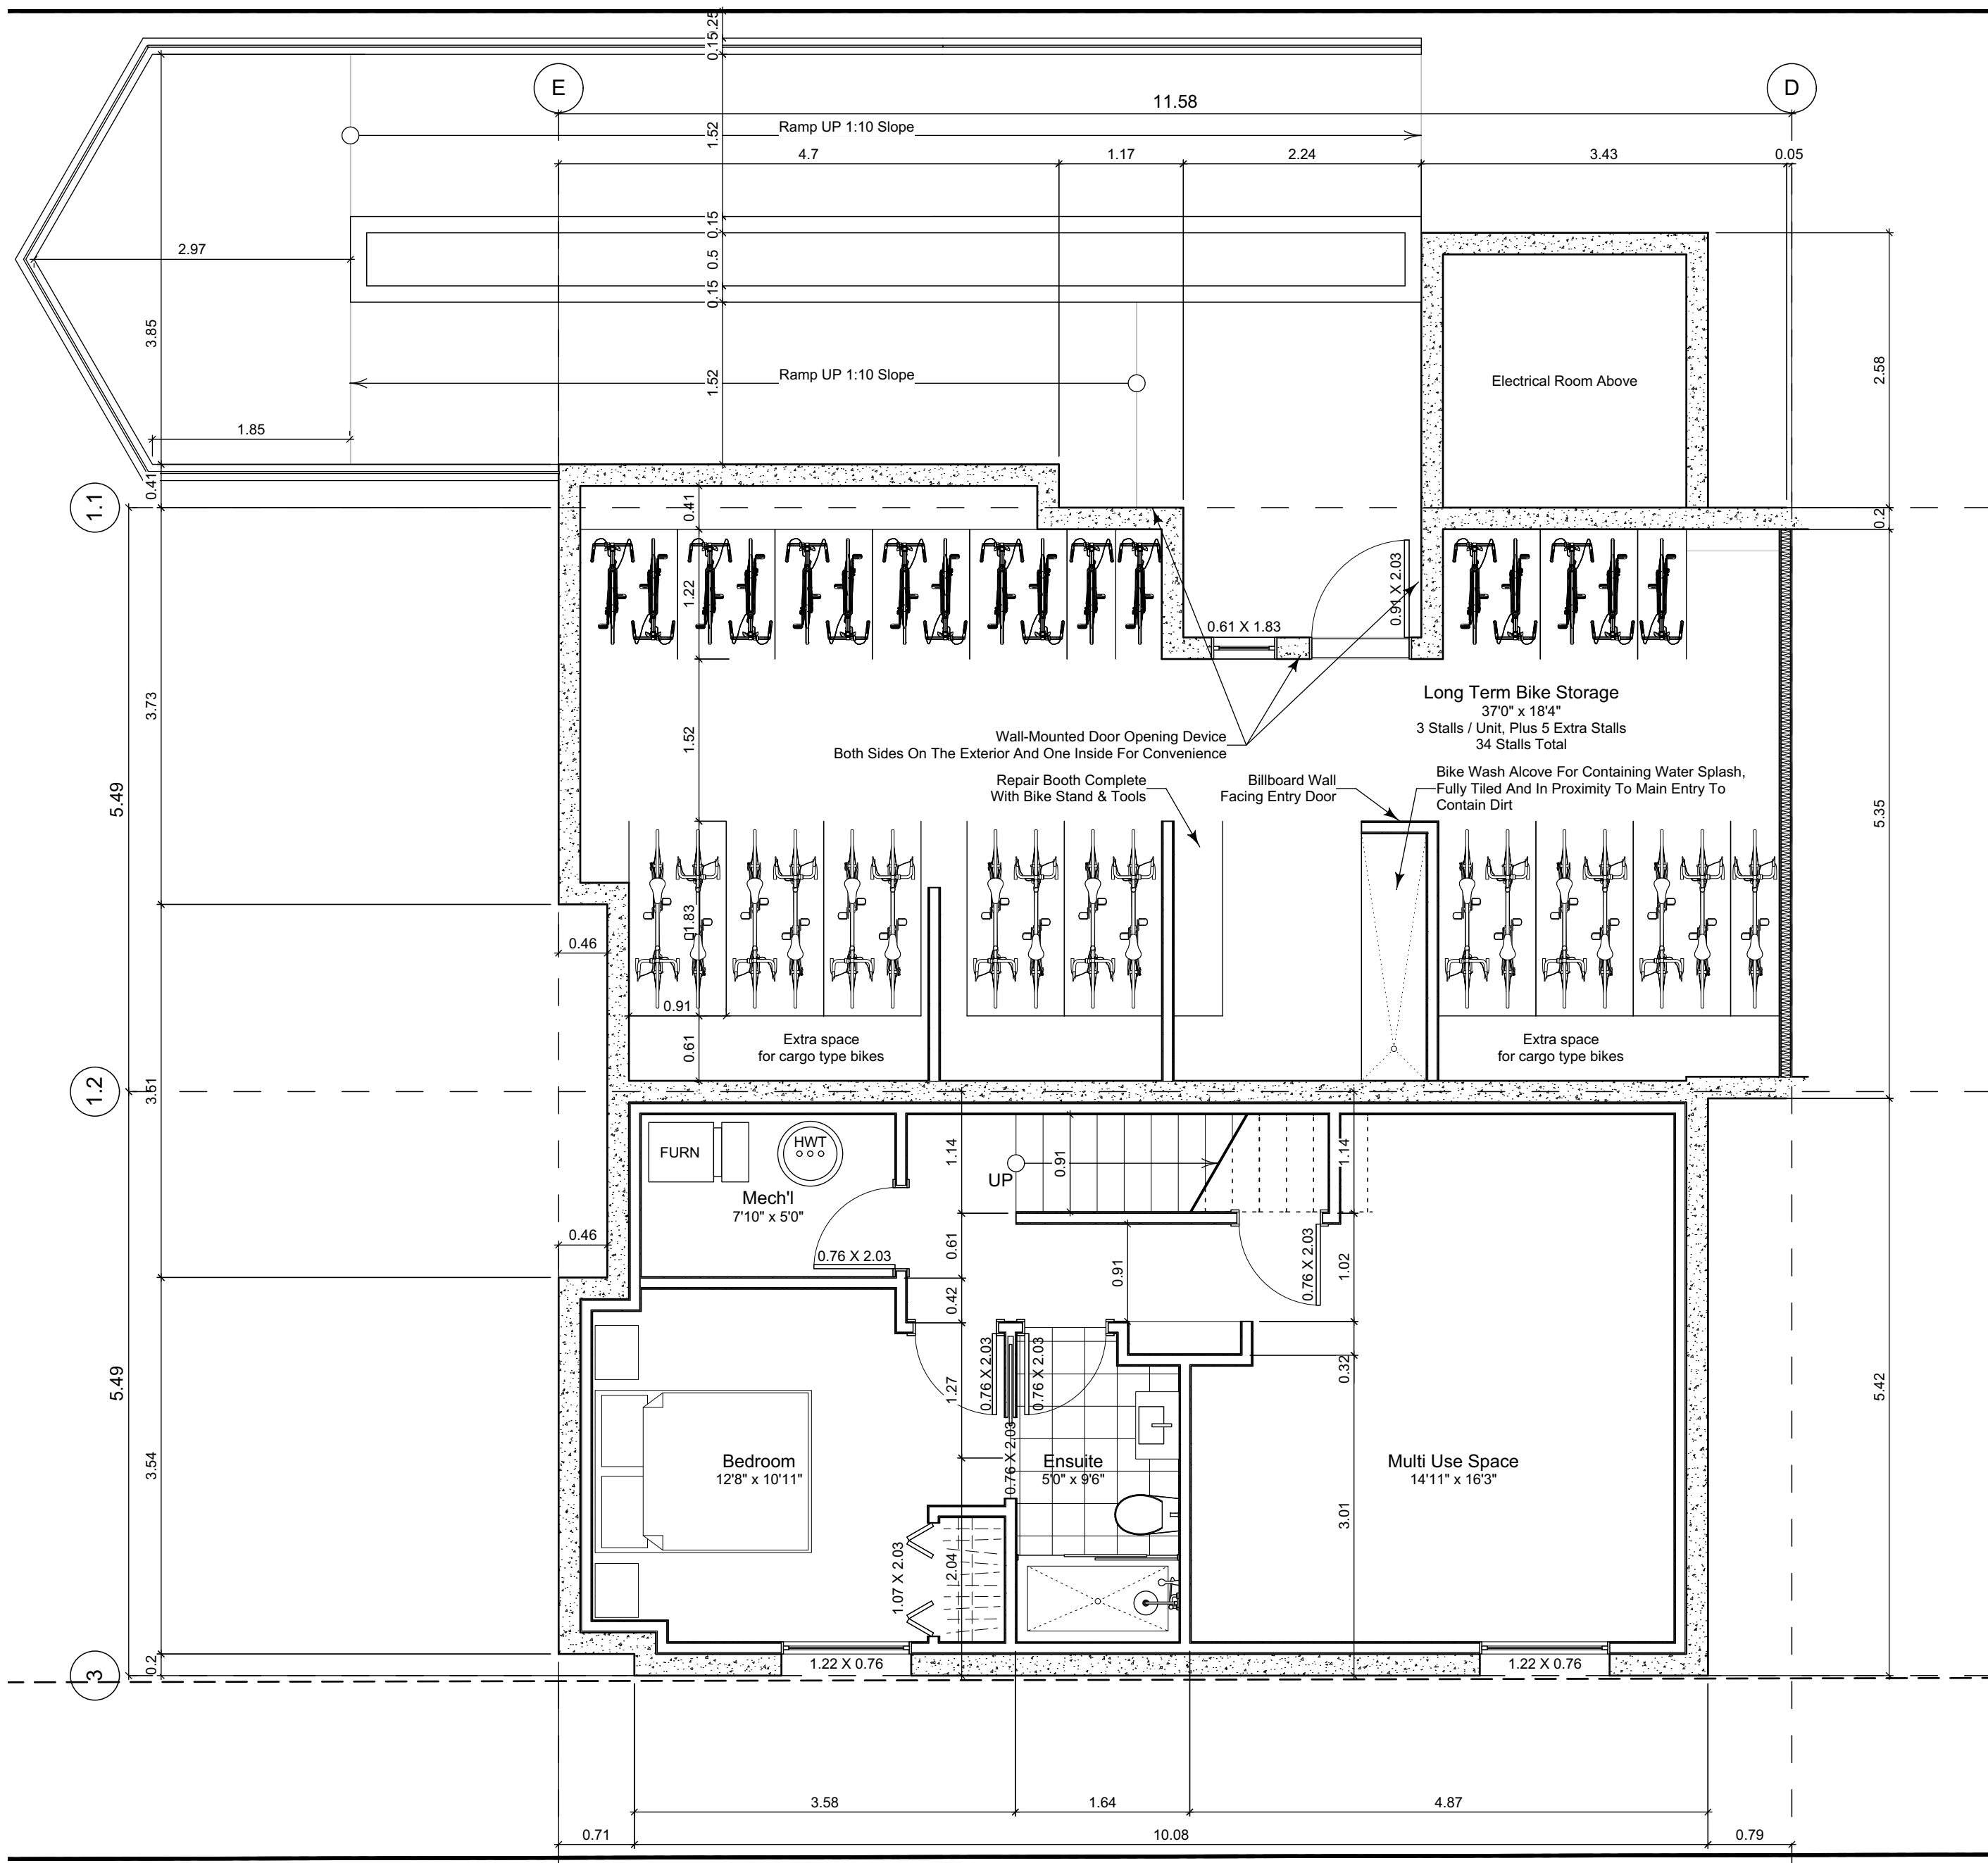

0 Basement Floor Plan
Scale: 1:50

Floor Area Calculations Unit 9				
	Gross Floor Area		Zoning Floor Area	Bedrms
Basement Floor	616 sq ft	57.2 m2	0 sq ft	0.0 m2
Main Floor	627 sq ft	58.3 m2	613 sq ft	56.9 m2
Second Floor	581 sq ft	54.0 m2	544 sq ft	50.6 m2
Half Storey				
Totals:	1,825 sq ft	169.5 m2	1,157 sq ft	107.5 m2 3
Garage	172 sq ft	16.0 m2		

Floor Area Calculations Unit 8				
	Gross Floor Area		Zoning Floor Area	Bedrms
Basement Floor	678 sq ft	63.0 m2	0 sq ft	0.0 m2
Main Floor	696 sq ft	64.7 m2	691 sq ft	64.2 m2
Second Floor	626 sq ft	58.2 m2	598 sq ft	55.6 m2
Half Storey				
Totals:	2,001 sq ft	185.9 m2	1,289 sq ft	119.8 m2 2
Garage	172 sq ft	16.0 m2		

Unit Plan Notes:
See Block plan for foundation plan.

Grid Lines are to:
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2) Centre line of demising wall.

Dimensions are to:
1) One side of interior stud,
2) Face of plywood, or face of concrete.

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Unit 8 & 9 Floor Plans &
Refuse Plans

Project Name:

Fairfield-Kipling
Development

Civic: 1400 Fairfield Rd &
349 Kipling St

Legal:

PID:


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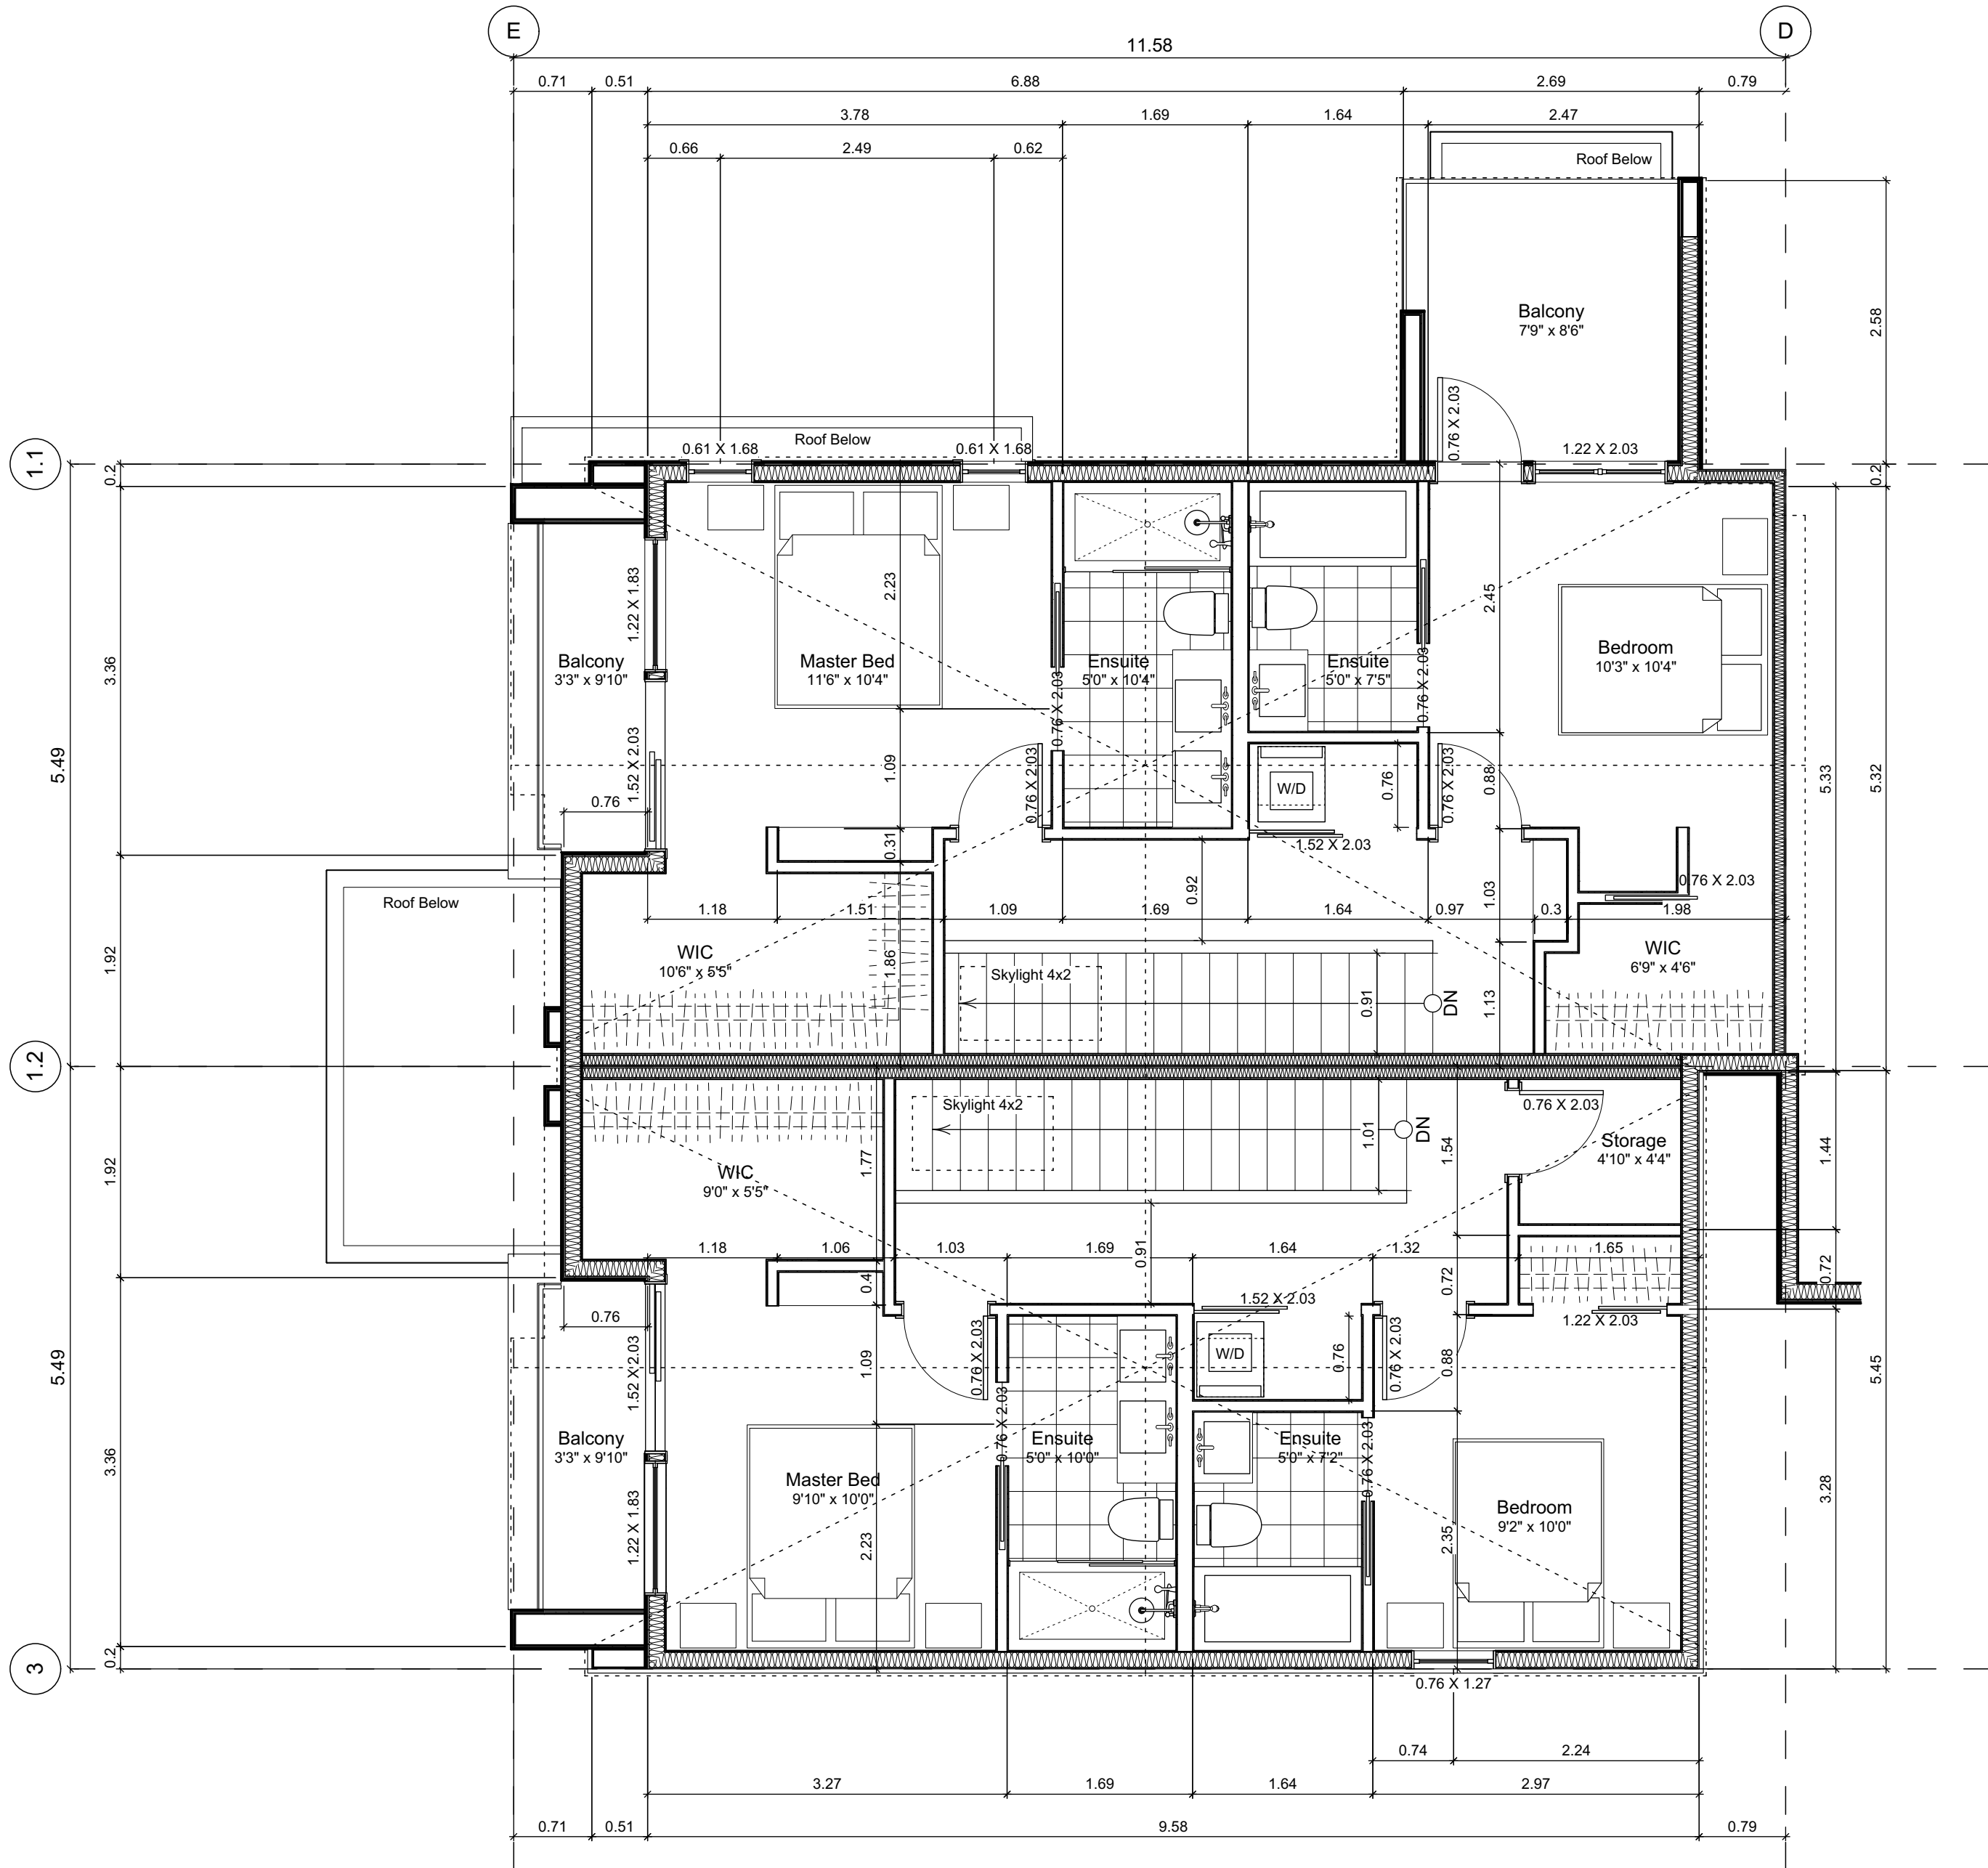
Plot Date: Nov 29, 2022

Scale: 1:50

Sheet No:



1 Main Floor Plan
Scale: 1:50

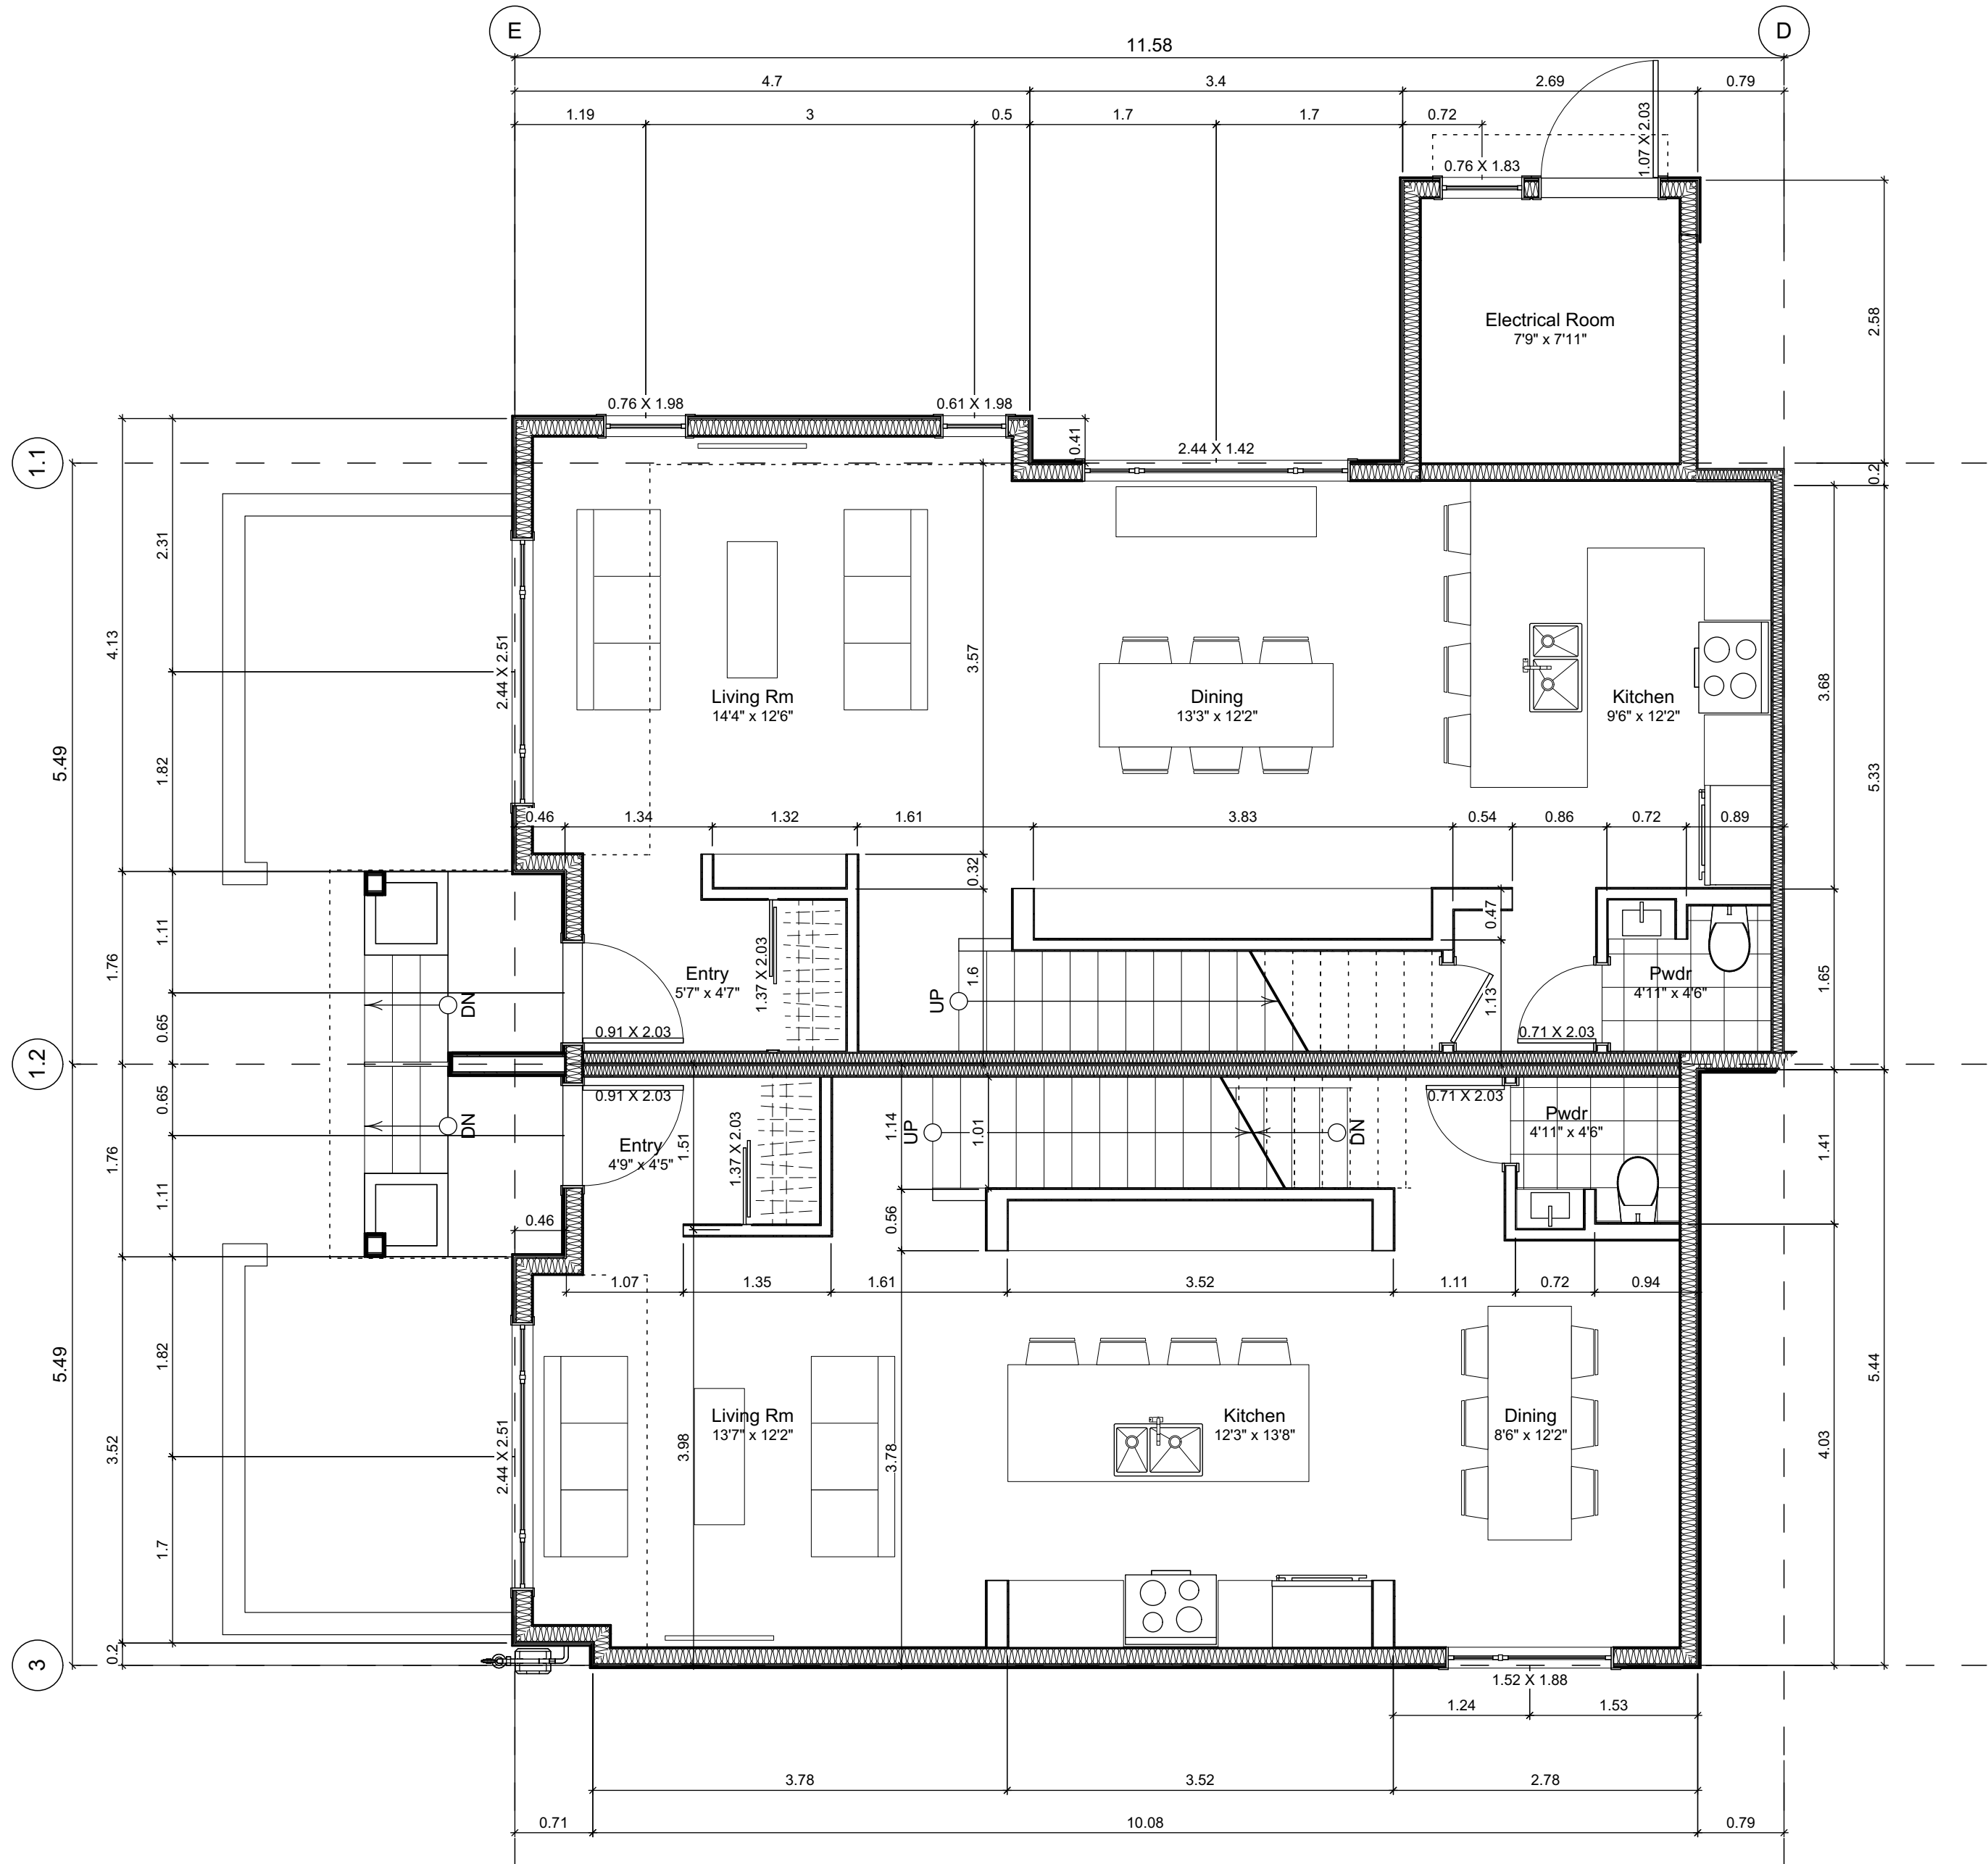

2 Second Floor Plan
Scale: 1:50

Unit Plan Notes:
See Block plan for foundation plan.

- Grid Lines are to:
1) Outside face of plywood or
2) Centre line of demising wall.

- Dimensions are to:
1) One side of interior stud,
2) Face of plywood, or face of concrete.

Floor Area Calculations

	Gross Floor Area		Zoning Floor Area		Bedrms
Basement Floor	616 sq ft	57.2 m2	0 sq ft	0.0 m2	
Main Floor	627 sq ft	58.3 m2	613 sq ft	56.9 m2	
Second Floor	581 sq ft	54.0 m2	544 sq ft	50.6 m2	
Half Storey					
Totals:	1,825 sq ft	169.5 m2	1,157 sq ft	107.5 m2	3
Garage	172 sq ft	16.0 m2			

Floor Area Calculations

	Gross Floor Area		Zoning Floor Area		Bedrms
Basement Floor	678 sq ft	63.0 m2	0 sq ft	0.0 m2	
Main Floor	696 sq ft	64.7 m2	691 sq ft	64.2 m2	
Second Floor	626 sq ft	58.2 m2	598 sq ft	55.6 m2	
Half Storey					
Totals:	2,001 sq ft	185.9 m2	1,289 sq ft	119.8 m2	2
Garage	172 sq ft	16.0 m2			

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Unit 8 & 9 Floor Plans

Project Name:

Fairfield-Kipling
Development

Civic: 1400 Fairfield Rd &
349 Kipling St

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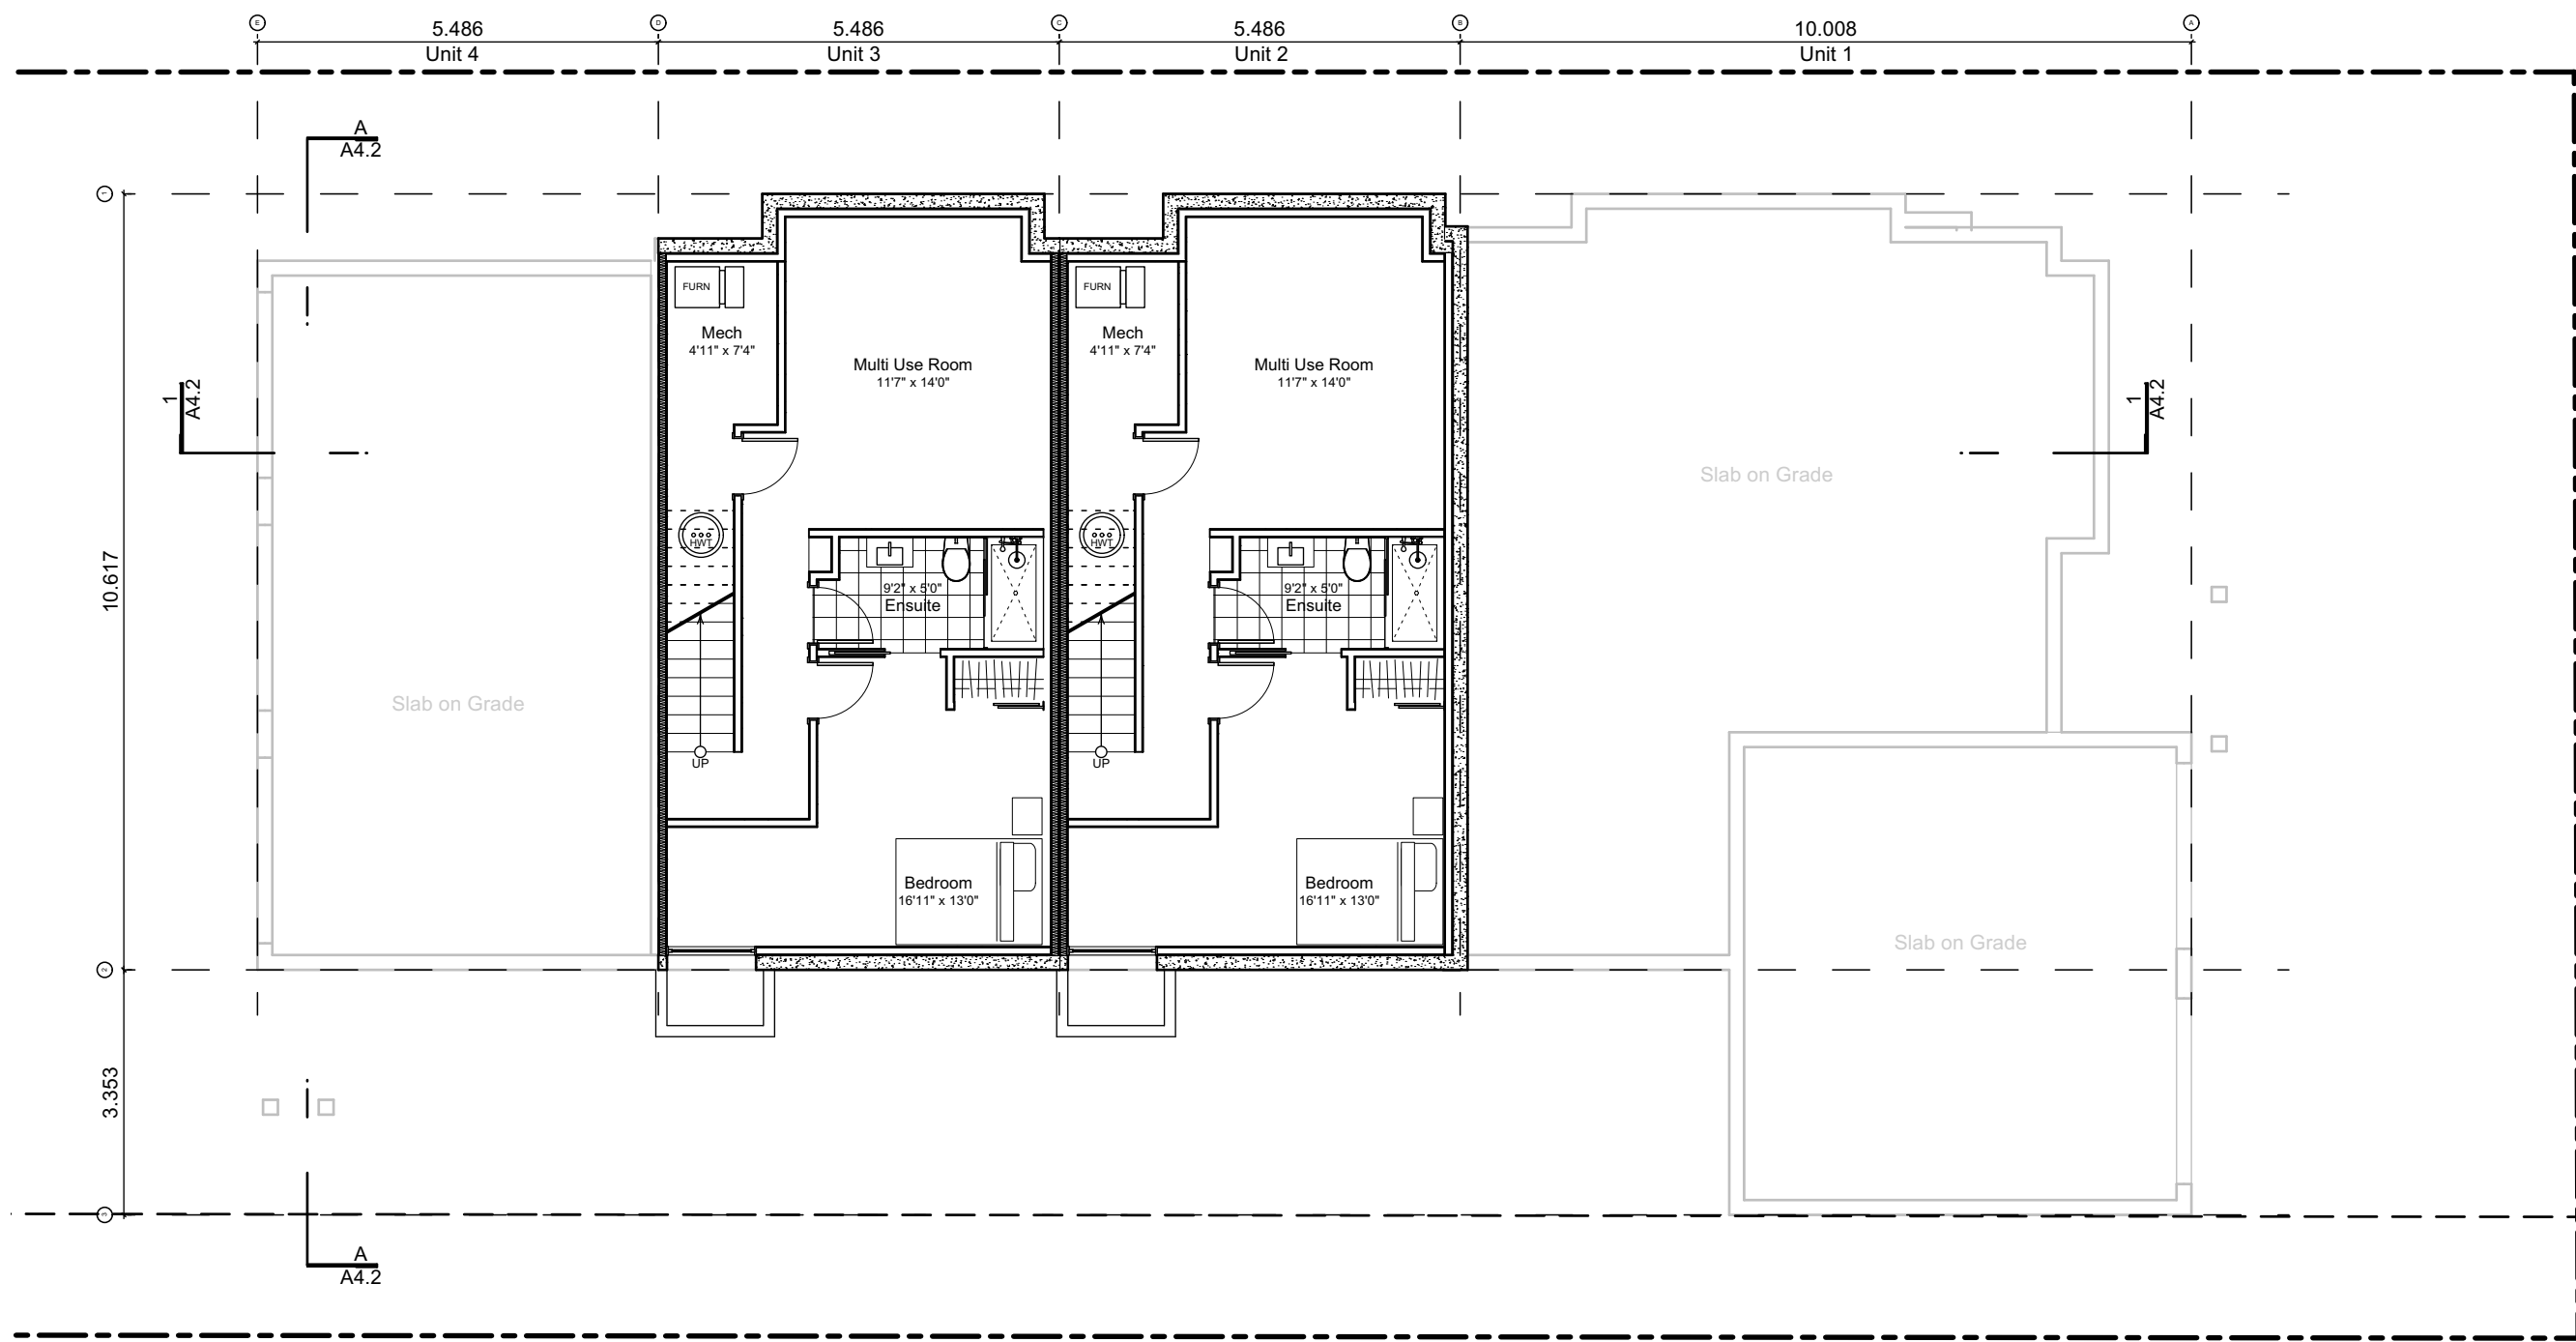
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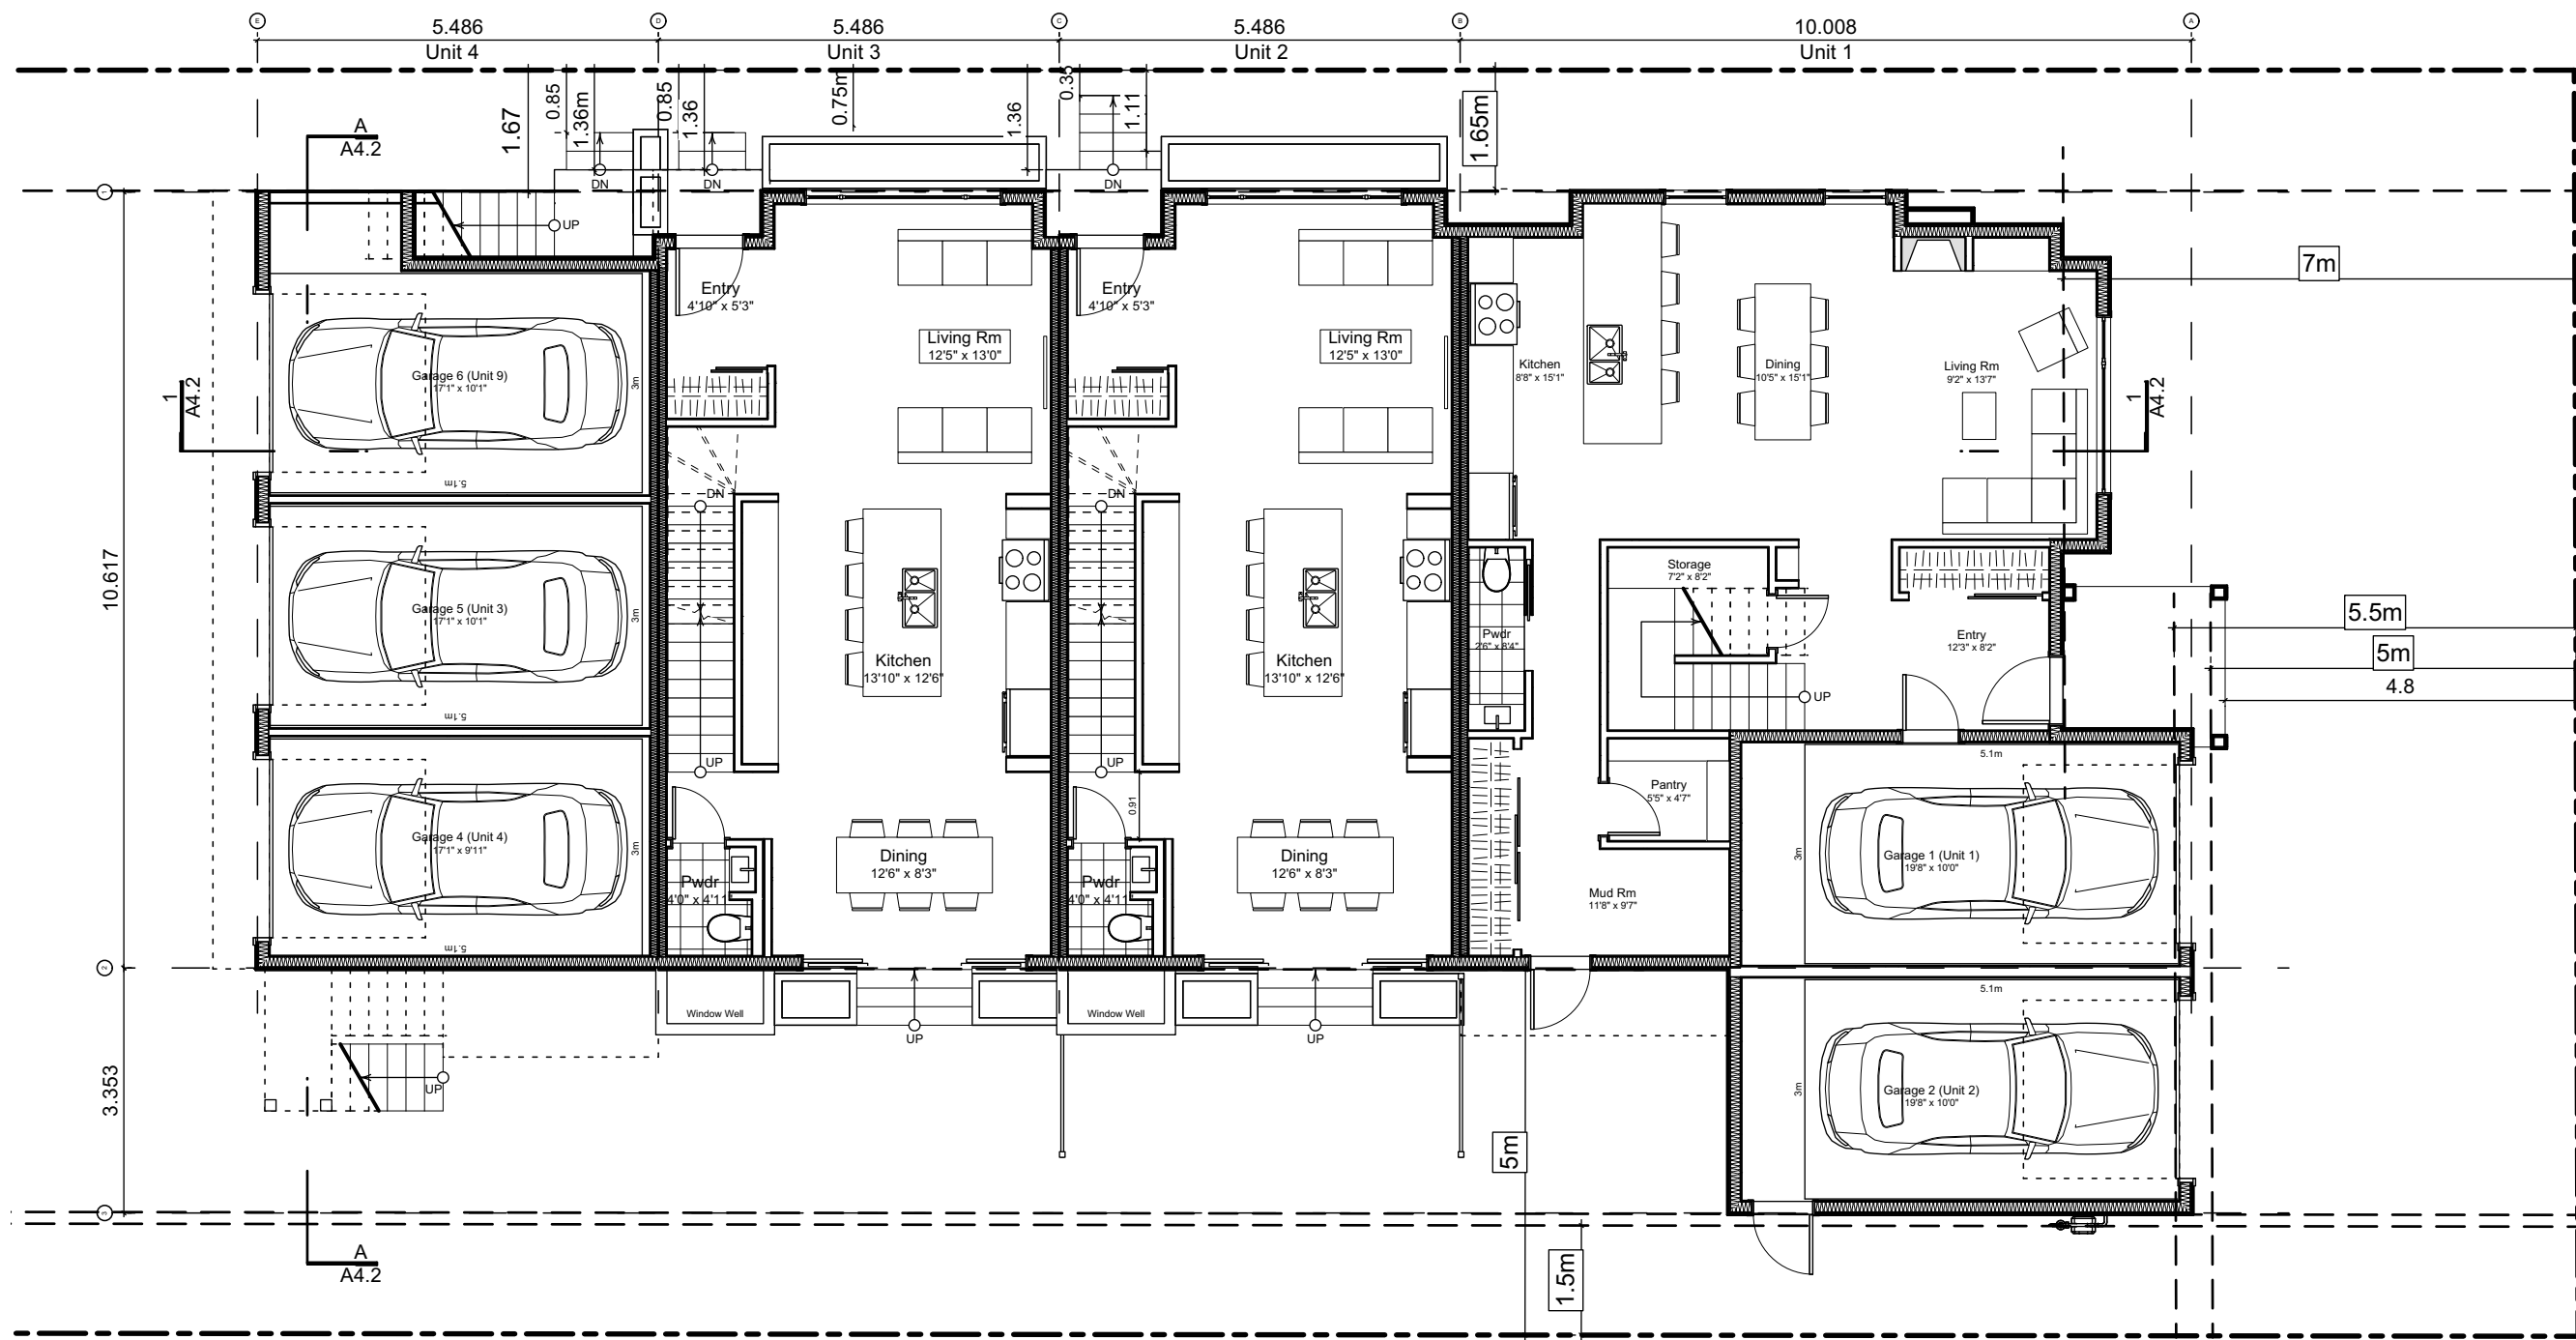
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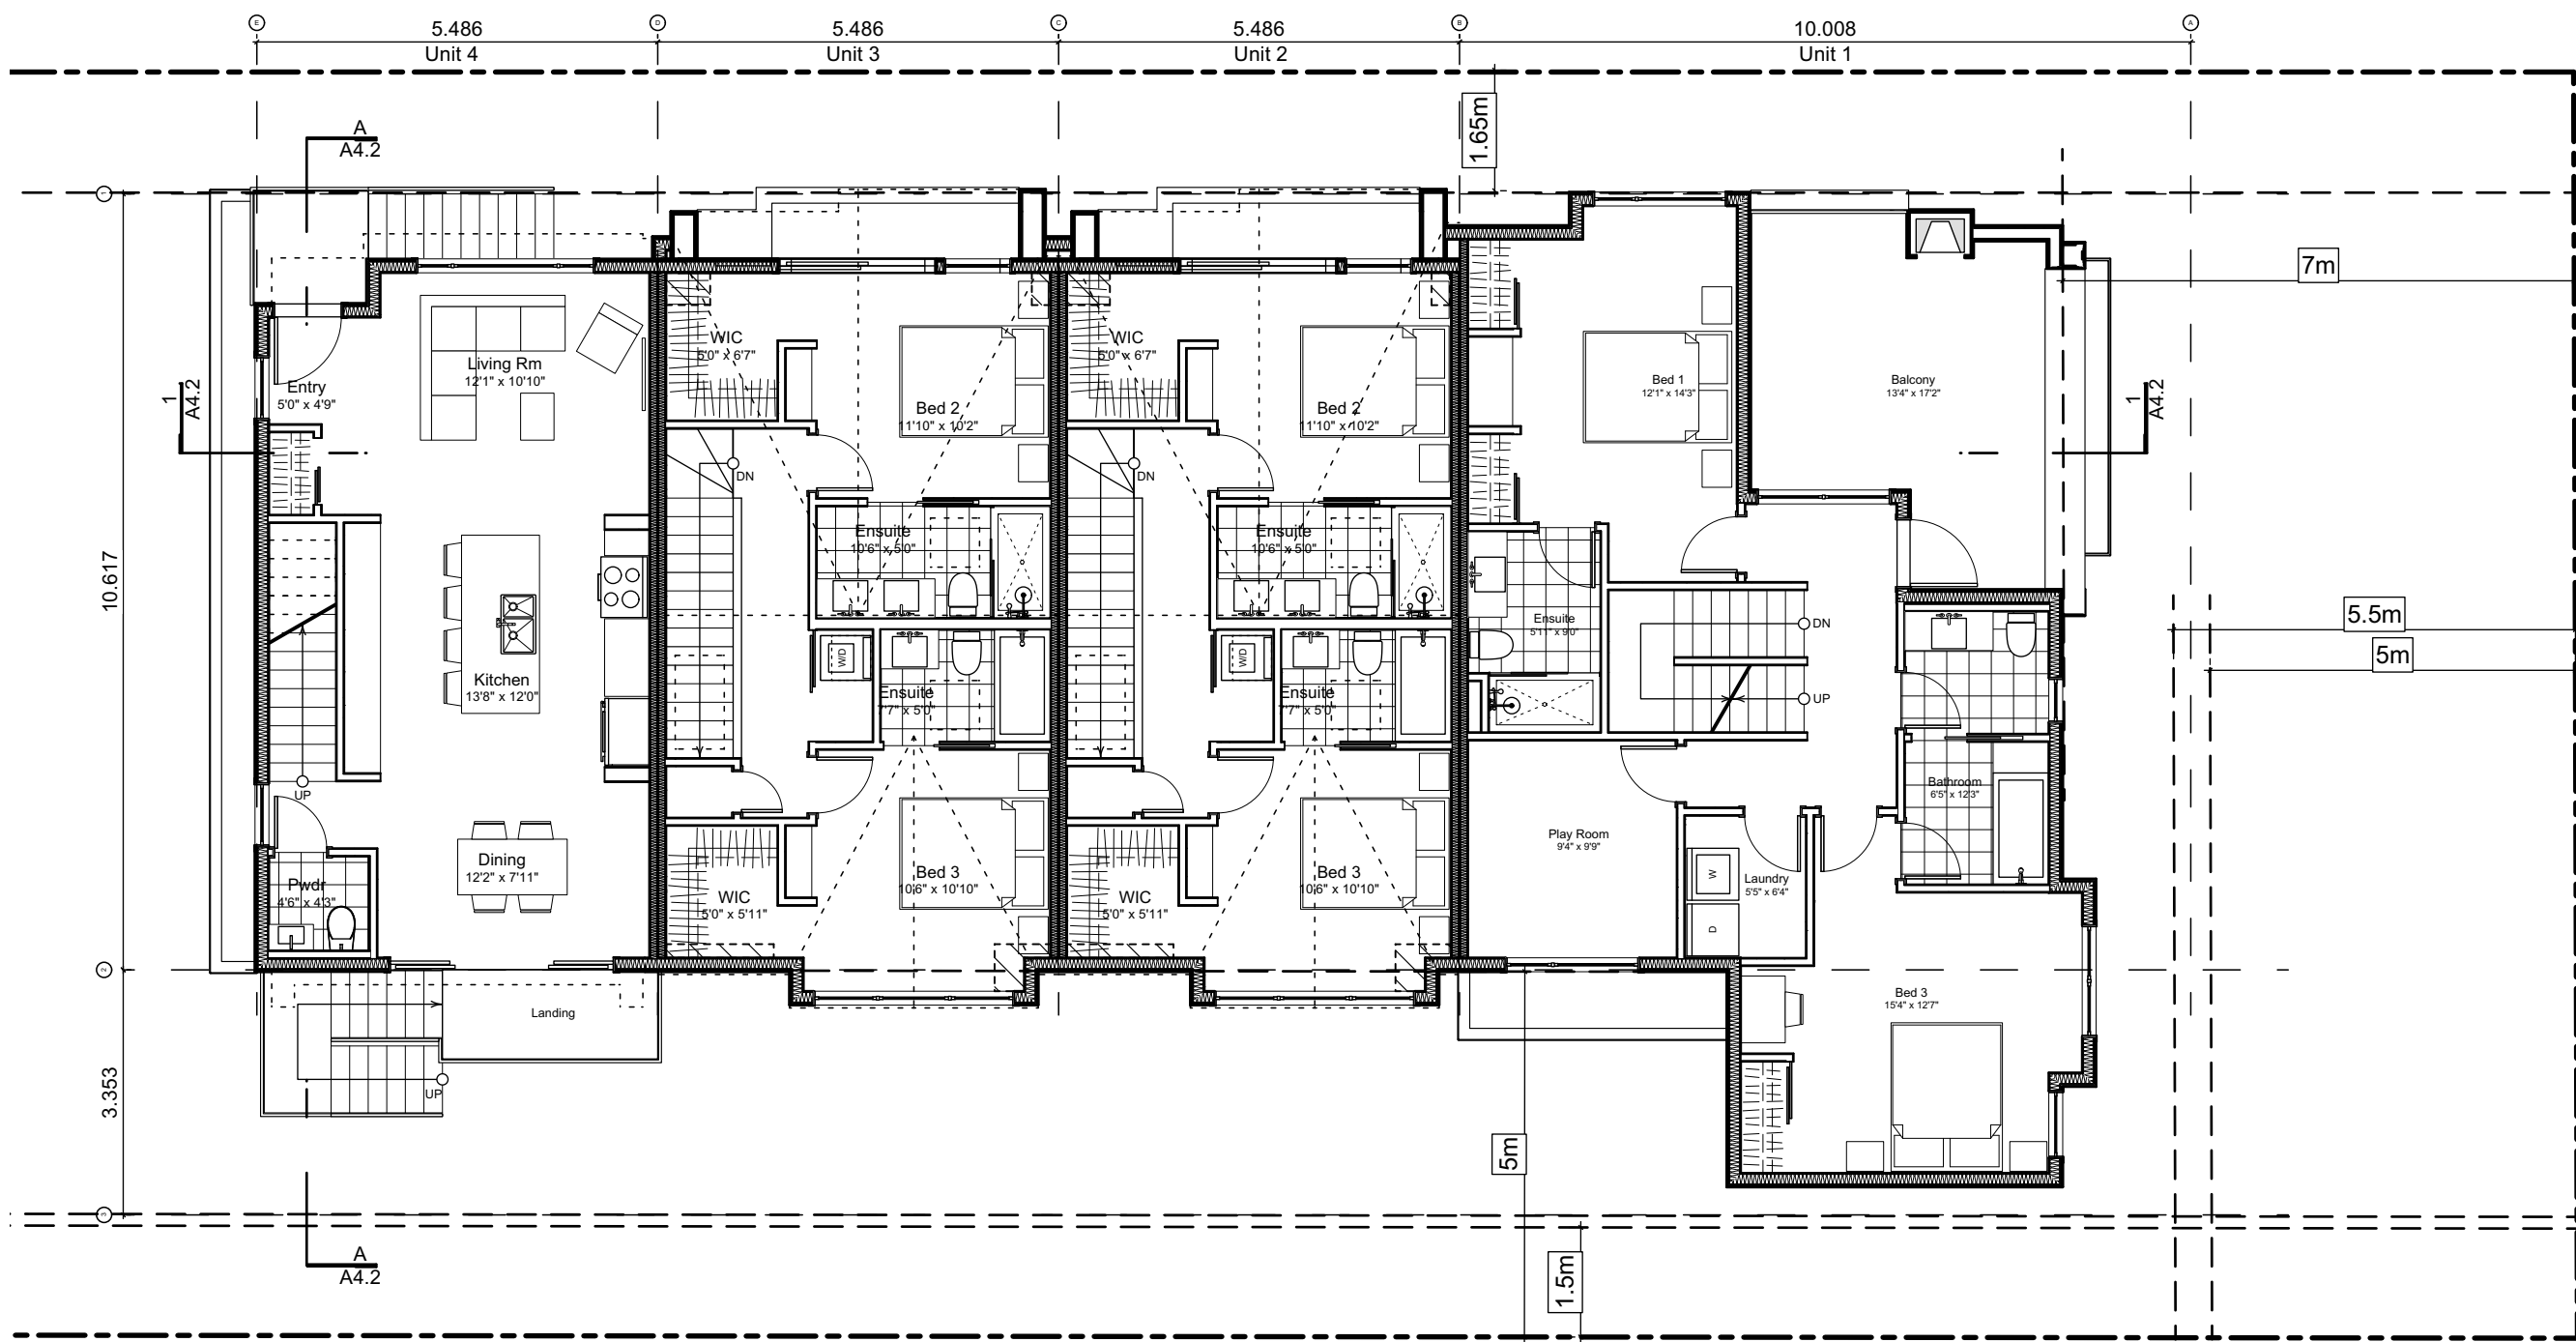
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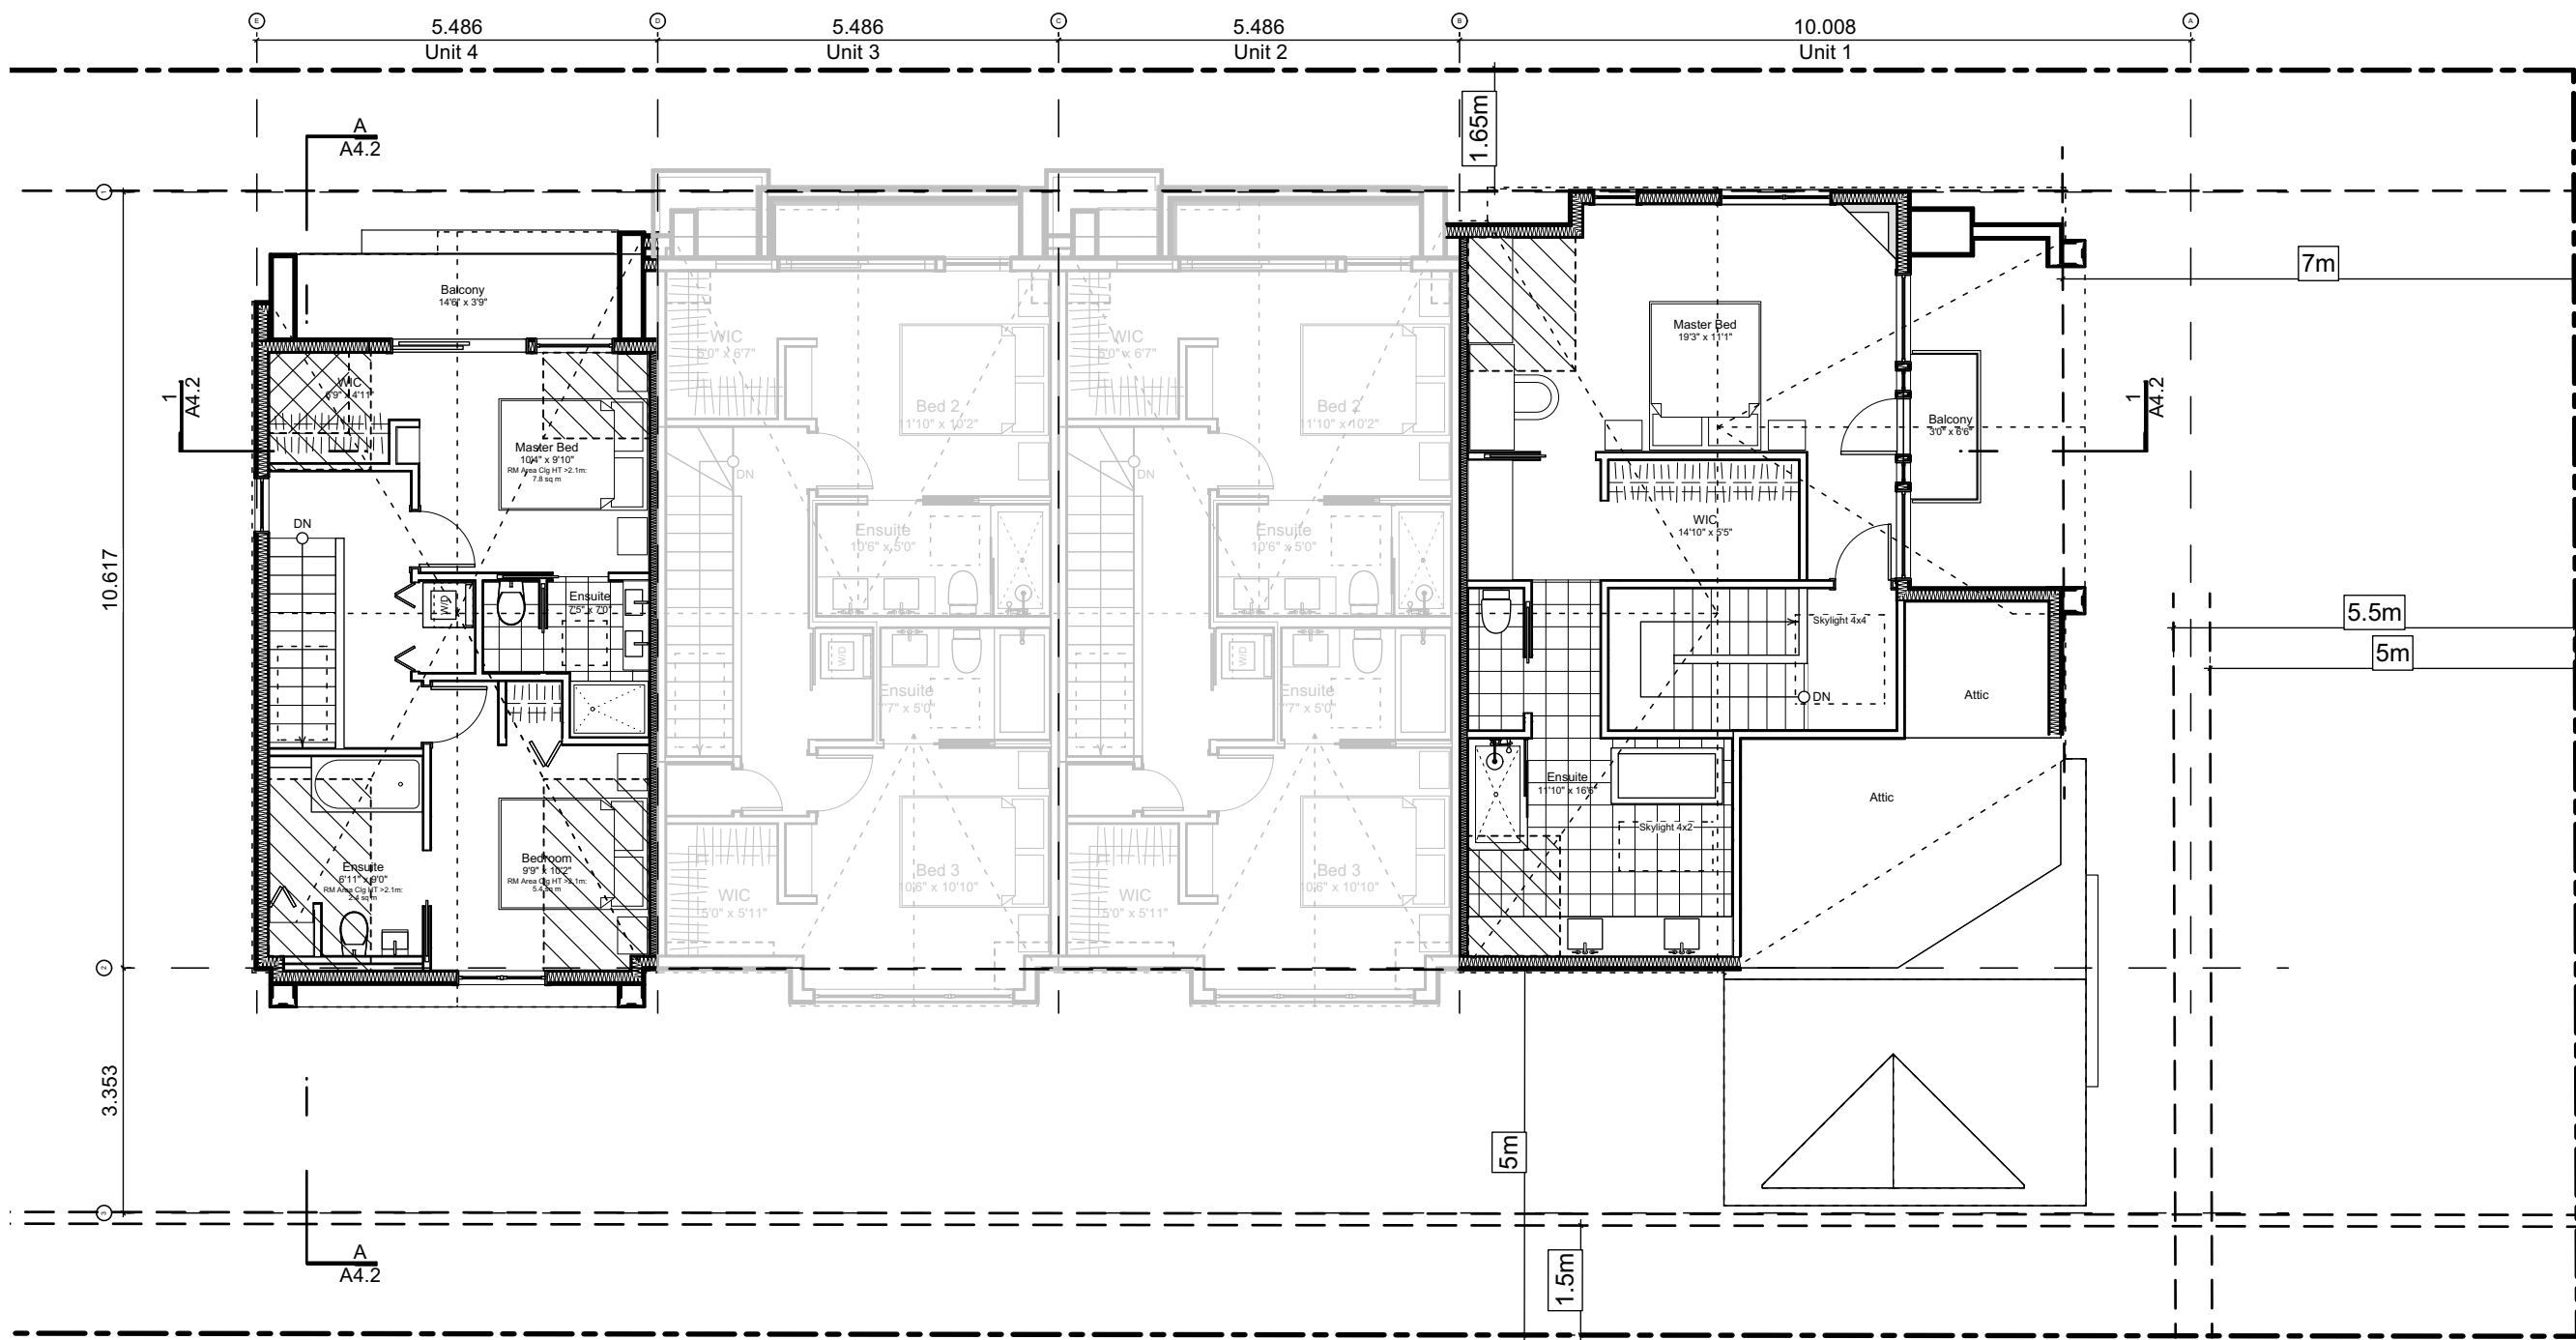
0 Basement Floor Plan
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1 Main Floor Plan
Scale: 1:100



2 Second Floor Plan
Scale: 1:100



3 Third Floor Plan
Scale: 1:100

Block Plan Notes:

See unit plans for detailed dimensions and notes.

Grid Lines are to:

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Block 01 Floor Plans

Project Name:

Fairfield-Kipling
Development

Civic: 1400 Fairfield Rd &
349 Kipling St

Legal:

PID:
Project No: 19.015

Drawn By: SG/TD

Plot Date: Nov 29, 2022

Scale: 1:100

Sheet No:

A4.0

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Spatial Separation (9.10.14.4.) - Block 01 (Not Sprinklered)

Compartment	Area of Facade	Limiting Distance (LD)		Unprotected Openings		Construction of Building Face	Cladding
				Permitted	Actual		
North Facade							
(N) Unit 1	51.5 m2	11.40 m	to C/L Kipling St.	95.2 % 49.0 m2	19.9 % 10.3 m2	C, 45 MIN	C or NC
(N) Unit 2	41.2 m2	11.40 m	to C/L Kipling St.	LD Exceeds 8.0m, UPO Allowed > 100%		C, 45 MIN	C or NC
(N) Unit 3	39.6 m2	11.40 m	to C/L Kipling St.	LD Exceeds 8.0m, UPO Allowed > 100%		C, 45 MIN	C or NC
(N) Unit 4	38.9 m2	11.40 m	to C/L Kipling St.	LD Exceeds 8.0m, UPO Allowed > 100%		C, 45 MIN	C or NC
East Facade							
(E) Unit 1	88.9 m2	15.16 m	to Thurlow Rd	LD Exceeds 12.0m, UPO Allowed > 100%		C, 45 MIN	C or NC
South Facade							
(S) Unit 1A	14.1 m2	1.66 m	to PL	19.5 % **2.8 m2	0.0 % 0.0 m2	C, 60 MIN	NC
(S) Unit 1B	30.6 m2	5.00 m	to PL	42.5 % 13.0 m2	10.5 % 3.2 m2	C, 45 MIN	C or NC
(S) Garage 2	17.9 m2	1.66 m	to PL	15.4 % **2.8 m2	9.2 % 1.7 m2	C, 60 MIN	NC
(S) Unit 2	35.9 m2	5.00 m	to PL	42.5 % 15.2 m2	23.9 % 8.6 m2	C, 45 MIN	C or NC
(S) Unit 3	35.9 m2	5.00 m	to PL	42.5 % 15.2 m2	23.9 % 8.6 m2	C, 45 MIN	C or NC
(S) Unit 4	24.9 m2	5.00 m	to PL	42.5 % 10.6 m2	33.6 % 8.4 m2	C, 45 MIN	C or NC
(S) Garage 3	12.6 m2	1.66 m	to PL	21.9 % **2.8 m2	0.0 % 0.0 m2	C, 60 MIN	NC
West Facade							
(W) Unit 4	43.1 m2	3.56 m	to Midway	29.4 % **12.7 m2	6.5 % 2.8 m2	C, 45 MIN	C or NC
(W) Garage 4	7.2 m2	3.56 m	to Midway	175.7 % **12.7 m2	72.1 % 5.2 m2	C, 45 MIN	C or NC
(W) Garage 5	7.3 m2	3.56 m	to Midway	174.1 % **12.7 m2	71.5 % 5.2 m2	C, 45 MIN	C or NC
(W) Garage 6	9.7 m2	3.56 m	to Midway	130.9 % **12.7 m2	53.7 % 5.2 m2	C, 45 MIN	C or NC

9.10.14.2.(2) Fire Compartments are to be a min. of 45min FRR

** Limiting Distance Squared

9.10.14.3. Assumes Fire department response time is < 10min


Exterior Materials

No.	Description	
1	Wood Shingles	Cedar
2	Vertical Siding	Light Grey
3	Stucco	Acrylic, White
4	Cementitious Trims & Panels	White
5	Horizontal Cladding	Wood Grain
6	Window Frame	White
7	Glass Railing	Glass Guardrail with White Aluminum Frame
8	Metal Cap Flashing	White
9	Metal Cladding	Standing Seam, White
10	Metal Roof	Standing Seam, White
11	Soffit	Wood Grain
12	Exposed Concrete	-
13	Skylight	
14	Pergola	
15	Gutter & Downspout	White


All Materials as noted or approved equal



1 North Elevation - Kipling Street
Scale: 1:65

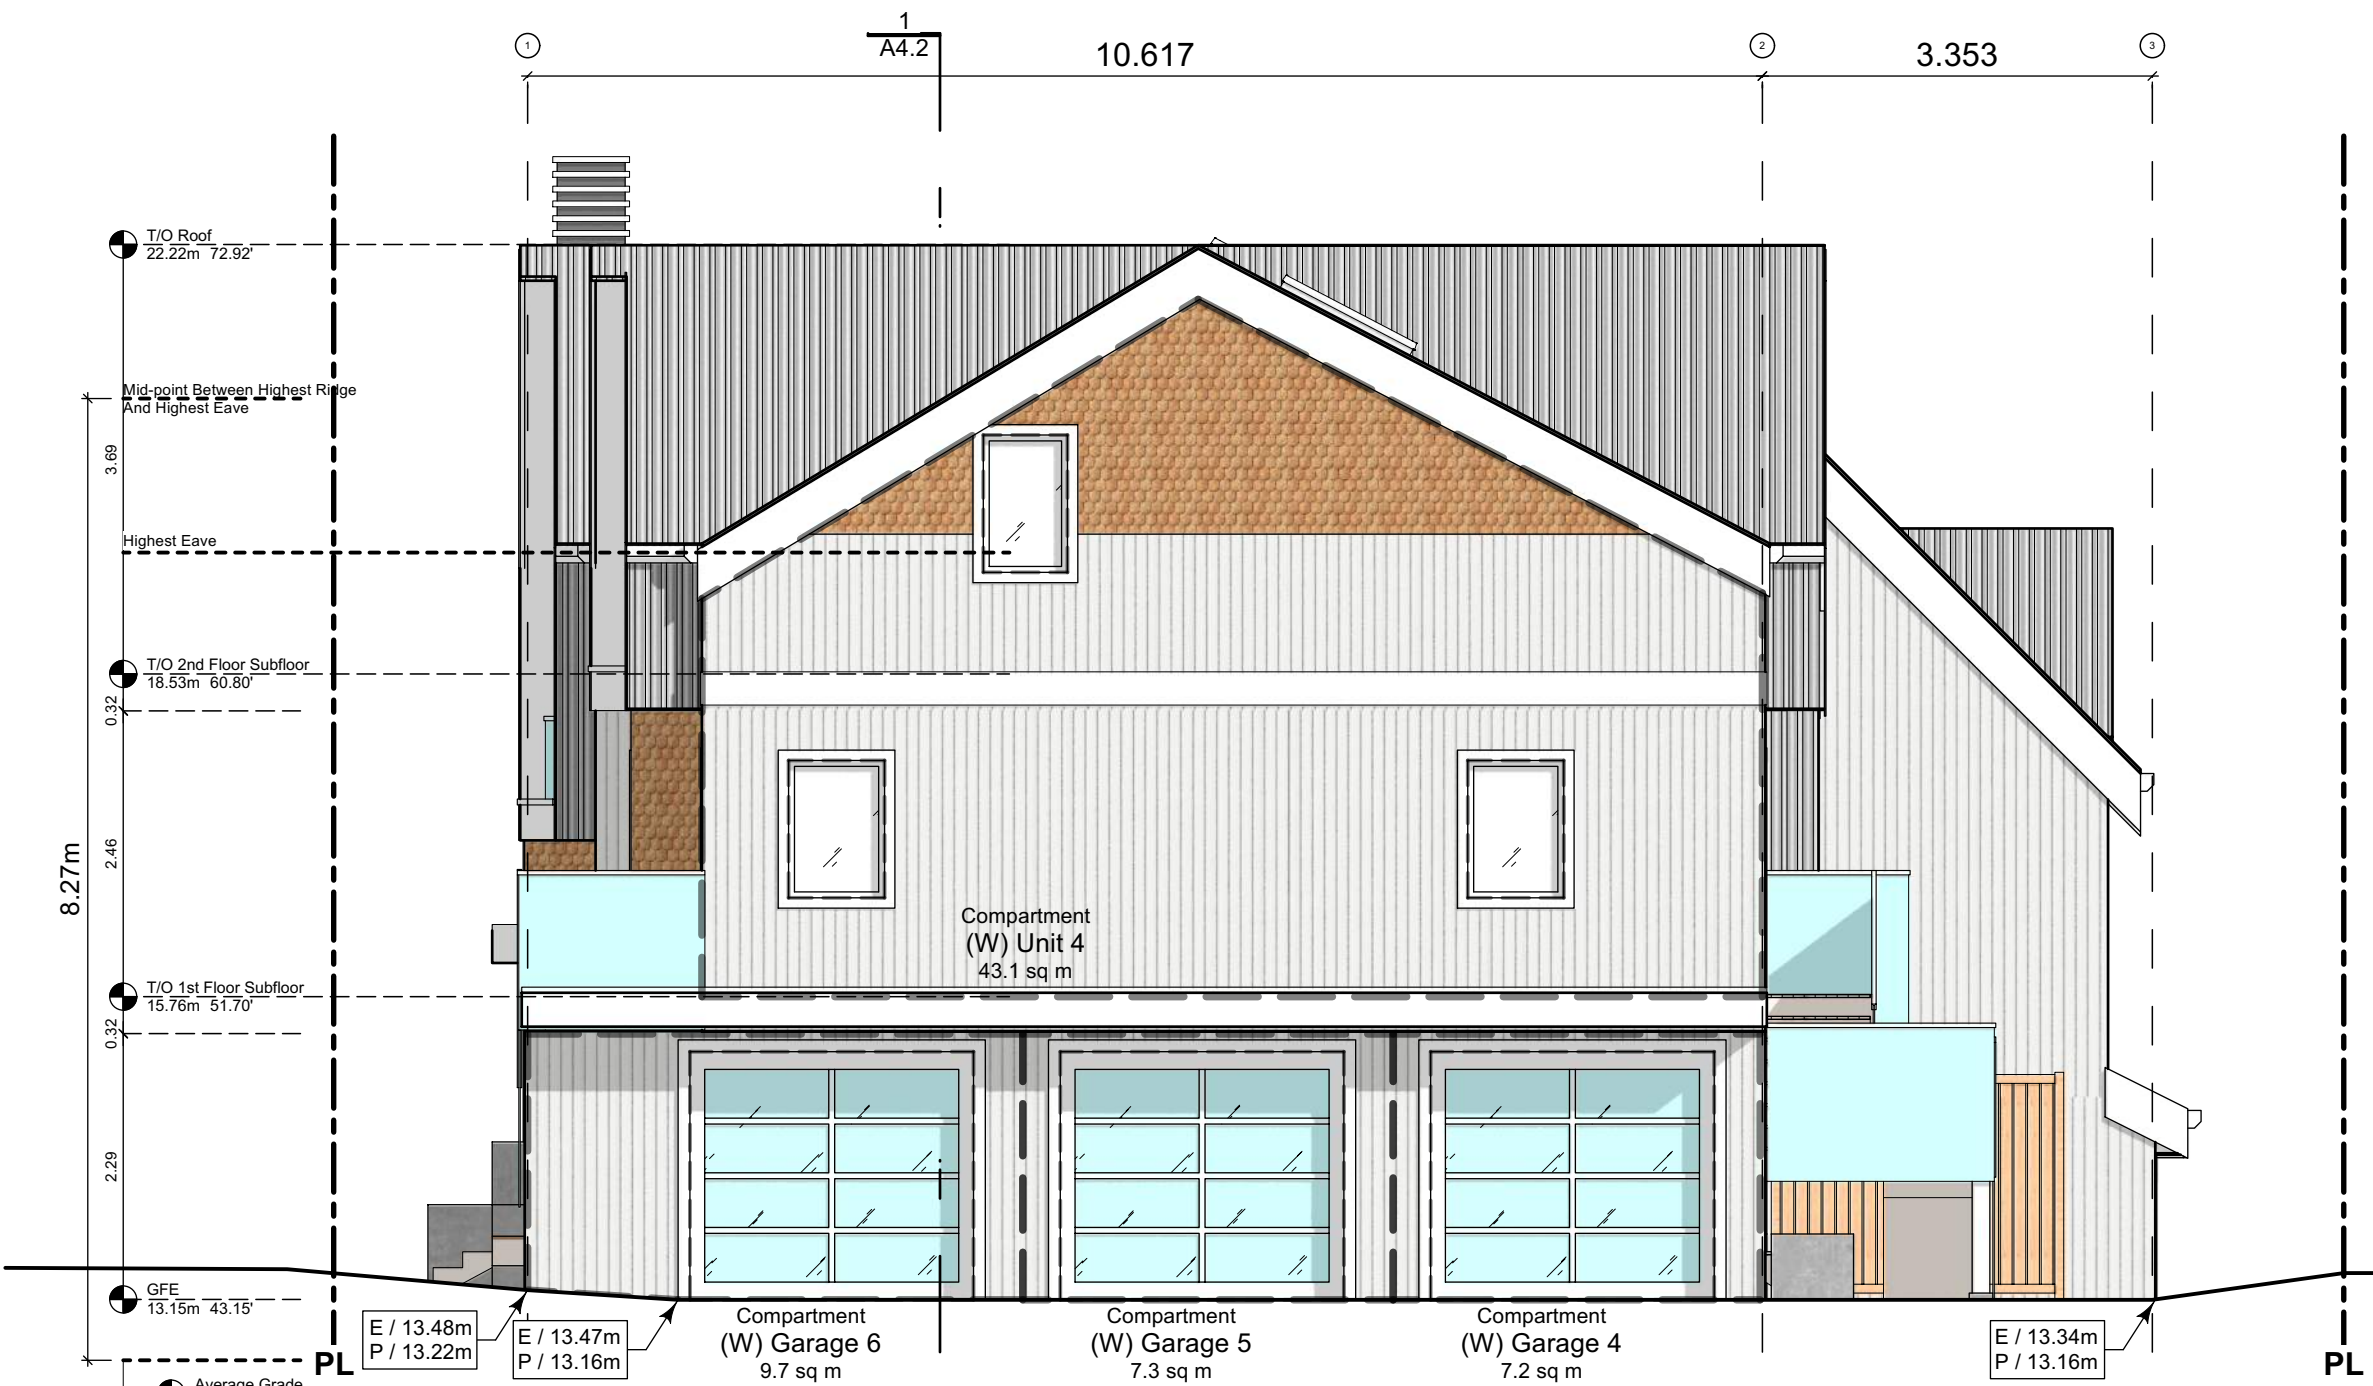

2 West Elevation - Driveway
Scale: 1:65

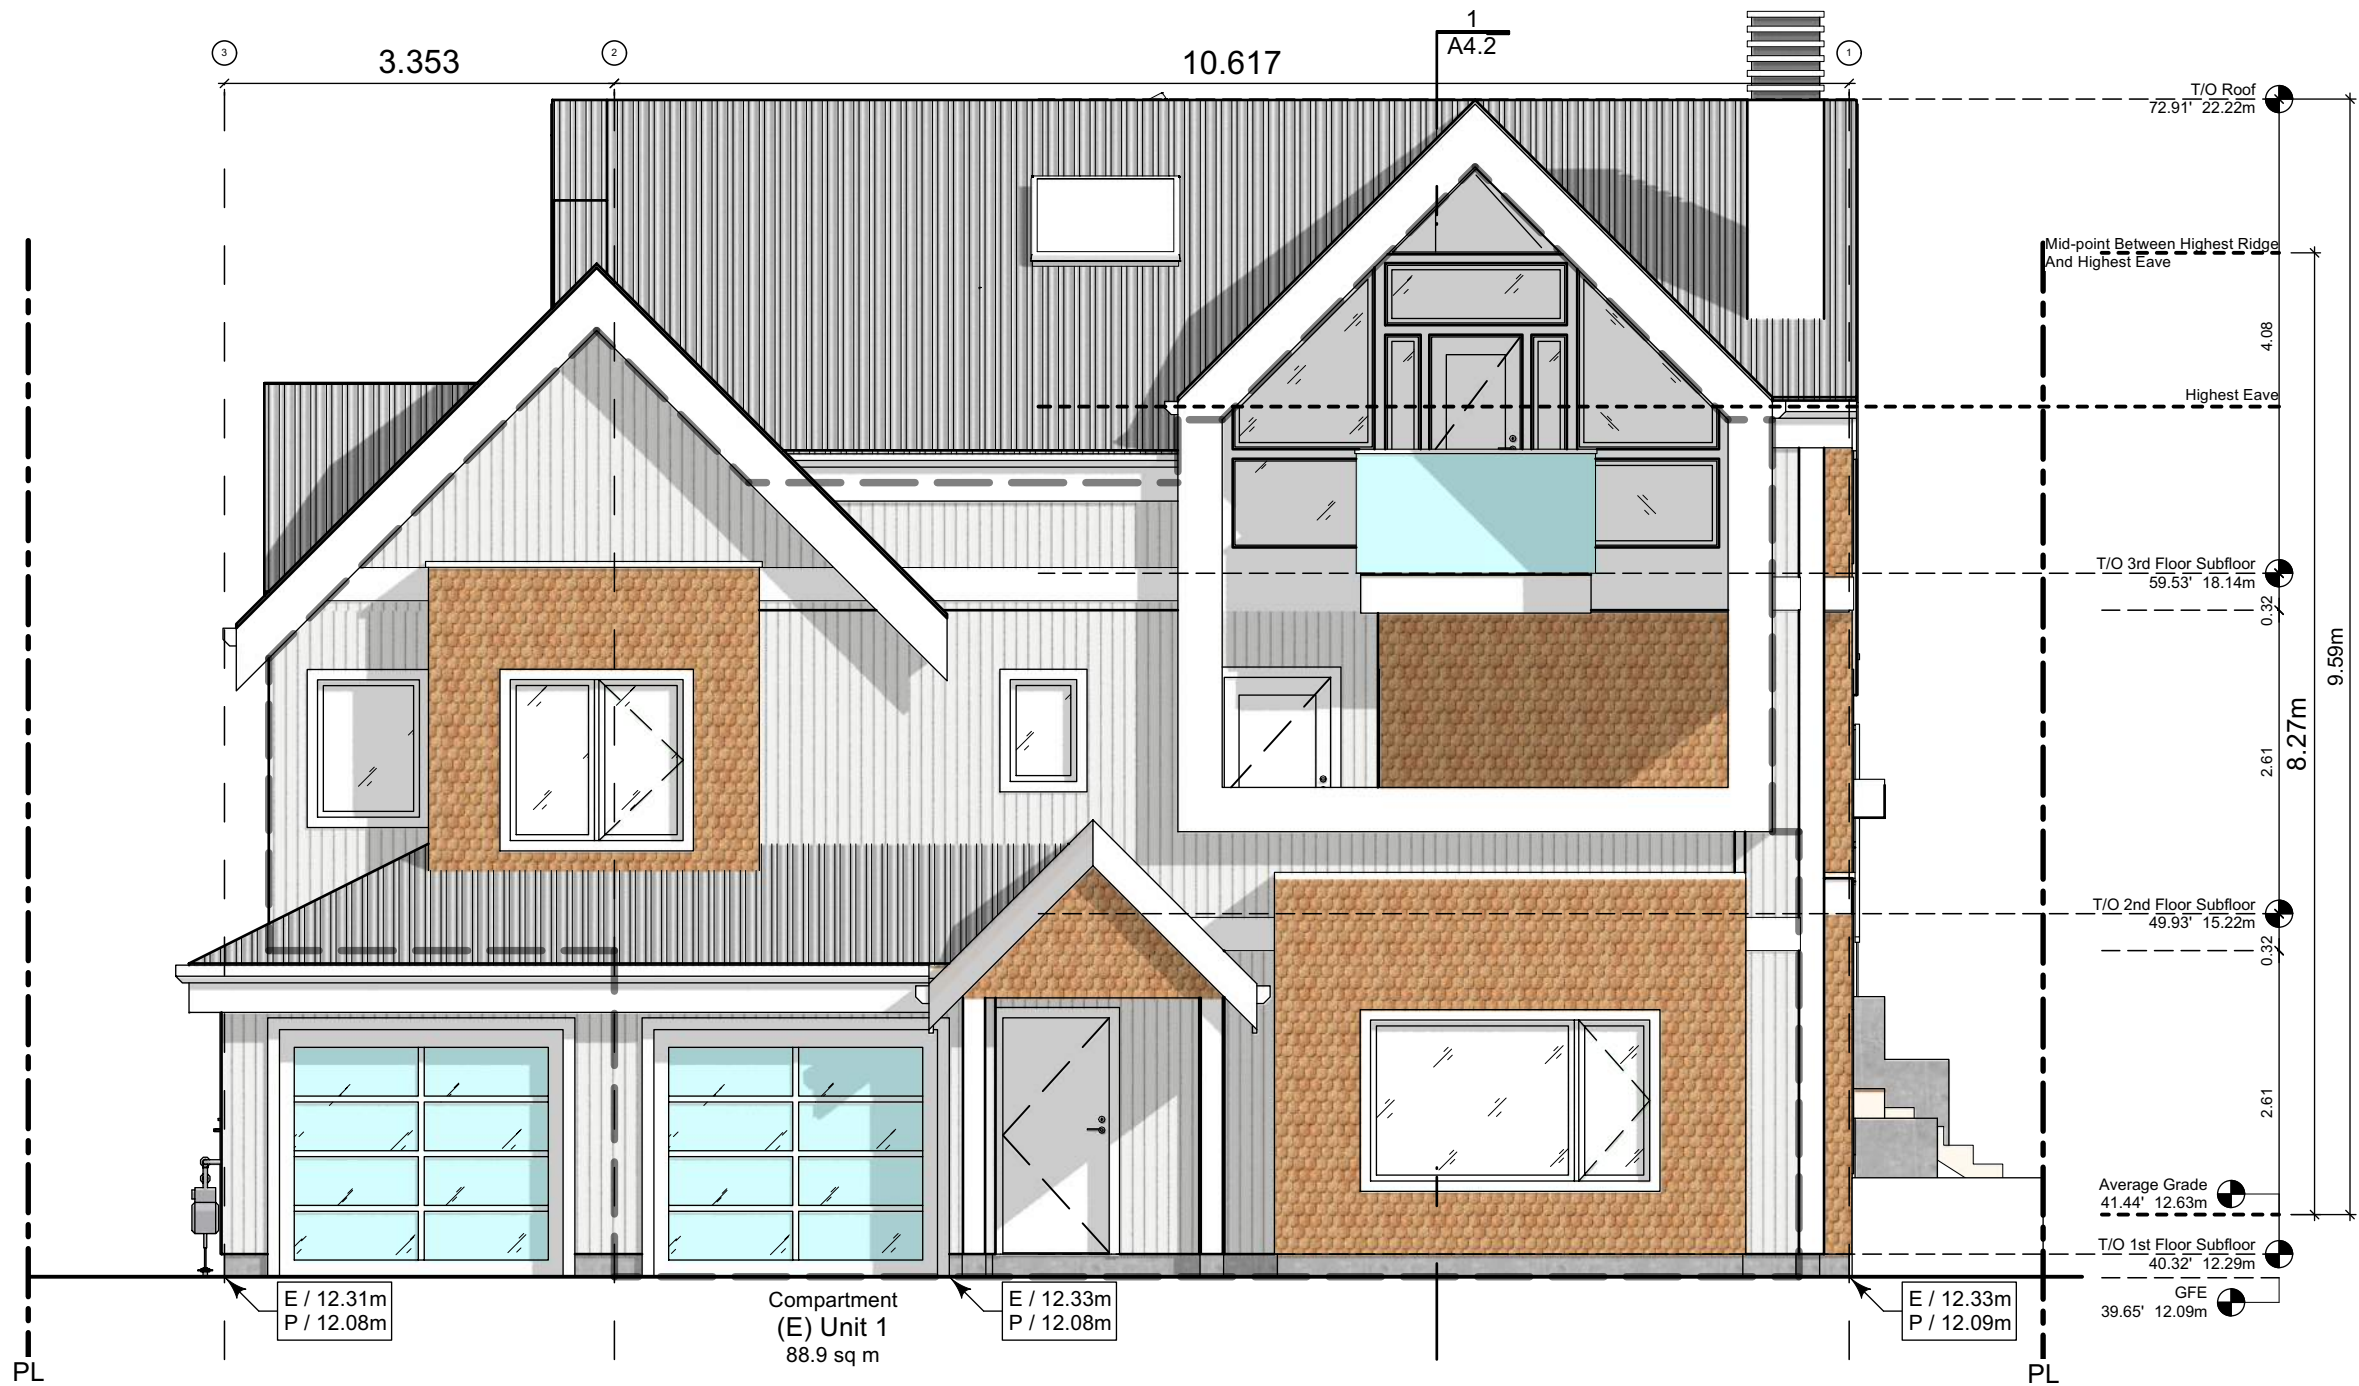

3 East Elevation - Thurlow Road
Scale: 1:65

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Block 01 Elevations

Project Name:

Fairfield-Kipling
Development

Civic: 1400 Fairfield Rd &
349 Kipling St

Legal:

PID:

Project No: 19.015

Drawn By: SG/TD

Plot Date: Nov 29, 2022

Scale: 1:65

Sheet No:


Exterior Materials

No.	Description	
1	Wood Shingles	Cedar
2	Vertical Siding	Light Grey
3	Stucco	Acrylic, White
4	Cementitious Trims & Panels	White
5	Horizontal Cladding	Wood Grain
6	Window Frame	White
7	Glass Railing	Glass Guardrail with White Aluminum Frame
8	Metal Cap Flashing	White
9	Metal Cladding	Standing Seam, White
10	Metal Roof	Standing Seam, White
11	Soffit	Wood Grain
12	Exposed Concrete	-
13	Skylight	
14	Pergola	
15	Gutter & Downspout	White

All Materials as noted or approved equal



2 South Elevation
Scale: 1:65

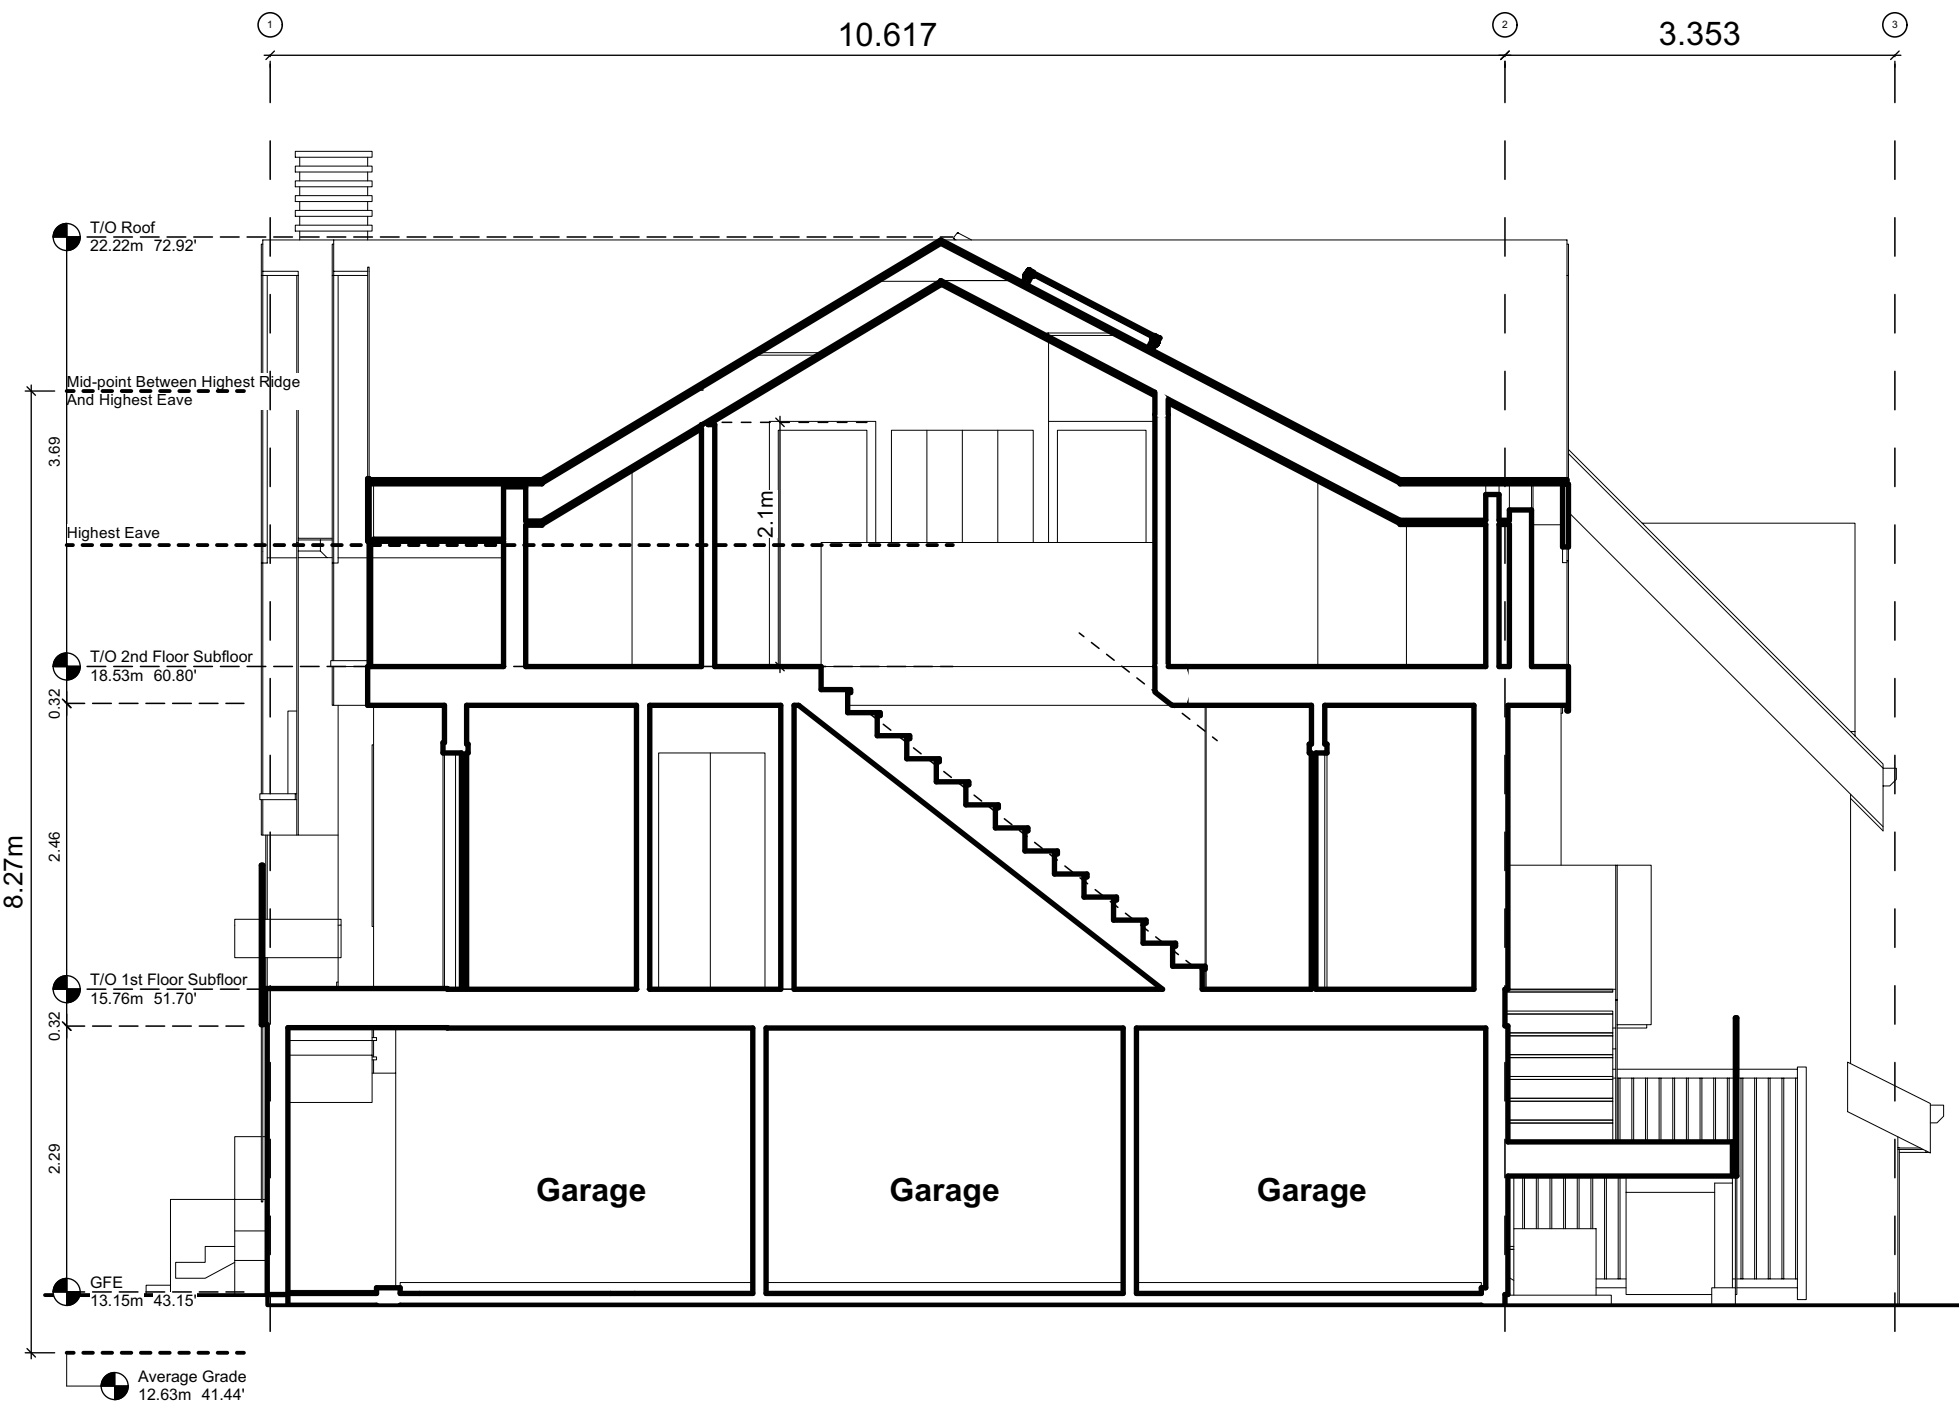

A Block 1 Unit 4 Section
Scale: 1:65



1 Block 1 Section
Scale: 1:65

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Block 01
Elevations & Sections

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Fairfield-Kipling
Development

Civic: 1400 Fairfield Rd &
349 Kipling St

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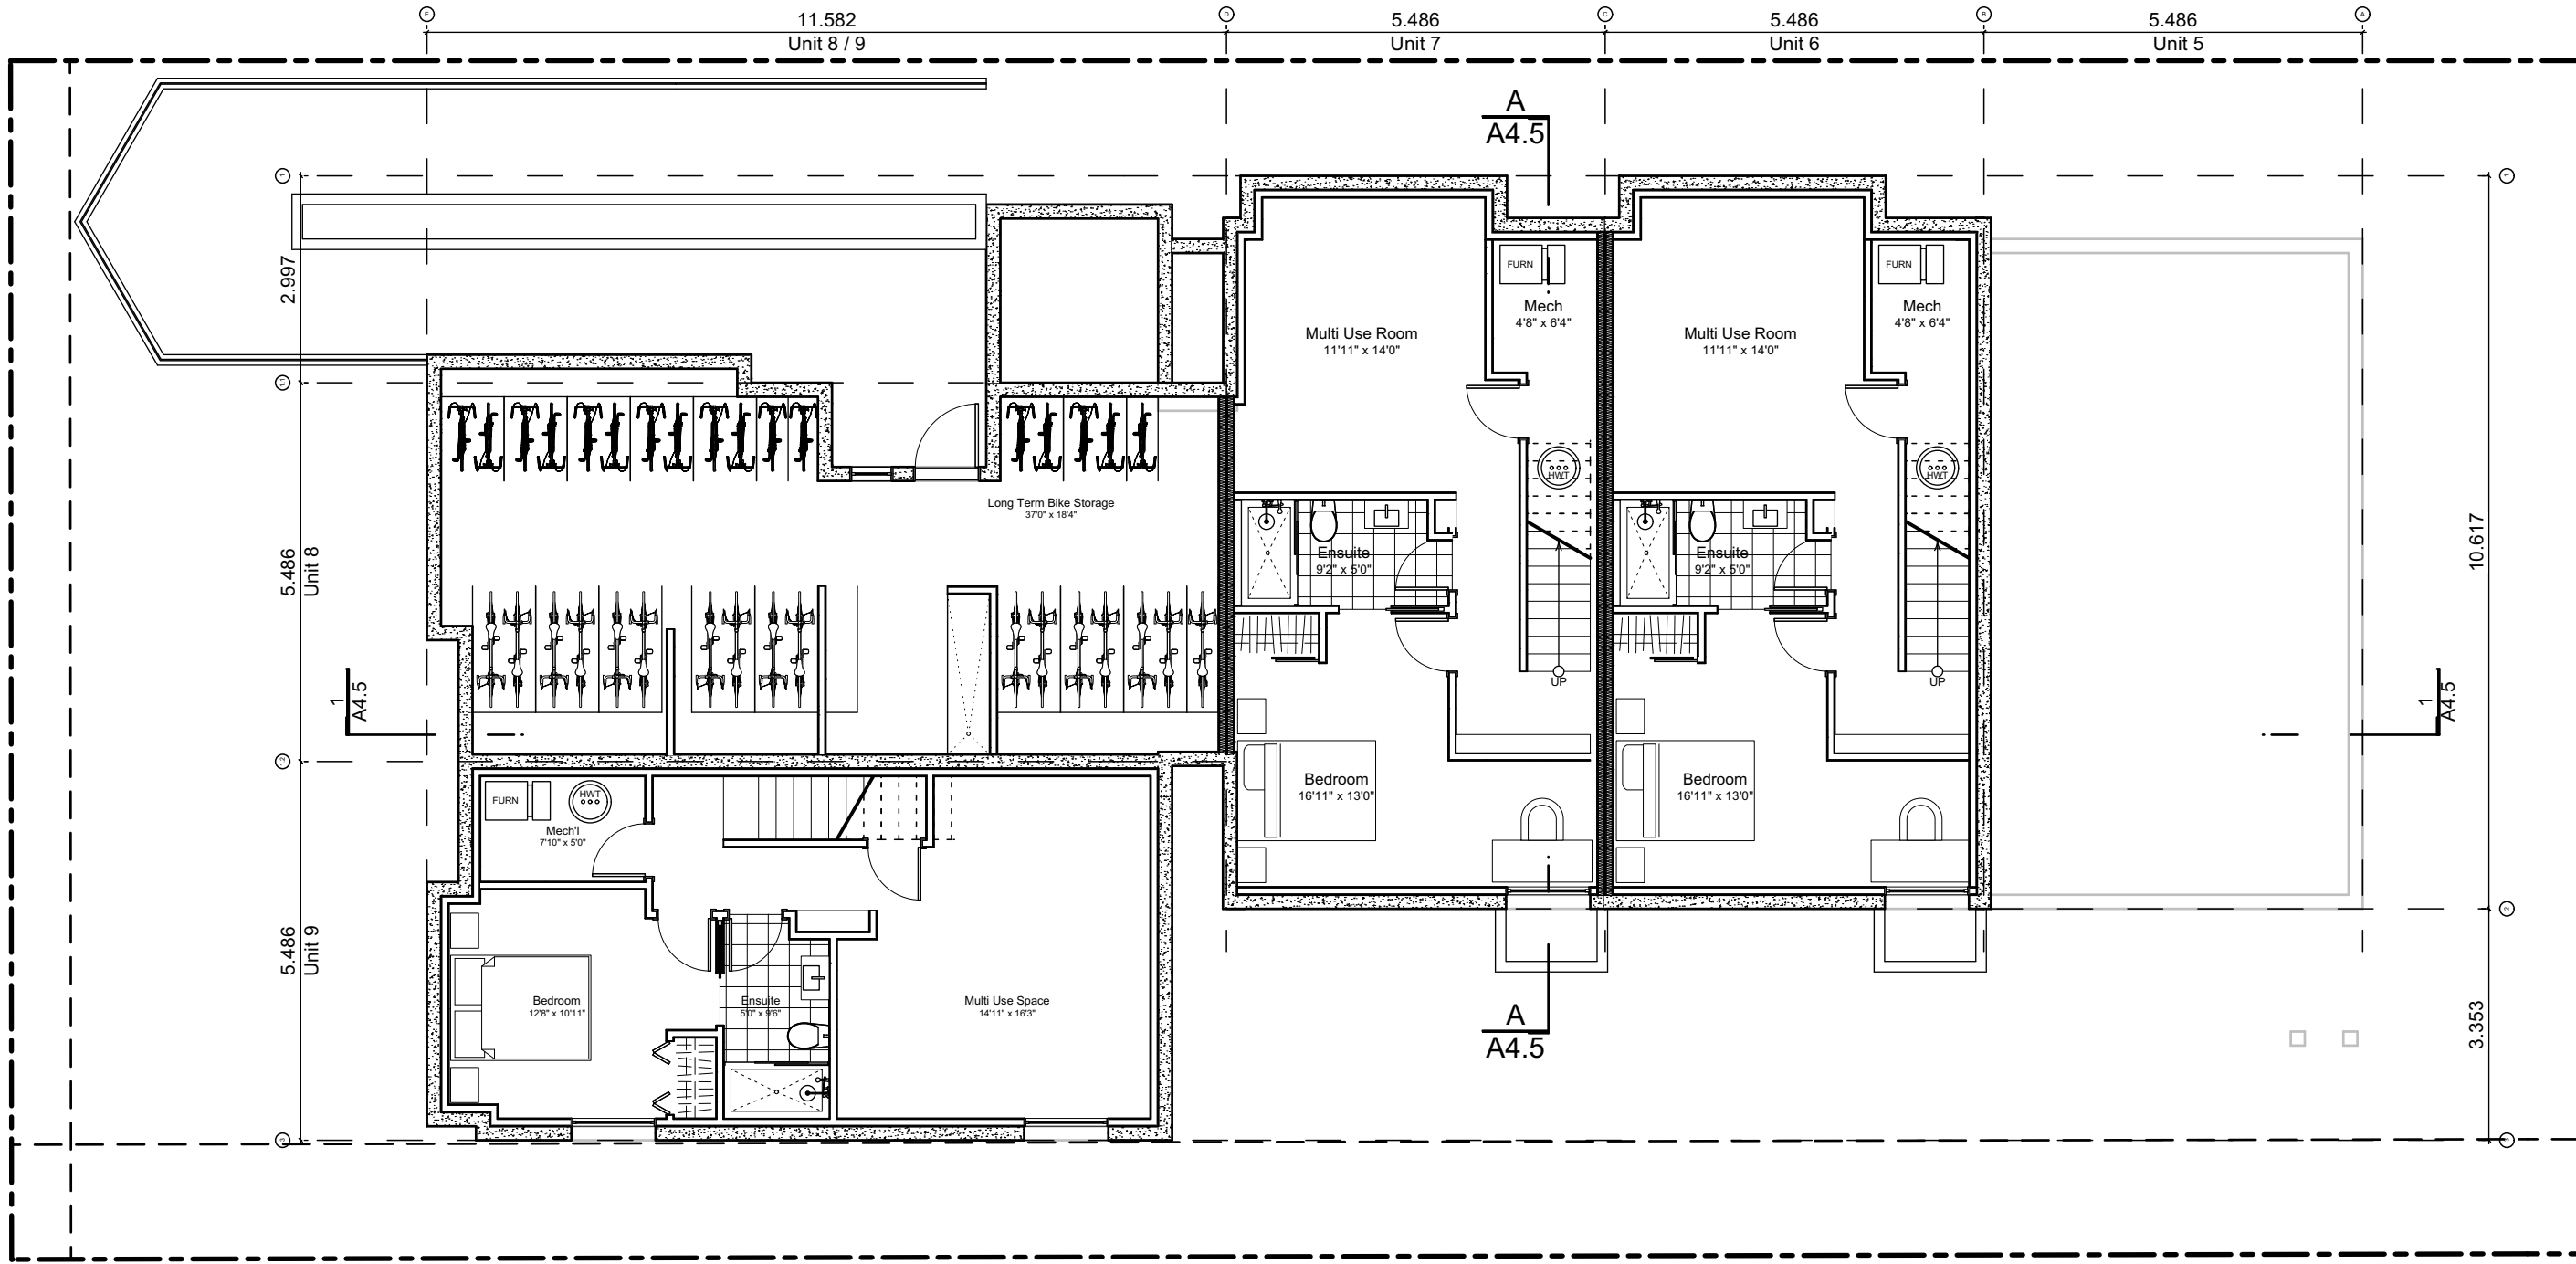
Project No: 19.015

Drawn By: SG/TD


Plot Date: Nov 29, 2022

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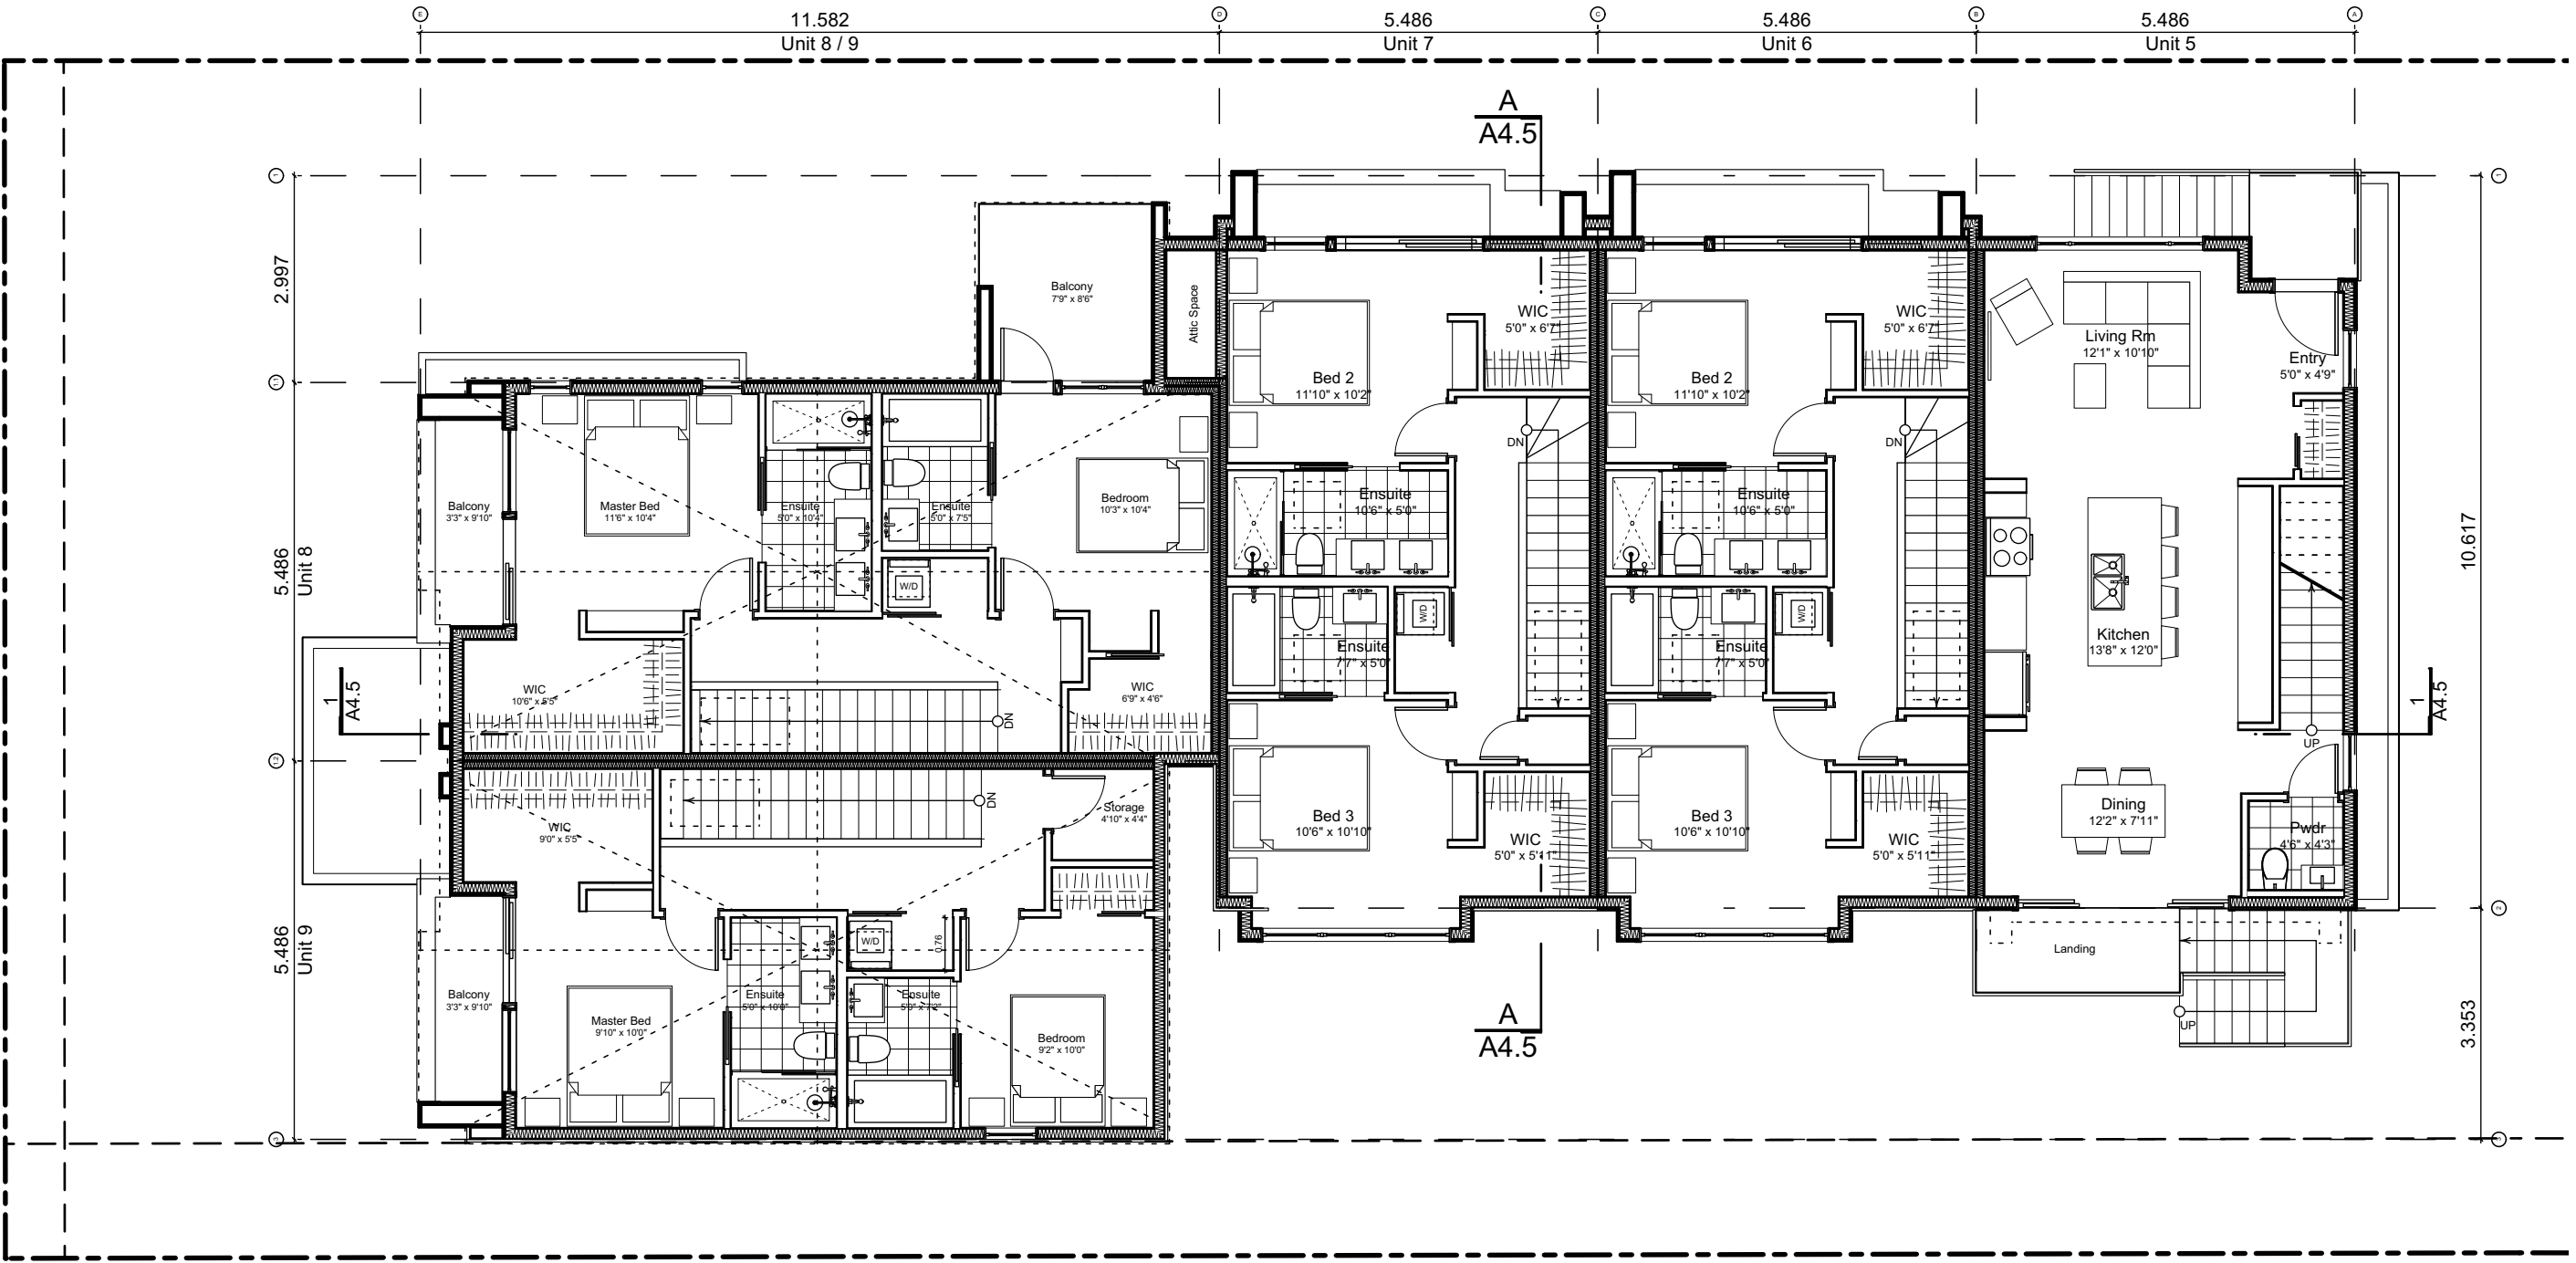
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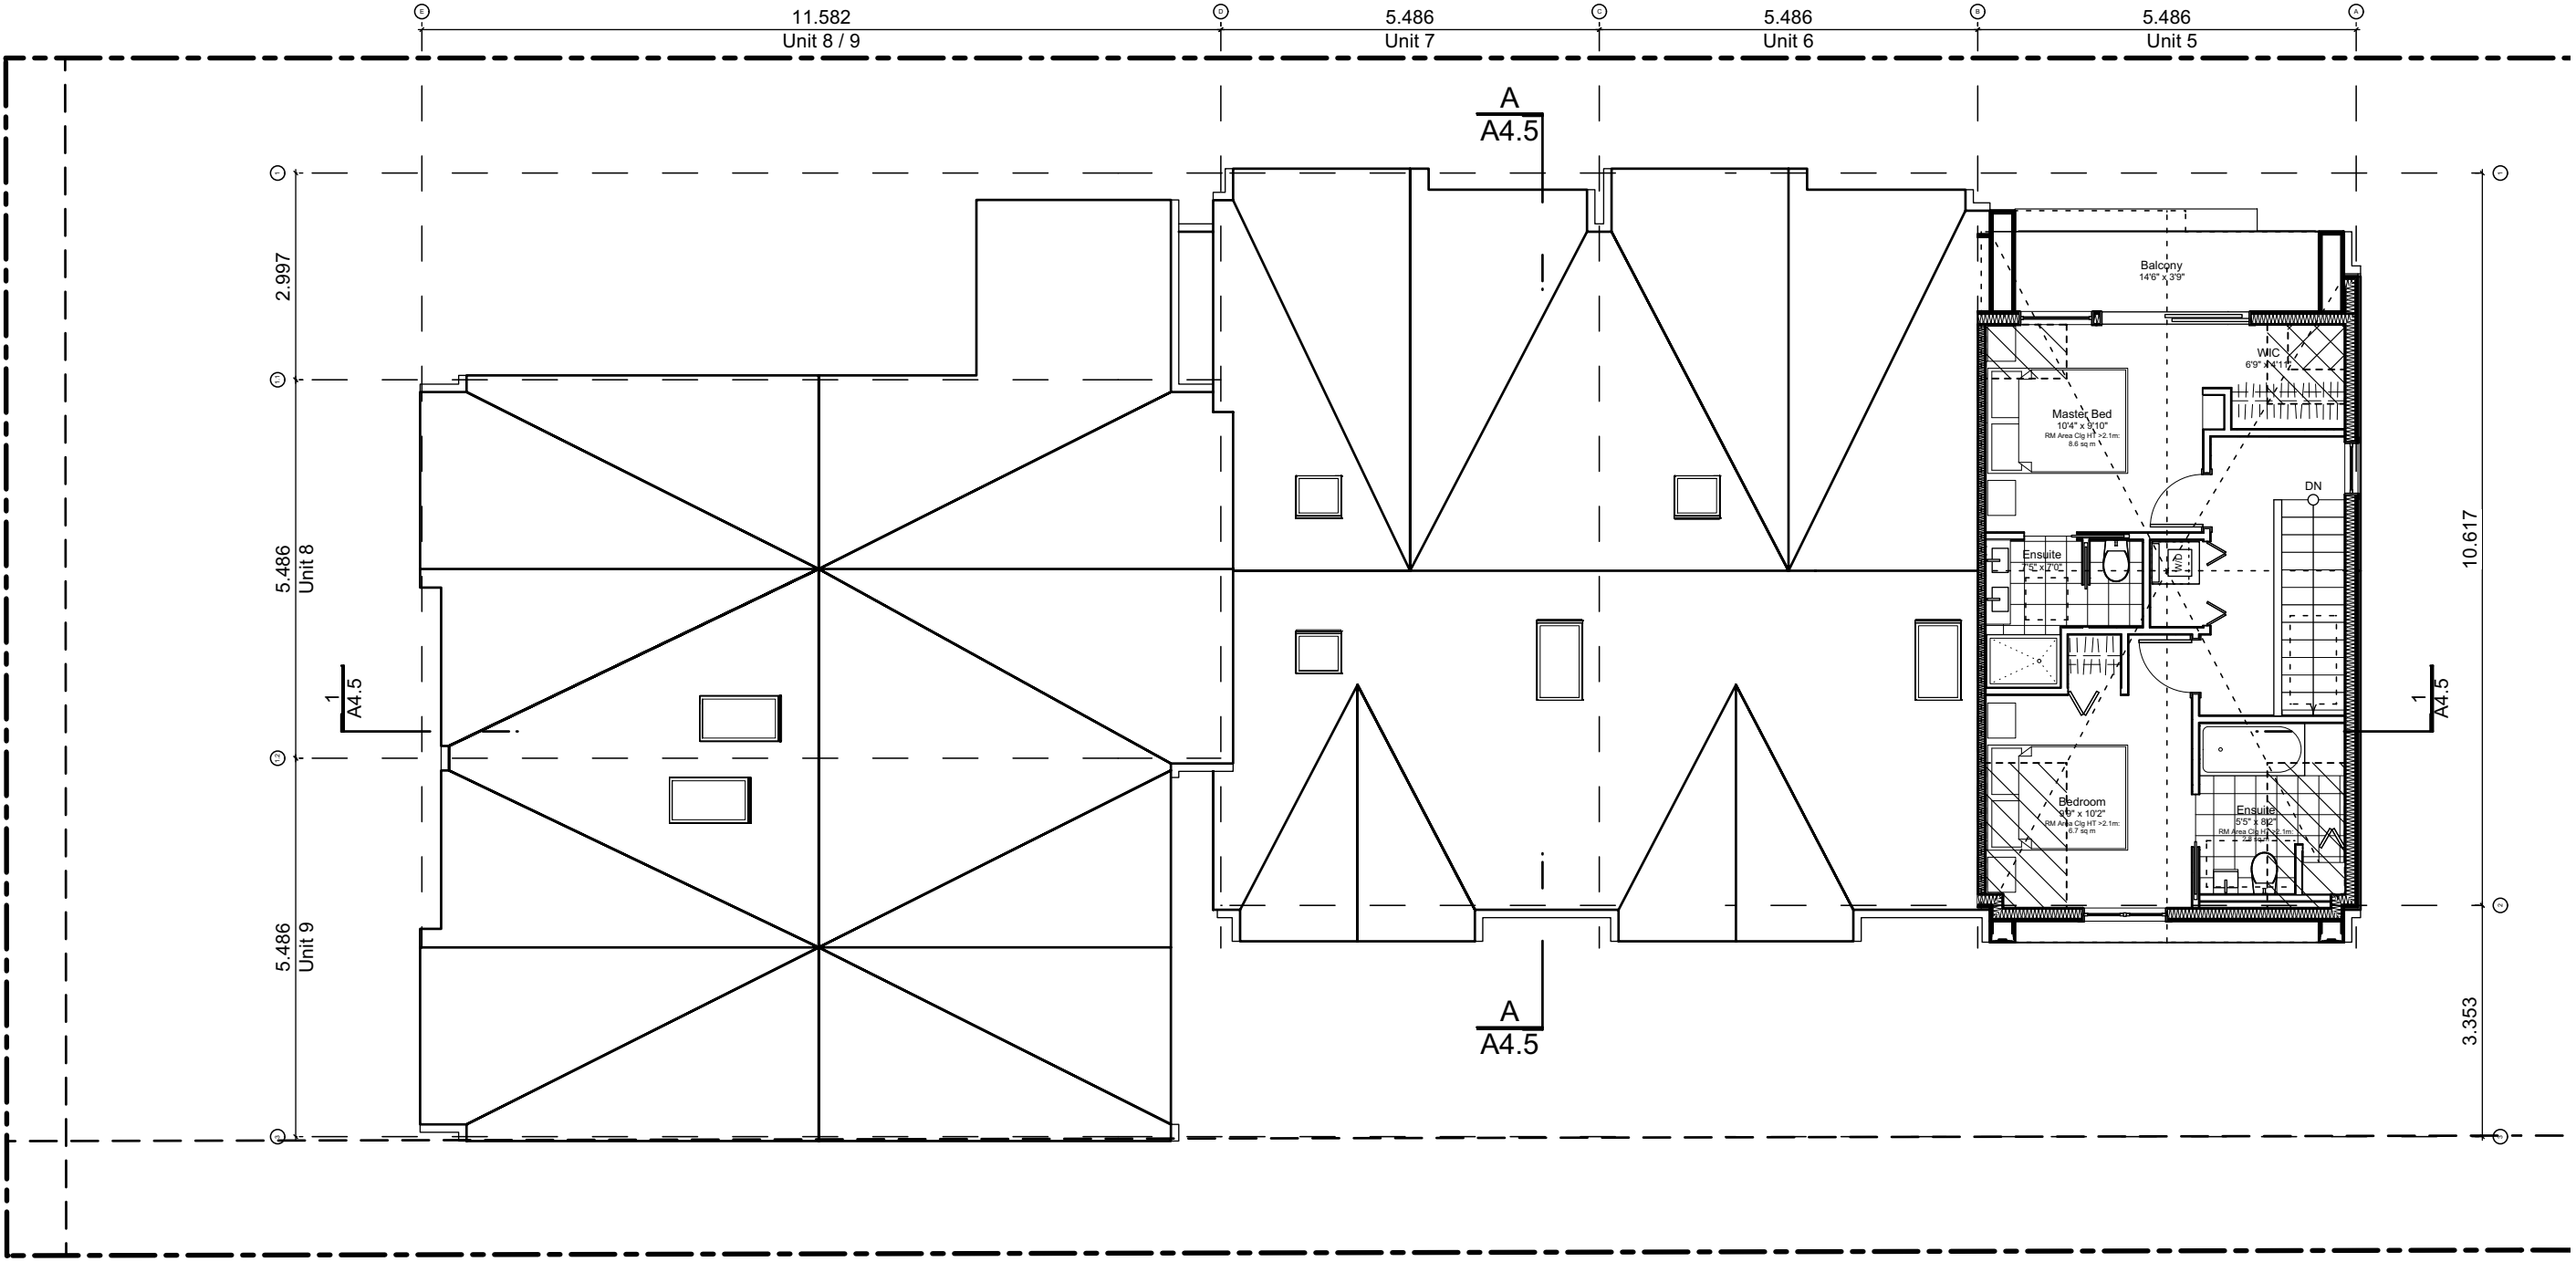
0 Basement Floor Plan
Scale: 1:100



1 Main Floor Plan
Scale: 1:100

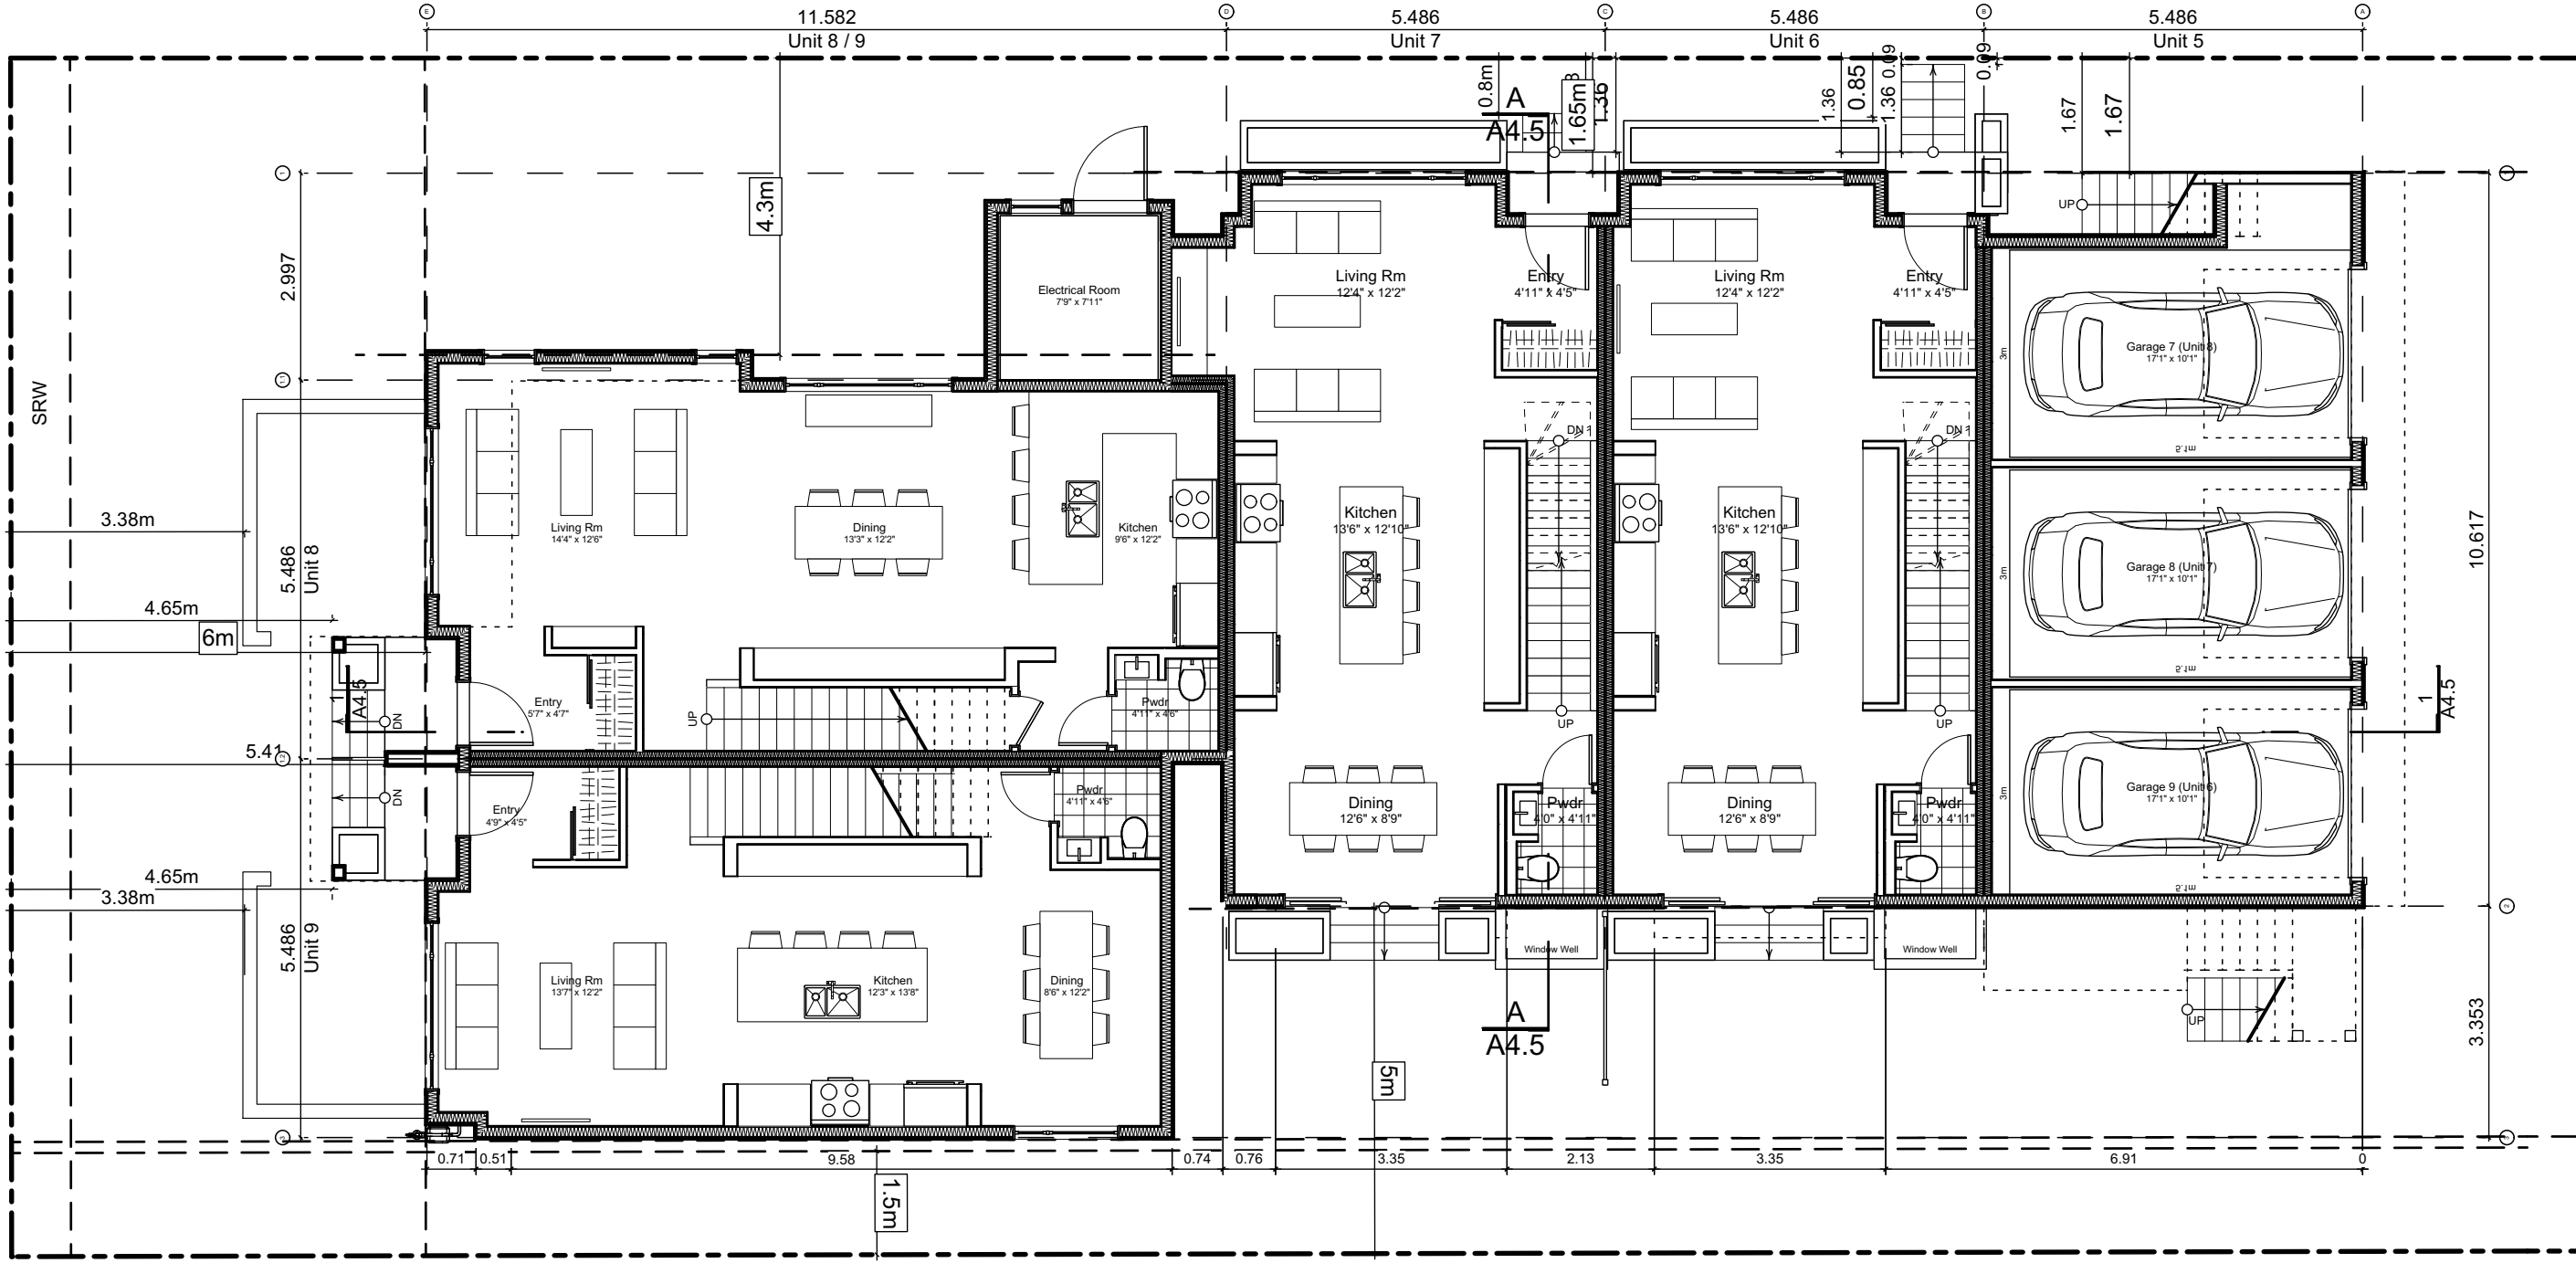

2 Second Floor Plan
Scale: 1:100



3 Third Floor Plan (Half Storey)
Scale: 1:100

Block Plan Notes:
See unit plans for detailed dimensions and notes.

Grid Lines are to:
1) Outside face of plywood or
2) Centre line of demising wall.

Dimensions are to:
1) One side of interior stud,
2) Face of plywood, or face of concrete.

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Spatial Separation (9.10.14.4.) - Block 02 (Not Sprinklered)

Compartment	Area of Facade	Limiting Distance (LD)		Unprotected Openings		Construction of Building Face	Cladding
				Permitted	Actual		
North Facade							
(N) Unit 5	38.5 m2	11.37 m	to C/L Kipling St.	LD Exceeds 8.0m, UPO Allowed > 100%		C, 45 MIN	C or NC
(N) Unit 6	39.1 m2	11.37 m	to C/L Kipling St.	95.0 % 37.1 m2	35.4 % 13.8 m2	C, 45 MIN	C or NC
(N) Unit 7	36.8 m2	11.37 m	to C/L Kipling St.	95.0 % 34.9 m2	50.3 % 18.5 m2	C, 45 MIN	C or NC
(N) Unit 8	79.2 m2	13.96 m	to C/L Kipling St.	LD Exceeds 12.0m, UPO Allowed > 100%		C, 45 MIN	C or NC
East Facade							
(E) Unit 5	47.6 m2	3.56 m	to Midway	26.6 % **12.7 m2	5.9 % 2.8 m2	C, 60 MIN	C or NC
(E) Garage 7	9.6 m2	3.56 m	to Midway	132.1 % **12.7 m2	54.2 % 5.2 m2	C, 45 MIN	C or NC
(E) Garage 8	7.3 m2	3.56 m	to Midway	174.1 % **12.7 m2	71.5 % 5.2 m2	C, 45 MIN	C or NC
(E) Garage 9	7.4 m2	3.56 m	to Midway	170.5 % **12.7 m2	70.0 % 5.2 m2	C, 45 MIN	C or NC
(E) Refuse	0.0 m2	3.56 m	to Midway	#DIV 0! **12.7 m2	#DIV 0! 0.0 m2	C, 45 MIN	C or NC
South Facade							
(S) Unit 5	41.6 m2	5.00 m	to PL	63.5 % 26.4 m2	20.1 % 8.4 m2	C, 45 MIN	C or NC
(S) Unit 6	35.0 m2	5.00 m	to PL	71.4 % **25.0 m2	30.7 % 10.7 m2	C, 45 MIN	C or NC
(S) Unit 7	35.0 m2	5.00 m	to PL	71.4 % **25.0 m2	30.7 % 10.7 m2	C, 45 MIN	C or NC
(S) Unit 9	90.2 m2	1.71 m	to PL	8.4 % 7.6 m2	5.9 % 5.3 m2	NC, 60 MIN	NC
West Facade							
(W) Unit 8	38.6 m2	15.28 m	to C/L Fairfield Rd.	LD Exceeds 8.0m, UPO Allowed > 100%		C, 45 MIN	C or NC
(W) Unit 9	38.2 m2	15.28 m	to C/L Fairfield Rd.	LD Exceeds 8.0m, UPO Allowed > 100%		C, 45 MIN	C or NC

9.10.14.2.(2) Fire Compartments are to be a min. of 45min FRR

** Limiting Distance Squared

9.10.14.3. Assumes Fire department response time is < 10min

Exterior Materials

No.	Description	
1	Wood Shingles	Cedar
2	Vertical Siding	Light Grey
3	Stucco	Acrylic, White
4	Cementious Trims & Panels	White
5	Horizontal Cladding	Wood Grain
6	Window Frame	White
7	Glass Railing	Glass Guardrail with White Aluminum Frame
8	Metal Cap Flashing	White
9	Metal Cladding	Standing Seam, White
10	Metal Roof	Standing Seam, White
11	Soffit	Wood Grain
12	Exposed Concrete	-
13	Skylight	-
14	Pergola	-
15	Gutter & Downspout	White

All Materials as noted or approved equal



1 North Elevation - Kipling Street

Scale: 1:65



2 East Elevation - Driveway

Scale: 1:65



3 West Elevation - Fairfield Road

Scale: 1:65

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Development

Civic: 1400 Fairfield Rd &
349 Kipling St

Legal:

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Project No: 19.015

Drawn By: SG/TD

Plot Date: Nov 29, 2022

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Block 02
Elevations & Sections

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A4.5


Exterior Materials

No.	Description	
1	Wood Shingles	Cedar
2	Vertical Siding	Light Grey
3	Stucco	Acrylic, White
4	Cementitious Trims & Panels	White
5	Horizontal Cladding	Wood Grain
6	Window Frame	White
7	Glass Railing	Glass Guardrail with White Aluminum Frame
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13	Skylight	-
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15	Gutter & Downspout	White


All Materials as noted or approved equal



2 South Elevation
Scale: 1:65

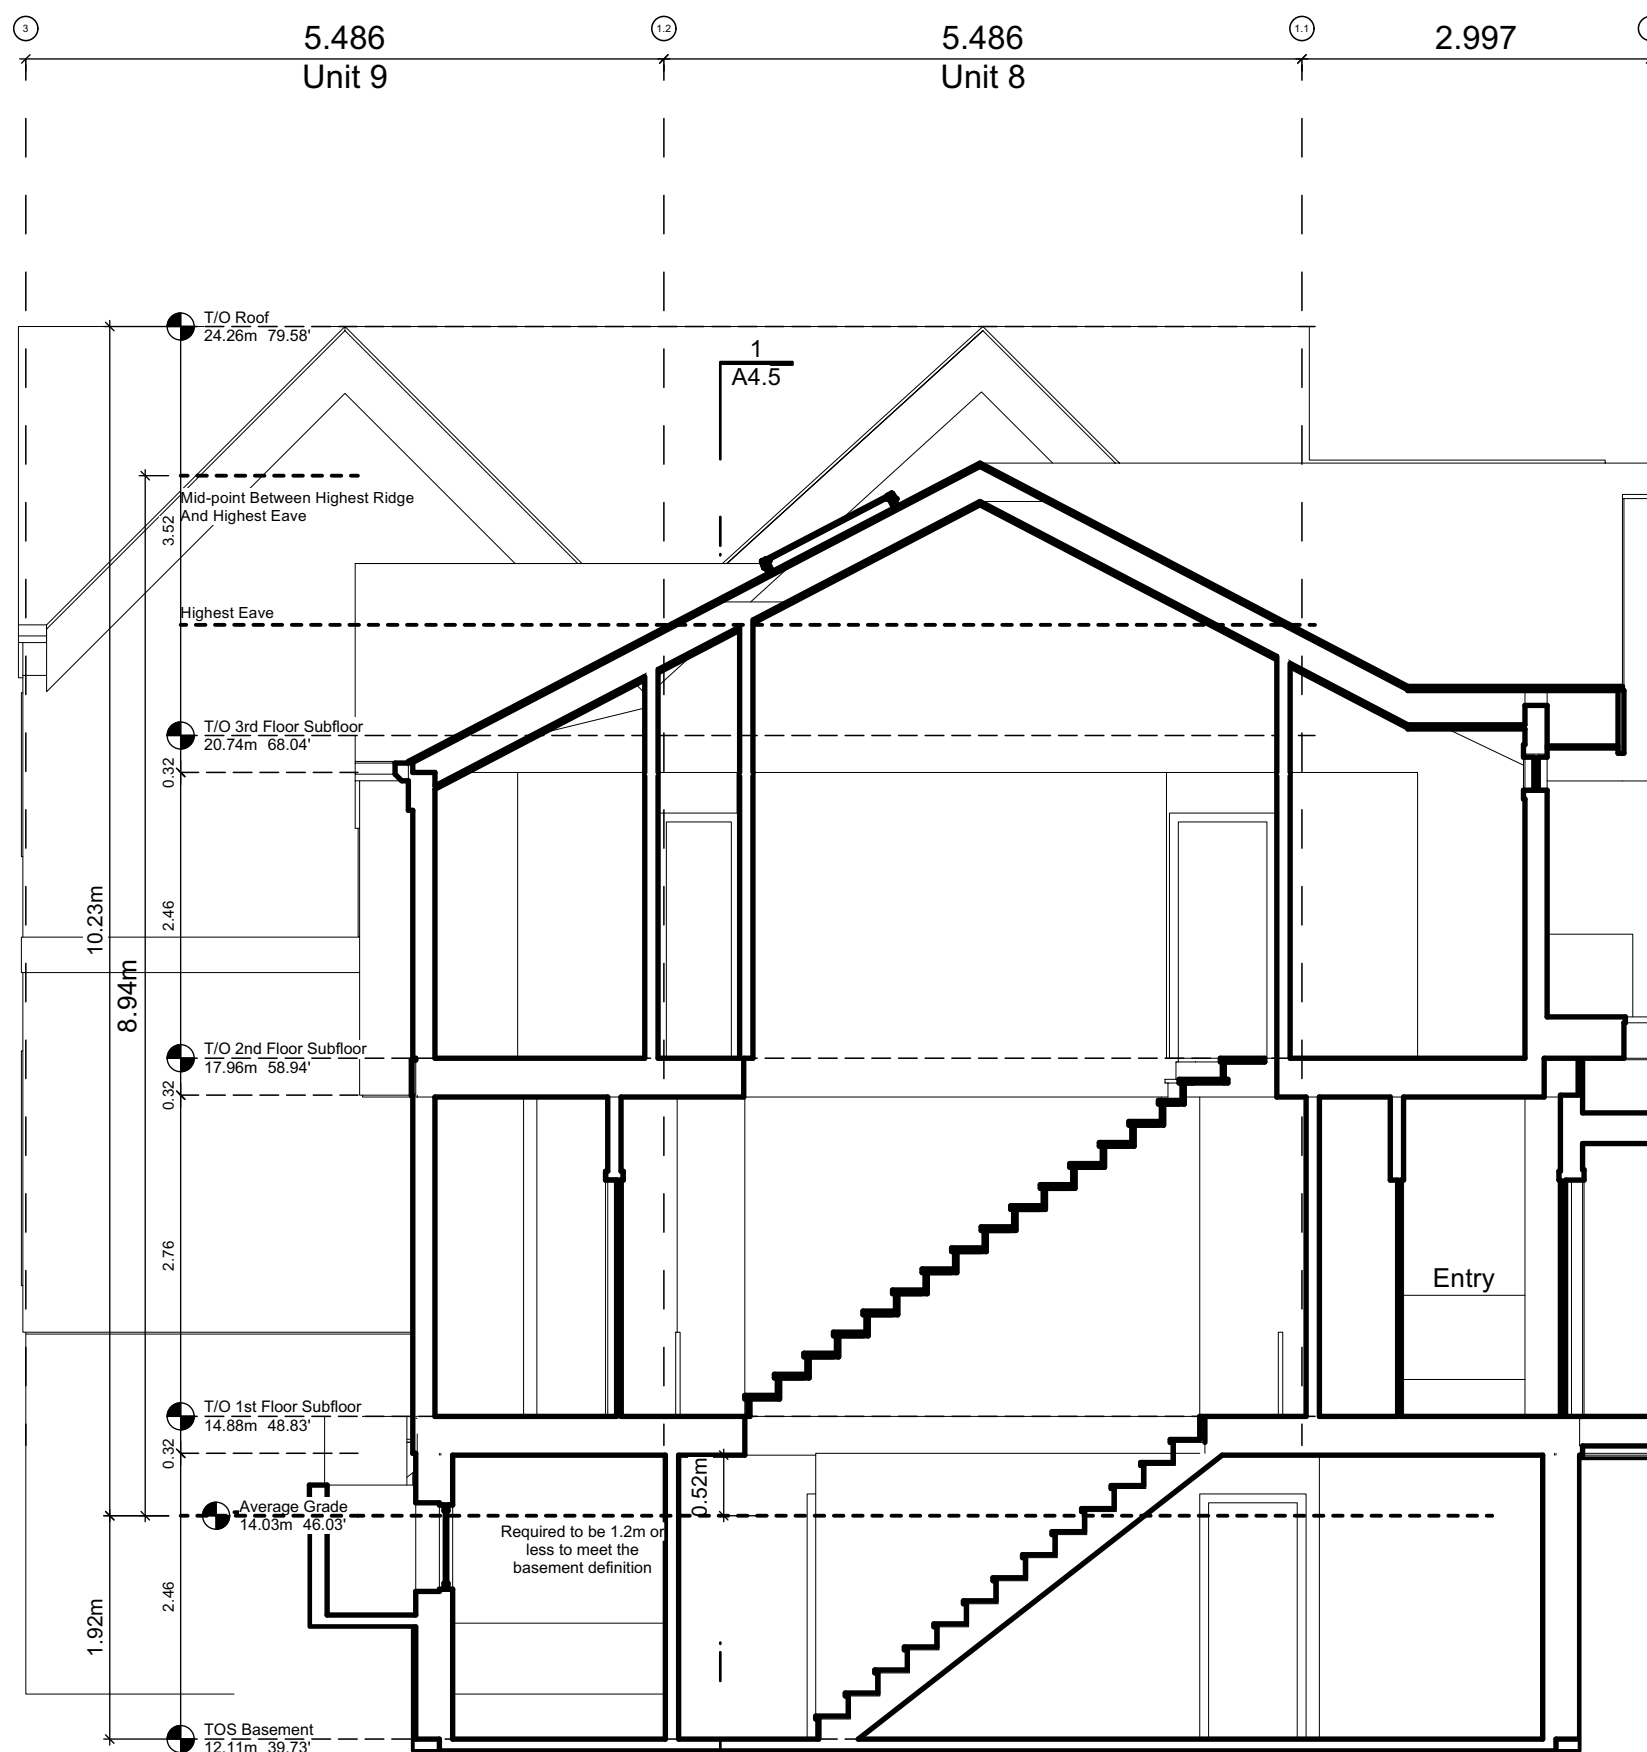


A Block 2 Section
Scale: 1:65

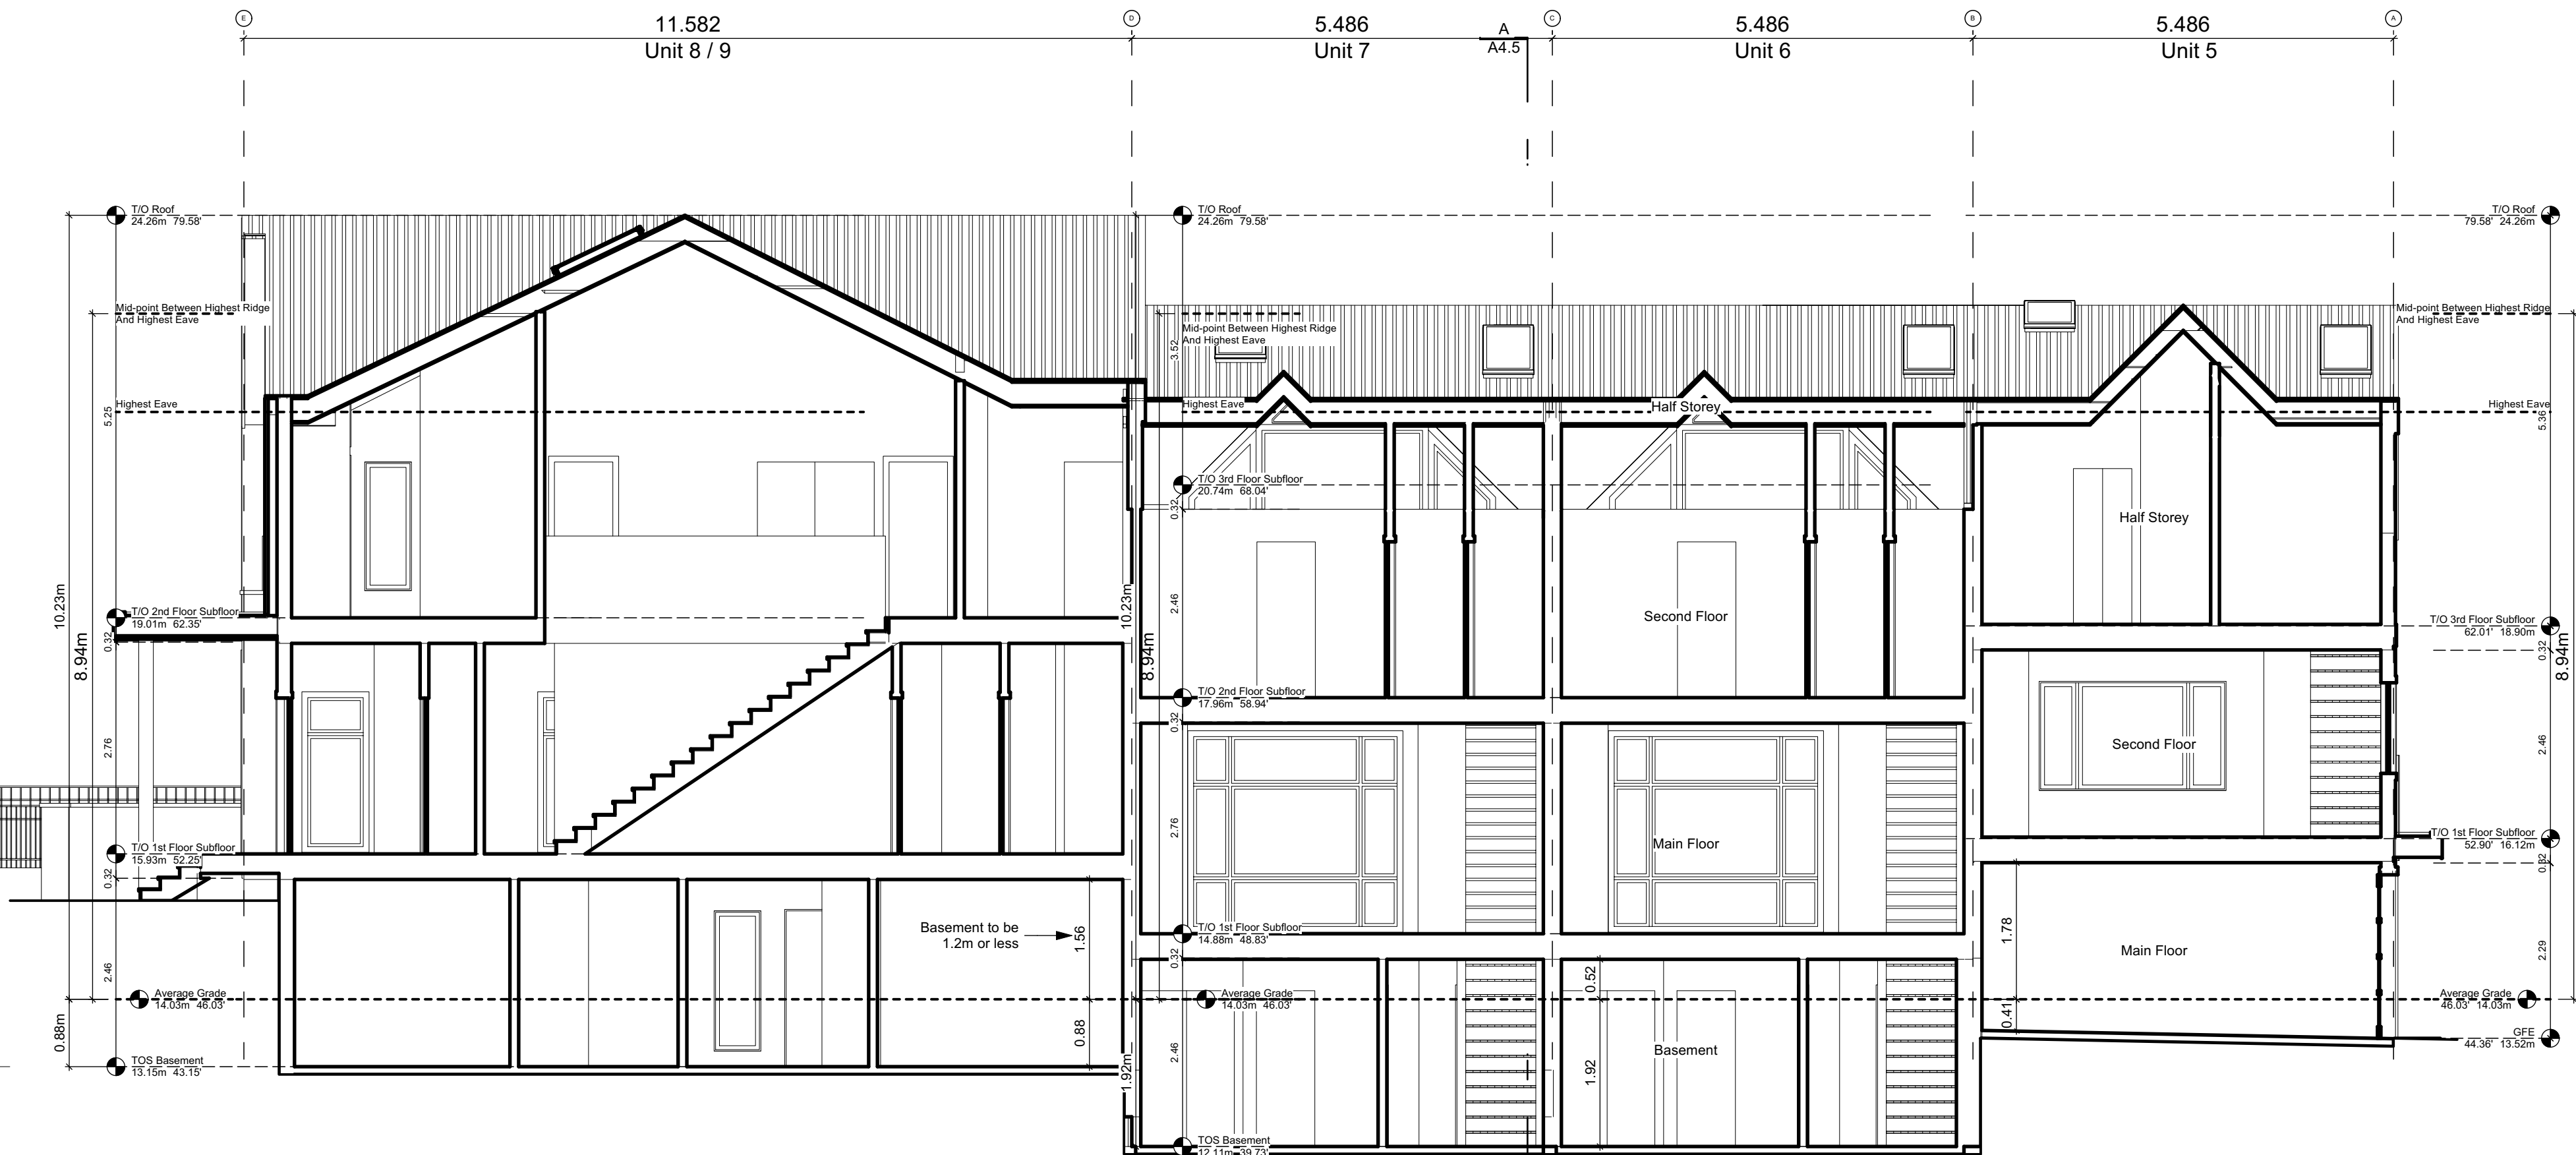

1 Block 2 Section 1
Scale: 1:65

FOR DEVELOPMENT APPLICATION ONLY

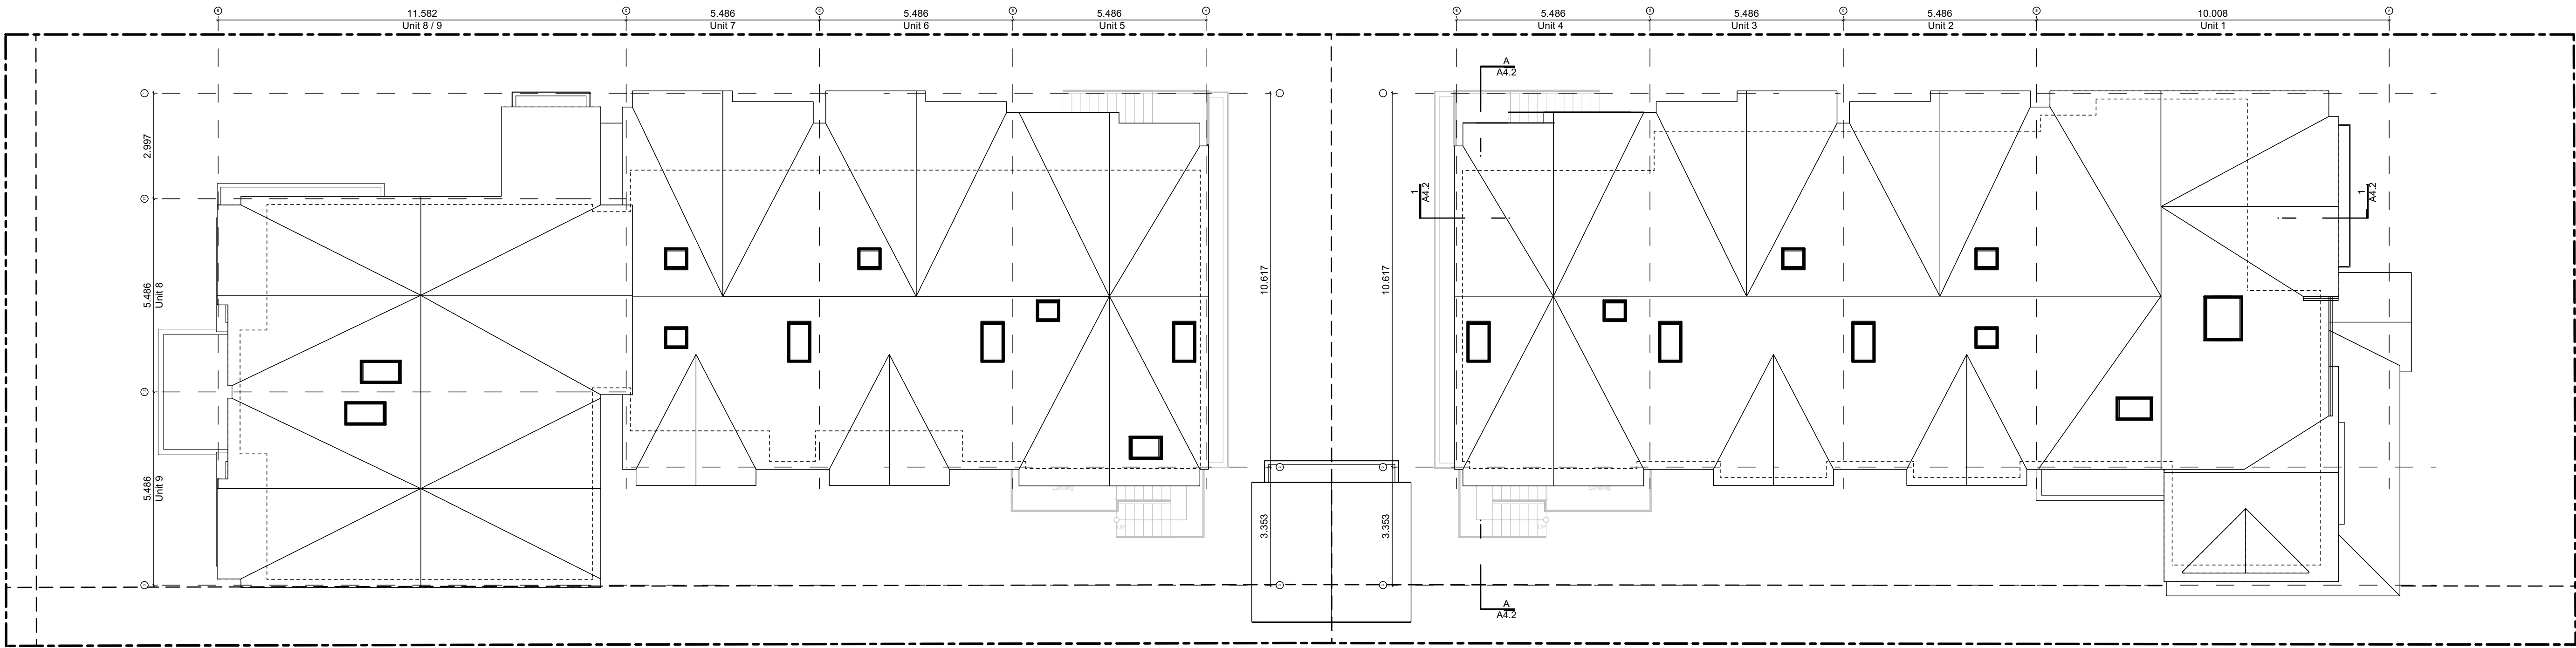

1 Site Roof Plan
Scale: 1:100

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Roof Plans

Project Name:

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Development

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Project No: 19.015

Drawn By: SG/TD

Plot Date: Nov 29, 2022

Scale: 1:100

Sheet No:

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Concept Renderings

Project Name:

Fairfield-Kipling
Development

Civic: 1400 Fairfield Rd &
349 Kipling St

Legal:

PID:

Project No: 19.015

Drawn By: SG/TD

Plot Date: Nov 29, 2022

Scale: NTS

Sheet No:

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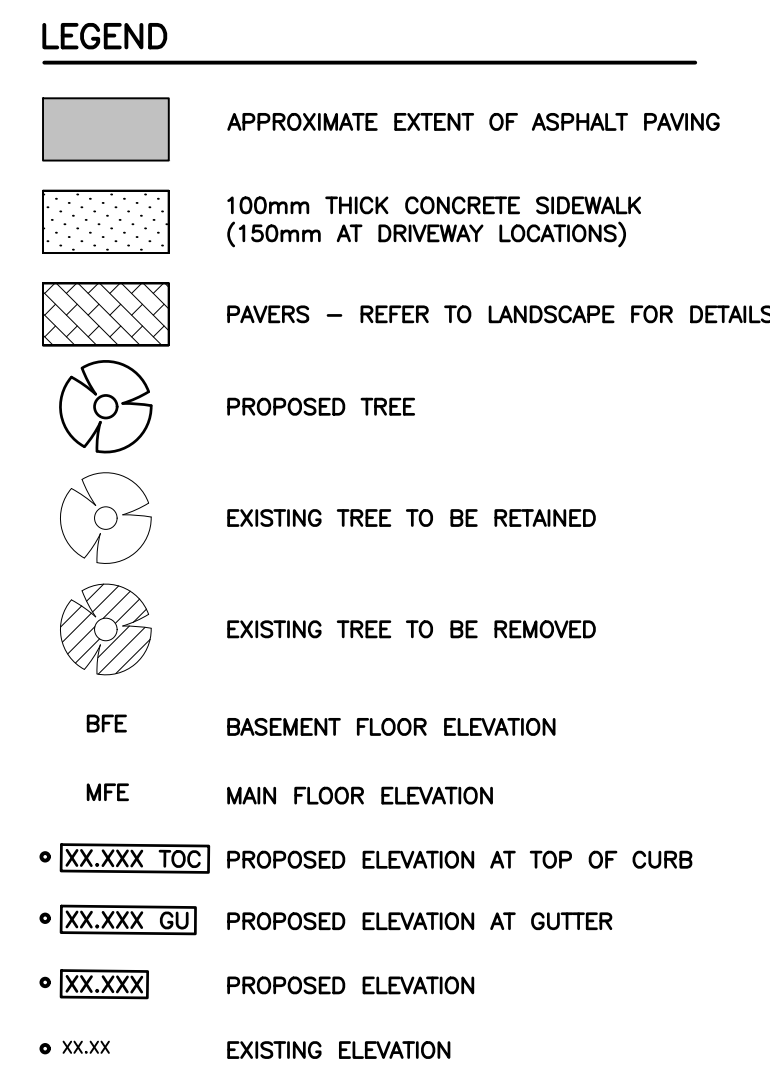
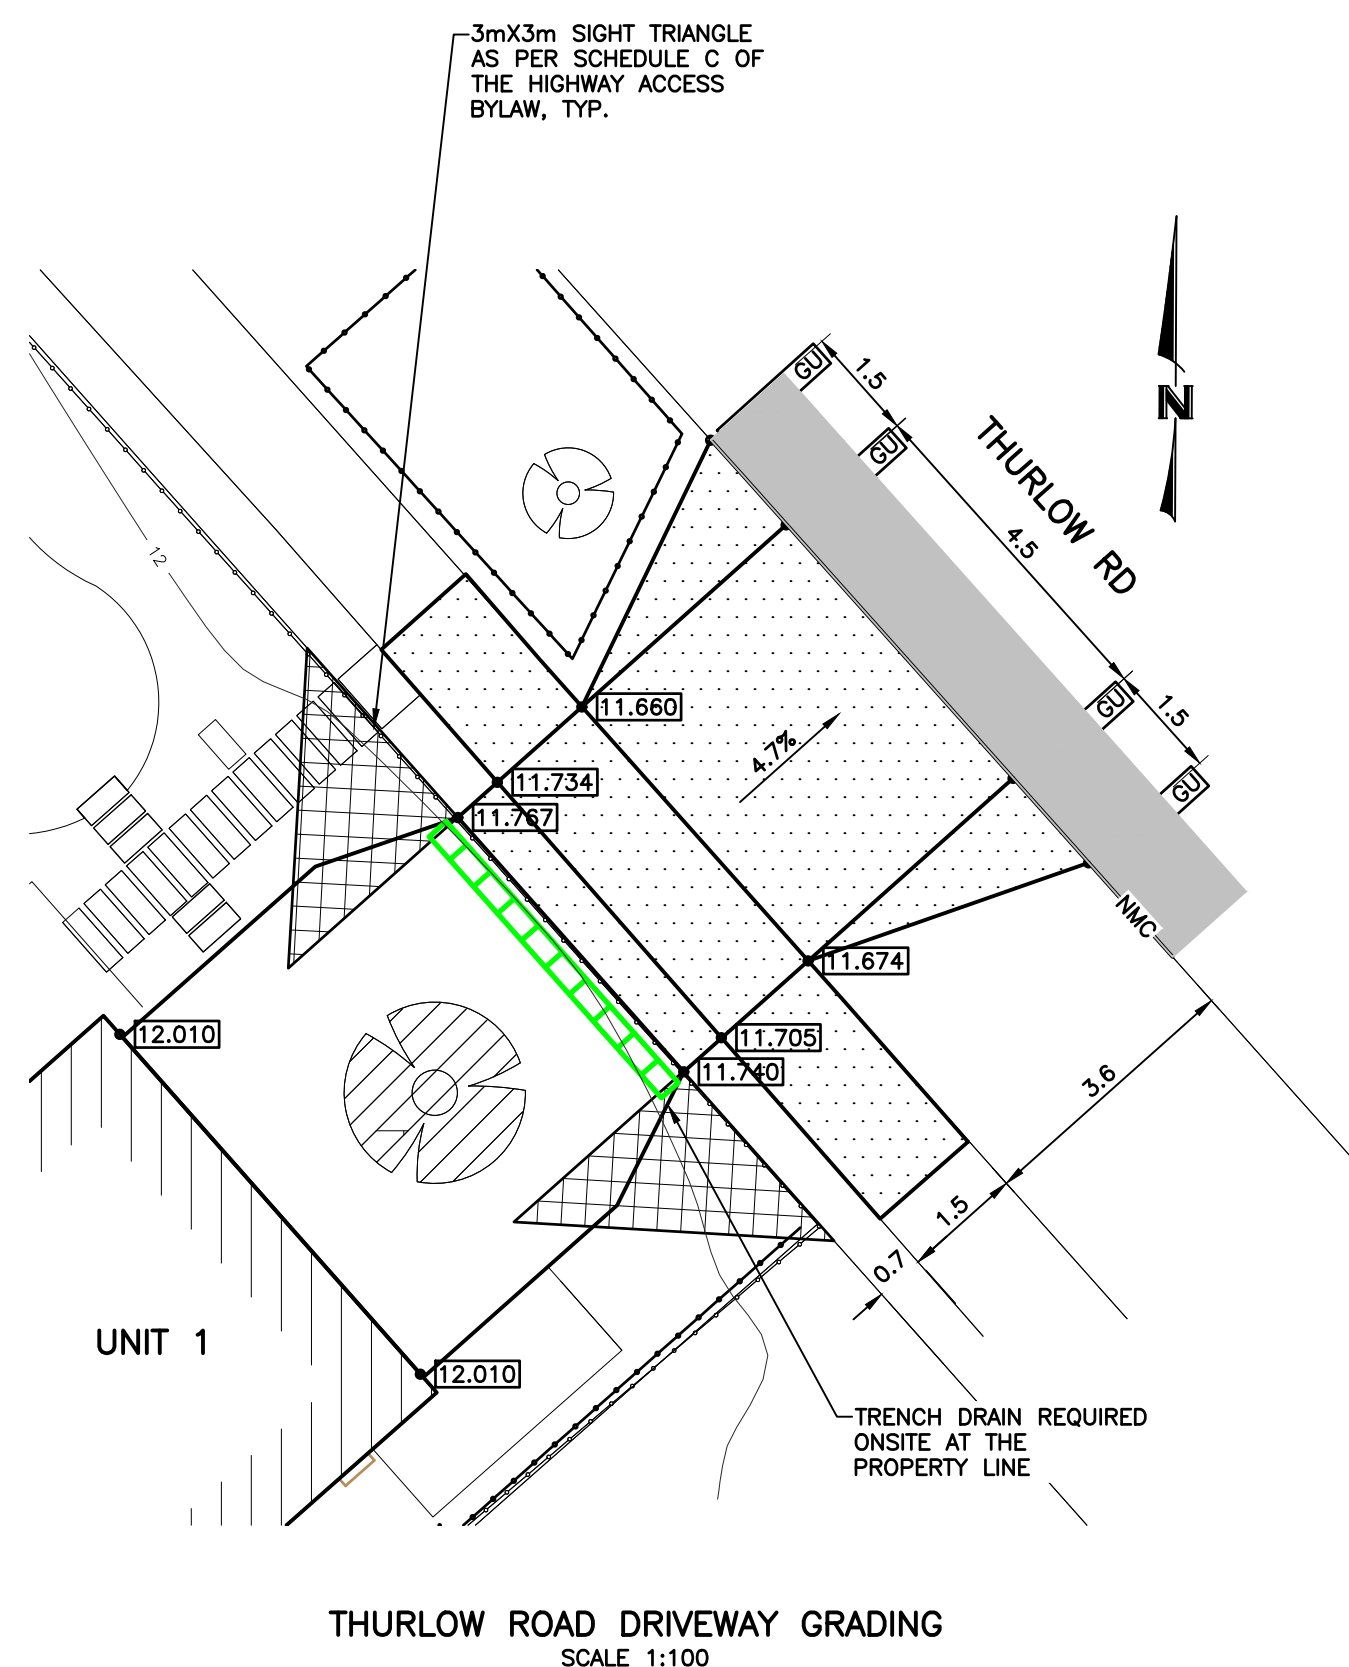
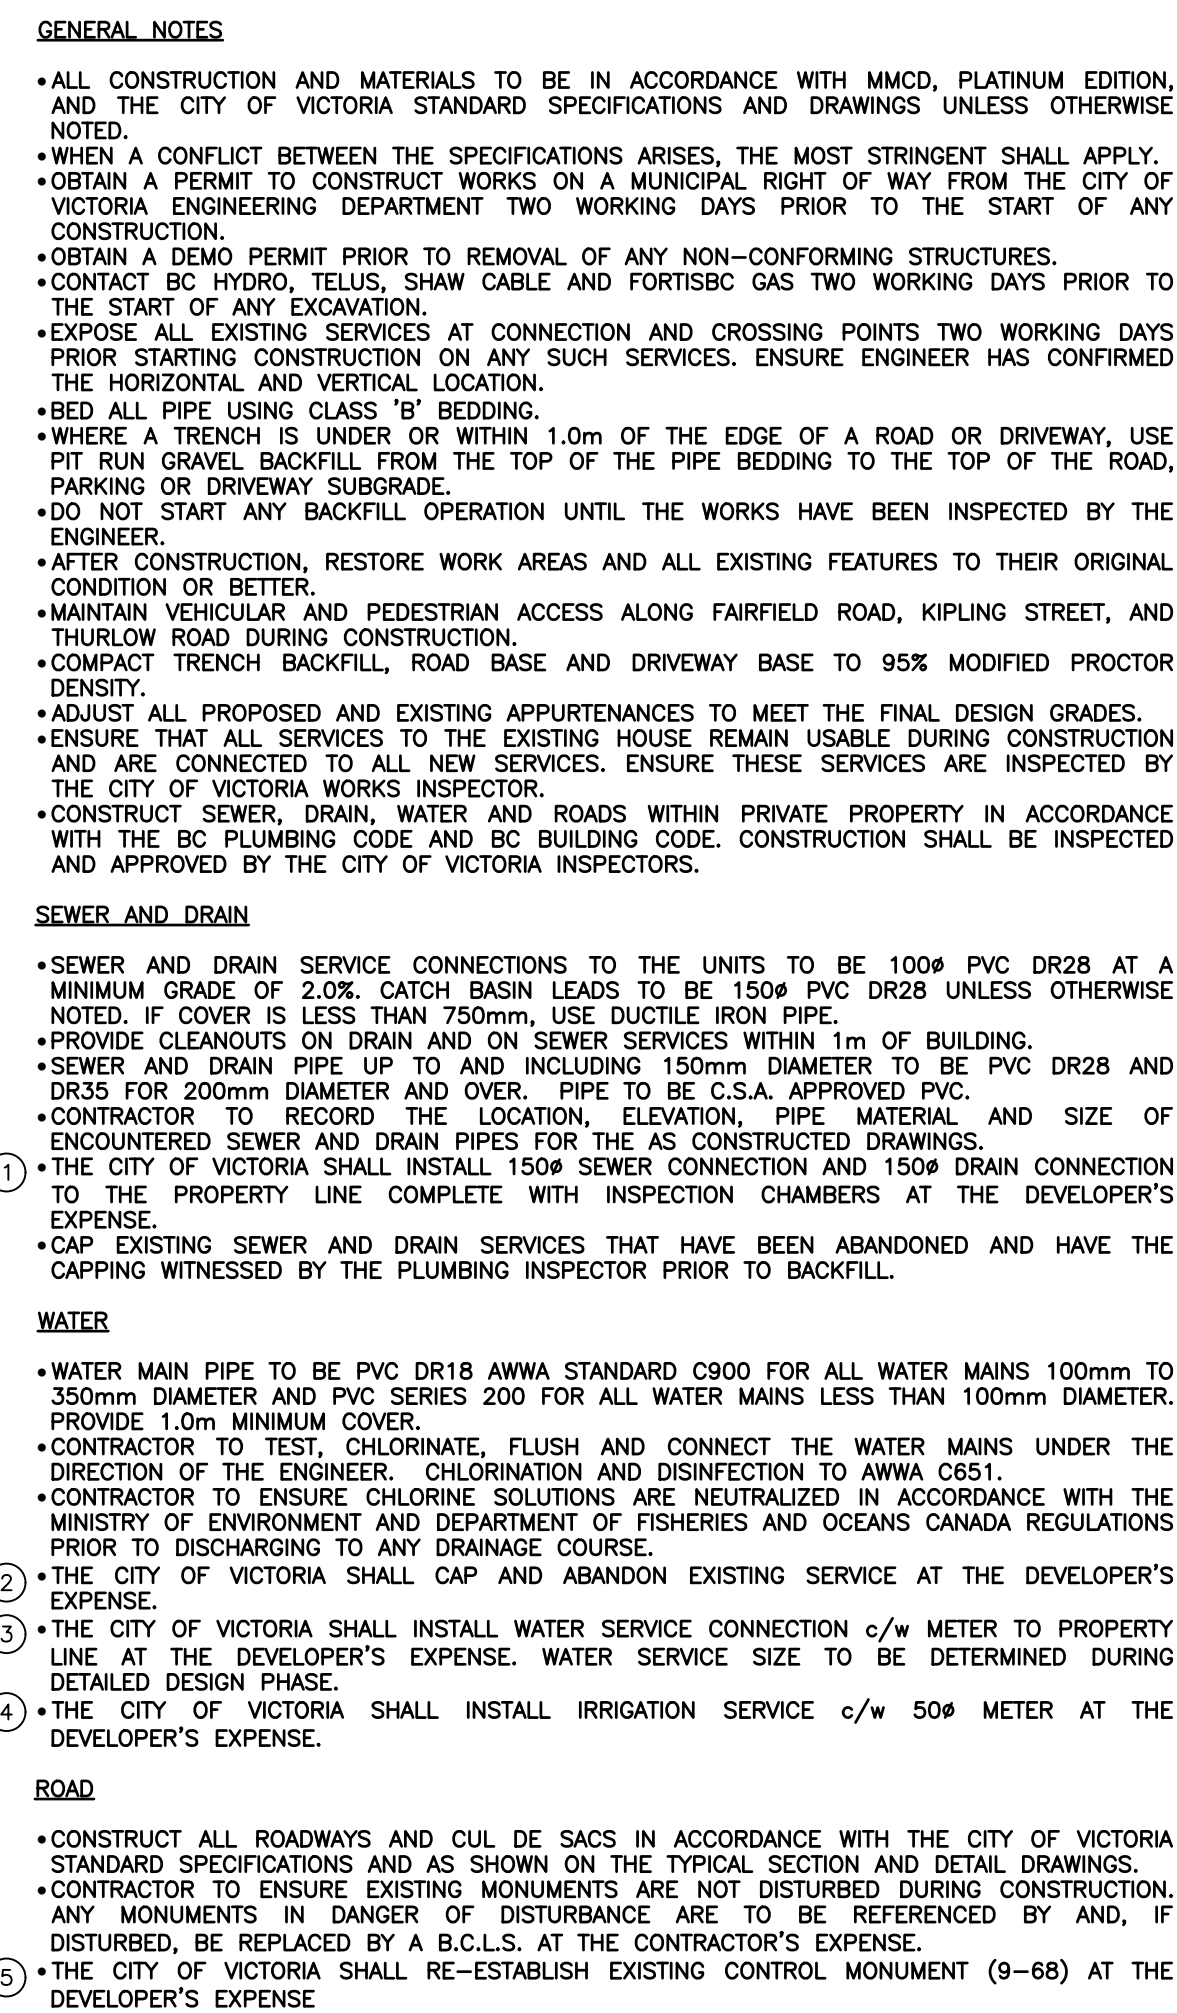
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Concept Renderings


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PID:	
Project No:	19.015
Drawn By:	SG/TD
Plot Date:	Nov 29, 2022
Scale:	NTS
Sheet No:	



LOCATION PLAN
N.T.S.

PROPOSED SUBDIVISION OF LOT 13 AND 35, BOTH ON
FAIRFIELD FARM ESTATE, PLAN VIP884, VICTORIA CITY.



THE LOCATION AND ELEVATION OF EXISTING UNDERGROUND SERVICES ON THIS DRAWING MAY NOT BE ACCURATE OR COMPLETE. THE ACTUAL HORIZONTAL AND VERTICAL LOCATIONS MUST BE CONFIRMED BY UTILITY COMPANIES AND THE CONTRACTOR PRIOR TO THE TO THE START OF ANY EXCAVATIONS	LEGEND										SEAL	REVISIONS					DESIGNED IK DRAWN IY/NC/IK		 <div>WESTBROOK Consulting Ltd.</div> <div>#115 - 866 Goldstream Ave., Victoria, BC V9B 0J3 Telephone: 250-391-8592 Facsimile: 250-391-8593</div>	PROJECT		1400 FAIRFIELD ROAD BREA HOLDINGS LTD.		WESTBROOK PROJECT No. 3455	
	WATER — W	GAS — G	EXISTING U/G UTILITY	MANHOLE	HYDRANT	MONUMENT	6	THURLOW DRIVEWAY REVISION	221212	IY	CHECKED IK	DATE		OCTOBER 2019		GOVERNING AUTHORITY FILE No.		SHEET 1 OF 1 REV. 6		WESTBROOK DRAWING No. 3455-01 (DP)					
	SEWER — S	CURB — C	PROPOSED U/G UTILITY	CLEANOUT	VALVE	LOT PIN	4	HYDRO REVISIONS	220228	JR/IK	DATE		OCTOBER 2019												
	DRAIN — D	SIDEWALK — S/W	LIGHT STANDARD	ROAD BASIN	METER	LEAD PLUG	3	SITE PLAN REVISION	210707	IK/NC	B.M.		9-68												
	DITCH — D	EDGE PAVE.	POWER POLE	ROAD SIGN	REDUCER		2	ARCHITECTURAL REVISION	210101	IK	ELEV.		15.742												
	CULVERT — C	BUSHLINE	ANCHOR				1	REVISED AS PER COV COMMENTS	200513	IY/IK	SCALE		Horz. 1:200												
	HEADWALL — H	TREE					No.	DESCRIPTION	DATE	SIGN	Vert.														

The diagram illustrates the proposed layout of the boulevard and sidewalk, including existing trees and critical root zones. The layout is divided into two main sections: a concrete sidewalk on the left and a sod boulevard on the right. The concrete sidewalk is shown with a grid of small squares, and the sod boulevard is shown with a grid of small circles. Existing trees are marked with a '+' symbol, and their critical root zones are indicated by dashed circles. The diagram also shows the property line and tree protection fencing.

CONCRETE SIDEWALK

SOD BOULEVARD

EXISTING TREE TO BE RETAINED

- SHOWN AT EXISTING SPREAD

EXISTING TREE TO BE REMOVED

- SHOWN AT EXISTING SPREAD

PROPERTY LINE

TREE PROTECTION FENCING

- TO OUTSIDE OF DIAPHRANE WHERE POSSIBLE (AS SHOWN)
- TO BE MAINTAINED UNTIL COMPLETION OF CONSTRUCTION
- TO CITY OF VICTORIA STANDARD

CRITICAL ROOT ZONE

ON SITE:

- EXISTING TREES = 10
- TREES TO BE REMOVED = 10
- BYLAW PROTECTED TREES TO BE REMOVED = 2
- REPLACEMENT TREES REQUIRED = 4

MUNICIPAL BOULEVARD:


- EXISTING TREES = 8
- TREES TO BE REMOVED = 3 (NT1, NT4, NT6)


1. ALL EXCAVATION OCCURRING WITHIN THE CRITICAL ROOT ZONES OF PROTECTED TREES SHOULD BE COMPLETED UNDER SUPERVISION BY THE PROJECT ARBORIST. IN PARTICULAR, THE FOLLOWING ACTIVITIES SHOULD BE COMPLETED UNDER THE DIRECTION OF THE PROJECT ARBORIST:
 - ANY EXCAVATION WITHIN THE CRZS OF MUNICIPAL TREES N77-9 FOR CONSTRUCTION OF THE NEW 6-UNIT BUILDING, LANDSCAPE FEATURES, OR DRIVEWAY OFF THURLOW ROAD
 - ANY EXCAVATION FOR THE ABANDONING OF EXISTING UNDERGROUND SERVICES OR INSTALLATION OF NEW SERVICES WITHIN THE CRZS OF TREES TO BE RETAINED.
2. PRUNING ROOTS: ANY SEVERED ROOTS MUST BE PRUNED BACK TO SOUND TISSUE TO REDUCE WOUND SURFACE AREA AND ENCOURAGE RAPID COMPARTMENTALIZATION OF THE WOUND. BRACING THE ROOTS AROUND THE ROOTS SHOULD BE DONE AS SOON AS POSSIBLE TO KEEP THE ROOTS MOIST AND AID IN ROOT REGENERATION. EXPOSED ROOTS SHOULD BE KEPT MOIST UNTIL THE AREA IS BACKFILLED, ESPECIALLY IF EXCAVATION OCCURS DURING A PERIOD OF DROUGHT. THIS CAN BE ACCOMPLISHED IN A NUMBER OF WAYS, INCLUDING WRAPPING THE ROOTS IN BURLAP OR INSTALLING A ROOT CURTAIN OF WIRE MESH LINED WITH BURLAP, AND KEEPING THE AREA MOIST THROUGHOUT THE CONSTRUCTION PROCESS.
3. MINIMIZING SOIL COMPACTION: IN AREAS WHERE CONSTRUCTION TRAFFIC MUST ENCRASH INTO THE CRITICAL ROOT ZONES OF TREES TO BE RETAINED, EFFORTS MUST BE MADE TO REDUCE SOIL COMPACTION WHERE POSSIBLE BY DISPLACING THE WEIGHT OF MACHINERY AND FOOT TRAFFIC. THIS CAN BE ACHIEVED BY ONE OF THE FOLLOWING METHODS:
 - INSTALLING A LAYER OF HOG FUEL OR COARSE WOOD CHIPS AT LEAST 20 CM IN DEPTH AND MAINTAINING IT IN GOOD CONDITION UNTIL CONSTRUCTION IS COMPLETE.
 - PLACING A MEDUMLAYER OF GEOTEXTILE CLOTH OVER THE AREA TO BE USED AND INSTALLING A LAYER OF CRUSHED ROCK TO A DEPTH OF 15 CM OVER TOP.
 - PLACING TWO LAYERS OF 19MM PLYWOOD.
 - PLACING STEEL PLATES.
4. LANDSCAPING AND IRRIGATION SYSTEMS: THE PLANTING OF NEW TREES AND SHRUBS SHOULD NOT DAMAGE THE ROOTS OF RETAINED TREES. THE INSTALLATION OF ANY IN-GROUND IRRIGATION SYSTEM MUST TAKE INTO ACCOUNT THE CRITICAL ROOT ZONES OF THE TREES TO BE RETAINED. PRIOR TO INSTALLATION, WE RECOMMEND THE IRRIGATION TECHNICIAN CONSULT WITH THE PROJECT ARBORIST ABOUT THE MOST SUITABLE LOCATIONS FOR THE IRRIGATION LINES AND HOW BEST TO MITIGATE THE IMPACTS ON THE TREES TO BE RETAINED. THIS MAY REQUIRE THE PROJECT ARBORIST SUPERVISE THE EXCAVATIONS ASSOCIATED WITH INSTALLING THE IRRIGATION SYSTEM. EXCESSIVE FREQUENT IRRIGATION AND IRRIGATION WHICH WETS THE TRUNK OF TREES MAY CAUSE ROOT ROT AND GROUNDWATER LEAD TO ROT AND TRUNK DISEASE.

ARBORIST ROLE: IT IS THE RESPONSIBILITY OF THE CLIENT OR HIS/HER REPRESENTATIVE TO CONTACT THE PROJECT ARBORIST FOR THE PURPOSE OF:

- LOCATING THE BARRIER FENCING
- REVIEWING THE REPORT WITH THE PROJECT FOREMAN OR SITE SUPERVISOR
- LOCATING WORK ZONES, WHERE REQUIRED
- SUPERVISING ANY EXCAVATION WITHIN THE CRITICAL ROOT ZONES OF TREES TO BE RETAINED
- REVIEWING AND ADVISING OF ANY PRUNING REQUIREMENTS FOR MACHINE CLEARANCE
- REVIEW AND SITE MEETING: ONCE THE PROJECT RECEIVES APPROVAL, IT IS IMPORTANT THAT THE PROJECT ARBORIST MEET WITH THE PRINCIPALS INVOLVED IN THE PROJECT TO REVIEW THE INFORMATION CONTAINED HEREIN. IT IS ALSO IMPORTANT THAT THE ARBORIST MEET WITH THE SITE FOREMAN OR SUPERVISOR BEFORE ANY SITE CLEARING, TREE REMOVAL, DEMOLITION, OR OTHER CONSTRUCTION ACTIVITY OCCURS AND TO CONFIRM THE LOCATIONS OF THE TREE PROTECTION BARRIER FENCING.

NOTES:
1. SEE ARBORIST REPORT FOR ADDITIONAL INFORMATION, REQUIREMENTS AND RECOMMENDATIONS

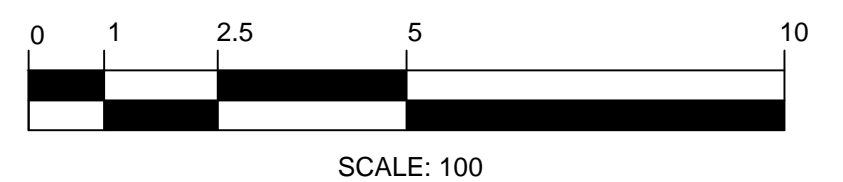

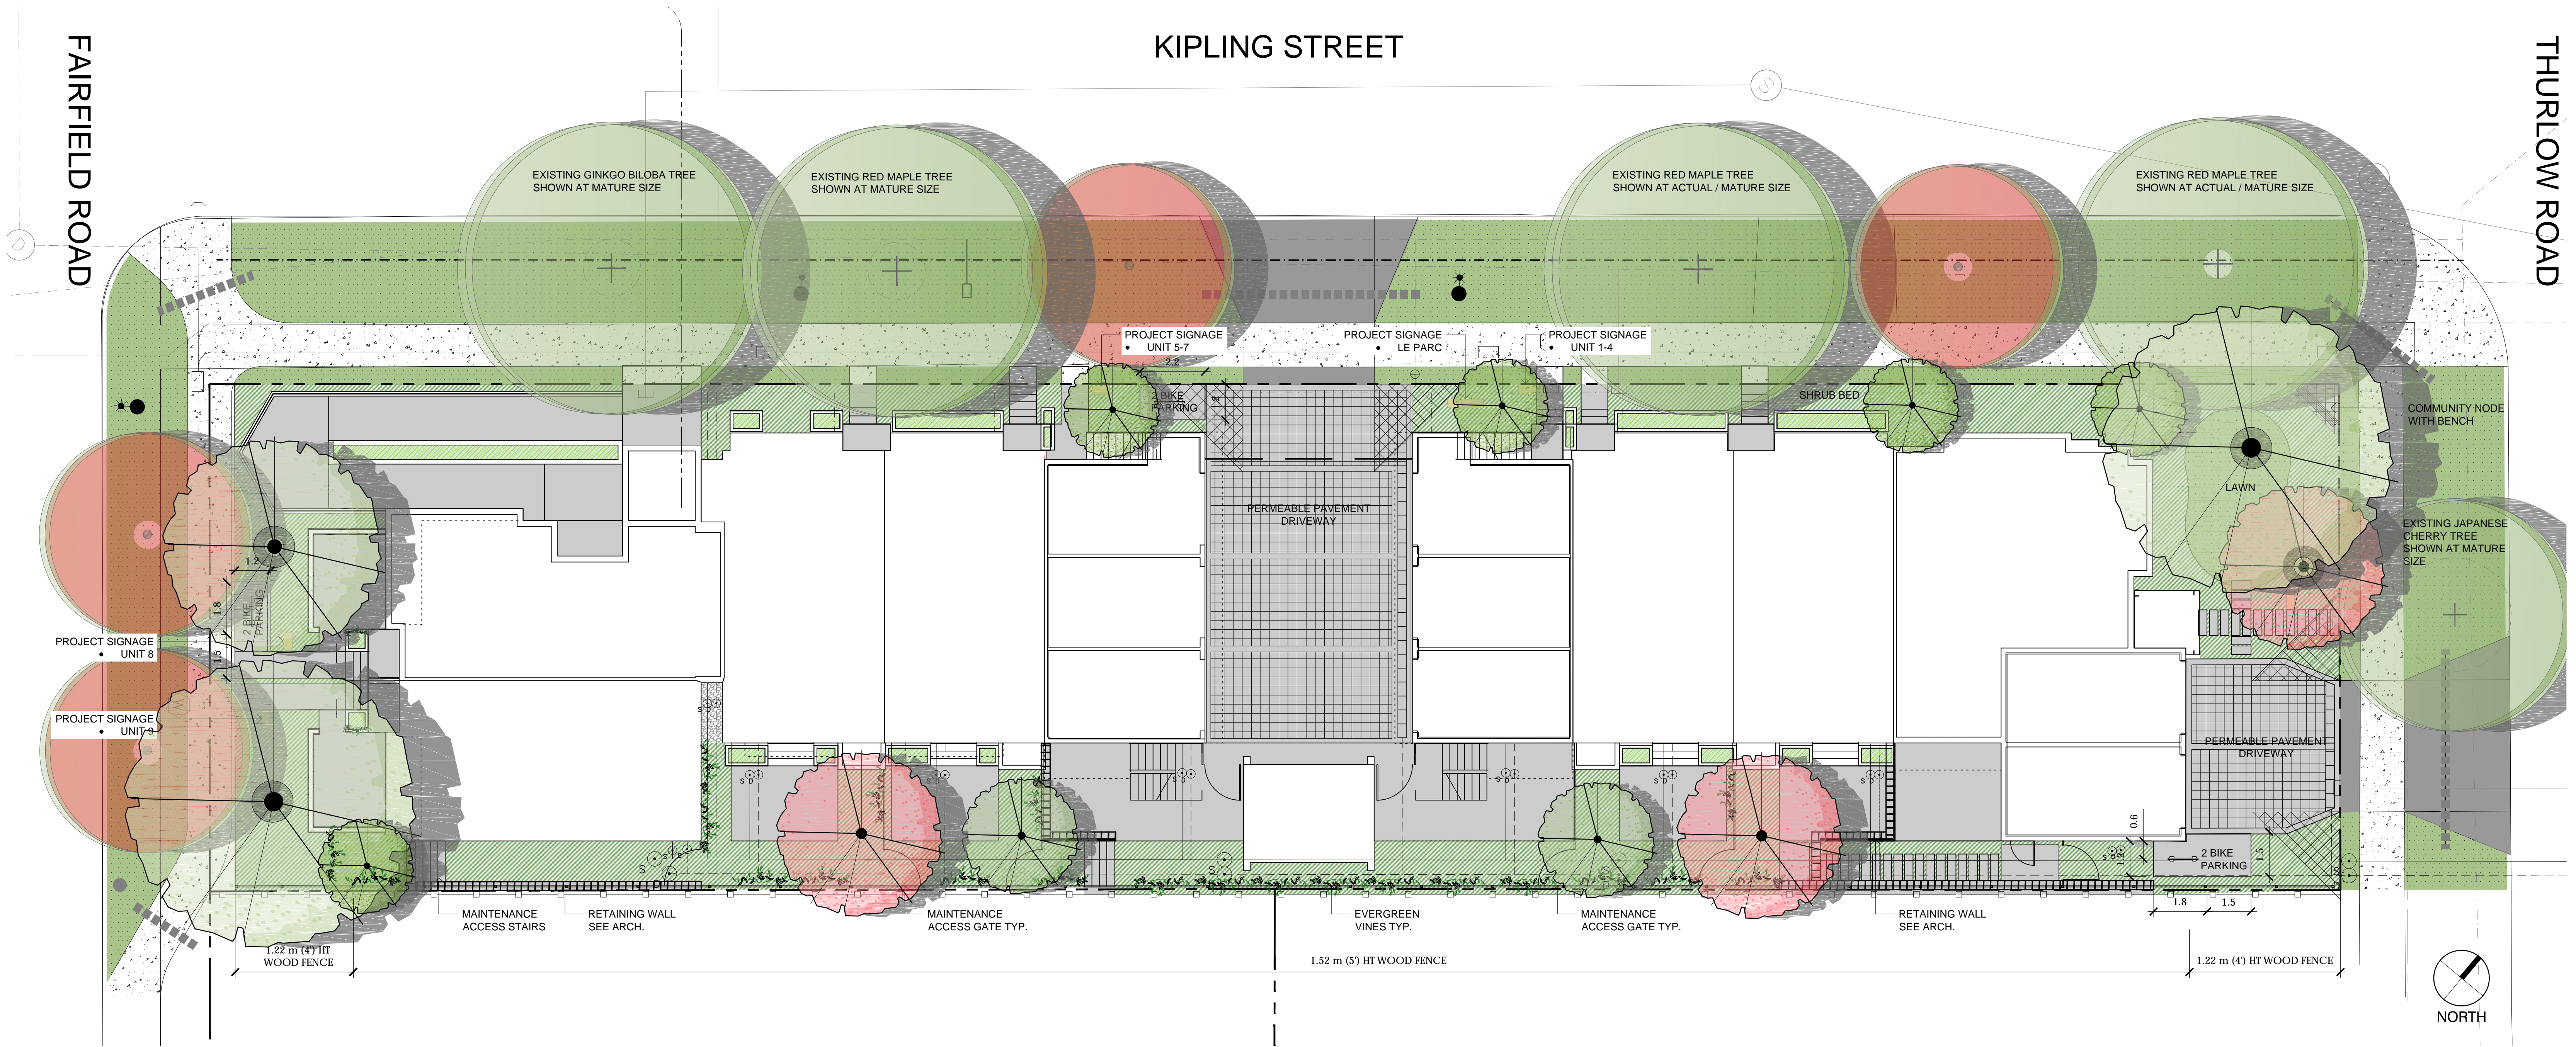

LEGEND

MUNICIPAL CONCRETE SIDEWALK

CONCRETE DRIVEWAY APRON

DRIVEWAY / PATIO

- PERMEABLE INTERLOCKING CONCRETE PAVER

CONCRETE SIDEWALK / PATIO

- MEDIUM SANDBLAST OR LIGHT BROOM FINISH
- SAW CUT CONCRETE CRACK CONTROL JOINTS

PATH

- CONCRETE PAVERS
- ABBOTSFORD PIAZZA SERIES

EVERGREEN VINES

SOD

SHRUB BED

PLANTER

EXISTING WOOD FENCE

- 6' (1.83 m) HT
- ON ADJACENT PROPERTY

PRIVACY FENCE

- 5' (1.52 m) HT AS NOTED
- 4' (1.22 m) HT AS NOTED
- SOLID WOOD FENCING

PROPERTY LINE

BYLAW PROTECTED REPLACEMENT TREES

- QTY 4
- SPECIES AND LOCATION TO BE APPROVED BY PARKS

IRRIGATION SLEEVE

LARGE BOULEVARD TREE TO REMAIN

SMALL BOULEVARD TREE TO REMAIN

PROPOSED TREES

PROPOSED BOULEVARD TREE

- SPECIES TO BE SELECTED BY CITY OF VICTORIA
- TO BE INSTALLED BY CITY OF VICTORIA AT DEVELOPER'S EXPENSE

PROPOSED TREE QUANTITIES

PROPOSED ON-SITE TREES = 13

- DECIDUOUS TREES: 8
- BROADLEAF EVERGREEN TREES: 5
- BYLAW REPLACEMENT TREES: 4

PROPOSED MUNICIPAL BOULEVARD TREES


- DECIDUOUS TREES: 4


BOULEVARD IRRIGATION NOTES:

- AUTOMATIC IRRIGATION TO BE PROVIDED TO THE 4 NEW BOULEVARD TREES FROM A DEDICATED 19mm METERED WATER SERVICE LOCATED WITHIN THE KIPLING FRONTAGE BOULEVARD.
- SEE CIVIL FOR LOCATION.

ON-SITE IRRIGATION NOTES:

- ALL SOFT LANDSCAPE AREAS TO BE IRRIGATED BY AN AUTOMATIC IRRIGATION SYSTEM DESIGNED AND INSTALLED TO IABC STANDARDS.

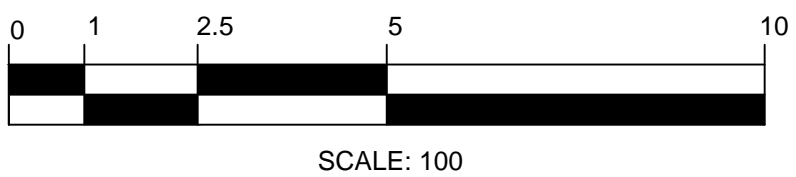

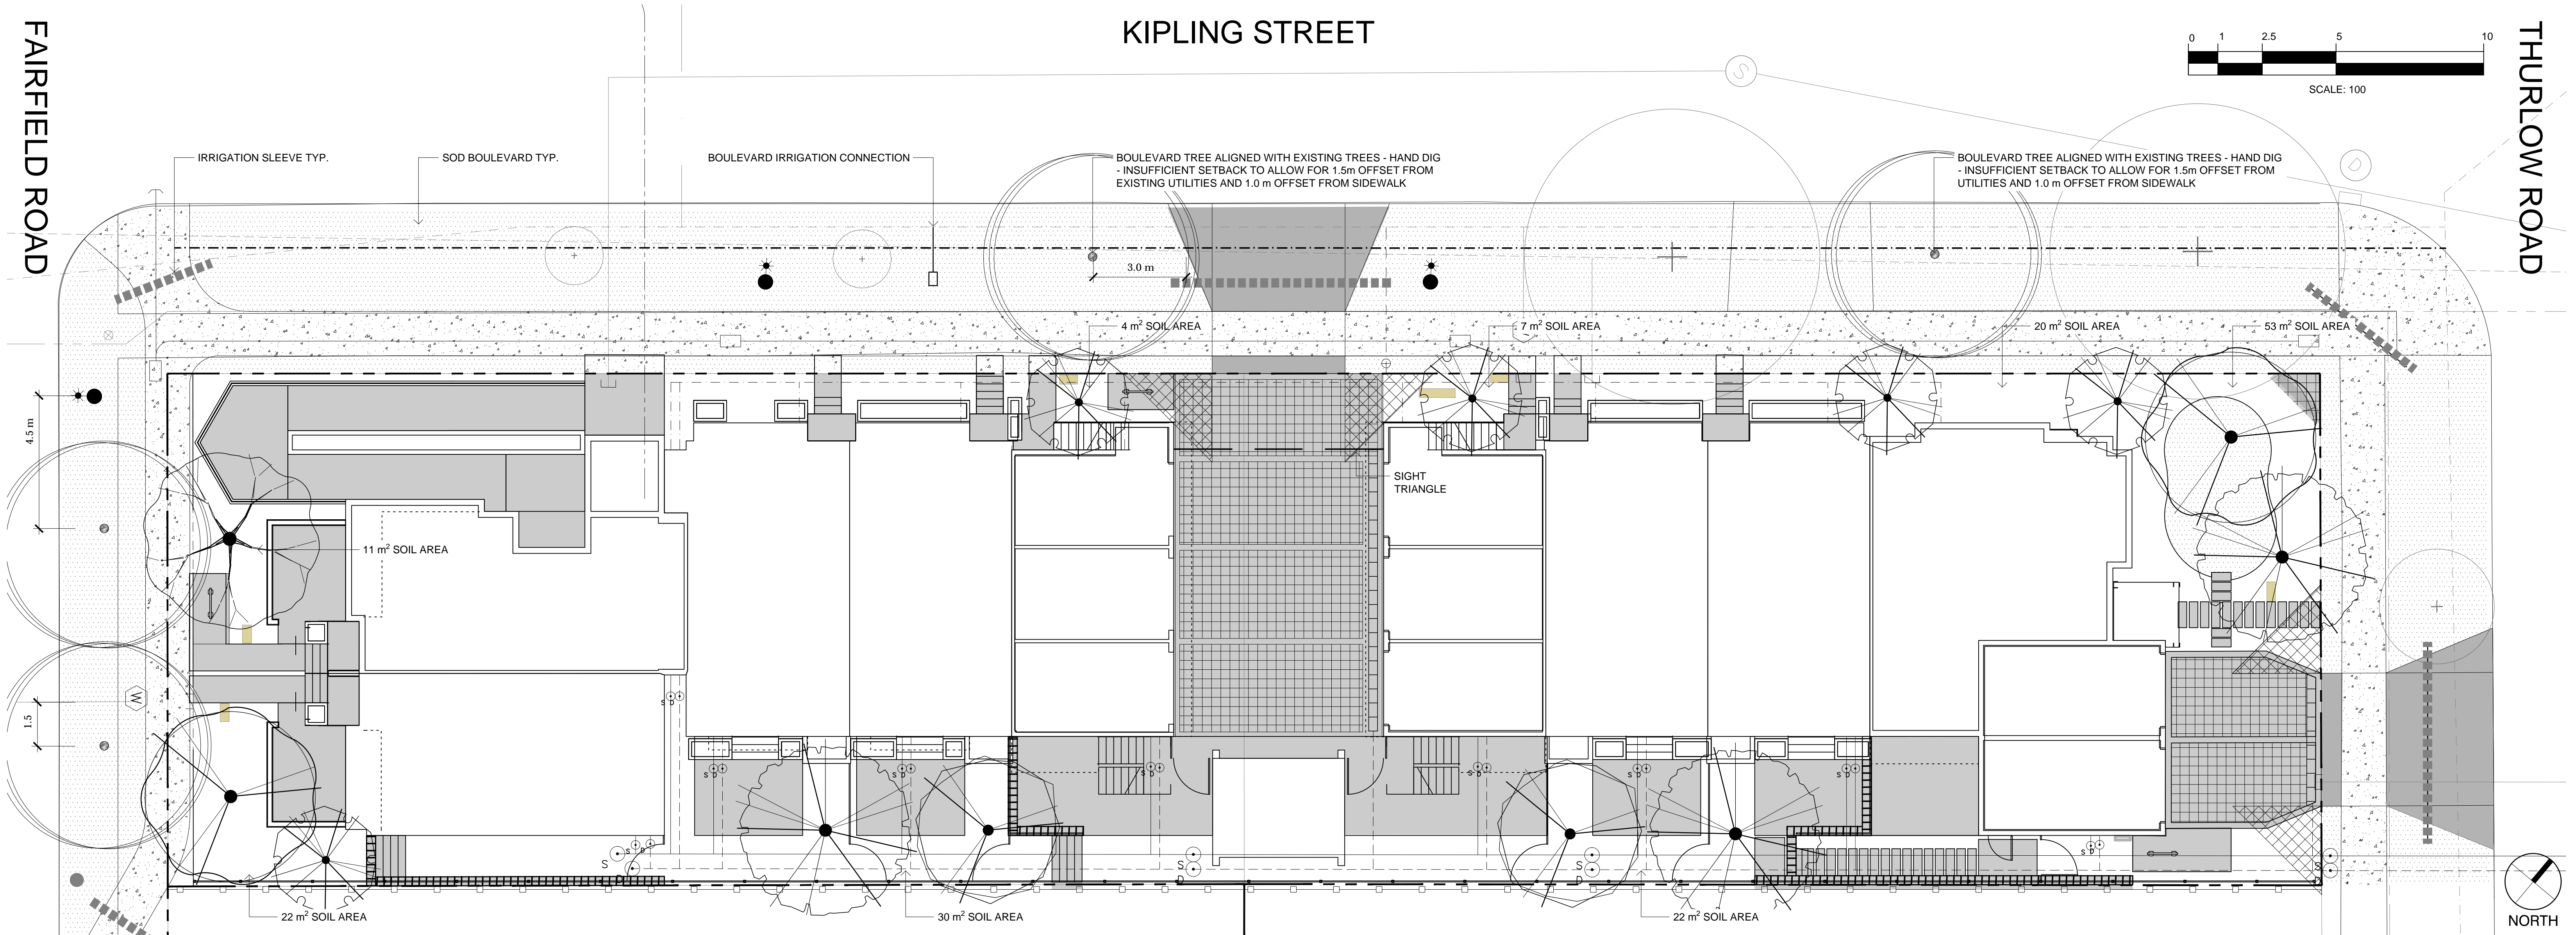

LEGEND

PROPERTY LINE

SOD

IRRIGATION SLEEVE

EXISTING TREE TO BE RETAINED

SHOWN AT EXISTING SPREAD

PROPOSED BOULEVARD TREE

TO BE INSTALLED BY CITY OF VICTORIA AT DEVELOPER'S EXPENSE

PLANT SCHEDULE - TREES					
TREES	QTY	BOTANICAL / COMMON NAME	CONT	CAL	REMARKS
	3	CORNUS NUTTALLII / PACIFIC DOGWOOD	CONT	60 MM	NATIVE; 10 M HT X 10 M W
	5	MAGNOLIA GRANDIFLORA 'LITTLE GEM' / LITTLE GEM DWARF SOUTHERN MAGNOLIA	CONT	40 MM	EVERGREEN; 5 M HT X 3 M W
	1	PARROTIA PERSICA / PERSIAN PARROTIA	B@B	60 MM	DECIDUOUS; 8 M HT X 5 M W
	2	QUERCUS GARRYANA / GARRY OAK	CONT	AS AVAILABLE	NATIVE; 20 M HT X 20 M W
	2	STYRAX JAPONICUS / JAPANESE SNOWBELL	CONT	50 MM	ORNAMENTAL; 5 M H X 5 M W

NOTES:
1. PLANTS IN PLANT LISTS ARE SPECIFIED ACCORDING TO THE CANADIAN NURSERY LANDSCAPE ASSOCIATION CANADIAN STANDARDS FOR NURSERY STOCK AND SECTION 12, CONTAINER GROWN PLANTS FROM THE BC LANDSCAPE STANDARD, CURRENT EDITION.
2. ALL LANDSCAPE AREAS TO BE IRRIGATED WITH AN AUTOMATIC IRRIGATION SYSTEM DESIGNED TO IABC STANDARDS.
3. ALL PROPOSED BOULEVARD TREES TO HAVE 10m² MIN. GROWING MEDIUM.

PACIFIC DOGWOOD

LITTLE GEM DWARF MAGNOLIA


GARRY OAK

JAPANESE SNOWBELL

FAIRFIELD ROAD

KIPLING STREET

THURLOW ROAD

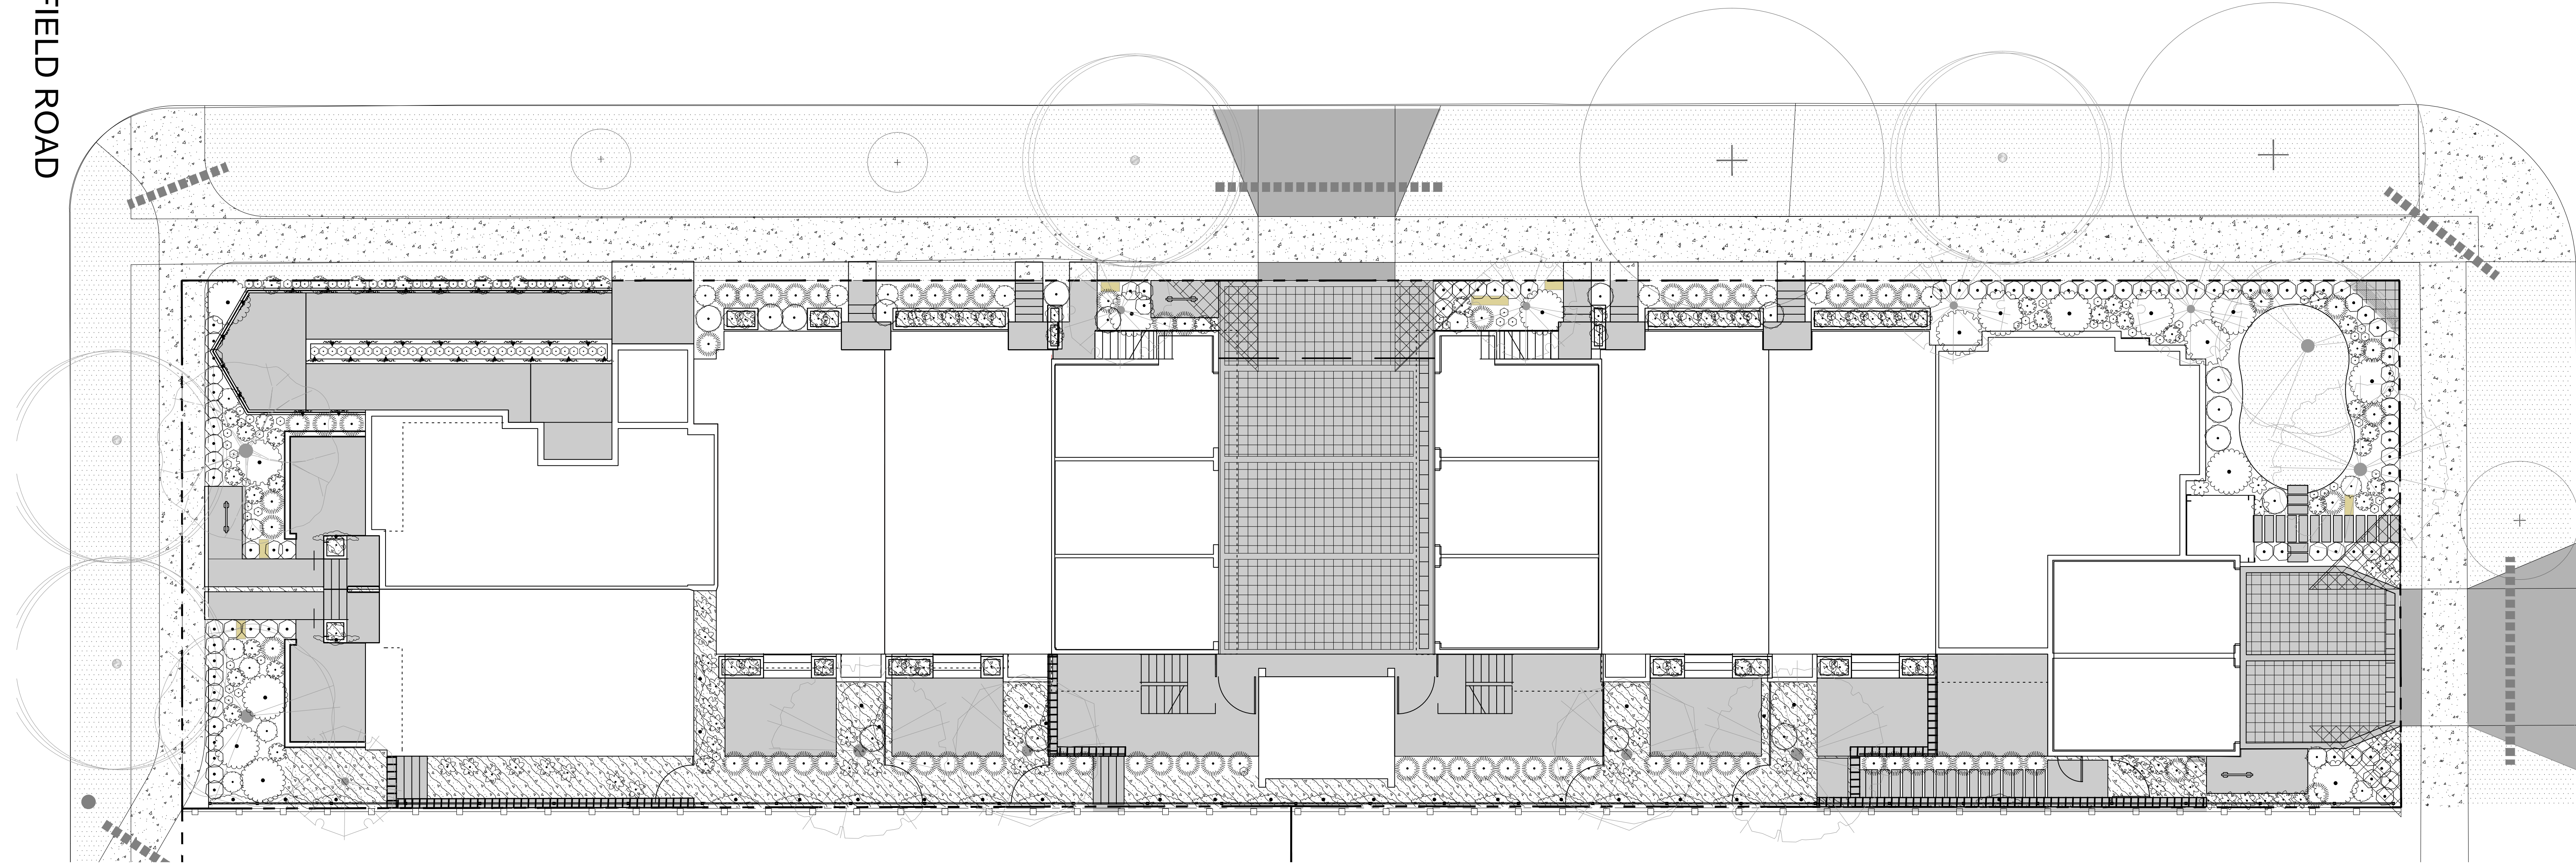

PLANT SCHEDULE - SHRUBS

SHRUBS	QTY	BOTANICAL / COMMON NAME	CONT	SPACING
	32	ARCTOSTAPHYLOS UVA-URSI 'MASSACHUSETTS' / MASSACHUSETTS KINNIKINNICK	#1 CONT	0.6m
	24	BRACHYLOTTIS GREYI / DAISY BUSH	#2 CONT	0.6m
	90	BUXUS X 'GREEN MOUNTAIN' / GREEN MOUNTAIN BOXWOOD	#2 CONT	0.6m
	3	CHOISYA TERNATA / MEXICAN ORANGE	#3 CONT	1.5m
	2	HYDRANGEA PANICULATA 'PHANTOM' / PANICLED HYDRANGEA	#3 CONT	1.5m
	29	JASMINUM POLYANTHUM / PINK JASMINE TRELLIS	#1 CONT	1.5m
	139	LAVANDULA ANGUSTIFOLIA 'AROMATICO BLUE' / ENGLISH LAVENDER 'AROMATICO BLUE'	#2 CONT	0.3m
	73	MISCANTHUS SINENSIS 'GRAZIELLA' / GRAZIELLA MAIDEN GRASS	#2 CONT	0.8m
	19	PENNISETUM ORIENTALE 'KARLEY ROSE' / KARLEY ROSE FOUNTAIN GRASS	#1 CONT	0.75m
	38	POLYSTICHUM MUNITUM / WESTERN SWORD FERN	#1 CONT	0.6m
	15	RHODODENDRON X 'CHRISTMAS CHEER' / CHRISTMAS CHEER RHODODENDRON	#5 CONT	1.5m
	64	SANTOLINA VIRENS / GREEN LAVENDER COTTON	#1 CONT	0.6m
	16	SARCOCOCCA CONFUSA / SWEETBOX	#1 CONT	0.9m



HYDRANGEA



JASMINE VINE



SWEETBOX




MEXICAN ORANGE



IRISH MOSS

PLANT SCHEDULE - GROUND COVER

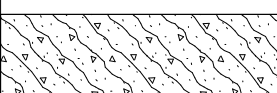GROUND COVERS	QTY	BOTANICAL / COMMON NAME	CONT	SPACING	REMARKS
	1,177	SAGINA SUBULATA / IRISH MOSS	PLUG	300mm	

NOTES:
1. PLANTS IN PLANT LISTS ARE SPECIFIED ACCORDING TO THE CANADIAN NURSERY LANDSCAPE ASSOCIATION CANADIAN STANDARDS FOR NURSERY STOCK AND SECTION 12, CONTAINER GROWN PLANTS FROM THE BC LANDSCAPE STANDARD, CURRENT EDITION.



BUILT-IN PLANTER



COMMUNITY BENCH



DAISY BUSH, LAVENDER COTTON, LAVENDER



MAIDEN GRASS



BIOPHILIA
design collective

Biophilia design collective Ltd.

1608 Camosun Street
Victoria, BC V8T 3E6
250.590.1156

Landscape Revision List

1400 Fairfield and 349 Kipling
December 13, 2022

1. Driveway and adjacent landscape adjusted.

END OF REVISIONS

