

# 633 BELTON AVENUE

## APPLICATION FOR REZONING & DEVELOPMENT PERMIT



Sheet Number	Sheet Name
A0.00	Site Plan & Project Info
A0.01	Building Code Analysis & Spatial Separations
A0.02	Building Code Analysis
A1.00	Site Survey & Grade Calculation
A2.00	Floor Plans
A3.00	Exterior Elevations
A4.00	Building Sections & Window Overlay Elevations



CONTEXT MAP

GENERAL PROPERTY INFORMATION	
PROJECT DESCRIPTION	A MIDDLE HOUSING DEVELOPMENT IN VIC WEST FEATURING 6 FAMILY SIZED UNITS, A LARGE REAR YARD ENCOURAGES NEIGHBOURS TO FORM A COMMUNITY AND FOR CHILDREN TO PLAY. A FOCUS ON BICYCLE AMENITIES RATHER THAN CARS SUPPORTS SUSTAINABLE LIFESTYLES.
CIVIC ADDRESS	633 BELTON AVENUE
LEGAL DESCRIPTION	LOT 7, SECTION 10, ESQUIMALT DISTRICT, PLAN 280.
PROPERTY IDENTIFICATION NUMBER (P.I.D.)	001-566-229
AUTHORITY HAVING JURISDICTION	THE CITY OF VICTORIA
APPLICABLE BUILDING CODE	BRITISH COLUMBIA BUILDING CODE, 2018 EDITION, INCLUDING ALL AMENDMENTS

PROJECT INFORMATION TABLE	
Zone	Proposed
Site Area	515.13 m <sup>2</sup> (R1-B existing zoning)
Total Floor Area *	427.30 m <sup>2</sup> 209.4 m <sup>2</sup> PERMEABLE SITE AREA, 439.79 m <sup>2</sup> NON-PERMEABLE.
Commercial Floor Area	N/A
Floor Space Ratio	0.68 : 1
Site Coverage % *	43%
Open Site Space % *	50%
Height of Building *	8.00m
Storages #	2 storages - lowest level qualifies as basement.
Parking Stalls #	1.45 per unit (7.00m <sup>2</sup> ) x 6 = 9 Visitor + 0.1 per unit x 6 = 1 10 total
Bicycle Parking #	21 Long Term Spaces provided - includes 7 cargo bike spaces 6 Short Term Spaces provided
Building Setbacks	Proposed
Front Yard (South)	4.20m
Rear Yard (North)	8.00m
Side Yard (West)	2.20m (4.3m to building face)
Side Yard (East)	1.37m (2.03m to building face)
Side Yards Combined	6.12m
Residential Use Details	
Total Number of Units	6
Unit Type Breakdown	2 two bedroom units and 4 three bedroom units
Ground Oriented Units	2 Adaptable residential units
Minimum Unit Floor Area <sup>1</sup>	70.68m <sup>2</sup>
Total Residential Floor Area <sup>2</sup>	375.11m <sup>2</sup>

\* Lowest level ceiling less than 1.2m from avg. grade and qualifies as basement and therefore not included. Measurements for area to inside face of exterior walls.


<sup>1</sup> Refer to A1.00 for average grade calculations and A3.00 for height measurements.

<sup>2</sup> Measurements for Unit Floor area are to centreline of exterior walls per the BC Strata Act.

<sup>3</sup> Refer to A1.00 for site coverage & open site space diagram.

FLOOR AREA - ZONING	
Name	Area
Level 2	215.65 m <sup>2</sup>
Level 3	211.58 m <sup>2</sup>
Total	427.23 m <sup>2</sup>

NOTE:  
ZONING FLOOR AREA MEASURED TO INSIDE FACE OF EXTERIOR WALLS.

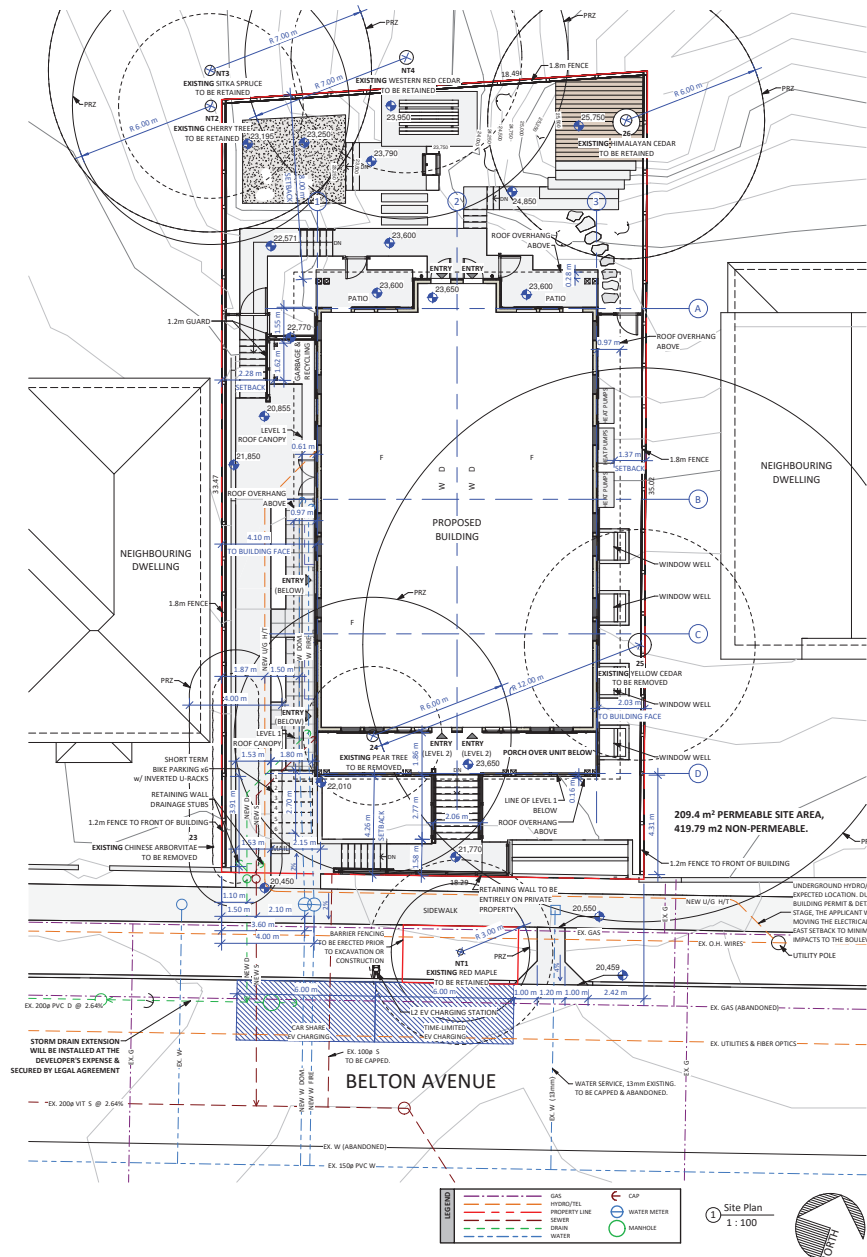

OWNER Urban Thrive Developments Inc. julian@urbanthrive.ca www.UrbanThrive.ca 250 896 4667 Contact: Julian West	ARCHITECTURAL Christine Lintott Architects Inc. Unit 1 - 864 Queens Avenue Victoria BC, V8T 1M5 250 384 1969 Contact: Christine Lintott	LANDSCAPE BIOPHILIA design collective ltd. 101 - 630 Goldstream Ave. Victoria BC, V8T 3E6 250 589 8244 Contact: Bianca Bodley	SURVEY Summit Land Surveying 101 - 630 Goldstream Ave. Victoria BC, V9B 2W8 250 391 6708 Contact: Jason Kozina
--	--	--	---

Christine Lintott Architects Inc.

Suite 1 - 864 Queens Avenue, Victoria, BC V8T 1M5  
Telephone: 250 384 1969  
www.lintottarchitect.ca

Issue Date

FOR DEVELOPMENT PERMIT 2022-02-07

Revision

No.	Description	Date
1	PERMEABLE SITE AREA	2022-05-17
2	RETAINING WALL ON PRIVATE PROPERTY	2022-05-17
3	CRK TO PRZ	2022-05-17
4	TREE IDENTIFIED & OUTLINES CLARIFIED	2022-05-17
5	HEAT PUMP LOCATIONS SHOWN	2022-05-17
6	HEIGHT INCREASED	2022-05-17
7	SITE COVERAGE & OPEN SPACE CONFIRMED	2022-05-17
8	STORM DRAIN EXTENSION NOTE	2022-05-17
9	BICYCLE PARKING NOTED	2022-05-17
10	HYBRID LOCATION NOTE	2022-05-17
11	ILLUSTRATED RAMP & REVERSED STREET PAVING	2022-05-17
12	PORCH & STEP PROTECTION DIMENSIONS	2022-05-17
13	CLARIFIED WEST SETBACK	2022-05-17
14	FENCE HEIGHTS INDICATED	2022-05-17
15	EAST SETBACK & DIMENSION TO BUILDING FACE	2022-05-17

Consultant



633 Belton Avenue

633 Belton Avenue

Site Plan &amp; Project Info

Date 2022-05-17 10:49:46 AM

Drawn by CC

Checked by CL

A0.00

Scale As indicated

# Building Code Analysis

NO.	ITEM	DESCRIPTION	REFERENCE
<b>GENERAL INFORMATION</b>			
1	PROJECT TYPE	<input checked="" type="checkbox"/> NEW CONSTRUCTION <input type="checkbox"/> ADDITION <input type="checkbox"/> RENO <input type="checkbox"/> EXISTING IMPROVEMENTS	
2	GOVERNING BUILDING CODE	2018 INTERNATIONAL BUILDING CODE (IBC) INCLUDING ALL AMENDMENTS	
3	BUILDING CODE PARTS APPLICABLE	PART 2 1 2 3 4 5 6 7 8 9 10 DIV. 4 1.1.2 1.3.1 1.3.4	
4	OCCUPANCY CLASSIFICATION	<input checked="" type="checkbox"/> R <input type="checkbox"/> U <input type="checkbox"/> F <input type="checkbox"/> I <input type="checkbox"/> A	9.10.3.1
5	MULTIPLE MAIN OCCUPANCIES	<input checked="" type="checkbox"/> YES <input type="checkbox"/> NO	9.10.3.5
6	FIREWALLS	<input checked="" type="checkbox"/> YES <input type="checkbox"/> NO	9.10.3.1
7	OCCUPANT LOAD	<input checked="" type="checkbox"/> 32 TOTAL (ALL STORIES)	9.10.3.3
<b>DESIGN OF AREAS AND SPACES</b>			
8	BUILDING AREA (±)	<input checked="" type="checkbox"/> 5,800 REQUIRED <input type="checkbox"/> 251 PROPOSED	DIV. 4 1.3.1.1 1.3.1.2 1.3.1.3
9	GRADE ELEVATION (IN GEODETIC)	<input checked="" type="checkbox"/> 20.70 ± "LOWEST AVERAGE GRADE GOVERNING"	1.4.1.2
10	BUILDING HEIGHT (STOREYS)	<input checked="" type="checkbox"/> 3 "FIRST STOREY" PER DEFINITION	1.4.1.2 1.3.1.4
11	NUMBER OF STREETS FACED	<input checked="" type="checkbox"/> 1	1.4.1.2
12	FIRE ALARM & DETECTION SYSTEM	<input checked="" type="checkbox"/> REQUIRED <input type="checkbox"/> PROPOSED <input type="checkbox"/> N/A	9.10.3.8.2
13	AUTOMATIC SPRINKLER SYSTEM	<input checked="" type="checkbox"/> REQUIRED <input type="checkbox"/> PROPOSED <input type="checkbox"/> N/A	9.10.3.8.2
14	MEZZANINES	<input checked="" type="checkbox"/> YES <input type="checkbox"/> NO	9.10.4.1
15	INTERCONNECTED FLOOR SPACE	<input checked="" type="checkbox"/> YES <input type="checkbox"/> NO	9.10.3.5
16	CONSTRUCTION TYPE(S)	<input checked="" type="checkbox"/> 1 <input type="checkbox"/> 2 <input type="checkbox"/> 3 <input type="checkbox"/> 4 <input type="checkbox"/> 5 <input type="checkbox"/> 6 <input type="checkbox"/> 7 <input type="checkbox"/> 8 <input type="checkbox"/> 9 <input type="checkbox"/> 10	9.10.3.5
17	ASSEMBLY FIRE RESISTANCE RATINGS (R.A.R., IN HOURS)	<input checked="" type="checkbox"/> 2 <input type="checkbox"/> 1 <input type="checkbox"/> 0 <input type="checkbox"/> 1 <input type="checkbox"/> 2 <input type="checkbox"/> 3 <input type="checkbox"/> 4 <input type="checkbox"/> 5 <input type="checkbox"/> 6 <input type="checkbox"/> 7 <input type="checkbox"/> 8 <input type="checkbox"/> 9 <input type="checkbox"/> 10	9.10.3.5
<b>DESIGN OF AREAS AND SPACES</b>			
18	ACCESS FOR PERSONS WITH DISABILITIES	<input checked="" type="checkbox"/> REQUIRED <input type="checkbox"/> PROPOSED <input type="checkbox"/> N/A	9.10.3.1 9.10.3.2
19	CEILING HEIGHTS (mm)	<input checked="" type="checkbox"/> 2,200 REQUIRED	9.10.3.1
20	HALLWAY WIDTHS (WITHIN A DWELLING UNIT) (mm)	<input checked="" type="checkbox"/> 800 REQUIRED	9.10.3.1
21	DOORWAY SIZES (mm)	<input checked="" type="checkbox"/> 800 REQUIRED	9.10.3.1
22	DWELLING UNIT ENTRANCE DOORS	<input checked="" type="checkbox"/> 800 REQUIRED	9.10.3.1
23	PERFORMANCE OF WINDOWS, DOORS AND SKYLIGHTS	<input checked="" type="checkbox"/> 800 REQUIRED	9.10.3.1
24	DESIGN AND CONSTRUCTION OF WINDOWS, DOORS AND SKYLIGHTS	<input checked="" type="checkbox"/> 800 REQUIRED	9.10.3.1
25	RESISTANCE TO FORCED ENTRY FOR SWINGING DWELLING UNIT DOORS	<input checked="" type="checkbox"/> 800 REQUIRED	9.10.3.1
26	RESISTANCE TO FORCED ENTRY FOR RESIDENTIAL WINDOWS	<input checked="" type="checkbox"/> 800 REQUIRED	9.10.3.1
<b>STAIRS, RAMPS, HANDRAILS AND GUARDS</b>			
27	STAIR WIDTH (mm)	<input checked="" type="checkbox"/> 800 REQUIRED	9.10.3.1
28	HEIGHT OVER STAIRS AND LANDINGS (mm)	<input checked="" type="checkbox"/> 800 REQUIRED	9.10.3.1
29	STAIR DIMENSIONS (mm)	<input checked="" type="checkbox"/> 800 REQUIRED	9.10.3.1
30	TREAD NOSSINGS (mm)	<input checked="" type="checkbox"/> 800 REQUIRED	9.10.3.1
31	TACTILE WARNING STRIPS	<input checked="" type="checkbox"/> 800 REQUIRED	9.10.3.1
32	RAMPS	<input checked="" type="checkbox"/> 800 REQUIRED	9.10.3.1
33	LANDINGS (mm)	<input checked="" type="checkbox"/> 800 REQUIRED	9.10.3.1

NO.	ITEM	DESCRIPTION	REFERENCE
34	HANDRAILS	<input checked="" type="checkbox"/> 800 REQUIRED	9.10.3.1
35	GUARDS	<input checked="" type="checkbox"/> 800 REQUIRED	9.10.3.1
<b>MEANS OF EGRESS</b>			
36	EXIT WIDTH (mm)	<input checked="" type="checkbox"/> 800 REQUIRED	9.10.3.1
37	WIDTH OF CORRIDORS (mm)	<input checked="" type="checkbox"/> 800 REQUIRED	9.10.3.1
38	CLEAR HEIGHT IN EXITS AND ACCESS TO EXITS (mm)	<input checked="" type="checkbox"/> 800 REQUIRED	9.10.3.1
39	FIRE SEPARATIONS FOR EXITS (R.A., IN HOURS)	<input checked="" type="checkbox"/> 2 REQUIRED	9.10.3.1
40	OPENINGS NEAR UNLOCKED EXTERIOR EXIT STAIRS AND RAMPS	<input checked="" type="checkbox"/> 800 REQUIRED	9.10.3.1
41	OPENINGS IN EXTERIOR WALLS OF EXITS	<input checked="" type="checkbox"/> 800 REQUIRED	9.10.3.1
42	OPENINGS NEAR EXIT DOORS	<input checked="" type="checkbox"/> 800 REQUIRED	9.10.3.1
43	SERVICE ROOMS	<input checked="" type="checkbox"/> 800 REQUIRED	9.10.3.1
44	OBSTRUCTIONS BY DOORS IN EXITS AND PUBLIC CORRIDORS	<input checked="" type="checkbox"/> 800 REQUIRED	9.10.3.1
45	CLEAR HEIGHT AT DOORWAYS (NOT SERVING A SINGLE DWELLING) (mm)	<input checked="" type="checkbox"/> 800 REQUIRED	9.10.3.1
46	CLEAR HEIGHT AT DOORWAYS (NOT SERVING A SINGLE DWELLING) (mm)	<input checked="" type="checkbox"/> 800 REQUIRED	9.10.3.1
47	EXIT AND DWELLING UNIT DOORS	<input checked="" type="checkbox"/> 800 REQUIRED	9.10.3.1
48	EXITS FROM ROOF TERRACES	<input checked="" type="checkbox"/> 800 REQUIRED	9.10.3.1
49	EXITS FROM SUITES	<input checked="" type="checkbox"/> 800 REQUIRED	9.10.3.1
50	DEAD END CORRIDORS	<input checked="" type="checkbox"/> 800 REQUIRED	9.10.3.1
51	NUMBER AND SPACING OF EXCESS DOORS	<input checked="" type="checkbox"/> 800 REQUIRED	9.10.3.1
52	TRAVEL DISTANCE (WITHIN SUITES)	<input checked="" type="checkbox"/> 800 REQUIRED	9.10.3.1
53	LOCATION OF EXITS	<input checked="" type="checkbox"/> 800 REQUIRED	9.10.3.1
54	EXITING THROUGH A LOBBY	<input checked="" type="checkbox"/> 800 REQUIRED	9.10.3.1

NO.	ITEM	DESCRIPTION	REFERENCE
55	MEZZANINE MEANS OF EXCESS	<input checked="" type="checkbox"/> 800 REQUIRED	9.10.3.1
56	TRAVEL LIMIT TO EXITS OR EXCESS DOORS (FROM DWELLING UNIT)	<input checked="" type="checkbox"/> 800 REQUIRED	9.10.3.1
57	TWO SEPARATE EXITS (FROM DWELLING UNIT)	<input checked="" type="checkbox"/> 800 REQUIRED	9.10.3.1
58	SHARED EXITS FACILITIES (FROM DWELLING UNIT)	<input checked="" type="checkbox"/> 800 REQUIRED	9.10.3.1
59	EXCESS WINDOWS OR DOORS FOR BEDROOMS	<input checked="" type="checkbox"/> 800 REQUIRED	9.10.3.1
60	EXIT SIGNS	<input checked="" type="checkbox"/> 800 REQUIRED	9.10.3.1
61	STAIRS FOR STAIRS AND RAMPS AT EXIT LEVEL	<input checked="" type="checkbox"/> 800 REQUIRED	9.10.3.1
62	FLOOR NUMBERING	<input checked="" type="checkbox"/> 800 REQUIRED	9.10.3.1
63	EMERGENCY LIGHTING FOR MEANS OF EXCESS NOT WITHIN DWELLING UNIT	<input checked="" type="checkbox"/> 800 REQUIRED	9.10.3.1
64	THE PROTECTION OF PUBLIC ENTRANCES	<input checked="" type="checkbox"/> 800 REQUIRED	9.10.3.1
65	SEPARATION OF PUBLIC CORRIDORS	<input checked="" type="checkbox"/> 800 REQUIRED	9.10.3.1
66	PENETRATION OF FIRE SEPARATIONS	<input checked="" type="checkbox"/> 800 REQUIRED	9.10.3.1
67	PENETRATION BY COMBUSTIBLE DRAIN, WASTE AND VENT PIPES	<input checked="" type="checkbox"/> 800 REQUIRED	9.10.3.1
68	SEPARATION OF RESIDENTIAL OCCUPANCIES (R.A., IN HOURS)	<input checked="" type="checkbox"/> 800 REQUIRED	9.10.3.1
69	SEPARATION OF RESIDENTIAL OCCUPANCIES (R.A., IN HOURS)	<input checked="" type="checkbox"/> 800 REQUIRED	9.10.3.1
70	SEPARATION OF SUITES (R.A., IN HOURS)	<input checked="" type="checkbox"/> 800 REQUIRED	9.10.3.1
71	SEPARATION OF PUBLIC CORRIDORS (R.A., IN HOURS)	<input checked="" type="checkbox"/> 800 REQUIRED	9.10.3.1
72	SEPARATION OF STORAGE GARAGES (R.A., IN HOURS)	<input checked="" type="checkbox"/> 800 REQUIRED	9.10.3.1

NO.	ITEM	DESCRIPTION	REFERENCE
73	SEPARATION OF SERVICE ROOMS (R.A., IN HOURS)	<input checked="" type="checkbox"/> 800 REQUIRED	9.10.3.1
74	LOCATION OF FIRE-FIRED APPLIANCES (R.A., IN HOURS)	<input checked="" type="checkbox"/> 800 REQUIRED	9.10.3.1
75	ROOMS FOR TEMPORARY STORAGE OF COMBUSTIBLE RESIDUE (R.A., IN HOURS)	<input checked="" type="checkbox"/> 800 REQUIRED	9.10.3.1
76	PROTECTION OF SKIRTS	<input checked="" type="checkbox"/> 800 REQUIRED	9.10.3.1
77	SPATIAL SEPARATIONS	<input checked="" type="checkbox"/> 800 REQUIRED	9.10.3.1
78	FIRE BLOCKS	<input checked="" type="checkbox"/> 800 REQUIRED	9.10.3.1
79	FLAME-SPREAD RATING OF INTERIOR SURFACES	<input checked="" type="checkbox"/> 800 REQUIRED	9.10.3.1
80	DOORS NOT WITHIN DWELLING UNITS	<input checked="" type="checkbox"/> 800 REQUIRED	9.10.3.1
81	FIRE ALARM SYSTEM	<input checked="" type="checkbox"/> 800 REQUIRED	9.10.3.1
82	ROOMS AND SPACES REQUIRING THAT DETECTORS OR SMOKE DETECTORS	<input checked="" type="checkbox"/> 800 REQUIRED	9.10.3.1
83	SMOKE ALARMS	<input checked="" type="checkbox"/> 800 REQUIRED	9.10.3.1
84	WINDOWS OR ACCESS PANELS	<input checked="" type="checkbox"/> 800 REQUIRED	9.10.3.1
85	PORTABLE FIRE EXTINGUISHERS	<input checked="" type="checkbox"/> 800 REQUIRED	9.10.3.1
86	PROTECTION FOR GAS, PROPANE AND ELECTRIC CLOSETS AND OVENS	<input checked="" type="checkbox"/> 800 REQUIRED	9.10.3.1
87	PROTECTION FROM AMBIENT NOISE	<input checked="" type="checkbox"/> 800 REQUIRED	9.10.3.1
88	DETERMINATION OF SOUND TRANSMISSION RATINGS	<input checked="" type="checkbox"/> 800 REQUIRED	9.10.3.1
89	ADJOINING CONSTRUCTIONS	<input checked="" type="checkbox"/> 800 REQUIRED	9.10.3.1

Christine Lintott Architects Inc.

Suite 1 - 864 Queens Avenue, Victoria, BC V8T 1M5  
Telephone: 250.384.1565  
www.lintottarchitect.ca

Issue Date

FOR DEVELOPMENT PERMIT 2022-02-07

Revision

No. Description Date

Consultant



633 Belton Avenue

633 Belton Avenue

Building Code Analysis

Date 2022-05-17 10:49:52 AM

Drawn by Author

Checked by Checker


A0.01

Scale 1:1

# Building Code Analysis (continued)

NO.	ITEM	DESCRIPTION	REFERENCE
90	SCOPE AND APPLICATION	<p>1. <b>WALLS</b></p> <p>WALLS SHALL BE CONSIDERED AS PART OF THE BUILDING ENVELOPE. WALLS SHALL BE CONSIDERED AS PART OF THE BUILDING ENVELOPE. WALLS SHALL BE CONSIDERED AS PART OF THE BUILDING ENVELOPE.</p>	9.2.1.1
91	THERMAL INSULATION	<p>1. <b>WALLS</b></p> <p>WALLS SHALL BE CONSIDERED AS PART OF THE BUILDING ENVELOPE. WALLS SHALL BE CONSIDERED AS PART OF THE BUILDING ENVELOPE. WALLS SHALL BE CONSIDERED AS PART OF THE BUILDING ENVELOPE.</p>	9.2.1.2
92	AIR BARRIER SYSTEMS	<p>1. <b>WALLS</b></p> <p>WALLS SHALL BE CONSIDERED AS PART OF THE BUILDING ENVELOPE. WALLS SHALL BE CONSIDERED AS PART OF THE BUILDING ENVELOPE. WALLS SHALL BE CONSIDERED AS PART OF THE BUILDING ENVELOPE.</p>	9.2.1.3
93	VAPOUR BARRIERS	<p>1. <b>WALLS</b></p> <p>WALLS SHALL BE CONSIDERED AS PART OF THE BUILDING ENVELOPE. WALLS SHALL BE CONSIDERED AS PART OF THE BUILDING ENVELOPE. WALLS SHALL BE CONSIDERED AS PART OF THE BUILDING ENVELOPE.</p>	9.2.1.4
94	BUILDING ENVELOPE	<p>1. <b>WALLS</b></p> <p>WALLS SHALL BE CONSIDERED AS PART OF THE BUILDING ENVELOPE. WALLS SHALL BE CONSIDERED AS PART OF THE BUILDING ENVELOPE. WALLS SHALL BE CONSIDERED AS PART OF THE BUILDING ENVELOPE.</p>	9.2.1.5
95	VENTILATION	<p>1. <b>WALLS</b></p> <p>WALLS SHALL BE CONSIDERED AS PART OF THE BUILDING ENVELOPE. WALLS SHALL BE CONSIDERED AS PART OF THE BUILDING ENVELOPE. WALLS SHALL BE CONSIDERED AS PART OF THE BUILDING ENVELOPE.</p>	9.2.1.6
96	NON-HEATING SEASON VENTILATION	<p>1. <b>WALLS</b></p> <p>WALLS SHALL BE CONSIDERED AS PART OF THE BUILDING ENVELOPE. WALLS SHALL BE CONSIDERED AS PART OF THE BUILDING ENVELOPE. WALLS SHALL BE CONSIDERED AS PART OF THE BUILDING ENVELOPE.</p>	9.2.1.7
97	HEATING SEASON VENTILATION	<p>1. <b>WALLS</b></p> <p>WALLS SHALL BE CONSIDERED AS PART OF THE BUILDING ENVELOPE. WALLS SHALL BE CONSIDERED AS PART OF THE BUILDING ENVELOPE. WALLS SHALL BE CONSIDERED AS PART OF THE BUILDING ENVELOPE.</p>	9.2.1.8
98	VENTILATION SYSTEM SUPPLY AIR	<p>1. <b>WALLS</b></p> <p>WALLS SHALL BE CONSIDERED AS PART OF THE BUILDING ENVELOPE. WALLS SHALL BE CONSIDERED AS PART OF THE BUILDING ENVELOPE. WALLS SHALL BE CONSIDERED AS PART OF THE BUILDING ENVELOPE.</p>	9.2.1.9
99	PRINCIPAL VENTILATION SYSTEM EXHAUST FAN	<p>1. <b>WALLS</b></p> <p>WALLS SHALL BE CONSIDERED AS PART OF THE BUILDING ENVELOPE. WALLS SHALL BE CONSIDERED AS PART OF THE BUILDING ENVELOPE. WALLS SHALL BE CONSIDERED AS PART OF THE BUILDING ENVELOPE.</p>	9.2.1.10
100	KITCHEN AND BATHROOM EXHAUST FANS	<p>1. <b>WALLS</b></p> <p>WALLS SHALL BE CONSIDERED AS PART OF THE BUILDING ENVELOPE. WALLS SHALL BE CONSIDERED AS PART OF THE BUILDING ENVELOPE. WALLS SHALL BE CONSIDERED AS PART OF THE BUILDING ENVELOPE.</p>	9.2.1.11
101	HEATED CRAWL SPACE VENTILATION	<p>1. <b>WALLS</b></p> <p>WALLS SHALL BE CONSIDERED AS PART OF THE BUILDING ENVELOPE. WALLS SHALL BE CONSIDERED AS PART OF THE BUILDING ENVELOPE. WALLS SHALL BE CONSIDERED AS PART OF THE BUILDING ENVELOPE.</p>	9.2.1.12
102	AIR DUCTS	<p>1. <b>WALLS</b></p> <p>WALLS SHALL BE CONSIDERED AS PART OF THE BUILDING ENVELOPE. WALLS SHALL BE CONSIDERED AS PART OF THE BUILDING ENVELOPE. WALLS SHALL BE CONSIDERED AS PART OF THE BUILDING ENVELOPE.</p>	9.2.1.13

NO.	ITEM	DESCRIPTION	REFERENCE
103	OUTDOOR INLETS AND OUTLETS	<p>1. <b>WALLS</b></p> <p>WALLS SHALL BE CONSIDERED AS PART OF THE BUILDING ENVELOPE. WALLS SHALL BE CONSIDERED AS PART OF THE BUILDING ENVELOPE. WALLS SHALL BE CONSIDERED AS PART OF THE BUILDING ENVELOPE.</p>	9.2.1.14
104	INTERIOR DISTRIBUTION	<p>1. <b>WALLS</b></p> <p>WALLS SHALL BE CONSIDERED AS PART OF THE BUILDING ENVELOPE. WALLS SHALL BE CONSIDERED AS PART OF THE BUILDING ENVELOPE. WALLS SHALL BE CONSIDERED AS PART OF THE BUILDING ENVELOPE.</p>	9.2.1.15
105	ADDITIONAL PROTECTION AGAINST DEPRESSURIZATION	<p>1. <b>WALLS</b></p> <p>WALLS SHALL BE CONSIDERED AS PART OF THE BUILDING ENVELOPE. WALLS SHALL BE CONSIDERED AS PART OF THE BUILDING ENVELOPE. WALLS SHALL BE CONSIDERED AS PART OF THE BUILDING ENVELOPE.</p>	9.2.1.16
106	CARBON MONOXIDE (CO) ALARMS	<p>1. <b>WALLS</b></p> <p>WALLS SHALL BE CONSIDERED AS PART OF THE BUILDING ENVELOPE. WALLS SHALL BE CONSIDERED AS PART OF THE BUILDING ENVELOPE. WALLS SHALL BE CONSIDERED AS PART OF THE BUILDING ENVELOPE.</p>	9.2.1.17
107	HEATING AND AIR-CONDITIONING	<p>1. <b>WALLS</b></p> <p>WALLS SHALL BE CONSIDERED AS PART OF THE BUILDING ENVELOPE. WALLS SHALL BE CONSIDERED AS PART OF THE BUILDING ENVELOPE. WALLS SHALL BE CONSIDERED AS PART OF THE BUILDING ENVELOPE.</p>	9.2.1.18
108	HEATING DESIGN TEMPERATURES	<p>1. <b>WALLS</b></p> <p>WALLS SHALL BE CONSIDERED AS PART OF THE BUILDING ENVELOPE. WALLS SHALL BE CONSIDERED AS PART OF THE BUILDING ENVELOPE. WALLS SHALL BE CONSIDERED AS PART OF THE BUILDING ENVELOPE.</p>	9.2.1.19
109	CAPACITY OF HEATING APPLIANCES	<p>1. <b>WALLS</b></p> <p>WALLS SHALL BE CONSIDERED AS PART OF THE BUILDING ENVELOPE. WALLS SHALL BE CONSIDERED AS PART OF THE BUILDING ENVELOPE. WALLS SHALL BE CONSIDERED AS PART OF THE BUILDING ENVELOPE.</p>	9.2.1.20
110	INSTALLATION STANDARDS (OF EQUIPMENT)	<p>1. <b>WALLS</b></p> <p>WALLS SHALL BE CONSIDERED AS PART OF THE BUILDING ENVELOPE. WALLS SHALL BE CONSIDERED AS PART OF THE BUILDING ENVELOPE. WALLS SHALL BE CONSIDERED AS PART OF THE BUILDING ENVELOPE.</p>	9.2.1.21
111	STANDARD FOR SOLID-FUEL BURNING APPLIANCES	<p>1. <b>WALLS</b></p> <p>WALLS SHALL BE CONSIDERED AS PART OF THE BUILDING ENVELOPE. WALLS SHALL BE CONSIDERED AS PART OF THE BUILDING ENVELOPE. WALLS SHALL BE CONSIDERED AS PART OF THE BUILDING ENVELOPE.</p>	9.2.1.22
112	PREPLACES	<p>1. <b>WALLS</b></p> <p>WALLS SHALL BE CONSIDERED AS PART OF THE BUILDING ENVELOPE. WALLS SHALL BE CONSIDERED AS PART OF THE BUILDING ENVELOPE. WALLS SHALL BE CONSIDERED AS PART OF THE BUILDING ENVELOPE.</p>	9.2.1.23
113	AIR DUCT DISTRIBUTION SYSTEMS	<p>1. <b>WALLS</b></p> <p>WALLS SHALL BE CONSIDERED AS PART OF THE BUILDING ENVELOPE. WALLS SHALL BE CONSIDERED AS PART OF THE BUILDING ENVELOPE. WALLS SHALL BE CONSIDERED AS PART OF THE BUILDING ENVELOPE.</p>	9.2.1.24
114	RADIATORS AND CONNECTIONS	<p>1. <b>WALLS</b></p> <p>WALLS SHALL BE CONSIDERED AS PART OF THE BUILDING ENVELOPE. WALLS SHALL BE CONSIDERED AS PART OF THE BUILDING ENVELOPE. WALLS SHALL BE CONSIDERED AS PART OF THE BUILDING ENVELOPE.</p>	9.2.1.25
115	PIPING FOR HEATING AND COOLING SYSTEMS	<p>1. <b>WALLS</b></p> <p>WALLS SHALL BE CONSIDERED AS PART OF THE BUILDING ENVELOPE. WALLS SHALL BE CONSIDERED AS PART OF THE BUILDING ENVELOPE. WALLS SHALL BE CONSIDERED AS PART OF THE BUILDING ENVELOPE.</p>	9.2.1.26
116	COOLING UNITS (COMBINED WITH FUEL-FIRED FURNACES)	<p>1. <b>WALLS</b></p> <p>WALLS SHALL BE CONSIDERED AS PART OF THE BUILDING ENVELOPE. WALLS SHALL BE CONSIDERED AS PART OF THE BUILDING ENVELOPE. WALLS SHALL BE CONSIDERED AS PART OF THE BUILDING ENVELOPE.</p>	9.2.1.27
117	CHIMNEYS AND VENTING EQUIPMENT	<p>1. <b>WALLS</b></p> <p>WALLS SHALL BE CONSIDERED AS PART OF THE BUILDING ENVELOPE. WALLS SHALL BE CONSIDERED AS PART OF THE BUILDING ENVELOPE. WALLS SHALL BE CONSIDERED AS PART OF THE BUILDING ENVELOPE.</p>	9.2.1.28
118	ELECTRICAL FACILITIES	<p>1. <b>WALLS</b></p> <p>WALLS SHALL BE CONSIDERED AS PART OF THE BUILDING ENVELOPE. WALLS SHALL BE CONSIDERED AS PART OF THE BUILDING ENVELOPE. WALLS SHALL BE CONSIDERED AS PART OF THE BUILDING ENVELOPE.</p>	9.2.1.29
119	GRANDES AND COMPARTS	<p>1. <b>WALLS</b></p> <p>WALLS SHALL BE CONSIDERED AS PART OF THE BUILDING ENVELOPE. WALLS SHALL BE CONSIDERED AS PART OF THE BUILDING ENVELOPE. WALLS SHALL BE CONSIDERED AS PART OF THE BUILDING ENVELOPE.</p>	9.2.1.30
120	APPLICATION	<p>1. <b>WALLS</b></p> <p>WALLS SHALL BE CONSIDERED AS PART OF THE BUILDING ENVELOPE. WALLS SHALL BE CONSIDERED AS PART OF THE BUILDING ENVELOPE. WALLS SHALL BE CONSIDERED AS PART OF THE BUILDING ENVELOPE.</p>	9.2.1.31
121	ENERGY COMPLIANCE STANDARD	<p>1. <b>WALLS</b></p> <p>WALLS SHALL BE CONSIDERED AS PART OF THE BUILDING ENVELOPE. WALLS SHALL BE CONSIDERED AS PART OF THE BUILDING ENVELOPE. WALLS SHALL BE CONSIDERED AS PART OF THE BUILDING ENVELOPE.</p>	9.2.1.32
122	ENERGY STEP	<p>1. <b>WALLS</b></p> <p>WALLS SHALL BE CONSIDERED AS PART OF THE BUILDING ENVELOPE. WALLS SHALL BE CONSIDERED AS PART OF THE BUILDING ENVELOPE. WALLS SHALL BE CONSIDERED AS PART OF THE BUILDING ENVELOPE.</p>	9.2.1.33
123	ENERGY PERFORMANCE COMPLIANCE AND MONITORING	<p>1. <b>WALLS</b></p> <p>WALLS SHALL BE CONSIDERED AS PART OF THE BUILDING ENVELOPE. WALLS SHALL BE CONSIDERED AS PART OF THE BUILDING ENVELOPE. WALLS SHALL BE CONSIDERED AS PART OF THE BUILDING ENVELOPE.</p>	9.2.1.34
124	ENERGY STEP CODE APPLICATION (TO MULTIFAMILY DWELLING UNITS)	<p>1. <b>WALLS</b></p> <p>WALLS SHALL BE CONSIDERED AS PART OF THE BUILDING ENVELOPE. WALLS SHALL BE CONSIDERED AS PART OF THE BUILDING ENVELOPE. WALLS SHALL BE CONSIDERED AS PART OF THE BUILDING ENVELOPE.</p>	9.2.1.35
125	ABOVEGROUND AIR CHANGES / HOUR AT 50 Pa	<p>1. <b>WALLS</b></p> <p>WALLS SHALL BE CONSIDERED AS PART OF THE BUILDING ENVELOPE. WALLS SHALL BE CONSIDERED AS PART OF THE BUILDING ENVELOPE. WALLS SHALL BE CONSIDERED AS PART OF THE BUILDING ENVELOPE.</p>	9.2.1.36
126	BUILDING EQUIPMENT AND MECHANICAL ENERGY USE INTENSITY (IN LOWER THAN REFERENCE HOUSE)	<p>1. <b>WALLS</b></p> <p>WALLS SHALL BE CONSIDERED AS PART OF THE BUILDING ENVELOPE. WALLS SHALL BE CONSIDERED AS PART OF THE BUILDING ENVELOPE. WALLS SHALL BE CONSIDERED AS PART OF THE BUILDING ENVELOPE.</p>	9.2.1.37
127	BUILDING ENVELOPE THERMAL ENERGY DEMAND INTENSITY (W/m <sup>2</sup> ·K)	<p>1. <b>WALLS</b></p> <p>WALLS SHALL BE CONSIDERED AS PART OF THE BUILDING ENVELOPE. WALLS SHALL BE CONSIDERED AS PART OF THE BUILDING ENVELOPE. WALLS SHALL BE CONSIDERED AS PART OF THE BUILDING ENVELOPE.</p>	9.2.1.38
128	BUILDING ENVELOPE AIRTIGHTNESS TESTING	<p>1. <b>WALLS</b></p> <p>WALLS SHALL BE CONSIDERED AS PART OF THE BUILDING ENVELOPE. WALLS SHALL BE CONSIDERED AS PART OF THE BUILDING ENVELOPE. WALLS SHALL BE CONSIDERED AS PART OF THE BUILDING ENVELOPE.</p>	9.2.1.39

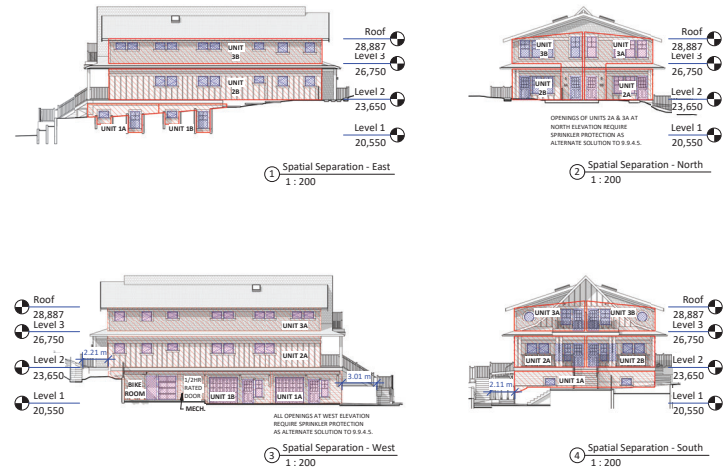

## Building Code Analysis - Spatial Separations

NO.	ITEM	DESCRIPTION	REFERENCE
5-1	Spatial Separations	<p>1. <b>WALLS</b></p> <p>WALLS SHALL BE CONSIDERED AS PART OF THE BUILDING ENVELOPE. WALLS SHALL BE CONSIDERED AS PART OF THE BUILDING ENVELOPE. WALLS SHALL BE CONSIDERED AS PART OF THE BUILDING ENVELOPE.</p>	9.2.1.40
6-1	SPATIAL SEPARATION AND EXPOSURE PROTECTION & CONSTRUCTION OF EXPOSING BUILDING FACE	<p>1. <b>WALLS</b></p> <p>WALLS SHALL BE CONSIDERED AS PART OF THE BUILDING ENVELOPE. WALLS SHALL BE CONSIDERED AS PART OF THE BUILDING ENVELOPE. WALLS SHALL BE CONSIDERED AS PART OF THE BUILDING ENVELOPE.</p>	9.2.1.41
6-2	EXIT EXPOSURE PROTECTION	<p>1. <b>WALLS</b></p> <p>WALLS SHALL BE CONSIDERED AS PART OF THE BUILDING ENVELOPE. WALLS SHALL BE CONSIDERED AS PART OF THE BUILDING ENVELOPE. WALLS SHALL BE CONSIDERED AS PART OF THE BUILDING ENVELOPE.</p>	9.2.1.42

Christine Littott Architects Inc.  
Suite 1 - 864 Queens Avenue, Victoria, BC V8T 1M5  
Telephone: 250.384.1969  
www.intortarchitect.ca

Issue Date  
FOR DEVELOPMENT PERMIT 2022-02-07

Revision No. Description Date

Consultant



633 Belton Avenue

633 Belton Avenue



Building Code Analysis & Spatial Separations

Date 2022-05-17 10:50:01 AM  
Drawn by CC  
Checked by CL

A0.02





Scale As indicated



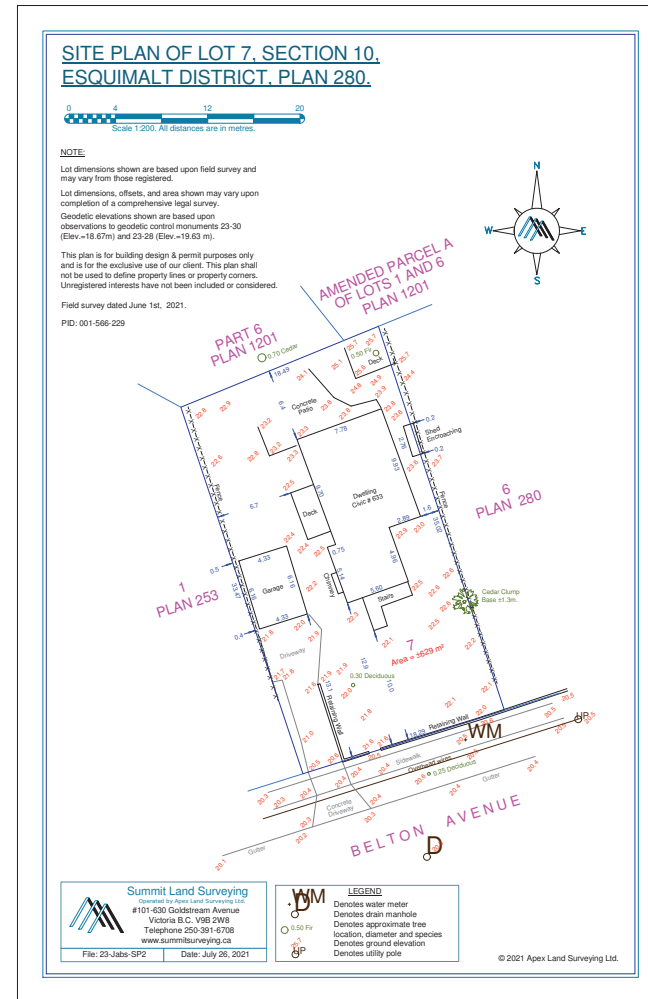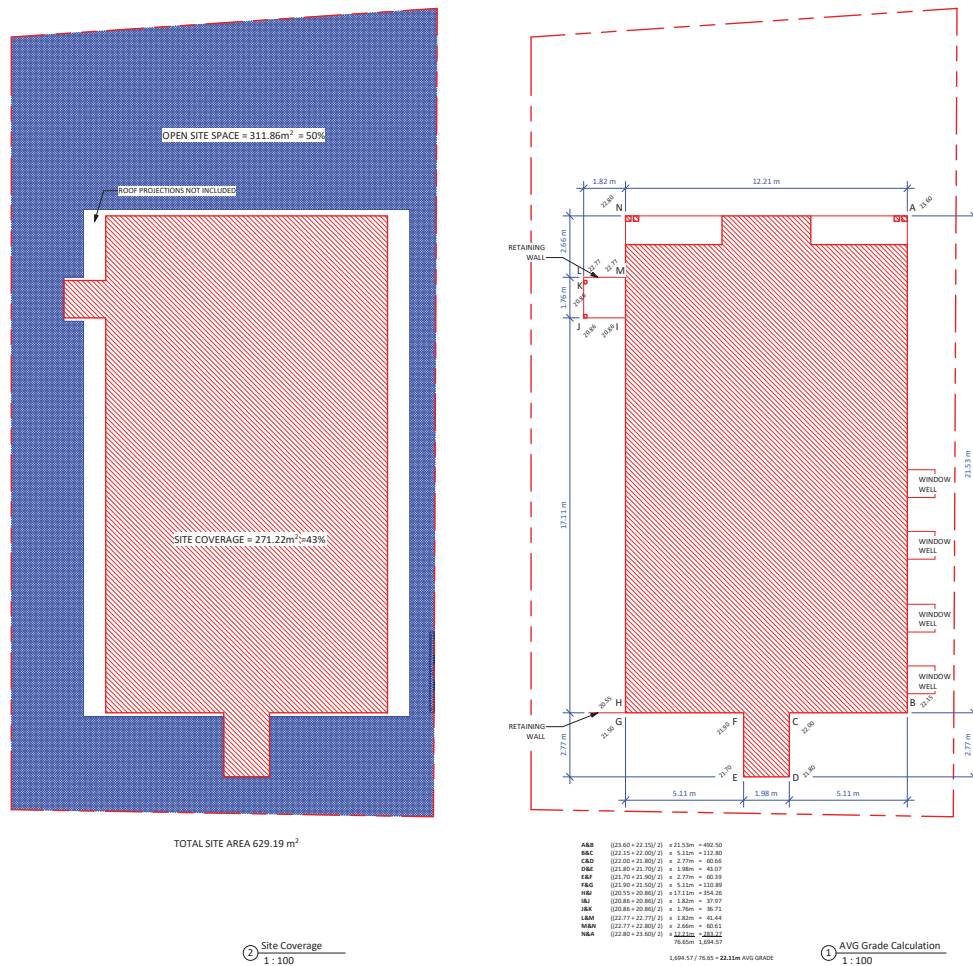

Window Schedule		
Type Mark	Width	Height
S01	559	1,299
W2	865	610
W3	865	865
W4	610	1,525
W5	660	1,525
W6	865	1,525
W7	865	1,830
W8	865	865

Window Schedule		
Type Mark	Width	Height
S01	559	1,299
W2	865	610
W3	865	865
W4	610	1,525
W5	660	1,525
W6	865	1,525
W7	865	1,830
W8	865	865

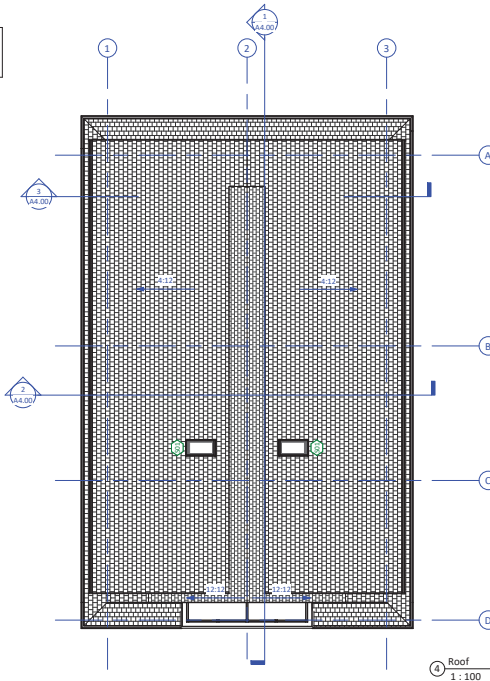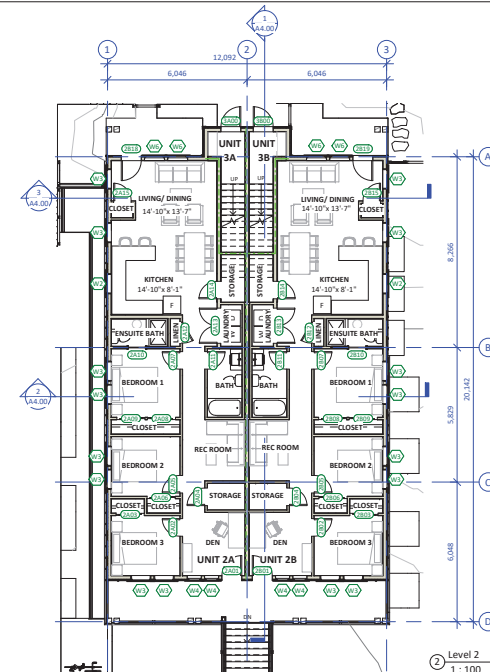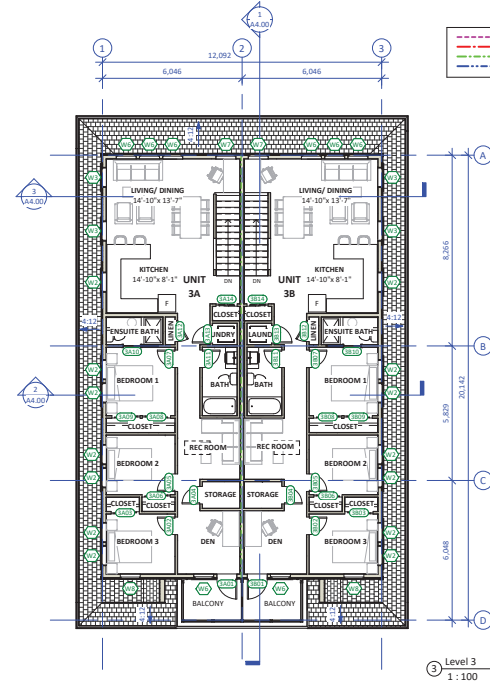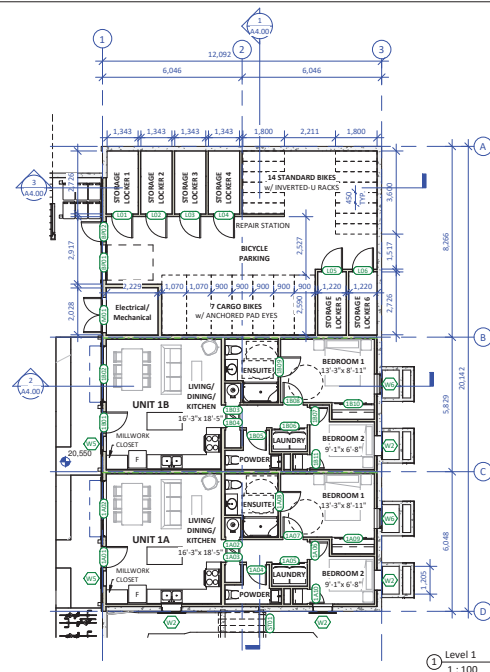

Suite 1 - 864 Queens Avenue, Victoria, BC V8T 1M5  
Telephone: 250.384.1969  
[www.lintottarchitect.ca](http://www.lintottarchitect.ca)

Issue	Date
FOR DEVELOPMENT PERMIT	2022-02-07

Revision		
No.	Description	Date
01	RECEIVE BACKS NOTED	2022.05.17

Consultant







633 Belton Avenue

633 Belton Avenue

## Floor Plans

Date	2022-05-17 10:50:14 AM
Drawn by	CC
Checked by	CL
A2.00	
Scale	As indicated

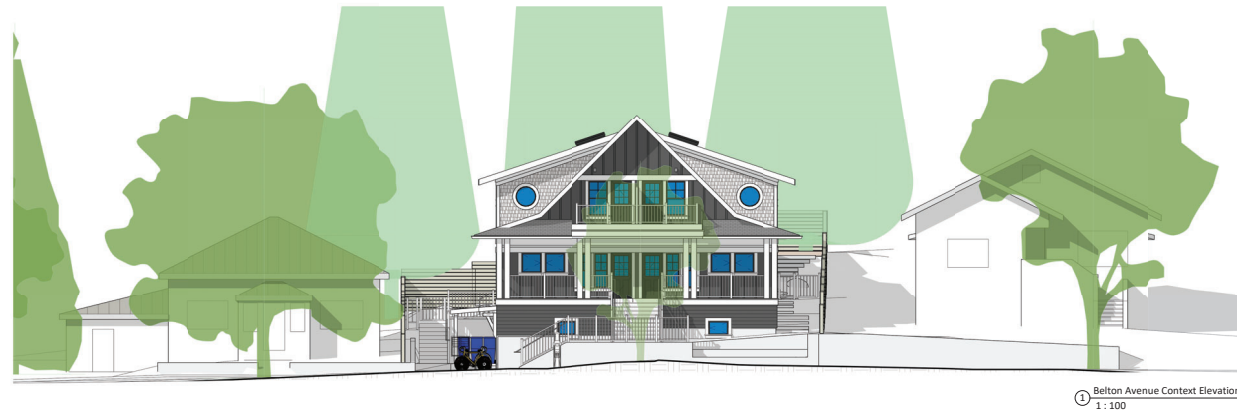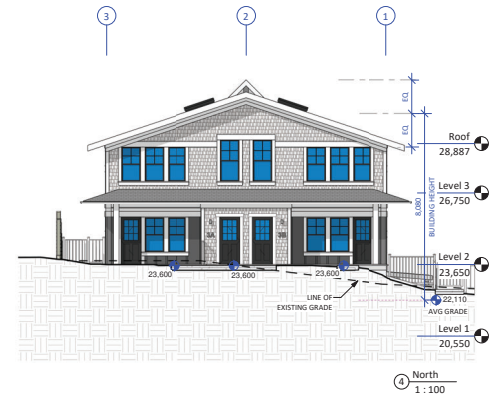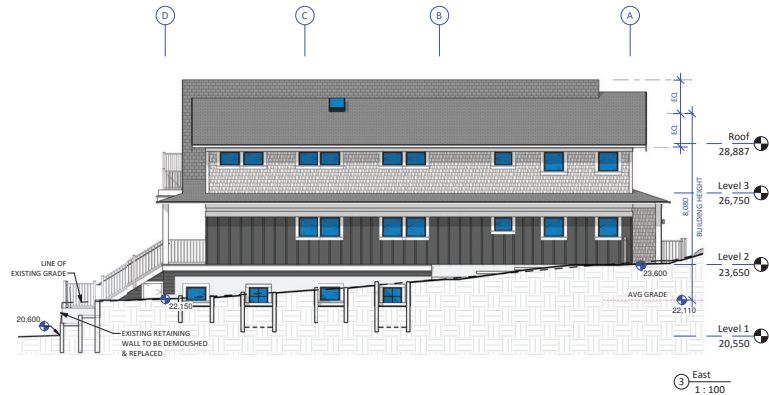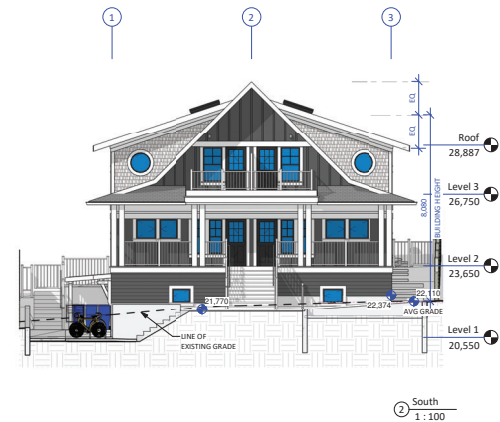


Christine Lintott  
Architects Inc.

Suite 1 - 864 Queens Avenue, Victoria, BC V8T 1M5  
Telephone: 250.384.1969  
www.lintottarchitect.ca

Issue	Date
FOR DEVELOPMENT PERMIT	2022-02-07

No.	Description	Date
1	AVG GRADE RECALCULATED	2022-05-17
2	HEIGHT INCREASED	2022-05-17
3	EXISTING GRADE LINES ADDED	2022-05-17

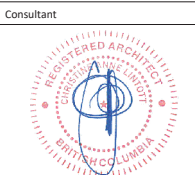

633 Belton Avenue

633 Belton Avenue



Exterior Elevations

Date 2022-05-17 10:50:31 AM  
Drawn by CC  
Checked by CL

A3.00

Scale 1:100




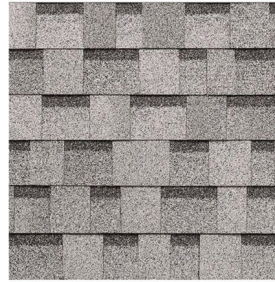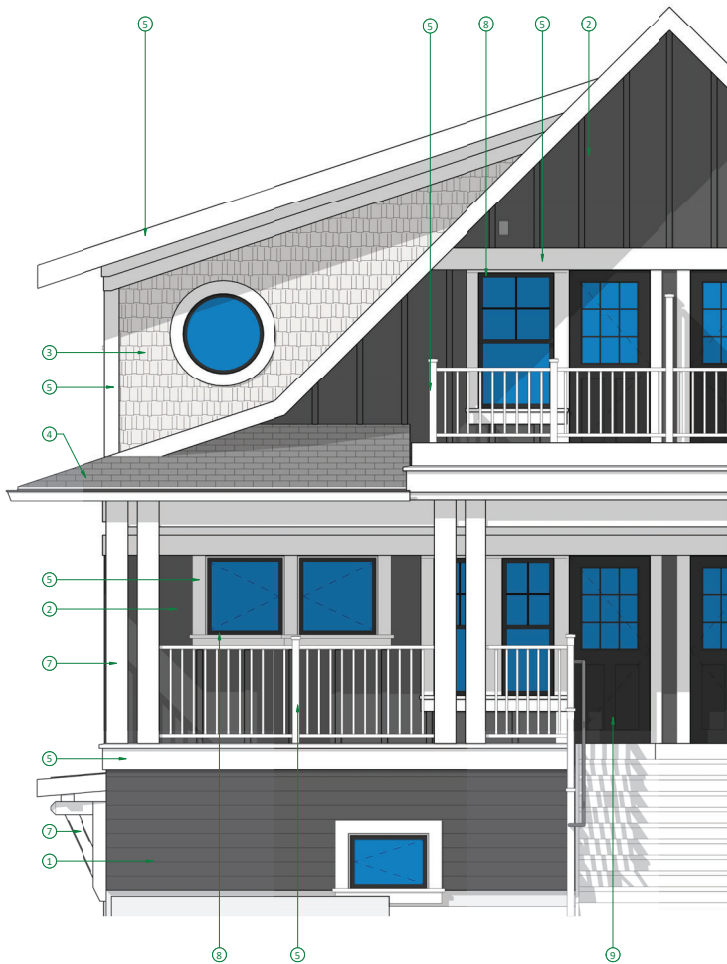

④ ROOFING SHINGLES - LIGHT GREY




③ FIBRE-CEMENT SHINGLES - LIGHT GREY

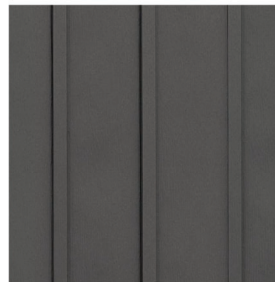

② BOARD & BATTEN - CHARCOAL GREY



① HORIZONTAL SIDING - CHARCOAL GREY

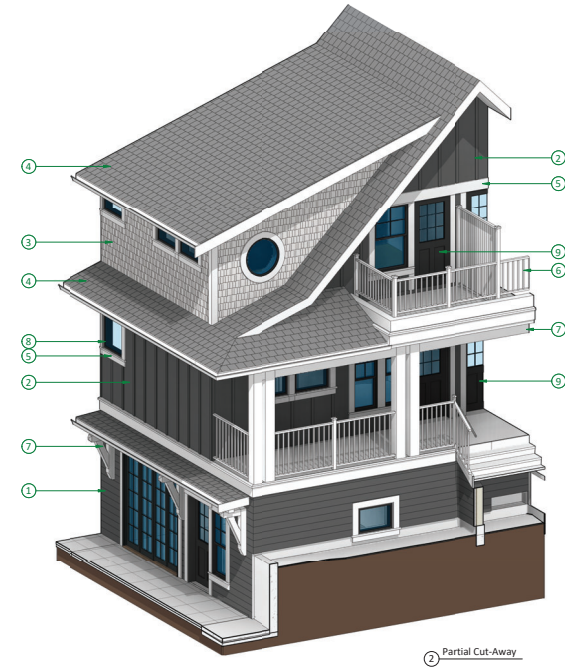

② Partial Cut-Away

- EXTERIOR FINISH LEGEND**
- 1. HORIZONTAL SIDING - CHARCOAL GREY
  - 2. BOARD & BATTEN - CHARCOAL GREY
  - 3. FIBRE-CEMENT SHINGLES - LIGHT GREY
  - 4. ROOFING SHINGLES - LIGHT GRAY
  - 5. PAINTED TRIM - WHITE
  - 6. PREFINISHED ALUMINUM RAILINGS - WHITE
  - 7. PAINTED WOOD POSTS & BEAMS - WHITE
  - 8. BLACK WINDOW FRAMES
  - 9. BLACK DOORS


Christine Lintott  
Architects Inc.



Suite 1 - 864 Queens Avenue, Victoria, BC V8T 1M5  
Telephone: 250.384.1369  
www.lintottarchitect.ca

Issue	Date
FOR DEVELOPMENT PERMIT	2022-02-07

Revision	No.	Description	Date
18	1	RAILING MATERIAL REVISED	2022-05-17

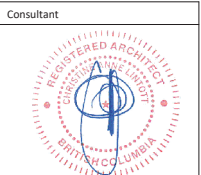

633 Belton Avenue




633 Belton Avenue

Exterior Materials



Date	2022-05-17 10:50:35 AM
Drawn by	CC
Checked by	CL

A3.01

Scale	1 : 25
-------	--------

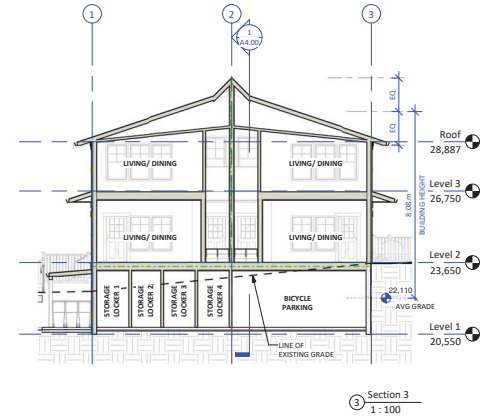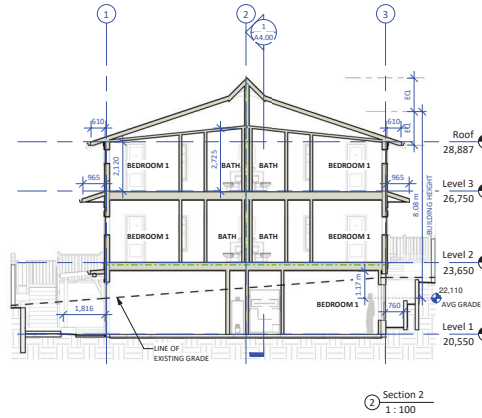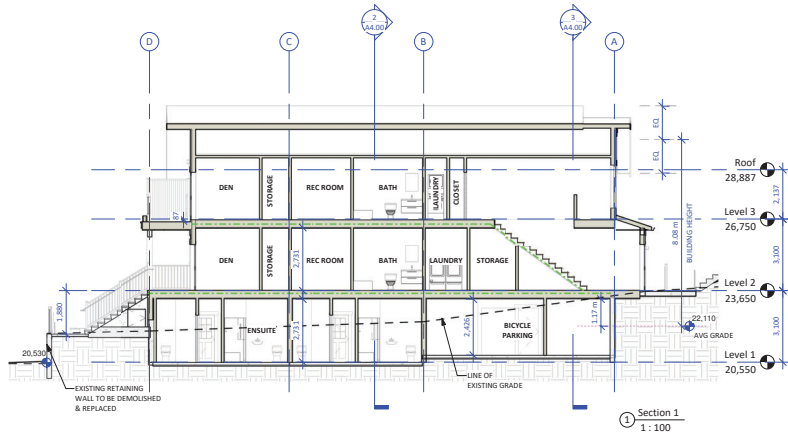


---	---	---	---	---
---	---	---	---	---
---	---	---	---	---
---	---	---	---	---
---	---	---	---	---

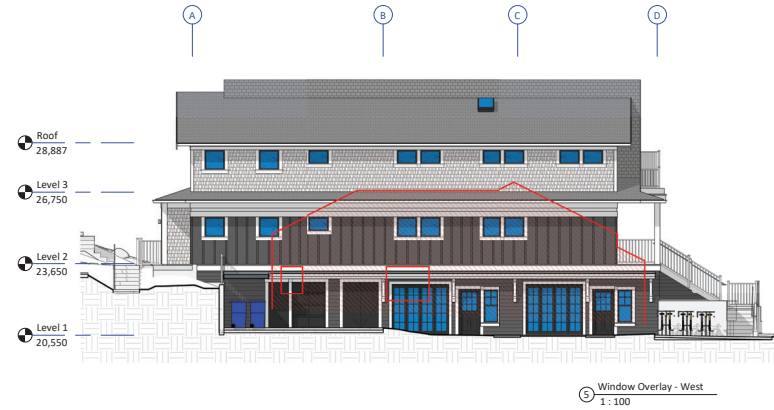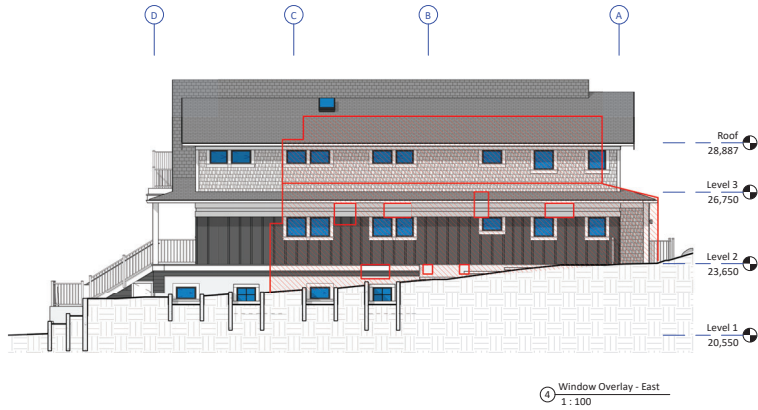

Issue	Date
FOR DEVELOPMENT PERMIT	2022-02-07

No.	Description	Date
1	AVG GRADE RECALCULATED	2022-05-17
2	HEIGHT INCREASED	2022-05-17
3	EXISTING GRADE LINES ADDED	2022-05-17

Consultant

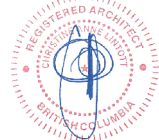

633 Belton Avenue

633 Belton Avenue

Building Sections &  
Window Overlay  
Elevations

Date	2022-05-17 10:50:43 AM
Drawn by	CC
Checked by	CL

A4.00

Scale	As indicated
-------	--------------