ATTACHMENT C

956 HEYWOOD

PROJECT NUMBER: 2101
REISSUED FOR DEVELOPMENT PERMIT- 2023.04.28



Revisions

Received Date:

April 28, 2023

CONTACTS

CLIENT

ARYZE DEVELOPMENTS

1839 FAIRFIELD ROAD,

VICTORIA BC, V8S 1G9

CONT: LUKE MARI

TEL: 250 881 6077

EMAIL: luke@aryze.ca

ARCHITECT COLIN HARPER ARCHITECT

302-666 COOK STREET, VICTORIA, BC, V8V 3Y7 CONT: COLIN HARPER TEL: 778 584 0582

EMAIL: charper@charch.ca

CIVIL MCELHANNEY

500-3960 QUADRA STREET, VICTORIA, BC V8X 4A3 CONT: NATHAN DUNLOP

TEL: 778 746 7417

EMAIL: ndunlop@mcelhanney.com

LANDSCAPE BIOPHILIA COLLECTIVE

1608 CAMOSUN STREET, VICTORIA BC, V8T 3E6 CONT: BIANCA BODLEY TEL: 250 589 8244

EMAIL: bianca@biophiliacollective.ca

DRAWING LIST

A303

A304

A305

A401

A402

ARCHITECTURA	L	CIVIL	
A000	COVER	21-006-CSP	CONCEPTUAL SERVICING
A001	AREA CALCULATIONS		
A002	SPATIAL SEPARATION CALCULATIONS	LANDCAPE	
A003	SHADOW STUDY AND STREETSCAPE	LO	COVER
A101	EXISTING SITE PLAN	L1	LANDSCAPE PLAN
A102	PROPOSED SITE PLAN	L2	LANDSCAPE SECTIONS AND IMAGERY
A201	BASEMENT FLOOR PLAN	L3	TREE REMOVAL & PROTECTION PLAN
A202	LEVEL 1 FLOOR PLAN	L4	TREE PLANTING PLAN
A203	LEVEL 2 FLOOR PLAN	L5	SHRUB PLANTING PLAN
A204	LEVEL 3 FLOOR PLAN	L6	LIGHTING PLAN
A205	LEVEL 4 ROOF PLAN	L7	PRODUCT SPECIFICATIONS
A301	NORTH & SOUTH ELEVATIONS		
A302	EAST & WEST ELEVATIONS	SURVEY	



MATERIAL BOARD

NEIGHBOUR OPENINGS

RENDERINGS

SECTIONS SECTIONS




SITE PLAN

PROJECT NOTES


- ALL DIMENSIONS AND AREAS ARE APPROXIMATE AND AREAS TO BE VERIFIED WITH SURVEY INFORMATION.
- 2. THIS IS NOT A COMPLETE DESIGN AND AS SUCH ANY ACTIONS OR DECISIONS ON PURCHASE OR SALE OF LANDIDEVELOPMENT ARE NOT THE RESPONSIBILITY OF THE ARCHITECT.
- 3. THIS DOCUMENT HAS BEEN DIGITALLY CERTIFIED WITH DIGITAL CERTIFICATE AND ENCRYPTION TECHNOLOGY AUTHORIZED BY THE ARCHITECTURAL INSTITUTE OF BC AND THE ENGINEERS AND GEOSCIENTISTS BC. THE AUTHORITATIVE ORIGINAL HAS SEEN TRANSMITTED TO YOU IN DIGITAL FORM.
- 4. PART 9, 3 STOREY BUILDING PER BCBC 2018.



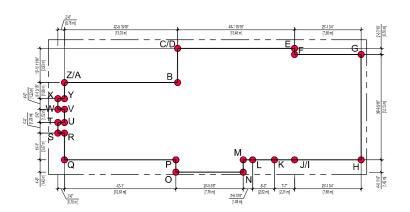


1 AVERAGE GRADE CALCULATION


Z	ONING GRADE CALCULATION				GRADES	GRADES	GRADES			
SR	ADE POIN	ITS (m)		LENGTH (m)	GRADE CALCS		Grade F	Points	Points Existing	Points Existing Proposed
	8.34	В	6.66	13.28	(8.34 + 6.66) ÷ 2 x 13.28m =	99.60	Points A		8.48	8.48 8.34
	6.66	С	6.66	3.68	(6.66 + 6.66) + 2 x 3.68m =	24.51	Points B		8.17	8.17 6.66
	8.05	E	7.56	13.46	(8.05 + 7.56) ÷ 2 x 13.46m =	105.06	Points C		8.05	8.05 6.66
	7.56	F	7.56	0.70	(7.56 + 7.56) + 2 x 0.7m =	5.29	Points D		8.05	8.05 8.05
	7.56	G	7.50	7.66	(7.56 + 7.5) ÷ 2 x 7.66m =	57.68	Points E		7.56	7.56 7.56
	7.50	Н	7.51	12.12	(7.5 + 7.51) ÷ 2 x 12.12m =	90.96	Points F		7.56	7.56 7.56
	7.51	- 1	7.74	7.66	(7.51 + 7.74) ÷ 2 x 7.66m =	58.41	Points G		7.50	7.50 7.67
	6.20	K	6.20	2.31	(6.2 + 6.2) + 2 x 2.31m =	14.32	Points H		7.51	7.51 7.67
	6.20	L	7.97	2.52	(6.2 + 7.97) ÷ 2 x 2.52m =	17.85	Points I		7.74	7.74 7.74
	7.97	М	8.02	1.08	(7.97 + 8.02) ÷ 2 x 1.08m =	8.63	Points J		7.74	7.74 6.20
	8.02	N	8.09	1.42	(8.02 + 8.09) + 2 x 1.42m =	11.44	Points K		7.90	7.90 6.20
ı	8.09	0	8.31	7.76	(8.09 + 8.31) ÷ 2 x 7.76m =	63.63	Points L	8	3.00	3.00 7.97
	8.31	Р	8.25	1.42	(8.31 + 8.25) ÷ 2 x 1.42m =	11.76	Points M	8.0	02	02 8.77
	8.25	Q	8.62	13.08	(8.25 + 8.62) + 2 x 13.08m =	110.33	Points N	8.08	Э	8.09
	8.62	R	8.62	3.20	(8.62 + 8.62) ÷ 2 x 3.2m =	27.58	Points O	8.31		8.31
	8.62	S	8.60	0.76	(8.62 + 8.6) ÷ 2 × 0.76m =	6.54	Points P	8.25		8.25
	8.60	T	8.54	1.22	(8.6 + 8.54) + 2 x 1.22m =	10.46	Points Q	8.69		8.62
	8.54	U	8.52	0.76	(8.54 + 8.52) + 2 x 0.76m =	6.48	Points R	8.62		8.62
	8.52	V	8.50	1.52	(8.52 + 8.5) ÷ 2 x 1.52m =	12.94	Points S	8.60		8.61
	8.50	W	8.52	0.76	(8.5 + 8.52) + 2 x 0.76m =	6.47	Points T	8.54		8.61
	8.52	Х	8.53	1.22	(8.52 + 8.53) ÷ 2 x 1.22m =	10.40	Points U	8.52		8.62
	8.53	Υ	8.51	0.76	(8.53 + 8.51) ÷ 2 x 0.76m =	6.48	Points V	8.50		8.62
	8.51	Z	8.48	1.98	(8.51 + 8.48) ÷ 2 x 1.98m =	16.82	Points W	8.52		8.61
C	TALS			100.33	= 783.64/100.33	783.64	Points X	8.53		8.61
٧	ERAGE GI	RADE				7.81	Points Y	8.51		8.62

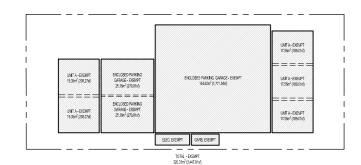


4 BASEMENT FLOOR AREA CALC

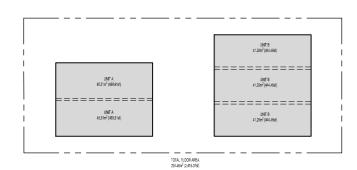




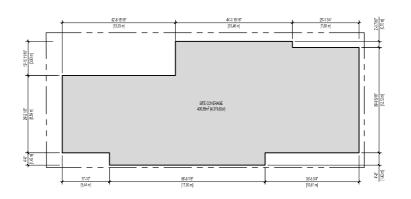




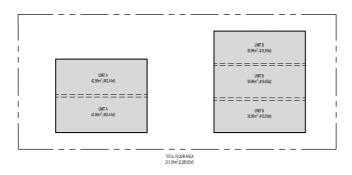




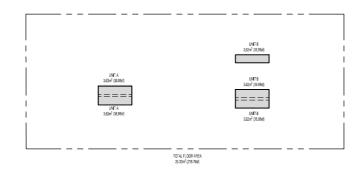

8 LEVEL 4 FLOOR AREA CALC

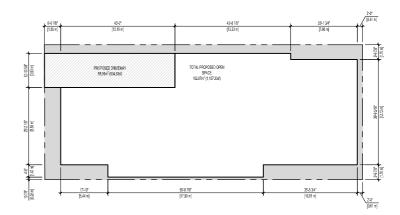

3 OPEN SITE SPACE

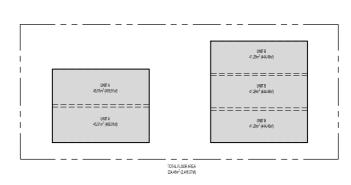

6 LEVEL 2 FLOOR AREA CALC



OWNER/CLIENT: ARYZE DEVELOPMENTS 250,940,3568

		1
Π		
T		
T		
	REISSUED FOR DEVELOPMENT PERMIT	04/28/2023
ı	REISSUED FOR DEVELOPMENT PERMIT	07/28/2022
	ISSUED FOR COORDINATION	03/14/2022
!	ISSUED FOR REVIEW	03/09/2022
	ISSUED FOR DEVELOPMENT PERMIT	09/07/2021
).	REVISION	WDY
RO	JECT NAME	•

956 HEYWOOD


VICTORIA, BC


956 HEYWOOD VICTORIA, BC





AREA CALCULATION

		DRAWING NO:	A001
SCALE:	1:200	REVIEW BY:	CH
PROJECT NO:	2101	DRAWN B1:	KG

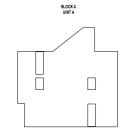


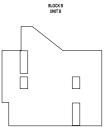

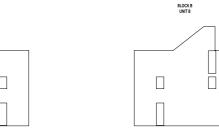

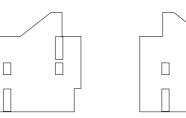



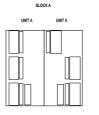





2 NORTH ELEVATION

BLOCK A UNIT A

3 BLOCK A - WEST ELEVATION

4 BLOCK B - WEST ELEVATION

OWNER/CLIENT: ARYZE DEVELOPMENTS 250,940,3568

05	REISSUED FOR DEVELOPMENT PERMIT	04/28/20
04	REISSUED FOR DEVELOPMENT PERMIT	07/28/20
03	ISSUED FOR COORDINATION	03/14/20
02	ISSUED FOR REVIEW	03/09/20
01	ISSUED FOR DEVELOPMENT PERMIT	09/07/20
NO	DEMONIA	MON

956 HEYWOOD

VICTORIA, BC

956 HEYWOOD VICTORIA, BC


PROJECT NAME




SPATIAL SEPARATION CALCULATION

		DRAWING NO:	Δ002
LE:	1:200	REVIEW BY:	CH
JECT NO:	2101	DRAWN BY:	KG




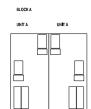



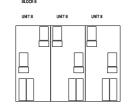


5 BLOCK B - EAST ELEVATION

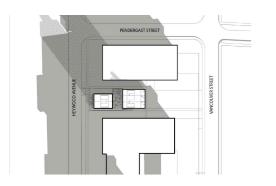

DECEMBER 21 - 9:30AM



DECEMBER 21 - 12:00PM

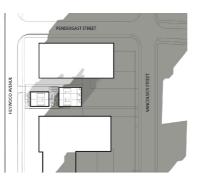


DECEMBER 21 - 3:00PM




JUNE 21 - 7:00AM



JUNE 21 - 12:00PM

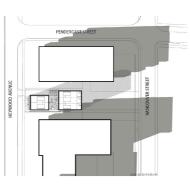

JUNE 21 - 6:00PM

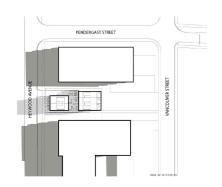

MARCH / SEPTEMBER 21 - 7:30AM



MARCH / SEPTEMBER 21 - 12:00PM



MARCH / SEPTEMBER 21 - 4:30 PM









OWNER/CLIENT: ARYZE DEVELOPMENTS

		_
		_
05	REISSUED FOR DEVELOPMENT PERMIT	04
04	REISSUED FOR DEVELOPMENT PERMIT	07
03	ISSUED FOR COORDINATION	03
02	ISSUED FOR REVIEW	03
01	ISSUED FOR DEVELOPMENT PERMIT	0
NO.	REVISION	

956 HEYWOOD

VICTORIA, BC


PROJECT ADDRESS: 956 HEYWOOD VICTORIA, BC



SHADOW STUDY

& STREETSCAPE

DRAWING NO: A003

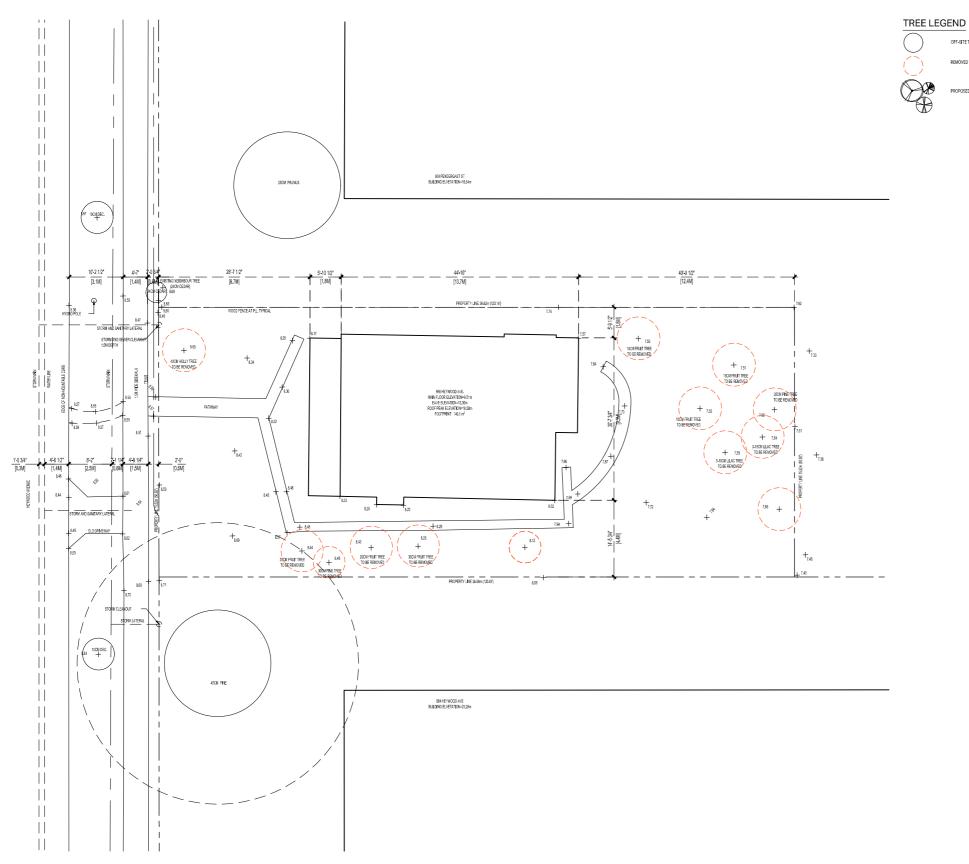

1 EXISTING SITE PLAN

Copyright reserved. All parts of this drawing are the exclusive property of Colin Harper Architect and shall not be used without the Architect's written permission. All climensions shall be verified by the Contractor before commencing work.

SEAL



NORTH ARROW



NOTES

THE DOCUMENT HAS BEEN LOGFILLY CERTIFIED WITH DISTRIA. CERTIFICATE AND ENCYPTION TECHNICATOR AT INTERESTS AND RECOCCUPIED THE RESTRICT OF EARLY DISTRICT SHEET AND RECOCCUPIED TO THE AUTHORITATION CORNICAL HAS BEEN CON-TRUSHED THE DISTRICT AT CORN. ANY PRINTED VISION CON-TRUSHED TO THE AUTHORITATION AND PRINTED VISION CON-TRUSHED TO THE AUTHORITATION OF THE PROPERSTORM AND STEED AND THE AUTHORITATION OF THE AUTHORITATION OF THE AUTHORITY OF THE AUTHORITATION OF THE AUTHORITY OF THE AUTHORI

OWNER/CLIENT: ARYZE DEVELOPMENTS 250,940,3568

5	REISSUED FOR DEVELOPMENT PERMIT	04/28/2023
1	REISSUED FOR DEVELOPMENT PERMIT	07/28/2022
3	ISSUED FOR COORDINATION	03/14/2022
2	ISSUED FOR REVIEW	03/09/2022
	ISSUED FOR DEVELOPMENT PERMIT	09/07/2021
Э.	REVISION	WDY
RO	JECT NAME	

956 HEYWOOD

VICTORIA, BC

PROJECT ADDRESS: 956 HEYWOOD VICTORIA, BC




302-666 Cook Street, Victoria, BC, V8V 3

DRAWING TITLE:

EXISTING SITE PLAN

			A 1 O 1
SCALE:	1:100	REVIEW BY:	CH
PROJECT NO:	2101	DRAWN BY:	KG

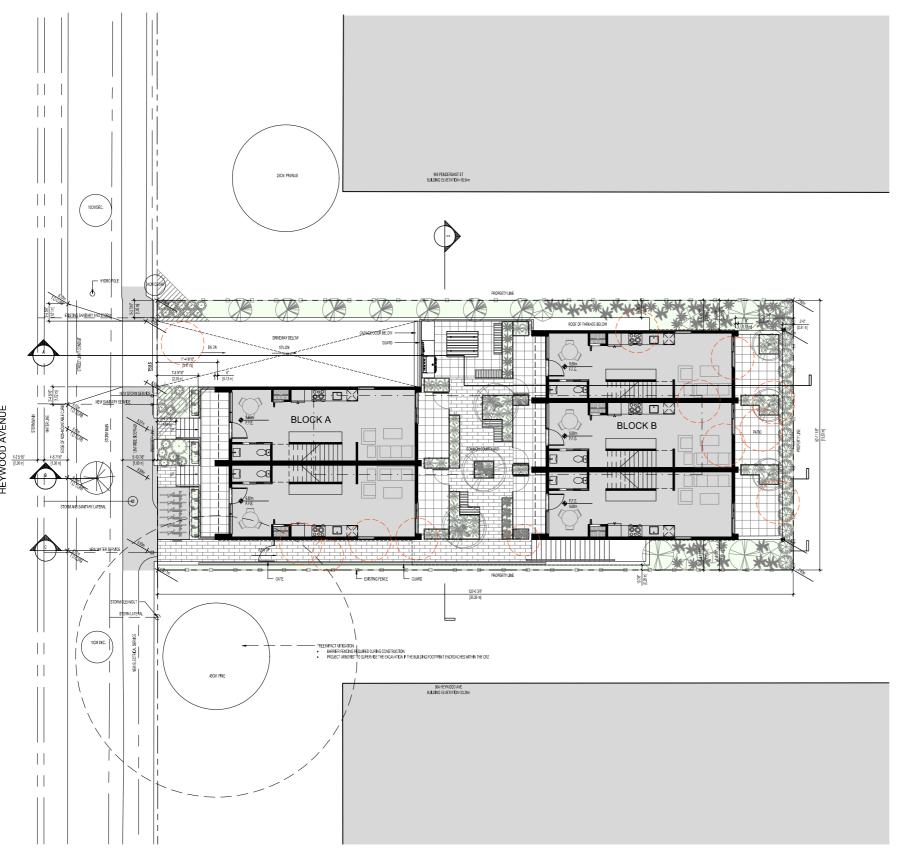

TREE LEGEND



GENERAL LEGEND

PROPOSED GRADE

DOLOM PROPOSED GRADE

PROJECT INFORMATION TABLE - 956 HEYWOOD

PR. #: 2101 DATE: 28-Apr-23

PROPERTY INFORMATION

 PROJECT ADDRESS
 956 HEYWOOD AVENUE, VICTORIA BC

 LEGAL DESCRIPTION
 LOT 36 OF LOT 1694, VICTORIA, PLAN 24

 ZONING
 R3-MM2

 DEVELOPMENT PERMIT AREA
 DPA 16 - GENERAL FORM AND CHARACTER

Z	DNING DATA	ALLO	WED/RE	QUIRED		PROP	OSED			VARIA	NCE		
	SITE AREA	920	m^2	9,902.79	sq.ft	568	m ²	6,114	sq.ft	N/A			
	TOTAL FLOOR AREA	681.6	m^2	7,336.67	sq.ft	681.2	m^2	7,332	sq.ft	N/A			
	COMMERCIAL FLOOR AREA	N/A											
	FLOOR SPACE RATIO	1.2				1.20				N/A			
	SITE COVERAGE %	40%				72%				32%			
	OPEN SITE SPACE %	30%				18%				12%			
	OPEN SITE SPACE AND DRIVEWAY %	50%				28%				22%			
	HEIGHT OF BUILDING	12	m	39.37	ft	13.57	m	44.52	ft	1.6	m	5.151	1
	HEIGHT OF ROOF	N/A				11.08	m	36.35	ft	N/A			
	NUMBER OF STOREYS	4				4				N/A			
	VEHICLE PARKING	8				6				2			
	LONG TERM BICYCLE PARKING	7				10				N/A			
	SHORT TERM BICYCLE PARKING	6				6				N/A			
В	JILDING SETBACKS	ALLO	VED/RE	QUIRED		PROP	OSED			VARIA	NCE		
	FRONT YARD	10.50	m	34.4	ft	3.47	m	11.4	ft	7.03	m	23.1	1
	FRONT YARD (PATIO)	N/A				2.35	m	7.7	ft	N/A			
	FRONT YARD (STAIR)	N/A				1.08	m	3.5	ft	N/A			
	REAR YARD	6.79	m	22.3	ft	3.32	m	10.9	ft	3.47	m	11.4	1
	REAR YARD (PATIO)	N/A				0.61	m	2.0	ft	N/A			
	SIDE YARD (NORTH) LEVEL 2-ROOF	6.79	m	22.3	ft	1.75	m	5.7	ft	5.04	m	16.5	1
	SIDE YARD (NORTH) BASEMENT	6.79	m	22.3	ft	1.00	m	3.3	ft	5.79	m	19.0	1
	SIDE YARD (SOUTH) LEVEL 2-ROOF	6.79	m	22.3	ft	1.75	m	5.7	ft	5.04	m	16.5	1
	SIDE YARD (SOUTH) BASEMENT	6.79	m	22.3	ft	0.28	m	0.9	ft	6.51	m	21.3	1
	COMBINED SIDE YARDS	N/A											
	FRONT YARD OPEN SPACE	10.50	m	34.4	ft	3.47	m	11.4	ft	7.03	m	23.1	1

FLOOR AREA (EXCLUDING BASEMENT)

Copyright reserved. All parts of this drawing are the exclusive property of Cofin Harper Architect and shall not be used without the Architect's written permission. All dimensions shall be verified by th Contractor before commencing work.

SEAL



NORTH ARROW



TES

- THIS DOCUMENT MAS SEEN INGTIFLY CERTIFIED WITH DIGITAL CERTIFICATION CONTROL CERTIFICATION CONTROL CERTIFICATION CONTROL CERTIFICATION CONTROL CERTIFICATION CERTIFICATION
- ING LAYOUTS.

OWNER/CLIENT: ARYZE DEVELOPMENTS 250,940,3568

05	REISSUED FOR DEVELOPMENT PERMIT	04/28/2
04	REISSUED FOR DEVELOPMENT PERMIT	07/28/2
03	ISSUED FOR COORDINATION	03/14/2
02	ISSUED FOR REVIEW	03/09/2
01	ISSUED FOR DEVELOPMENT PERMIT	09/07/2
NO.	REVISION	WDA
PRO	JECT NAME	

956 HEYWOOD

VICTORIA, BC

PROJECT ADDRESS: 956 HEYWOOD VICTORIA, BC




302-666 Cook Street, Victoria, BC, V8V 3

PROPOSED SITE PLAN

PROJECT NO:	2101	DRAWN BY:	KG
SCALE:	1:100	REVIEW BY:	СН
		DRAWING NO:	A102



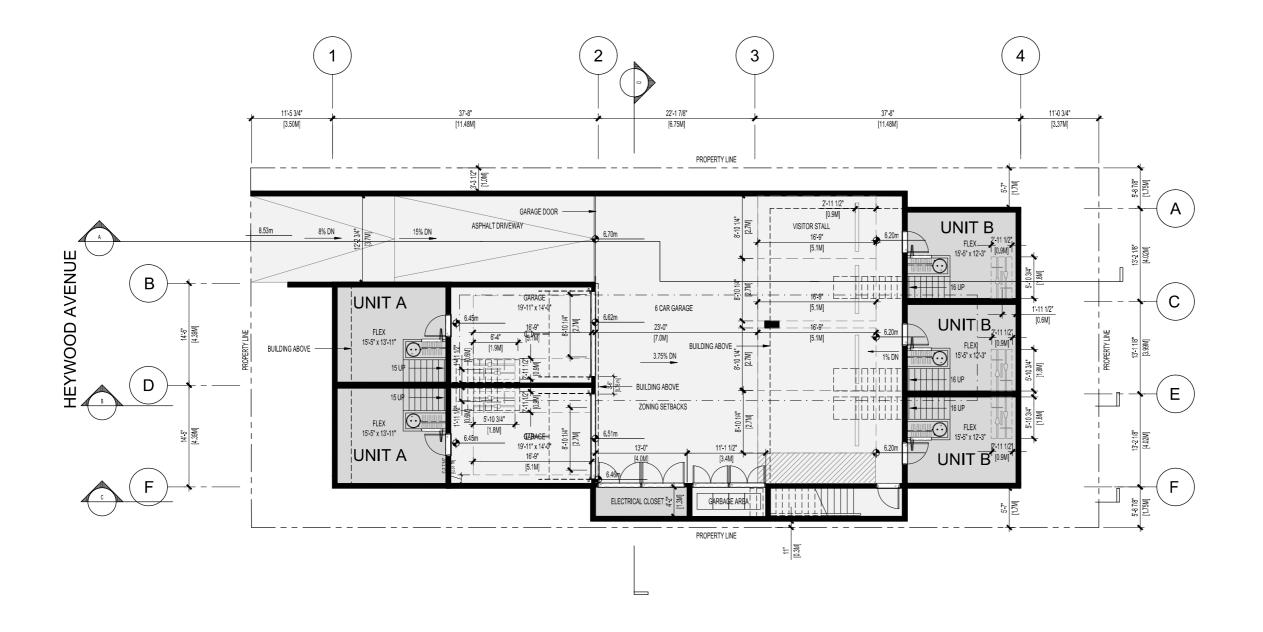



Copyright reserved. All parts of this drawing are the exclusive property of Colin Harper Architect and shall not be used without th Architect's written permission. All dimensions shall be verified by t Contractor before commencing work.

SEAL



NORTH ARROW

NOTES

1 THIS DOCUMENT HAS BEEN GOTALLY CERTIFIED WITH GOTAL CERTIFICATE AND EXPERTION TECHNOLOGY AUTHORIZED BY THE AND HEIGHT CONTROLLING THE CONTROLLING AND THE AND EXPERIMENT CHARGESTERN OF THE AND HEIGHT AND HEIGHT AND HEIGHT CONTROLLING THE AND HEIGHT CONTROLLING AND HEIGHT AND HEIGHT CONTROLLING BY THE ADDITION OF AND HEIGHT AND HEIGHT AND HEIGHT CONTROLLING BY THE ADDITION CERTIFICATE OR WHEN HEIGHT CONTROLLING AND HEIGHT AND HEIGHT

OWNER/CLIENT: ARYZE DEVELOPMENTS 250,940,3568

05	REISSUED FOR DEVELOPMENT PERMIT	04/28/20
04	REISSUED FOR DEVELOPMENT PERMIT	07/28/20
03	ISSUED FOR COORDINATION	03/14/20
02	ISSUED FOR REVIEW	03/09/20
01	ISSUED FOR DEVELOPMENT PERMIT	09/07/20
NO.	REVISION	WDY
PRC	JECT NAME	

956 HEYWOOD

VICTORIA, BC

PROJECT ADDRESS: 956 HEYWOOD VICTORIA, BC




302-666 Cook Street, Victoria, BC, V8V 3 778-584-0582 | info@charch.ca | charch

DRAWING TITLE:

BASEMENT

			4004
SCALE:	1:75	REVIEW BY:	СН
PROJECT NO:	2101	DRAWN BY:	KG

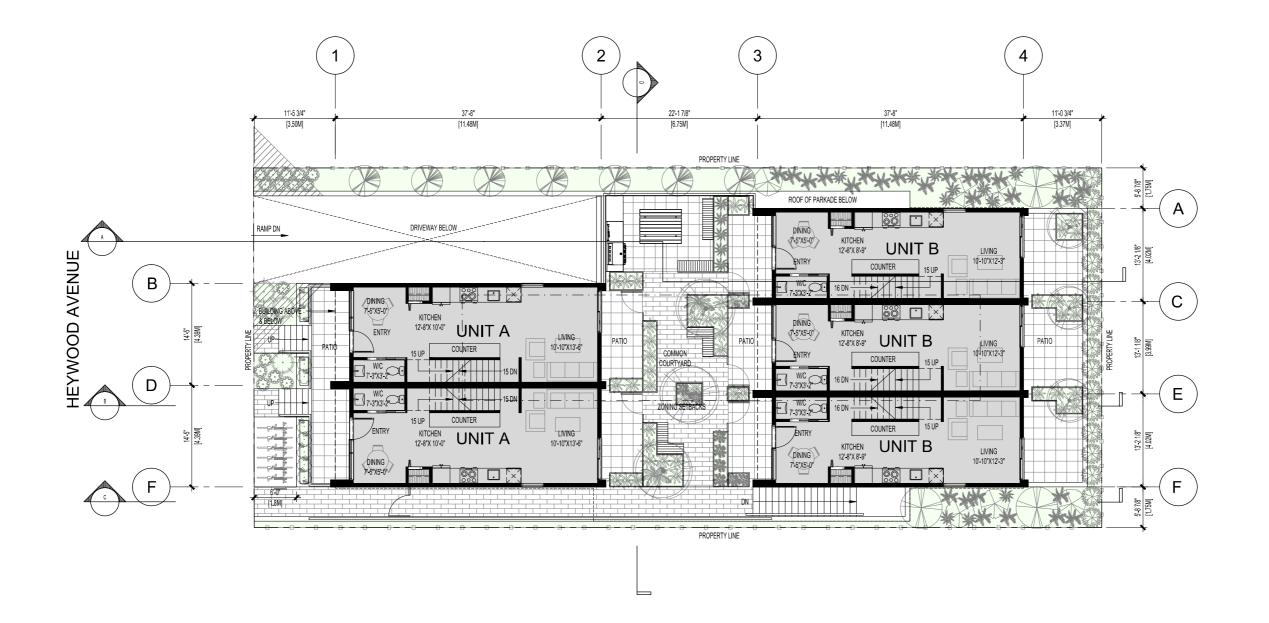



Copyright reserved. All parts of this drawing are the exclusive property of Colin Harper Architect and shall not be used without the Architect's written permission. All dimensions shall be verified by the Contractor before commencing work.

SEAL



NORTH ARROW

NOTES

 THIS DOCUMENT HAS BERNIGOTIALLY CERTIFICATE WITH DIGITAL CERTIFICATE AND ENCENTRON THE CHOROLOGY AUTHORIZED BY THE ARCHITECTURA LIBRITUTE OF CHAIN THE DIGITAL HAS BEEN DOCUMENTED TO YOUR MODIL. FORM ANY BAYRID SHESD OF THE ARCHITECTURA SHAPPING AND THE PROPERTY OF THE HAZ BAYRID OF REVIEW OF THE PROPERTY OF THE ARCHITECTURA AND AND DIGITAL CERTIFICATE OR WHEN POWER PROW THE BIGHTALLY CERTIFICATE OR WHEN PROPERTY OF THE ARCHITECTURA BIGHTALLY CERTIFICATE OR WHEN PROPERTY OF THE ARCHITECTURA.

OWNER/CLIENT: ARYZE DEVELOPMENTS 250,940,3568

05	REISSUED FOR DEVELOPMENT PERMIT	04/28/20
04	REISSUED FOR DEVELOPMENT PERMIT	07/28/20
03	ISSUED FOR COORDINATION	03/14/20
02	ISSUED FOR REVIEW	03/09/20
01	ISSUED FOR DEVELOPMENT PERMIT	09/07/20
NO.	REVISION	WDY
DDO	ICCT NAME	

956 HEYWOOD

VICTORIA, BC

956 HEYWOOD VICTORIA, BC




302-666 Cook Street, Victoria, BC, V8V

7/8-584-0

LEVEL 1

Ľ				
٦,	SCALE:	1:75	REVIEW BY:	CH
F	PROJECT NO:	2101	DRAWN BY:	KG

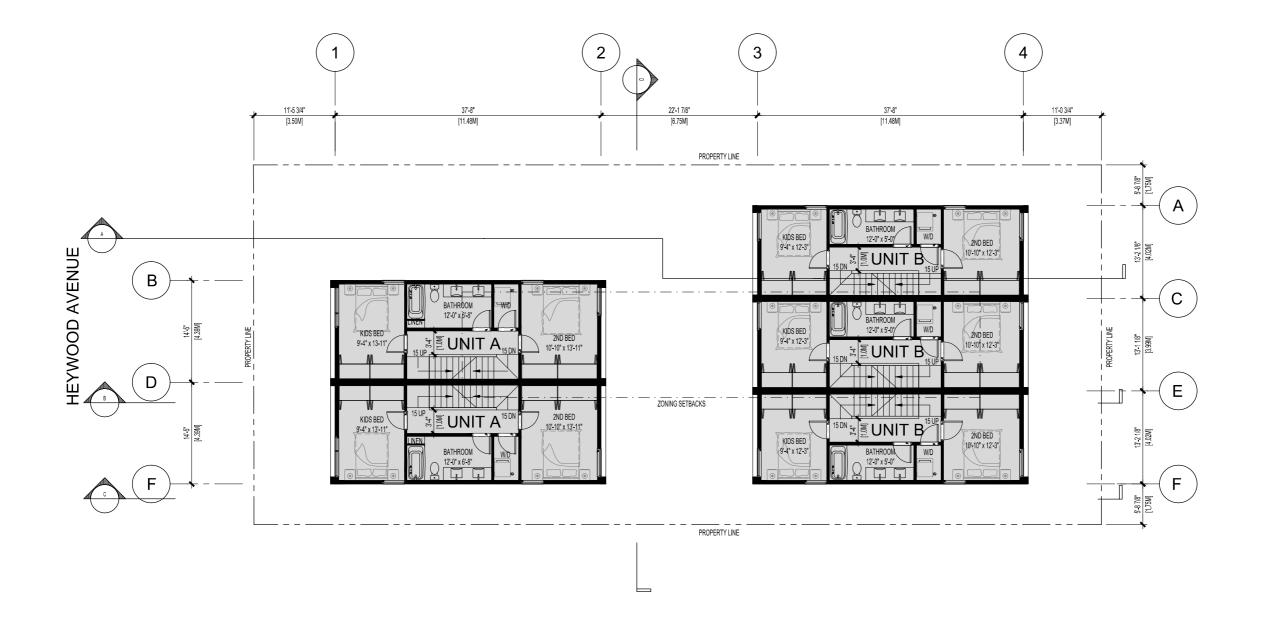



Copyright reserved. All parts of this drawing are the exclusive property of Coll happer Architect and shall not be used without the Architect's written permission. All dimensions shall be verified by th Contractor before commencing work.

SEAL



NORTH ARROW

NOTES

 THIS DOCUMEN HAS BEEN LOGFALLY CERTIFIED WITH DEFINAL CERTIFICATE AND ENCRYPTION TECHNOLOGY AUTHORIZED BY THE AROHITECTURAL INSTITUTE OF EX AND THE INSINEERS AND EGSSCHEINSTSS. THE AUTHORITHY CORRAIL HAS SEEN THAN BEEN TO YOU IN LOGTAL FORM ANY PRINTED VISISION OF BE RELEGIBLED AS A TRIEL COPY OF CORRAIL. WHEN SUPPLED BY THE AROHITECT, BEARING MAKES OF THE MODESSIONAL, SEA, AND LOGFAL CERTIFICATE, OR WHEN HAVING THE MODESSIONAL, SEA,

OWNER/CLIENT: ARYZE DEVELOPMENTS 250.940.3568

05	REISSUED FOR DEVELOPMENT PERMIT	04/28/20
04	REISSUED FOR DEVELOPMENT PERMIT	07/28/20
03	ISSUED FOR COORDINATION	03/14/20
02	ISSUED FOR REVIEW	03/09/20
01	ISSUED FOR DEVELOPMENT PERMIT	09/07/20
NO.	REVISION	M/D/Y
PRO	UECT NAME	•

956 HEYWOOD

VICTORIA, BC

956 HEYWOOD VICTORIA, BC




302-666 Cook Street, Victoria, BC, V8V

//8-584-0582|info

LEVEL 2

			4000
SCALE:	1:75	REVIEW BY:	CH
PROJECT NO:	2101	DRAWN BY:	KG

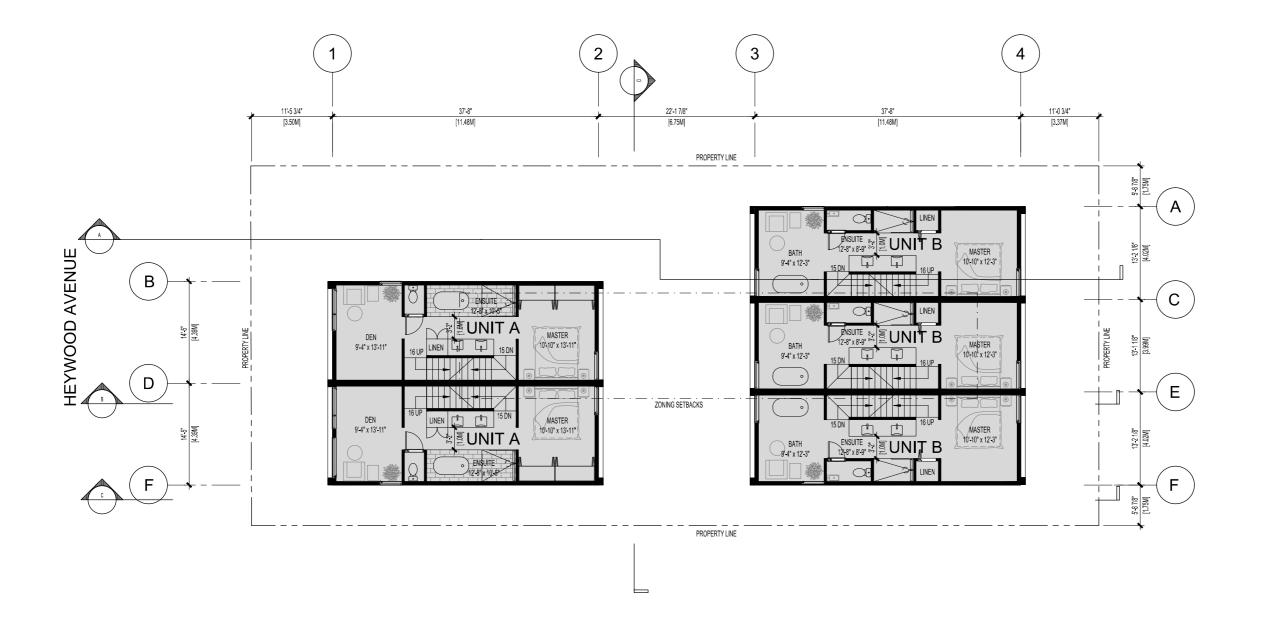



Copyright reserved. All parts of this drawing are the exclusive property of Colin Harper Architect and shall not be used without th Architect's written permission. All dimensions shall be verified by t Contractor before commencing work.

SEAL



NORTH ARROW

NOTES

1 THIS DOCUMENT HAS BEEN GOTALLY CERTIFIED WITH DOCTAL CERTIFICATE AND EXPERTION TECHNOLOGY AITHORDERS IT THE ARCHITECTURAL INSTITUTE OF ECA AND THE EXPERTISHES AND CRESIDENTISES THE AITHORDERS OF MORRAL HAS RESIDUON TRANSMITTED TO OUR MORRAL FOR ANY PARTIES HER SUBJICAN THE AIR CONTICT OF EXPERIMENTAL OF THE PROPERSON OF A BY THE ARCHITECT BEARDING MARKED OF THE PROPERSON AND BY THE ARCHITECT BEARDING MARKED ON THE PROPERSON AND BY THE ARCHITECT BY AND AIR CANNEL OF THE PROPERSON OF THE AND DIGITAL CERTIFICATE ON WHICH PRIVILED RAY THE DIGITALLY CERTIFICATE ON WHICH PROVIDED BY THE ARCHITECT BY THE PROPERSON OF THE PROVIDED BY THE ARCHITECT OF THE PROPERSON OF THE PROVIDED BY THE ARCHITECT THE PROPERSON OF THE PROVIDED BY THE ARCHITECT THE PROPERSON OF THE PROPERSON OF THE ARCHITECT THE PROPERSON OF THE PROPERSON OF THE PROPERSON OF THE ARCHITECT THE PROPERSON OF THE PROPERSON OF THE PROPERSON OF THE PROPERSON OF THE THE PROPERSON OF THE PR

OWNER/CLIENT: ARYZE DEVELOPMENTS 250,940,3568

05	REISSUED FOR DEVELOPMENT PERMIT	04/28/20
04	REISSUED FOR DEVELOPMENT PERMIT	07/28/20
03	ISSUED FOR COORDINATION	03/14/20
02	ISSUED FOR REVIEW	03/09/20:
01	ISSUED FOR DEVELOPMENT PERMIT	09/07/20
NO.	REVISION	WDY
PRC	JECT NAME	

956 HEYWOOD

VICTORIA, BC

956 HEYWOOD VICTORIA, BC




302-666 Cook Street, Victoria, BC, V8V 3

778-584-0582 | info@charch.ca | charch

DRAWING TITLE:

LEVEL 3

PROJECT NO: 2101 DRAWN BY: KG SCALE: 1:75 REVIEW BY: CH	۸4
PROJECT NO: 2101 DRAWN BY: KG	

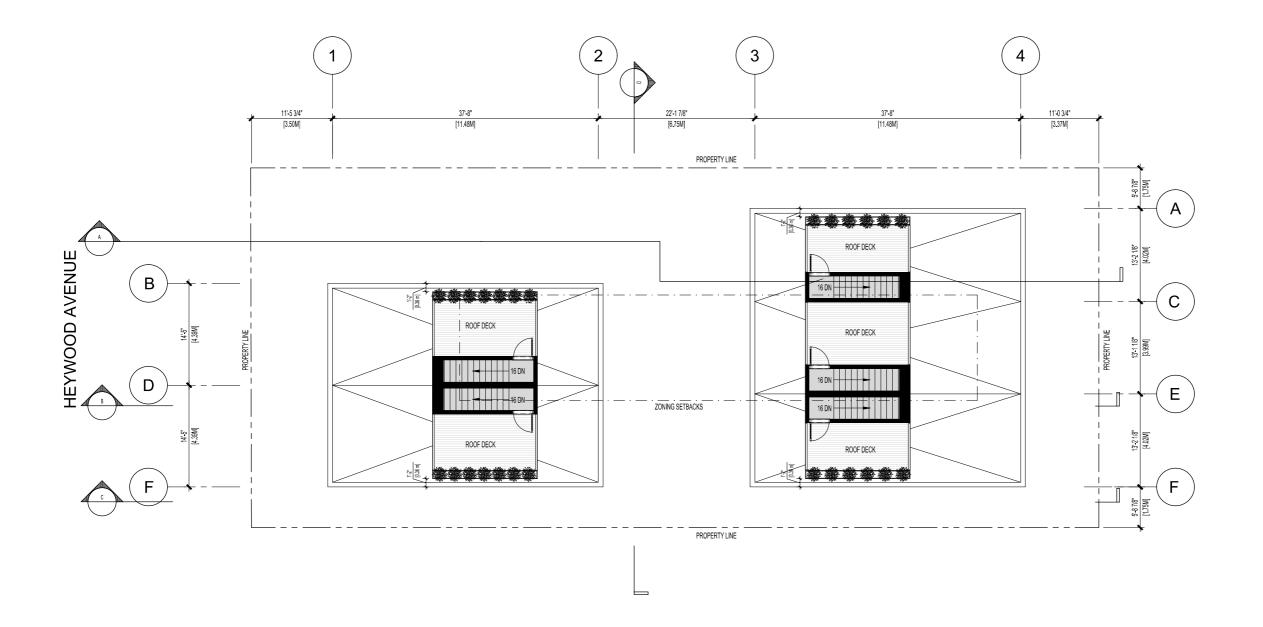

LEVEL 4 / ROOF PLAN

Copyright reserved. All parts of this drawing are the exclusive property of Colin Harper Architect and shall not be used without the Architect's written permission. All dimensions shall be verified by the Contractor before commencing work.

SEAL



NOR IT ARROW

NOTES

1. THIS DOCUMENT HAS BEEN GOTFALLY CESTIFIED WITH DIGITAL CERTIFICATE AND MONEMPHISM TECHNOLOGY AUTHORIZED BY THE ARCHITECTURAL INSTITUTE OF EC. AND THE BURKERS AND CESSIONETTES THE AUTHORIZED AND ANY PARTIES VERSION OF THE ARCHITECTURAL CONTRACTOR ANY PARTIES VERSION OF THE ARCHITECTURAL CONTRACTOR ANY PARTIES VERSION OF THE ARCHITECTURAL CONTRACTOR AND ANY PARTIES VERSION OF THE ARCHITECTURAL CONTRACTOR OF THE PROPERSION OF

OWNER/CLIENT: ARYZE DEVELOPMENTS 250,940,3568

_		
_		
_		
05	REISSUED FOR DEVELOPMENT PERMIT	04/28/2023
04	REISSUED FOR DEVELOPMENT PERMIT	07/28/2022
03	ISSUED FOR COORDINATION	03/14/2022
02	ISSUED FOR REVIEW	03/09/2022
01	ISSUED FOR DEVELOPMENT PERMIT	09/07/202
NO.	REVISION	WDY

956 HEYWOOD

VICTORIA, BC

PROJECT ADDRESS: 956 HEYWOOD VICTORIA, BC




302-666 Cook Street, Victoria, BC, V8V 31

LEVEL 4 / ROOF PLAN

DJECT ND: 2101 DRAWN BY: KG

DRAWING NO: A205

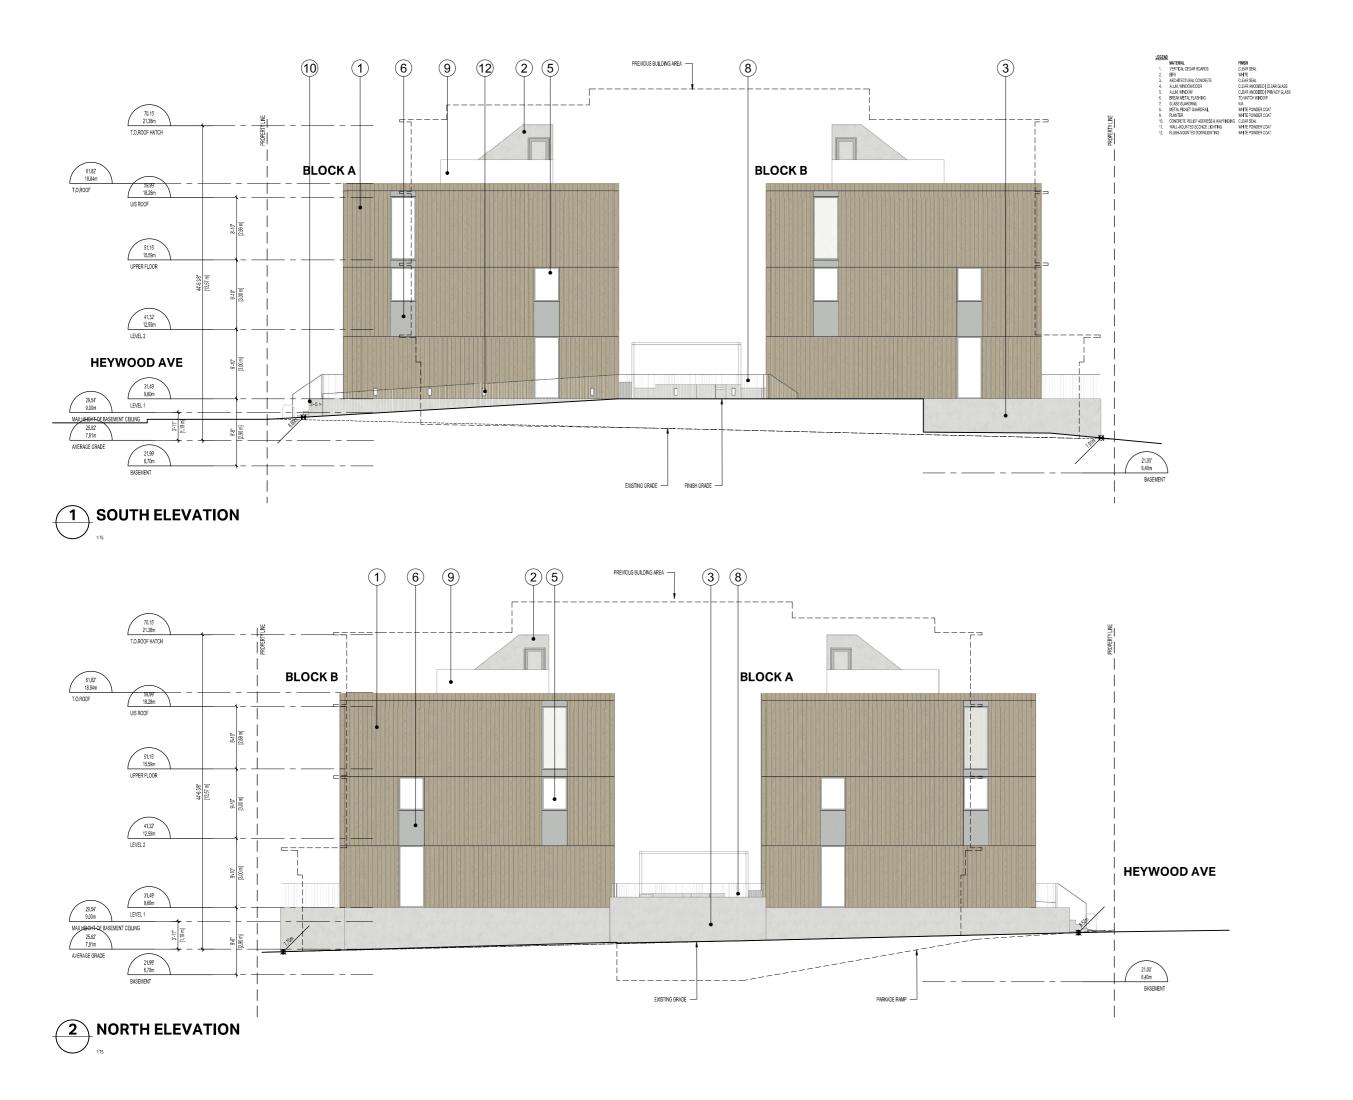

Copyright reserved. All parts of this drawing are the exclusive property of Colin Harper Architect and shall not be used without the Architect's written permission. All dimensions shall be verified by til Contractor before commencing work.

SEAL



NORTH ARROW

IOTES

 THIS DOCUMENT HAS BEEN INGERIALY CERTIFIED WITH DISTRIAL CERTIFICATE AND ENCRYPTION TECHNOLOGY AUTHORIZED BY THE ACHITECTURAL INSTITUTE OF BC AND THE SINKERS AND CESCISIENTS SEE THE AUTHORITH OR GRINAL HAS BEEN THE ACHITECT IN BUILDING THE FORM ANY PRINTED WHISH OF THE ACHITECT REPRINTED HIS OF THE PROPESSIONAL SEA AND INDETECT SERVING MARKET OF THE PROPESSIONAL SEA AND INDETECT SERVING MARKET OR WHEN PRINTED FROM THE DISTRIAL PRINTED ELECTRONIC THE PROVISION THE ACHITECT THE PRINTED THE PROVISION OF THE ACHITECT THE PRINTED THE PROVISION OF THE ACHITECT THE PRINTED THE PROVISION OF THE PROVISION OF THE ACHITECT THE PRINTED THE PRINTED THE PROVISION OF THE PROVISION OF THE PRINTED THE PROVISION OF THE PRINTED THE PRINTED THE PRINTED THE PROVISION OF THE PRINTED THE PRINTED THE PROVISION OF THE PRINTED THE

OWNER/CLIENT: ARYZE DEVELOPMENTS 250,940,3568

04	REISSUED FOR DEVELOPMENT PERMIT	04/28/202
03	REISSUED FOR DEVELOPMENT PERMIT	07/28/202
02	ISSUED FOR REVIEW	03/09/202
01	ISSUED FOR DEVELOPMENT PERMIT	09/07/202
NO.	REVISION	WD/Y
PROJEC	CT NAME	

956 HEYWOOD

VICTORIA, BC

PROJECT ADDRESS: 956 HEYWOOD VICTORIA, BC





302-666 Cook Street, Victoria, BC, V8V 3\778-584-0582 | info@charch.ca | charch.c


DRAWING TITLE:

ELEVATIONS

SCALE:	1:75	REVIEW BY:	CH
PROJECT NO:	2101	DRAWN BY:	CH

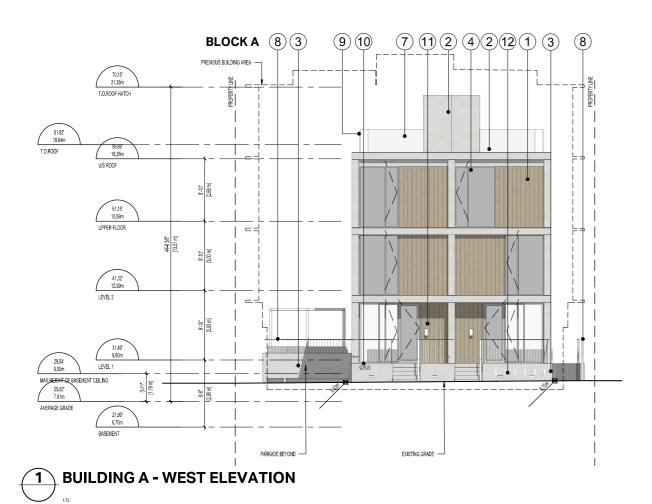

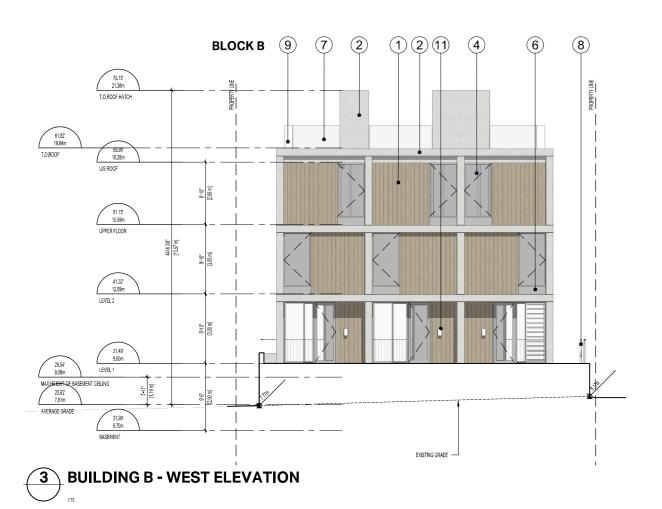

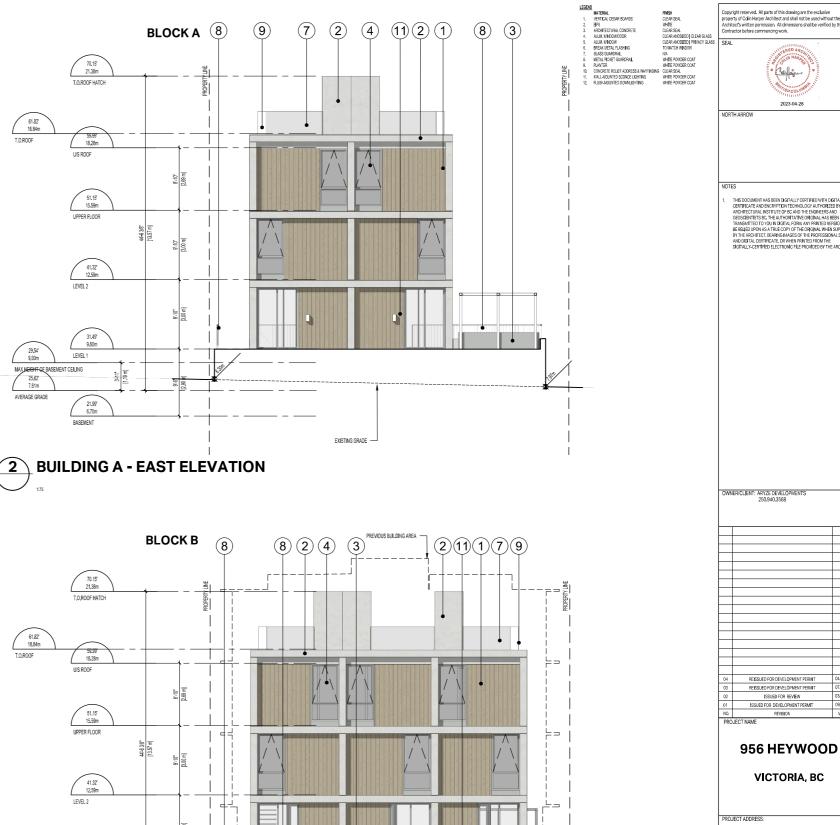

31,49' 9,60m

21.99' 6.70m

4 BUILDING B - EAST ELEVATION

BASEMENT

MAX HEIGHT OF BASEMENT CEILING 25.62' 7.81m PROJECT ADDRESS.

956 HEYWOOD VICTORIA, BC

302-666 Cook Street, Victoria, BC, V8V 3Y7 778-584-0582 | info@charch.ca | charch.ca

A302





CONCRETE RELIEF ADDRESS & WAYFINDING

WALL-MOUNTED SCONCE LIGHTING

FLUSH-MOUNTED DOWNLIGHTING

2.

3.

5.

6. 7.

8.

11.


12.

13.

14.

PAVERS

FENCE

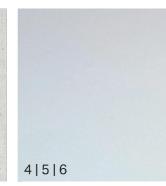

WHITE POWDER COAT **CLEAR SEAL**

WHITE POWDER COAT WHITE POWDER COAT

PER LANDSCAPE

EXISTING

	250.940.3568	
_		
_		
_		
-		_
_		-
-		-
+		
-		
+		_
+		
04	REISSUED FOR DEVELOPMENT PERMIT	04/28/
03	REISSUED FOR DEVELOPMENT PERMIT	07/28/
02	ISSUED FOR REVIEW	03/09/
01	ISSUED FOR DEVELOPMENT PERMIT	09/07/
NO.	REVISION	WDA

OWNER/CLIENT: ARYZE DEVELOPMENTS


956 HEYWOOD

VICTORIA, BC

956 HEYWOOD VICTORIA, BC



MATERIAL BOARD

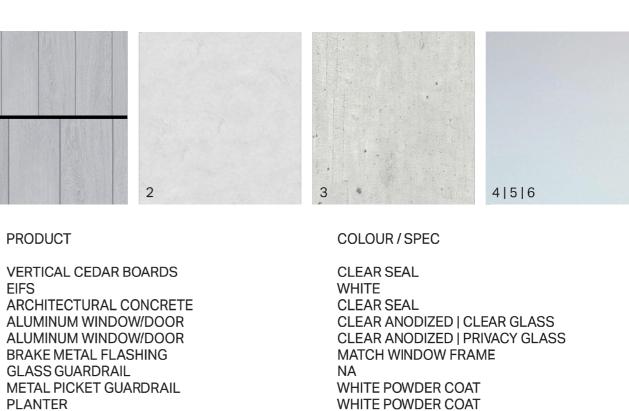





Copyright reserved. All parts of this drawing are the exclusive property of Colin Harper Architect and shall not be used without th Architect's written permission. All dimensions shall be verified by t Contractor before commencing work.

SEAL



NORTH ARROW

NOTE

THE DOCUMENT HAS BERNINGTHAL YESTIHED WITH DIGITAL CERTIFICATE MAD REVERTIBLY THE MOOKEN HAT PROTECTIVE BY THE ARCHITECTURAL INSTITUTE OF EO AND THE ENGINEERS AND GEOSCIBINITIES FOR HAIT THE STATE OF GRINAL HAS BEEN THAN SOMETHED TO YOU IN LOGATA, JOHN, AM IN PRINTED VERSION ON TRANSPIRITED TO YOU IN LOGATA, JOHN, AM IN PRINTED VERSION ON THE RELIES WHEN A THILE COPY OF THE PROMISSIONAL SOAL OF THE PROFESSIONAL SOAL O

OWNER/CLIENT: ARYZE DEVELOPMENTS 250.940.3568

04	REISSUED FOR DEVELOPMENT PERMIT	04/28/20
03	REISSUED FOR DEVELOPMENT PERMIT	07/28/20
02	ISSUED FOR REVIEW	03/09/20
01	ISSUED FOR DEVELOPMENT PERMIT	09/07/20
NO.	REVISION	WDY
PRC	JECT NAME	

956 HEYWOOD

VICTORIA, BC

O IECT ADDRESS

956 HEYWOOD VICTORIA, BC



302-666 Cook Street, Victoria, BC, V8V 3

DRAWING TITLE

RENDERINGS

		DDAWING NO-	V 30
SCALE:	NTS	REVIEW BY:	CH
PROJECT NO:	2101	DRAWN BY:	KG



Copyright reserved. All parts of this drawing are the exclusive property of Colin Harper Architect and shall not be used without th Architect's written permission. All dimensions shall be verified by Contractor before commencing work.

SE



NOR I'M AKKOW

NOTES

THIS DOUMENT HAS BEEN IGRIFALLY CERTIFIED WITH DISTIN. CERTIFICATE AND EXEMPTION TECHNICAL MITHORITISATE OF THE ARCHITECTURAL INSTITUTE OF BC AND THE DISCRETS AND CECKSICHIN'TES TO THE AITHORITISATE ORGANIL HAS BEEN TRANSMITTED TO YOUR MODIFICATION AND PRINTED VISION ON TRANSMITTED TO YOUR MODIFICATION AND PRINTED VISION ON THE ARCHITECT REARISH DAMED OF THE PROPERSTAND. SEAL AND DISTINCT REARISH DAMED OF THE PROPERSTAND AS AND AND DISTINCT REARISH DAMED OF THE PROPERSTAND AS AND AND DISTINCT REARISH DAMED OF THE PROPERSTAND. SEAL AND DISTINCT REARISH DISTINCT OF THE PROPERSTAND AS AND CONTINUES OF THE PROPERTY OF THE PROPERSTAND.

OWNER/CLIENT: ARYZE DEVELOPMENTS 250.940.3568

_		_
_		
_		
\neg		
_		
_		
04	REISSUED FOR DEVELOPMENT PERMIT	04/28/
03	REISSUED FOR DEVELOPMENT PERMIT	07/28
02	ISSUED FOR REVIEW	03/09/
01	ISSUED FOR DEVELOPMENT PERMIT	09/07
NO.	REVISION	M/D/

956 HEYWOOD

VICTORIA, BC


956 HEYWOOD VICTORIA, BC




302-666 Cook Street, Victoria, BC, V8V 3 778-584-0582 | info@charch.ca | charch.

NEIGHBOUR OPENINGS

JUALE.	1.15	REVIEW D1.	Un
SCALE:	1:75	REVIEW BY:	CH
PROJECT NO:	2101	DRAWN BY:	CH

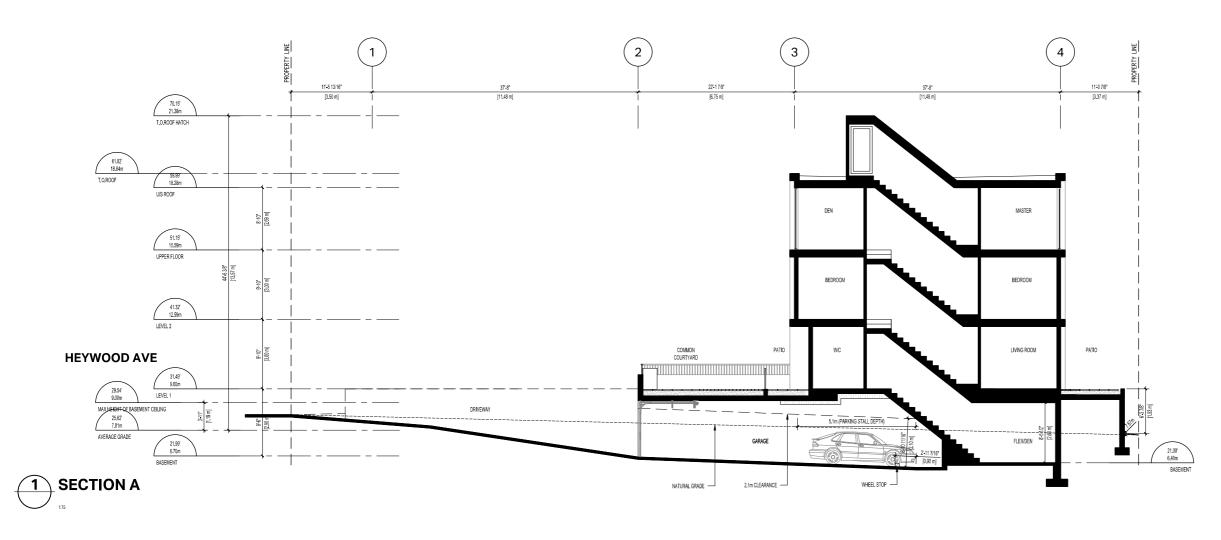

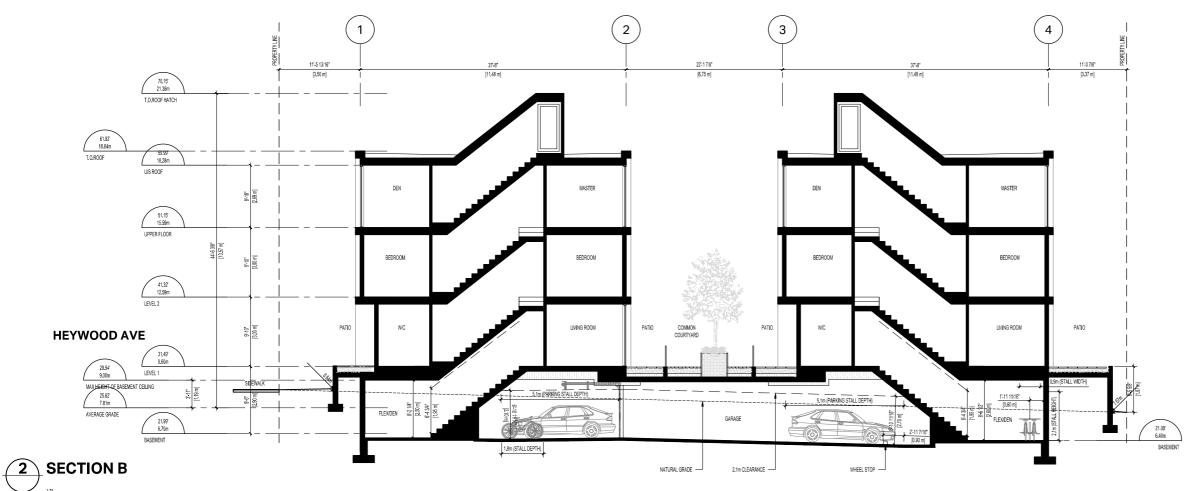

Copyright reserved. All parts of this drawing are the exclusive property of Colin Harper Architect and shall not be used without the Architect's written permission. All dimensions shall be verified by Contractor before commencing work.

SE



NORTH ARROW

NOTES

OWNER/CLIENT: ARYZE DEVELOPMENTS 250.940.3568

	-	
-		
_		
_		_
_		
_		_
_		_
+		+
04	REISSUED FOR DEVELOPMENT PERMIT	04
03	REISSUED FOR DEVELOPMENT PERMIT	07
02	ISSUED FOR REVIEW	03
01	ISSUED FOR DEVELOPMENT PERMIT	09
NO.	REVISION	

956 HEYWOOD

VICTORIA, BC

956 HEYWOOD VICTORIA, BC




302-666 Cook Street, Victoria, BC, V8V 3


78-584-0582 | info@d

SECTIONS

PROJECT NO:	2101	DRAWN BY:	CH
SCALE:	1:75	REVIEW BY:	CH

DRAWING NO: A401

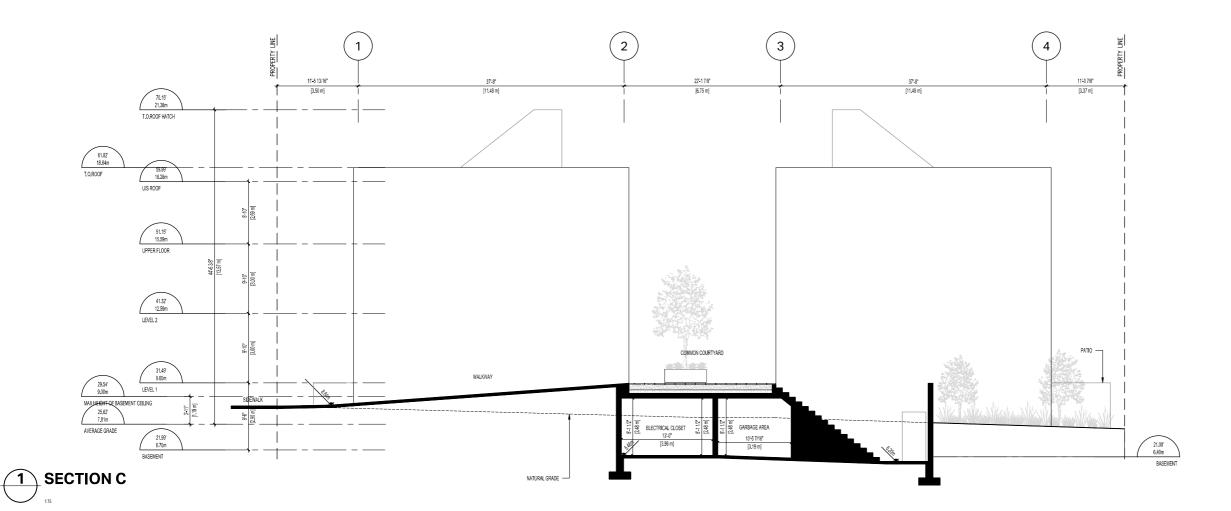

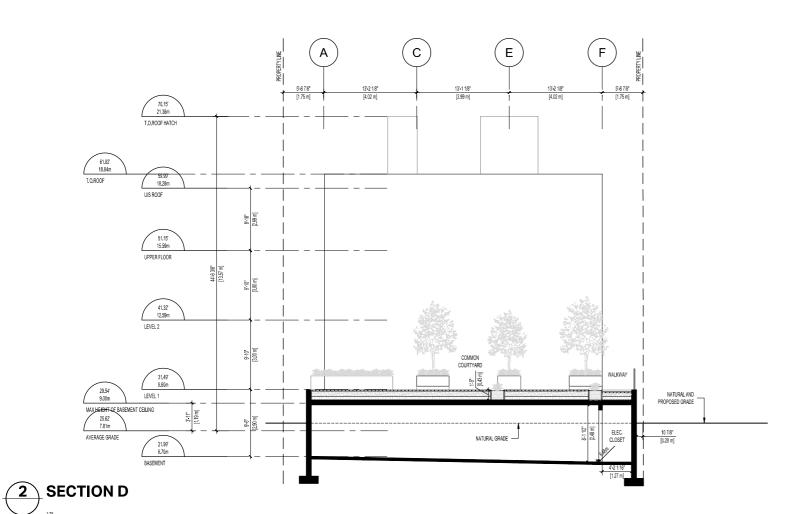

Copyright reserved. All parts of this drawing are the exclusive property of Colin Harper Architect and shall not be used without Architect's written permission. All dimensions shall be verified Contractor before commencing work.

SE



NORTH ARROW

NOTES

1. THIS DOCUMENT HAS BEEN GOTALLY CERTIFIED WITH DISTRIAL CERTIFICATE AND ENCREPTION TECHNOLOGY AUTHORIZED BY THE ARCHITECTURAL INSTITUTE OF ECANOTIES DISTRICT HAS REPORTED ACCOUNTED THE OWN LONG THE PROBLEMS THE OWN LONG THE INSTITUTE OF OWN LONG THE PROBLEMS THE OWN LONG THE INSTITUTE OF THE OWN LONG THE PROPERS THE OWN LONG THE INTERNATION THE PROBLEMS THE OWN LONG THE PROPERS THE ARCHITECT BY THE ARCHITECT REASON WHEN PROBLEMS THE ARCHITECT SALL AND DIGITAL CERTIFICATE OR WHEN PROBLEMS THE ARCHITECT BY CONTINUED THE OWN LONG THE OWN LONG THE ARCHITECT OWN THE ARCHITECT AND THE OWN LONG THE PROBLEMS THE ARCHITECT OWN THE ARCHITECT AND THE OWN LONG THE ARCHITECT OWN THE ARCHITECT AND THE OWN LONG THE ARCHITECT OWN THE ARCHITECT AND THE ARCHITECT AND THE ARCHITECT OWN THE ARCHITECT AND THE ARCHITECT AND THE ARCHITECT OWN THE ARCHITECT AND THE ARCHITECT AND THE ARCHITECT OWN THE ARCHITECT AND THE ARCHITECT AND THE ARCHITECT OWN THE ARCHITECT AND THE ARCHITECT AND THE ARCHITECT OWN THE ARCHITECT AND THE ARCHITECT AND THE ARCHITECT OWN THE ARCHITECT AND THE ARCHITECT AND THE ARCHITECT OWN THE ARCHITECT AND THE ARCHITECT AND THE ARCHITECT OWN THE ARCHITECT AND THE ARCHITECT AND THE ARCHITECT OWN THE ARCHITECT AND THE ARCHITECT AND THE ARCHITECT OWN THE ARCHITECT AND THE ARCHITECT AND THE ARCHITECT OWN THE ARCHITECT AND THE ARCHITECT AND THE ARCHITECT OWN THE ARCHITECT AND THE ARCHITECT AND THE ARCHITECT OWN THE ARCHITECT AND THE ARCHITECT AND THE ARCHITECT OWN THE ARCHITECT AND THE ARCHITECT AND THE ARCHITECT OWN THE ARCHITECT AND THE ARCHITECT AND THE ARCHITECT AND THE ARCHITECT OWN THE ARCHITECT AND THE

OWNER/CLIENT: ARYZE DEVELOPMENTS 250,940,3568

		- 1
_		
_		
_		
04	REISSUED FOR DEVELOPMENT PERMIT	04/
03	REISSUED FOR DEVELOPMENT PERMIT	07/
02	ISSUED FOR REVIEW	03/
01	ISSUED FOR COORDINATION	03/
NO.	REVISION	M

956 HEYWOOD

VICTORIA, BC

PROJECT ADDRESS: 956 HEYWOOD VICTORIA, BC




302-666 Cook Street, Victoria, BC, V8V 3

DRAWING TITLE

SECTIONS


PROJECT NO:	2101	DRAWN BY:	
PROJECT NO:	2101	DRAWN D1.	KG
SCALE:	1:75	REVIEW BY:	CH

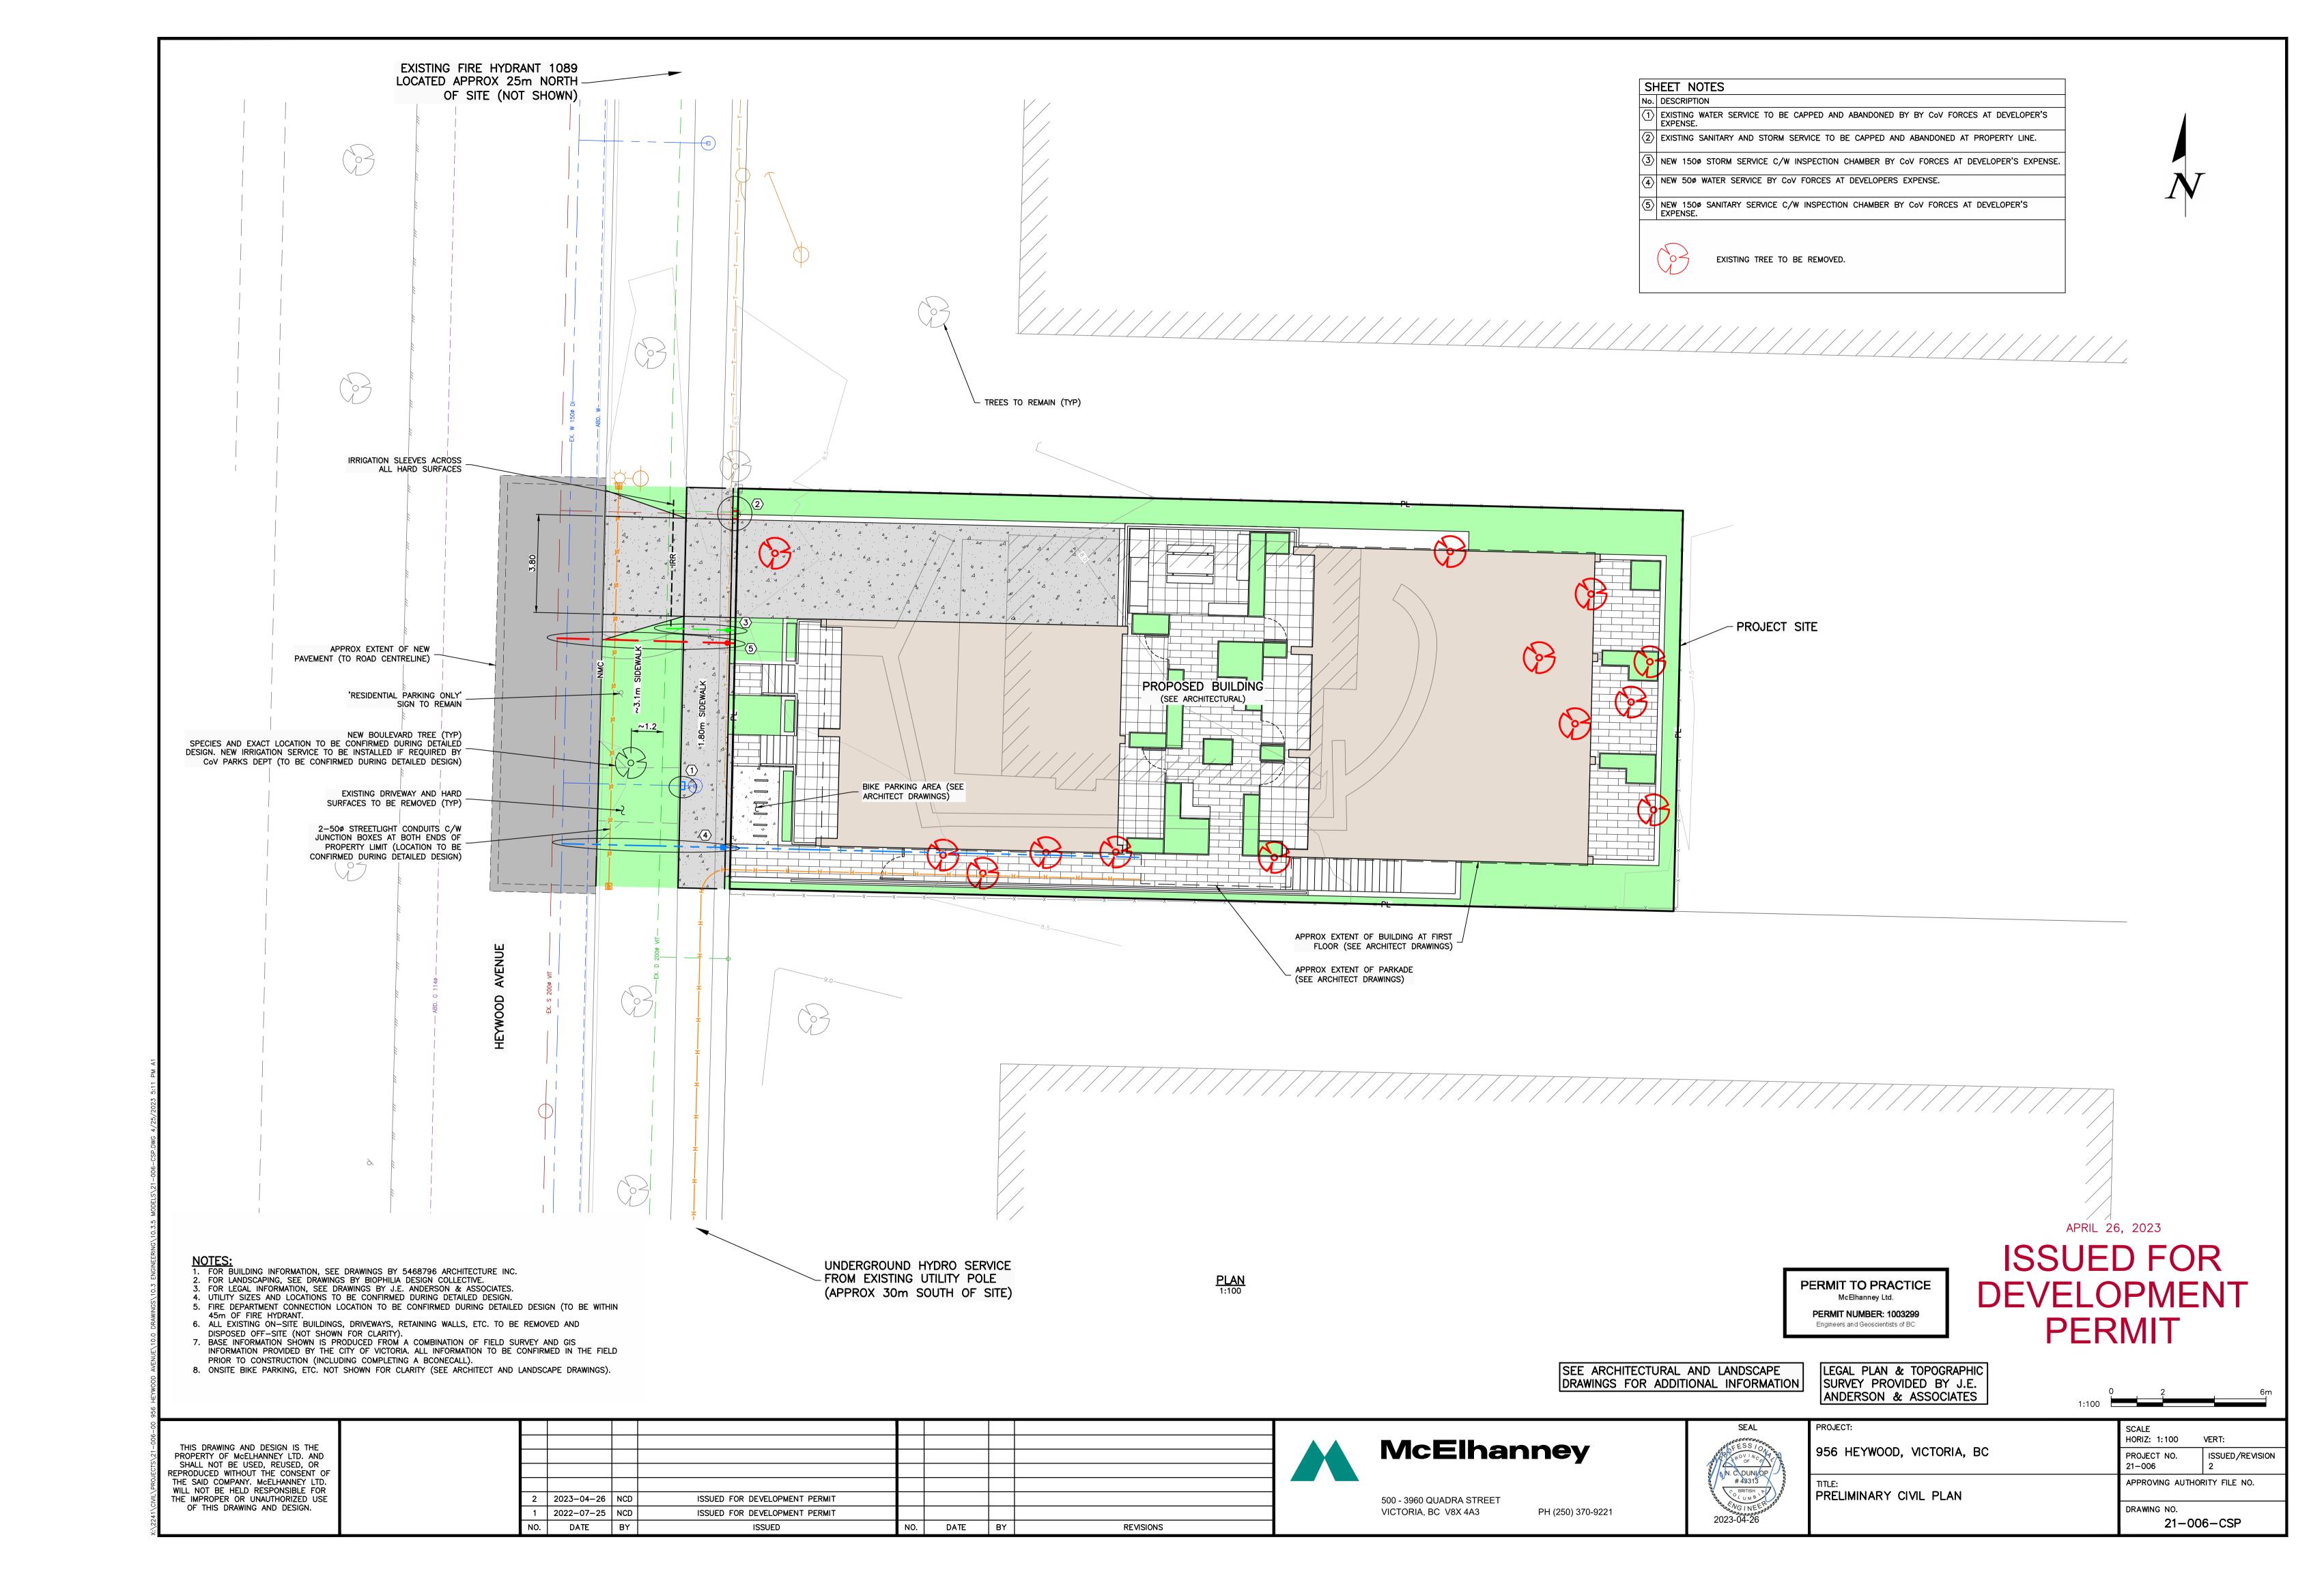







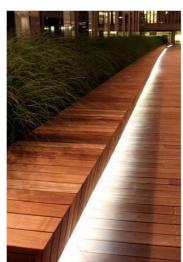





1608 Camosun Street, Victoria BC V3T 3E6 Info@biophiliacollective.ca 250 590 1156

owner/client: Aryze

Heywood Townhome

PROJECT ADDRESS: 956 Heywood Ave Victoria, BC

DESIGNED BY: BIANCA BODLEY DRAWN BY: KIM TANG


NO.	ISSUED FOR	DATE
1	Development Permit	09/07/2021
2	Development Permit	03/28/2022
3	Development Permit	07/22/2022
4	Development Permit	04/26/2023






DRAWING TITLE:



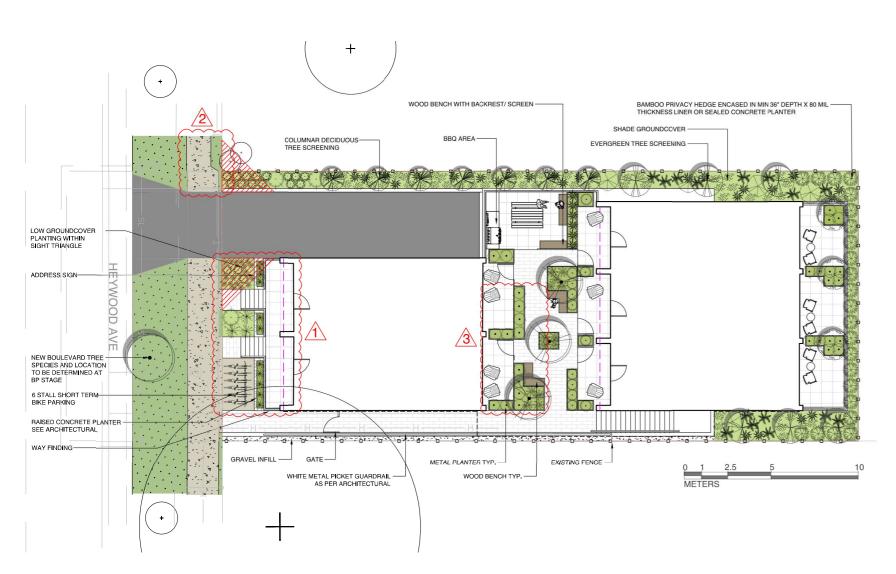

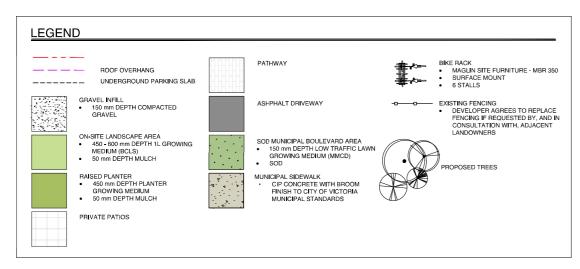

SITE PERMEABILITY

SITE AREA: 568 m2 PERVIOUS AREA OF GARDENS: 71 m2/ 12.5% PERVIOUS AREA OF HARDSCAPE AND PLANTER: 35.5 m2/ 6% SITE PERVIOUS RATIO: 18.5%





PRIVATE PATIO PAVER

HARD SURFACE TREATMENT

PATHWAY PAVER



BUILT IN BENCH



FURNITURE/ **STRUCTURES**









DOWN LIGHT IN BENCH

DOWN LIGHT IN WALL

LANDSCAPE NOTES

- PROPOSED BOULEVARD TREES

 TREE SPECIES TO BE COORDINATED WITH PARKS PRIOR TO PLANTING

 TREES MUST HAVE ONE DOMINANT CENTRAL LEADER OR SINGLE STRAIGHT TRUNK, 5-8 cm DIAMETER, CALIPER MEASURED 15 cm
 ABOVE GROUND, WELL BALANCED CROWN WITH BRANCHING STARTING AT 1.8m-2.5m ABOVE GROUND

 TREES TO BE PLANTED AS PER PLANTIG OF TREES, SHRUBS AND GROUND COVERS (32 93 01 MMCD 2009 AND CITY OF VICTORIA SUPPLEMENTAL DRAWINGS SD P3 AND SD P4)

 PARKS WILL RECUIRE (3) INSPECTIONS FOR TREE PLANTING: 1) INSPECTION OF SOIL AND PLANTING AREA, 2) INSPECTION OF STOCK UPON DELIVERY, 3) INSPECTION OF INSTALLED TREE WITH MULCH AND STAKING. TRUNK FLARE MUST BE VISIBLE AND PLANTED AT OR SLIGHTLY ABOVE GRADE UPON INSPECTION.

 THE APPLICANT MUST MAINTAIN THE TREE IN GOOD HEALTH AND STRUCTURAL CONDITION FOR 1 YEAR FROM THE SUBSTANTIAL COMPLETION TO BE ELIGIBLE FOR DEPOSIT RETURN.

- BOULEAVARD IRRIGATION

 SEE IRRIGATION PLAN IRRIGATION PLAN TO BE SUBMITTED AT DP STAGE

 MUNICIPAL BOULEVARD TO BE IRRIGATED BY A SEPARATE SYSTEM FROM A SEPARATE CITY SOURCE CONFORMING TO THE CITY OF VICTORIA SUPPLEMENTARY SPECIFICATIONS FOR STREET TREES AND IRRIGATION SCHEDULE C TO BYLAW 12-042, SUBDIVISION

- WILDING SUFF LEMENTAL OF LEMENTAL OF SEMENTAL SEMENTS OF THE START OF



1608 Camosun Street, Victoria BC V8T 3E6

Aryze

Heywood Townhome

Victoria, BC

956 Heywood Ave

DESIGNED BY: BIANCA BODLEY DRAWN BY: KIM TANG


NO.	ISSUED FOR	DATE
1	Development Permit	09/07/2021
2	Development Permit	03/28/2022
3	Development Permit	07/22/2022
4	Development Permit	04/26/2023







LANDSCAPE PLAN

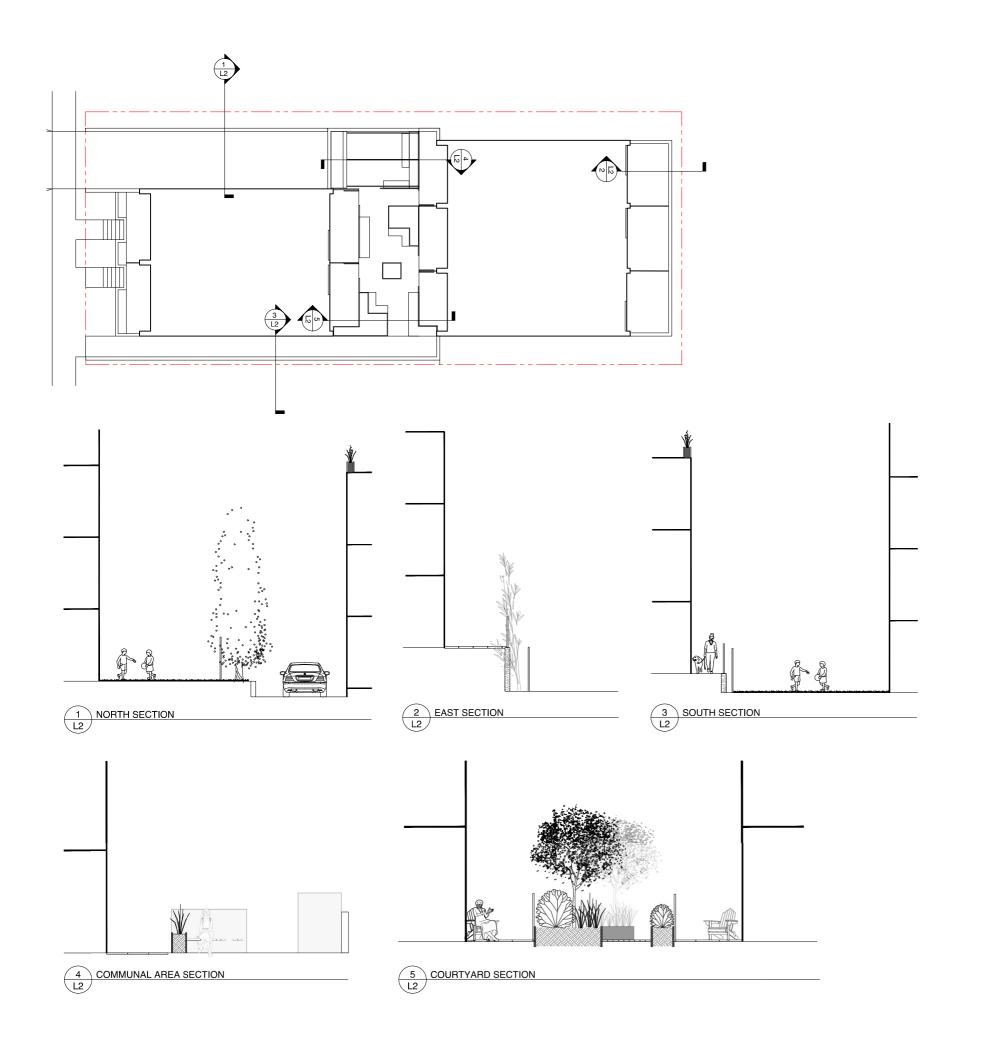



1608 Camosun Street, Victoria BC V8T 3E6 Info@biophiliacollective.ca 250 590 1156

Aryze

DDO IFOT NA

Heywood Townhome

PROJECT ADDRESS

956 Heywood Ave Victoria, BC

SIGNED BY: BIANCA BODLEY

ISSUED FOR	DATE
Development Permit	09/07/2021
Development Permit	03/28/2022
Development Permit	07/22/2022
Development Permit	04/26/2023
L_	
	Development Permit Development Permit Development Permit

SE



NORTH ARROV





DRAWING TIT

LANDSCAPE SECTIONS AND IMAGERY

DWG NO:

CALE: NTS

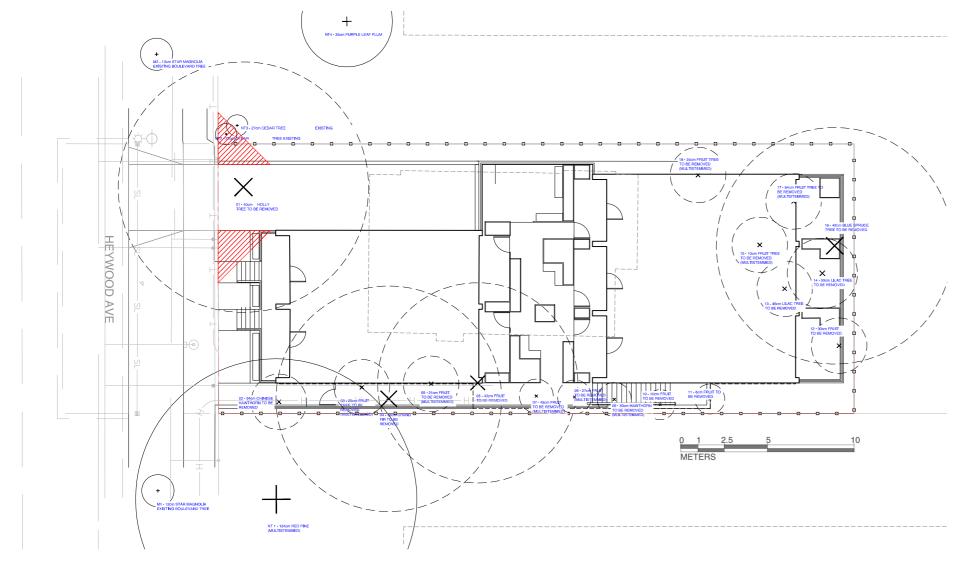

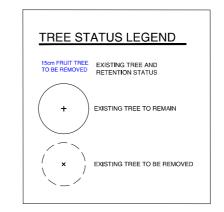

NOTES:

1. THIS APPLICATION IS BEING REVIEWED UNDER TREE PRESERVATION BYLAW NO. 05-106 AS ADOPED BY COUNCIL ON NOVEMBER 15TH, 2005.

					1
TREE ID	COMMON NAME	DBH (cm)	LOCATION	PROPOSED STATUS	COMMENTS
M1	Star Magnolia	12	Municipal tree	Retain	
M2	Star Magnolia	13	Municipal tree	Retain	
NT1	Red Pine	134	Neighbor's tree	Retain	Multistem
NT2	Cedar	22	Neighbor's tree	Retain	
NT3	Cedar	27	Neighbor's tree	Retain	
NT4	PURPLE LEAF PLUM	35	Neighbor's tree	Retain	
01	Common Holly	40	Onsite	Remove	
02	Chinese Howthorn	64	Onsite	Remove	
03	Fruit Tree	25	Onsite	Remove	Multistem
04	Grand Fir	38	Onsite	Remove	
05	Fruit Tree	21	Onsite	Remove	Multistem
06	Fruit Tree	43	Onsite	Remove	
07	Fruit Tree	45	Onsite	Remove	Multistem
08	Fruit Tree	27	Onsite	Remove	Multistem
09	Howthorn	30	Onsite	Remove	Multistem
10	Fruit Tree	10	Onsite	Remove	
11	Fruit Tree	6	Onsite	Remove	
12	Fruit Tree	30	Onsite	Remove	
13	Lilac Tree	46	Onsite	Remove	
14	Lilac Tree	59	Onsite	Remove	
15	Fruit Tree	10	Onsite	Remove	Multistem
16	Blue Spruce	42	Onsite	Remove	
17	Fruit Tree	54	Onsite	Remove	Multistem
18	Fruit Tree	24	Onsite	Remove	Multistem



1608 Camosun Street, Victoria BC V8T 3E6 Info@biophiliacollective.ca 250 590 1156

Aryze

Heywood Townhome

956 Heywood Ave Victoria, BC

DESIGNED BY: BIANCA BODLEY DRAWN BY: KIM TANG


NO.	ISSUED FOR	DATE
1	Development Permit	09/07/2021
2	Development Permit	03/28/2022
3	Development Permit	07/22/2022
4	Development Permit	04/26/2023
	_	






TREE REMOVAL & PROTECTION PLAN

SCALE: 1:100

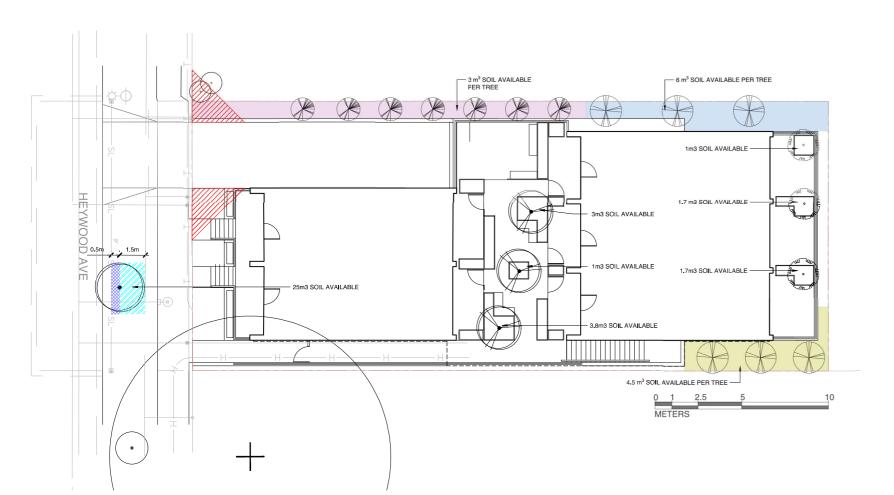

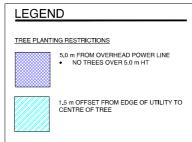


TREE	SCHEDULE							
Quantity	Symbol	Latin Name	Common Name	Height	Caliper	Native	Height at Maturity (m)	Spread at Maturity (m
1	\bigcirc	BOULEVARD TREE TO BE DETERMINED BY PARKS AT BP			60mm			
7		Liquidambar styraciflua 'Slender Silhouette'	Slender Silhouette Sweet Gum		60mm		15m	3m
6		Cupressus nootkatensis 'Pendula'	Weeping Nootka Cypress	3.5m			8m	3m
3		Styrax japonicus	Japanese Snowbell		50mm		7m	7m
3	M. M	Acer circinatum	Vine Maple		50mm		4.5m	4.5m

NOTES:

1. PLANTS IN PLANT LISTS ARE SPECIFIED ACCORDING TO THE CANADIAN NURSERY LANDSCAPE ASSOCIATION CANADIAN STANDARDS FOR NURSERY STOCK AND SECTION 12, CONTAINER GROWN PLANTS FROM THE BC LANDSCAPE STANDARD, CURRENT EDITION.



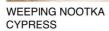



JAPANESE SNOWBELL



SLENDER SILHOUETTE VINE MAPLE **SWEETGUM**





1608 Camosun Street, Victoria BC V8T 3E6 Info@biophiliacollective.ca 250 590 1156

Aryze

Heywood Townhome

956 Heywood Ave Victoria, BC

DESIGNED BY: BIANCA BODLEY DRAWN BY: KIM TANG

2 Development Permit 03/28/202 3 Development Permit 07/22/202	NO.	ISSUED FOR	DATE
3 Development Permit 07/22/202	1	Development Permit	09/07/2021
The state of the s	2	Development Permit	03/28/2022
4 Development Permit 04/26/202	3	Development Permit	07/22/2022
	4	Development Permit	04/26/2023









DRAWING TITLE:

TREE PLANTING PLAN

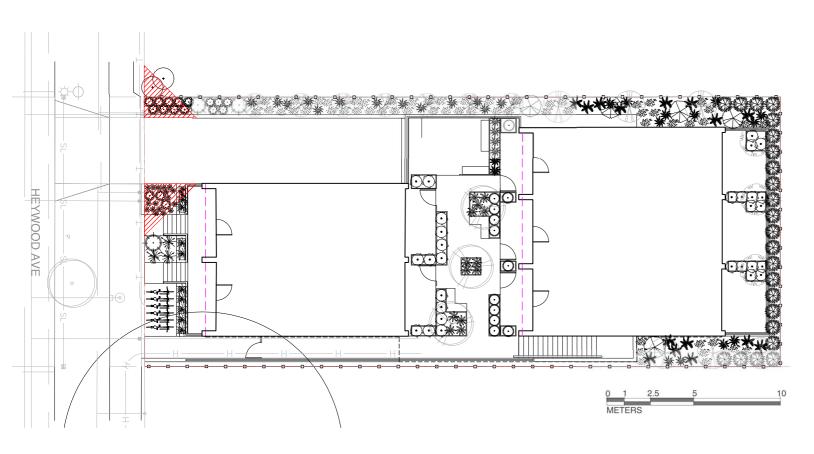

SITE SHRUB PLANTING PLAN

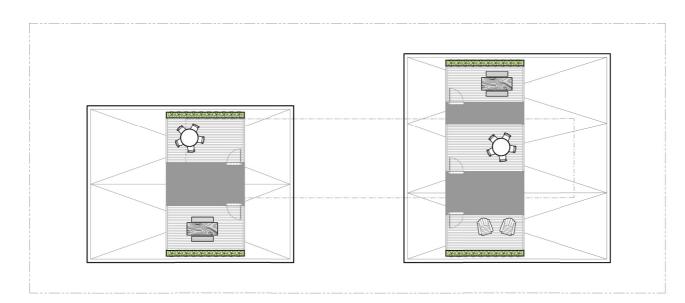

ROOF PLANTING PLAN



STIPA GIGANTEA

DWARF

JAPANESE BLACK PINE



HEBE SUTHERLANDII



HINO WHITE AZALEA












BUNCHBERRY



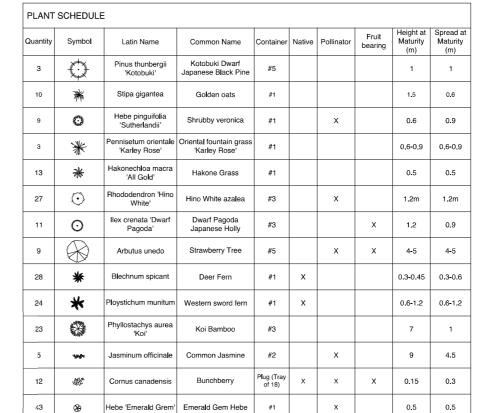

NOTES:

1. PLANTS IN PLANT LISTS ARE SPECIFIED ACCORDING TO THE CANADIAN NURSERY LANDSCAPE ASSOCIATION CANADIAN STANDARDS FOR NURSERY STOCK AND SECTION 12, CONTAINER GROWN PLANTS FROM THE BC LANDSCAPE STANDARD, CURRENT EDITION.


PLANTS DATA

KOI BAMBOO

TOTAL QUANTITY: 243 NATIVE PLANTS IN TOTAL: 77 (32%) POLLINATOR PLANTS IN TOTAL: 103 (42%) FRUIT BEARING PLANTS IN TOTAL: 35 (14%)





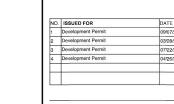

BI

Aryze

1608 Camosun Street, Victoria BC V8T 3E6

Heywood Townhome

956 Heywood Ave

DESIGNED BY: BIANCA BODLEY DRAWN BY: KIM TANG

Victoria, BC




SHURB PLANTING PLAN

ARBUTUS UNEDO

DEER FERN

HEBE EMERALD GEM

SWORD FERN

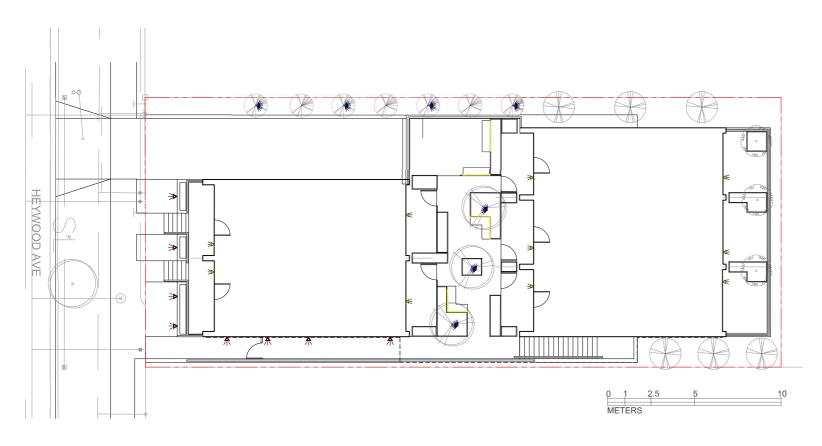







1608 Camosun Street, Victoria BC V8T 3E6 Info@biophiliacollective.ca 250 590 1156

OWNER/CLIENT Aryze

Heywood Townhome

956 Heywood Ave Victoria, BC

DESIGNED BY:BIANCA BODLEY DRAWN BY:KIM TANG

2 Development Permit 03/28/2 3 Development Permit 07/22/2	NO.	ISSUED FOR	DATE
3 Development Permit 07/22/20	1	Development Permit	09/07/2021
	2	Development Permit	03/28/2022
4 Development Permit 04/26/20	3	Development Permit	07/22/2022
	4	Development Permit	04/26/2023





DRAWING TITLE: LIGHTING PLAN

DWG NO:

SCALE: 1:100

A Large Format Modern Paver

Broadway is a large profile paver suited for nearly any application. This 65mm thick paver is especially designed for residential projects that don't require the thickness of a commercial location. Its sleek and contemporary design lends itself to beautiful driveways, paths and patios. The 600 x 600 paver is an excellent choice for rooftop applications and the 300 x 300 can also be used as a stepping stone.





















PRIVATE PATIO PAVER SPECIFICATIONS

Pattern 6

Pieces per 100 Sqft (1) 300 x 150 = 7%, 14 pcs (1) 300 x 300 = 13%, 14 pcs

(1) 600 x 300 = 27%, 14 pcs (1) 600 x 600 = 53%, 14 pcs

Linear Elegance for Inspiring Designs

Boardwalk is a eight paver system with a modern, linear look. Boardwalk is an excellent option for drawing the eve towards the focal point in any landscape. At 3 inches thick, it's perfect for high traffic areas including driveways, patios, and plazas. For quickinstallation, Boardwalk can be machine installed. Its wide spacers also allow it to be used as a permeable paver in locations that require good







SIZES (LXWXH)










12.68 x 3.50 x 3.15 ln

COLOURS

14.25 x 3.50 x 3.15 in



PATHWAY PERMEABLE PAVER SPECIFICATIONS

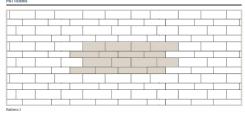

Lightology

DESCRIPTION
The Silo Silo Outdoor Up / Down Wall Sconce is the perfect addition to exteriors from coastal to modern. The compact design blends seamlessly into your space, while the up and down light washes a large area with light. Coated with anti-dading finishes, for maximum durability in harsh climates. Finished in Architectural Bronze, Black, and Satin White. JAB complaint. Wet location rated. UL and CSA listed.

BRAND

		PAL	LET R	OV			PALLET								
DESCRIPTION	SIZE (L > W X H)	.>WXH)	FACE AREA		WXH) FACE AREA		AREA WEIGHT		NO. OF FACE		NO. OF	NO. OF	FACE	AREA	WEIGHT
	ми	IN	M ²	SQ FT	LB	UNITS	M ²	SQFT	UNITS	ROWS	M2	SQFT	LB		
14×45	362×119×80	14.25 x 4.09 x 3.15	.04	.44	17.17	-		-	28	-					
14×3	362 x 85 x 80	14.25 x 3.50 x 3.15	.03	.32	13.15	-		-	28	-					
12.5 x 4.5	322×119×80	12.58 x 4.69 x 3.15	.04	.39	15.69	-			28	-					
12.5×3	322 x 89 x 80	12.68 x 3.50 x 3.15	.03	.29	11.70	-		-	28	-	7.06	75.74	2888		
11x45	282×119×80	11.10×4.09×3.15	.03	.34	13.76	-		-	28	-	1,00	12.14	2000		
11x3	282 x 85 x 80	11.10×3.50×3.15	.02	.25	10.26	-	-		28	-					
9x45	242×119×80	9.53×4.69×3.15	.03	.29	11.82	-		-	28	-					
9x3	242×88×80	9.53×3.50×3.15	.02	.21	8.82	-		-	28	-					

Hinkley Lighting

Silo Outdoor Up / Down Wall Sconce

(h) (f) • JAS

Shown in: Satin White / Etched Glass



BIO

Aryze

1608 Camosun Street, Victoria BC V8T 3E6 Info@biophiliacollective.ca 250 590 1156

Heywood Townhome

956 Heywood Ave Victoria, BC

DESIGNED BY:BIANCA BODLEY DRAWN BY:KIM TANG

| Control | Cont

RECESSED LIGHT SPECIFICATION - FOR CONCRETE PLANTER













FINISH CONSTRUCTION
Satin White Cast Aluminum
Satin White Cast Aluminum 1.2w / 1.5VA 1.2w / 1.5VA

DISTANCE FROM LIF	BHT	LEDITEM	r	2'	3	4	5	6	7	В	Q/	10'
	18" Mounting	1551 SW	10.13	3.334	1.228	0.49	0.23	0.112	0.07	0.035	0.024	0.002
FOOTCANDLES	36" Mounting	1331 310	3.35	2.104	1.205	0.665	0.383	0.245	0.165	0.117	0.075	0.045
POUTCARDLES	12" Mounting	4550.004	15.83	2.39	0.73	0.28	0.114	0.053	0.019			
	18" Mounting	1556 SW	7.67	2.79	0.838	0.415	0.199	0.106	0.054	0.001		

RECESSED LIGHT SPECIFICATION - FOR WALL

LED	Flex Light • Bas	sicBright
	AS .	Operating Volta
	000	Finish (fin)

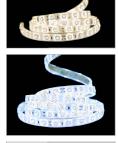

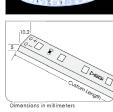

Light Output Lumens (at 85 CRI)	2700K 114.5 per foot 3000K 120.6 per foot 3500K 125.1 per foot 4000K 129.6 per foot 5000K 138.6 per foot
CRI (cri) Colour Rendering Index	85 95 ¹
IP Rating	IP67
Dimension Width, Height, Length	W 0.393" 10 mm H 0.157" 4 mm L Specify maximum length in inches
Watts	1.57W per foot
Input Voltage	AC 100V - 240V, 277V external transformer
Dimmable	Yes With dimmable transformer MLV, ELV or 0-10V. Please specify at time of ord
Operating Temperature	-25°C to +50°C -13°F to 122°F
Life Lumen Maintenance	50,000 hours
Warranty	5 Years

24V DC 12V DC1

Rugged – silicone injected, available in: WHT White PCB BLK Black PCB¹

2700K Incondescent White
3000K Warm White
4000K Neutral White
4000K Neutral White
5000K Cool White
5000K Cool White
R Red ¹ G Green ¹ B Blue ¹ A Amber ¹

Recommended Tracks	LP1816	REC1707	UCH1715	ANG2618
See track page to	r more compatible tracks. See	individual track cutsheets for	more details.	

Beam Angle (ba) Degrees

Category	Family	Operating Voltage (ov)	Finish (fin)	Light Colour (Ic)	CRI (cri)
FLEX-P Professional	BASIC	12VDC ¹ 24VDC	WHT White BLK Black ¹	2700K IW 3000K WW 3500K SW 4000K NW 5000K CW R ¹ G ¹ B ¹ A ¹	85 95 ¹



Alliance Outdoor Lighting • (800) 930-6225 • www.allianceoutdoorlighting.com

WELL LIGHT SPECIFICATIONS SCONCE LIGHT SPECIFICATIONS

BENCH LIGHT SPECIFICATIONS



NO. ISSUED FOR

1 Development Permit

2 Development Permit

PRODUCT

SPECIFICATIONS