


1702 QUADRA STREET + 862 FISGARD STREET

VICTORIA, BC

01.06.2023 ISSUED FOR DP





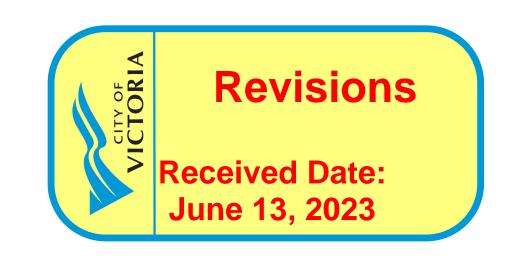

ARCHITECTURAL:

ARCHITECTURE INC

5468796 ARCHITECTURE INC. 266 McDermot Ave Winnipeg, MB. R3B 0S8 P: 204.480.8421

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COVER **GENERAL NOTES** RENDERINGS AG.2 AG.3 RENDERINGS AG.4 MATERIAL BOARD AG.5 SHADOW STUDIES AG.6 SITE CONTEXT ELEVATIONS AG.7 WINDOW + DOOR SCHEDULE AG.8 ZONING CALCULATIONS AG.9 SITE SURVEY

CONTEXT SITE PLAN EXISTING SITE PLAN + DEMOLITION A0.3 PROPOSED SITE PLAN LEVEL 00 PLAN LEVEL 01 PLAN LEVEL 02 PLAN

LEVEL 03 PLAN LEVEL 04/06/08/10/12 PLAN LEVEL 05/07/09/11 PLAN A1.7 LEVEL 13 **ROOF PLAN** A1.8

BUILDING ELEVATION BUILDING ELEVATION A2.3 BUILDING ELEVATION A2.4 BUILDING ELEVATION BUILDING SECTION

BUILDING SECTION ENLARGED PLAN - BIKE ROOM

BUILDING SECTION

BUILDING SECTION

BUILDING SECTION

DEVELOPER:

A3.2

A3.3



ARYZE DEVELOPMENTS INC. 1839 Fairfield Road Victoria, BC, V8S 1G9 P.250.940.3568 Vinit Jain

E: vinit@aryze.ca

CIVIL:



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CONCEPTUAL SERVICING

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ENVELOPE:



RDH BUILDING SCIENCE 602-740 Hillside Avenue Victoria, BC, V8T 1Z4 P.250.479.1110.

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LANDSCAPE:



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P.250.590.1156 Bianca Bodley

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LANDSCAPE SITE PLAN TREE REMOVAL AND PROTECTION PLAN THIRD FLOOR PLAN ROOFTOP LANDSCAPE PLAN

ROOFTOP PLANTING PLAN

SYMBOL LEGEND:



EXISTING DOOR NEW DOOR


FINIISH TYPE F-1

FLOOR TYPE LABEL


LABEL ROOF TYPE

NOTES GRIDLINE MARKER


BUILDING SECTIONS:

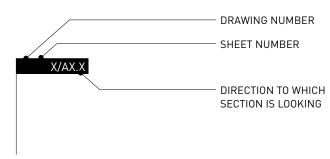


SECTIONS: - DRAWING NUMBER

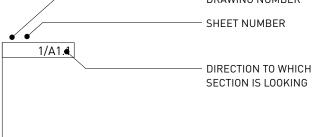


DETAILS:

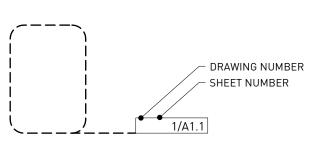


ROOM LABELS:

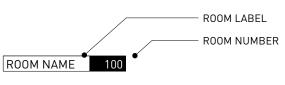



INTERIOR ELEVATIONS:

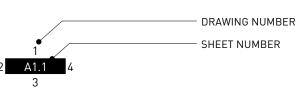

FLOOR CONSTRUCTION ELEVATIONS:

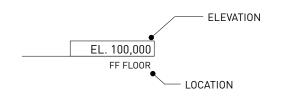

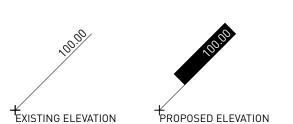

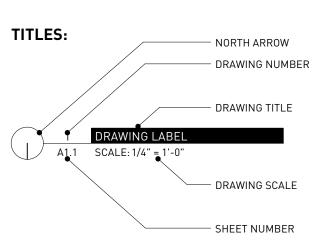

ABBREVIATIONS:

& ABV AFF ALUM ANOD @ ARCH AT AVB	AND ABOVE ABOVE FINISHED FLOOR ALUMINUM ANODIZED AT ARCHITECTURAL ACOUSTIC TILE AIR/VAPOUR BARRIER
BLDG BLKG BRG BS B TO B	BUILDING BLOCKING BEARING BOTH SIDES BACK TO BACK
CB CF CG CJ CL CLG CLR COL CONC CONC CONN CONT CORR CT C/W	CATCH BASIN CLEAR FINISH CORNER GUARD CONTROL JOINT CENTRE LINE CEILING CLEAR COLUMN CONCRETE CONNECTION CONTINUOUS CORRIDOR CERAMIC TILE COMPLETE WITH
Ø DIM DN DRWG DTL	DIAMETER DIMENSION DOWN DRAWING DETAIL
EL EW EA ELEC EQ EXIST EJ EXT	ELEVATION EACH WAY EACH ELECTRICAL EQUAL EXISTING EXPANSION JOINT EXTERIOR
FDN FE FEJ FIN FD FFD FF FLEX FO FR FRR	FOUNDATION FIRE EXTINGUISHER FLOOR EXPANSION JOINT FINISHED FLOOR DRAIN FUNNEL DRAIN FINISHED FACE FLEXIBLE FACE OF FRIDGE FIRE RESISTANCE RATING
G GA GWB GCB	GRILL GAUGE GYPSUM WALL BOARD GYPSUM CEILING BOARD

GENERAL CONTRACTOR GLASS **HOLLOW METAL** HOLLOW METAL INSULATED HORIZ HORIZONTAL HSS HOLLOW STEEL SECTION HSTG

HERMETICALLY SEALED DOUBLE GLAZING HERMETICALLY SEALED TRIPLE GLAZING HEATING, VENTILATING, AIR CONDITIONING INSIDE DIAMETER INSIDE FACE INSULATION INTERIOR LENGTH

METRE MILLIMETRE MOUNT MATERIAL MAX MAXIMUM MDF MEDIUM DENSITY FIBREBOARD MECH MECHANICAL MINIMUM MISC MISCELLANEOUS MASONRY OPENING NOT IN CONTRACT NUMBER NOM NOMINAL NTS NOT TO SCALE

ON CENTRE OUTSIDE DIAMETER OVERHEAD 0PP OPPOSITE OPEN TO ABOVE OTB OPEN TO BELOW OVEN PLAM PLASTIC LAMINATE

PLBG PLUMBING PAIR PREFINISHED PRESSED STEEL PRESSURE TREATED PAINTED FINISH PROPERTY LINE RADIUS

ROOF DRAIN REINF REINFORCED REQ'D REQUIRED REV REVISION, REVISED, REVERSED ROUGH OPENING SHEET FLOORING SIM SPC'D SQ SIMILAR

SPECIFIED

SQUARE STEEL STD STANDARD STAIN FINISH STRUCT STRUCTURAL SUSP SUSPENDED TEMP TEMPERED TEMPERED GLASS TOP OF TYPICAL U/N

UNLESS OTHERWISE NOTED UNDERSIDE

VARNISHED FINISH VERTICAL WIDE, WIDTH WASHER/DRYER WHC WOOD HOLLOW CORE WOOD SOLID CORE

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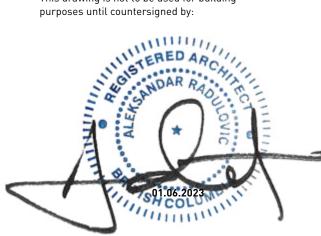
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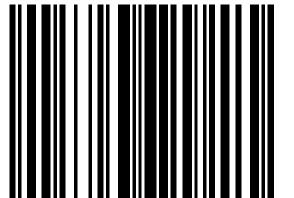
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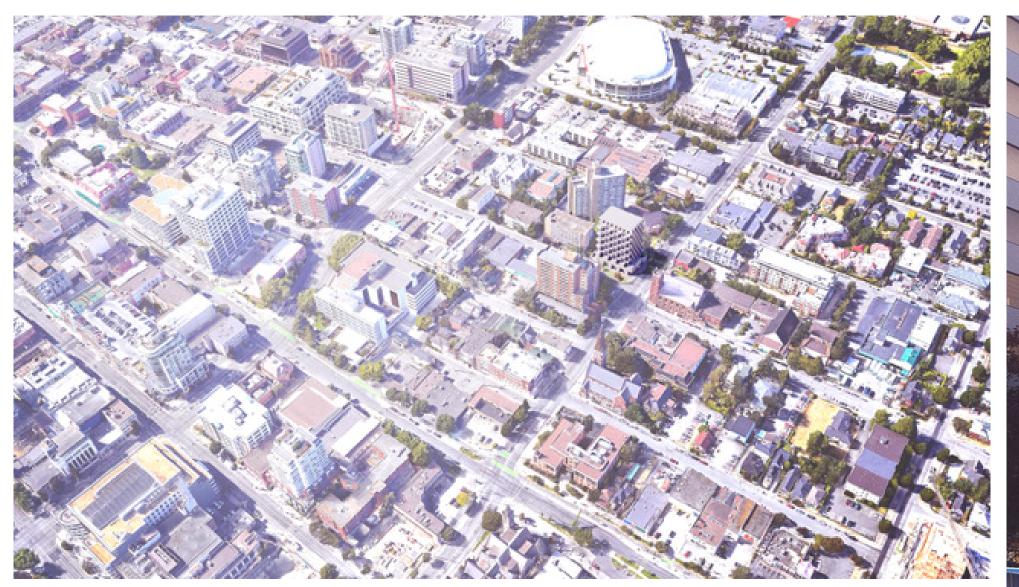
1702 QUADRA STREET + 862 FISGARD STREET

GENERAL NOTES

0650 Sheet

Project

AG.1







RENDER 3: STREETVIEW EXPERIENCE ALONG QUADRA



RENDER 4: VIEW OF EAST BUILDING ELEVATION FROM QUADRA

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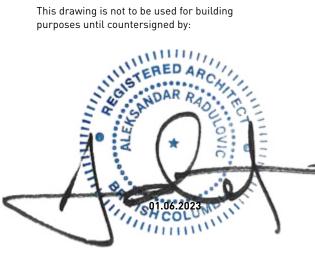
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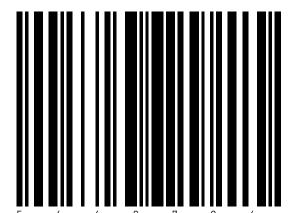
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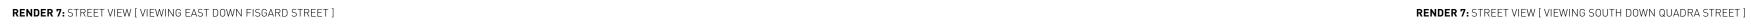
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RENDERINGS

Project 0650 Sheet AG.2







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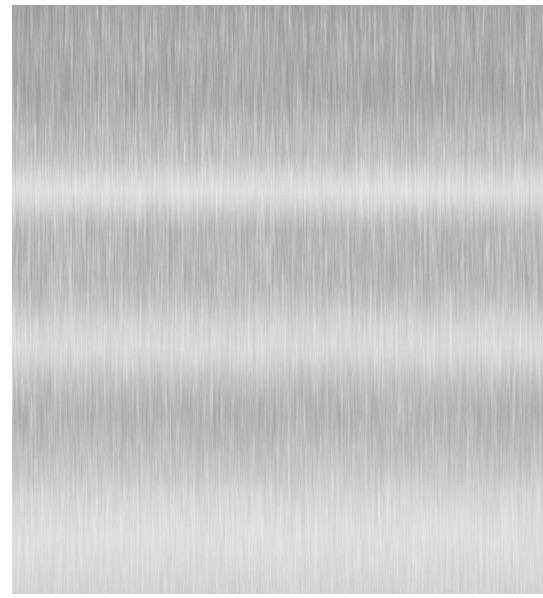
1702 QUADRA STREET + 862 FISGARD STREET

RENDERINGS

Project 0650 Sheet

AG.3






ALUMINUM BRUSHED

BRICK





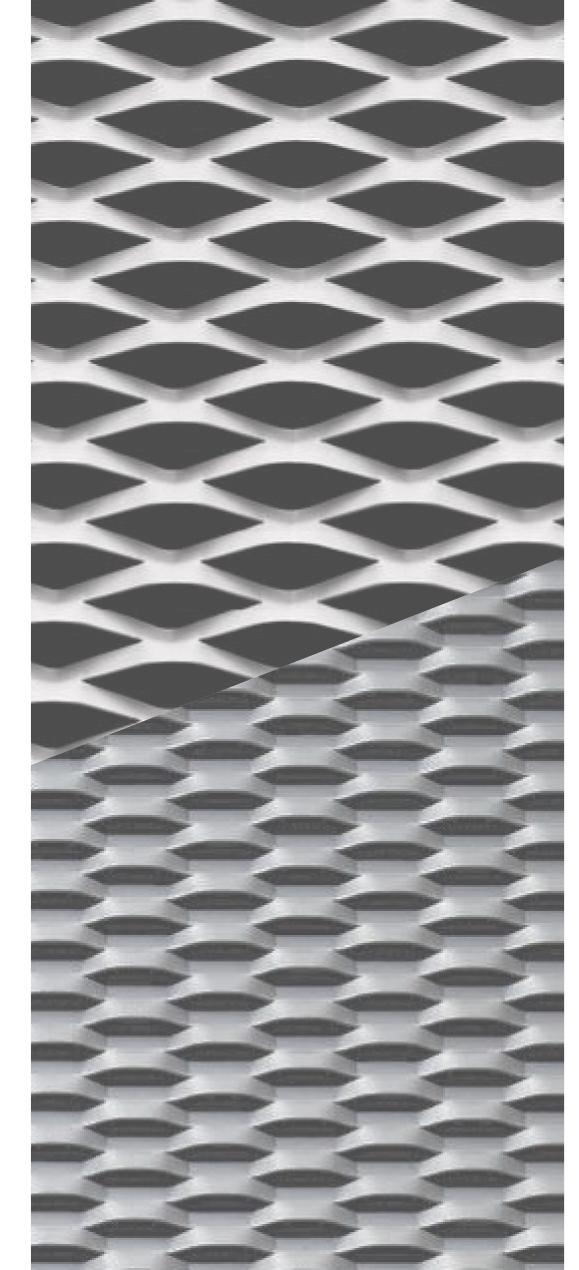



GLASS - TRANSLUCEN



CONCRETE









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1702 QUADRA STREET + 862 FISGARD STREET

MATERIALS

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Project 0650 Sheet AG.4



MARCH 20 9:00 AM



MARCH 20 12:00 PM



MARCH 20 4:00 PM





JUNE 21 9:00 AM



JUNE 21 12:00 PM



JUNE 21 4:00 PM



SEPTEMBER 22 9:00 AM



SEPTEMBER 22 12:00 PM



SEPTEMBER 22 4:00 PM



DECEMBER 21 9:00 AM



DECEMBER 21 12:00 PM



DECEMBER 21 4:00 PM





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PB 01.06.2023


01.06.2023


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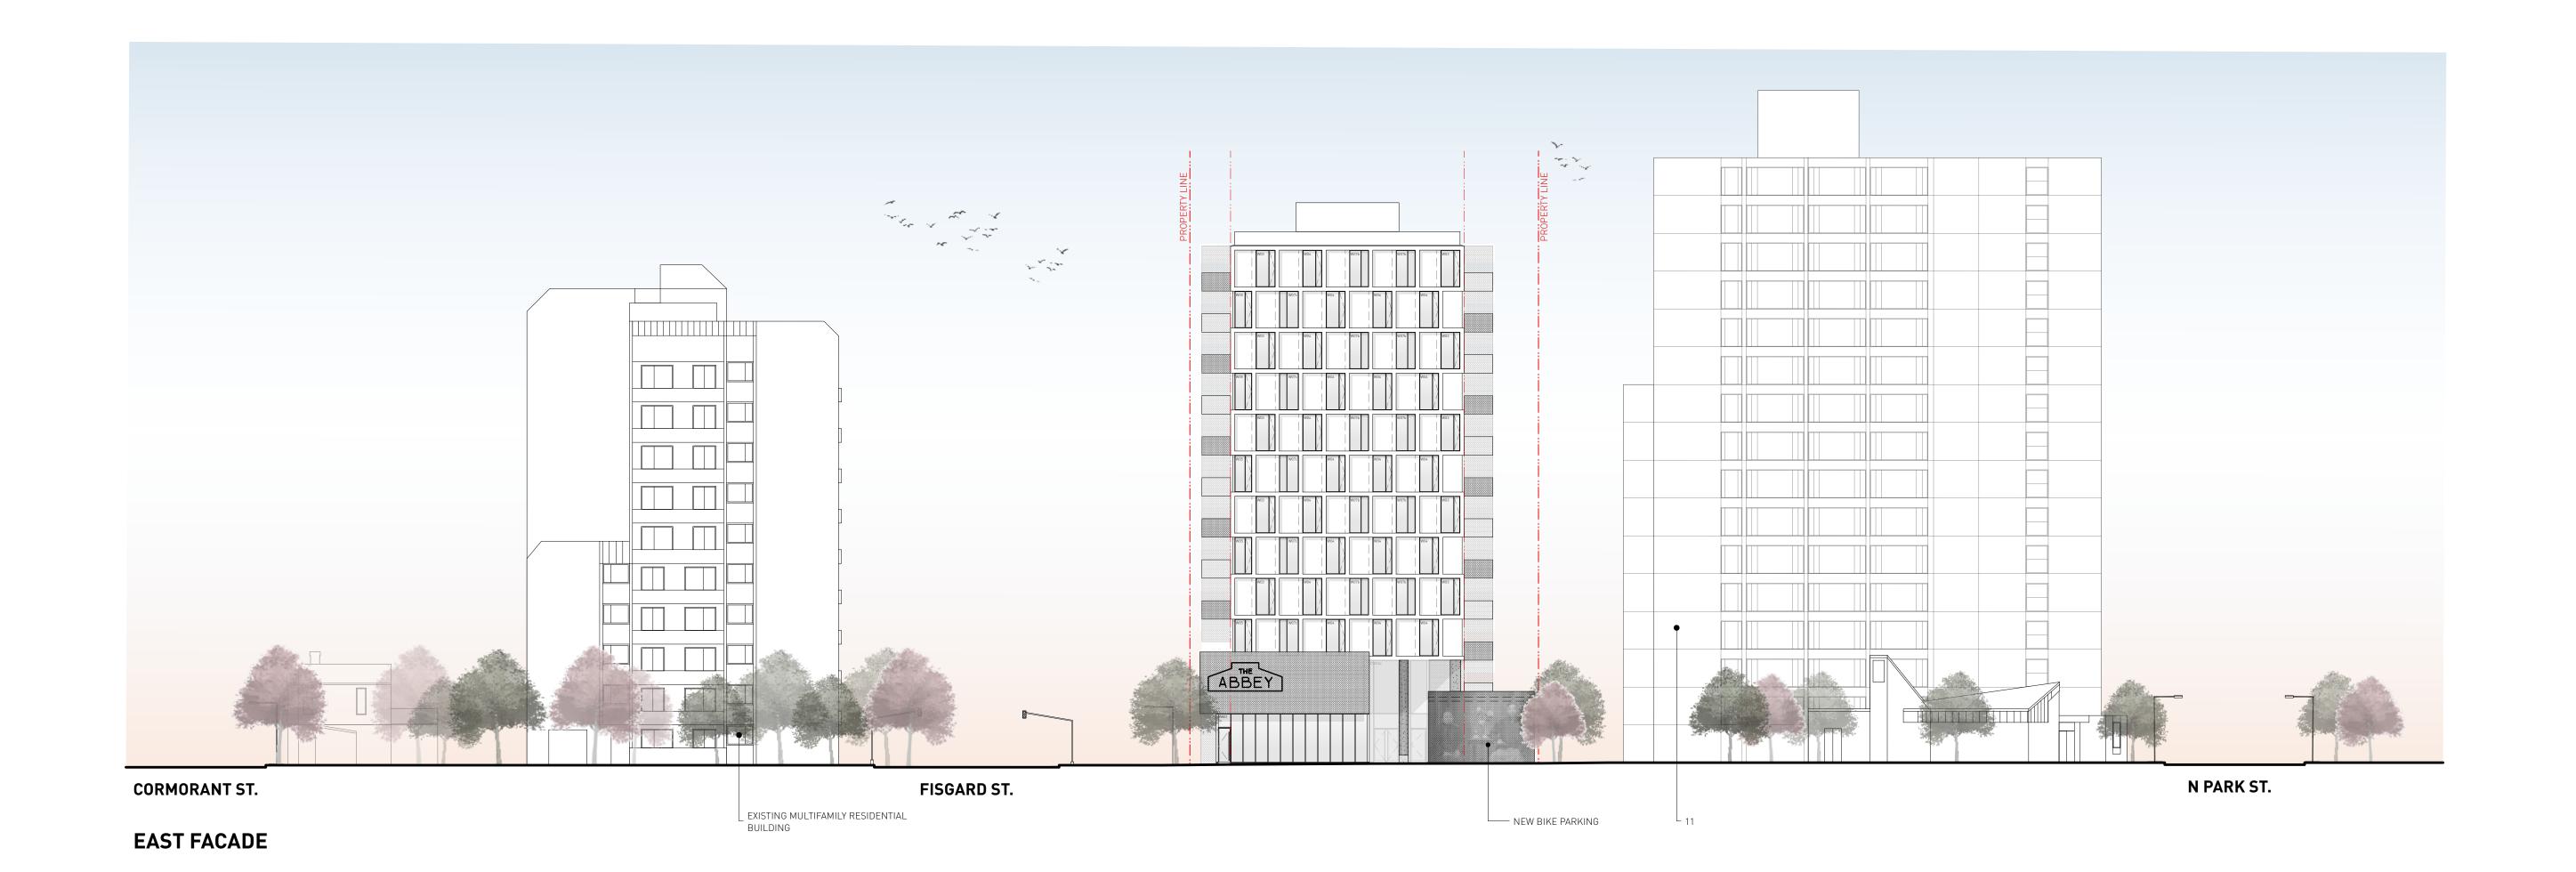


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SHADOW STUDIES

0650 Sheet AG.5



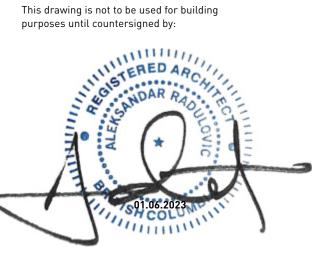
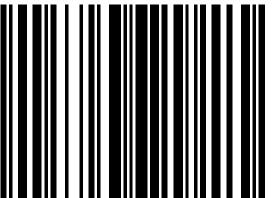
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1702 QUADRA STREET + 862 FISGARD STREET

CONTEXT ELEVATIONS

Sheet AG.6

RESIDENTIAL WINDOW SCHEDULE

• ALL GLAZING TO BE HSTG, LOW E ON SURFACE 2, ARGON-FILLED W/ SUPERSPACERS, LOW REFLECTIVITY COATING TO REDUCE INTERNAL GLARE

ALUMINUM WINDOW WALL SYSTEM

• REFER TO WINDOW SUPPLIER CUT SHEETS FOR TEMPERING REQUIREMENTS

• PROVIDE PRE-FINISHED ALUMINUM FLASHING AT HEADS AND SILLS, COLOUR TO BE SELECTED BY ARCHITECT • GLASS TO BE 3mm CLEAR [UNLESS OTHERWISE NOTED OR REQUIRED BY MANUFACTURING ENGINEER]

ALL INTERIOR CASINGS TO BE GYPSUM BOARD RETURN

• ALL WINDOWS TO MEET NAFS-17 & CANADIAN TEST STANDARDS. ENVELOPE CONSULTANT TO REVIEW TESTING DATA.

• ALL WINDOW SPECIFICATIONS MUST COMPLY OR SURPASS ENERGY CODE CONSULTANT'S ENERGY MODEL ASSUMPTIONS

• REFER TO ENVELOPE CONSULTANT WINDOW INSTALLATION GUIDELINES FOR SILL AND THREE SIDES MEMBRANE DETAILING FOR ALL RESIDENTIAL WINDOWS ENVELOPE CONSULTANT TO REVIEW ALL RESIDENTIAL AND COMMERCIAL GLAZING SHOP DRAWINGS

COMMERCIAL WINDOW SCHEDULE

• ALUMICOR THERMALLY BROKEN STOREFRONT OR APPROVED EQUAL, SSG, ANTI-ROTATION BLOCKS TO BE ALUMINUM OR PVC

• ALL GLAZING TO BE HSTG, LOW E ON SURFACE 2, ARGON-FILLED W/ SUPERSPACERS, LOW REFLECTIVITY COATING TO REDUCE INTERNAL GLARE


• ALL EXTERIOR CURTAINWALL TO BE TEMPERED, BLACK FRAME


• GLASS TO BE 6mm CLEAR & TEMPERED • ALL WINDOW SPECIFICATIONS MUST COMPLY OR SURPASS ENERGY CODE CONSULTANT'S ENERGY MODEL ASSUMPTIONS


• SUPPLY SPANDREL PANEL AS REQUIRED FOR MECHANICAL GRILLE PENETRATIONS OF CURTAIN WALL.


• ENVELOPE CONSULTANT TO REVIEW ALL RESIDENTIAL AND COMMERCIAL GLAZING SHOP DRAWINGS


RESIDENTIAL WINDOW WALL

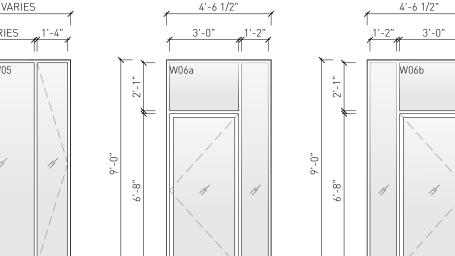

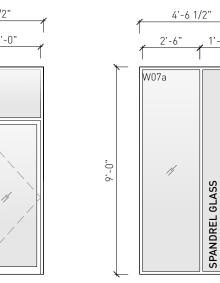


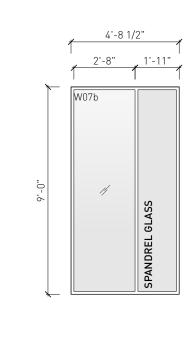

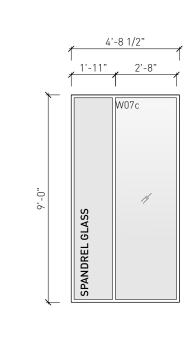


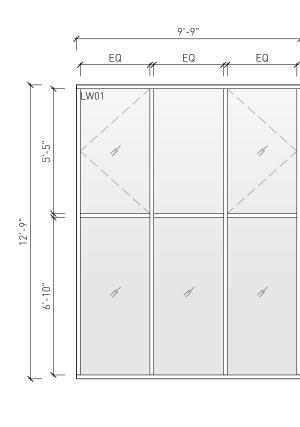



LIVE WORK STOREFRONT

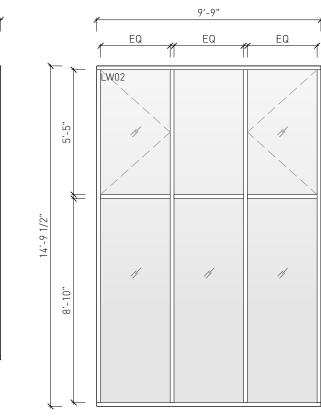


COMMERCIAL STOREFRONT

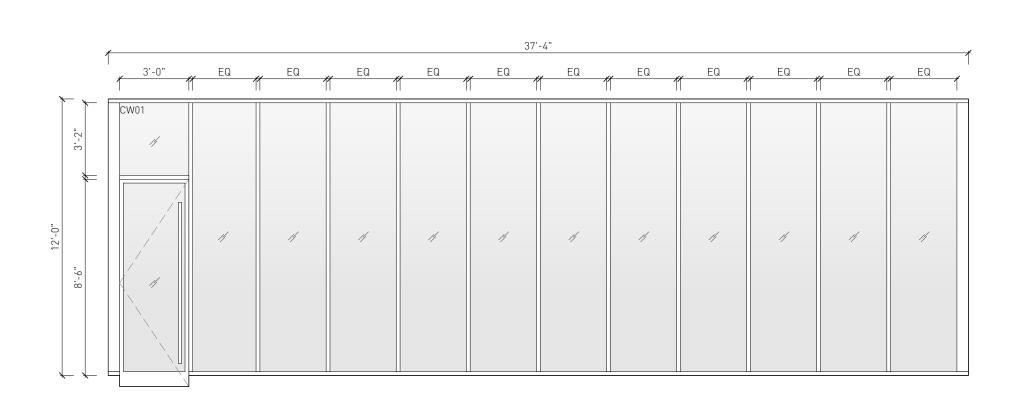


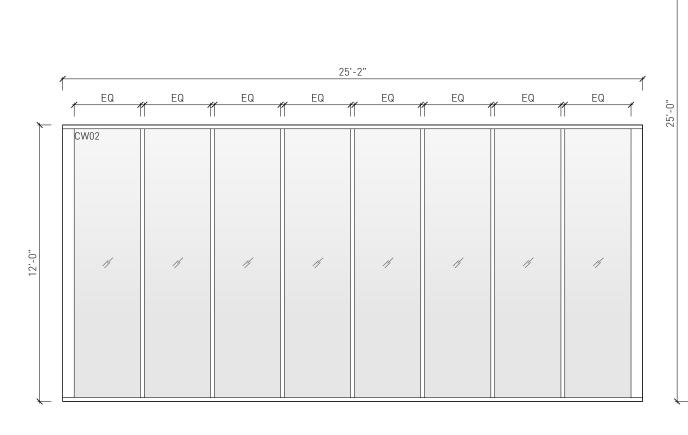

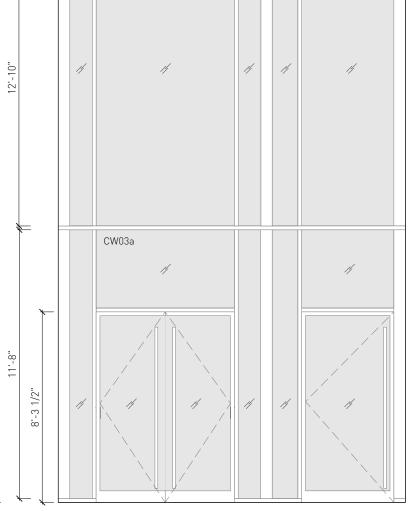

CW03b

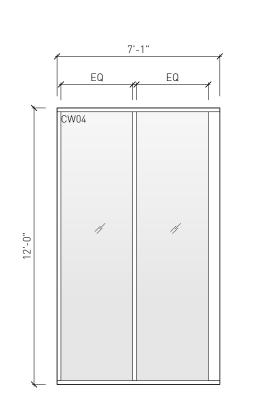

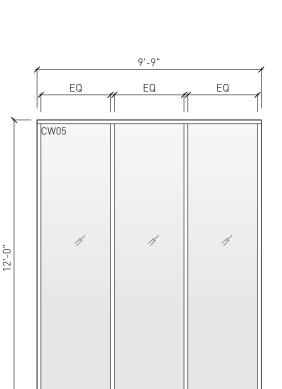

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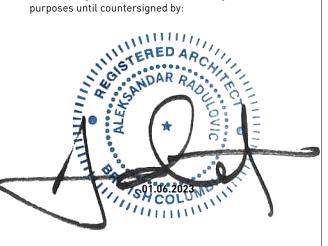
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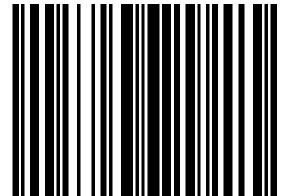
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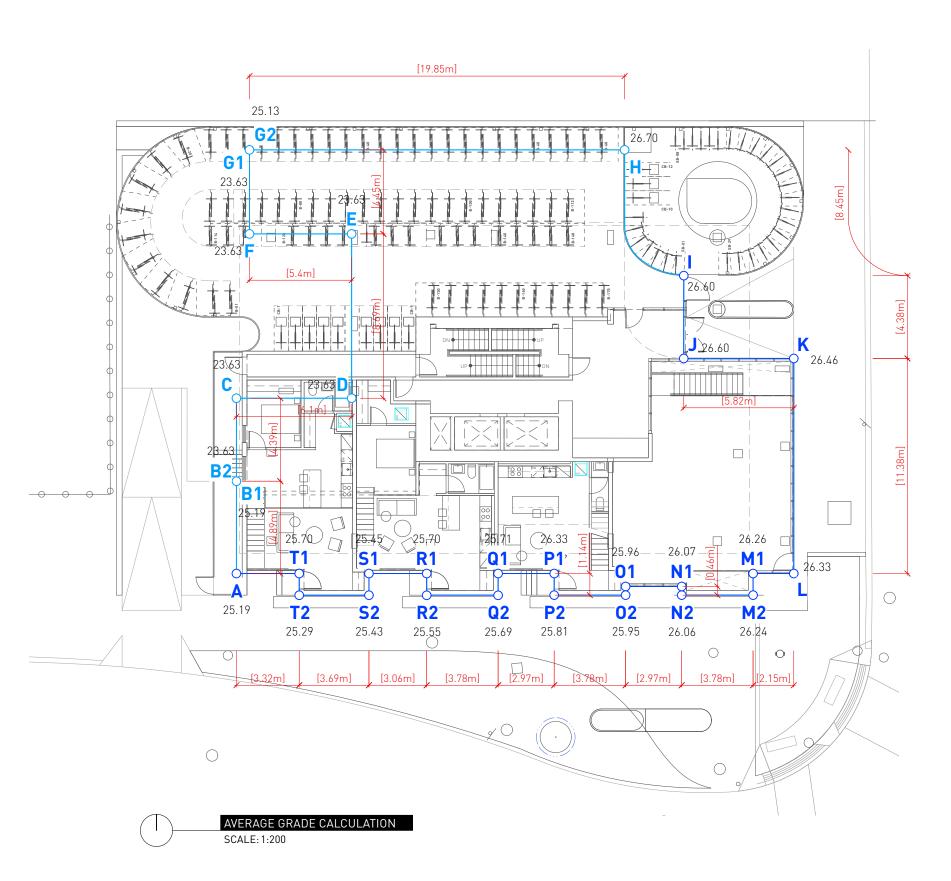
1702 QUADRA STREET + 862 FISGARD STREET

WINDOW & DOOR SCHEDULE

0650 Sheet


Project

AG.7




GRADI	E POINTS	BUILDING PERIMETER
Α	25.19	121.06
B1	25.19	
B2	23.63	
С	23.63	
D	23.63	
E	23.63	
F	23.63	
G1	23.63	
G2	25.13	
Н	26.70	
1	26.60	
J	26.60	
K	26.46	
L	26.33	
M1	26.26	
M2	26.24	
N1	26.07	
N2	26.06	
01	25.96	
02	25.95	
P1	26.33	
P2	25.81	
Q1	25.71	
Q2	25.69	
R1	25.70	
R2	25.55	
S 1	25.45	
S2	25.43	
T1	25.70	
T2	25.29	

CALCULATION:	AVERAGES	DISTANCE	TOTALS
A & B1	25.19	4.89	123.18
B2 & C	23.63	4.39	103.74
C & D	23.63	6.1	144.14
D & E	23.63	8.69	205.34
E&F	23.63	5.4	127.60
F & G1	23.63	4.45	105.15
G2 & H	25.92	19.85	514.41
H & I	26.65	8.45	225.19
l & J	26.60	4.38	116.51
J & K	26.53	5.82	154.40
K & L	26.40	11.38	300.38
L & M	26.30	2.15	56.53
M1 & M2	26.25	1.14	29.93
M2 & N2	26.15	3.78	98.85
N2 & N1	26.07	0.46	11.99
N1 & 01	26.02	2.97	77.28
01 & 02	25.96	0.46	11.94
02 & P2	25.88	3.78	97.83
P2 & P1	26.07	1.14	29.72
P1 & Q1	26.02	2.97	77.28
Q1 & Q2	25.70	1.14	29.30
Q2 & R2	25.62	3.78	96.84
R2 & R1	25.63	1.14	29.21
R1 & S1	25.58	3.06	78.28
S1 & S2	25.44	1.14	29.00
S2 & T2	25.36	3.69	93.58
T2 & T1	25.50	1.14	29.08
T1 & A	25.45	3.32	84.48
		121.06	3,081.11

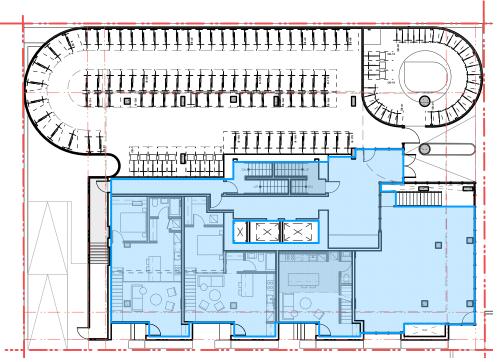

339.8 m²

1 LEVEL 01 FAR PLAN
A0.3 SCALE:1:300

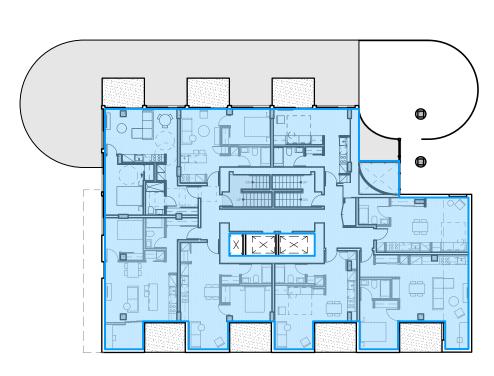


457.6 m²

2 LEVEL 02 FAR PLAN
A0.3 SCALE: 1:300



437.5 m²

3 LEVEL 03 FAR PLAN
A0.3 SCALE: 1:300

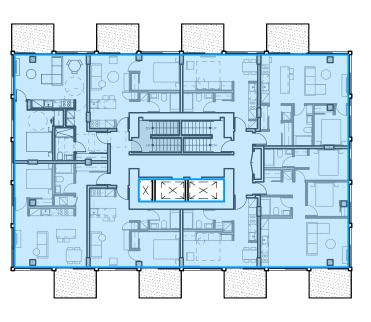

437.5 m²

4 LEVEL 04-12 FAR PLAN
A0.3 SCALE: 1:300

REVISION NO.1			May 31, 202			
SITE INFORMATION						
LEGAL DESCRIPTION	ZONING: R3-C LOTS: A, 1, 2	SUBURBAN LOT: 4 PLAN:	CITY 01516011			
CIVIC ADDRESS	1702 QUADRA STREET, VICTORIA, BC					
ZONING	CURRENT [R-3C, RESIDENTIAL MULTI- FAMILY]	PROPOSED [R-3C, COMMERCIAL RESIDENTIAL]	1702 QUADRA PROJECT STATS			
SITE AREA [m²]			947.78			
GROSS FLOOR AREA [m²]			5212.56			
FLOOR SPACE RATIO	3.0	5.50	5.50			
SITE COVERAGE (%)			78.7%			
OPEN SITE SPACE (%)			21.3%			
AVERAGE GRADE			25.45 m			
BUILDING HEIGHT	NO BUILDING SHALL EXCEED 37 METRES IN HEIGHT	36 METRES	13 STOREYS [42.70m]			
SETBACKS						
NORTH [SIDE]	6.0m	3.7m	5.5m [EXCLUDING BIKE PARKING ENCLOSURE]			
EAST [FRONT]	4.5m	0.0m	0.7m [BASE] 3.0m [TOWER]			
SOUTH [FLANKING]	4.5m	3.0m	0.82m [BASE] 3.0m [TOWER]			
WEST [REAR]	6.0m	4.8m	6.5m [EXCLUDING BIKE PARKING ENCLOSURE]			

BUILDING DATA			1
UNIT TYPES	AVERAGE AREA (M²)	UNIT COUNT	TOTAL AREA (M²)
RESIDENTIAL			
BACHELOR	31.72	23	729.50
1 BEDROOM UNIT	48.28	55	2,655.43
2 BEDROOM UNIT	67.89	10	678.90
OTHER			
COMMERCIAL UNIT [S]	86.32	1	86.32
WORK / LIVE	60.66	3	63.09
TOTAL		92	
TOTAL RENTABLE AREA			4,213.24

RESIDENTIAL UNIT MIX	UNIT COUNT	%
BACHELOR	23	25%
1 BEDROOM UNIT	55	60%
2 BEDROOM UNIT	10	11%

SITE DATA	
	AREA [m²]
LEVEL 01	339.80
LEVEL 02	457.60
LEVEL 03	437.50
LEVEL 04	437.50
LEVEL 05	437.50
LEVEL 06	437.50
LEVEL 07	437.50
LEVEL 08	437.50
LEVEL 09	437.50
LEVEL 10	437.50
LEVEL 11	437.50
LEVEL 12	437.50
LEVEL 13	40.16
TOTAL GROSS FLOOR AREA	5212.56
BUILDING FOOTPRINT	745.69

	UNIT COUNT	RATE	REQUIRED STALLS
RESIDENTIAL			
UNIT < 45 M ²	44	0.85 STALLS / UNIT	37
UNIT 45-70 M ²	47	1.0 STALLS / UNIT	47
UNIT > 70 M ²	0	1.45 STALLS / UNIT	0
VISITOR	91	0.1 STALLS / UNIT	9
COMMERCIAL			
RESTAURANT	86.32 m ²	1.0 STALLS / 20m ²	4
TOTAL REQUIRED			98
TOTAL PROPOSED			2

	UNIT COUNT	RATE	REQUIRED STALLS
LONG TERM			
UNIT < 45 M ²	44	1.0 STALLS / UNIT	44
UNIT => 45 M ²	47	1.25 STALLS / UNIT	32
RESTAURANT	86.32 m ²	1.0 STALLS / 400m ²	1
TOTAL REQUIRED			77
TOTAL PROPOSED			170
SHORT TERM			
RESIDENTIAL	91	0.1 STALLS / UNIT	9.1
RESTAURANT	86.32 m ²	1.0 STALLS / 100m ²	1
TOTAL REQUIRED		'	11

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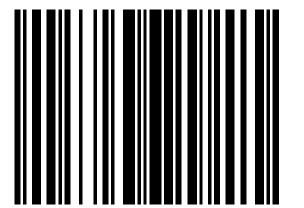
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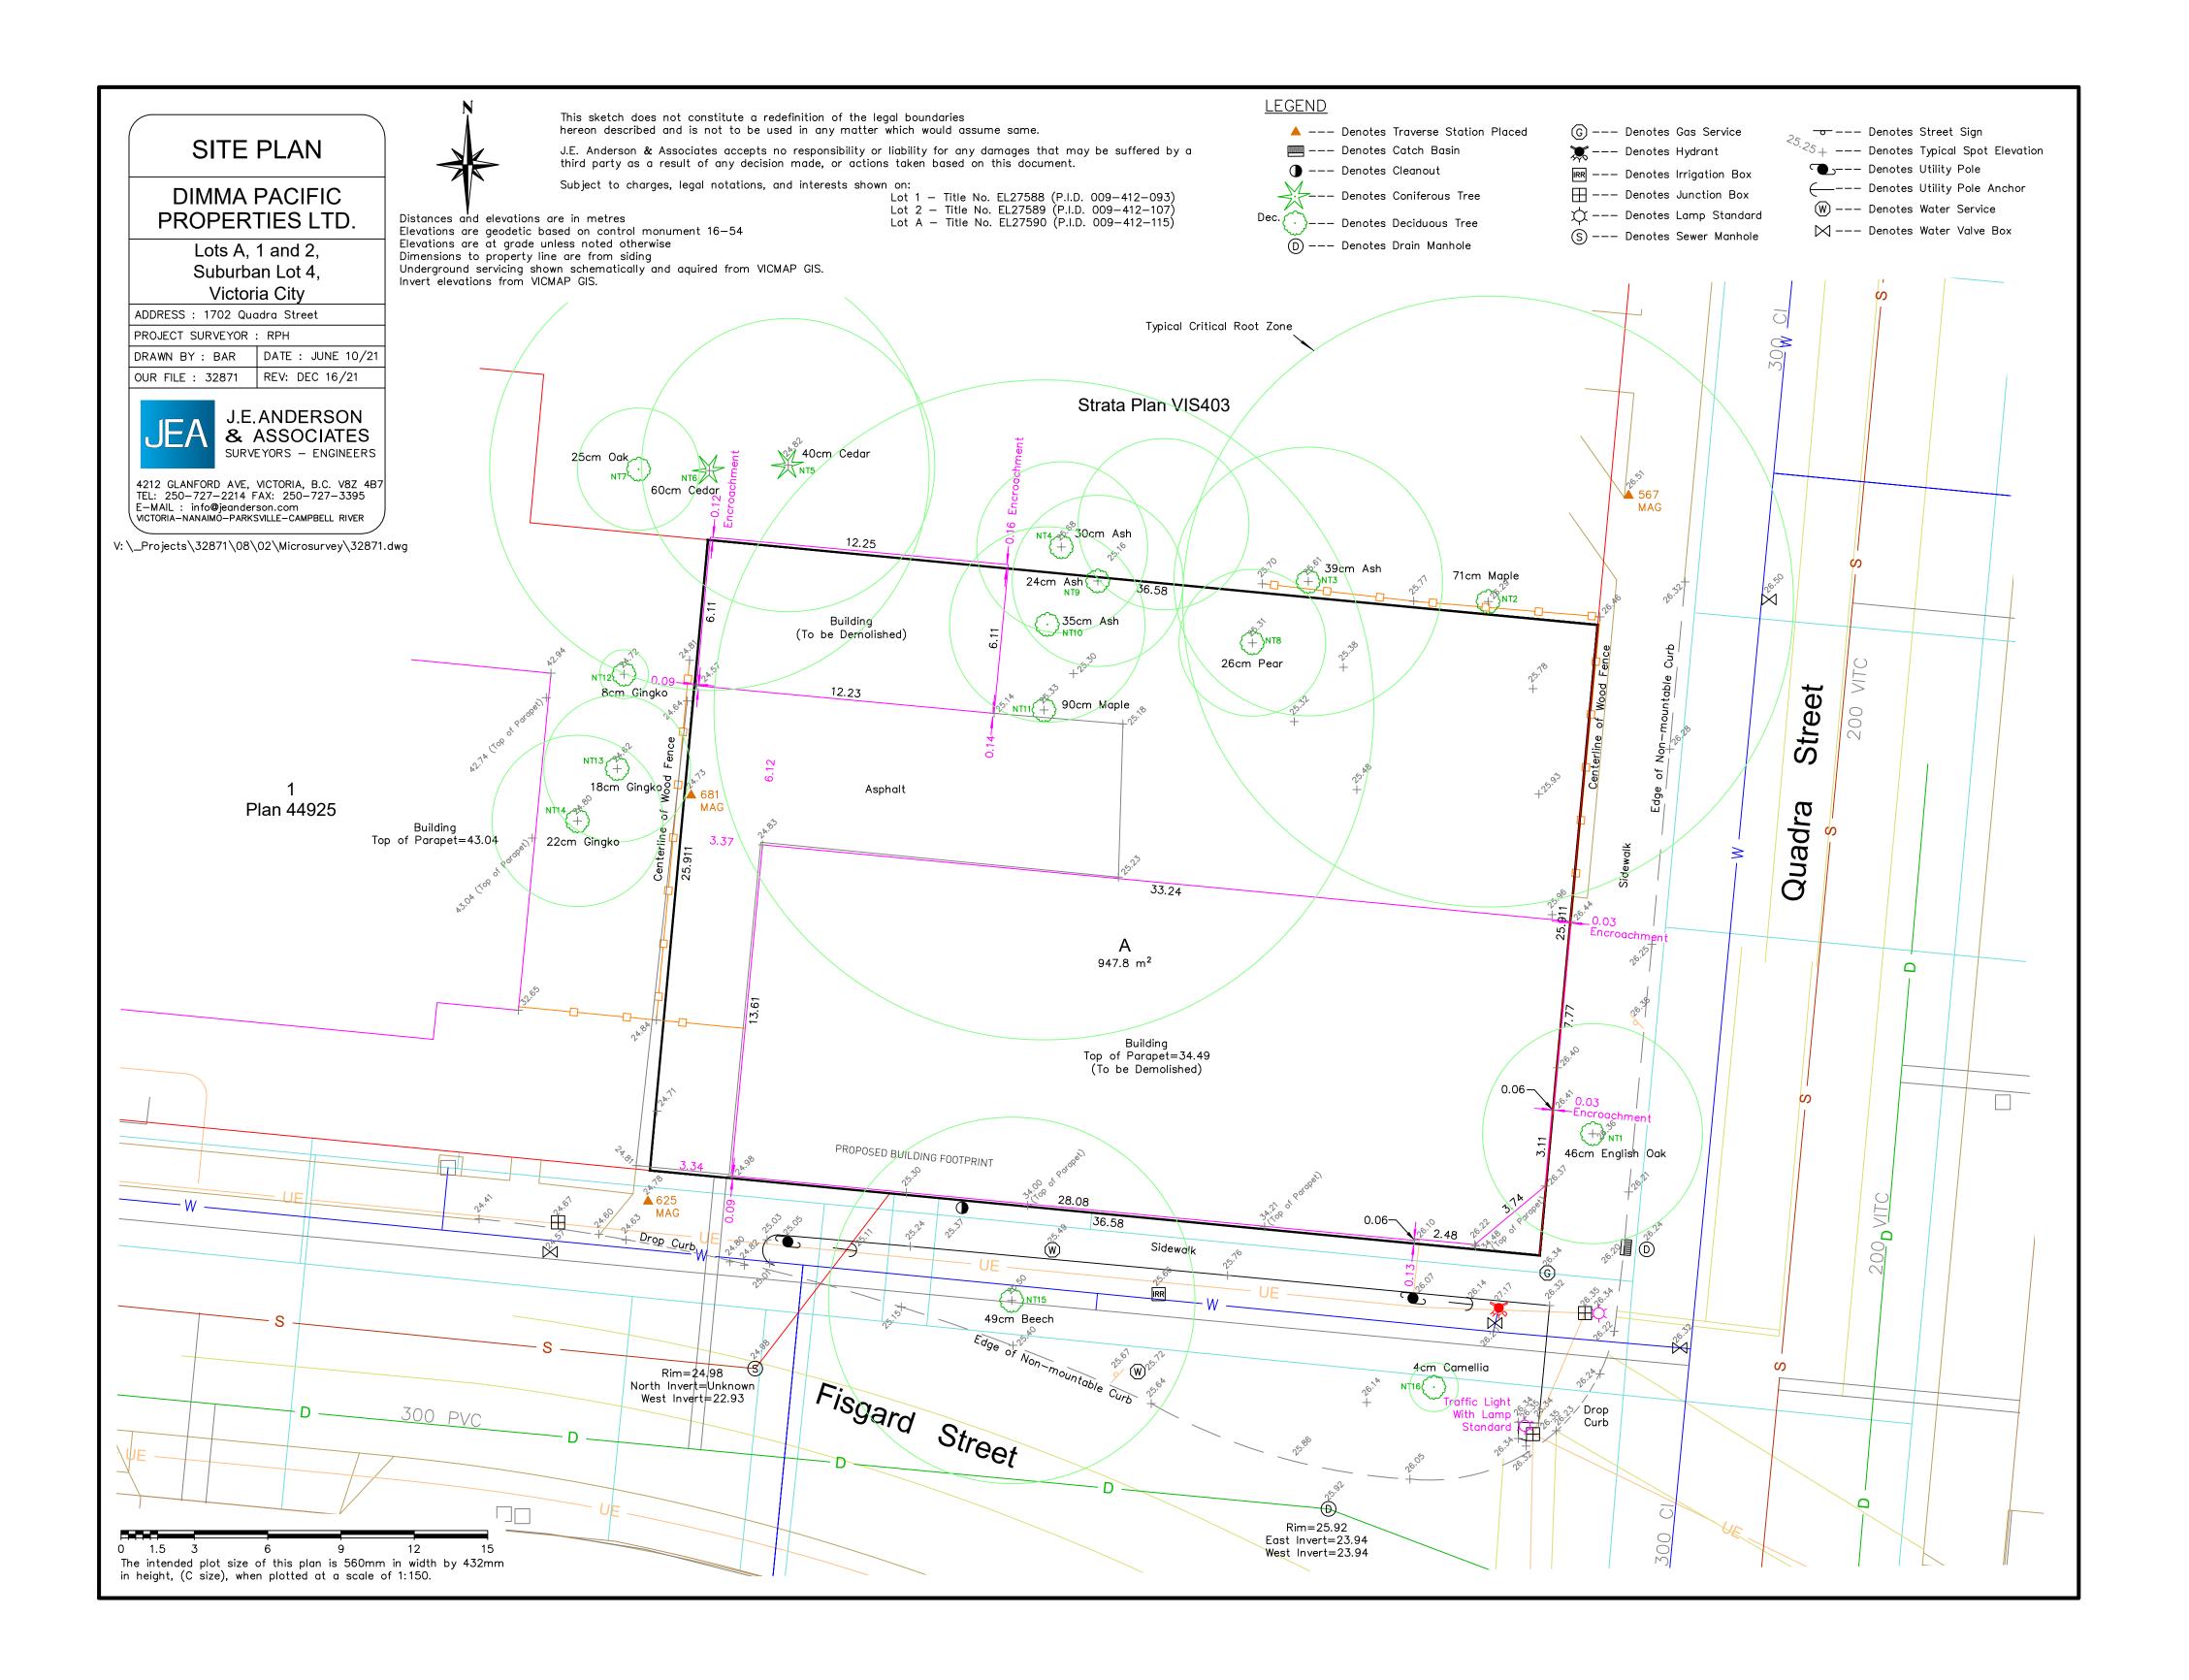
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1702 QUADRA STREET + 862 FISGARD STREET

ZONING CALCULATIONS Project 0650

Sheet AG.8



1 SITE SURVEY BY OTHERS
AG.5 SCALE: NTS

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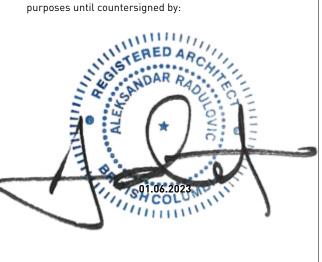
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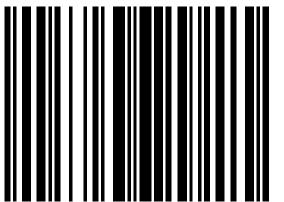
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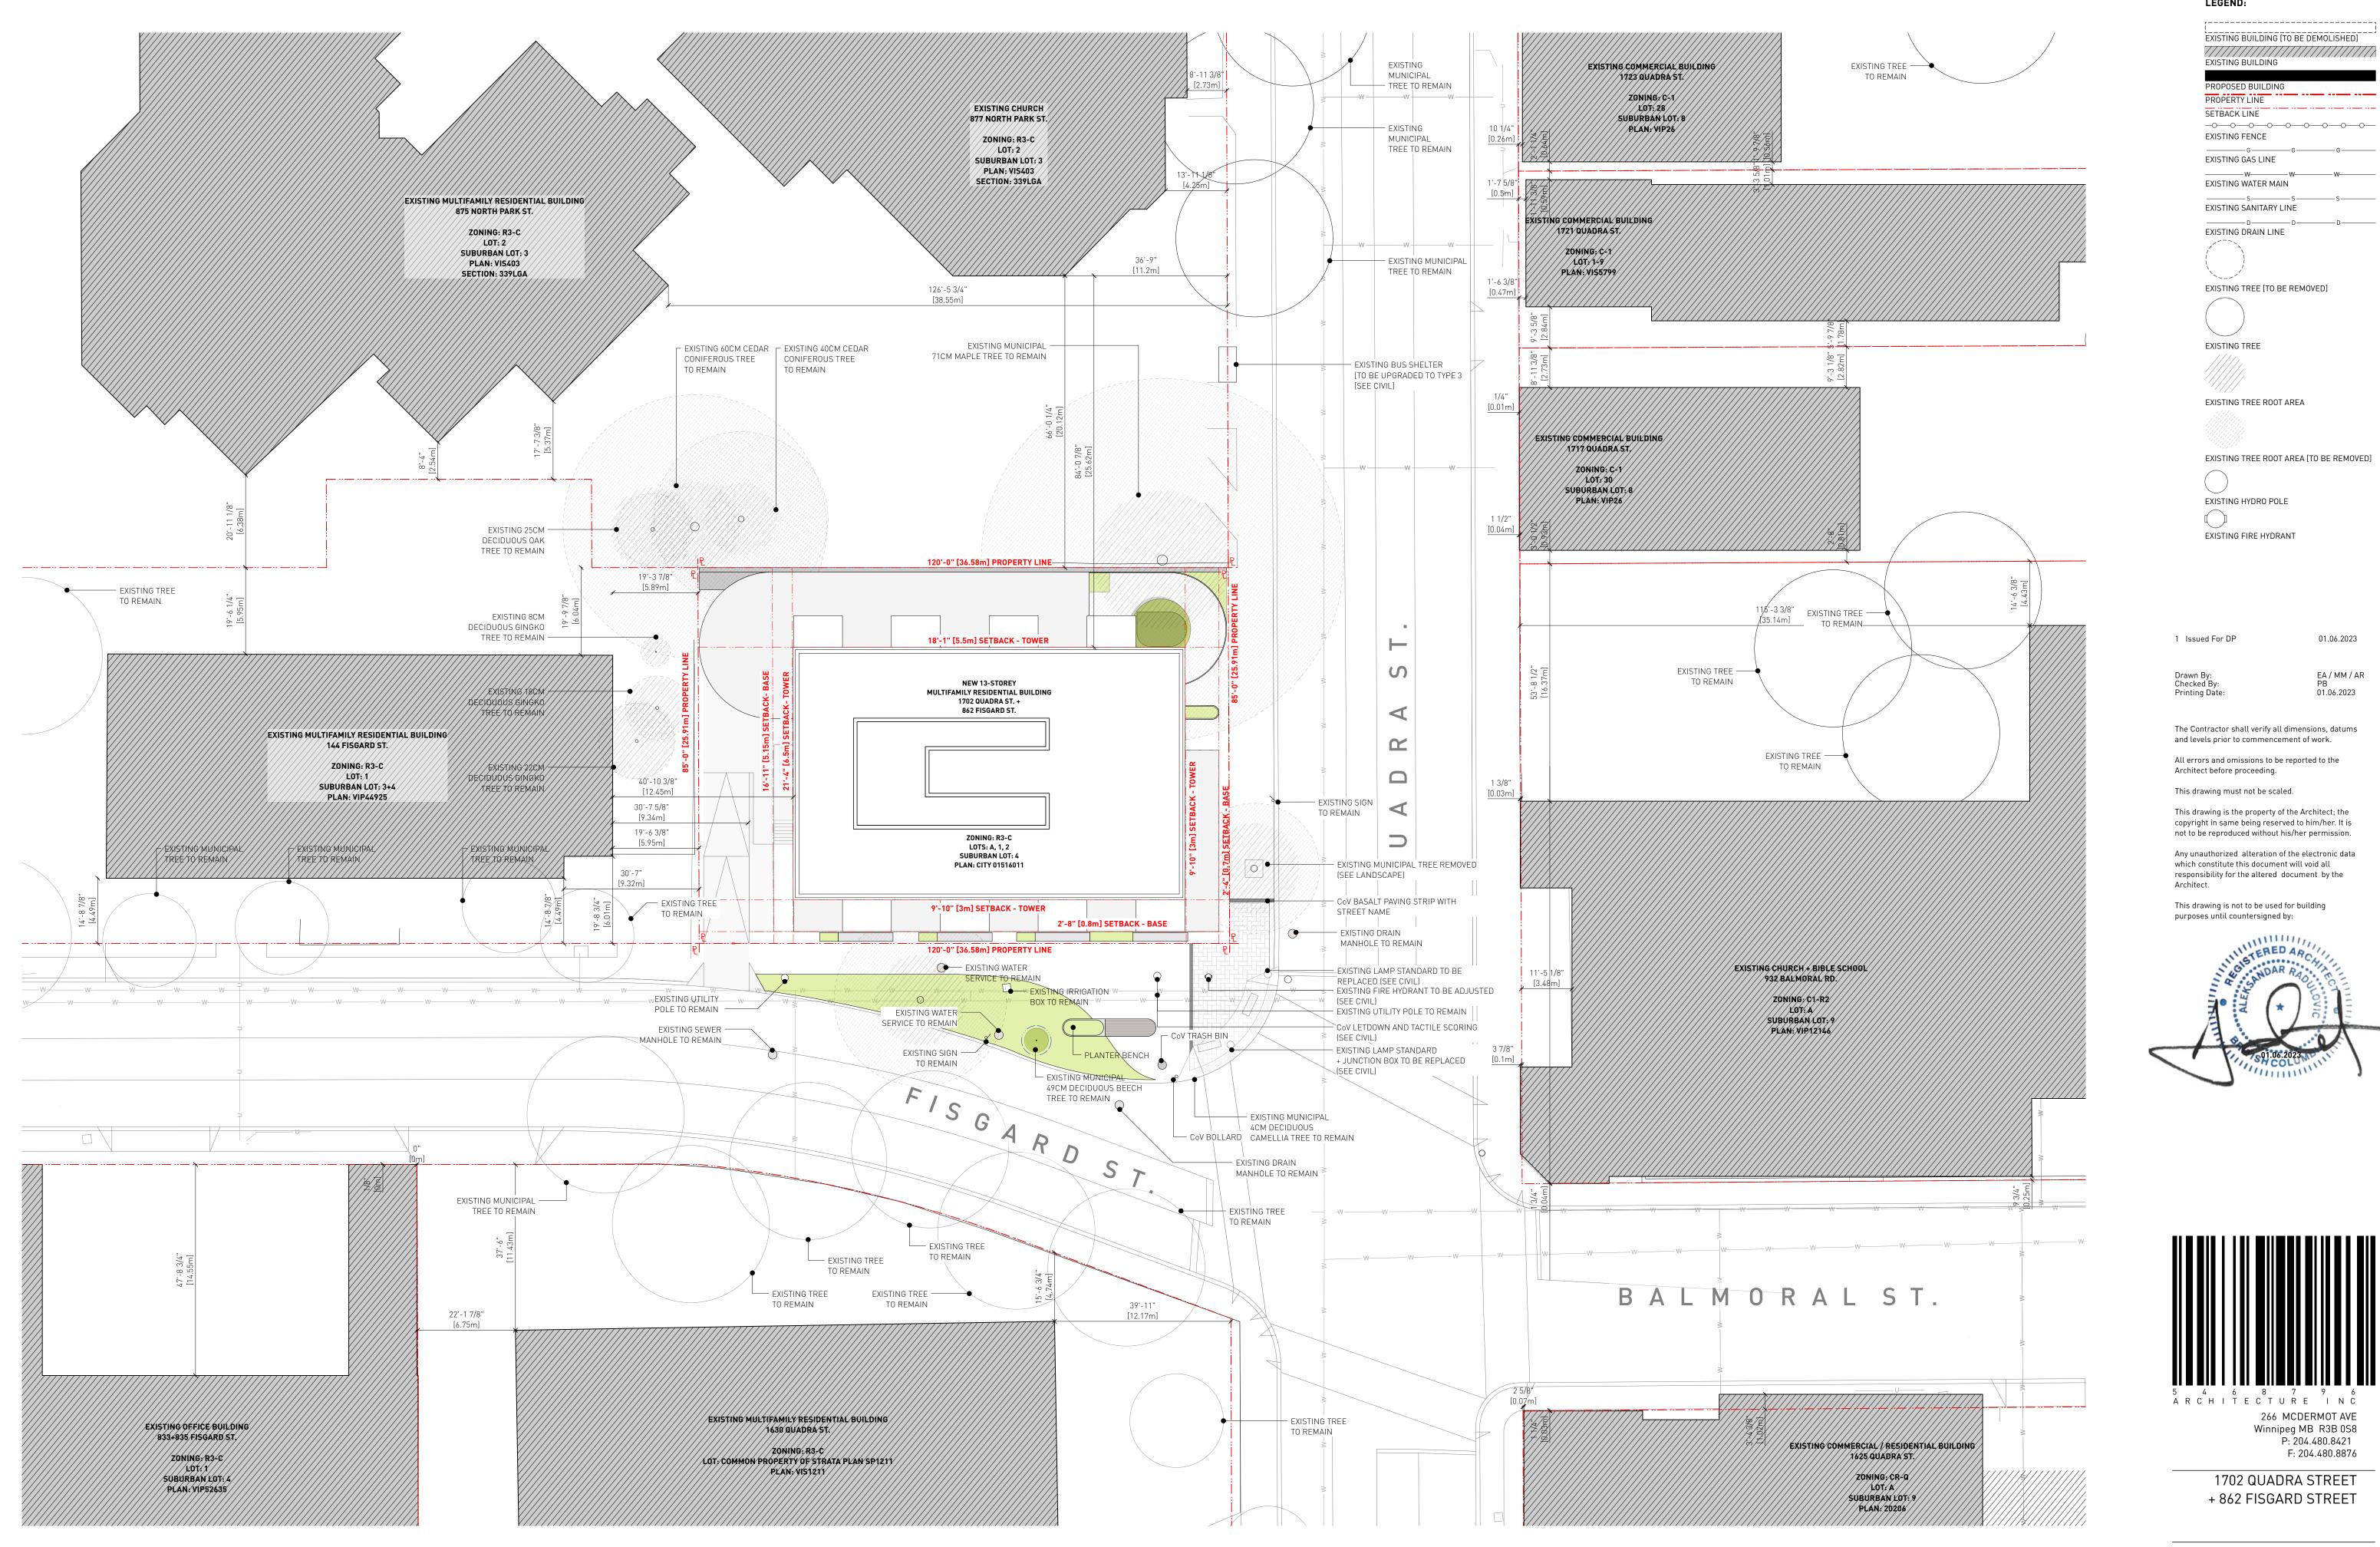
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SITE SURVEY

0650 Sheet

Project

AG.9



1 CONTEXT SITE PLAN
AG.6 SCALE: 1:200

LEGEND:

EXISTING BUILDING [TO BE DEMOLISHED]

EXISTING BUILDING

SETBACK LINE $-\bigcirc-\bigcirc-\bigcirc-\bigcirc-\bigcirc-\bigcirc-\bigcirc-\bigcirc-\bigcirc-\bigcirc-$ EXISTING FENCE

EXISTING WATER MAIN _____s___s___s____s

EXISTING SANITARY LINE EXISTING DRAIN LINE

EXISTING TREE [TO BE REMOVED]

EXISTING TREE ROOT AREA [TO BE REMOVED]

EXISTING HYDRO POLE

EXISTING FIRE HYDRANT

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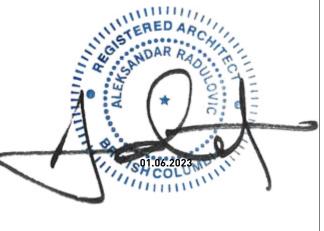
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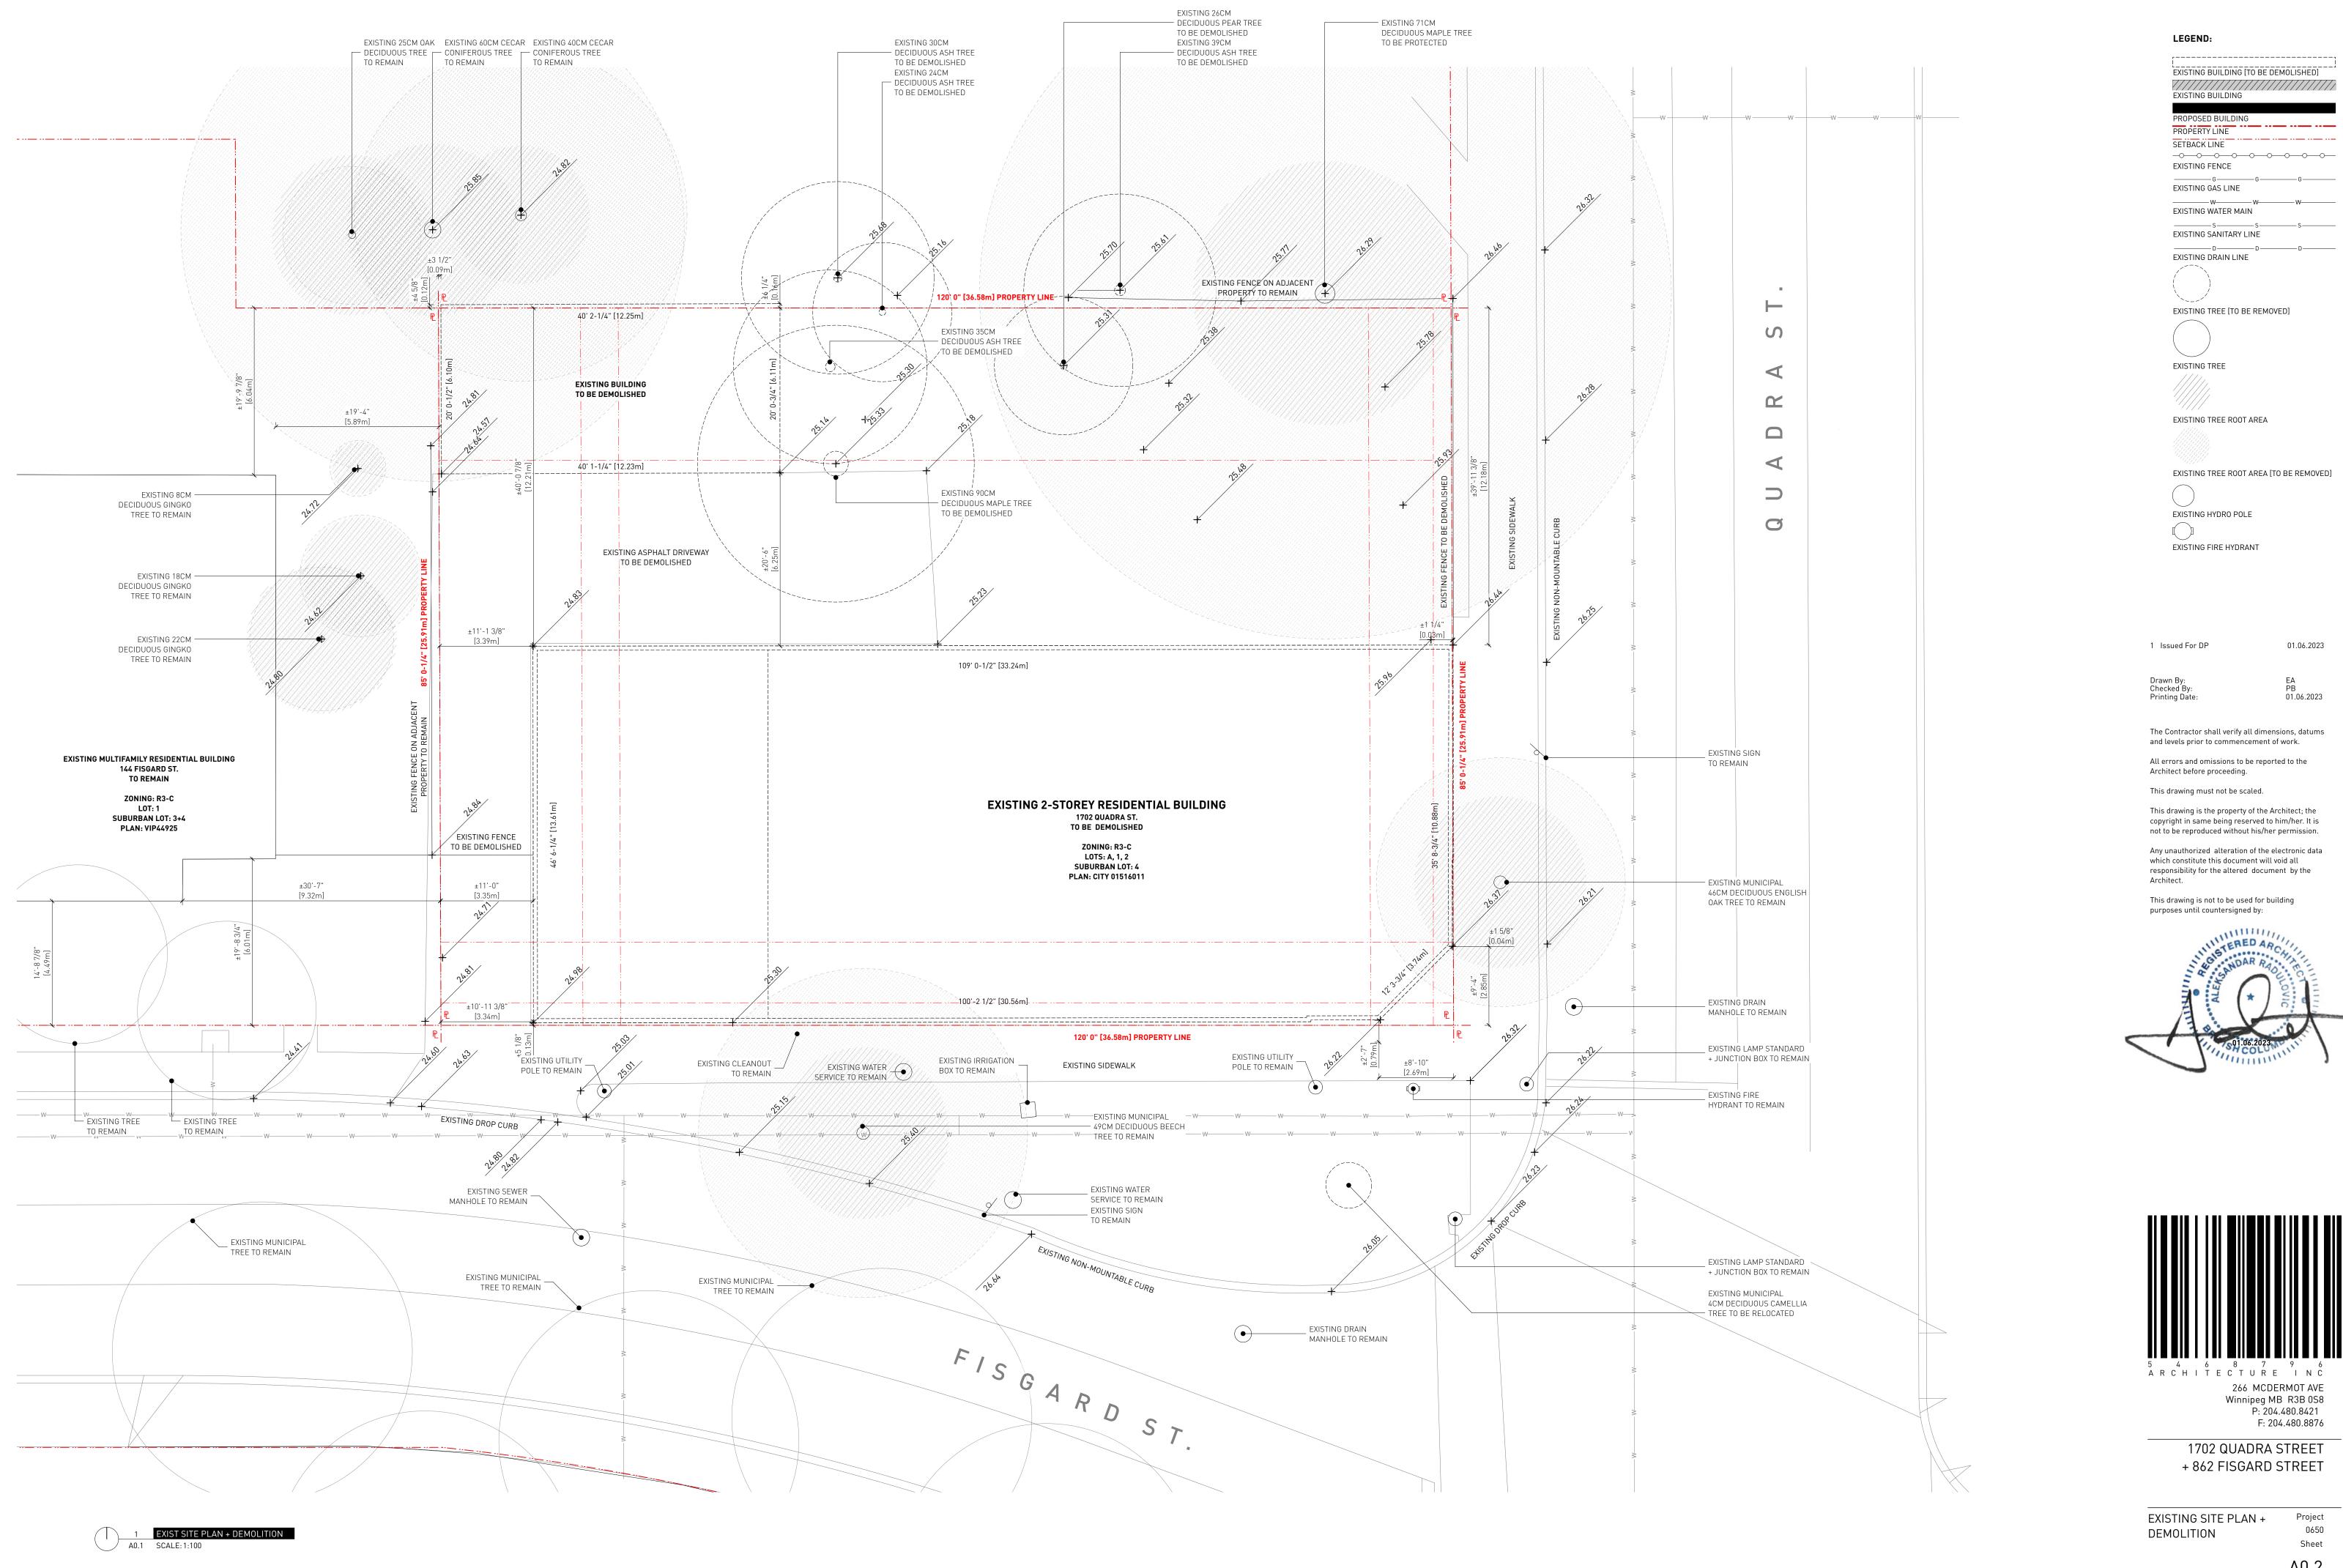


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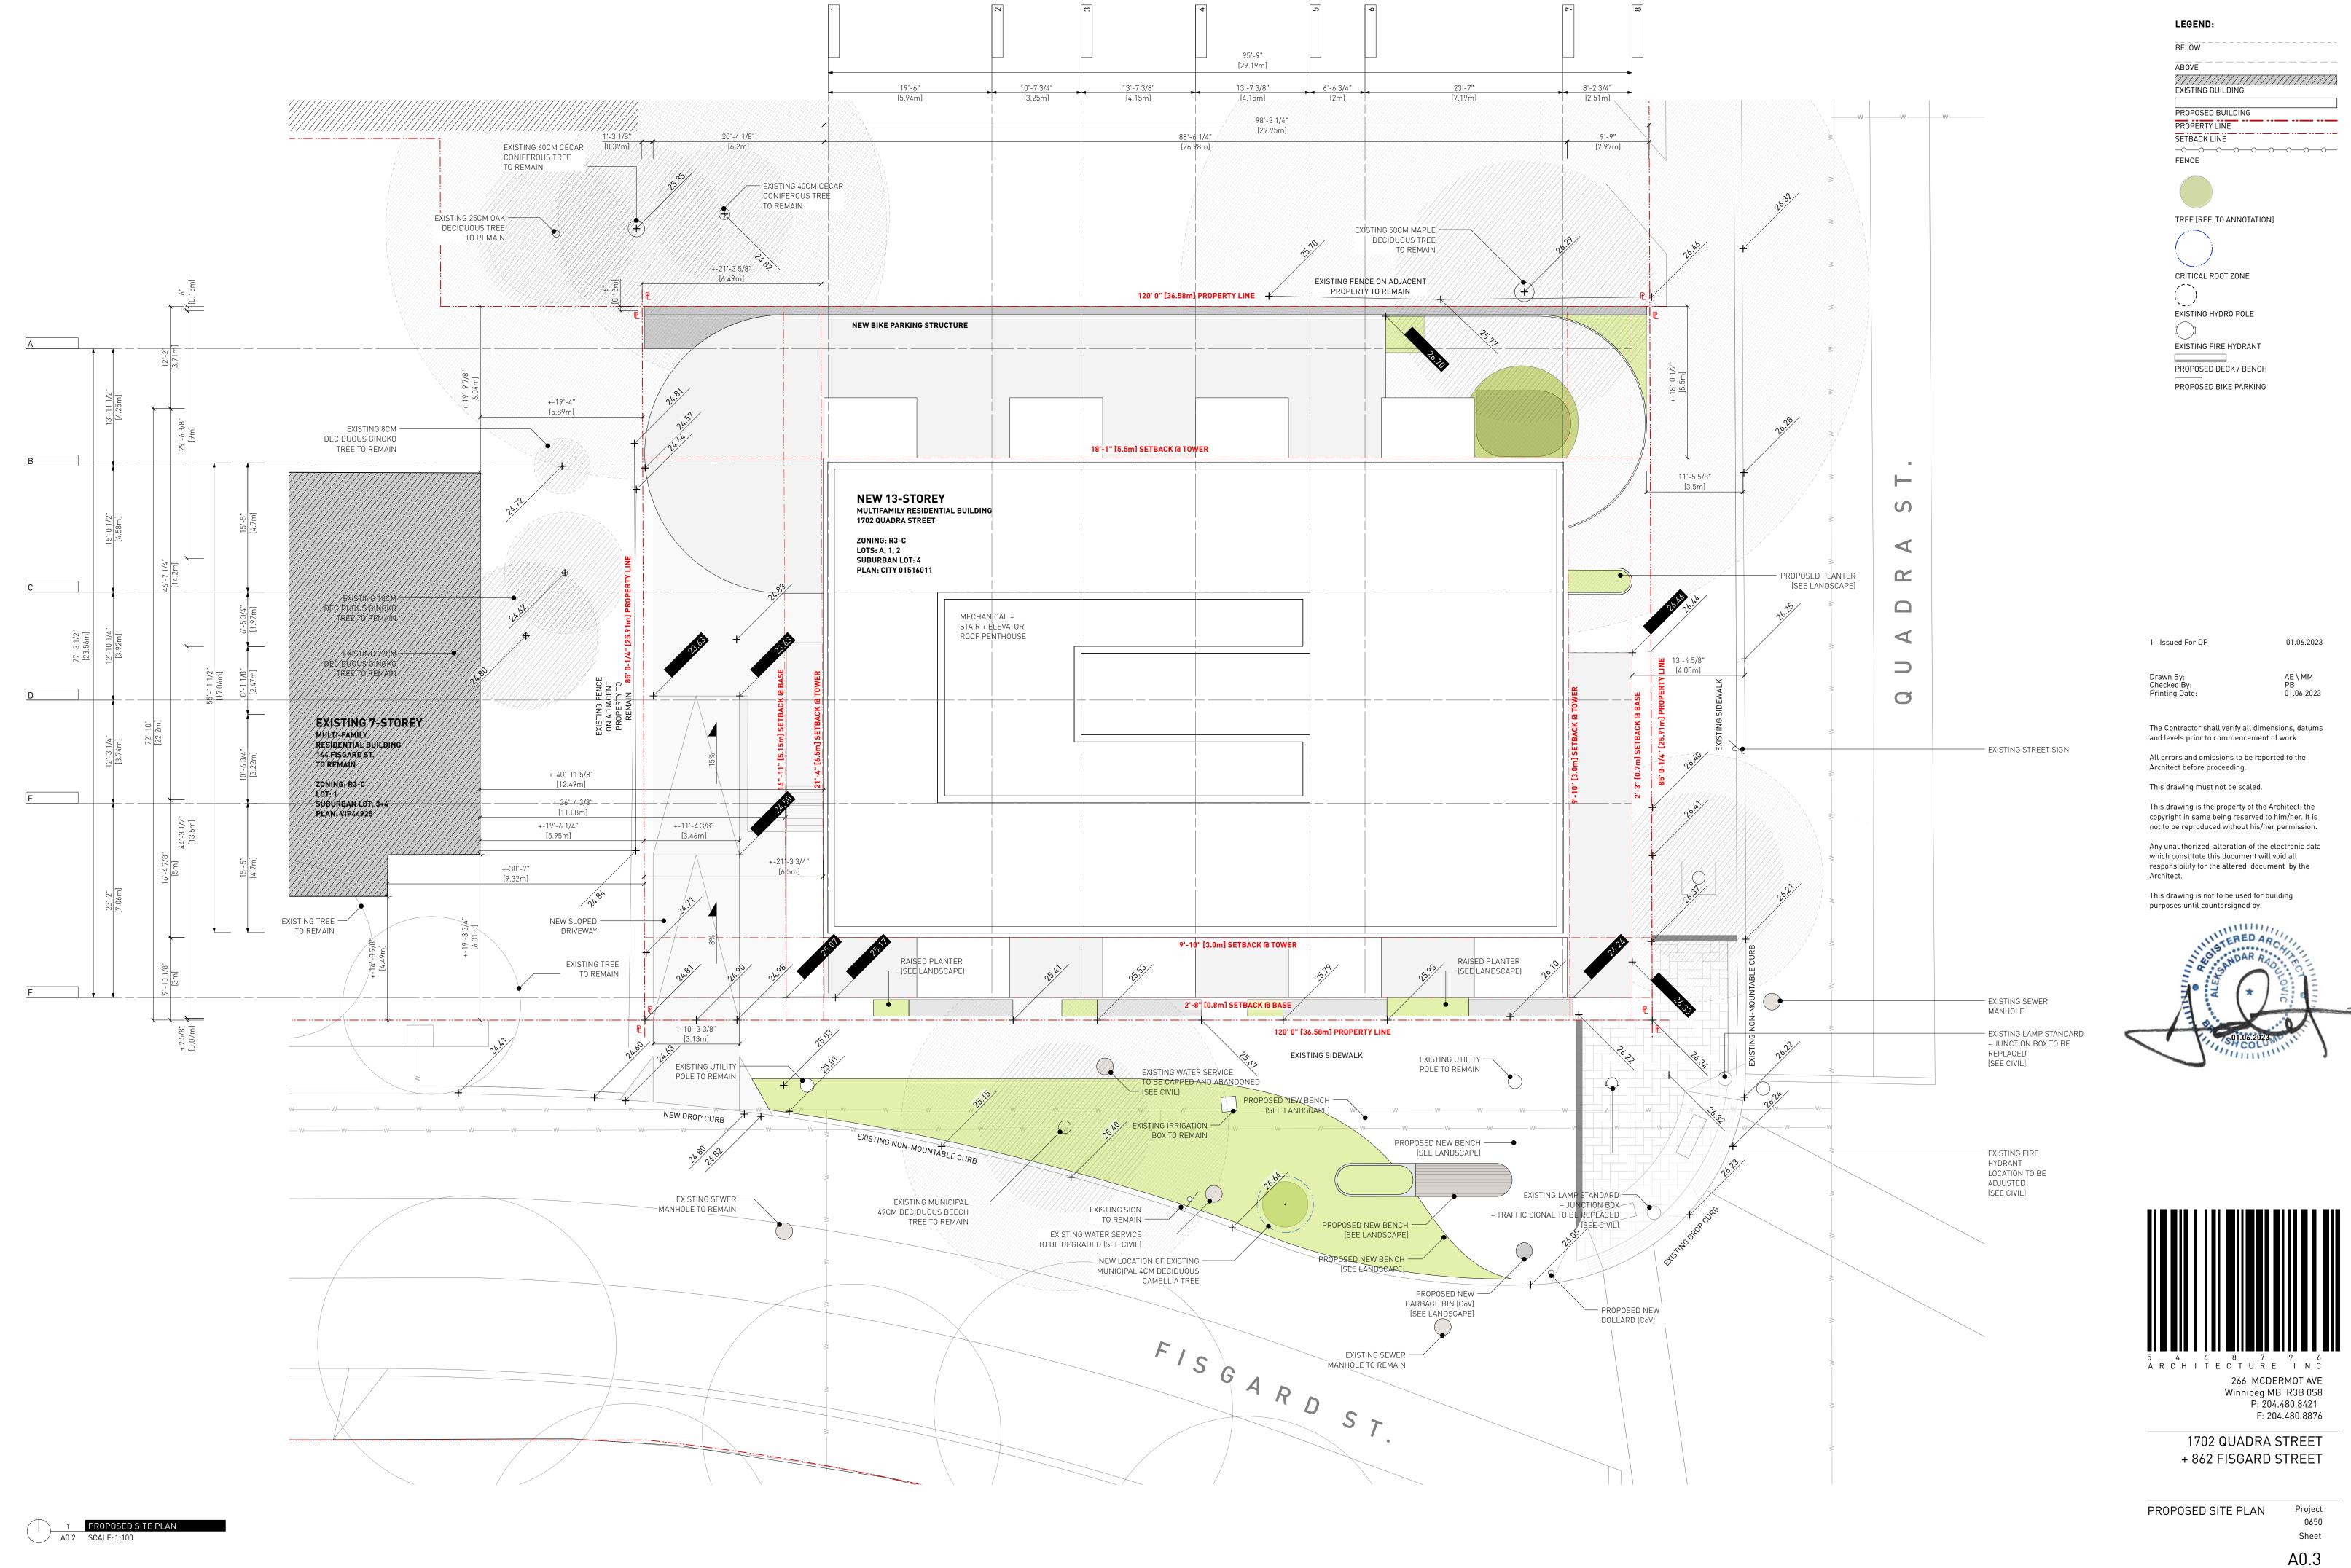
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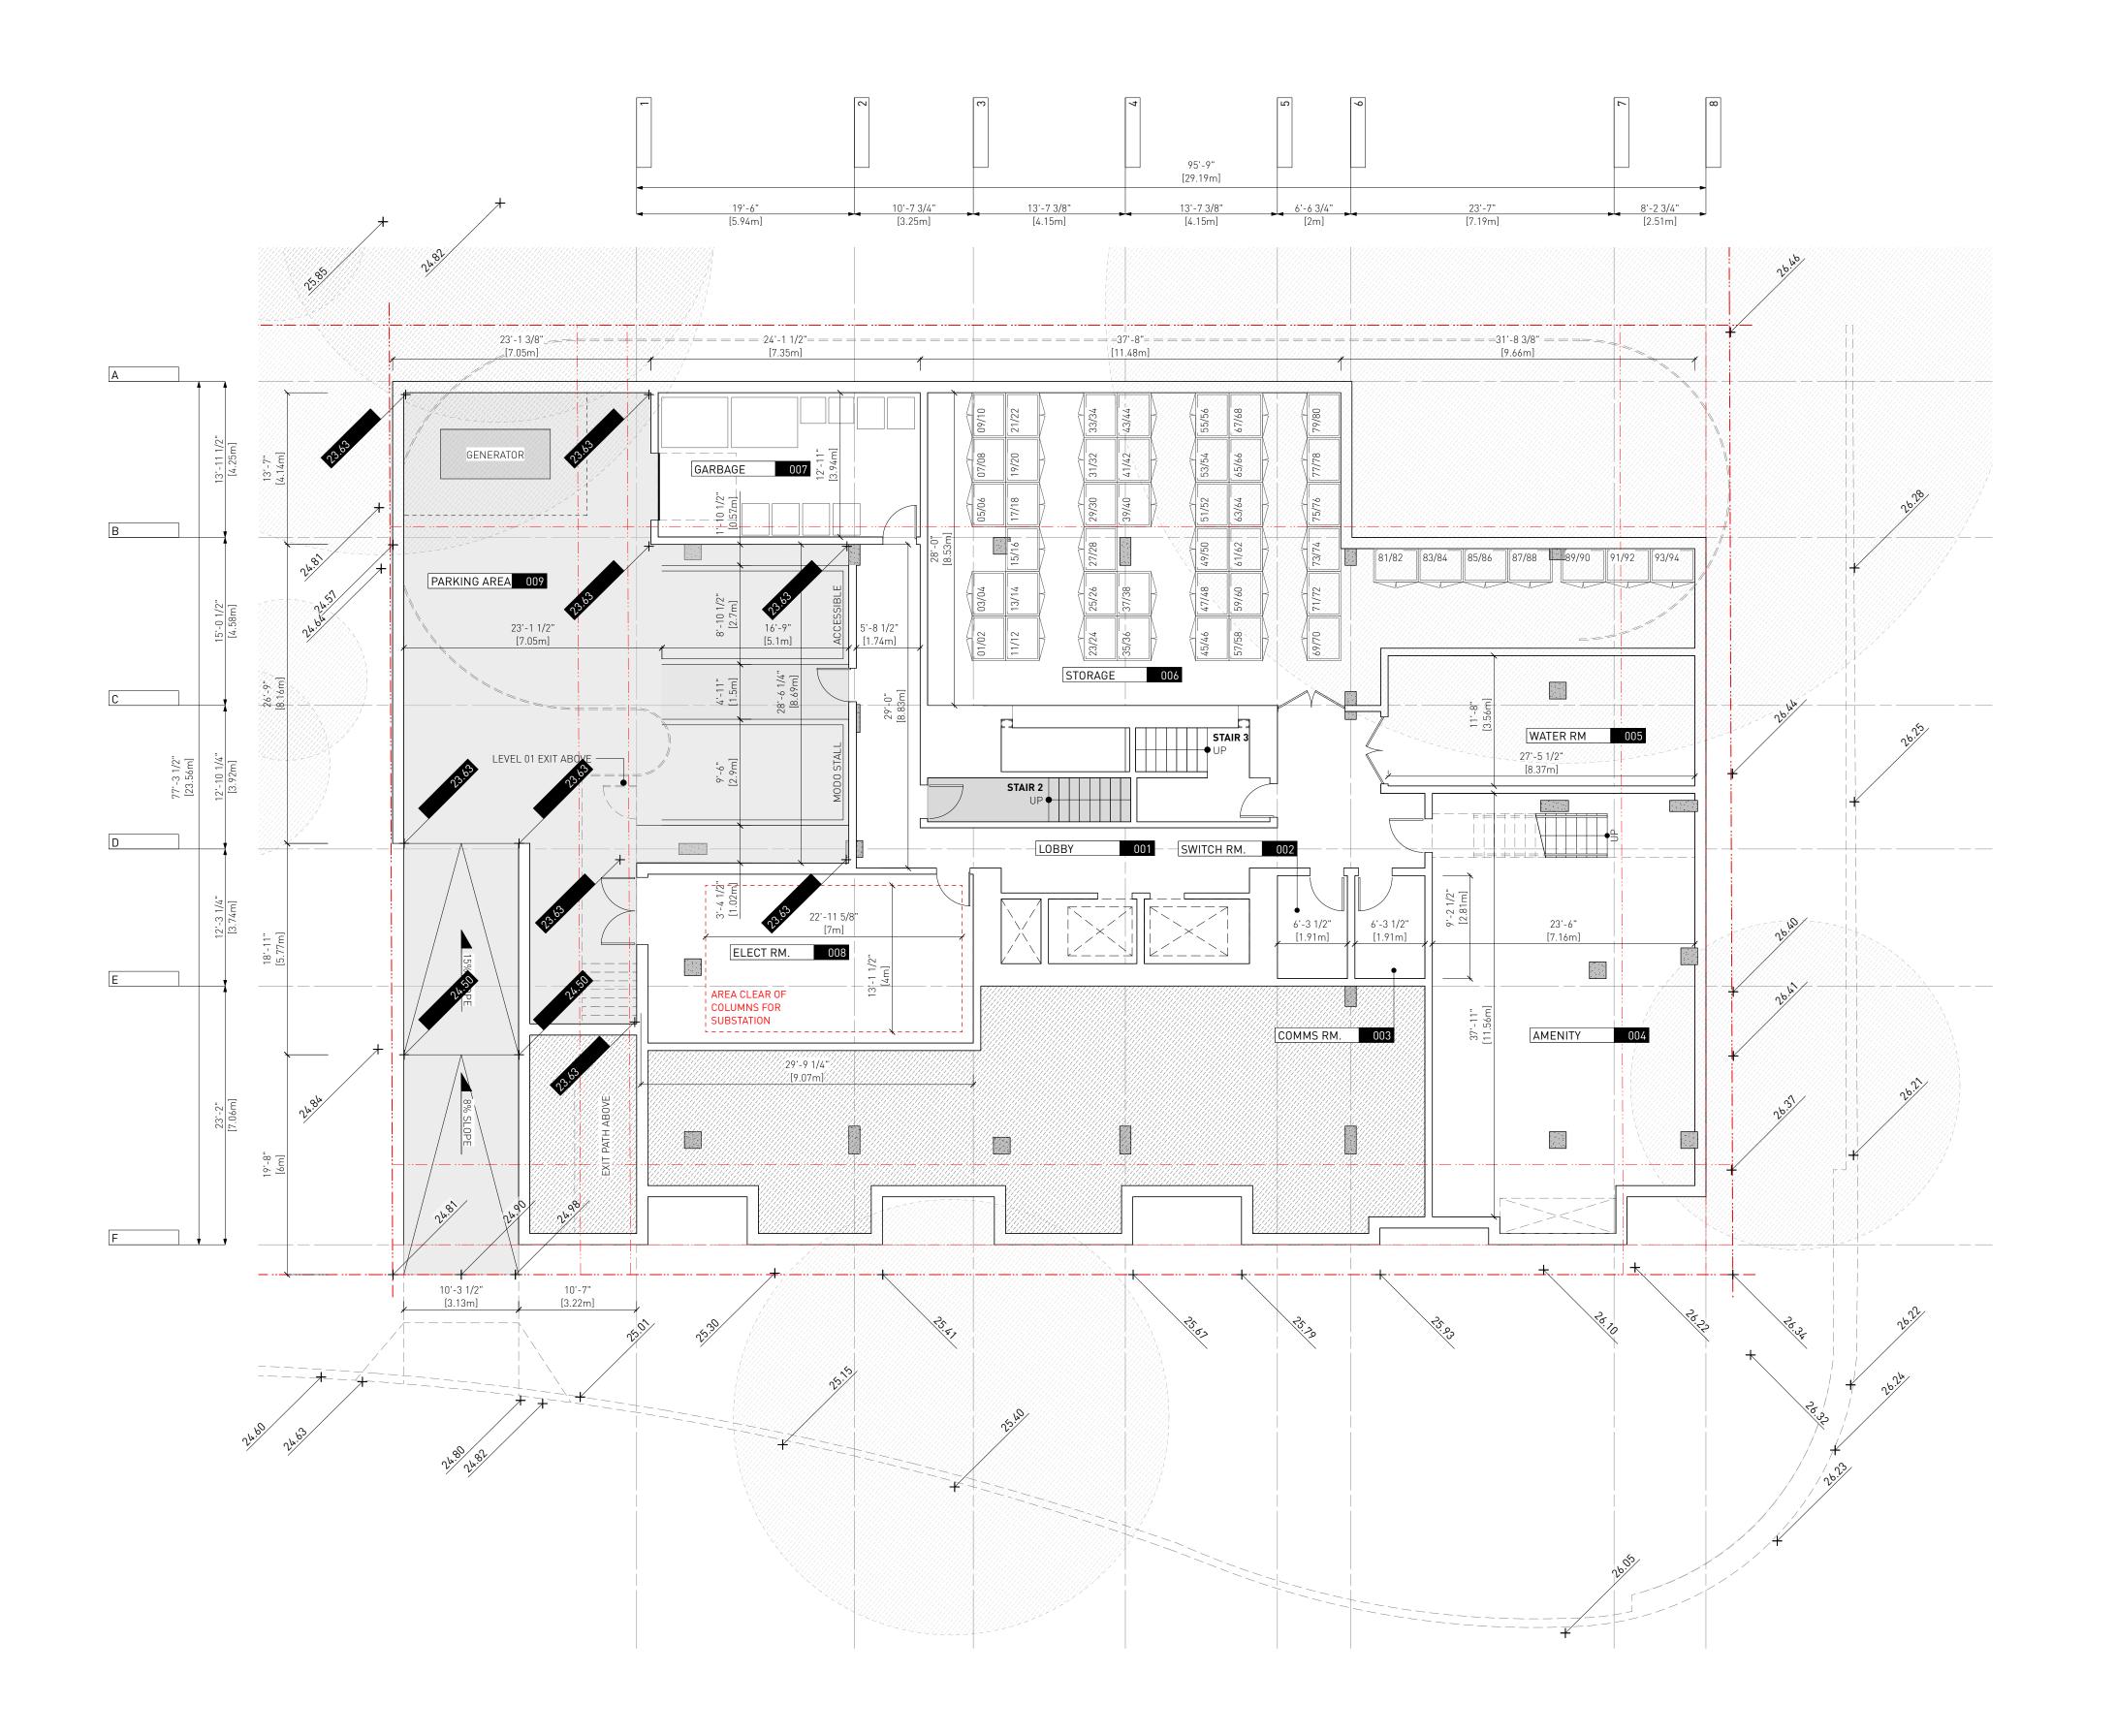
CONTEXT SITE PLAN

0650 Sheet A0.1



A0.2





LEGEND:

BELOW

EXISTING BUILDING

PROPOSED BUILDING
PROPERTY LINE
SETBACK LINE



TREE [REF. TO ANNOTATION]

CRITICAL ROOT ZONE

EXISTING HYDRO POLE

EXISTING FIRE HYDRANT
PROPOSED DECK / BENCH

PROPOSED DECK / BENCH

PROPOSED BIKE PARKING

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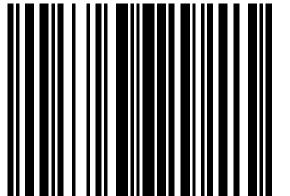
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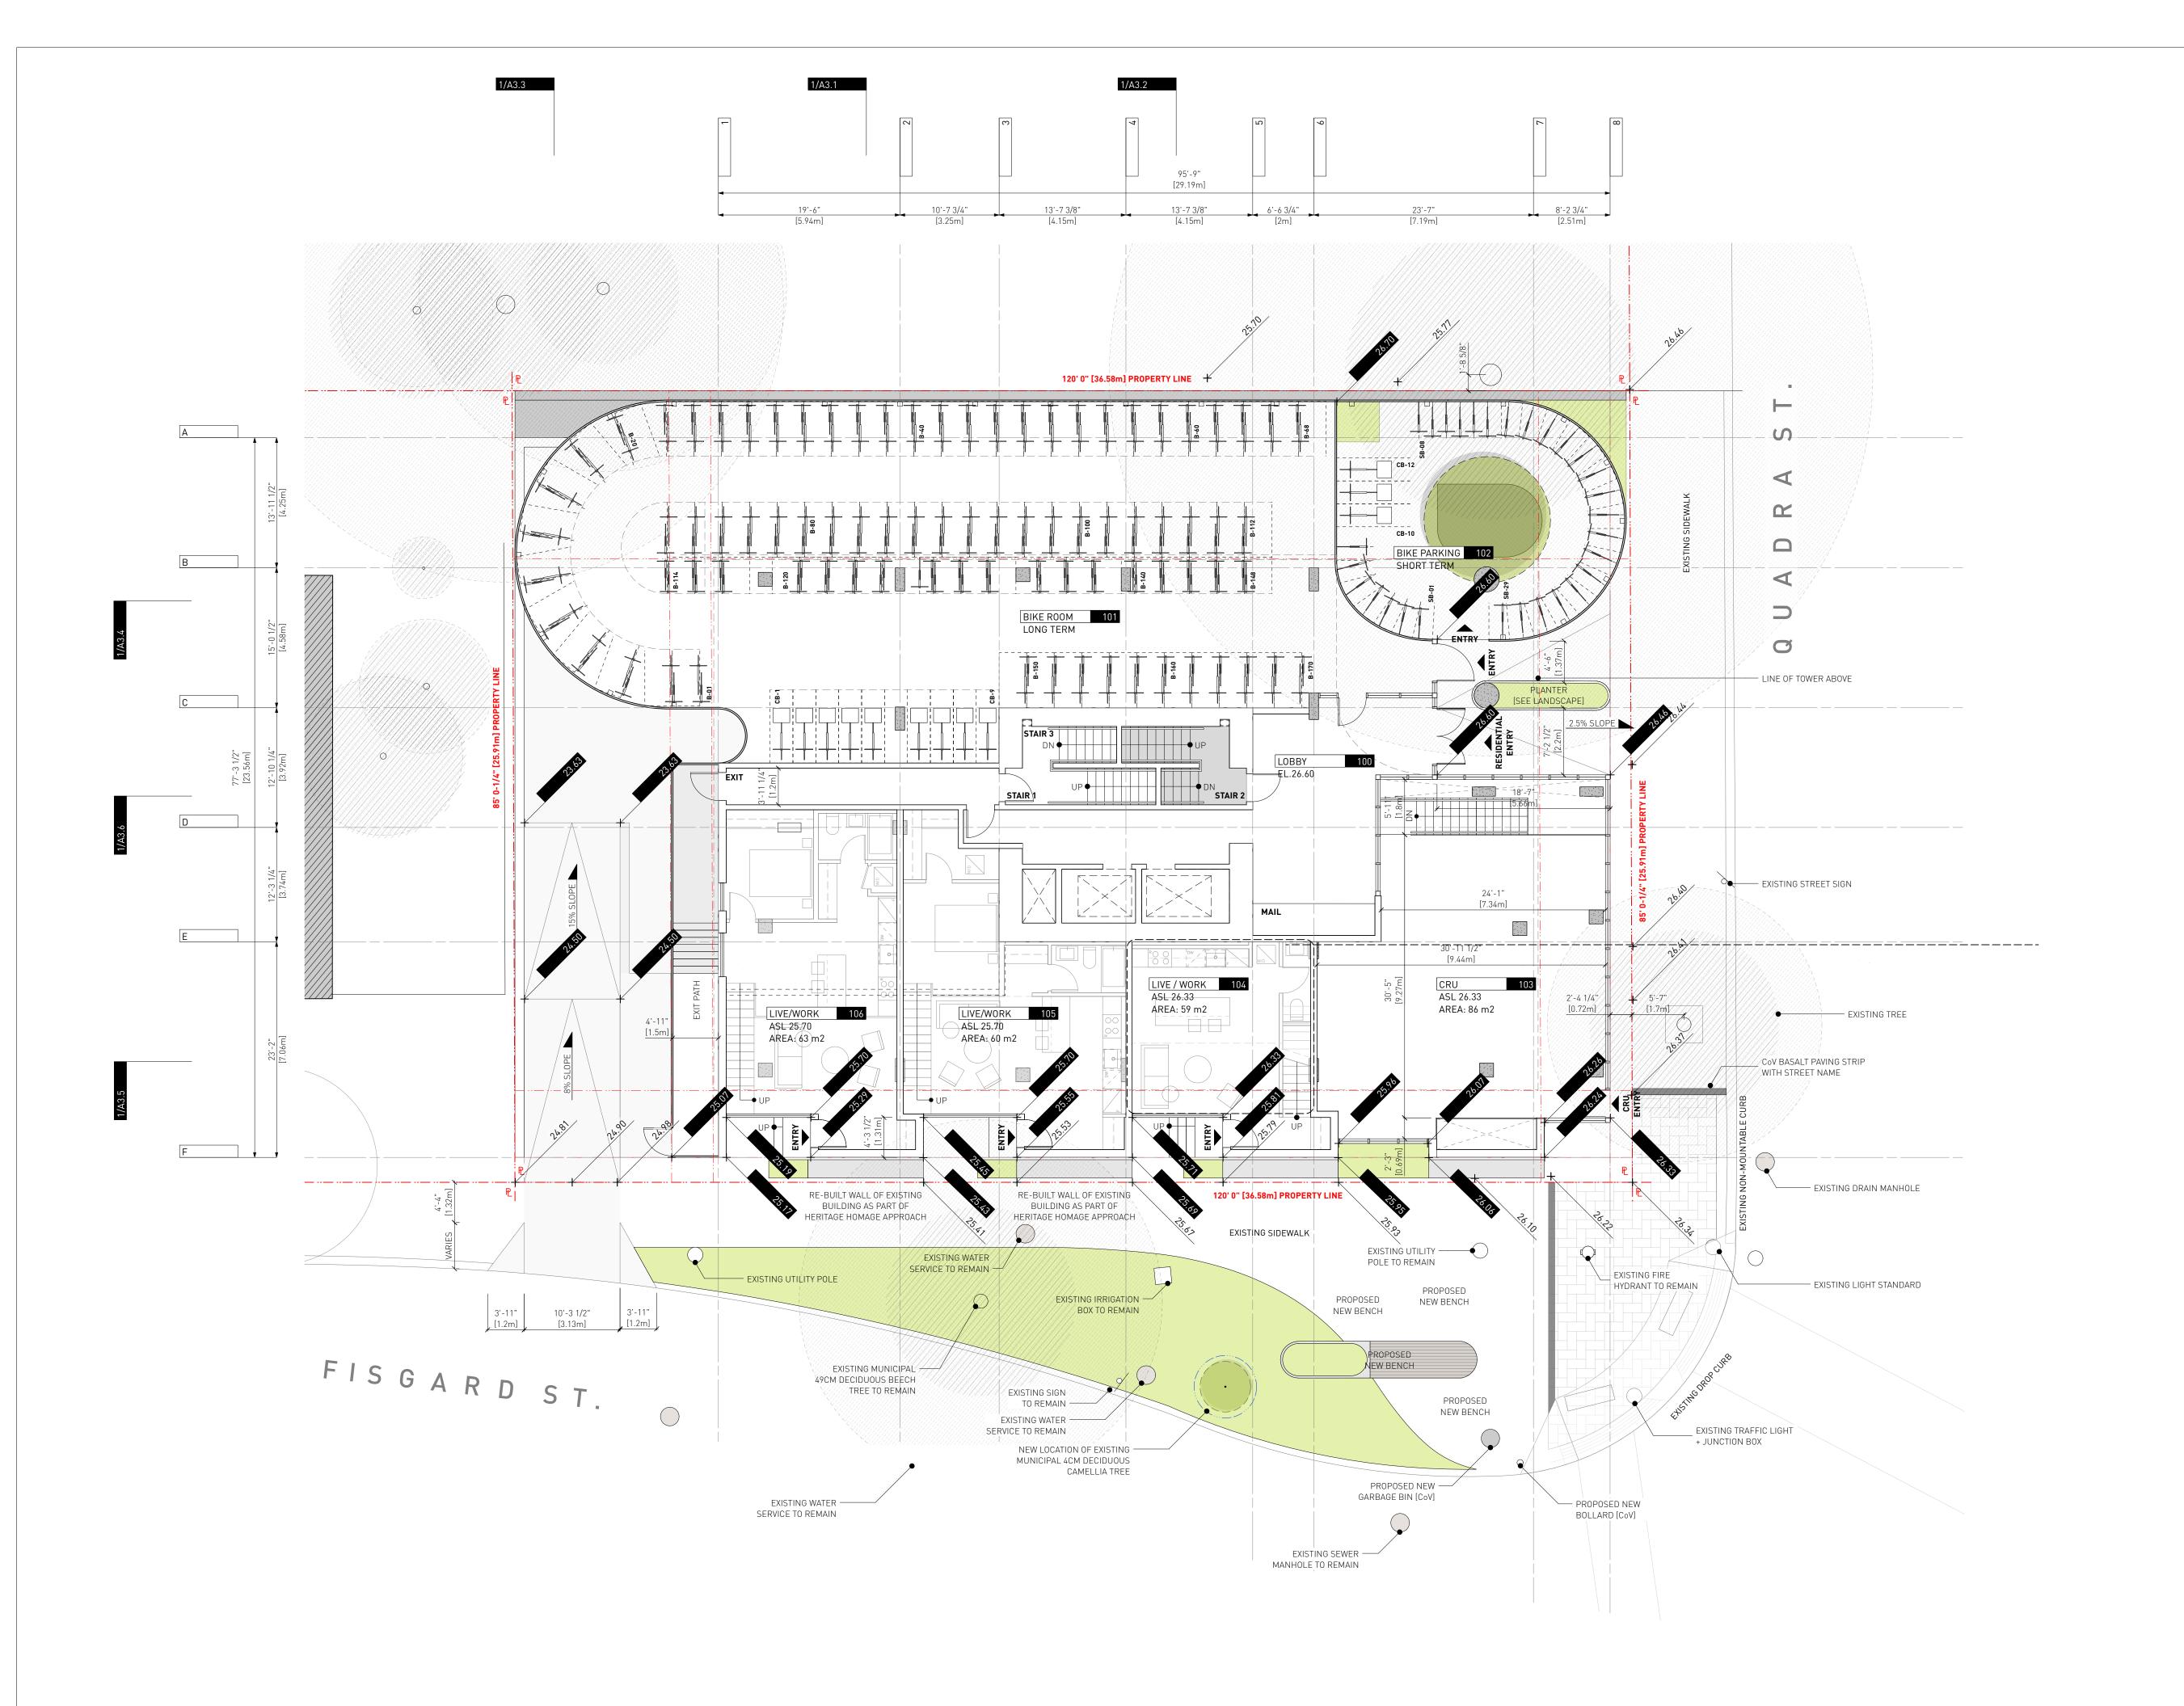


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1702 QUADRA STREET + 862 FISGARD STREET

LEVEL 00 PLAN

Project 0650 Sheet



1 LEVEL 01 PLAN
A1.2 SCALE: 1:100

LEGEND:

BELOW

EXISTING BUILDING

PROPOSED BUILDING
PROPERTY LINE
SETBACK LINE



TREE [REF. TO ANNOTATION]

CRITICAL ROOT ZONE

EXISTING HYDRO POLE

EXISTING FIRE HYDRANT

PROPOSED DECK / BENCH
PROPOSED BIKE PARKING

 \triangle

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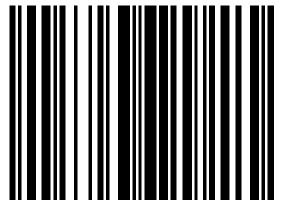
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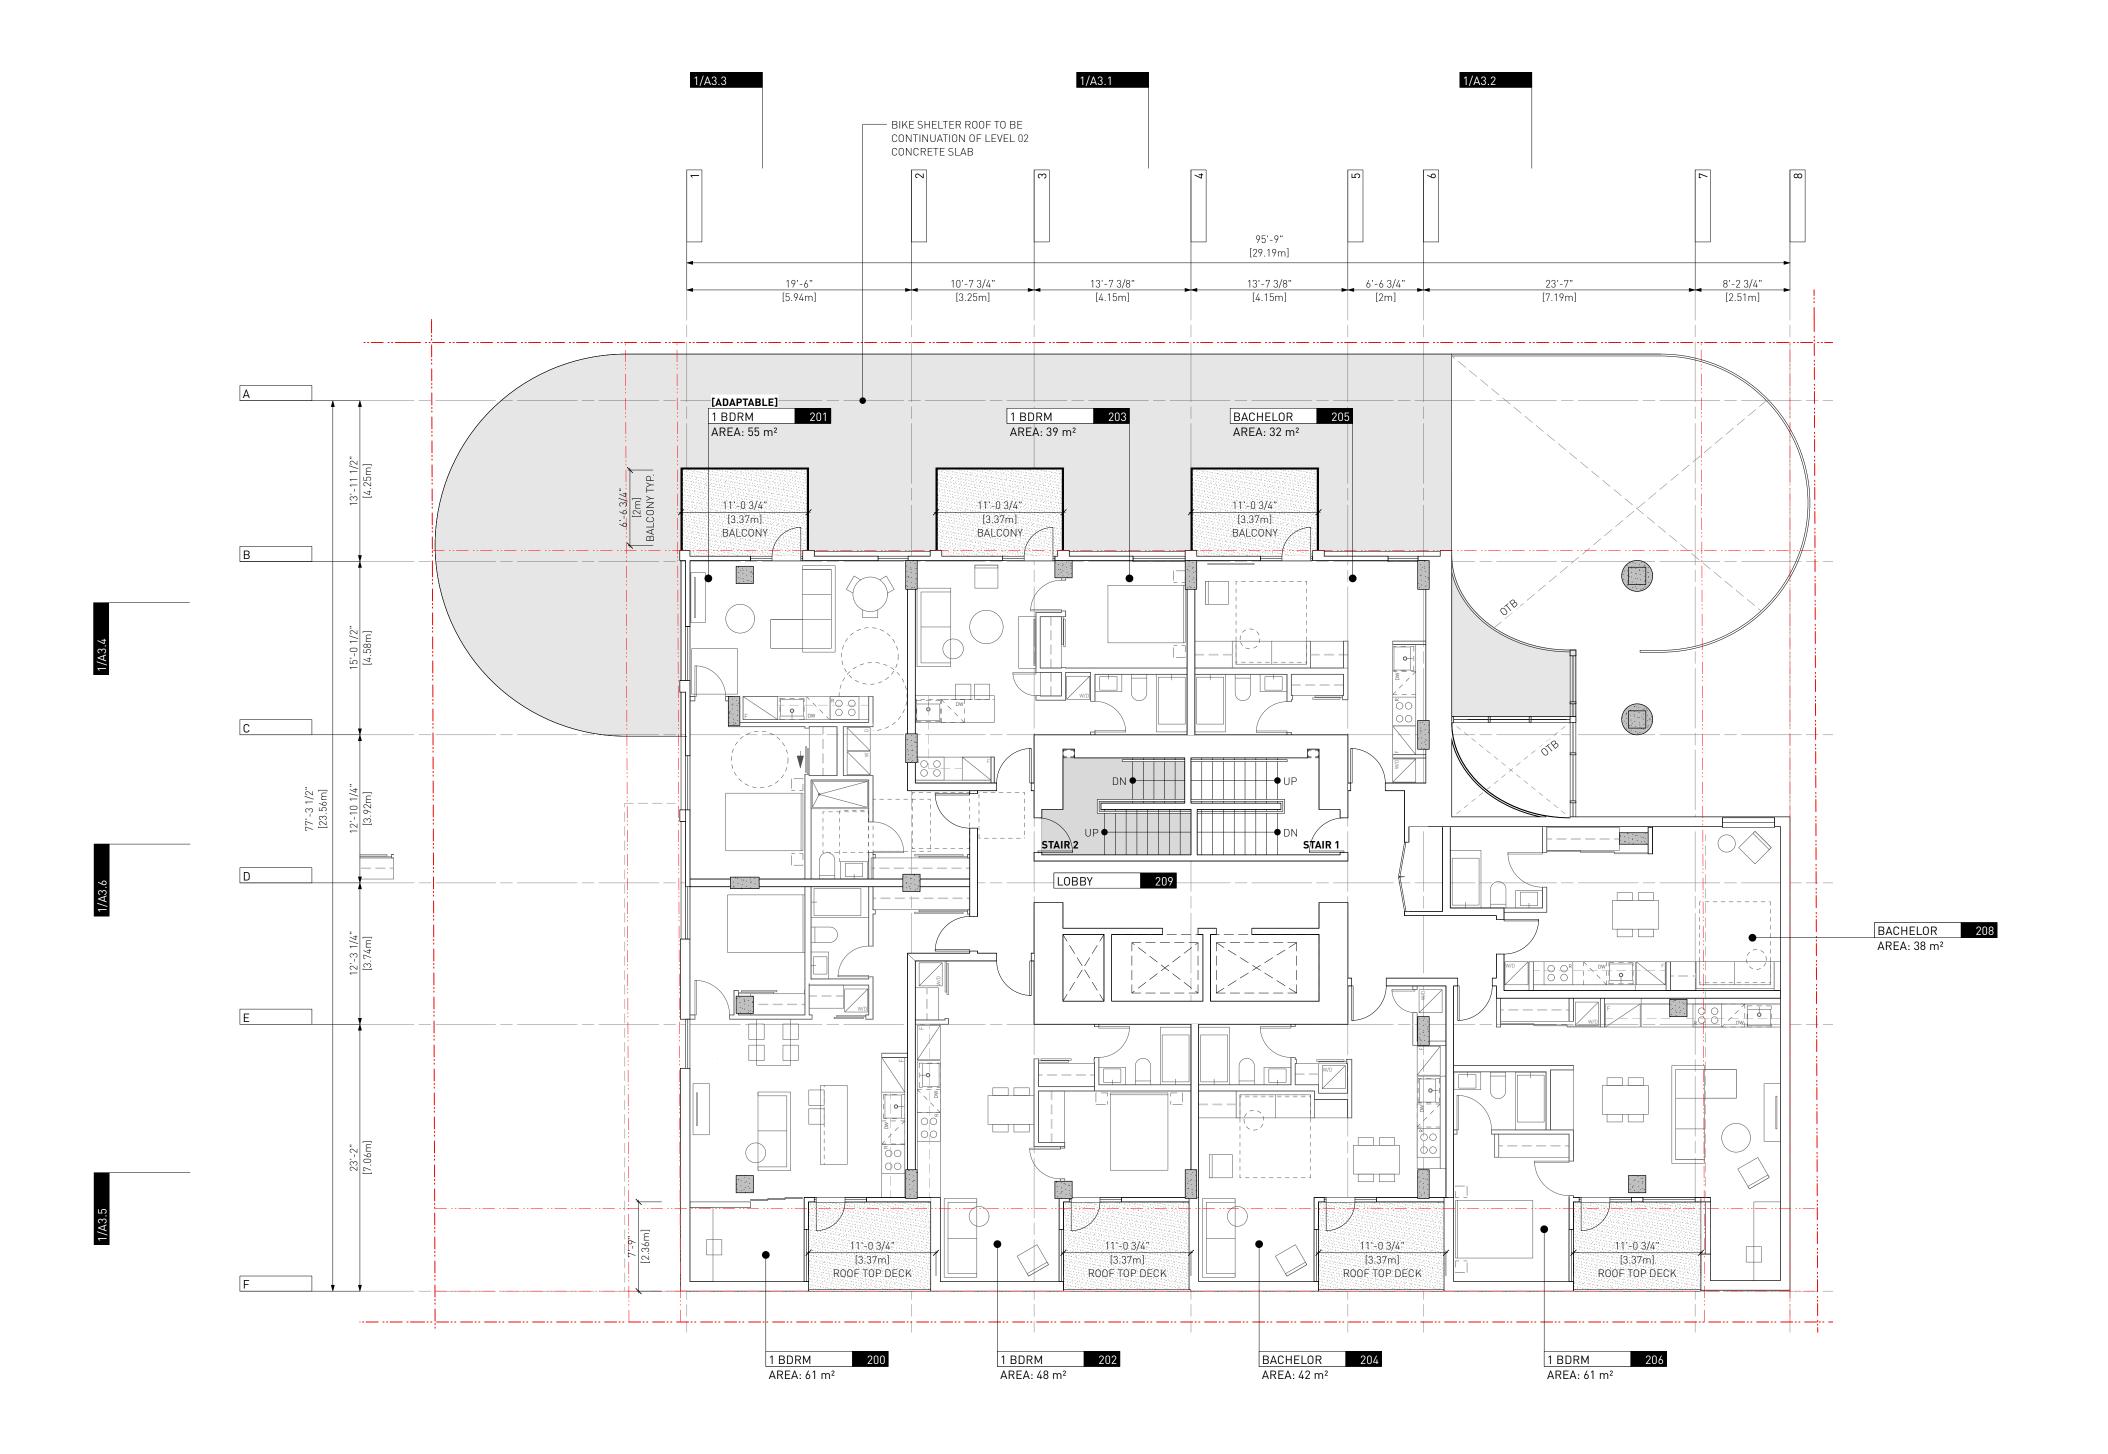


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1702 QUADRA STREET + 862 FISGARD STREET

LEVEL 01 PLAN

Project 0650 Sheet



1 LEVEL 02 PLAN

LEGEND:

BELOW

ABOVE

EXISTING BUILDING

PROPOSED BUILDING

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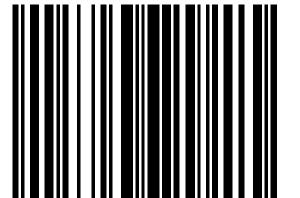
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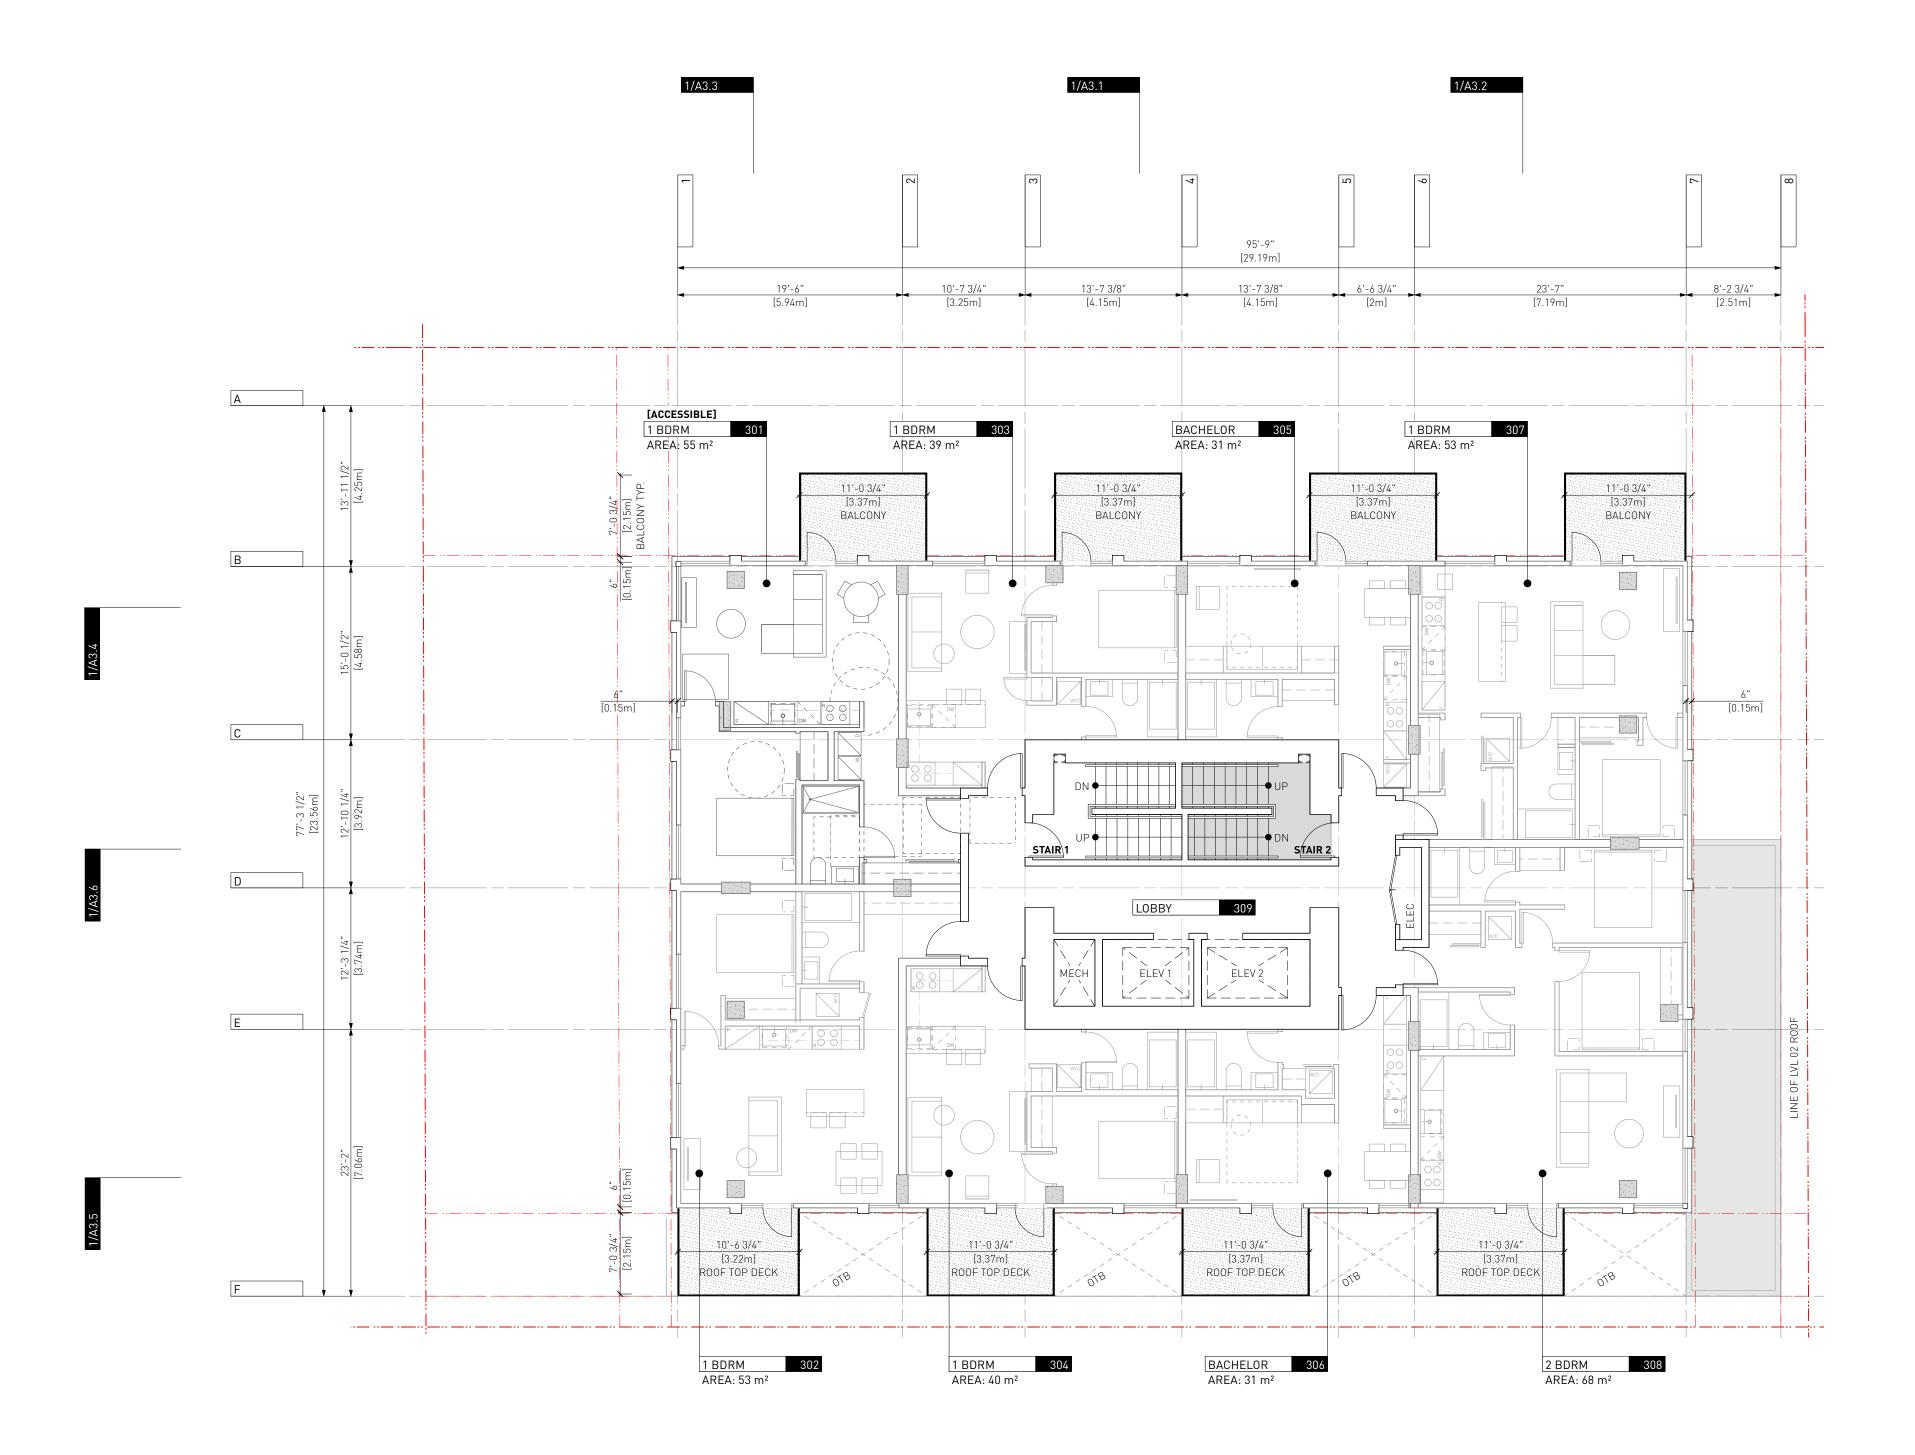


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1702 QUADRA STREET + 862 FISGARD STREET

LEVEL 02 PLAN

0650 Sheet **A1.3**



LEGEND:

BELOW

EXISTING BUILDING

PROPOSED BUILDING PROPERTY LINE SETBACK LINE FENCE

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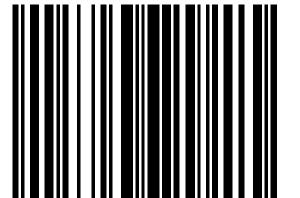
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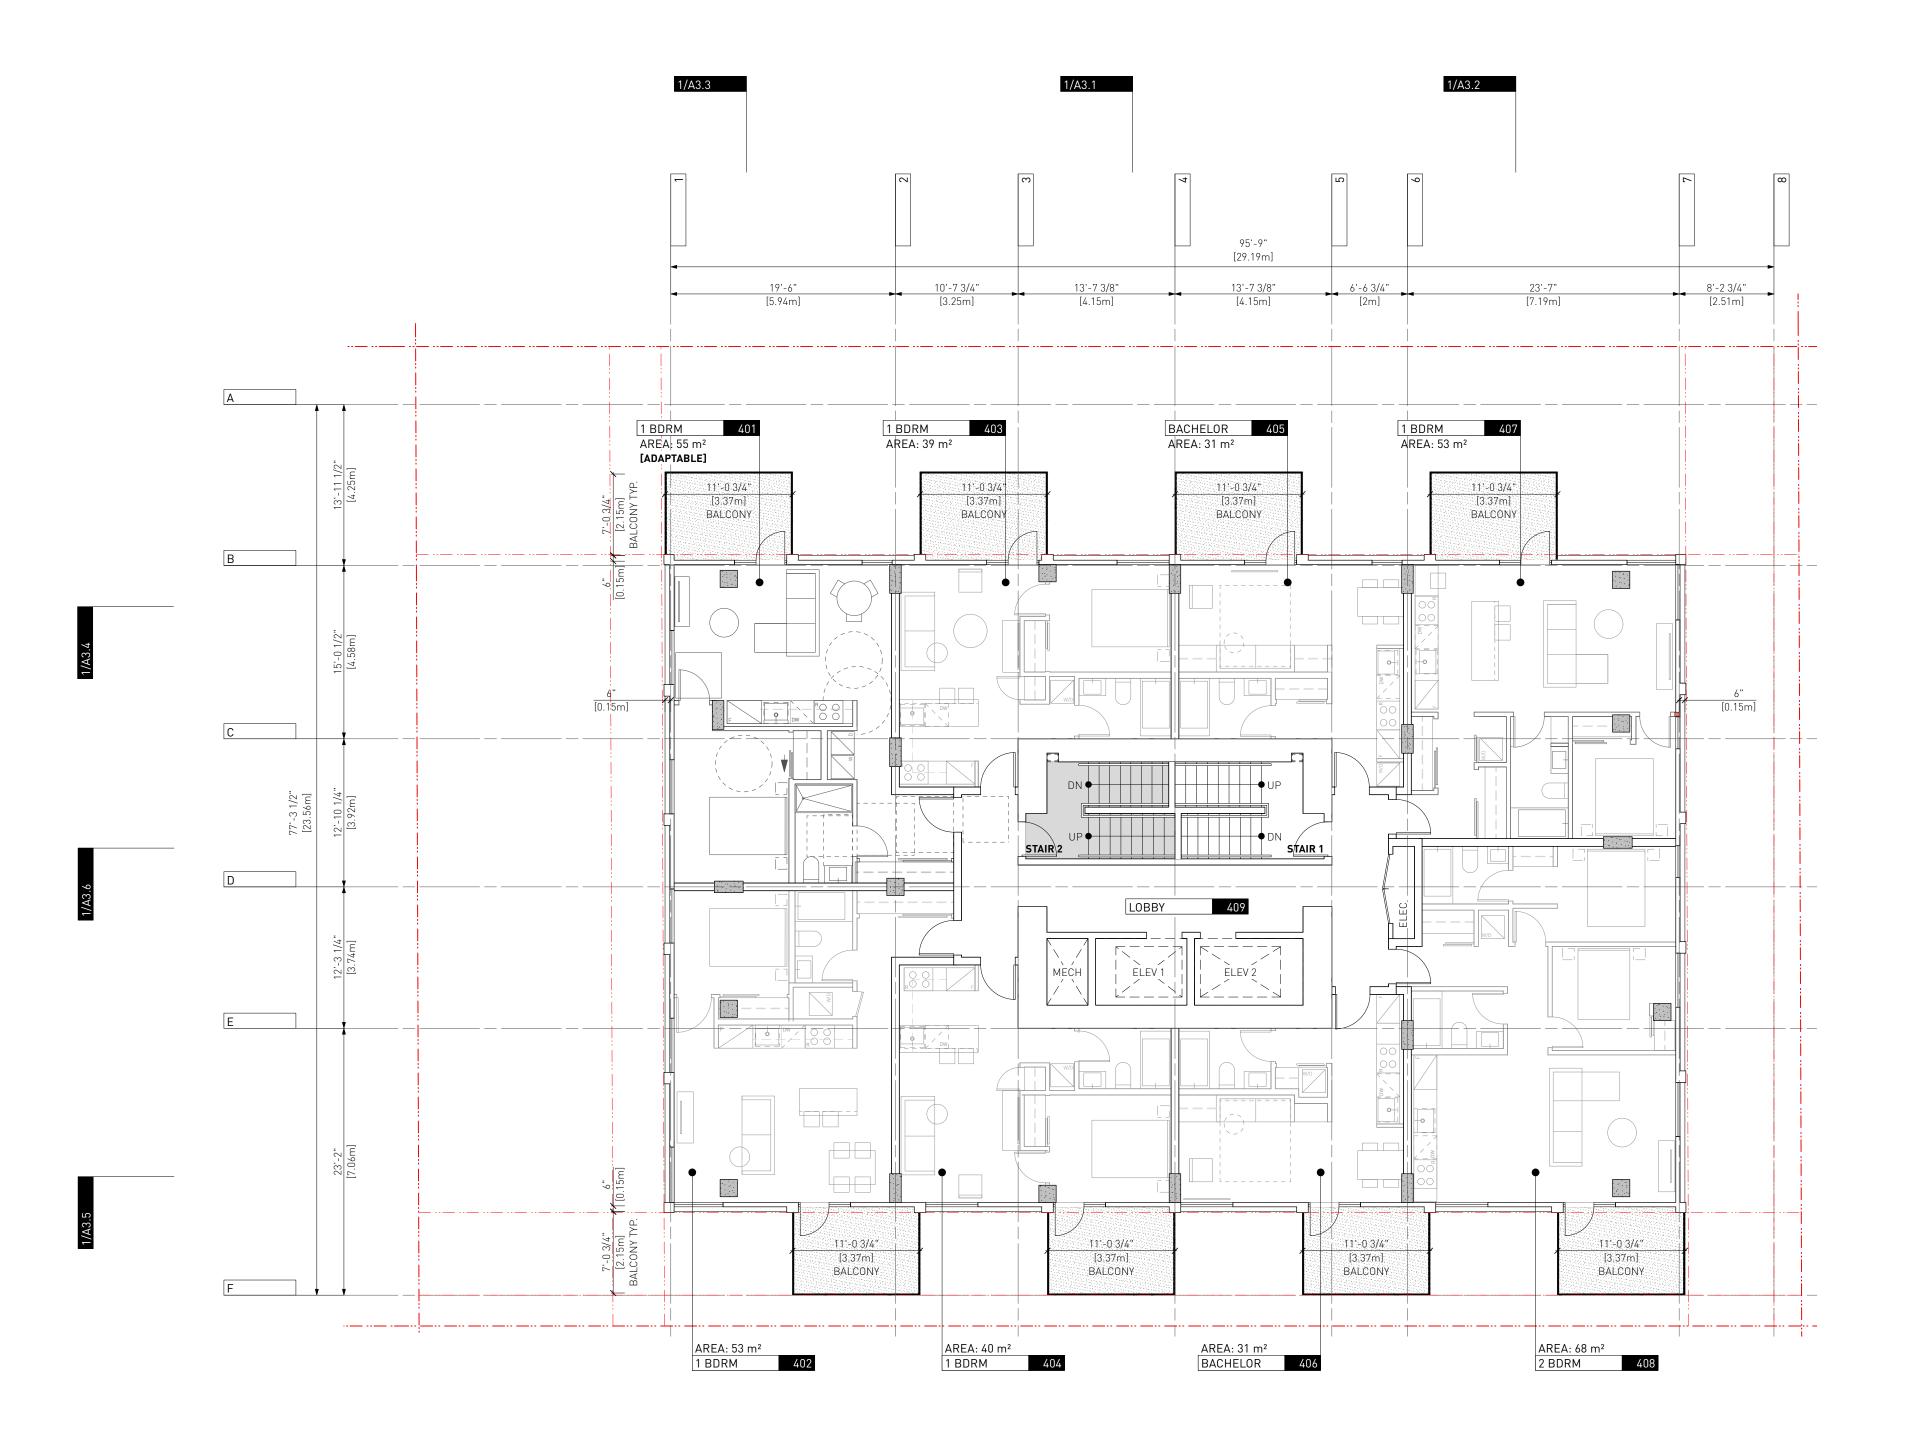
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1702 QUADRA STREET + 862 FISGARD STREET

LEVEL 03 PLAN

0650 Sheet

Project



1 LEVEL 04 / 06 / 08 / 10 / 12 A1.5 SCALE: 1:100 LEGEND:

BELOW

EXISTING BUILDING

EXISTING BUILDING
PROPOSED BUILDING

PROPOSED BOILDING

PROPERTY LINE

SETBACK LINE

FENCE

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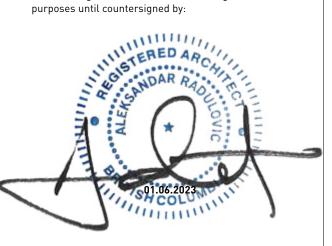
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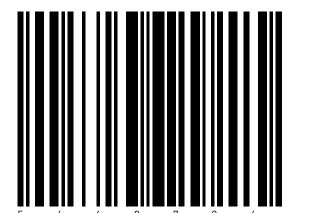
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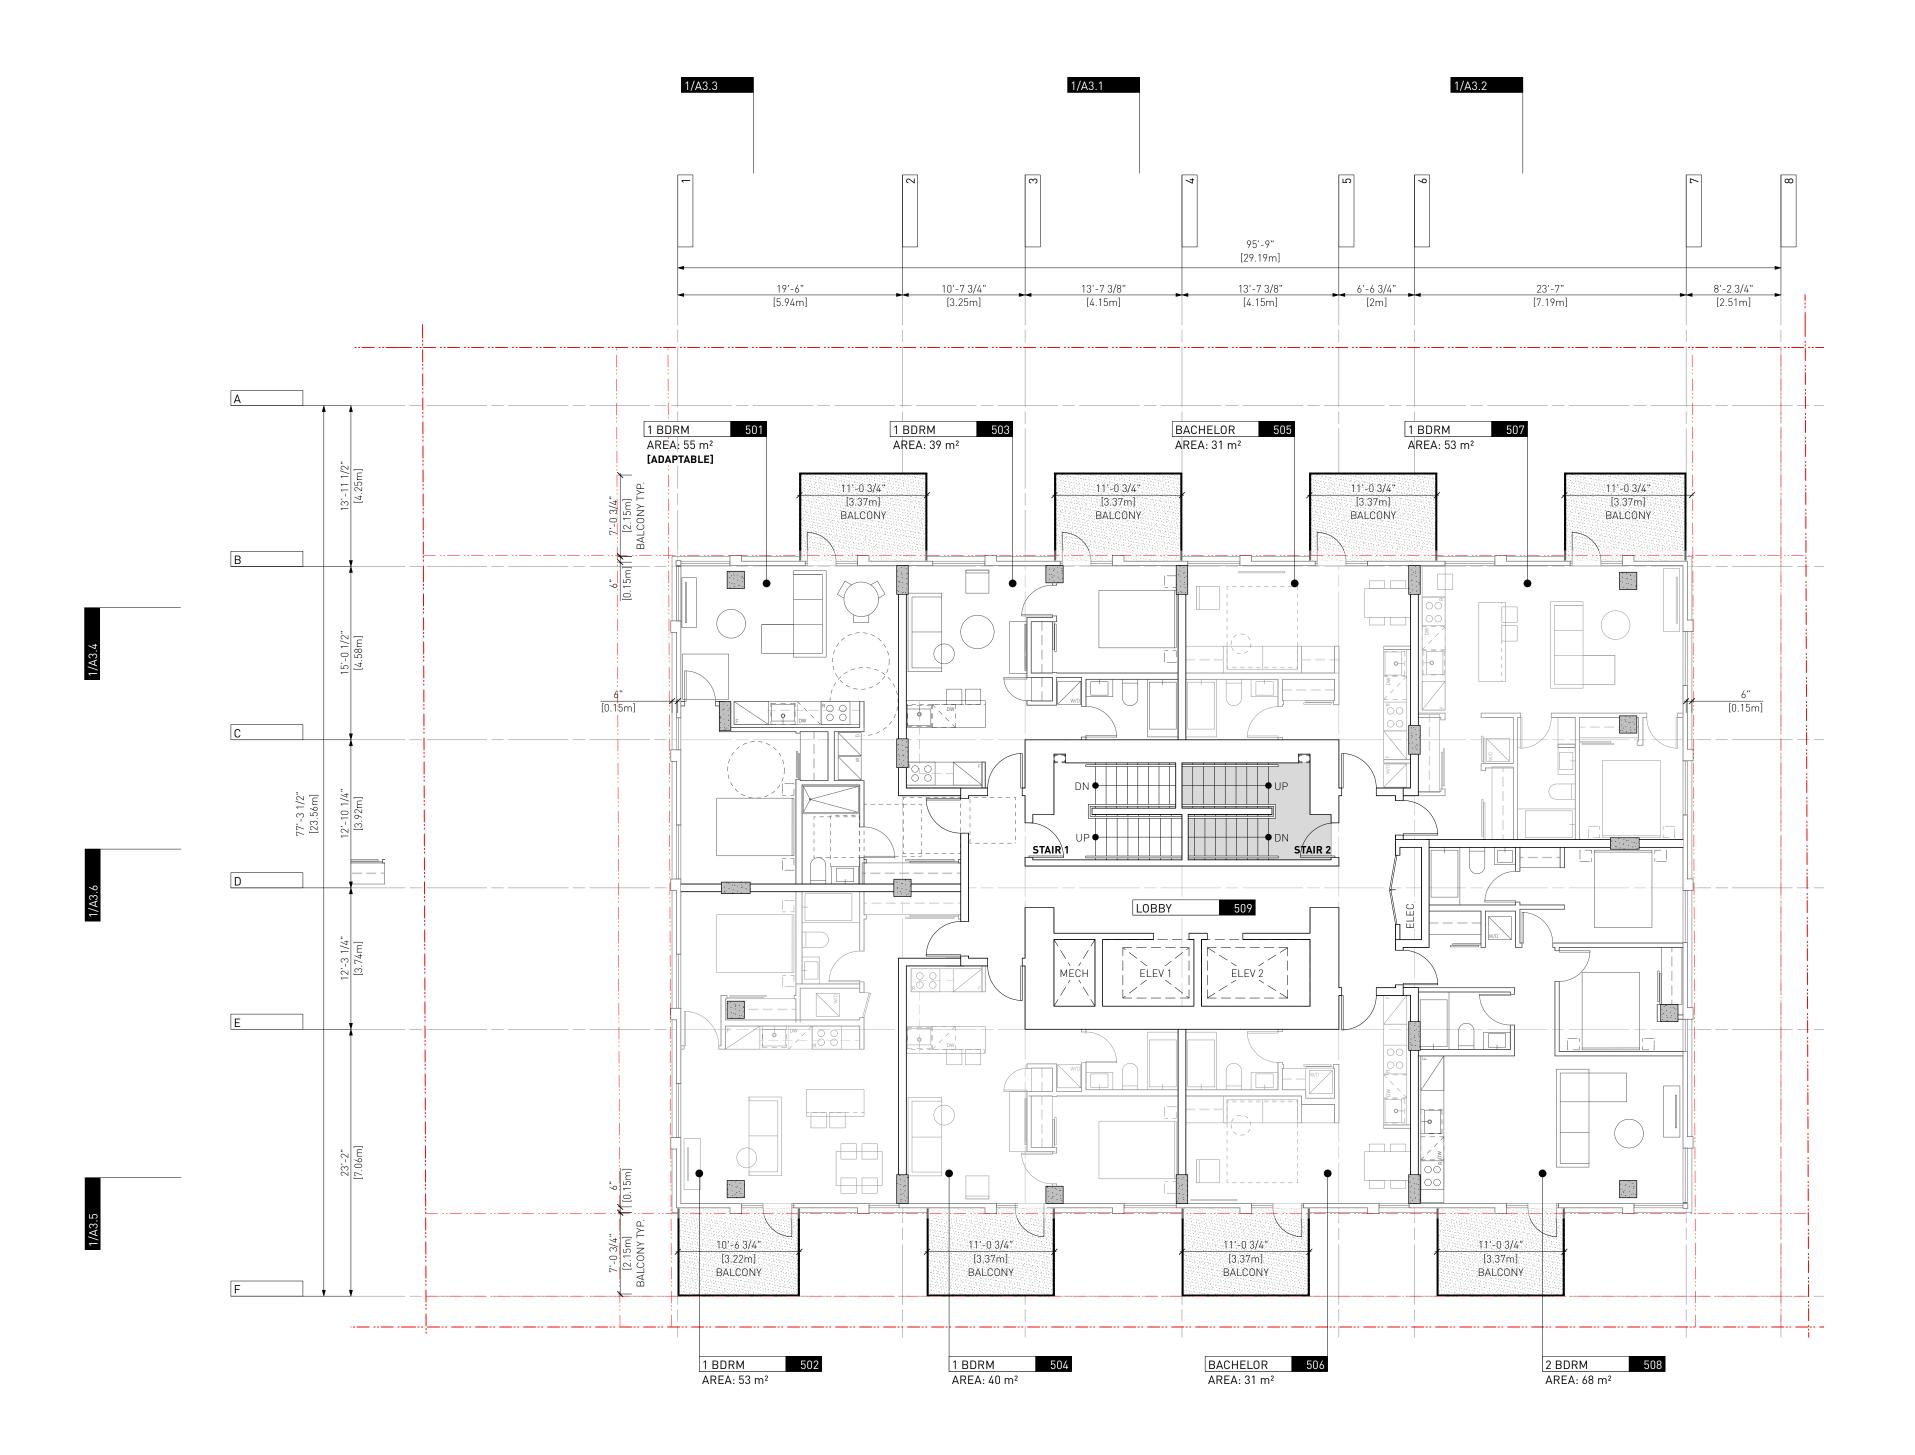
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1702 QUADRA STREET + 862 FISGARD STREET

LEVEL 04/06/08/10/12

0650 Sheet

Project



LEGEND:

BELOW

EXISTING BUILDING

PROPOSED BUILDING PROPERTY LINE SETBACK LINE FENCE

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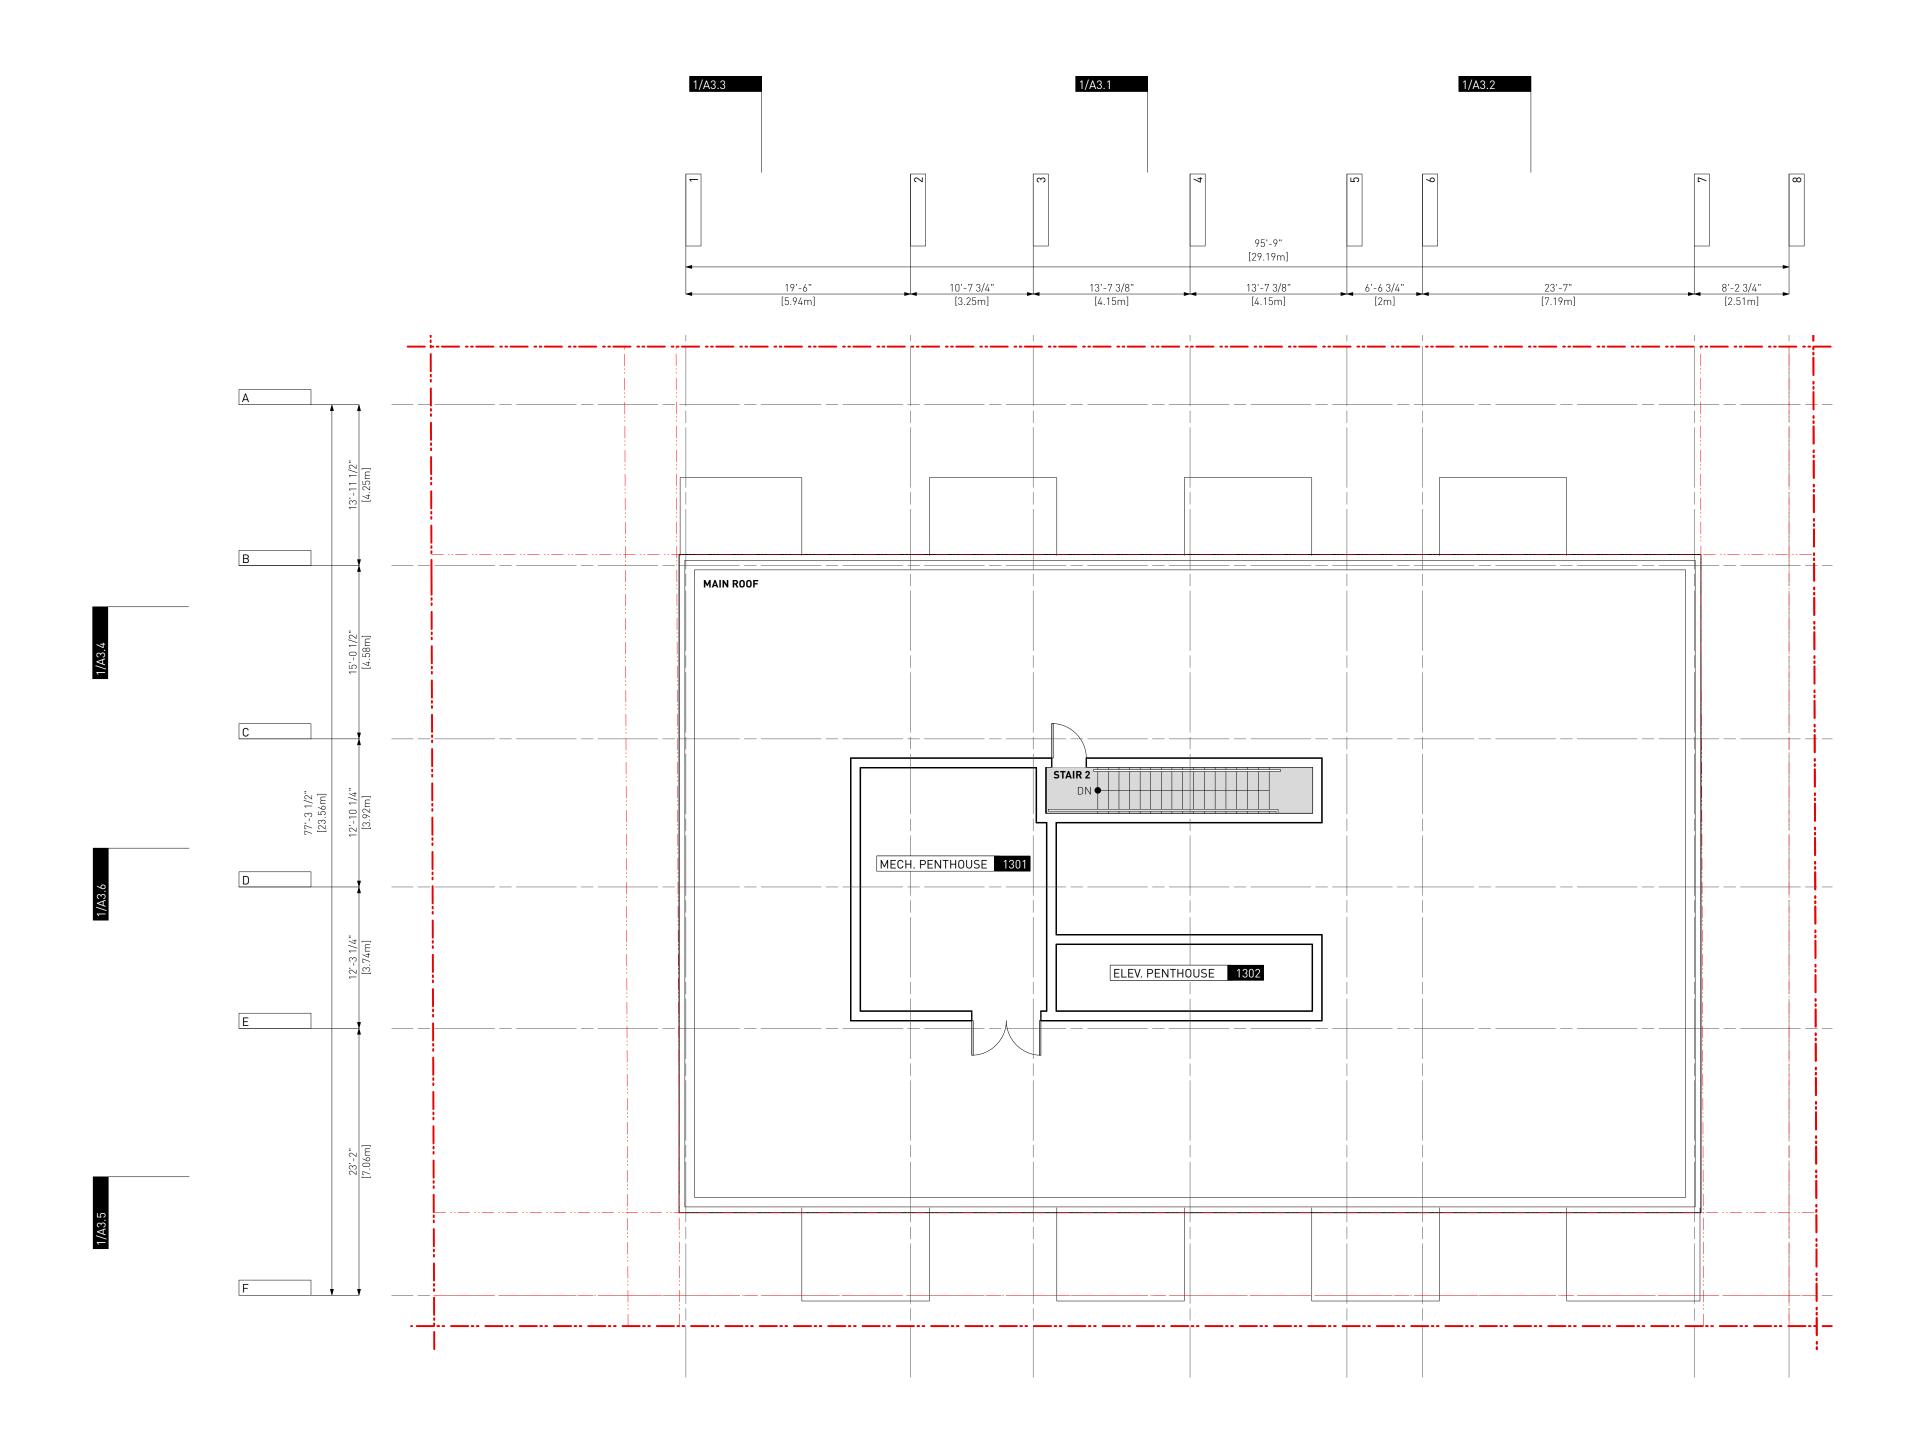
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1702 QUADRA STREET + 862 FISGARD STREET

LEVEL 05/07/09/11

0650 Sheet

Project



1 LEVEL 13

LEGEND:

WC

ABOVE

EXISTING BUILDING

PROPOSED BUILDING
PROPERTY LINE
SETBACK LINE

FENCE

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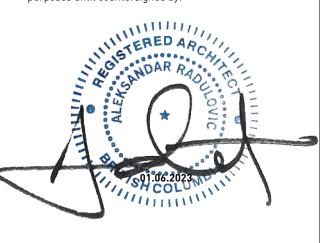
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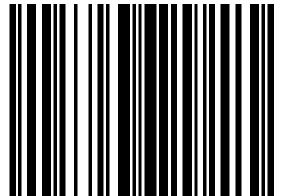
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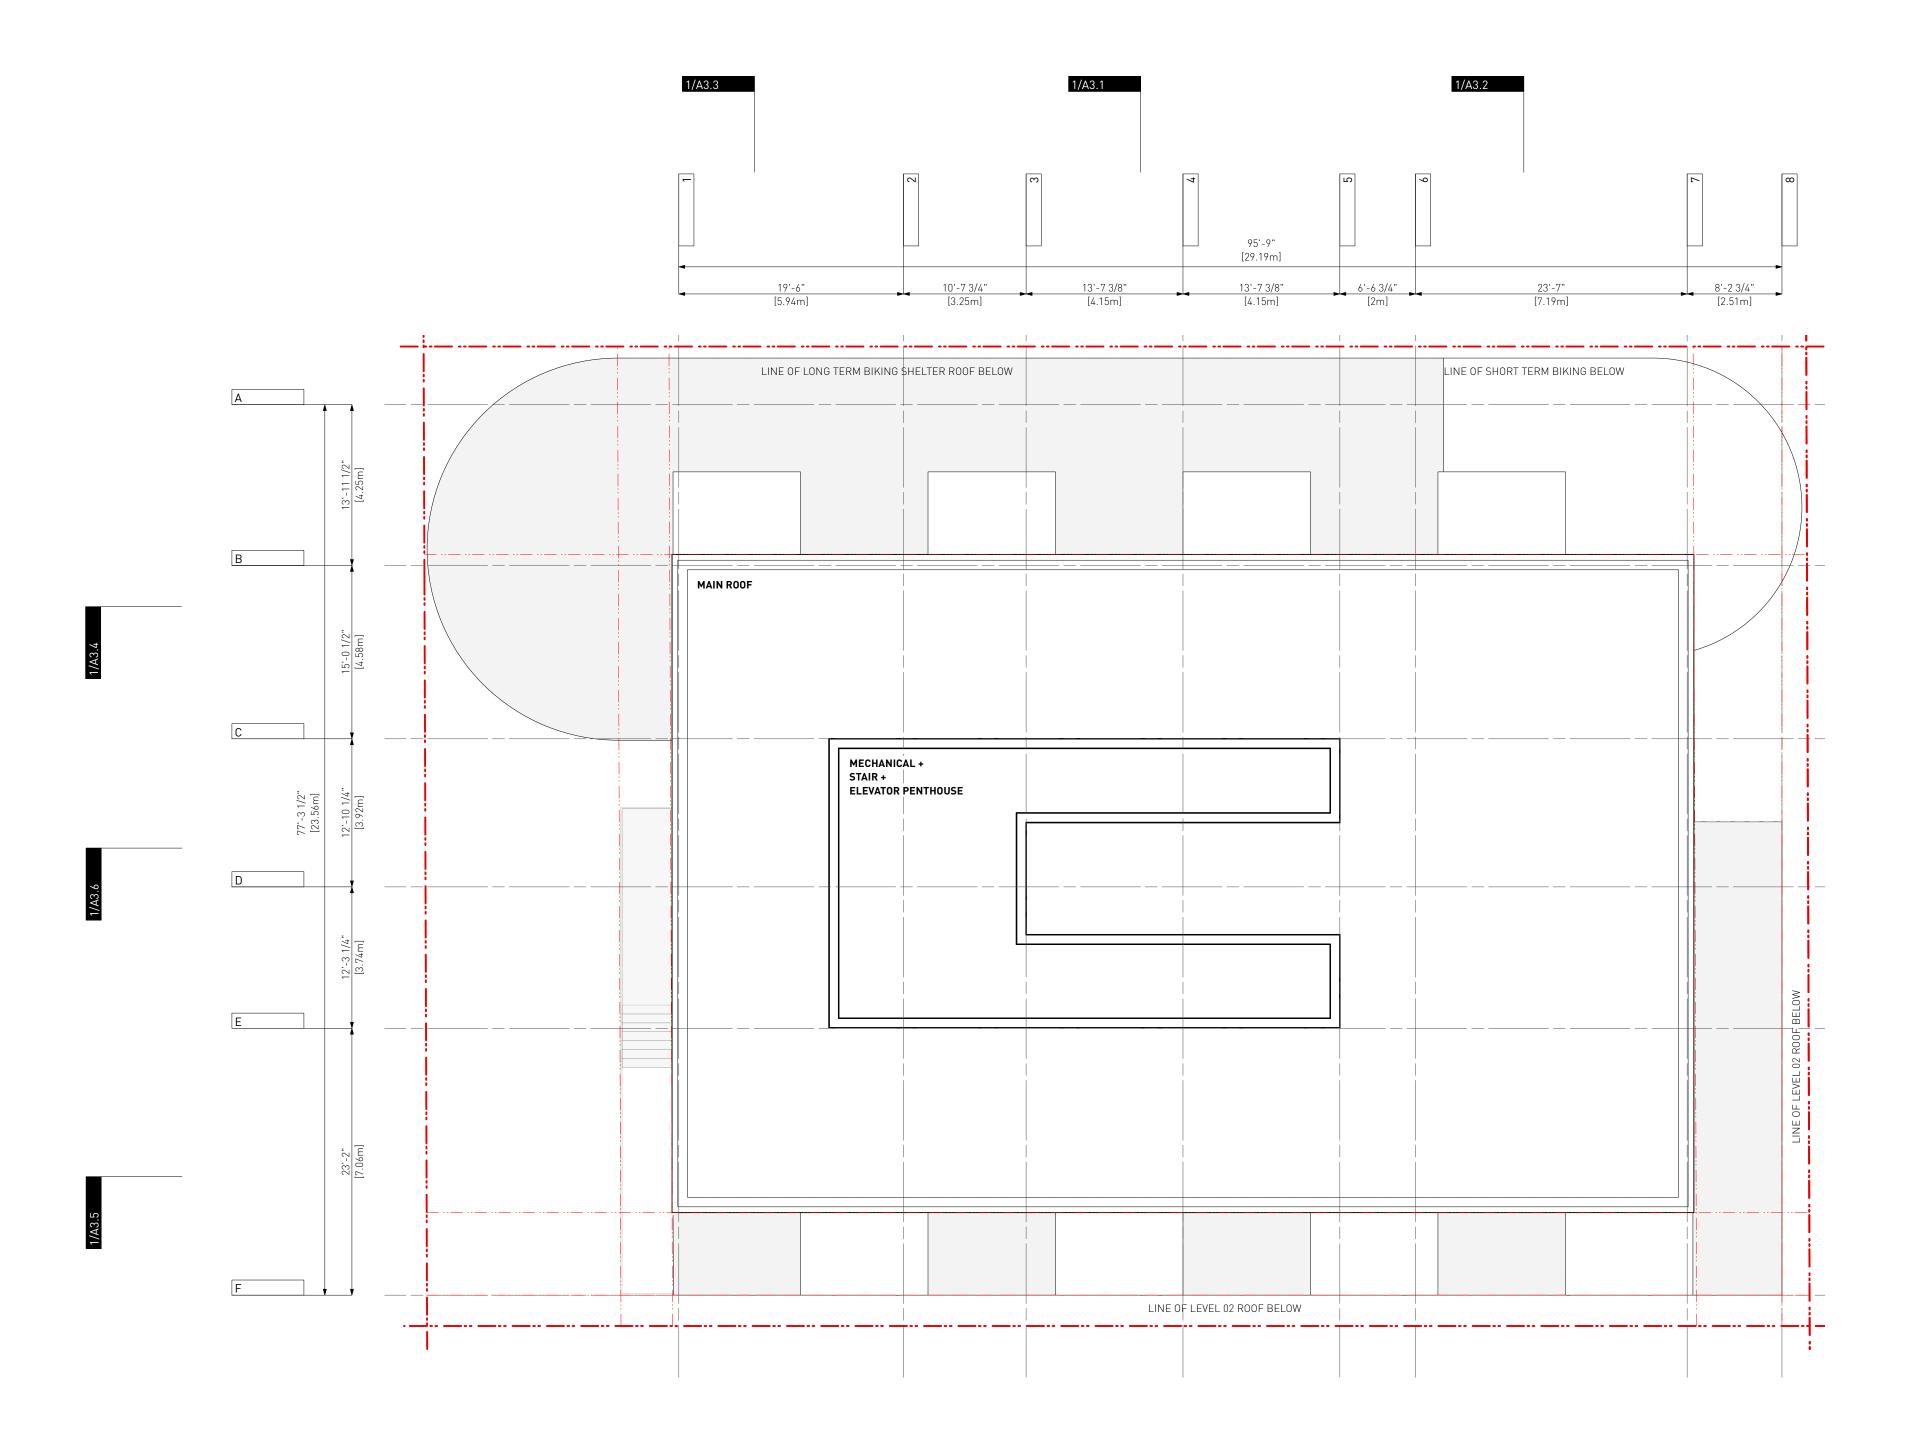
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1702 QUADRA STREET + 862 FISGARD STREET

LEVEL 13

0650 Sheet

Project



1 LEVEL ROOF

LEGEND:

ABOVE

EXISTING BUILDING

EXISTING BUILDING

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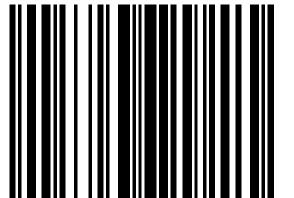
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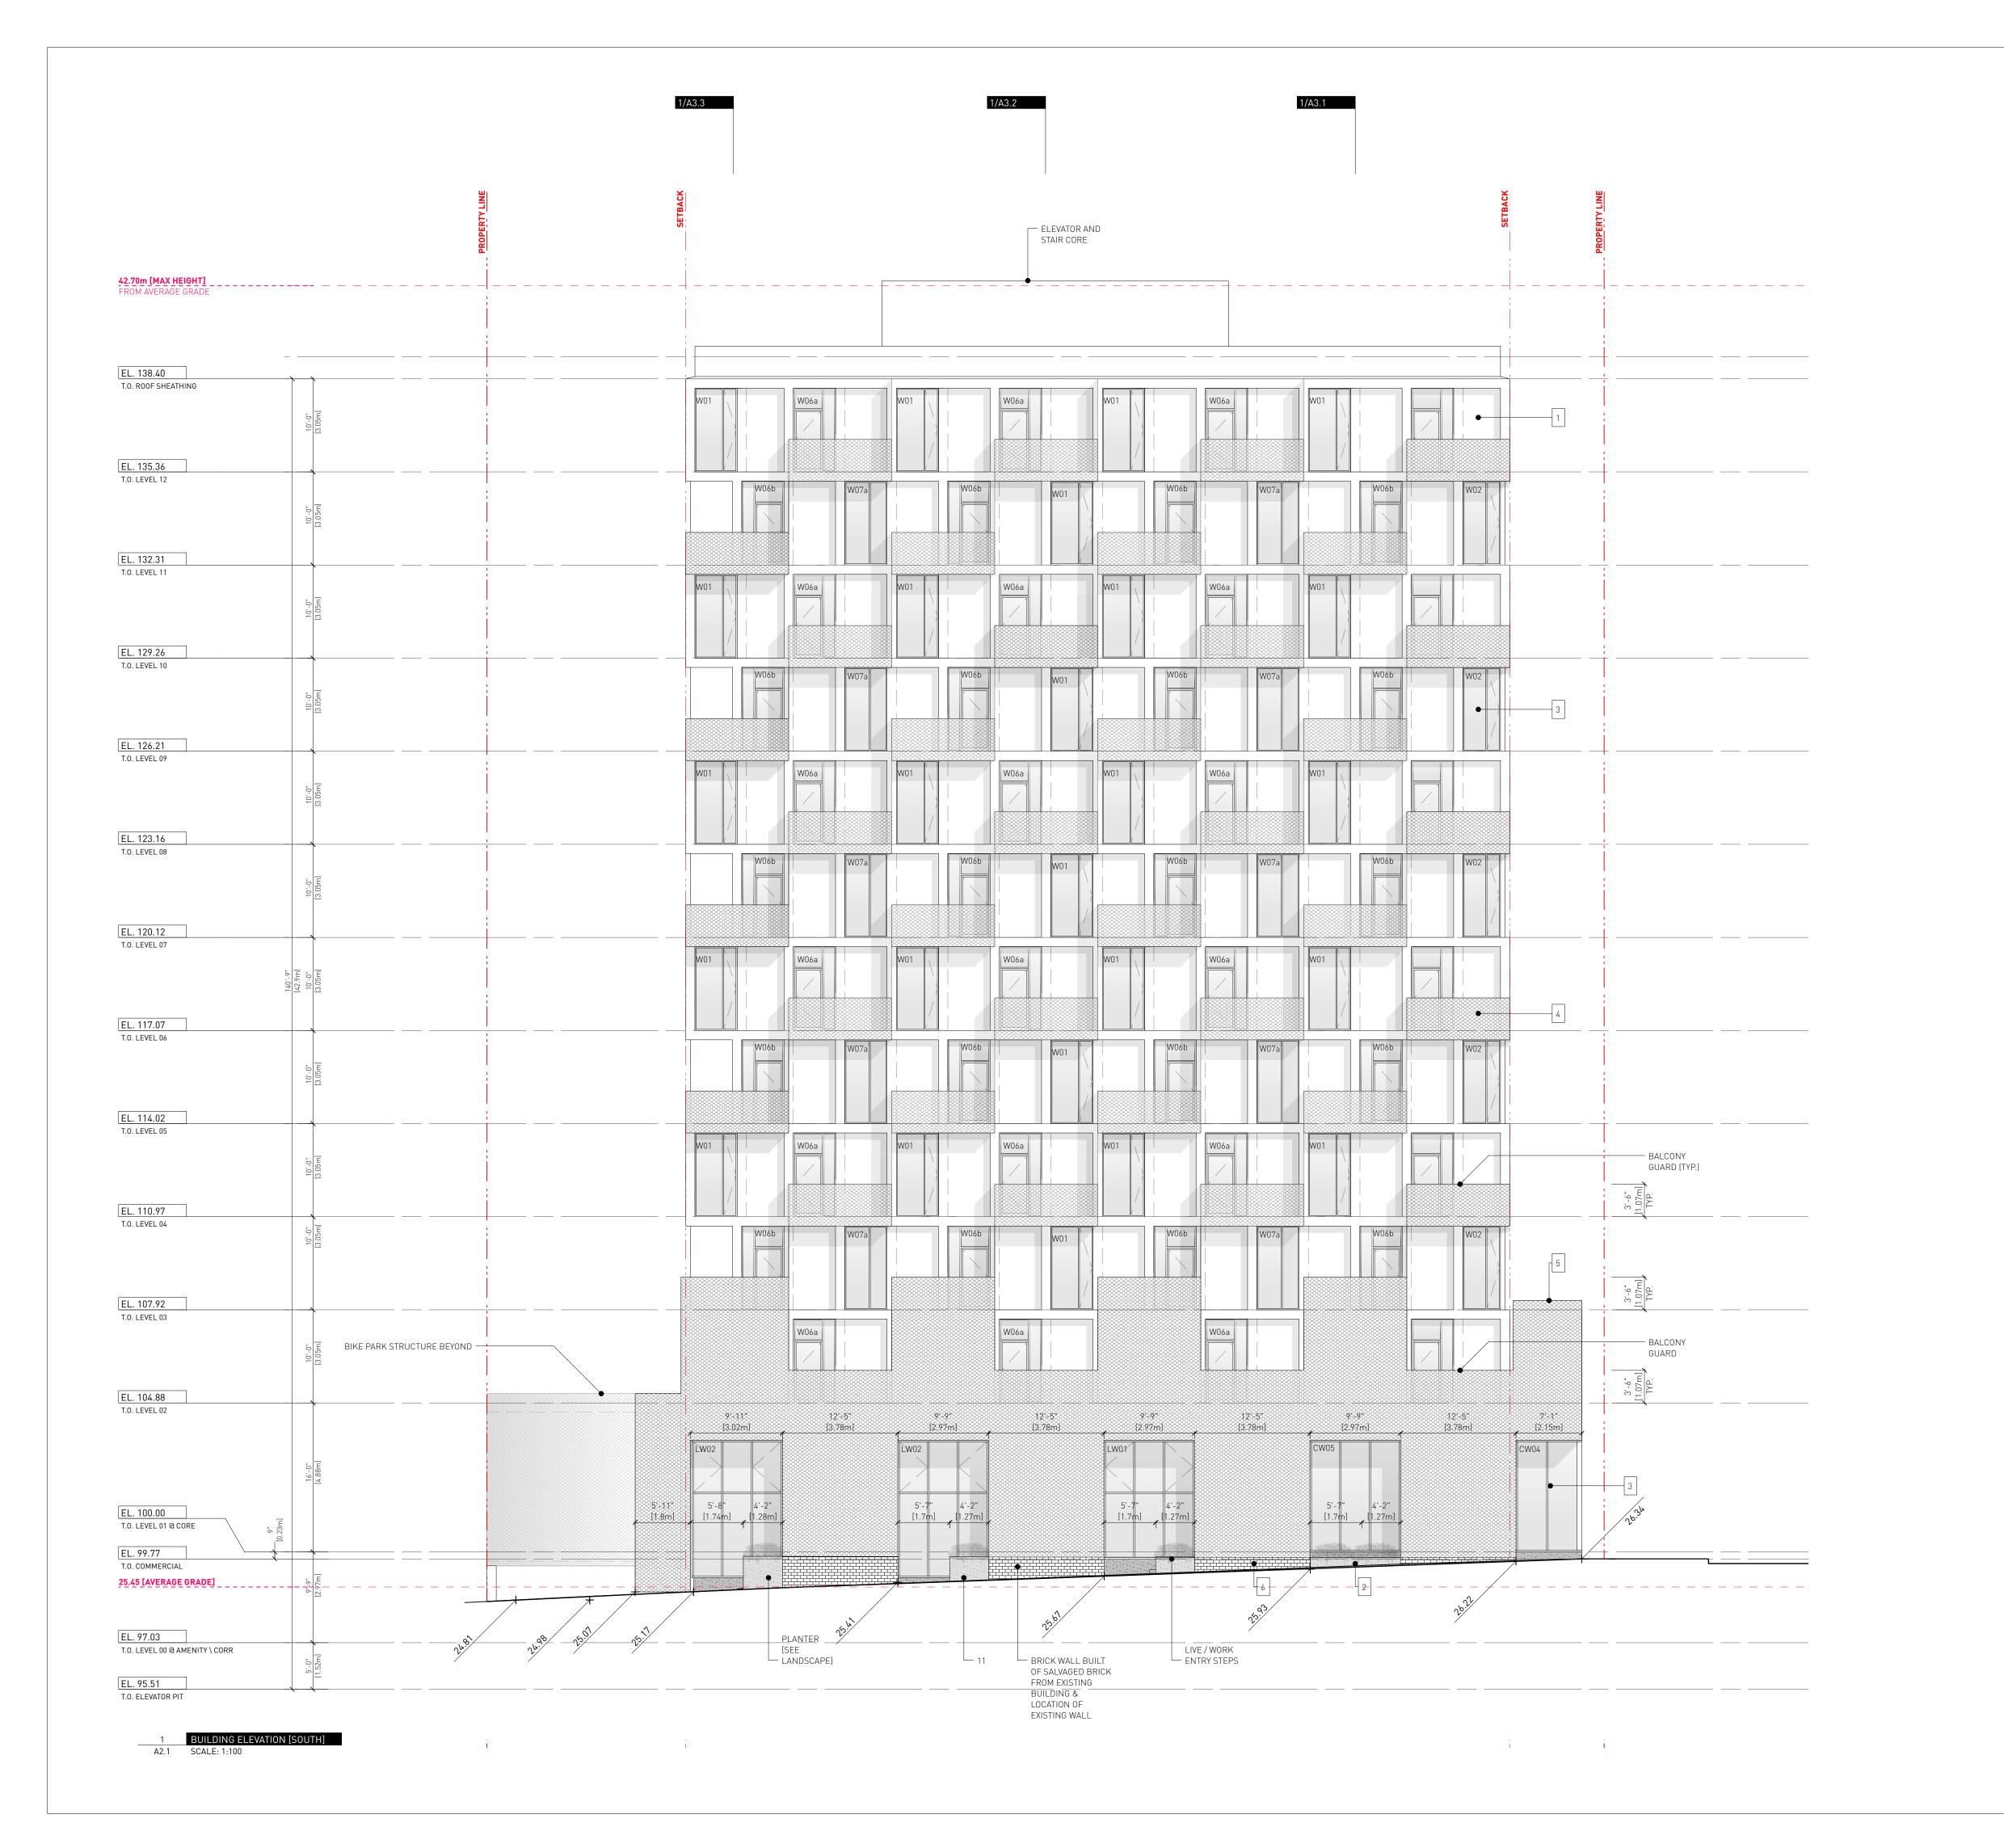



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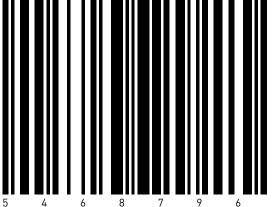
ROOF PLAN

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Project





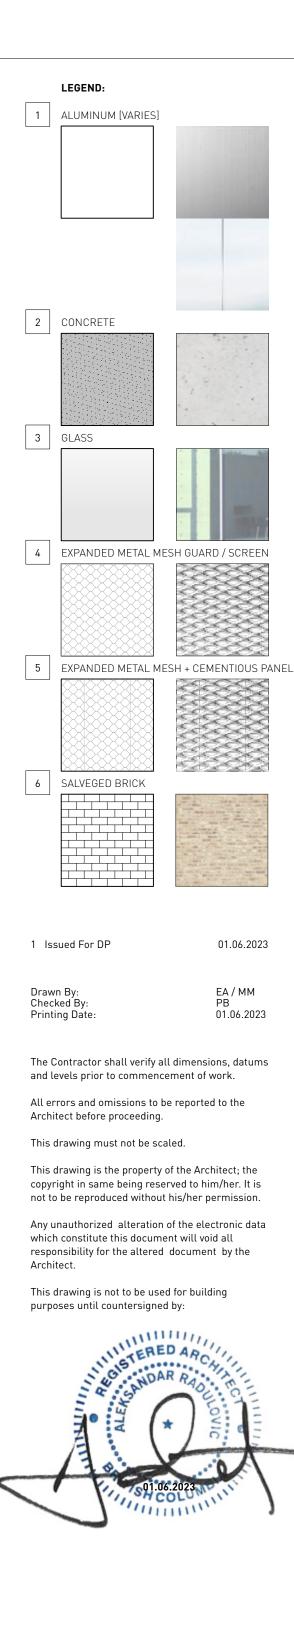

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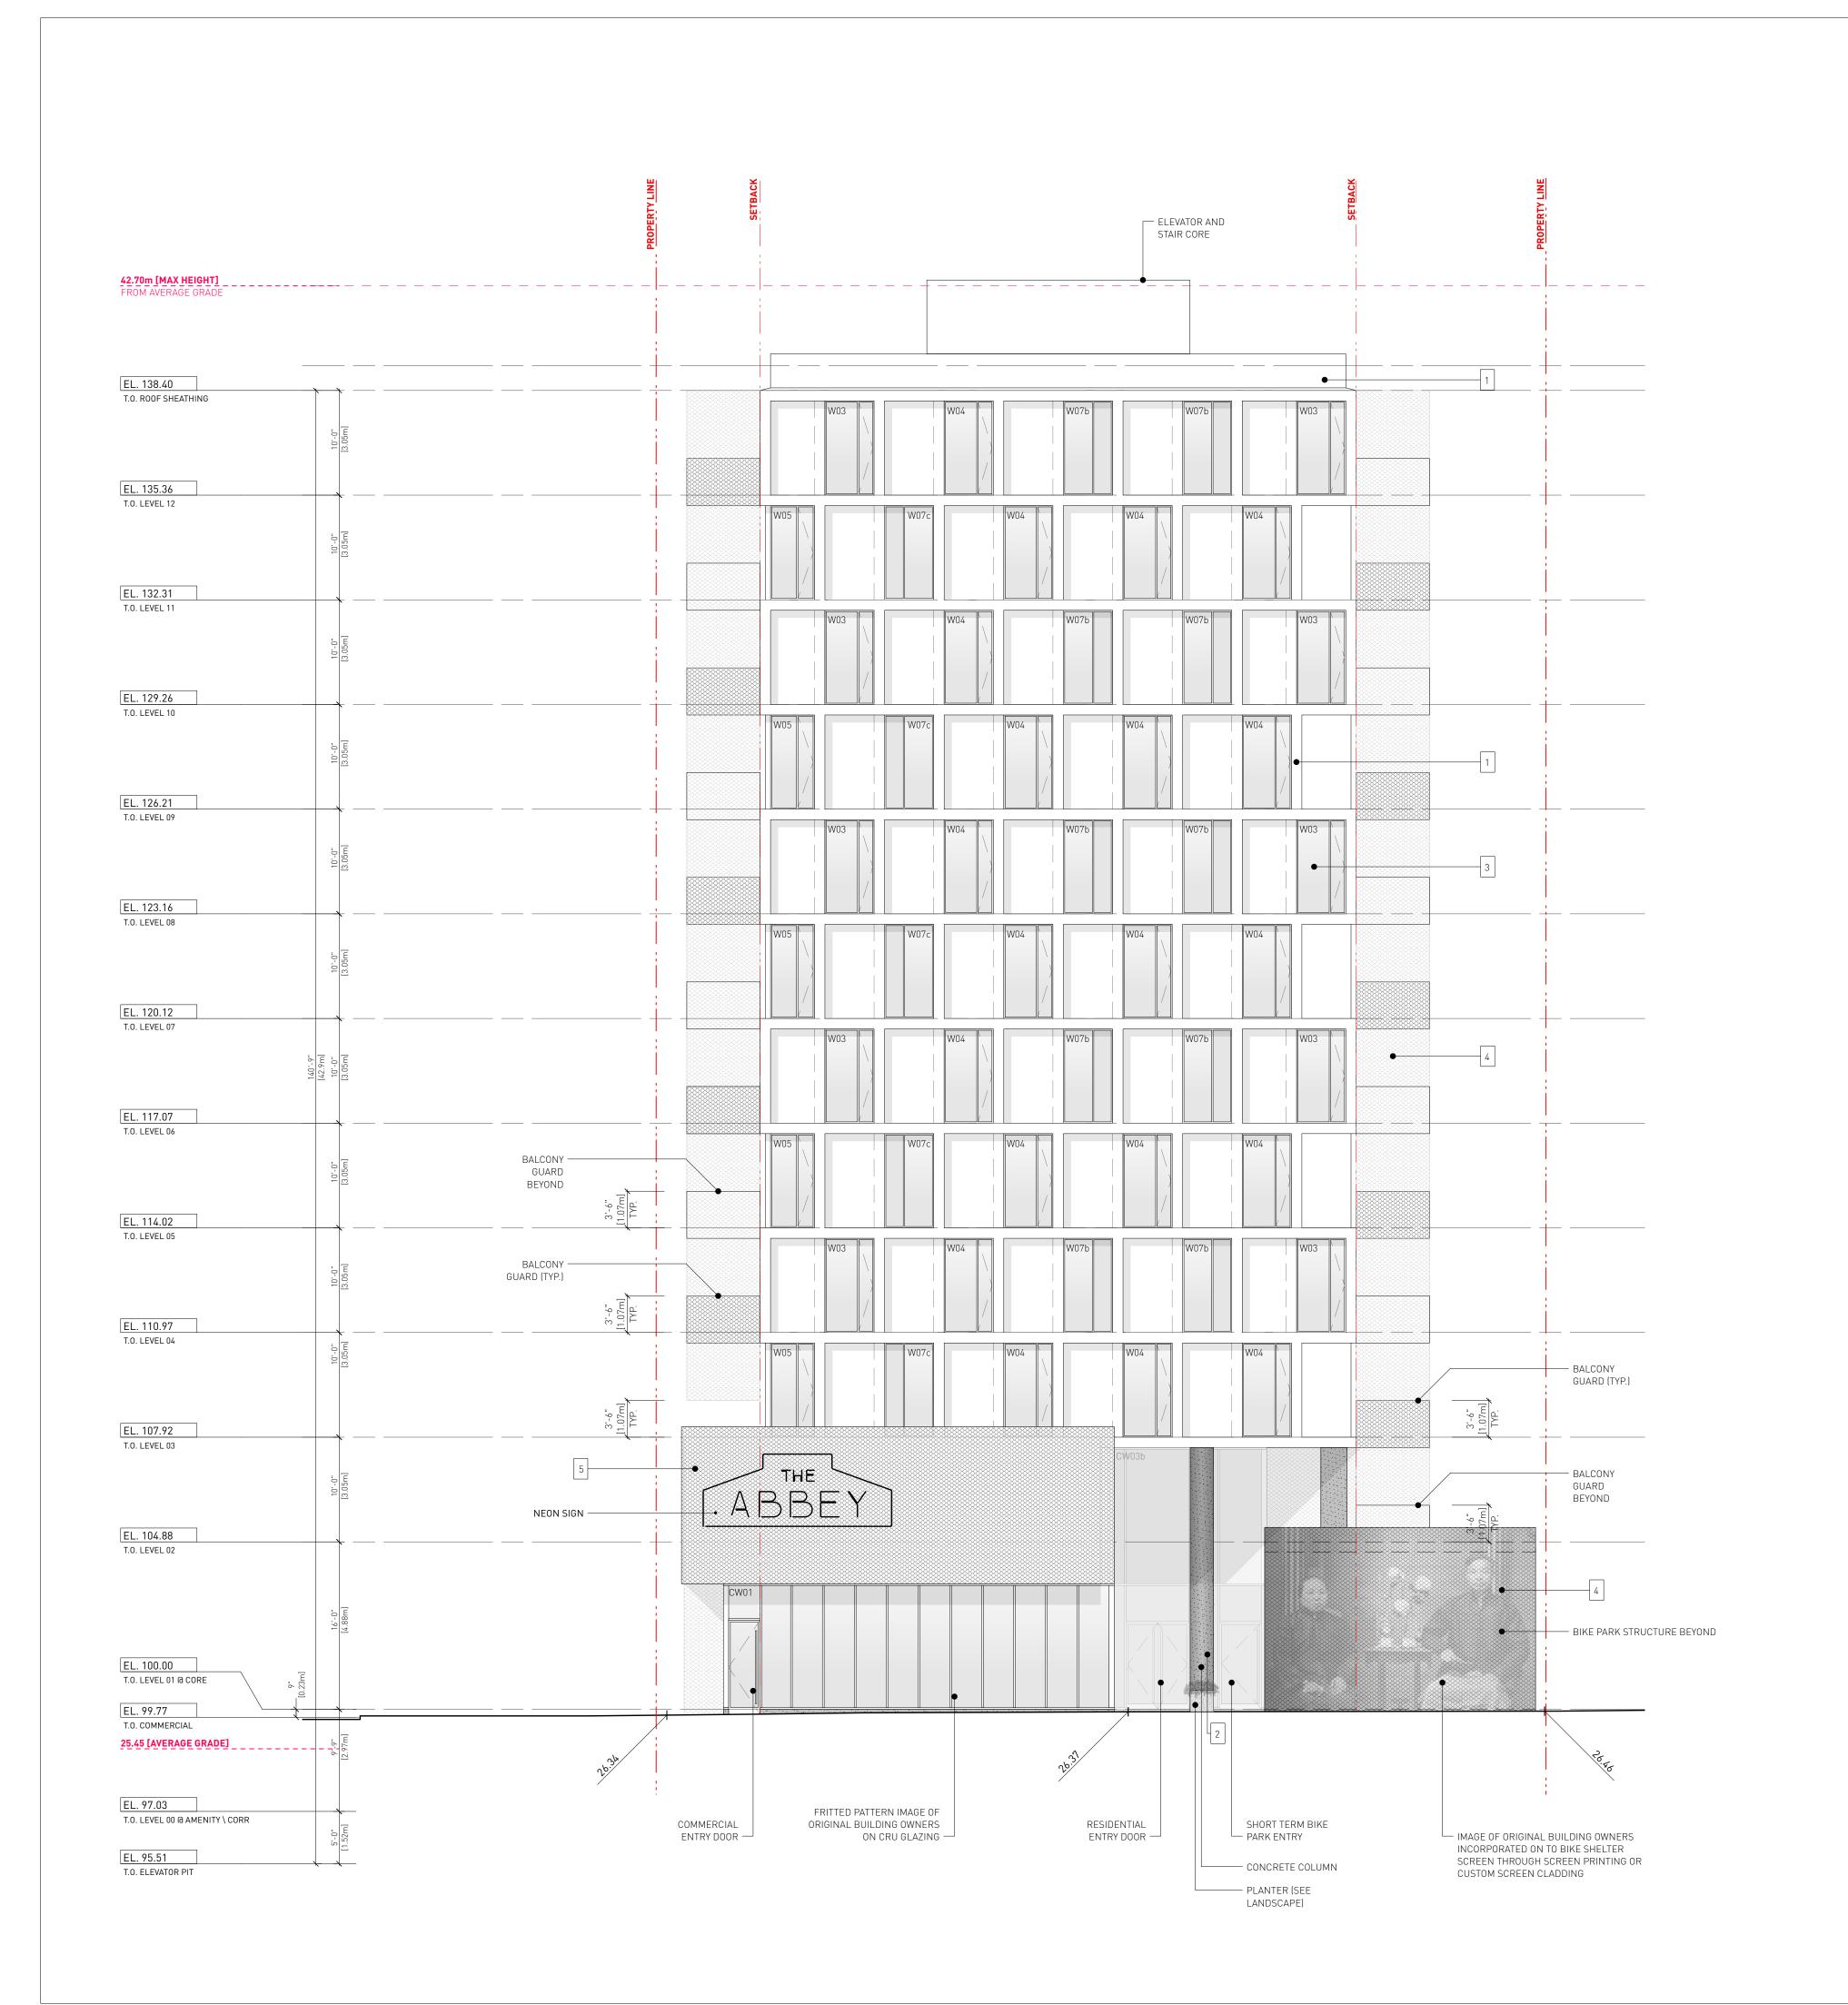
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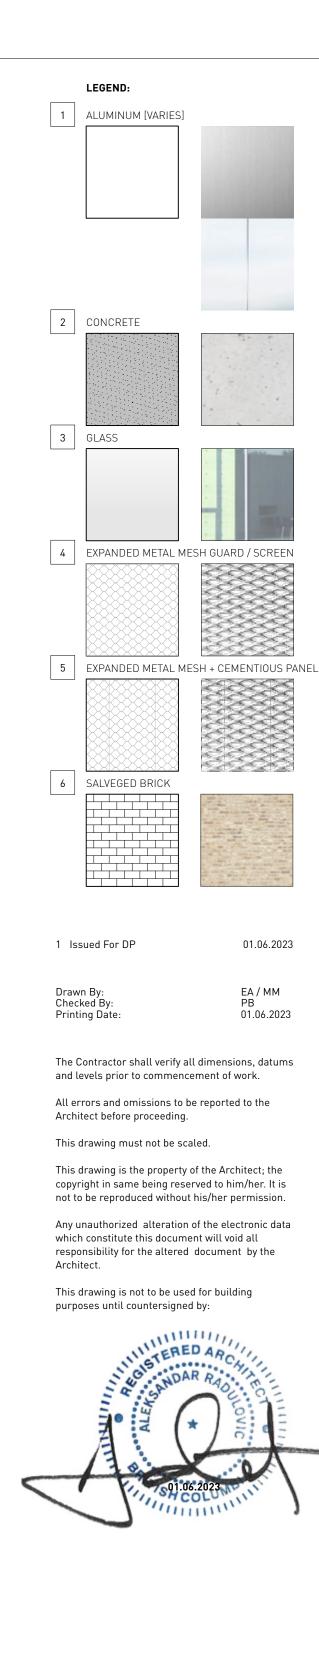
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BUILDING ELEVATIONS Project 0650


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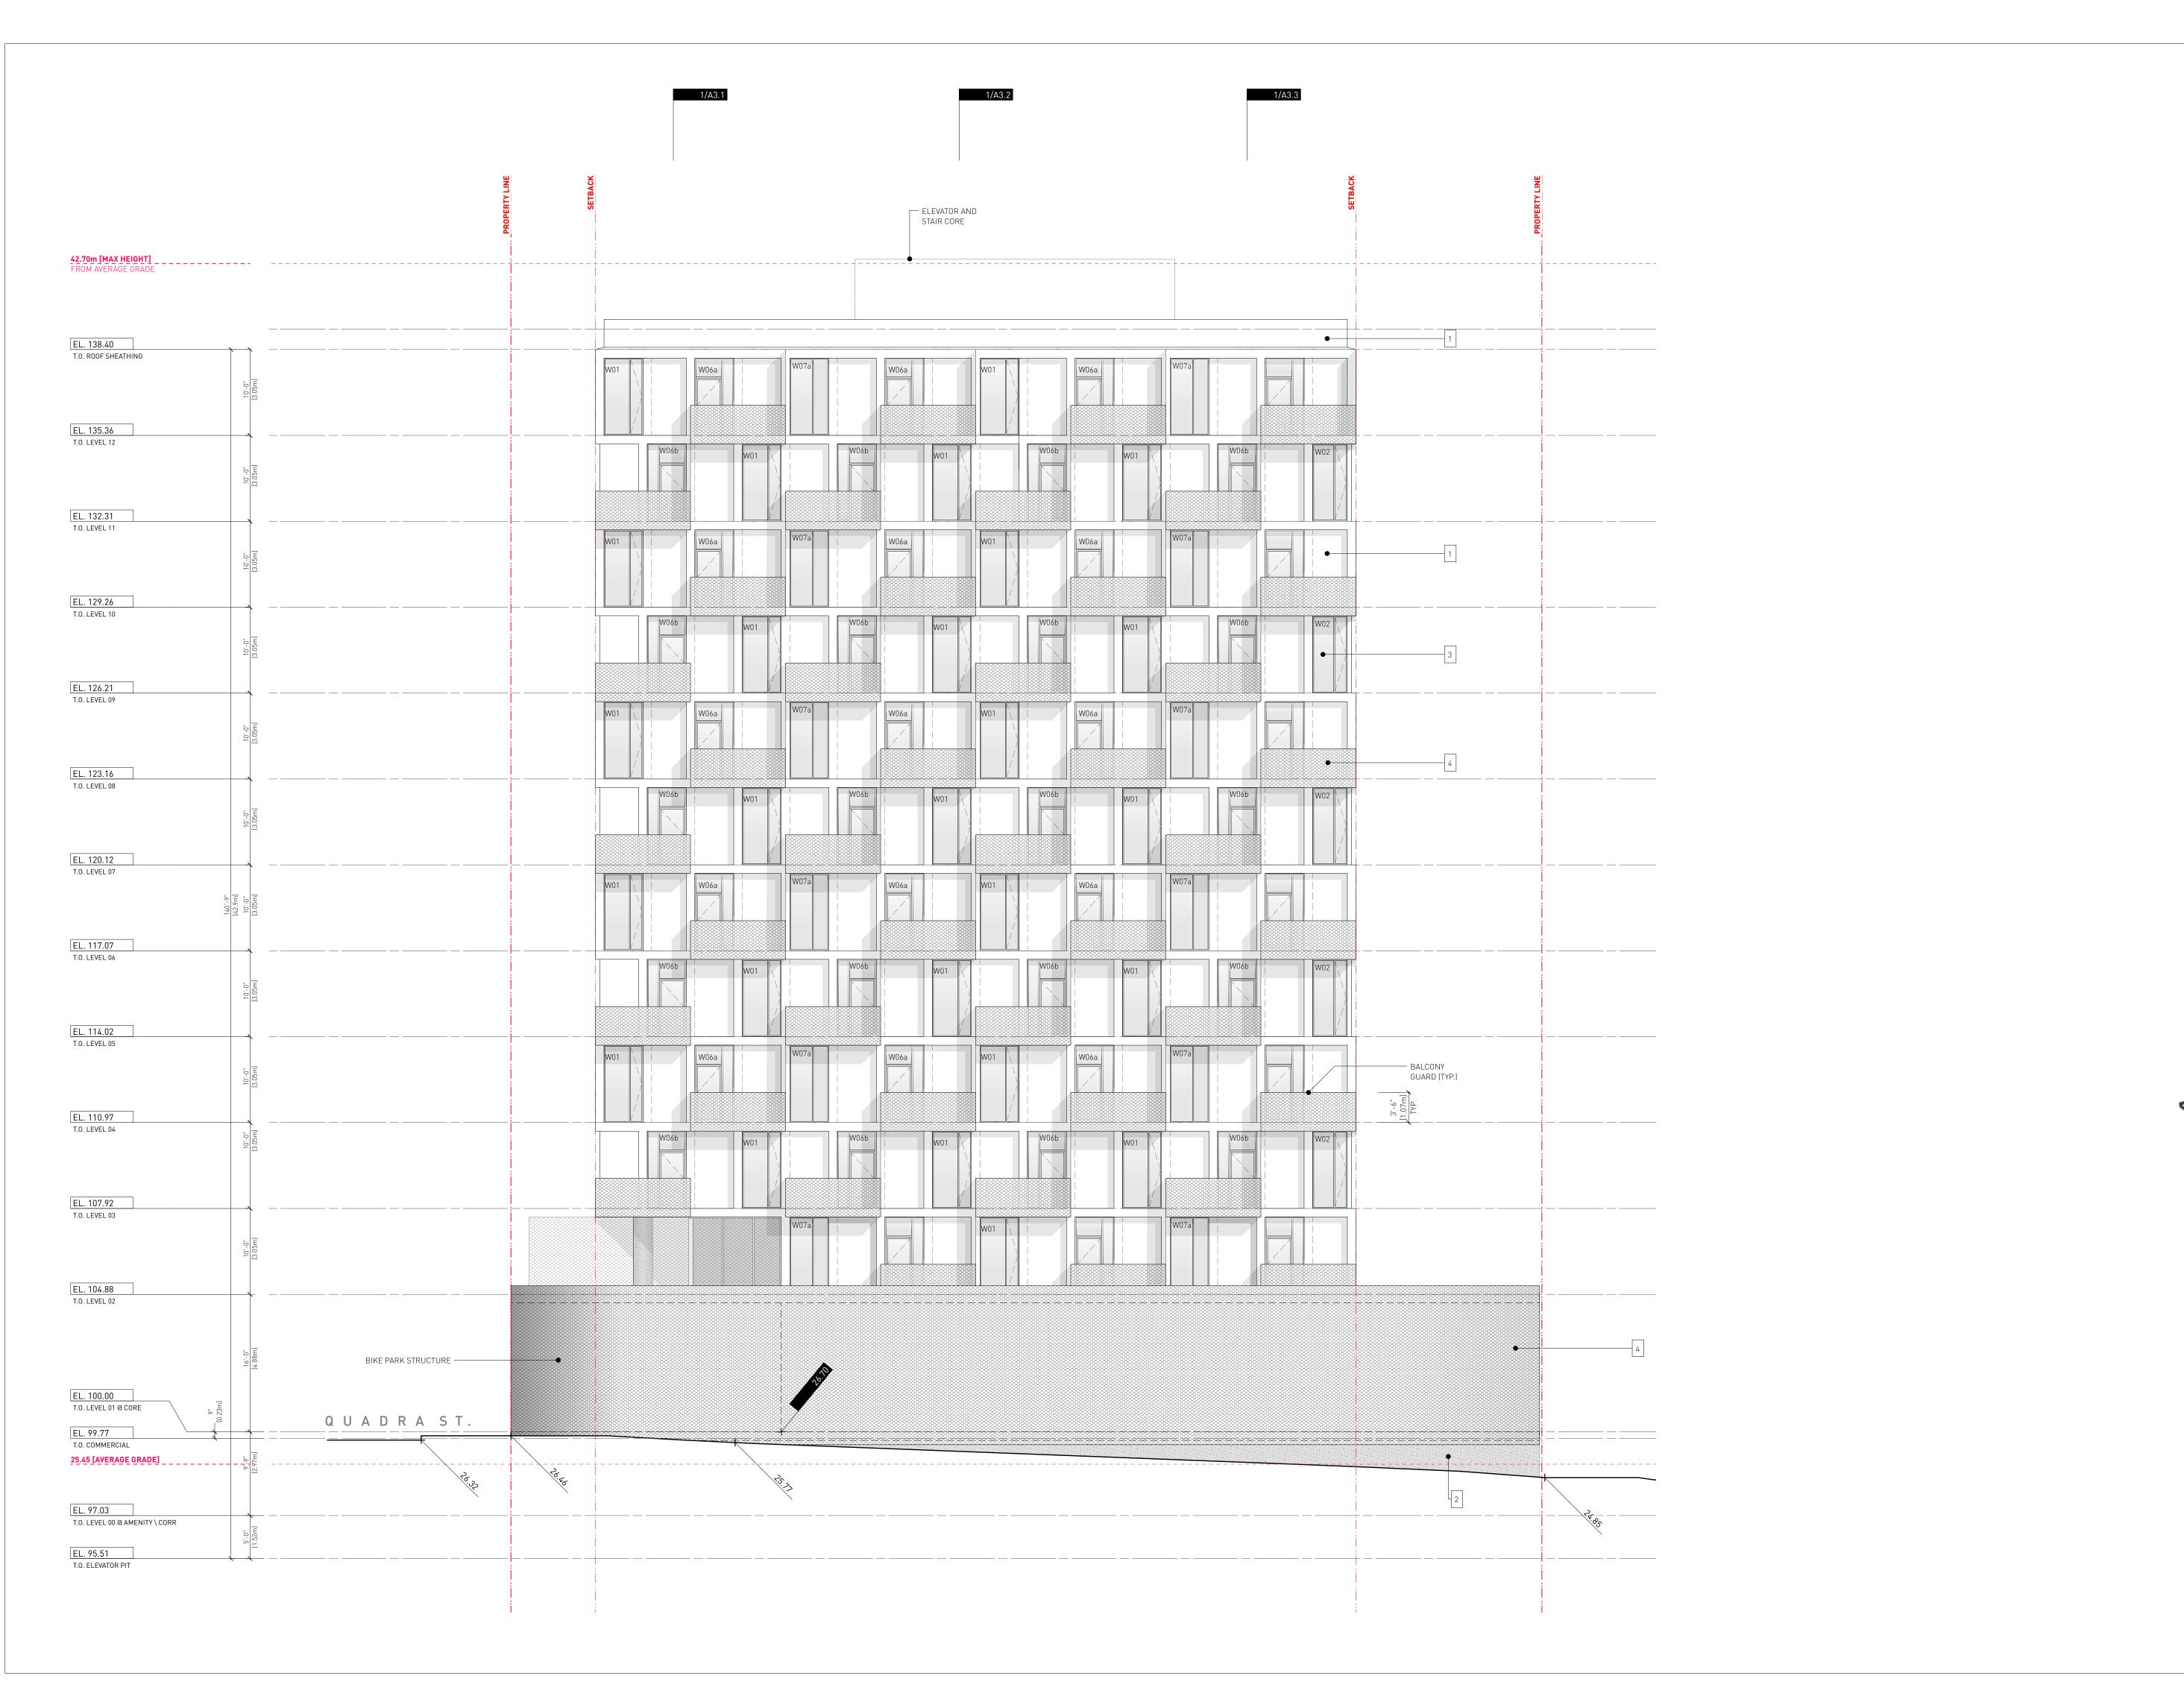
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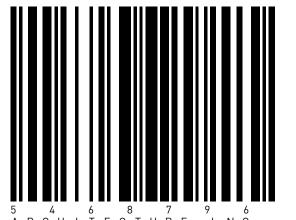
BUILDING ELEVATIONS Project

0650 Sheet

A2.2





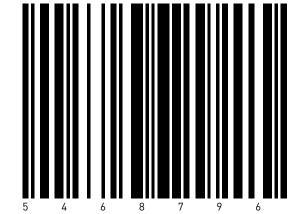


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BUILDING ELEVATIONS
Project
0650


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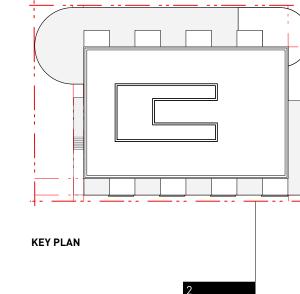
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1702 QUADRA STREET + 862 FISGARD STREET

BUILDING ELEVATIONS Project

0650 Sheet A2.4

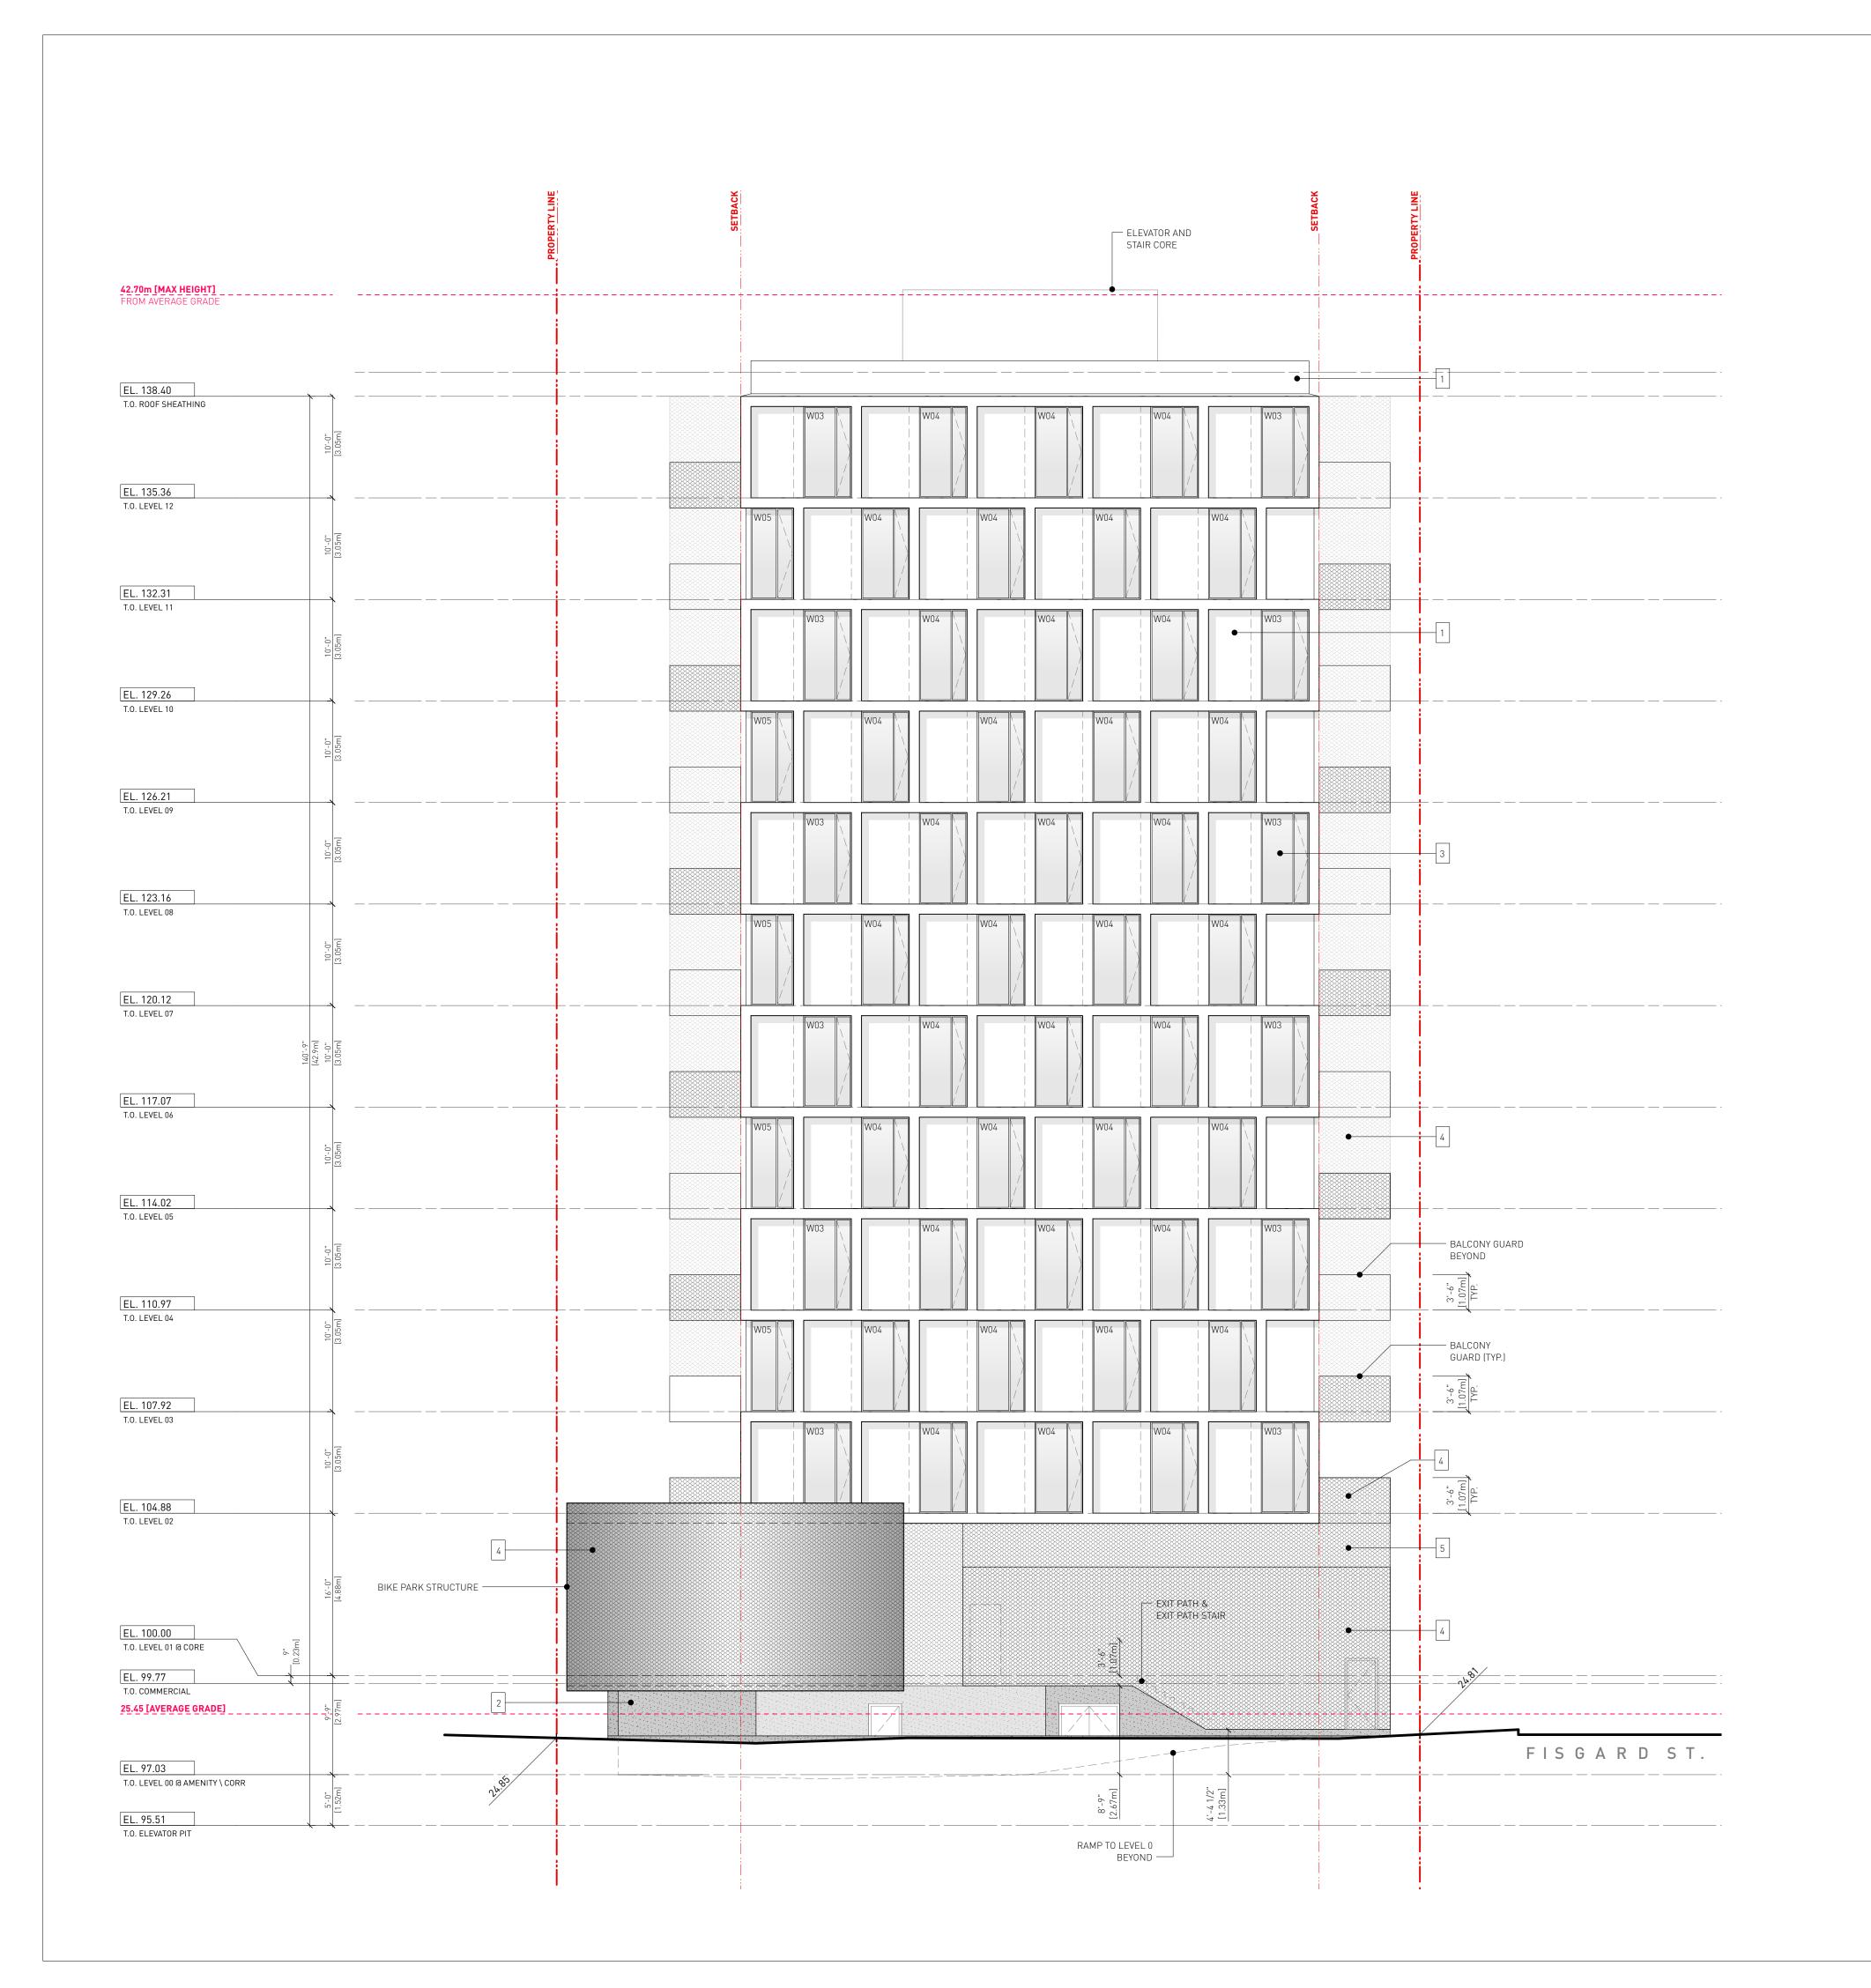

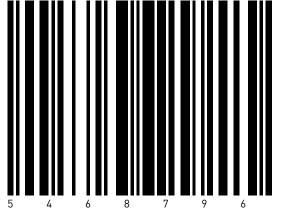

LEGEND: 1 ALUMINUM [VARIES] 2 CONCRETE 3 GLASS 4 EXPANDED METAL MESH GUARD / SCREEN 5 EXPANDED METAL MESH + CEMENTIOUS PANEL 6 SALVEGED BRICK 1 Issued For DP Drawn By: Checked By: Printing Date:

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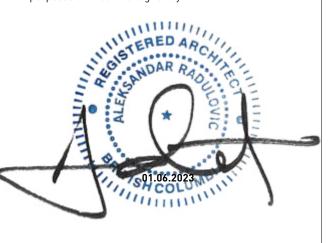
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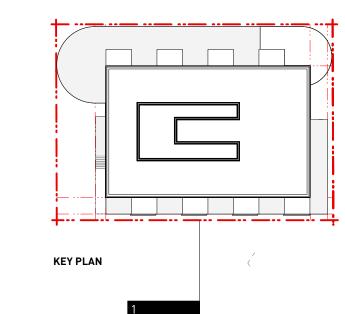
1702 QUADRA STREET + 862 FISGARD STREET

BUILDING SECTION

0650 Sheet

A3.1





LEGEND:

1 ALUMINUM [VARIES]

2 CONCRETE

3 GLASS

4 EXPANDED METAL MESH GUARD / SCREEN

5 EXPANDED METAL MESH + CEMENTIOUS PANEL

6 SALVEGED BRICK

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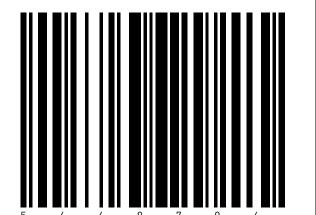
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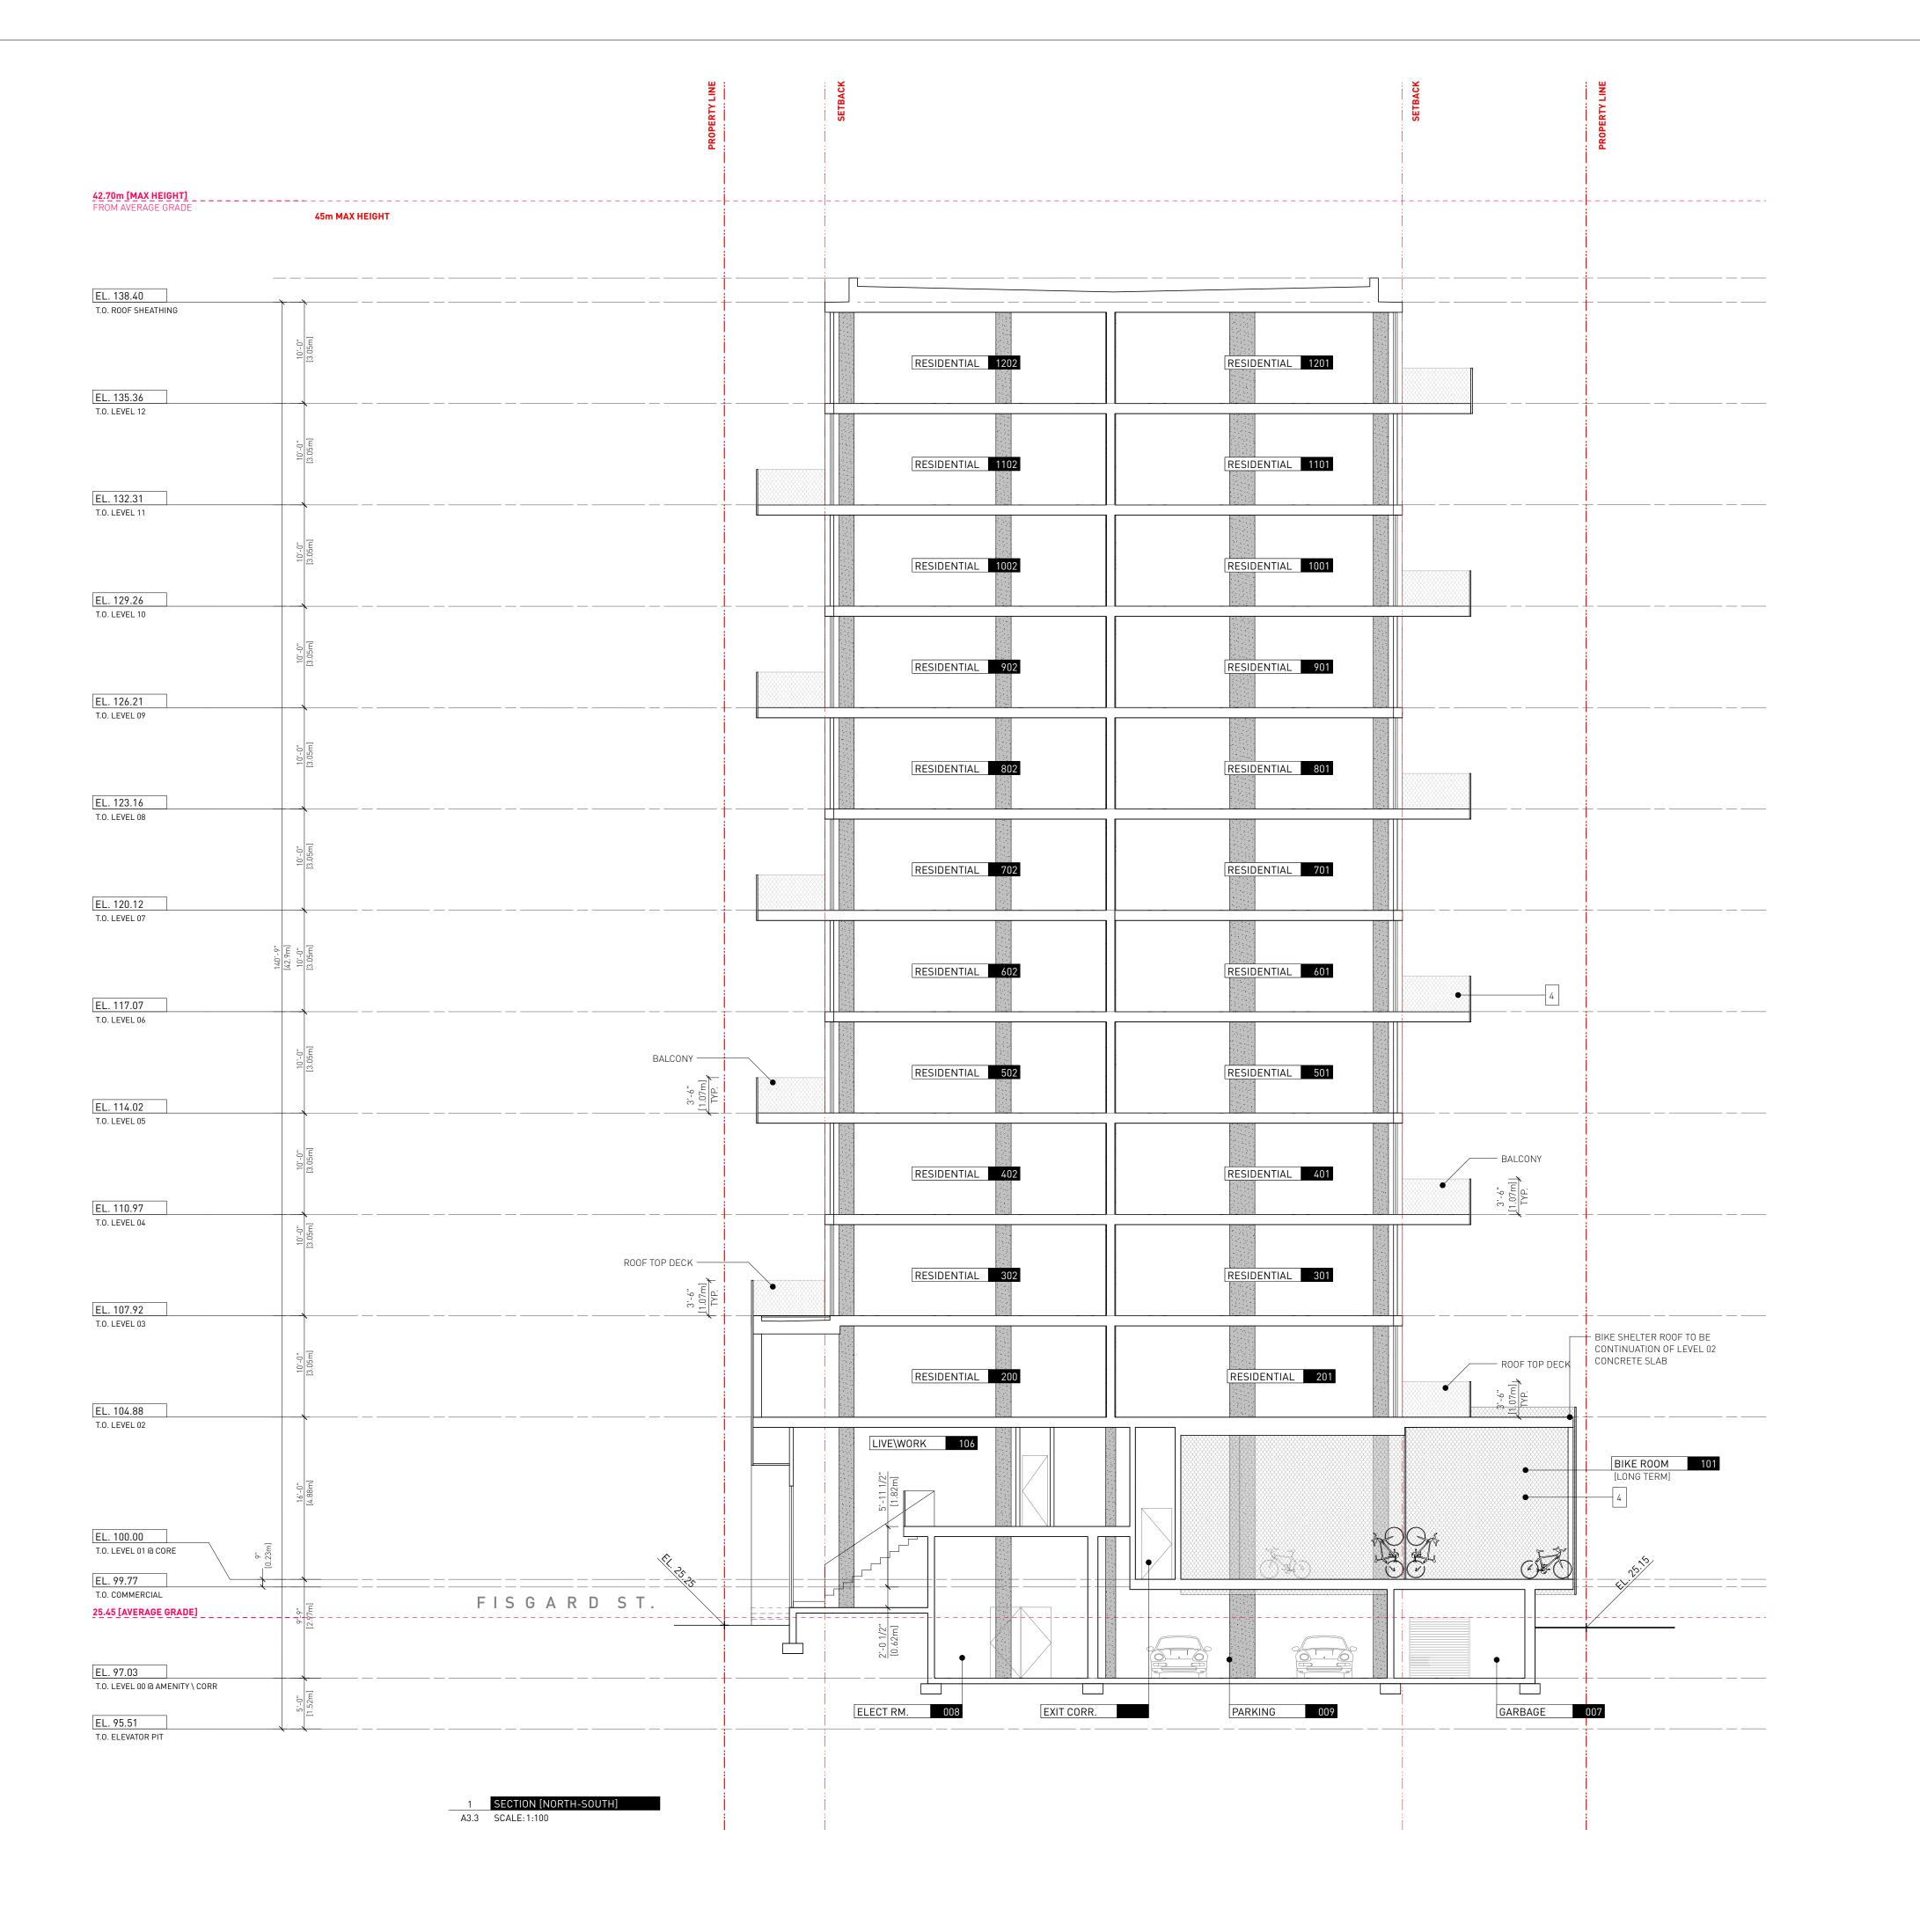
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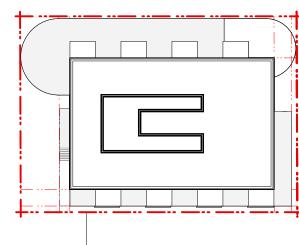
1702 QUADRA STREET + 862 FISGARD STREET

BUILDING SECTION

0650 Sheet

A3.2





KEY PLAN

LEGEND: 1 ALUMINUM [VARIES] 2 CONCRETE 3 GLASS 4 EXPANDED METAL MESH GUARD / SCREEN 5 EXPANDED METAL MESH + CEMENTIOUS PANEL 6 SALVEGED BRICK 1 Issued For DP Drawn By: Checked By: Printing Date:

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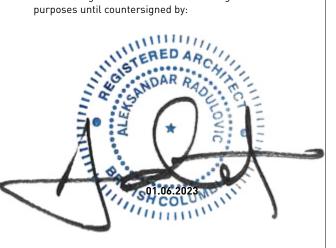
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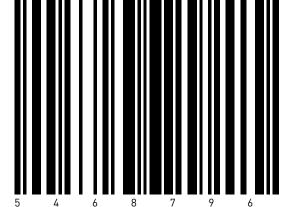
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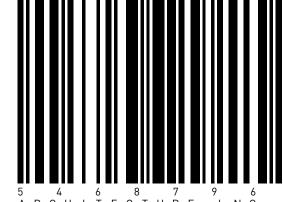
BUILDING SECTION

0650 Sheet

A3.3



LEGEND: 1 ALUMINUM [VARIES] 2 CONCRETE 3 GLASS 4 EXPANDED METAL MESH GUARD / SCREEN 5 EXPANDED METAL MESH + CEMENTIOUS PANEL 6 SALVEGED BRICK 1 Issued For DP 01.06.2023 Drawn By: Checked By: Printing Date: PB 01.06.2023 The Contractor shall verify all dimensions, datums and levels prior to commencement of work. All errors and omissions to be reported to the Architect before proceeding. This drawing must not be scaled. This drawing is the property of the Architect; the copyright in same being reserved to him/her. It is Any unauthorized alteration of the electronic data which constitute this document will void all responsibility for the altered document by the This drawing is not to be used for building purposes until countersigned by:



266 MCDERMOT AVE Winnipeg MB R3B 0S8 P: 204.480.8421 F: 204.480.8876

1702 QUADRA STREET + 862 FISGARD STREET

BUILDING SECTION

0650 Sheet

A3.4






5 4 6 8 7 9 6 A R C H I T E C T U R E I N C 266 MCDERMOT AVE Winnipeg MB R3B 0S8 P: 204.480.8421 F: 204.480.8876


1702 QUADRA STREET + 862 FISGARD STREET


BUILDING SECTION

0650 Sheet

A3.5

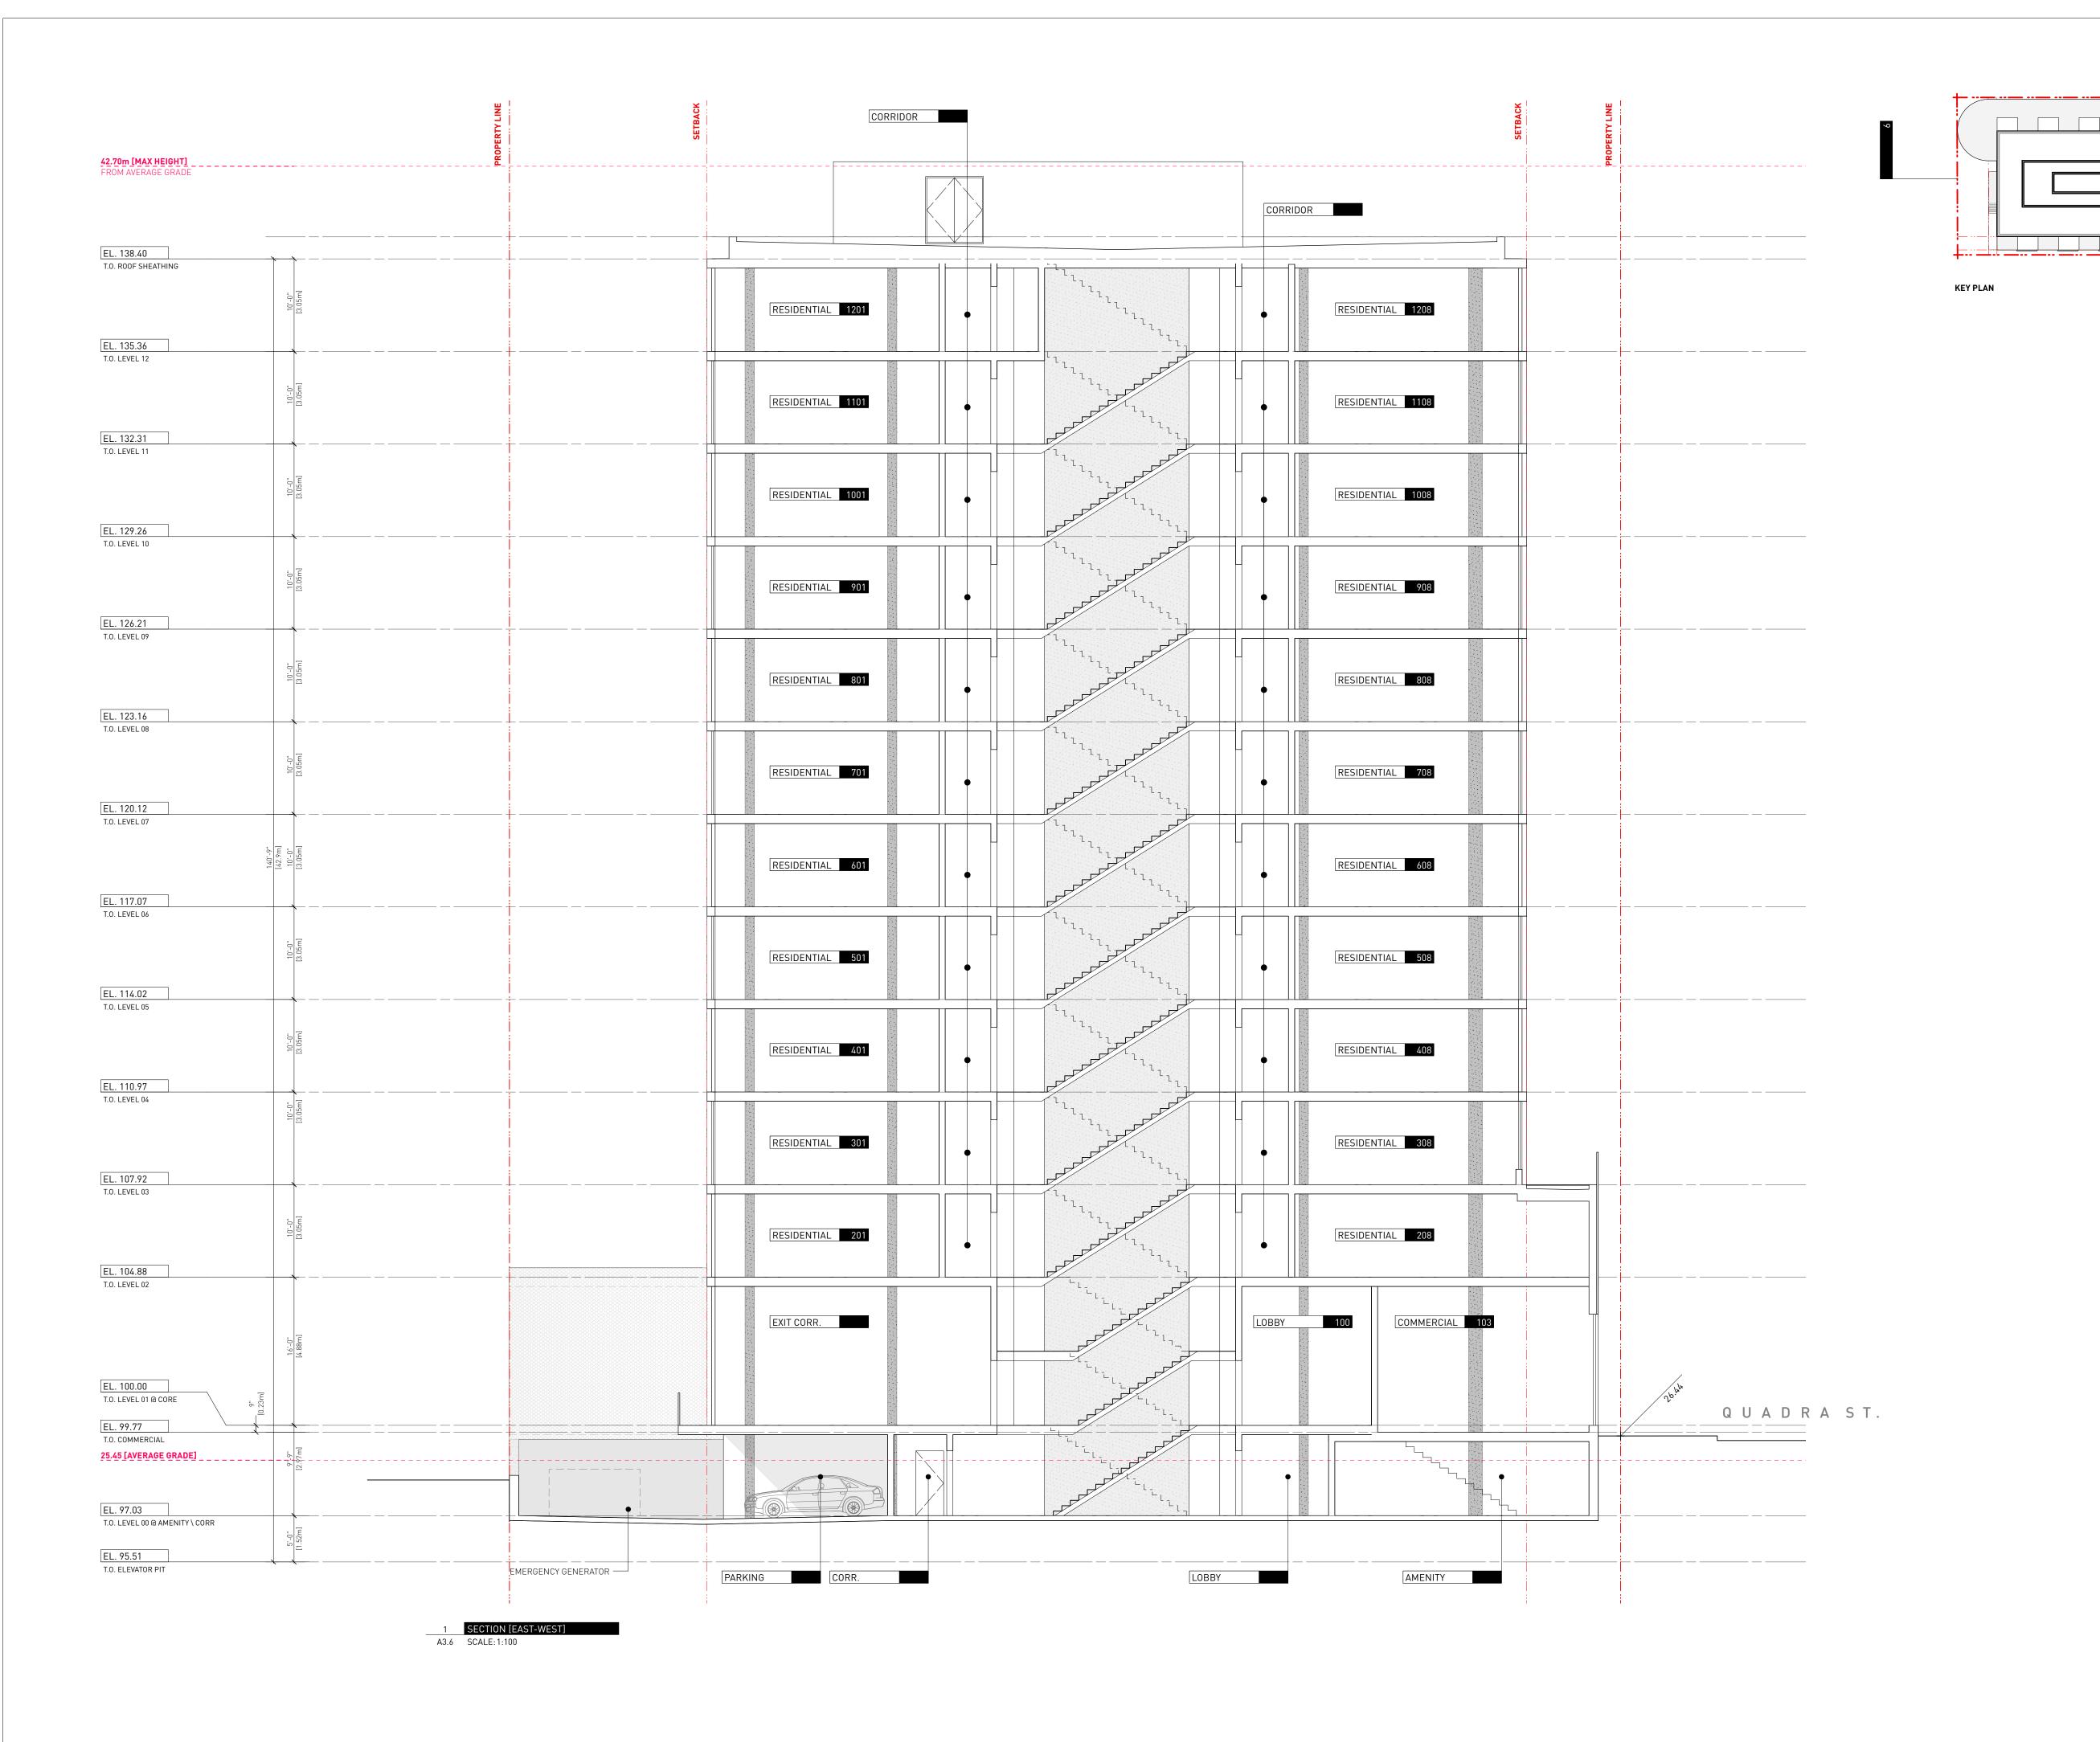

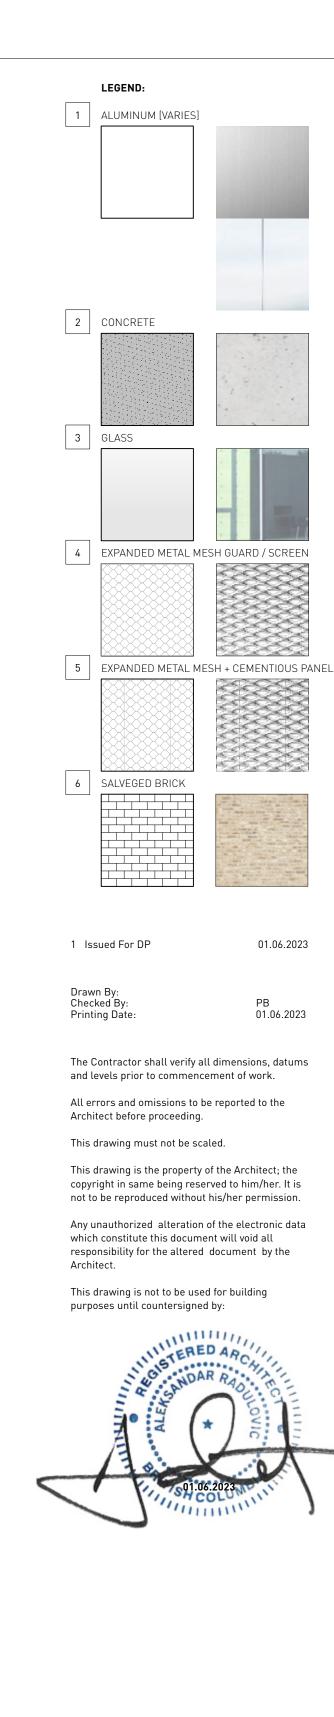

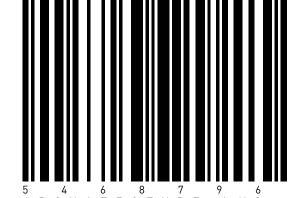

A R C H I T E C T U R E I N C

266 MCDERMOT AVE

Winnipeg MB R3B 0S8


P: 204.480.8421


F: 204.480.8876

1702 QUADRA STREET + 862 FISGARD STREET

BUILDING SECTION

0650 Sheet **A3.6**

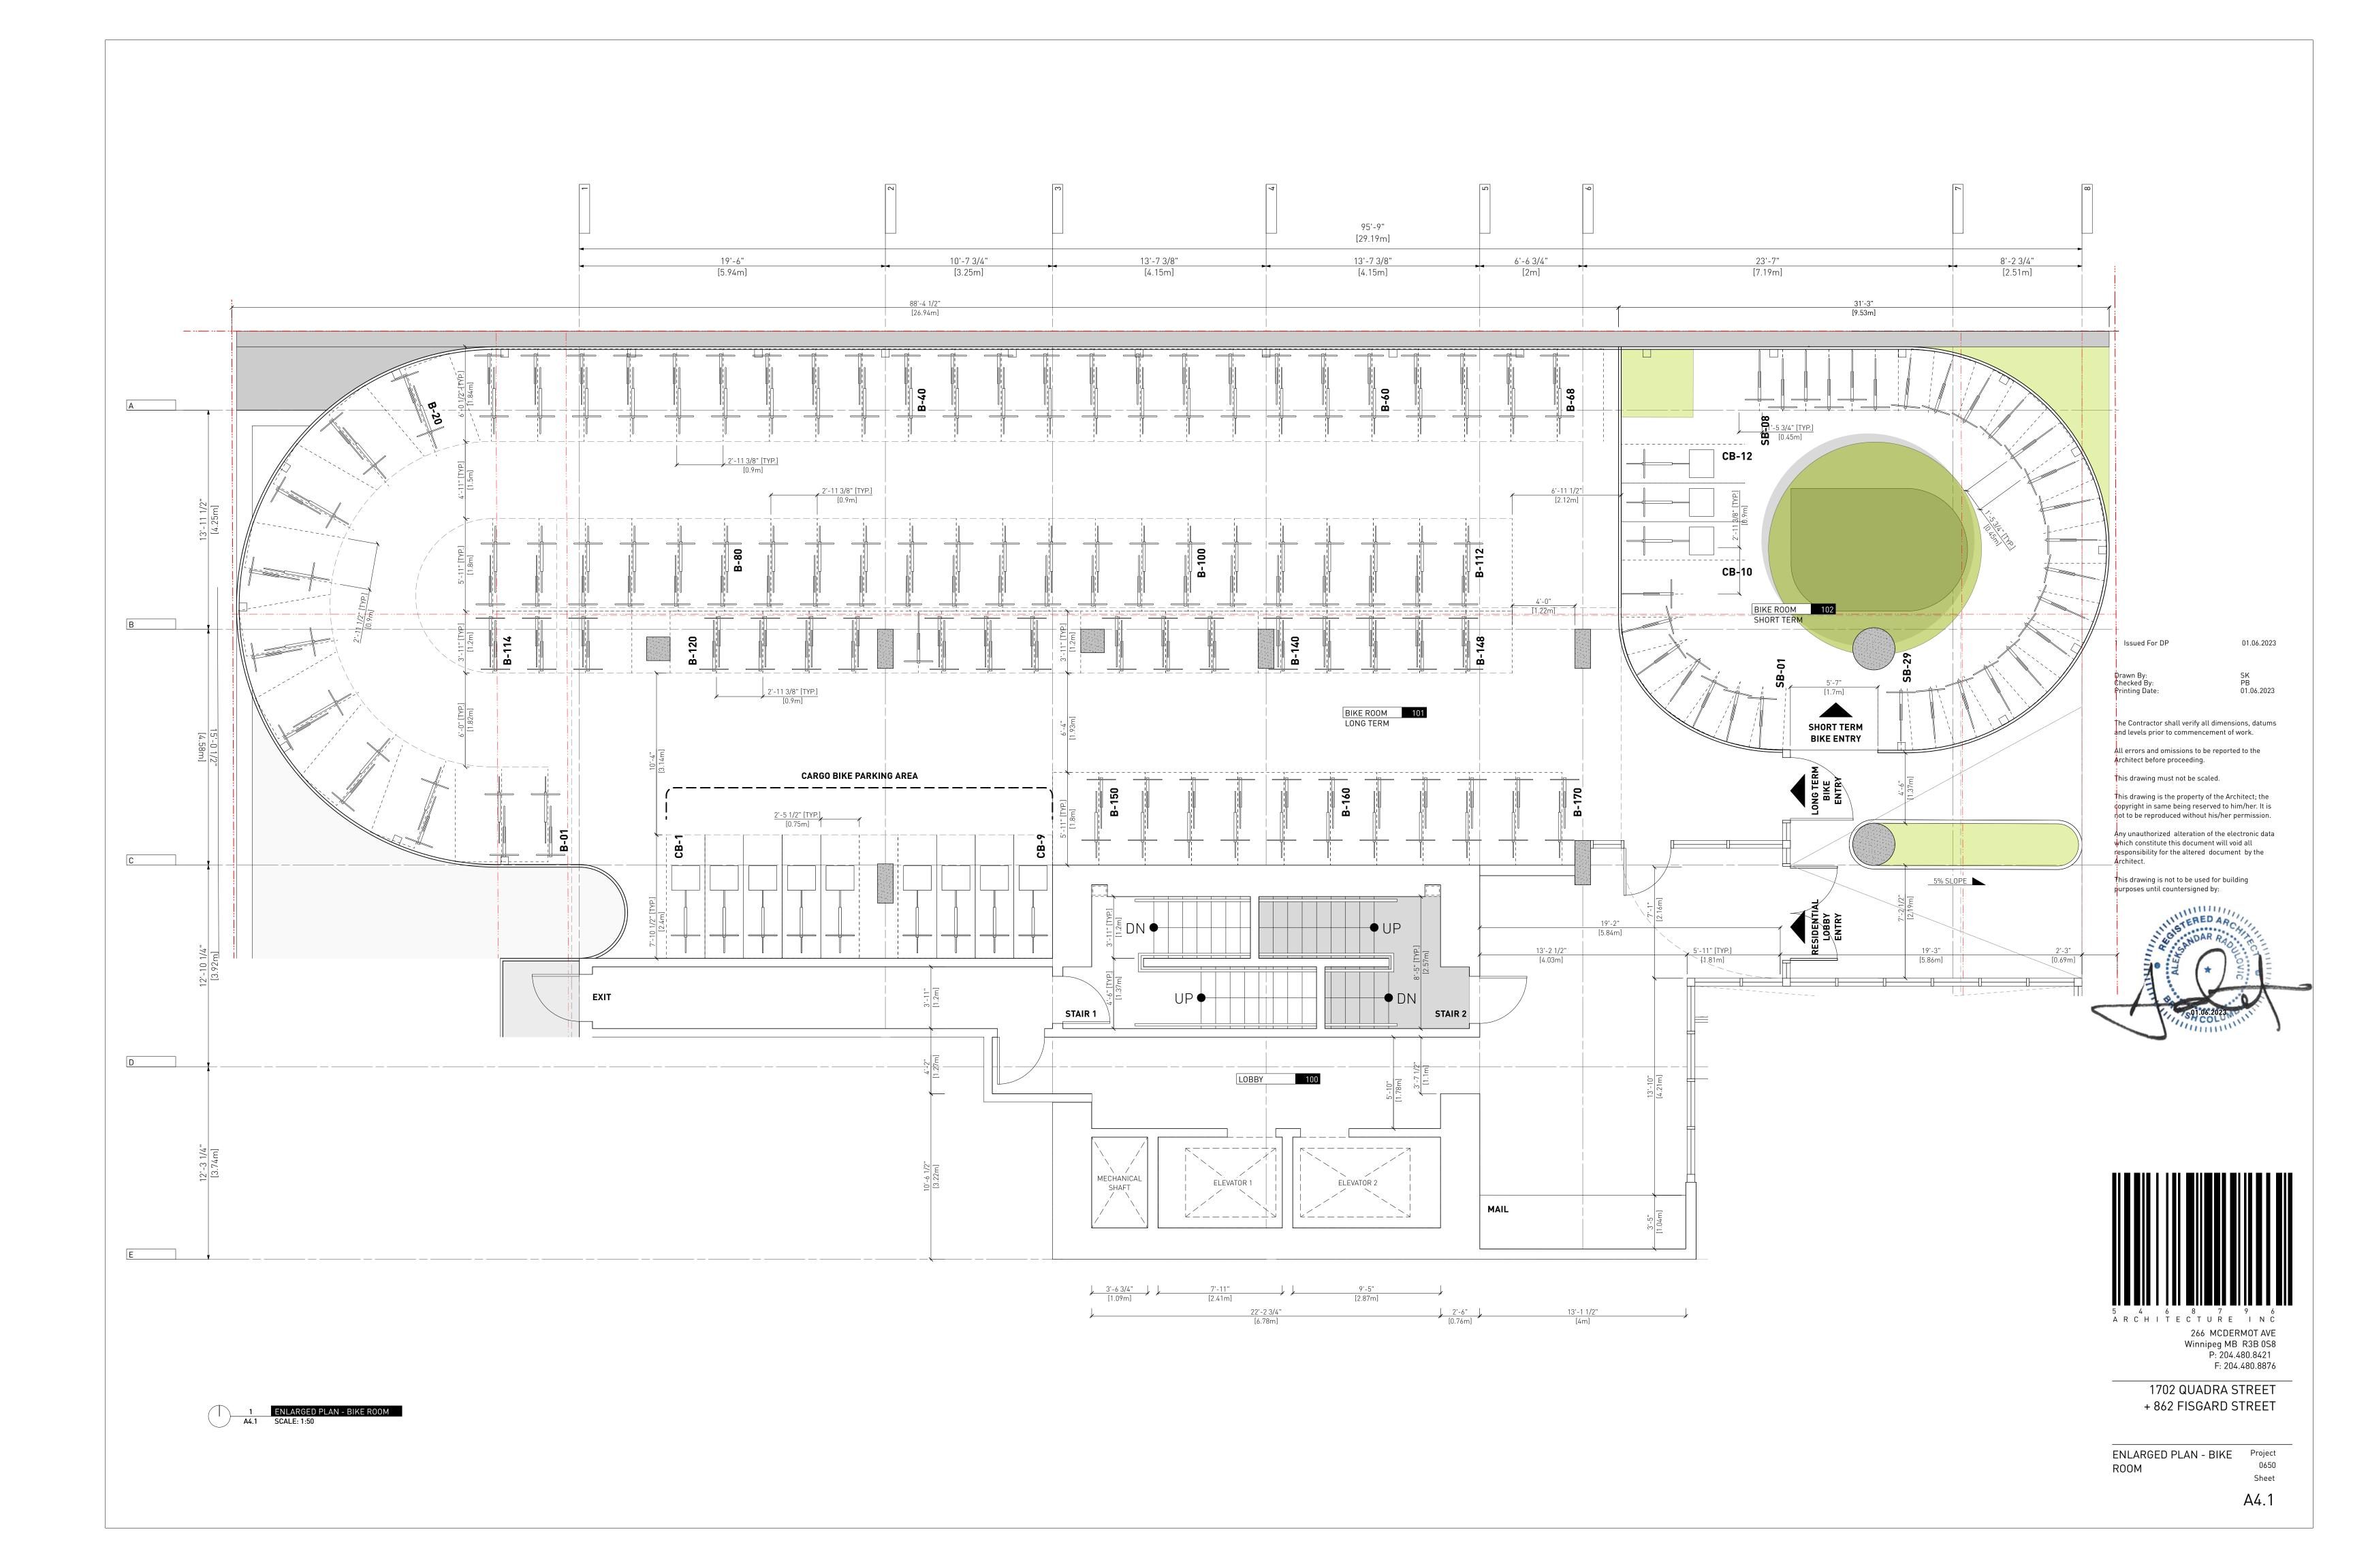

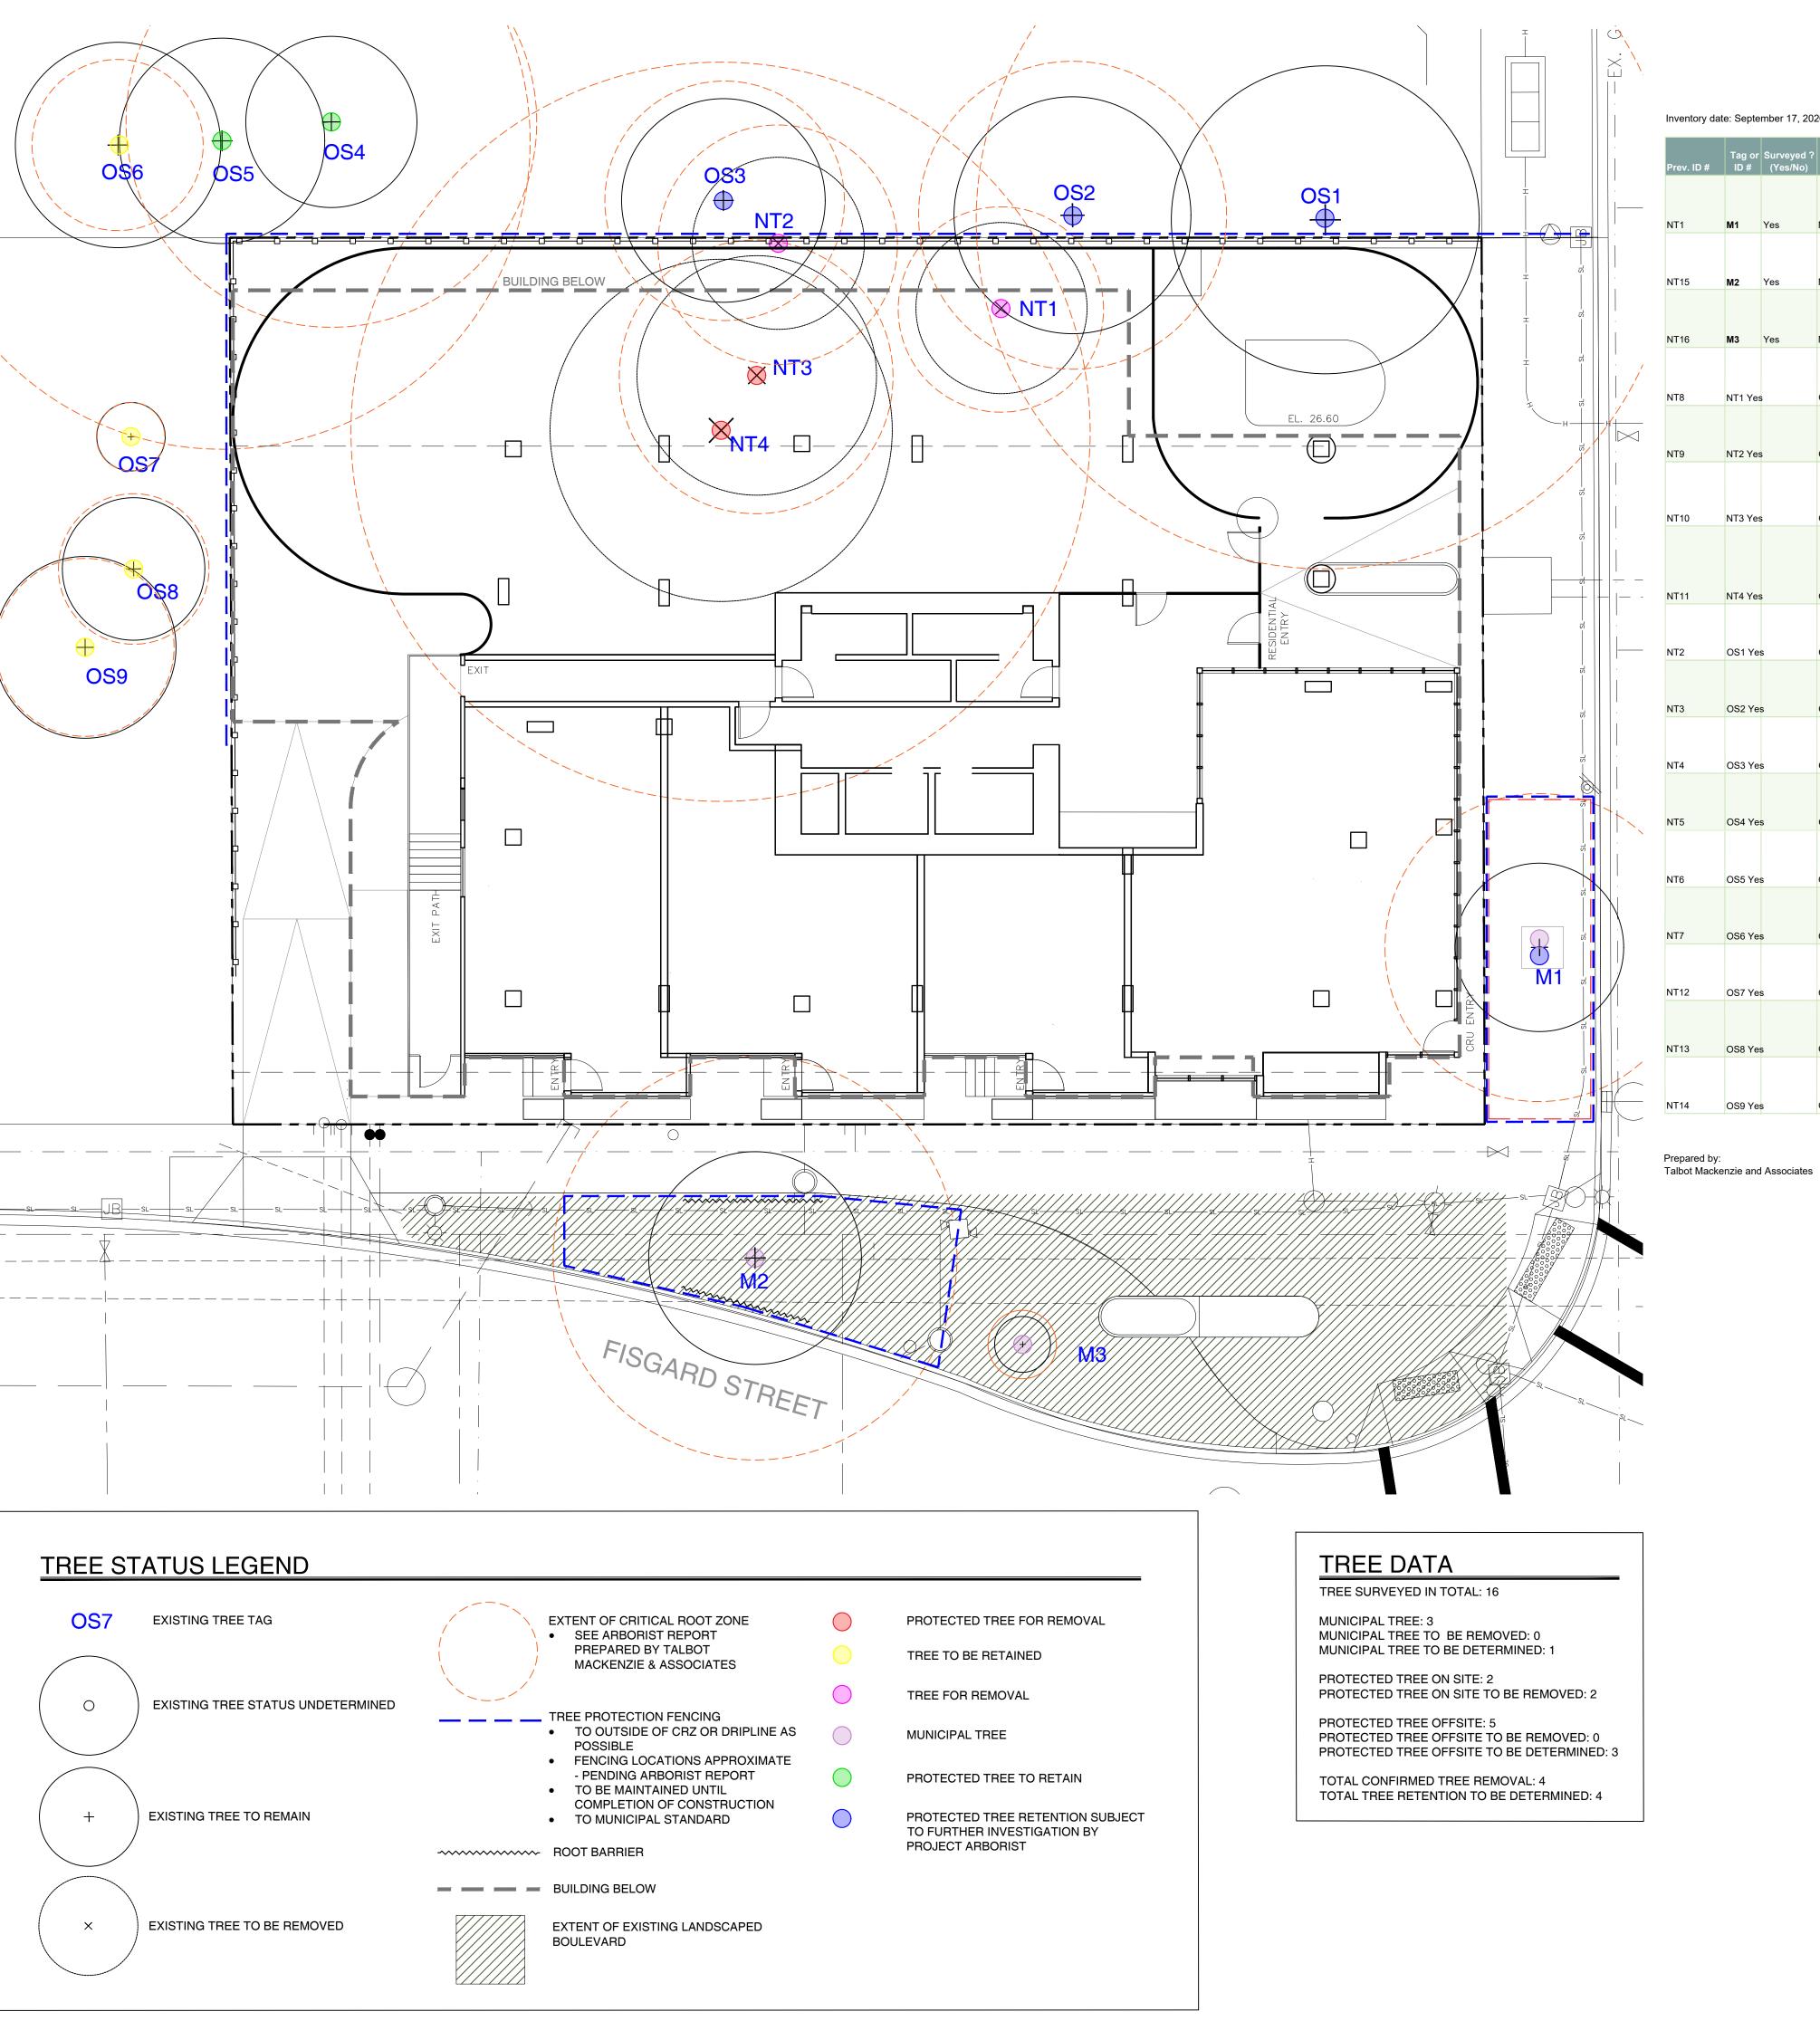

1702 Quadra Street - Tree Resource Spreadsheet

Inventory date: September 17, 2020

			Location (On,	Bylaw	Name			Critical root	Dripline	Condition		Retention			
Prev. ID#	Tag or ID #	Surveyed? (Yes/No)	Off, Shared, City)	protected ? (Yes/No)		Botanical	dbh (cm)	zone radius (m)	diameter (m)	Health	Structural	Suitability (onsite trees)		General field observations/remarks	Tree retention / location comments
		, , , ,	3,				, ,								
NT1	M1	Yes	Municipal	Municipal Eng	glish Oak Quercu	ıs robur 46		4.6	5	Fair	Fair		Good	Columnar form. Clearance pruned away from building.	Within proposed sidewalk (if tragrate is not retained).
					-									, ,	,
							49								
NT15	M2	Yes	Municipal	Municipal Cu		Fagus sylvatica 'Asplenifolia'	(below union)	5.9	6	Good	Fair		Poor	Measured at 1m. Hydro clearance pruned.	May be impacted by sidewalk/underground services
					Deciduous	O4									Detential conflict with proposes
NT16	МЗ	Yes	Municipal	Municipal	Camellia	Stewartia pseudocamellia 4	L	1	1	Fair	Fair		Moderate J	uvenile tree. Weedwacker damage.	Potential conflict with proposed sidewalk.
NT8	NT1 Yes	i	On-site	No	Pear	Pyrus spp.	26	3.1	5	Fair	Fair	Suitable	Moderate T	opped. Gravel parking adjacent. Withir	building footprint.
														Located between fence and storage	
NT9	NT2 Yes	i	On-site	No	Ash	Fraxinus spp.	~18,10	2.8	5	Fair	Fair-poor 0	Conditional	Good	shed. Topped, epicormic growth. With	nin building footprint.
														Located between storage shed and brick garage. Large seam up trunk,	
														likely from past failure, decaying.	
NT10	NT3 Yes		On-site	Yes	Ash	Fraxinus spp.	~35	3.5	7	Fair-poor P	oor	Unsuitable	Good	Lowest limb actively failing, has been shortened, will rest on garage roof. W	ithin building footprint
			0.1. 0.1.0		7.6.1	r iaxiiiao oppi		0.0		. a poor :		O.I.Guillania	0000	energing, nim reet en garage reen tr	ann zanang roopina
														Large deadwood/decay north	
							90							canopy. Pruning stubs and deadwood in primary stem, response	
NT11	NT4 Yes		On-site	Yes	Big-Leaf Maple	Acer	(below unions)	10.8	10	Fair-poor F	air poor Co	nditional	Moderate	growth lower stem. Large surface roots lifting surrounding asphalt. With	in building footprint
NI II	1114 163	'	OII-Site	163	Dig-Leai Wapie	macrophyllum	unions)	10.0	10	i ali-pool i	ан-роог со	ilulional	Woderate	North neighbouring property.	in ballang tootprint.
														Codominant stems, narrow	
NT2	OS1 Yes	S	Off-site	Yes	Big-Leaf Maple	Acer macrophyllum ~5	0.35	10.2	9	Fair	Fair		Moderate	attachments. Previous thinning. Located against fence.	Conflict with building footprint.
					3 1	1,	,							3	3 1
														North neighbouing property. Located	
NT3	OS2 Yes	3	Off-site	Yes	Ash	Fraxinus spp.	~30,15	4.5	7	Fair	Fair		Good	against fence. Previous thinning and raising. Epicormic growth.	Conflict with building footprint.
														North neighbouring property.	
				Yes (if estimate is										Located against fence. Previously topped, epicormic growth, heavy	
NT4	OS3 Yes	3	Off-site		Ash	Fraxinus spp.	~30	3	7	Fair	Fair		Good	seed crop.	Conflict with building footprint.
					Western Red										Potential conflict with building
NT5	OS4 Yes	3	Off-site	Yes	Cedar	Thuja plicata	~40	6	5	Good	Good		Poor	North neighbouring property.	footprint.
					Western Red										Potential conflict with building
NT6	OS5 Yes	5	Off-site	Yes	Cedar	Thuja plicata	~60	9	6	Good	Good		Poor	North neighbouring property.	footprint.
NT7	OS6 Yes	3	Off-site	No	English Oak Qu	ercus robur ~25		2.5	6	Good	Fair		Good	North neighbouring property.	
IT40	00		O" "		Maidenhair	a		_							
NT12	OS7 Yes	3	Off-site	No	Tree	Gingko biloba	~8	1	2	Good	Fair		Moderate V	est neighbouring property.	
														West neighbouring property. Codominant top. Canopy beginning	
JT12	000.14		Off cito	No	Maidenhair	Cingles I-:I-!	40	2.0	2	Cood	Eo:-		Moder	to encroach on driveway on subject	Possible clearance pruning for
NT13	OS8 Yes	i	Off-site	No	Tree	Gingko biloba	~18	2.2	3	Good	Fair		Moderate	property.	driveway access.
														West neighbouring property. Codominant top. Canopy beginning	
IT14	OS9 Yes		Off-site	No	Maidenhair Tree	Ginaka bilaha	~22	2.6	1	Good	Fair		Modorata	to encroach on driveway on subject	Possible clearance pruning for
1114	OS9 Yes	•	OII-SILE	INO	1166	Gingko biloba	22	2.6	4	Good	rall		Moderate	property.	driveway access.

1608 Camosun Street, Victoria BC V8T 3E6 Info@biophiliacollective.ca 250 590 1156

PROJECT NAME:

THE ABBEY

PROJECT ADDRESS:

1702 QUADRA STREET VICTORIA, BC

DESIGNED BY: BIANCA BODLEY DRAWN BY: KIM TANG

NO.	ISSUED FOR	YY\MM\DD
1	CIS PRESENTATION	12/07/2021
2	DEVELOPMENT PERMIT	12/22/2021
3	ADP MEETING	04/13/2022
4	REVISED AND RE-ISSUED FOR DP	2023/06/01
5		
6		


NORTH ARROW

DRAWING TITLE:

TREE REMOVAL & PROTECTION PLAN

DWG NO:

SCALE: 1:100

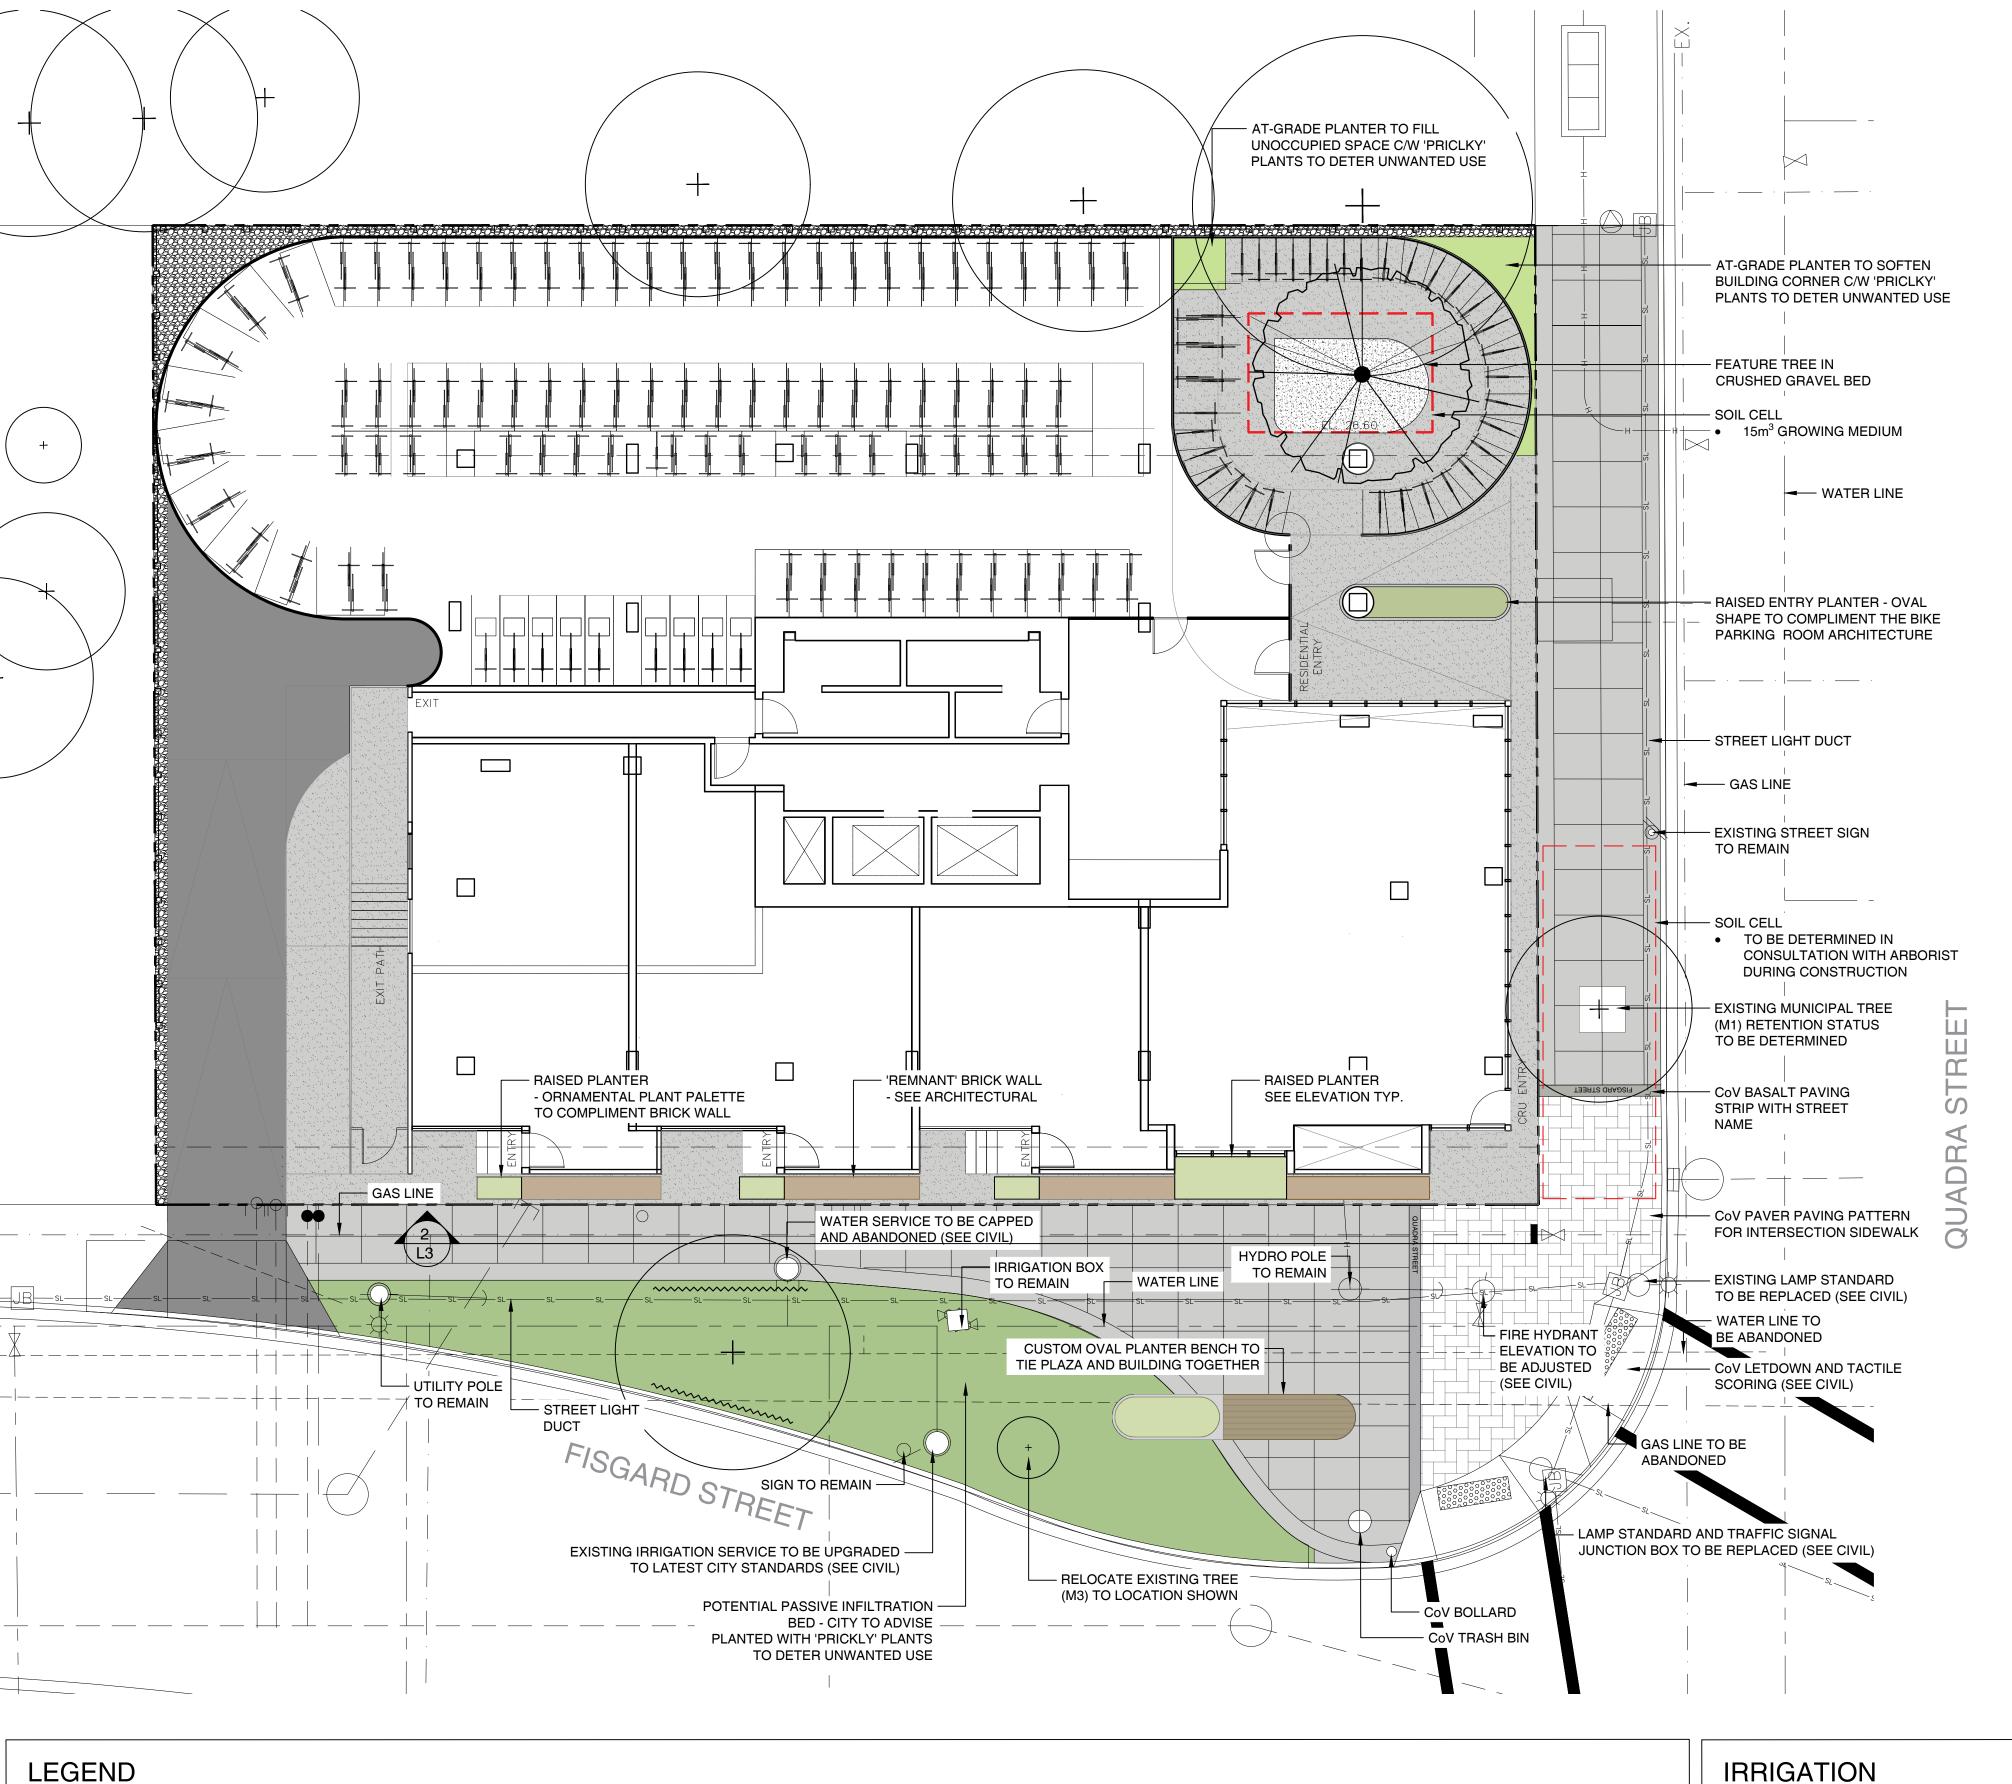

MUNICIPAL BOULEVARD PLANTER

MEDIUM (BCLS)

• 50 mm DEPTH MULCH

MUNICIPAL SIDEWALK

MUNICIPAL SIDEWALK

LIGHT BROOM FINISH

MUNICIPAL SIDEWALK

450 - 600 mm DEPTH 1L GROWING

TO CITY OF VICTORIA 'NEW TOWN'

TO CITY OF VICTORIA 'NEW TOWN'

DESIGN GUIDELINE STANDARDS

TO CITY OF VICTORIA 'NEW TOWN' DESIGN

BASALT PAVING STRIP WITH STREET NAME

ABBOTSFORD CONCRETE OR

SAW CUT JOINTING PATTERN

GUIDELINE STANDARDS

APPROVED EQUAL

DESIGN GUIDELINE STANDARDS

PROPERTY LINE

ON-SITE LANDSCAPE AREA

MEDIUM (BCLS)

RAISED PLANTER

50 mm DEPTH MULCH

450 - 600 mm DEPTH 1L GROWING

MIN. 400 mm DEPTH PLANTER

GROWING MEDIUM

GRAVEL MAINTENANCE STRIP

300mm DEPTH RIVER ROCK

300mm DEPTH WASHED CRUSHED

50 mm DEPTH MULCH

CRUSHED GRAVEL MULCH

GRAVEL

CONCRETE WALK

DRIVE AISLE

LIGHT SANDBLAST FINISH

CUSTOM METAL PLANTER

6' HT BLACK METAL PERIMETER

CUSTOM CONCRETE AND CEDAR BENCH PLANTER

FENCING

SAW CUT JOINTING PATTERN

IRRIGATION

MUNICIPAL LITTER RECEPTACLE,

TOWN' DESIGN GUIDELINE

TO CITY OF VICTORIA DESIGN

EXISTING BOULEVARD TREE

TO CITY OF VICTORIA 'NEW

BENCH AND BOLLARD

STANDARDS

STANDARDS

STRUCTURAL SOIL CELL

TO BE RETAINED

PROPOSED TREE

ROOT BARRIER

- ALL PLANTERS AND AT-GRADE LANDSCAPE AREAS TO BE
- IRRIGATED WITH AN AUTOMATIC IRRIGATION SYSTEM. DETAILED IRRIGATION PLAN TO BE SUBMITTED AT BUILDING
- PERMIT APPLICATION STAGE. ALL IRRIGATION DESIGNS AND INSTALLATIONS SHALL MEET THE MINIMUM STANDARDS OF THE IRRIGATION INDUSTRY ASSOCIATION OF B.C. (IIABC).

ASSEMBLY TEST REPORT.

- OFF-SITE (MUNICIPAL) MUNICIPAL BOULEVARD TO BE IRRIGATED BY A SEPARATE SYSTEM FROM A SEPARATE CITY SOURCE CONFORMING TO THE **CITY OF** VICTORIA SUPPLEMENTARY SPECIFICATIONS FOR STREET TREES AND IRRIGATION SCHEDULE C TO BYLAW 12-042, SUBDIVISION
- IRRIGATION DESIGN DRAWINGS MUST BE SENT TO PARKS FOR
- REVIEW 30 DAYS PRIOR TO INSTALLATION. DRAWINGS SHOULD INDICATE ALL COMPONENTS, MODELS AND
- MATERIALS FROM WATER SUPPLY TO IRRIGATION HEADS. THE CITY WILL REQUIRE 4 INSPECTIONS FOR IRRIGATION INSTALLATION: 1)SLEEVING, 2) OPEN TRENCH MAINLINE AND PRESSURE TEST, 3) OPEN TRENCH AND LATERAL LINE, 4) OPERATION AND COVERAGE, AND BACKFLOW PREVENTER

CITY OF VICTORIA DOWNTOWN REALM PLAN AND STREETSCAPE STANDARDS - NEW TOWN

NEW TOWN PAVING MATERIALS

Installation Method: Cast-in-place

Colour: Natural

Finish: Fine broom finish

Application: Sidewalk fill and frame






• Dimensions: 225mm x 75mm x 60

Installation Method: Mortar set

Application: Paving field


Colours: Natural grey

Finish: Unsealed

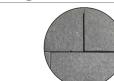





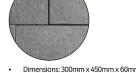

Installation Method: Mortar set

Application: Entry banding

Colour: Charcoal grey

Finish: Flamed

1608 Camosun Street, Victoria BC V8T 3E6 Info@biophiliacollective.ca 250 590 1156

PROJECT NAME:

THE ABBEY


PROJECT ADDRESS: 1702 QUADRA STREET VICTORIA, BC

DESIGNED BY: BIANCA BODLEY

DRAWN BY: KIM TANG



NEW TOWN PAVING APPLICATIONS

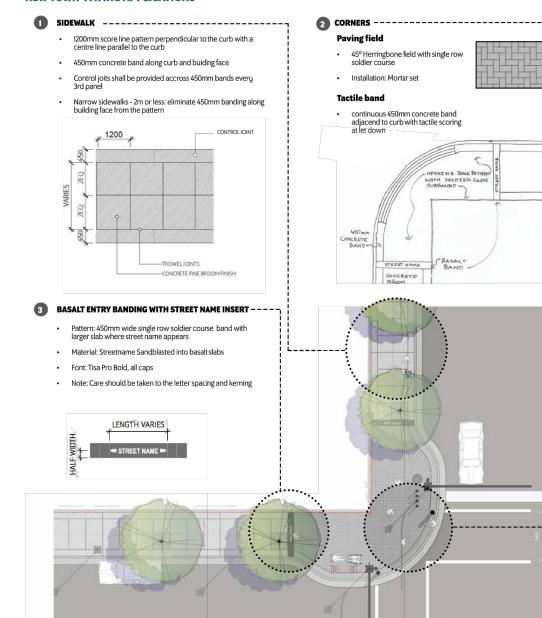



DOWNTOWN PUBLIC REALM PLAN STRATEGY + STREETSCAPE PLAN | 75

NEW TOWN PLANTING DETAILS

For all sidewalks in New Town area there are be two types of trees-in-sidewalk condition:

- Adaptation of existing tree locations to sidewalk improvements: Small modifications of proposed trowel joint pattern are recommended to best accommodate for existing tree locations. Detailed design and recommendations to be provided on a case-by-case basis for each improvement area.
- New development condition:
- A street tree spacing of between 8 10 metres is desired Tree grates should be set in a concrete band that runs across the sidewalk from curb to building face as illustrated on the diagram below with trowel joint defining the band always aligned with tree grates

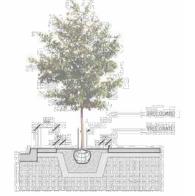

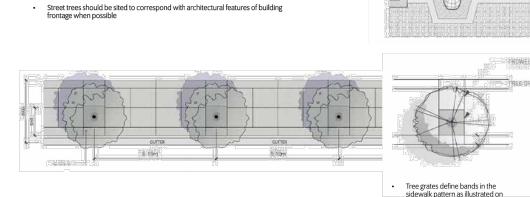


TRASH BINS **BIKE RACK**

Type B Bollard: Modern style Application: Corner bump outs and all other locations where vertical Multi-stream recycling receptacles separation is needed

Type A: Modern Metal Bin Application: All locations

> are to be used when appropriate on a case by case basis

Downtown Bike Rack Application: All locations

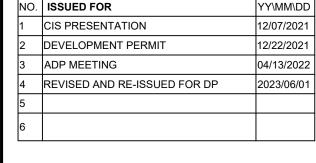

SEAL




DRAWING TITLE:

LANDSCAPE SITE PLAN

DWG NO: SCALE: 1:100



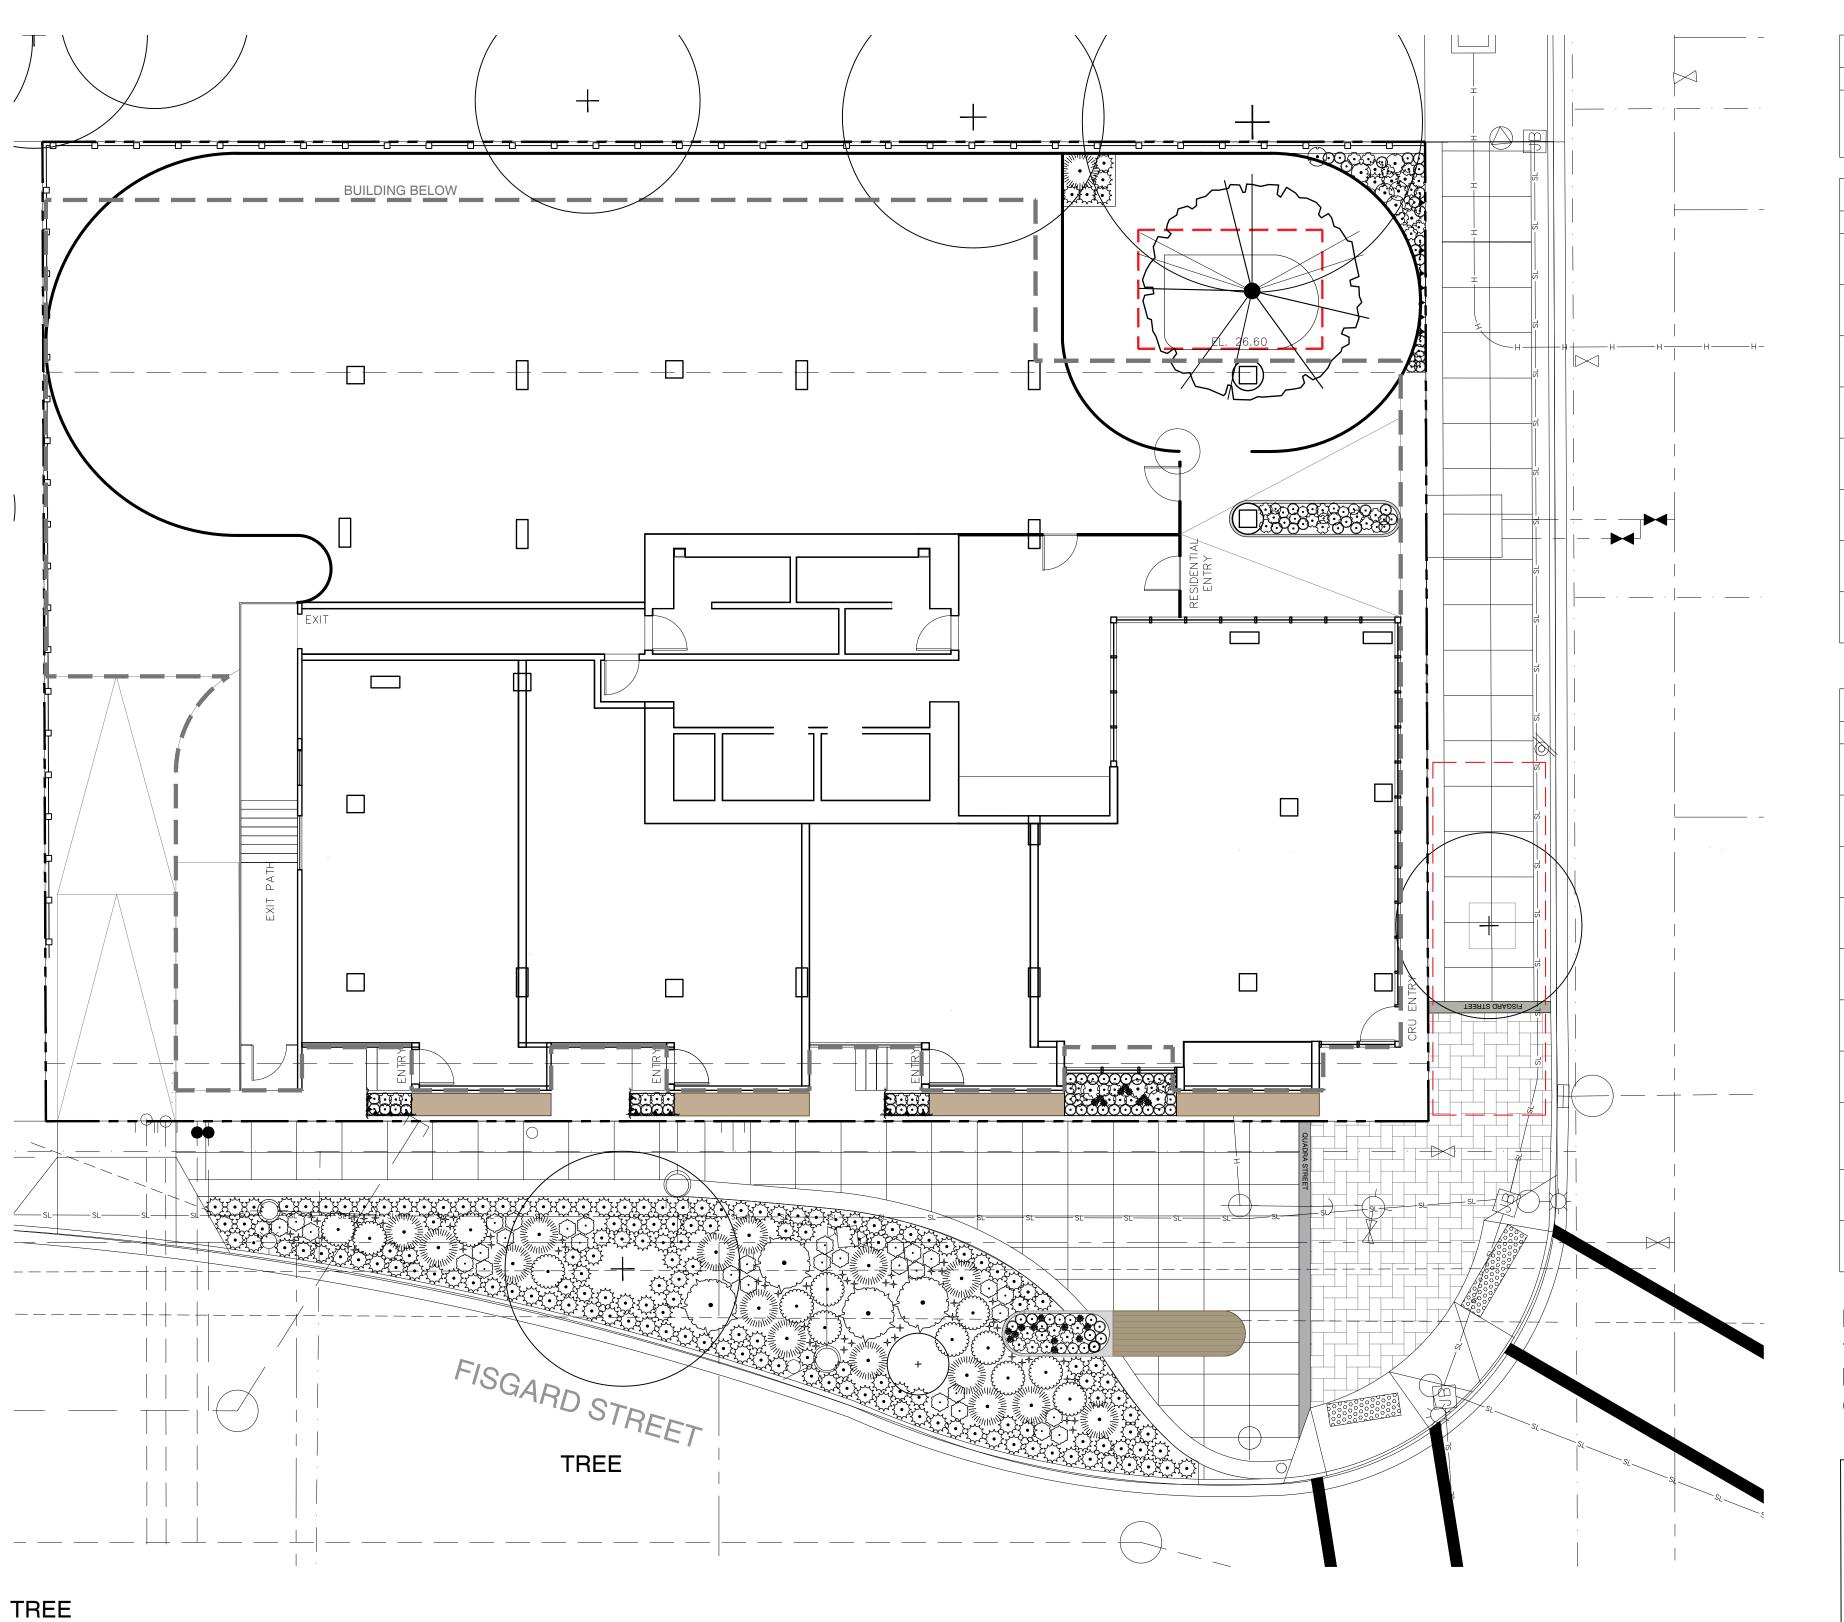

TREE SCHEDULE ON-SITE									
TREES	QTY	BOTANICAL NAME	COMMON NAME	CONT	CAL	REMARKS			
	1	GLEDITSIA TRIACANTHOS INERMIS	THORNLESS HONEY LOCUST	B@B	70 MM	MINIMUM BRANCH HEIGHT 1.2M			

SHRUBS	QTY	BOTANICAL NAME	COMMON NAME	CONT	SPACING	REMARKS
mfree	22	ARCTOSTAPHYLOS UVA-URSI 'MASSACHUSETTS'	MASSACHUSETTS KINNIKINNICK	#1 CONT	0.5m	POLLINATOR
0	69	CALLUNA VULGARIS 'FIREFLY'	FIREFLY HEATHER	#1 CONT	0.3m	POLLINATOR
①	41	CAREX TESTACEA 'PRAIRIE FIRE'	PRAIRIE FIRE ORANGE SEDGE	#1 CONT	0.35m	
*	9	ERIOPHYLLUM LANATUM	WOOLLY SUNFLOWER	#1 CONT	0.2m	NATIVE/POLLINATOR
\odot	10	HEBE X 'EMERALD GREEN'	EMERALD GREEN HEBE	#2 CONT	0.3m	POLLINATOR
₹ *	10	MAHONIA REPENS	CREEPING MAHONIA	#2 CONT	0.5m	POLLINATOR
	1	PINUS MUGO 'COMPACTA'	DWARF MUGO PINE	#3 CONT	1.0m	
.	9	STIPA ARUNDINACEA	NEW ZEALAND WIND GRASS	#2 CONT	0.5m	

HRUBS	QTY	BOTANICAL NAME	COMMON NAME	CONT	SPACING	REMARKS
0	10	CALLUNA VULGARIS 'FIREFLY'	FIREFLY HEATHER	#1 CONT	0.3m	POLLINATOR
♡	8	CAREX TESTACEA 'PRAIRIE FIRE'	PRAIRIE FIRE ORANGE SEDGE	#1 CONT	0.35m	
*	12	ERIOPHYLLUM LANATUM	WOOLLY SUNFLOWER	#1 CONT	0.2m	NATIVE/POLLINATOR
O	6	HEBE X 'EMERALD GREEN'	EMERALD GREEN HEBE	#2 CONT	0.3m	POLLINATOR
₹ .	153	MAHONIA REPENS	CREEPING MAHONIA	#2 CONT	0.5m	POLLINATOR
£	13	MISCANTHUS SINENSIS 'MORNING LIGHT'	MORNING LIGHT EULALIA GRASS	#3 CONT	0.9m	
	15	PINUS MUGO 'COMPACTA'	DWARF MUGO PINE	#3 CONT	1m	
	4	ROSA NUTKANA	NOOTKA ROSE	#2 CONT	1.5m	NATIVE/POLLINATOR
•	32	STIPA ARUNDINACEA	NEW ZEALAND WIND GRASS	#2 CONT	0.5m	
*	60	VERBENA BONARIENSIS	TALL VERBENA	#1 CONT	0.2m	POLLINATOR

NOTES:

1. PLANTS IN PLANT LISTS ARE SPECIFIED ACCORDING TO THE CANADIAN NURSERY LANDSCAPE ASSOCIATION CANADIAN STANDARDS FOR NURSERY STOCK AND SECTION 12, CONTAINER GROWN PLANTS FROM THE BC LANDSCAPE STANDARD, CURRENT EDITION.

PLANT RATIOS - ON SITE

- NATIVE PLANTS

 % BY QUANTITY = 4%


 % BY AREA = 2%
- **POLLINATOR PLANTS** % BY QUANTITY = 76%% BY AREA = 76%

PLANT RATIOS - OFF SITE

- NATIVE PLANTS

 % BY QUANTITY = 3%

 % BY AREA = 1%
- POLLINATOR PLANTS % BY QUANTITY = 65%% BY AREA = 57%

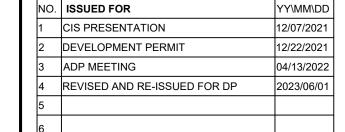

1608 Camosun Street, Victoria BC V8T 3E6 Info@biophiliacollective.ca 250 590 1156

1702 QUADRA STREET

PROJECT NAME:

THE ABBEY

PROJECT ADDRESS:

VICTORIA, BC

DESIGNED BY: BIANCA BODLEY DRAWN BY: KIM TANG

SEAL

NORTH ARROW


DRAWING TITLE:

PLANTING PLAN

DWG NO:

SCALE: 1:100

GLEDITSIA TRIACANTHOS

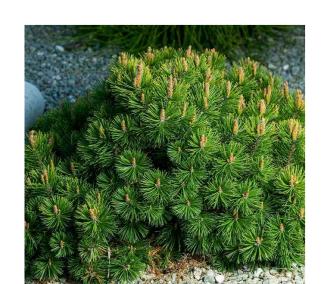

DWARF MUGO PINE













			392 St
	57.35	100	-
	Jo (Y	77	1
			WALLSON TO
3 5		N. T.	ed (S
			DITE H
			The second

SHRUBS + PERENNIALS

FIREFLY HEATHER

PRAIRIE FIRE SEDGE

EMERALD GREEN HEBE


CREEPING MAHONIA

NEW ZEALAND GRASS

MISCANTHUS

VERBENA

WOOLLY SUNFLOWER

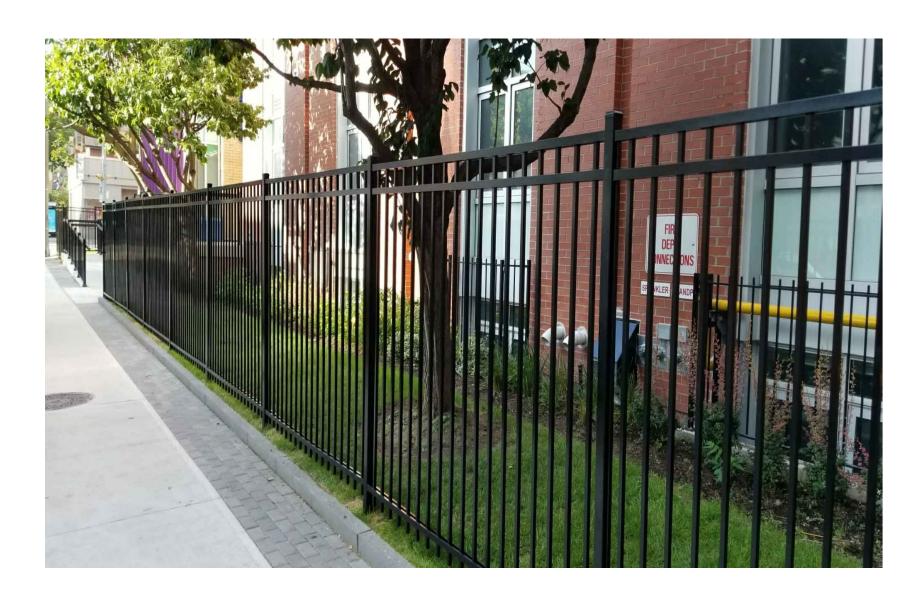





2 SOUTH ELEVATION PLANTERS - ELEVATION L3 1:100



1608 Camosun Street, Victoria BC V8T 3E6 Info@biophiliacollective.ca 250 590 1156

PROJECT NAME:

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PROJECT ADDRESS:

1702 QUADRA STREET VICTORIA, BC

DESIGNED BY: BIANCA BODLEY DRAWN BY: KIM TANG

NO. ISSUED FOR YY\MM\DD 1 CIS PRESENTATION 12/07/2021 2 DEVELOPMENT PERMIT 12/22/2021 3 ADP MEETING 04/13/2022 4 REVISED AND RE-ISSUED FOR DP 2023/06/01 5 6			
2 DEVELOPMENT PERMIT 12/22/2021 3 ADP MEETING 04/13/2022 4 REVISED AND RE-ISSUED FOR DP 2023/06/01 5	NO.	ISSUED FOR	YY\MM\DD
3 ADP MEETING 04/13/2022 4 REVISED AND RE-ISSUED FOR DP 2023/06/01 5	1	CIS PRESENTATION	12/07/2021
4 REVISED AND RE-ISSUED FOR DP 2023/06/01	2	DEVELOPMENT PERMIT	12/22/2021
5	3	ADP MEETING	04/13/2022
	4	REVISED AND RE-ISSUED FOR DP	2023/06/01
6	5		
	6		

NORTH ARROW

DRAWING TITLE:

SITE FURNITURE + PLANTER ELEVATION

DWG NO: