

822 CATHERINE STREET + 304 LANGFORD STREET

VICTORIA, BC


14.07.2023

ISSUED FOR DEVELOPMENT PERMIT

ARYZE DEVELOPMENT
1839 Fairfield Road
Victoria, BC, V8S 1G9
P: 250.940.3568





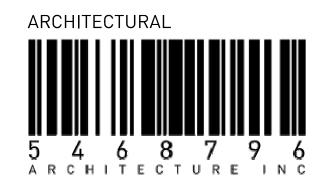

5468796 ARCHITECTURE INC. 266 McDermot Ave Winnipeg, MB. R3B 0S8 P: 204.480.8421 F: 204.480.8876

Colin Neufeld | Principal Architect E: colin@5468796.ca

Pablo Batista | Architect E: pablo@5468796.ca

COVER SHEET GENERAL NOTES AG.2 SHADOW STUDIES AG.3 SITE SURVEY AG.4 SITE PLAN - CONTEXT AG.5 BUILDING ELEVATION - CONTEXT AG.6 WINDOW SCHEDULE AG.7 MATERIAL BOARD

AG.8 AVERAGE GRADE CALCULATION

SITE PLAN - EXISTING + DEMOLITION A1.0 SITE PLAN - PROPOSED A1.1 LEVEL 00 PLAN

LEVEL 01 PLAN

LEVEL 02 PLAN

BUILDING ELEVATIONS A2.2 BUILDING ELEVATIONS

A1.2

A1.3

A3.1 **BUILDING SECTIONS** A3.2 **BUILDING SECTIONS**

ARYZE DEVELOPMENT 1839 Fairfield Road Victoria, BC, V8S 1G9 P.250.940.3568

Liv McMahon E: liv@aryze.ca

Chris Quigley E: chris@aryze.ca



MCELHANNEY Suite 500 - 3960 Quadra Street Victoria, BC, V8X 4A3 P.778.746.7417

NATHAN DUNLOP E: ndunlop@mcelhanney.com

21-014-CSP PRELIMINARY CIVIL PLAN

LANDSCAPE

BIOPHILIA 1608 Camosun Street Victoria, BC, V8T 3E6 P.250.590.1156

ELIZABETH BALDERSTON E: elizabeth@biophiliacollective.ca

TREE REMOVAL AND PROTECTION PLAN LANDSCAPE PLAN TREE PLANTING PLAN SHRUB PLANTING PLAN

SYMBOL LEGEND:


WALL TYPE WINDOW TYPE DOOR NUMBERS EXISTING DOOR NEW DOOR F-1 FINIISH TYPE

FLOOR TYPE LABEL


LABEL **ROOF TYPE**

NOTES GRIDLINE MARKER


BUILDING SECTIONS:

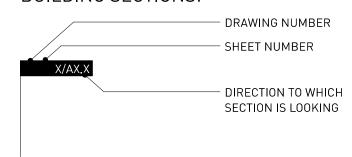


SECTIONS:

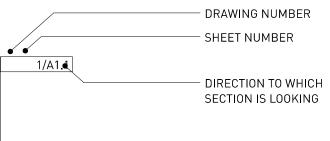

DETAILS:

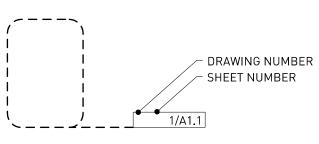



ROOM LABELS:

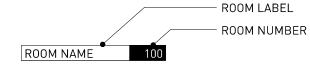


INTERIOR ELEVATIONS: - DRAWING NUMBER SHEET NUMBER

FLOOR CONSTRUCTION ELEVATIONS:

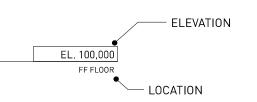

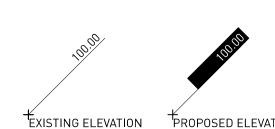

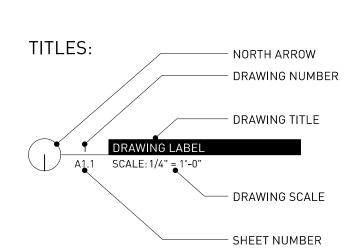

ABBREVIATIONS:

BV	ABOVE	SH	SHEET FLOORING
FF	ABOVE FINISHED FLOOR	SIM	SIMILAR
LUM	ALUMINUM	SPC'D	SPECIFIED
NOD	ANODIZED	SQ	SQUARE
I	AT	ST	STEEL
RCH	ARCHITECTURAL	STD	STANDARD
Т	ACOUSTIC TILE	STN	STAIN FINISH
VB	AIR/VAPOUR BARRIER	STRUCT	STRUCTURAL
		SUSP	SUSPENDED
LDG	BUILDING		
LKG	BLOCKING	TEMP	TEMPERED
RG	BEARING	TG	TEMPERED GLASS
S	BOTH SIDES	TO	TOP OF
TO B	BACK TO BACK	TYP	TYPICAL
В	CATCH BASIN	U/N	UNLESS OTHERWISE NOTED
F	CLEAR FINISH	U/S	UNDERSIDE
G	CORNER GUARD		
J	CONTROL JOINT	V	VARNISHED FINISH
L	CENTRE LINE	VERT	VERTICAL
LG	CEILING		
LR	CLEAR	W	WIDE, WIDTH
OL	COLUMN	W/	WITH
ONC	CONCRETE	W/D	WASHER/DRYER
ONN	CONNECTION	WD	WOOD
ONT	CONTINUOUS	WHC	WOOD HOLLOW CORE
ORR	CORRIDOR	WSC	WOOD SOLID CORE
T	CERAMIC TILE		
/W	COMPLETE WITH		

DRAWING DETAIL ELEVATION

DN

DRWG

ELEC

EXT

GCB

НМІ

HORIZ

HSDG

HSS

HSTG

HVAC

INSUL

MAX

MDF

MIN

MISC

N0

NOM

NTS

OPN'G

OPP OTA

OTB

PLAM

PLBG

PREF

RD

REINF

REQ'D

REV

MECH

DIAMETER

DIMENSION

DOWN

EACH WAY EACH ELECTRICAL EQUAL EXISTING **EXPANSION JOINT** EXTERIOR FOUNDATION FIRE EXTINGUISHER

FLOOR EXPANSION JOINT FINISHED FLOOR DRAIN **FUNNEL DRAIN** FINISHED FACE FLEXIBLE FACE OF FRIDGE FIRE RESISTANCE RATING

GAUGE

GYPSUM WALL BOARD GYPSUM CEILING BOARD GENERAL CONTRACTOR GLASS **HOLLOW METAL** HOLLOW METAL INSULATED

HORIZONTAL HERMETICALLY SEALED DOUBLE GLAZING HOLLOW STEEL SECTION HERMETICALLY SEALED TRIPLE GLAZING HEATING, VENTILATING, AIR CONDITIONING

INSIDE DIAMETER INSIDE FACE INSULATION INTERIOR

LENGTH METRE MILLIMETRE MOUNT MATERIAL MAXIMUM

MEDIUM DENSITY FIBREBOARD MECHANICAL METAL MINIMUM MISCELLANEOUS MINUTE

NOT IN CONTRACT NUMBER NOMINAL NOT TO SCALE

MASONRY OPENING

ON CENTRE OUTSIDE DIAMETER OPENING OVERHEAD OPPOSITE OPEN TO ABOVE OPEN TO BELOW OVEN

PLASTIC LAMINATE

PLUMBING PAIR PREFINISHED PRESSED STEEL PRESSURE TREATED PAINTED FINISH PROPERTY LINE

RADIUS **ROOF DRAIN** REINFORCED REQUIRED REVISION, REVISED, REVERSED ROUGH OPENING

PROJECT STATS

SITE INFORMATION

LEGAL DESCRIPTION	LOT C, (DD 3386541), BLOCK N, SEC	ΓΙΟΝ 31, ESQUIMALT DISTRICT, PLAN	549
CIVIC ADDRESS	822 CATHERINE STREET, VICTORIA E	3C	
ZONING	CURRENT [R-2, TWO FAMILY DWELLING]	PROPOSED [CR-3C, COMMERCIAL RESIDENTIAL [CATHERINE ST]]	822 CATHERINE 304 LANGFORD PROJECT STATS
SITE AREA [m²]			1,002.9
GROSS FLOOR AREA [m²]			1,810.23
FLOOR SPACE RATIO	0.5	1.00	1.80
SITE COVERAGE (%)			72.8%
OPEN SITE SPACE (%)			27.2%
AVERAGE GRADE			28.51
BUILDING HEIGHT	TWO-FAMILY DWELLING: 7.6m; 2 STOREYS IF DWELLING DOES NOT HAVE BASEMENT. 1.5 IF IT DOES PUBLIC BUILDING: [non-commercial]: 11m OR THE WIDTH OF THE LOT [WHICHEVER IS LESSER] AND 2.5 STOREYS	10.7m or 3 STOREYS	3 STOREYS [±12.17m]
SETBACKS			
FRONT	7.5m	3.0m [FIRST STOREY]; 6.0m [UPPER STOREYS]	2.77 m AT GROUND FLOOR 0.0m AT 2ND AND 3RD FLOOR
SIDE	1.5m OR 10% OF LOT DEPTH [WHICHEVER IS GREATER]	ADJACENT TO RESIDENTIAL: 1/4 BUILDING HEIGHT OR 2.5m [WHICHEVER IS GREATER]. ADJACENT TO NON-RESIDENTIAL: 2.4m OR GREATER, OR ZERO.	N/A
COMBINED SIDE YARD	4.5m	N/A	N/A
SIDE YARD, CORNER LOT [FLANKING ST]	3.5m OR 10% OF LOT WIDTH [WHICHEVER IS GREATER]	N/A	3.1m [AT LANGFORD ST], 3.9m [AT BELLA ST]
REAR	10.7m OR 35% OF LOT DEPTH [WHICHEVER IS GREATER]	6.0m	2.4m AT GROUND

BUILDING DATA			
UNIT TYPES	AREA (M²)	UNIT COUNT	TOTAL AREA (M²)
COMMERCIAL UNIT	85	1	85
BACHELOR			
	37	1	37
	38	1	38
1 BEDROOM UNIT			
	42	5	210
	45	4	180
	53	6	318
2 BEDROOM UNIT			
	70	1	70
	74	4	296
3 BEDROOM UNIT			
	82	5	410
TOTAL		28	
TOTAL RENTABLE AREA			1 644

	,	
RESIDENTIAL UNIT MIX	UNIT COUNT	%
BACHELOR	2	7%
1 BEDROOM UNIT	15	56%
2 BEDROOM UNIT	5	19%
3 BEDROOM UNIT	5	19%
TOTAL	27	100%

SITE DATA		
	AREA [m²]	AREA [sq ft]
LEVEL 00	0	0
LEVEL 01	550.05	5,921
LEVEL 02	624.3	6,720
LEVEL 03	624.3	6,720
LEVEL 04	11.58	125
TOTAL GROSS FLOOR AREA	1,810.23	19,485
BUILDING FOOTPRINT	729.75	7,855

TOTAL PROPOSED

	UNIT COUNT	RATE	REQUIRED STALLS
RESIDENTIAL			
UNIT < 45 M ²	7	0.2 STALLS / UNIT	1
UNIT 45-70 M ²	11	0.5 STALLS / UNIT	5.5
UNIT > 70 M ²	9	0.75 STALLS / UNIT	7
VISITOR	27	0.1 STALLS / UNIT	3
COMMERCIAL			
RESTAURANT	85 m²	1.0 STALLS / 20m ²	4
TOTAL REQUIRED			21

12

	UNIT COUNT	RATE	REQUIRED STALLS
LONG TERM			
UNIT < 45 M ²	7	1.0 STALLS / UNIT	7
UNIT => 45 M ²	20	1.25 STALLS / UNIT	25
RESTAURANT	85 m²	1.0 STALLS / 400m ²	1
TOTAL REQUIRED			33

	LLS / UNIT	2.7
	LLS / UNIT	2.7
		=
2 1.0 STALI	LLS / 100m ²	1
		4

1 ISSUED FOR DP

Drawn By: Checked By: Printing Date:

CN / PB 14.07.2023

14.07.2023

and levels prior to commencement of work. All errors and omissions to be reported to the

The Contractor shall verify all dimensions, datums


Architect before proceeding. This drawing must not be scaled.


This drawing is the property of the Architect; the

copyright in same being reserved to him/her. It is

Any unauthorized alteration of the electronic data which constitute this document will void all responsibility for the altered document by the Architect.

This drawing is not to be used for building purposes until countersigned by:

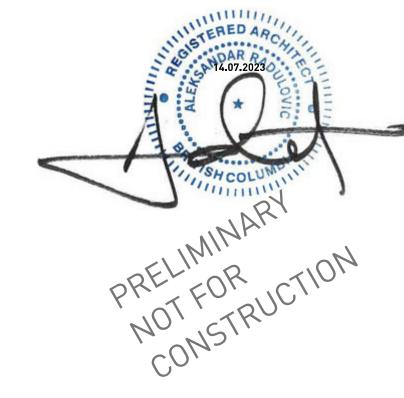

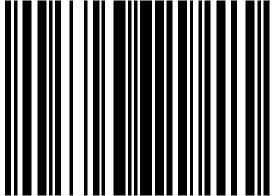

266 MCDERMOT AVE Winnipeg MB R3B 0S8 P: 204.480.8421 F: 204.480.8876

822 CATHERINE STREET + 304 LANGFORD STREET

GENERAL NOTES

Sheet AG.0

Project

VICTORIA, BC



VIEW OF CRU FROM CATHERINE STREET SIDEWALK





VIEW FROM LANGFORD STREET @ MARY STREET



VIEW FROM CATHERINE STREET

: CN / PB te: 14.07.2023

14.07.2023

The Contractor shall verify all dimensions, datums and levels prior to commencement of work.

All errors and omissions to be reported to the Architect before proceeding.


This drawing must not be scaled.

This drawing is the property of the Architect; the copyright in same being reserved to him/her. It is not to be reproduced without his/her permission.

Any unauthorized alteration of the electronic data which constitute this document will void all responsibility for the altered document by the Architect.

This drawing is not to be used for building purposes until countersigned by:



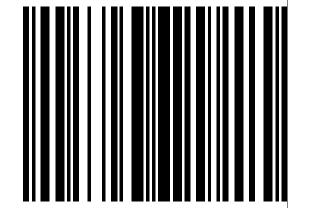


ARCHITECTURE INC 266 MCDERMOT AVE Winnipeg MB R3B 0S8 P: 204.480.8421 F: 204.480.8876

822 CATHERINE STREET + 304 LANGFORD STREET


VICTORIA, BC


RENDERINGS

Sheet AG.1

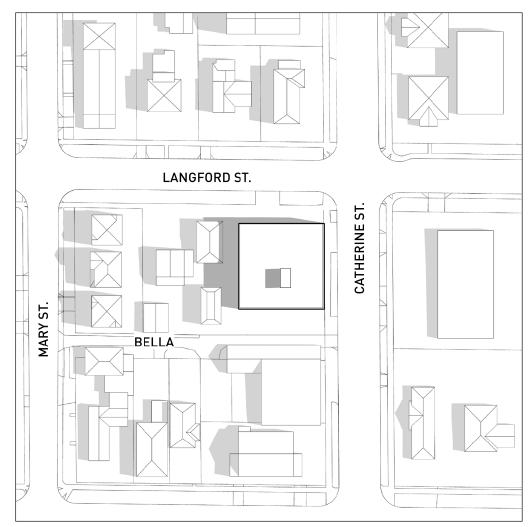


JUNE 21 9:00 AM

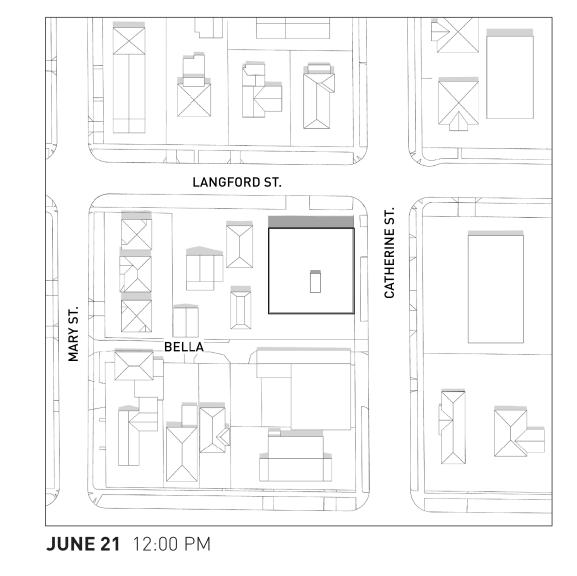


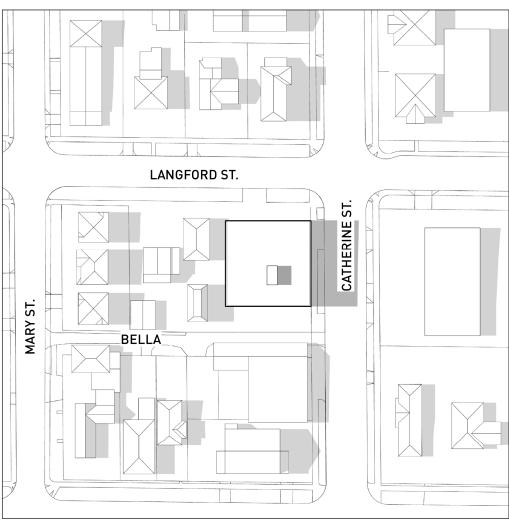


JUNE 21 4:00 PM

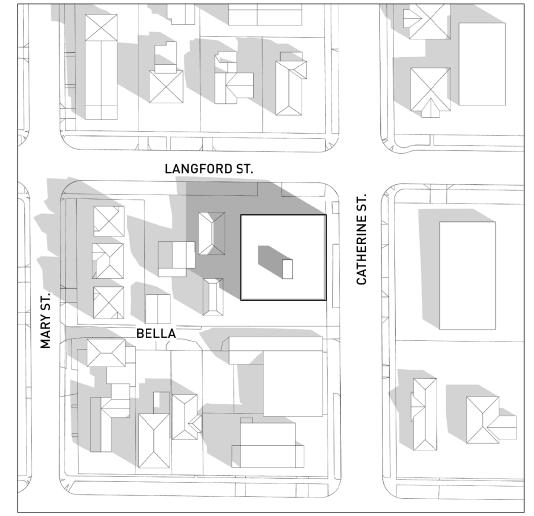


MARCH 20/SEPTEMBER 22 9:00 AM

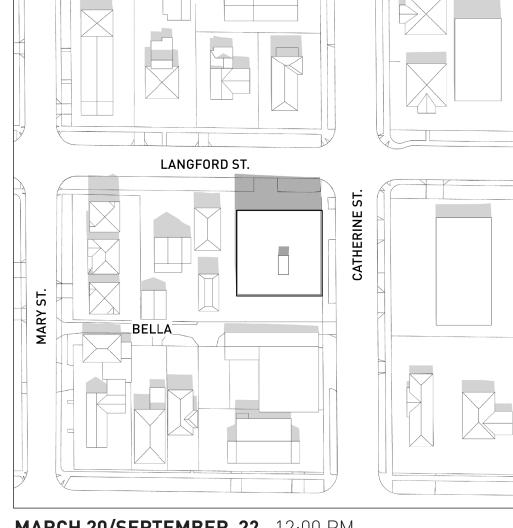


MARCH 20/SEPTEMBER 22 12:00 PM

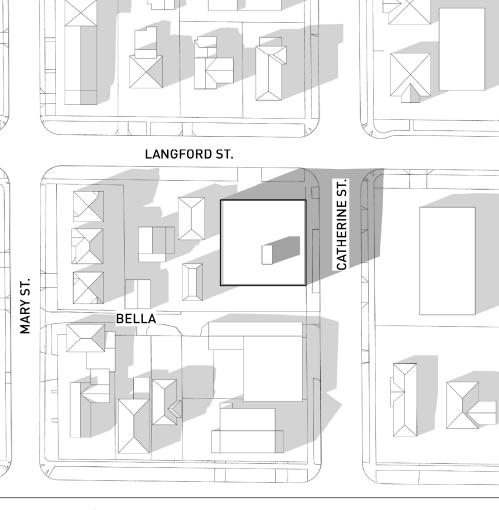

MARCH 20/SEPTEMBER 22 4:00 PM

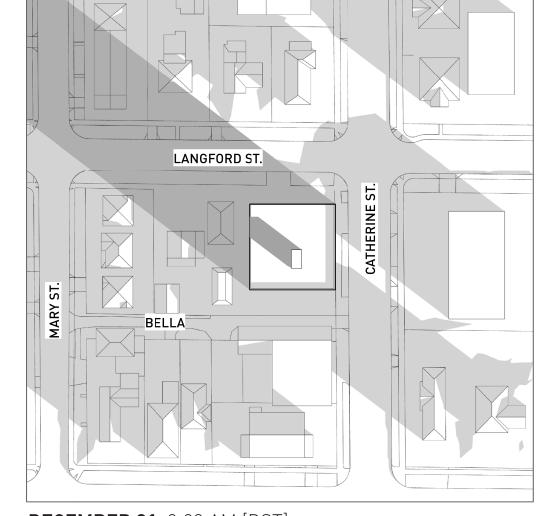


DECEMBER 21 8:00 AM [DST]

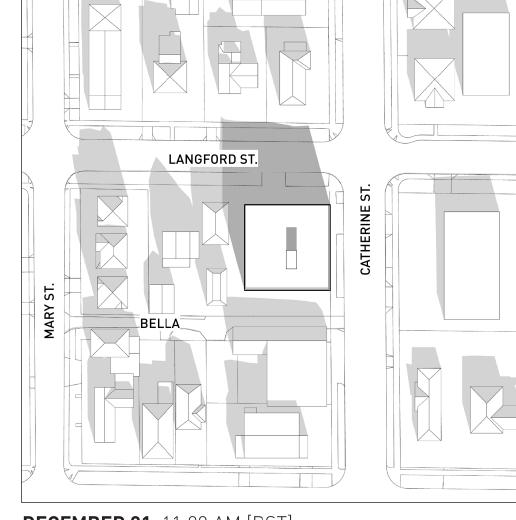

DECEMBER 21 11:00 AM [DST]



DECEMBER 21 3:00 PM [DST]

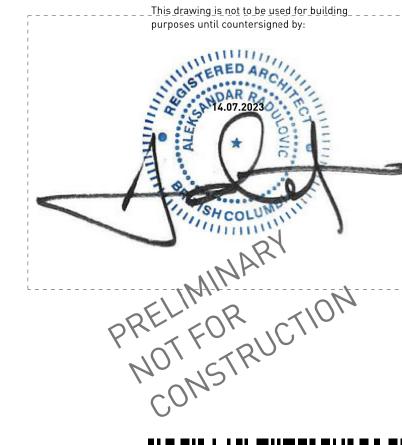

The Contractor shall verify all dimensions, datums and levels prior to commencement of work.

This drawing is the property of the Architect; the copyright in same being reserved to him/her. It is


Any unauthorized alteration of the electronic data which constitute this document will void all responsibility for the altered document by the

All errors and omissions to be reported to the Architect before proceeding.

This drawing must not be scaled.

Drawn By: Checked By: Printing Date: 14.07.2023

MK CN / PB 14.07.2023

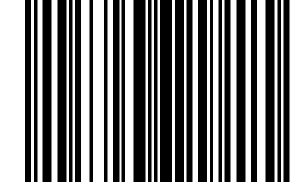


5 4 6 8 7 9 6 A R C H I T E C T U R E I N C 266 MCDERMOT AVE Winnipeg MB R3B 0S8 P: 204.480.8421 F: 204.480.8876

822 CATHERINE STREET + 304 LANGFORD STREET

SHADOW STUDIES

0646 Sheet

VICTORIA, BC

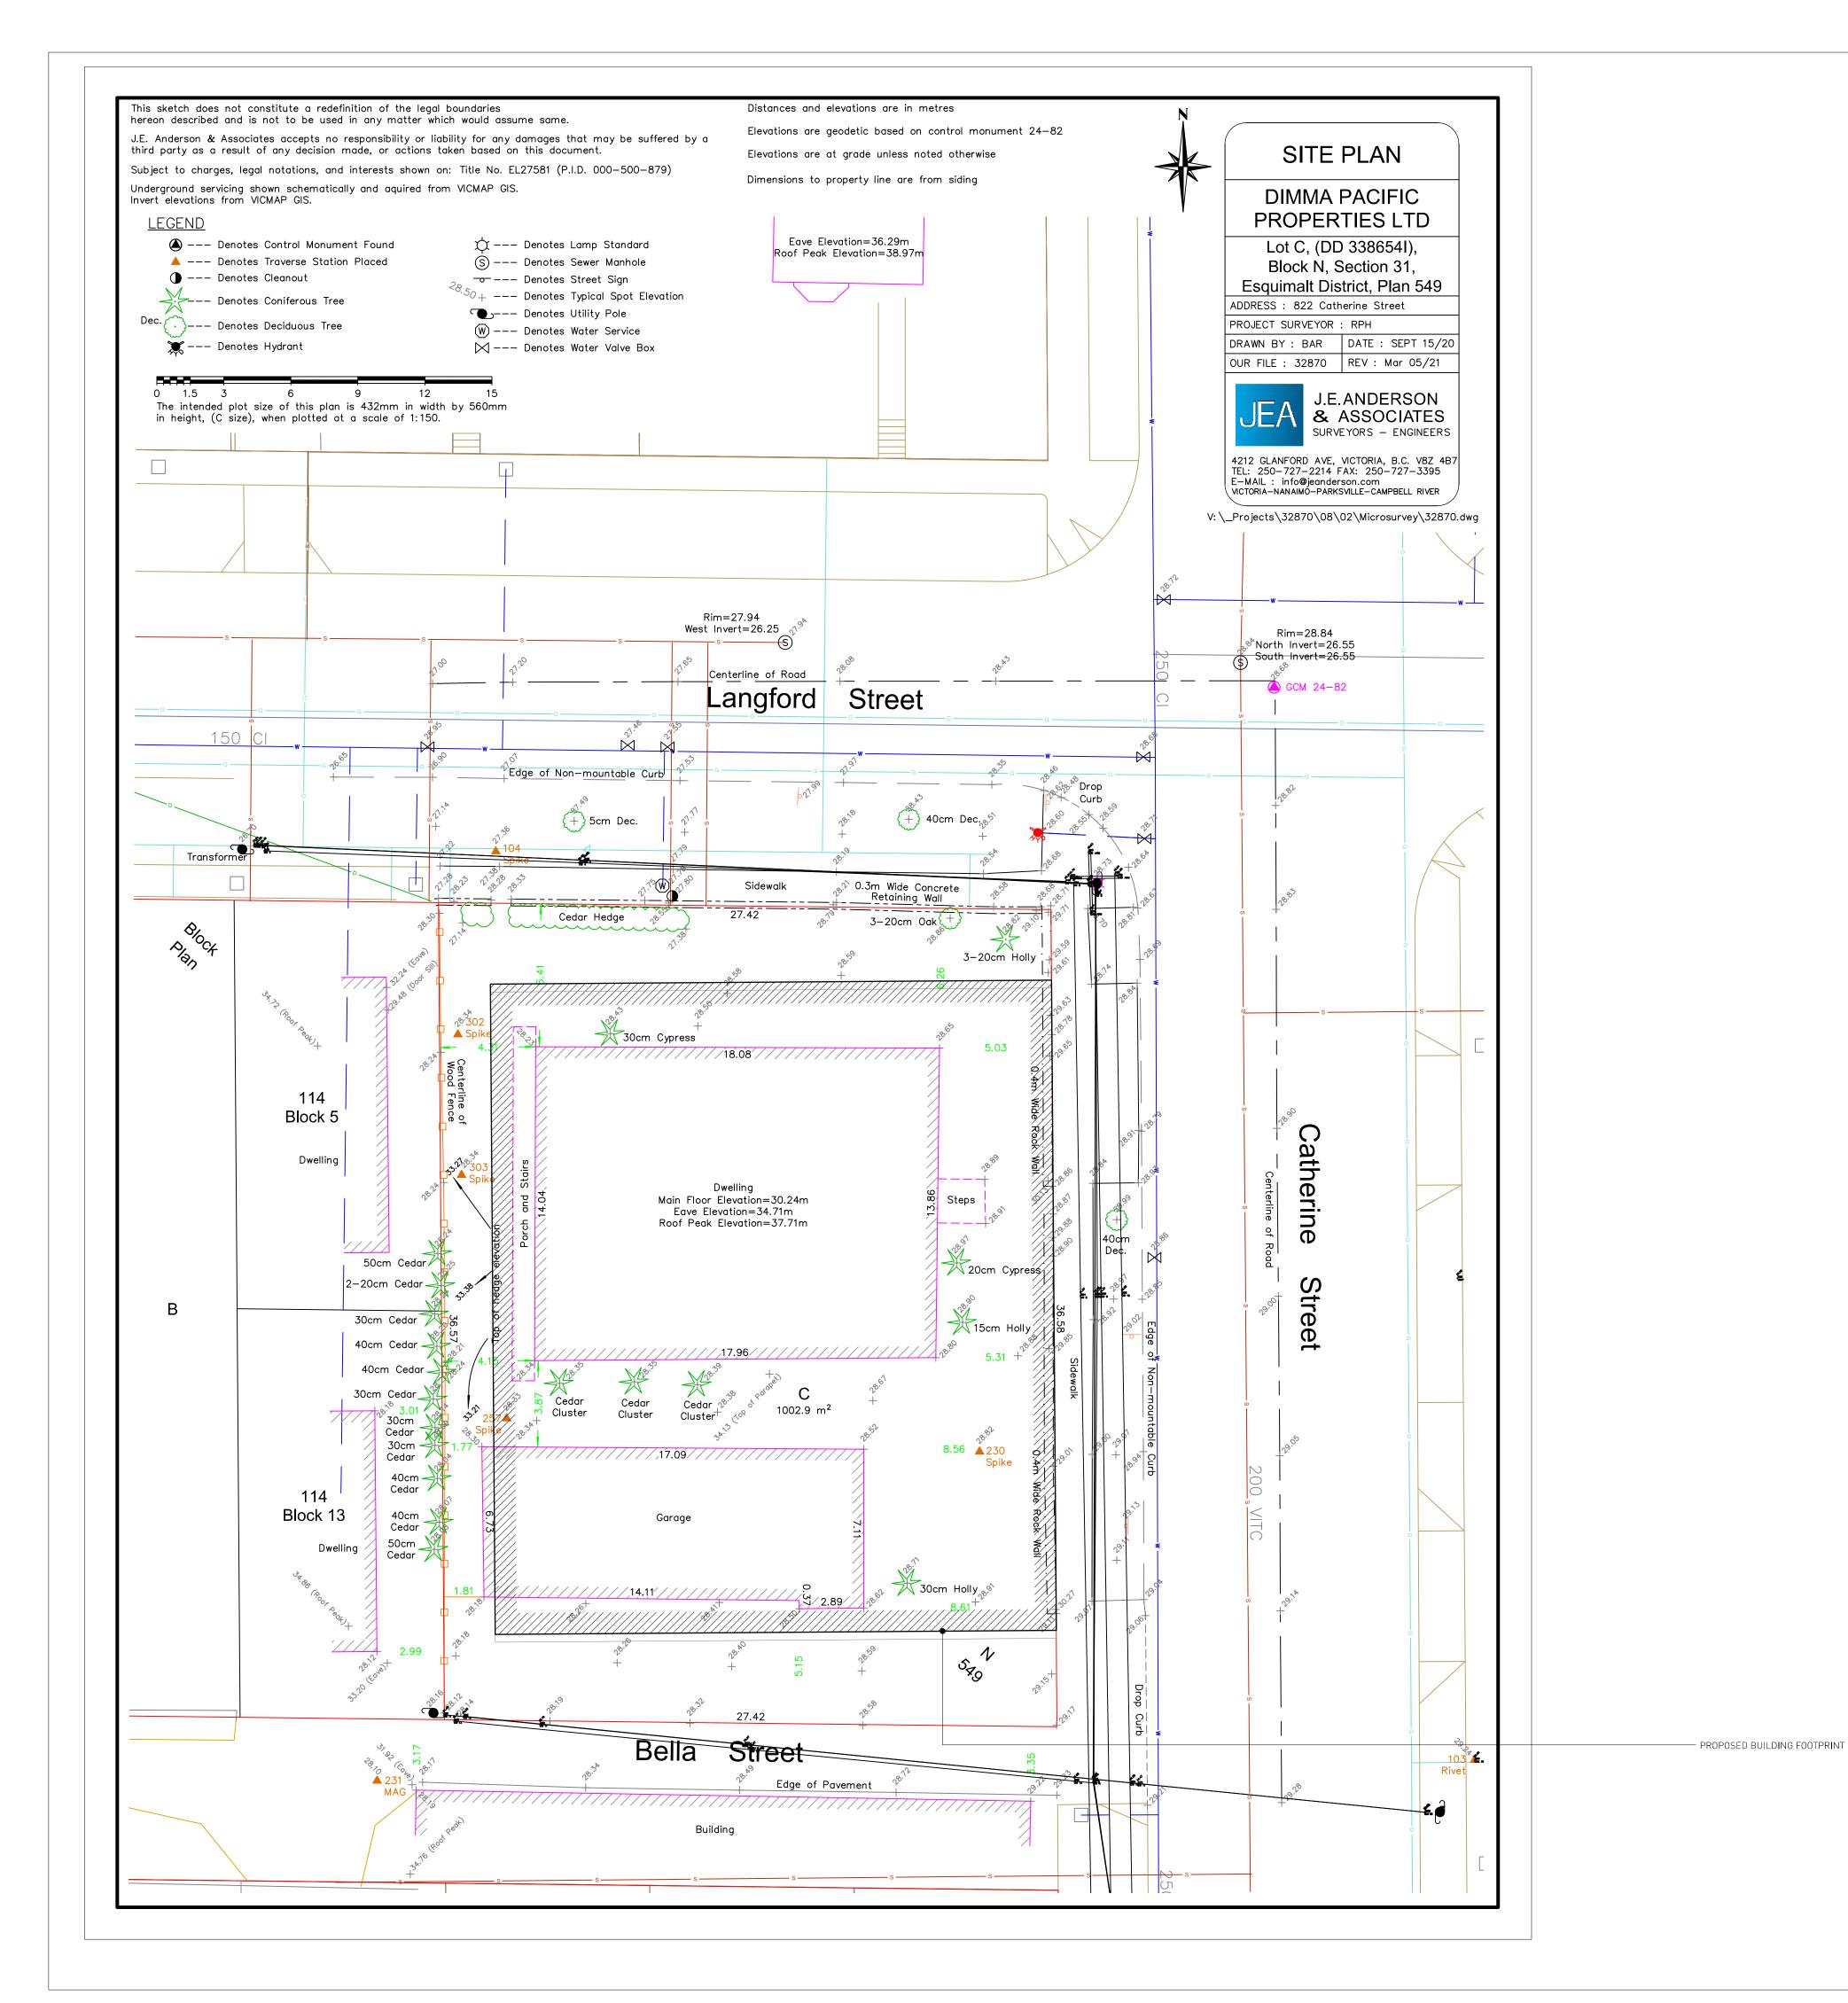

Drawn By: Checked By:

CN / PB 14.07.2023 Printing Date:

14.07.2023

The Contractor shall verify all dimensions, datums and levels prior to commencement of work.


All errors and omissions to be reported to the Architect before proceeding.

This drawing must not be scaled.

This drawing is the property of the Architect; the copyright in same being reserved to him/her. It is

Any unauthorized alteration of the electronic data which constitute this document will void all responsibility for the altered document by the Architect.

This drawing is not to be used for building purposes until countersigned by:

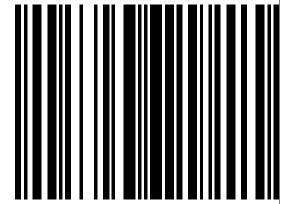



266 MCDERMOT AVE Winnipeg MB R3B 0S8 P: 204.480.8421 F: 204.480.8876

822 CATHERINE STREET + 304 LANGFORD STREET


VICTORIA, BC


SITE SURVEY Project Sheet

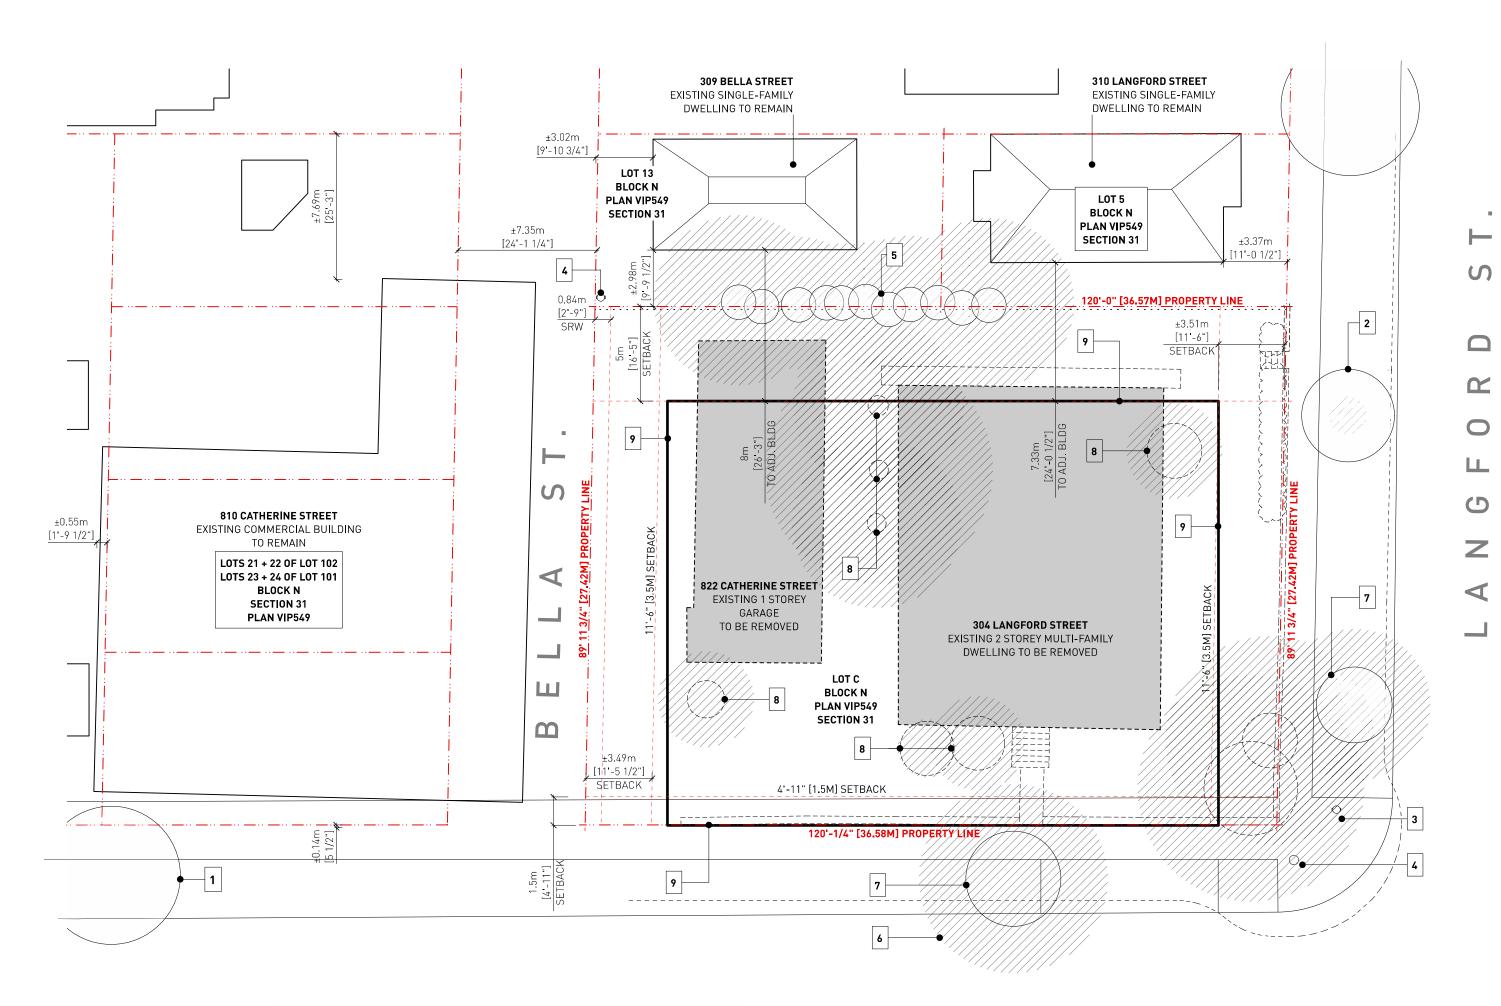

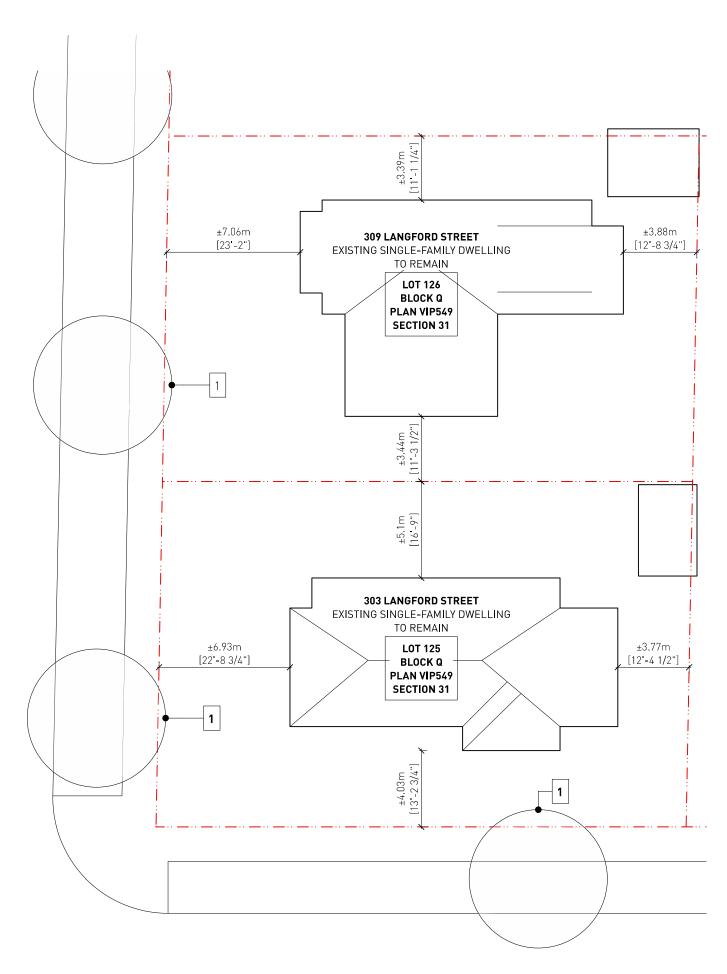

CATHERINE ST.

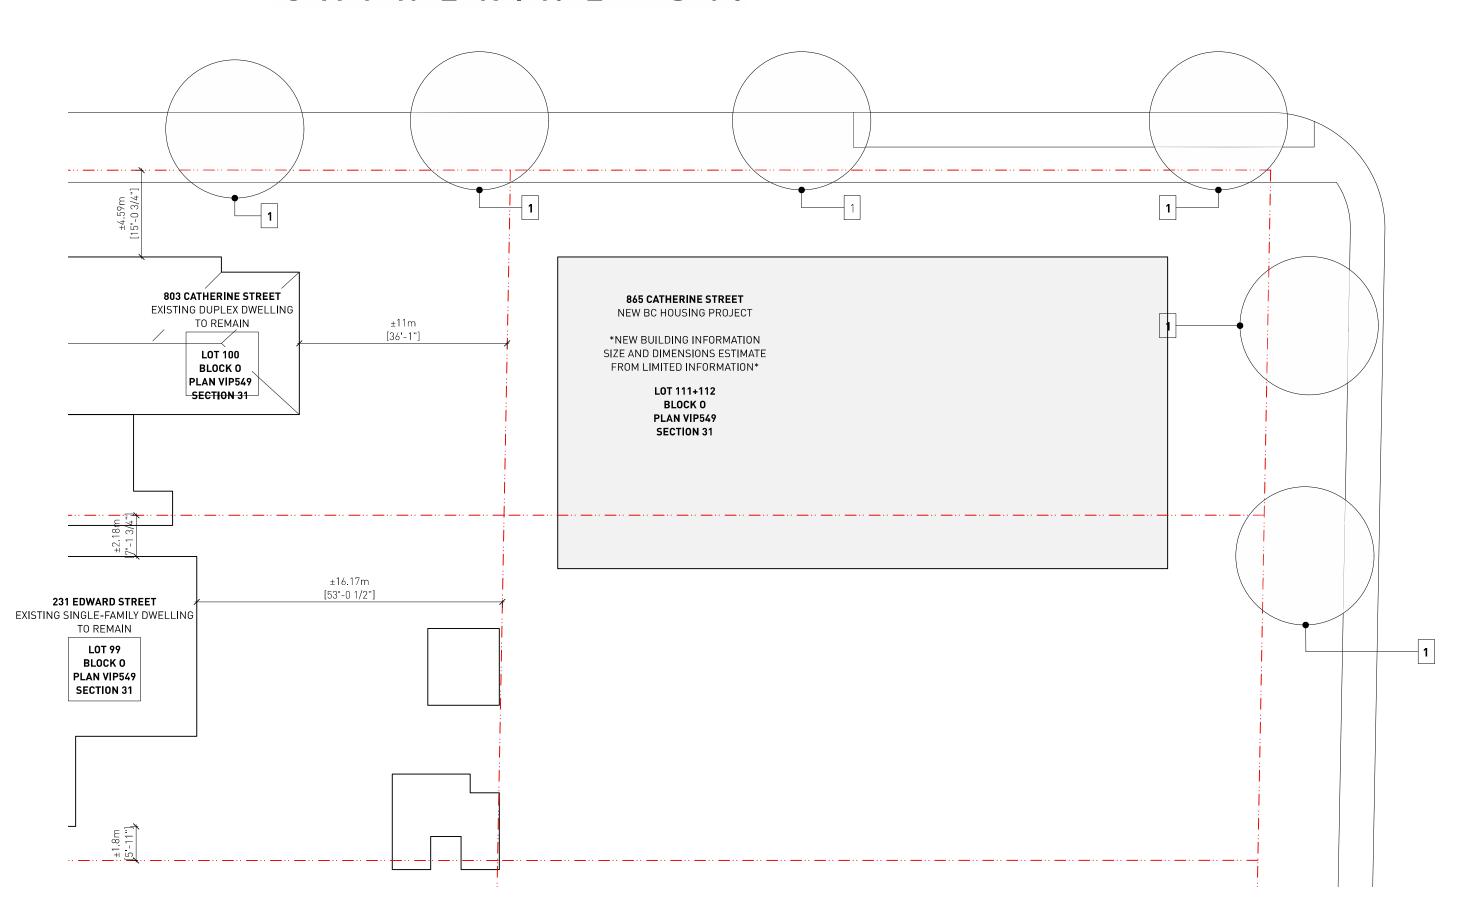


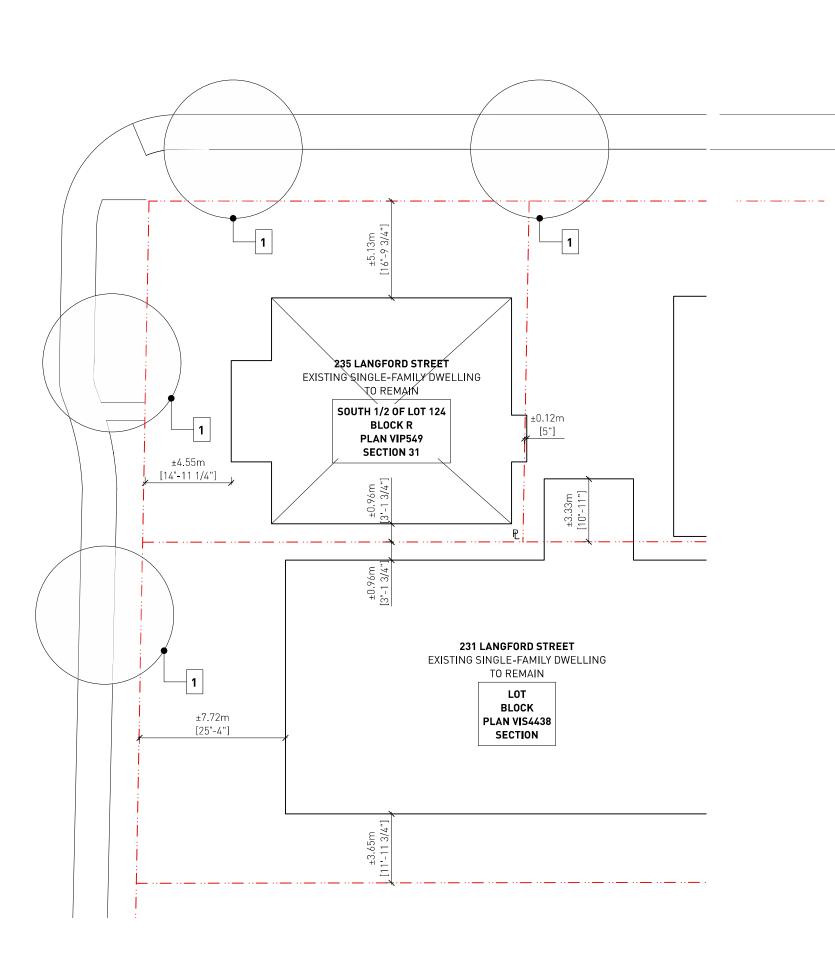

1 SITE CONTEXT PLAN
AG.4 SCALE: 1:200

ABOVE
PROPERTY LINE
BUILDING - EXISTING
BUILDING - DEMO
TREE PROTECTION

LEGEND:

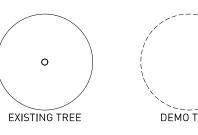

VEVNIOTES SITE CONTEXT

EXISTING MUNICIPAL TREE TO REMAIN
 EXISTING DECIDUOUS TREE [5CM] TO REMAIN

EXISTING DECIDOOUS TREE [SCM] TO

 EXISTING FIRE HYDRANT

4. EXISTING HYDRO POLE

5. EXISTING HEDGE [CEDAR] TO REMAIN

6. EXISTING PROTECTED TREE ROOT AREA

7. EXISTING DECIDUOUS TREE [40CM] TO

REMAIN

8. TREE TO BE REMOVED

9. PROPOSED BUILDING FOOTPRINT

1 ISSUED FOR DP

Drawn By:
Checked By:
Chinting Date:

AR / EA
CN / PB
Printing Date:
14.07.2023

14.07.2023

The Contractor shall verify all dimensions, datums and levels prior to commencement of work.

All errors and omissions to be reported to the Architect before proceeding.

This drawing must not be scaled.


This drawing is the property of the Architect; the copyright in same being reserved to him/her. It is


Any unauthorized alteration of the electronic data which constitute this document will void all

which constitute this document will void all responsibility for the altered document by the Architect.

Architect.

This drawing is not to be used for building

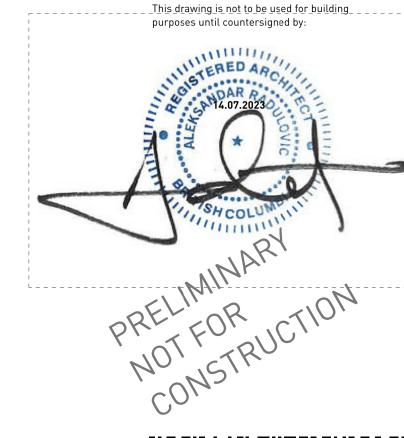

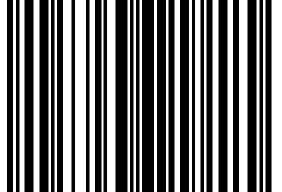

ARCHITECTURE INC 266 MCDERMOT AVE Winnipeg MB R3B 0S8 P: 204.480.8421 F: 204.480.8876

822 CATHERINE STREET + 304 LANGFORD STREET

VICTORIA, BC

SITE PLAN - CONTEXT

Proj

Od

She





EXISTING COMMERCIAL BUILDING — EXISTING SINGLE FAMILY RESIDENTIAL — BELLA ST. LANGFORD ST.



BELLA ST.

4 SITE CONTEXT ELEVATION - WEST
AG.5 SCALE: 1:200

Drawn By: Checked By: Printing Date:

1 ISSUED FOR DP

The Contractor shall verify all dimensions, datums and levels prior to commencement of work.

14.07.2023

AR/ JY CN / PB 14.07.2023

All errors and omissions to be reported to the Architect before proceeding.

This drawing must not be scaled.

This drawing is the property of the Architect; the copyright in same being reserved to him/her. It is

Any unauthorized alteration of the electronic data which constitute this document will void all responsibility for the altered document by the Architect.

This drawing is not to be used for building purposes until countersigned by:



266 MCDERMOT AVE Winnipeg MB R3B 0S8 P: 204.480.8421 F: 204.480.8876

822 CATHERINE STREET + 304 LANGFORD STREET

VICTORIA, BC

BUILDING ELEVATION -CONTEXT

COMMERCIAL GLAZING SCHEDULE

CURTAIN WALL

DESCRIPTION: ALUMICOR, THERMALLY BROKEN ALUMINUM STOREFRONT

TEMPERED, DUAL PANE, LOW E COATING, ARGON FILL, LOW REFLECTIVITY COATING TO REDUCE INTERNAL GLARE PRE-FINISHED ALUMINUM FLASHING AT HEADS AND SILLS



RESIDENTIAL WINDOW & DOOR SCHEDULE

PICTURE / AWNING WINDOW


DESCRIPTION: PLYGEM, DESIGN ARCHITECTURAL SERIES, ALUMINUM CLAD VINYL

CASEMENT WINDOW

DESCRIPTION: PLYGEM, DESIGN ARCHITECTURAL SERIES, ALUMINUM CLAD VINYL

EXTERIOR DOOR

DESCRIPTION: SMOKE SEAL, WALL STOP, HINGE, PEEP HOLE, DEAD BOLT, LEVERED SET, CLOSER, DOOR SWEEP, UNIT#.

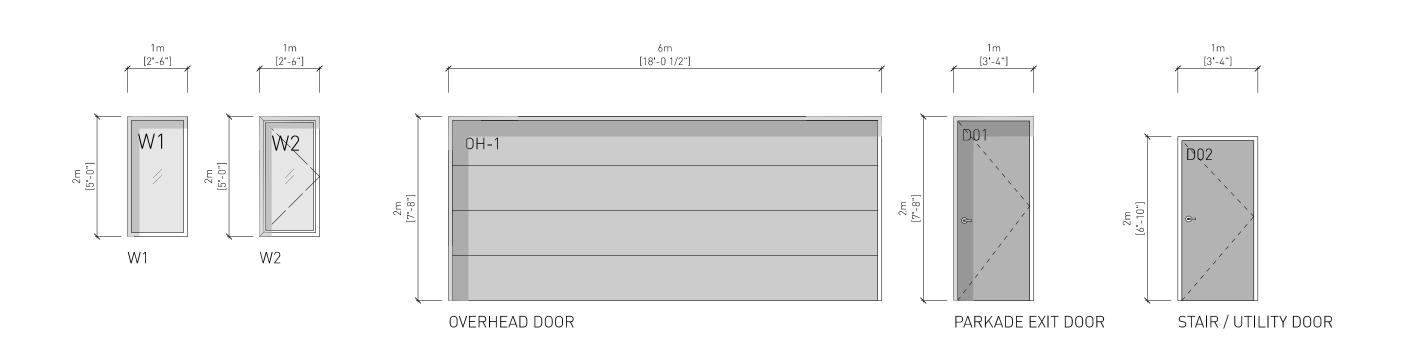

1 ISSUED FOR DP

Drawn By: Checked By: Printing Date:

AR/ JY CN / PB 14.07.2023

14.07.2023

The Contractor shall verify all dimensions, datums

and levels prior to commencement of work.

All errors and omissions to be reported to the


Architect before proceeding.


This drawing must not be scaled.

This drawing is the property of the Architect; the copyright in same being reserved to him/her. It is

Any unauthorized alteration of the electronic data which constitute this document will void all

responsibility for the altered document by the

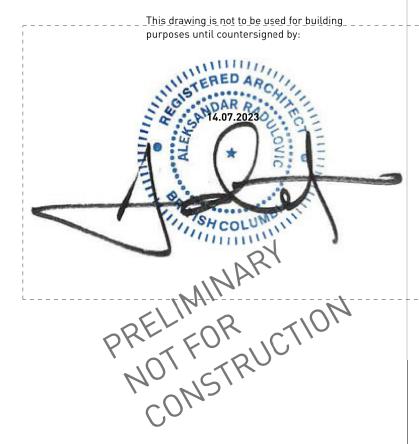

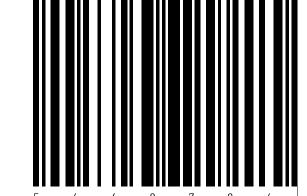



266 MCDERMOT AVE Winnipeg MB R3B 0S8 P: 204.480.8421 F: 204.480.8876

822 CATHERINE STREET + 304 LANGFORD STREET

VICTORIA, BC

WINDOW SCHEDULE

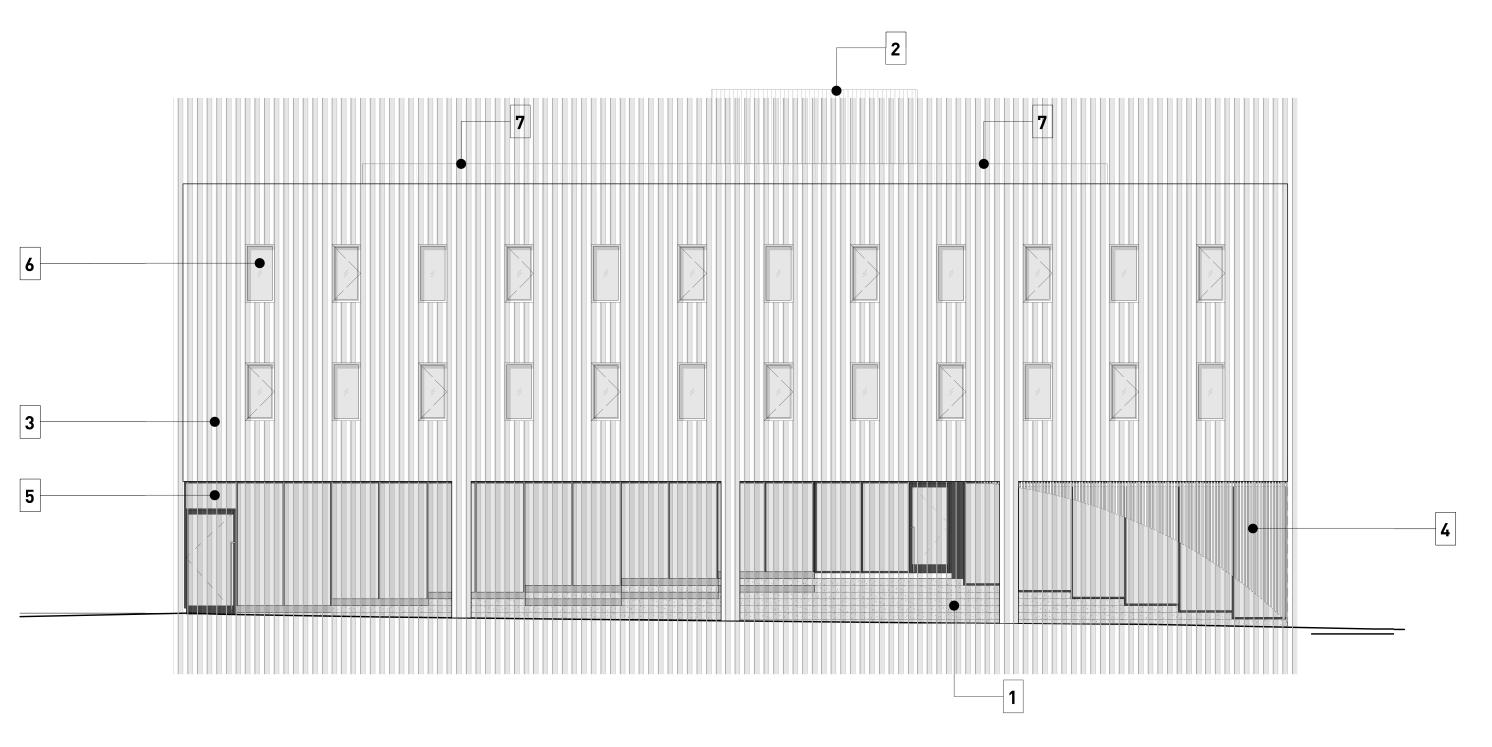


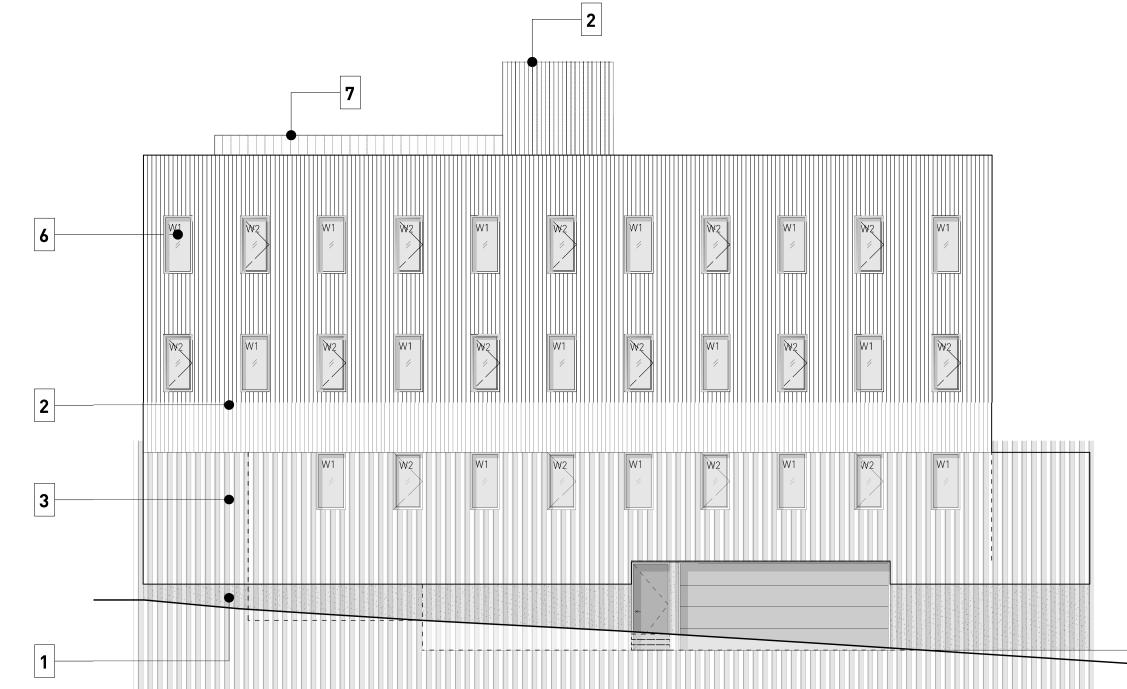








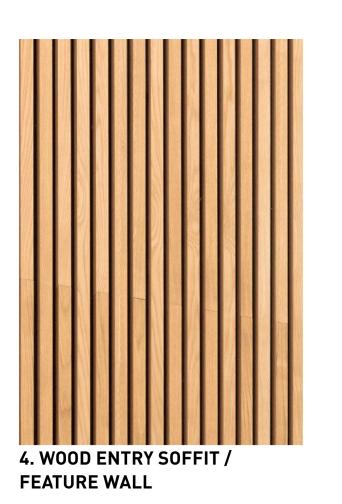







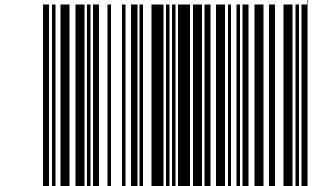

5 4 6 8 7 9 6 ARCHITECTURE INC 266 MCDERMOT AVE Winnipeg MB R3B 0S8 P: 204.480.8421 F: 204.480.8876

The Contractor shall verify all dimensions, datums and levels prior to commencement of work.

All errors and omissions to be reported to the Architect before proceeding.

This drawing is the property of the Architect; the copyright in same being reserved to him/her. It is

Any unauthorized alteration of the electronic data which constitute this document will void all responsibility for the altered document by the

__This <u>drawing is not to be used for building</u>__ purposes until countersigned by:

This drawing must not be scaled.


14.07.2023

AR/ JY CN / PB 14.07.2023

822 CATHERINE STREET + 304 LANGFORD STREET

VICTORIA, BC

MATERIAL BOARD Project
0646
Sheet

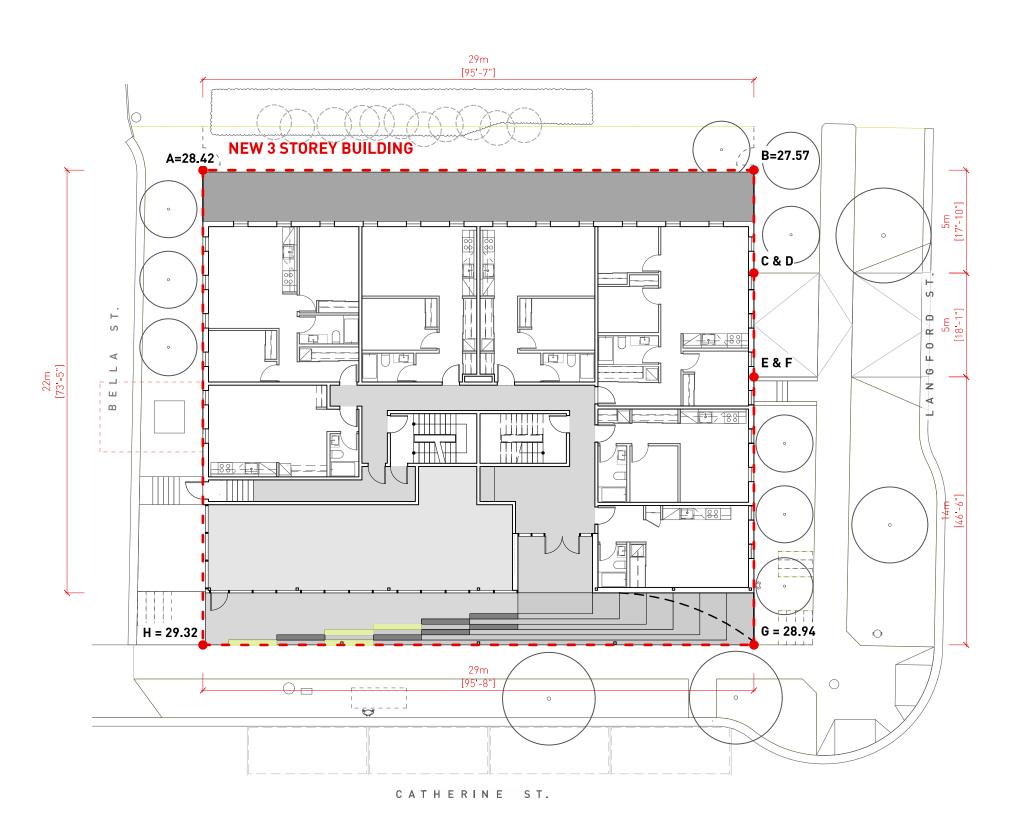




GRA	DE POINTS	BUILDING PERIMETER
Α	28.42	105.74
В	27.57	
С	27.62	
D	27.52	
E	27.98	
F	27.52	
G	28.94	
Н	29.32	

CALCULATION:	AVERAGES	DISTANCE	TOTALS
A & B	28.00	29.15	816.05
B & C	27.60	5.40	149.01
D & F	27.52	5.50	151.36
E & G	28.46	14.18	403.56
G & H	29.13	29.15	849.05
H & I	28.87	22.37	645.71

	105.74	3014.75
AVERAGE GRADE		
28.51		

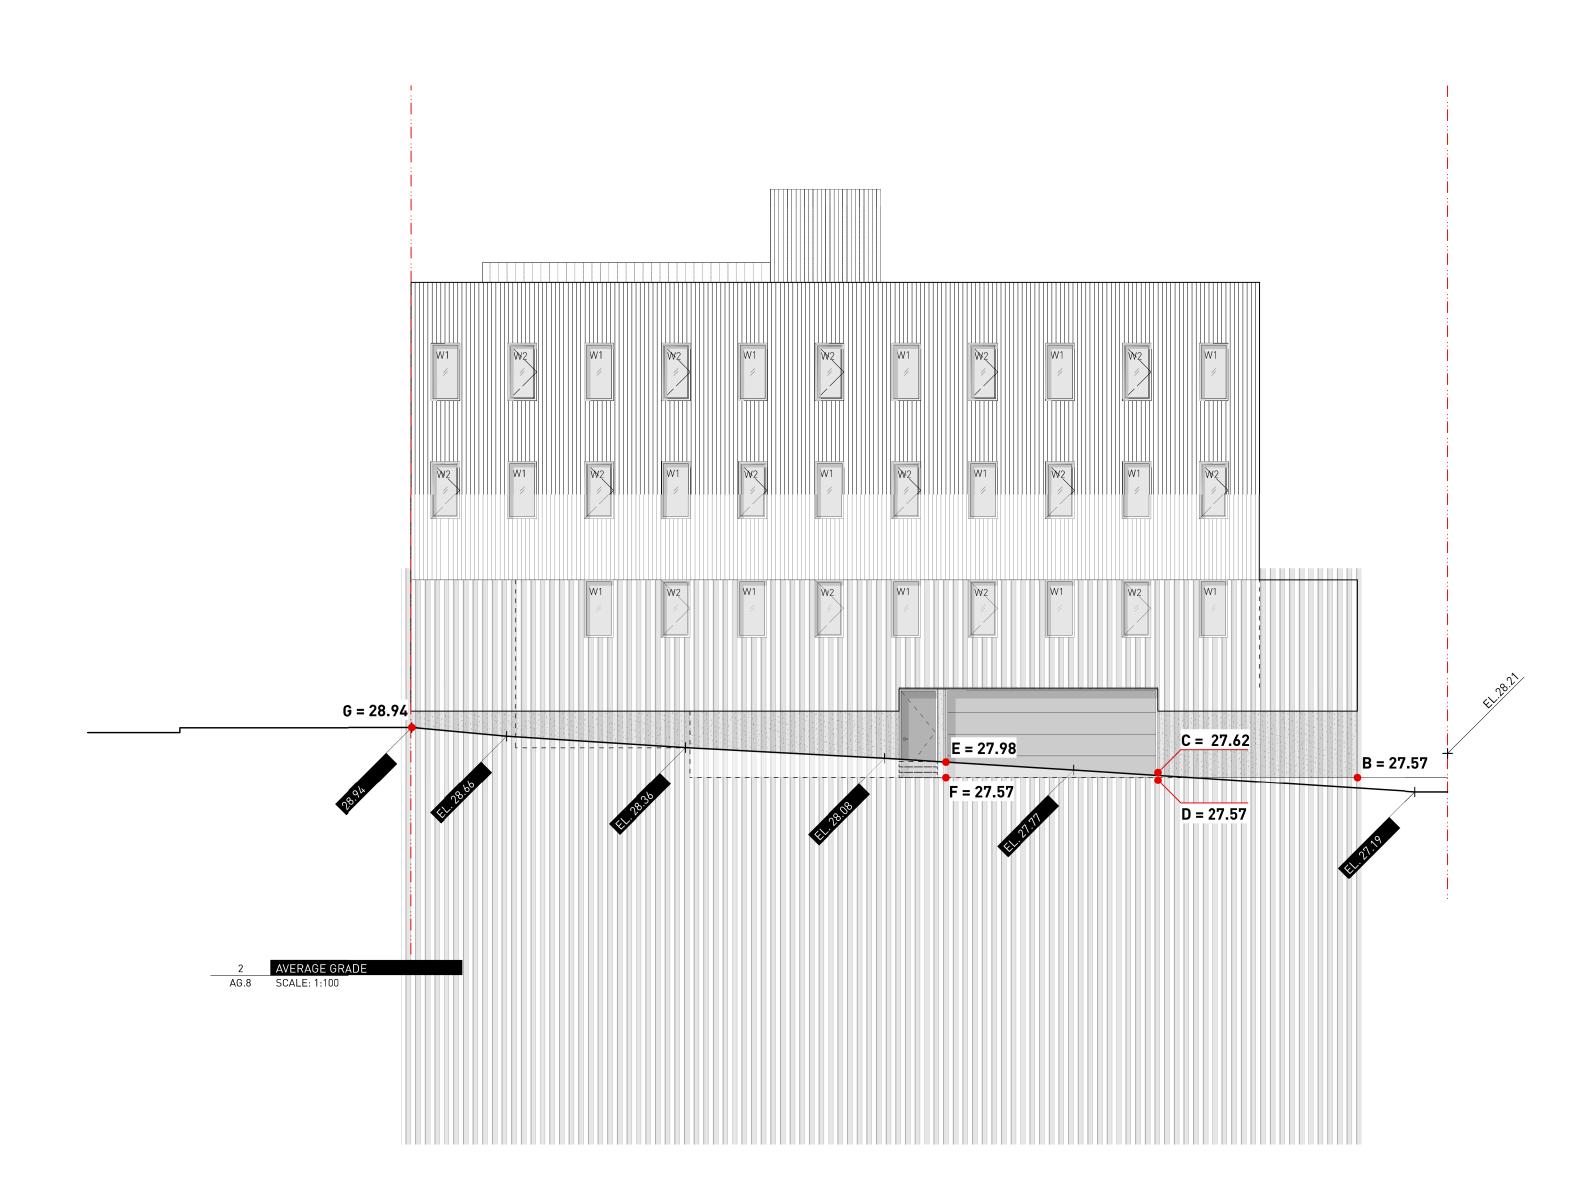

14.07.2023

AR/ JY CN / PB 14.07.2023

Drawn By: Checked By: Printing Date:

The Contractor shall verify all dimensions, datums

and levels prior to commencement of work.

All errors and omissions to be reported to the Architect before proceeding.

This drawing must not be so


This drawing must not be scaled.


This drawing is the property of the Architect; the copyright in same being reserved to him/her. It is not to be reproduced without his/her permission.

Any unauthorized alteration of the electronic data which constitute this document will void all responsibility for the altered document by the Architect.

Architect.

_ _ _ _This drawing is not to be used for building _ purposes until countersigned by:

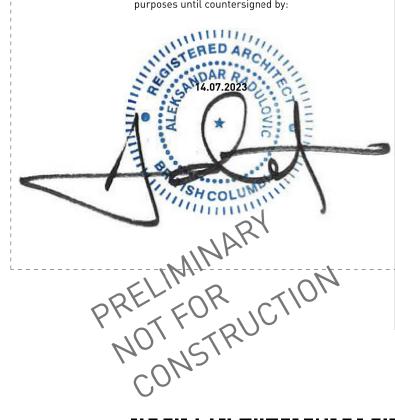

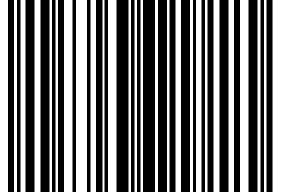

ARCHITECTURE INC 266 MCDERMOTAVE Winnipeg MB R3B 0S8 P: 204.480.8421 F: 204.480.8876


822 CATHERINE STREET + 304 LANGFORD STREET

VICTORIA, BC

AVERAGE GRADE CALCULATION

Sheet AG.8

Project 0646

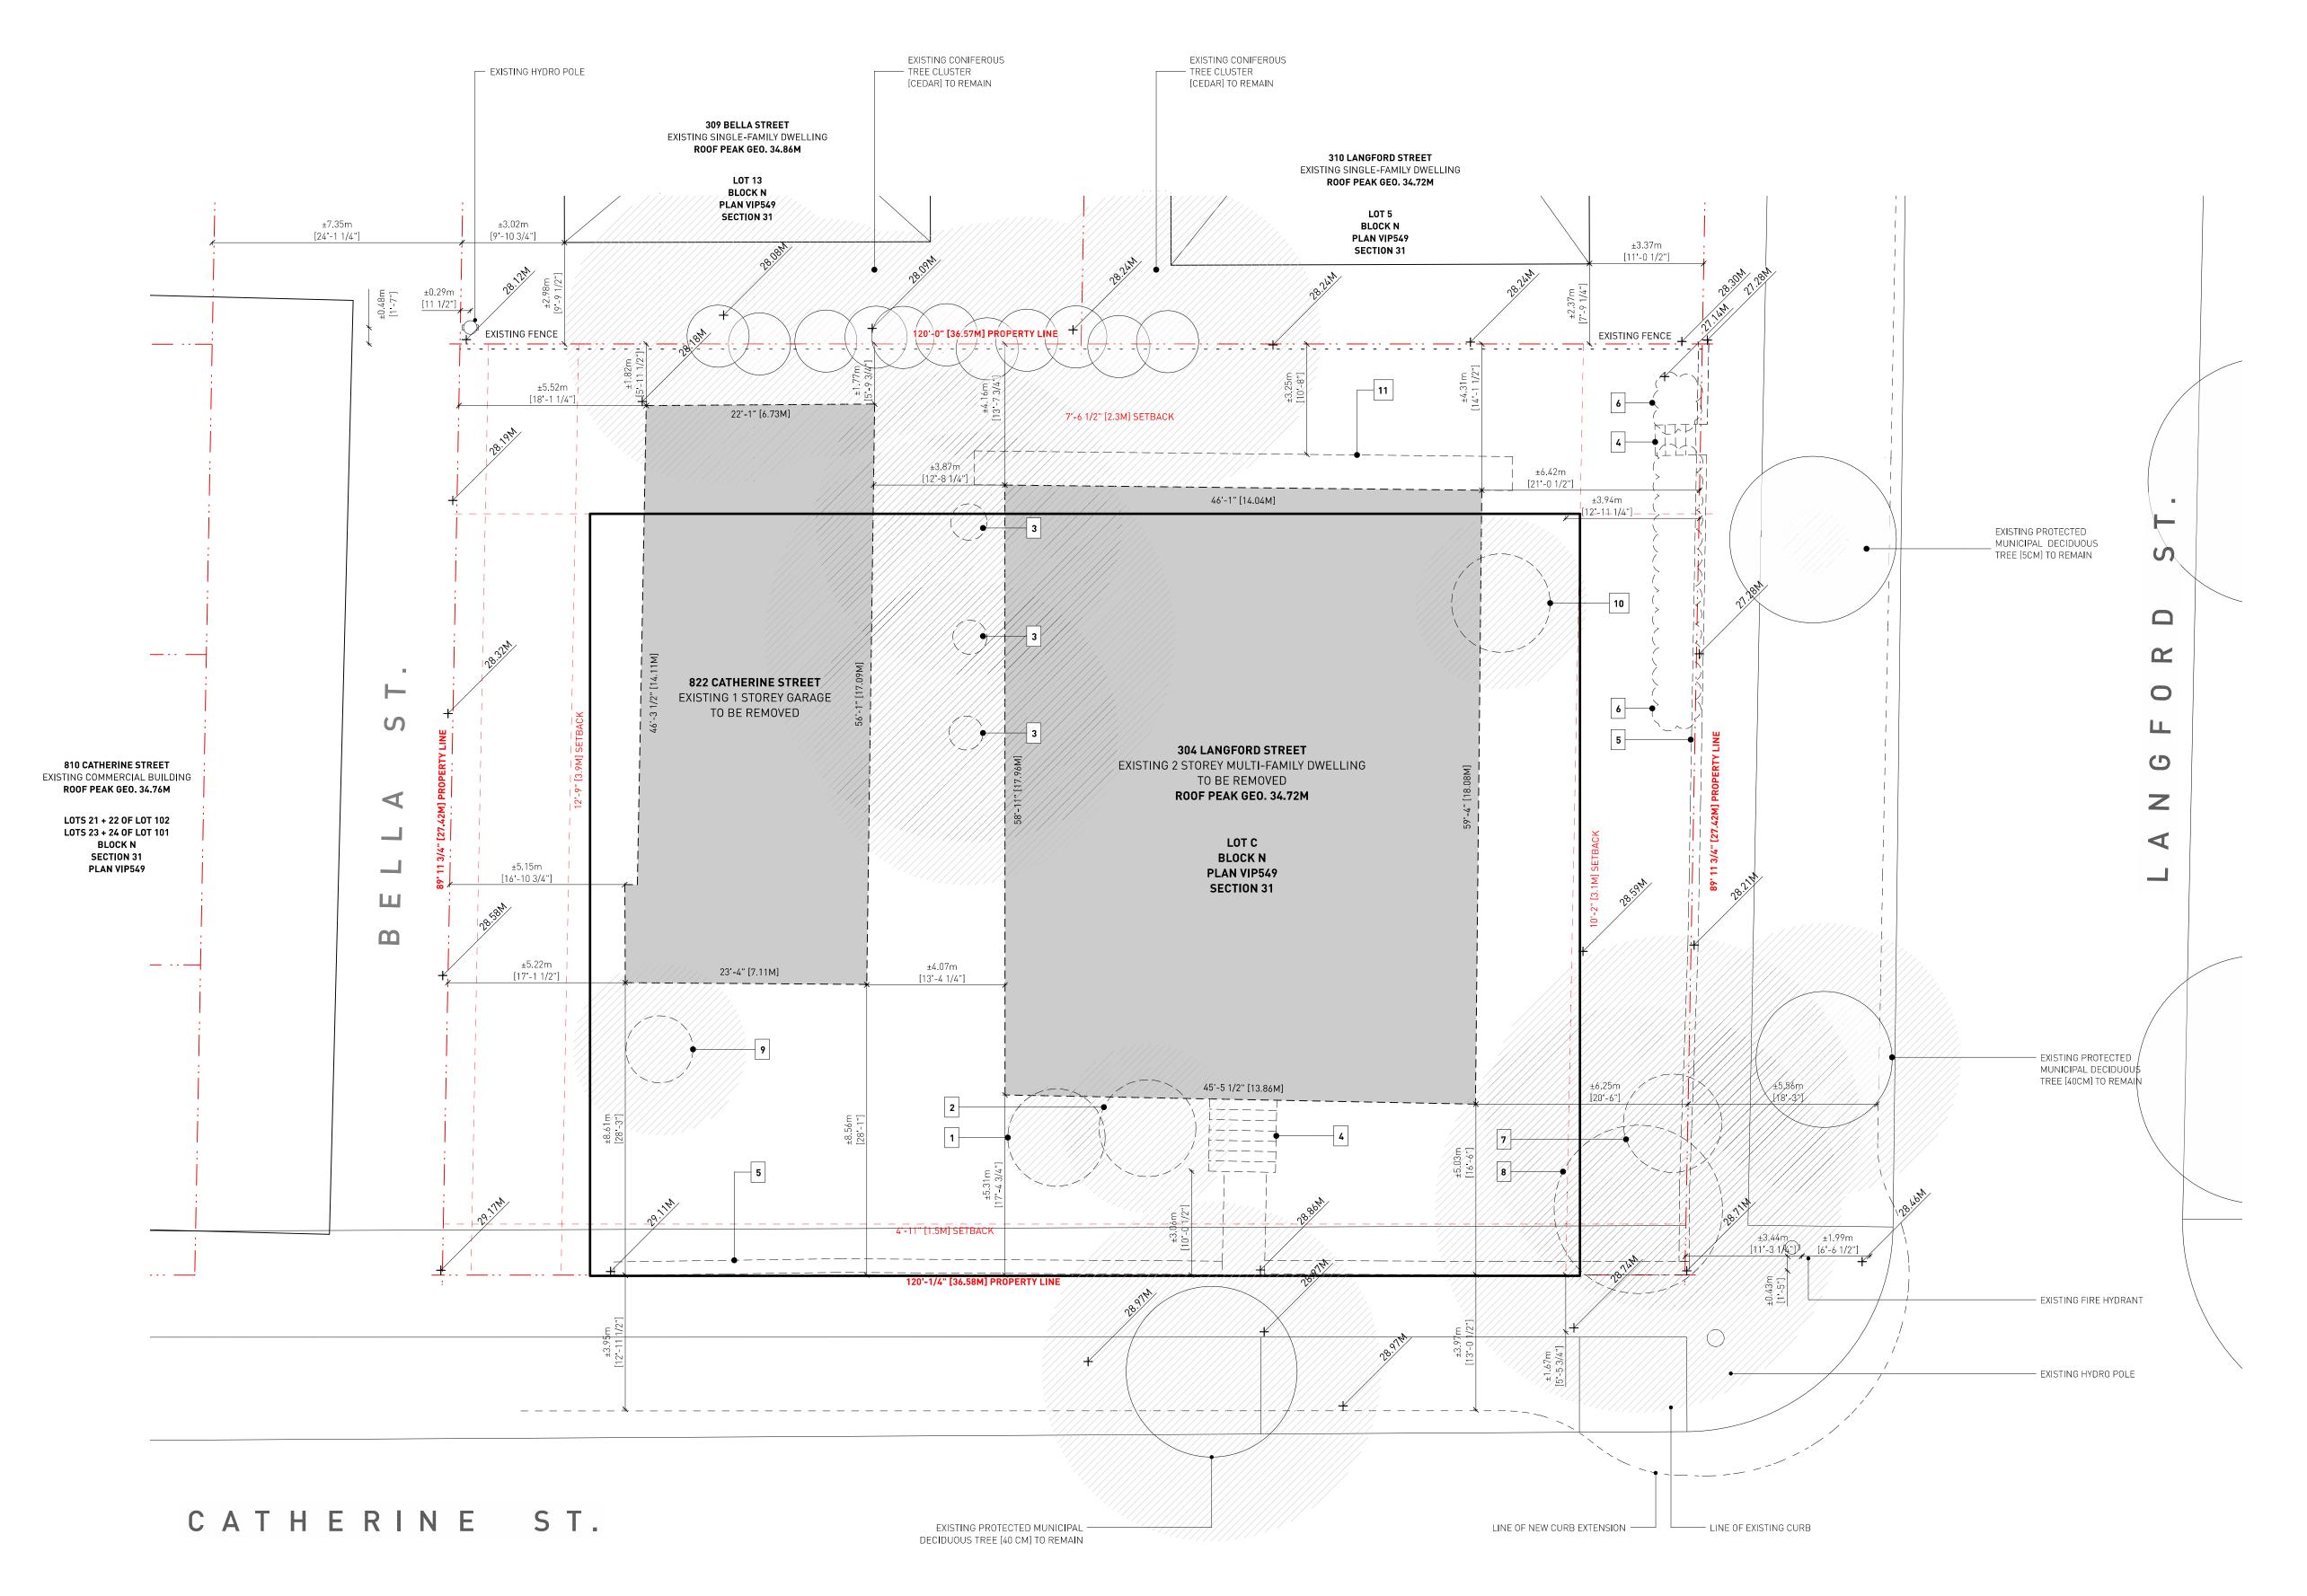

KEYNOTES - SITE EXISTING + DEMO

1. EXISTING CONIFEROUS TREE [15CM HOLLY]

TO BE REMOVED 2. EXISTING CONIFEROUS

TREE [20CM CYPRESS] TO BE REMOVED

3. EXISTING CONIFEROUS TREE [CEDAR] TO BE REMOVED

4. EXISTING STEPS TO BE REMOVED

5. EXISTING RETAINING WALL TO BE REMOVED 6. EXISTING HEDGE [CEDAR]

TO BE REMOVED 7. EXISTING PROTECTED DECIDUOUS TREE [3-20CM TO BE REMOVED

8. EXISTING PROTECTED CONIFEROUS TREE [3-20CM HOLLY] TO BE REMOVED

9. EXISTING CONIFEROUS TREE [30CM HOLLY] TO BE REMOVED

10. EXISTING CONIFEROUS TREE [30CM CYPRESS] TO BE REMOVED

11. EXISTING PORCH + STEPS TO BE REMOVED

LEGEND:

EXISTING BUILDING [TO BE REMOVED]

EXISTING BUILDING [TO REMAIN] PROPERTY LINE

SETBACK LINE EXISTING GAS LINE

EXISTING WATER MAIN

EXISTING SANITARY LINE

EXISTING FENCE PROPOSED CONCRETE HARDSCAPE

EXISTING TREE [TO BE REMOVED]



EXISTING TREE ROOT AREA



EXISTING FIRE HYDRANT

1 ISSUED FOR DP 14.07.2023

> AR / EA CN / PB 14.07.2023

Drawn By: Checked By: Printing Date:

and levels prior to commencement of work. All errors and omissions to be reported to the

The Contractor shall verify all dimensions, datums


Architect before proceeding. This drawing must not be scaled.


This drawing is the property of the Architect; the copyright in same being reserved to him/her. It is

Any unauthorized alteration of the electronic data which constitute this document will void all

responsibility for the altered document by the

__This <u>drawing is not to be used for building</u>__ purposes until countersigned by:

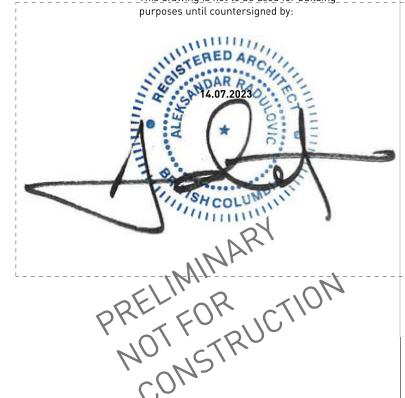

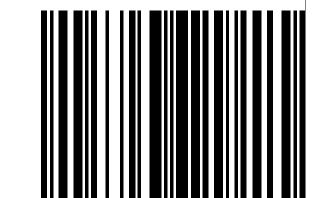


266 MCDERMOT AVE Winnipeg MB R3B 0S8 P: 204.480.8421 F: 204.480.8876

822 CATHERINE STREET + 304 LANGFORD STREET

VICTORIA, BC

SITE PLAN - EXISTING + DEMOLITION

A0.1

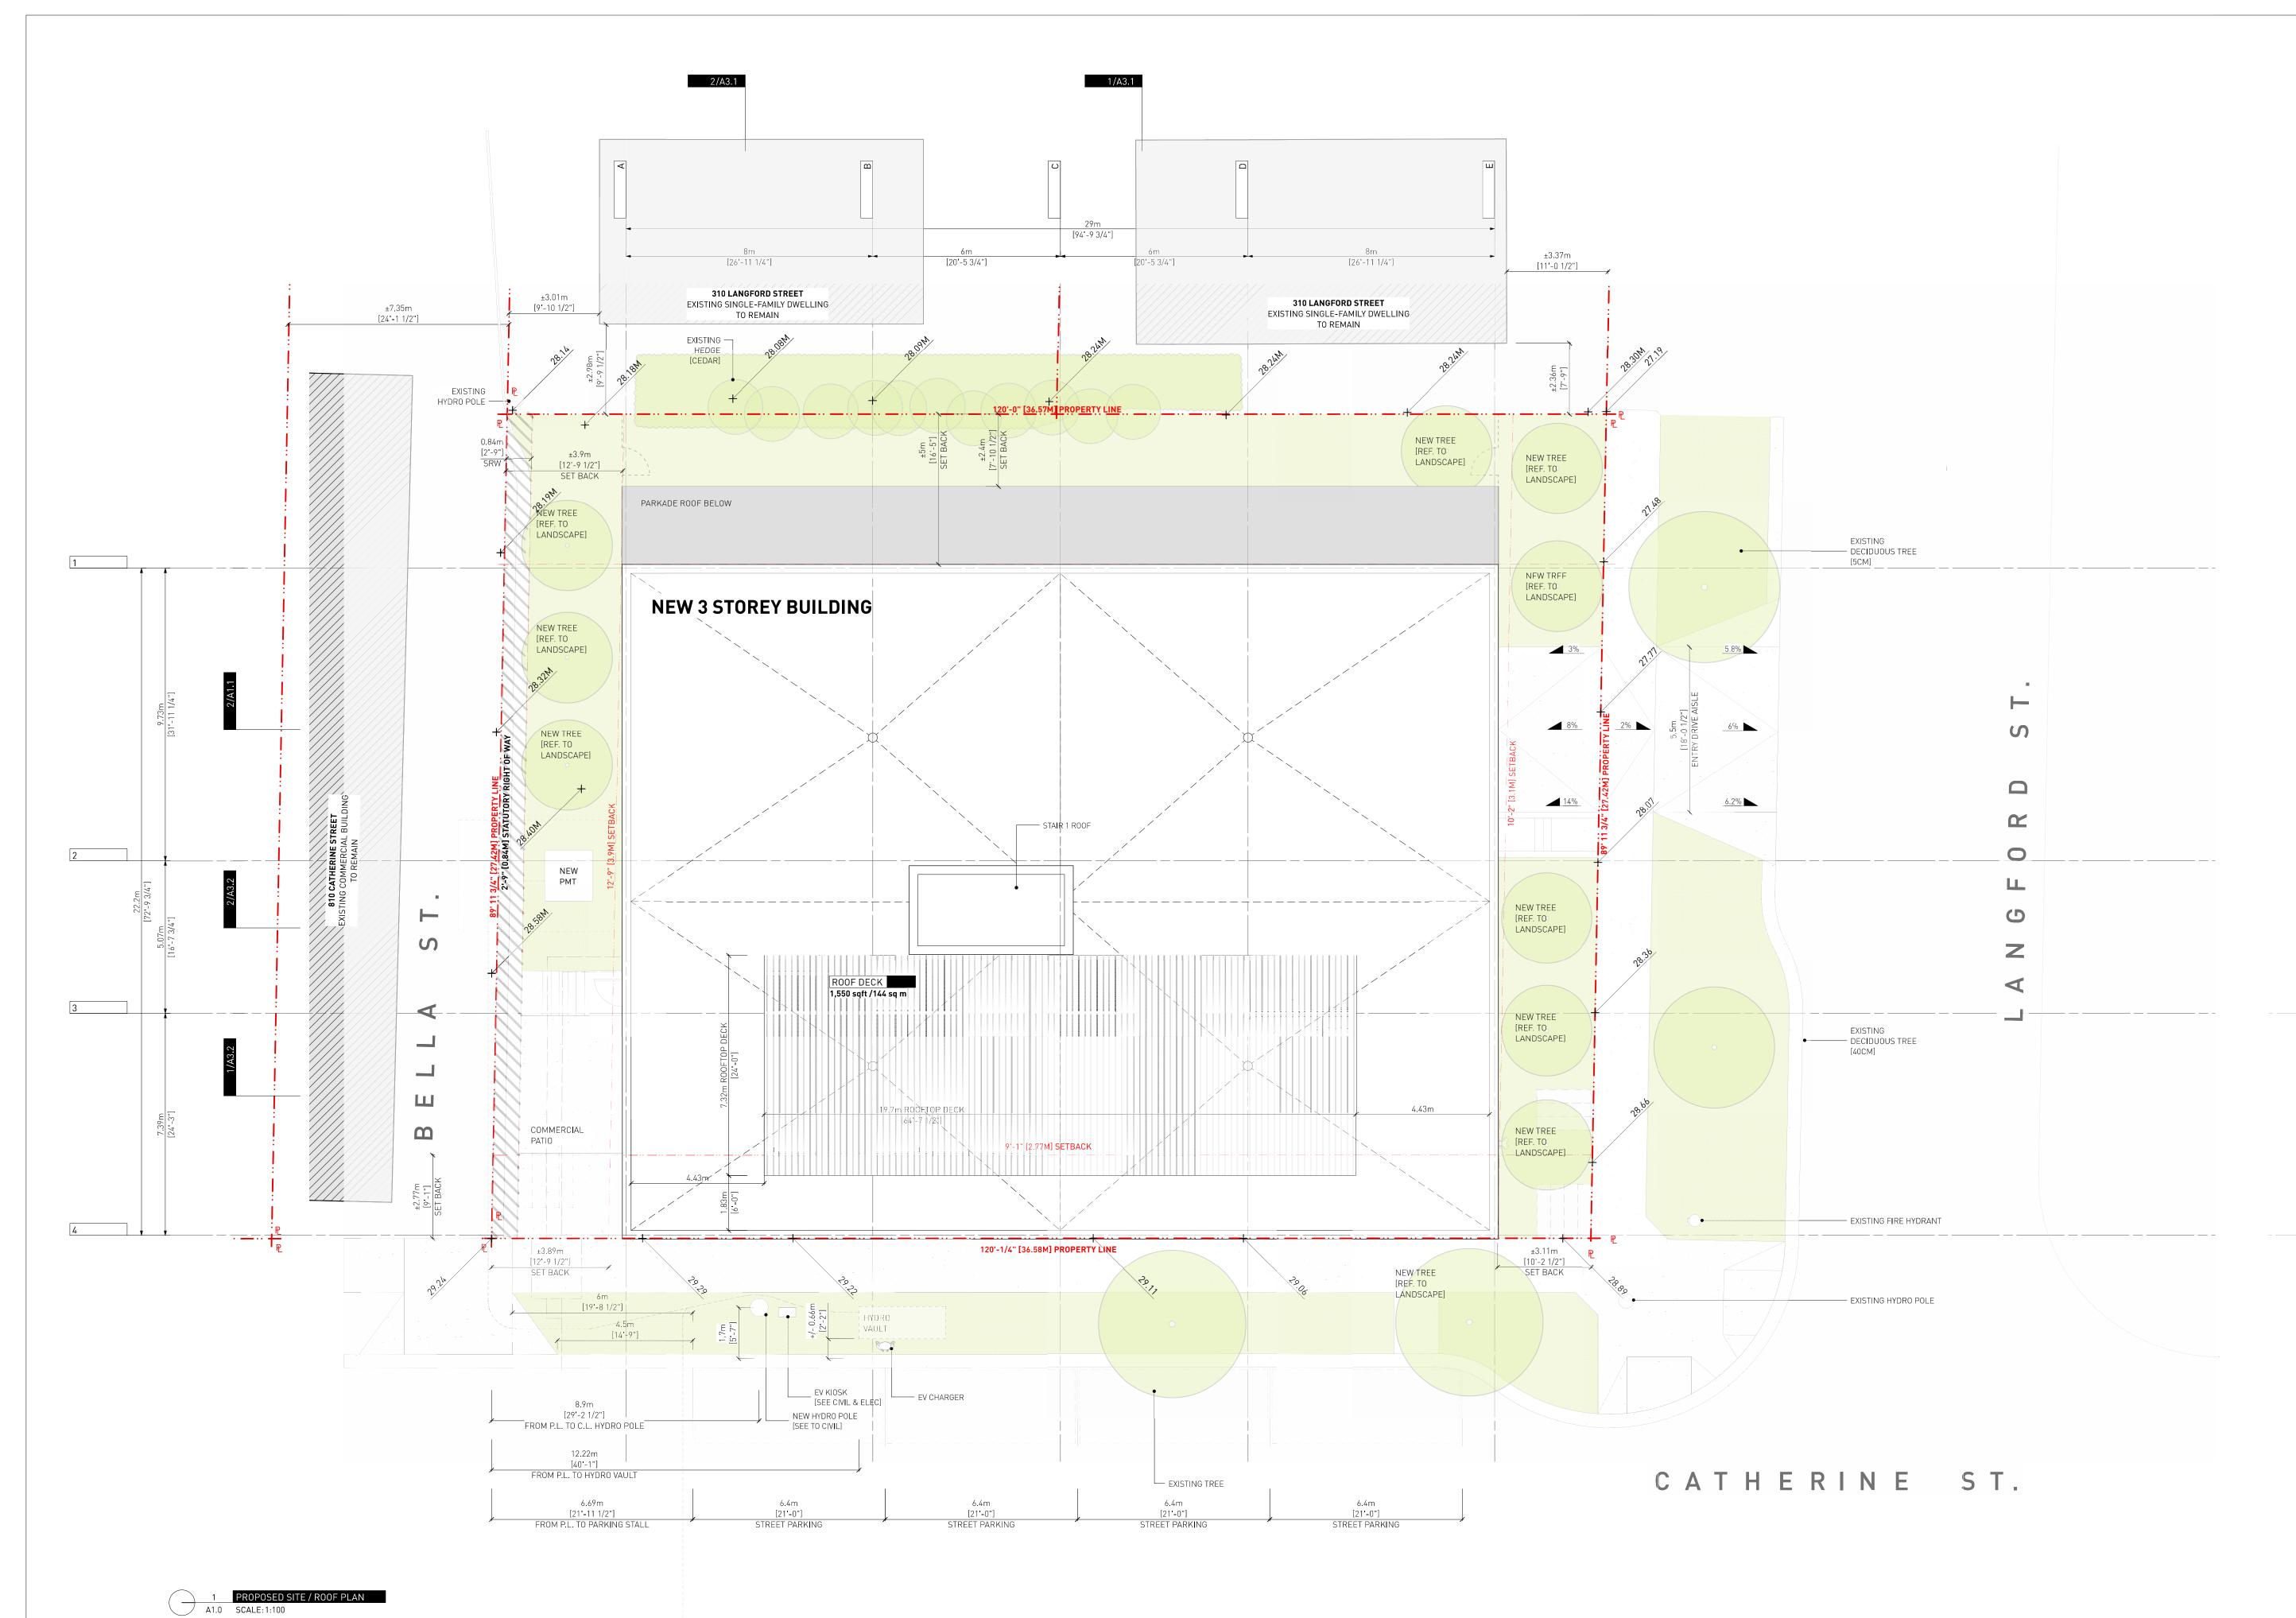

LEGEND:

ABOVE

PROPERTY LINE

EXISTING BUILDING

NON-RATED, GWB BULKHEAD ABOVE

EXISTING HYDRO POLE

EXISTING FIRE HYDRANT

PROPOSED BENCH

1 ISSUED FOR DP

Drawn By: Checked By: Printing Date:

The Contractor shall verify all dimensions, datums and levels prior to commencement of work.

14.07.2023

AR/ JY CN / PB 14.07.2023

All errors and omissions to be reported to the Architect before proceeding.

This drawing must not be scaled.


This drawing is the property of the Architect; the


copyright in same being reserved to him/her. It is

Any unauthorized alteration of the electronic data which constitute this document will void all responsibility for the altered document by the

Architect.

_This drawing is not to be used for building _ purposes until countersigned by:

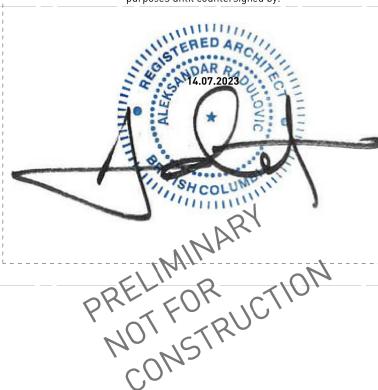

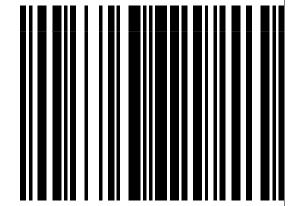


266 MCDERMOT AVE Winnipeg MB R3B 0S8 P: 204.480.8421 F: 204.480.8876

822 CATHERINE STREET + 304 LANGFORD STREET

VICTORIA, BC

SITE PLAN - PROPOSED Sheet

A1.0

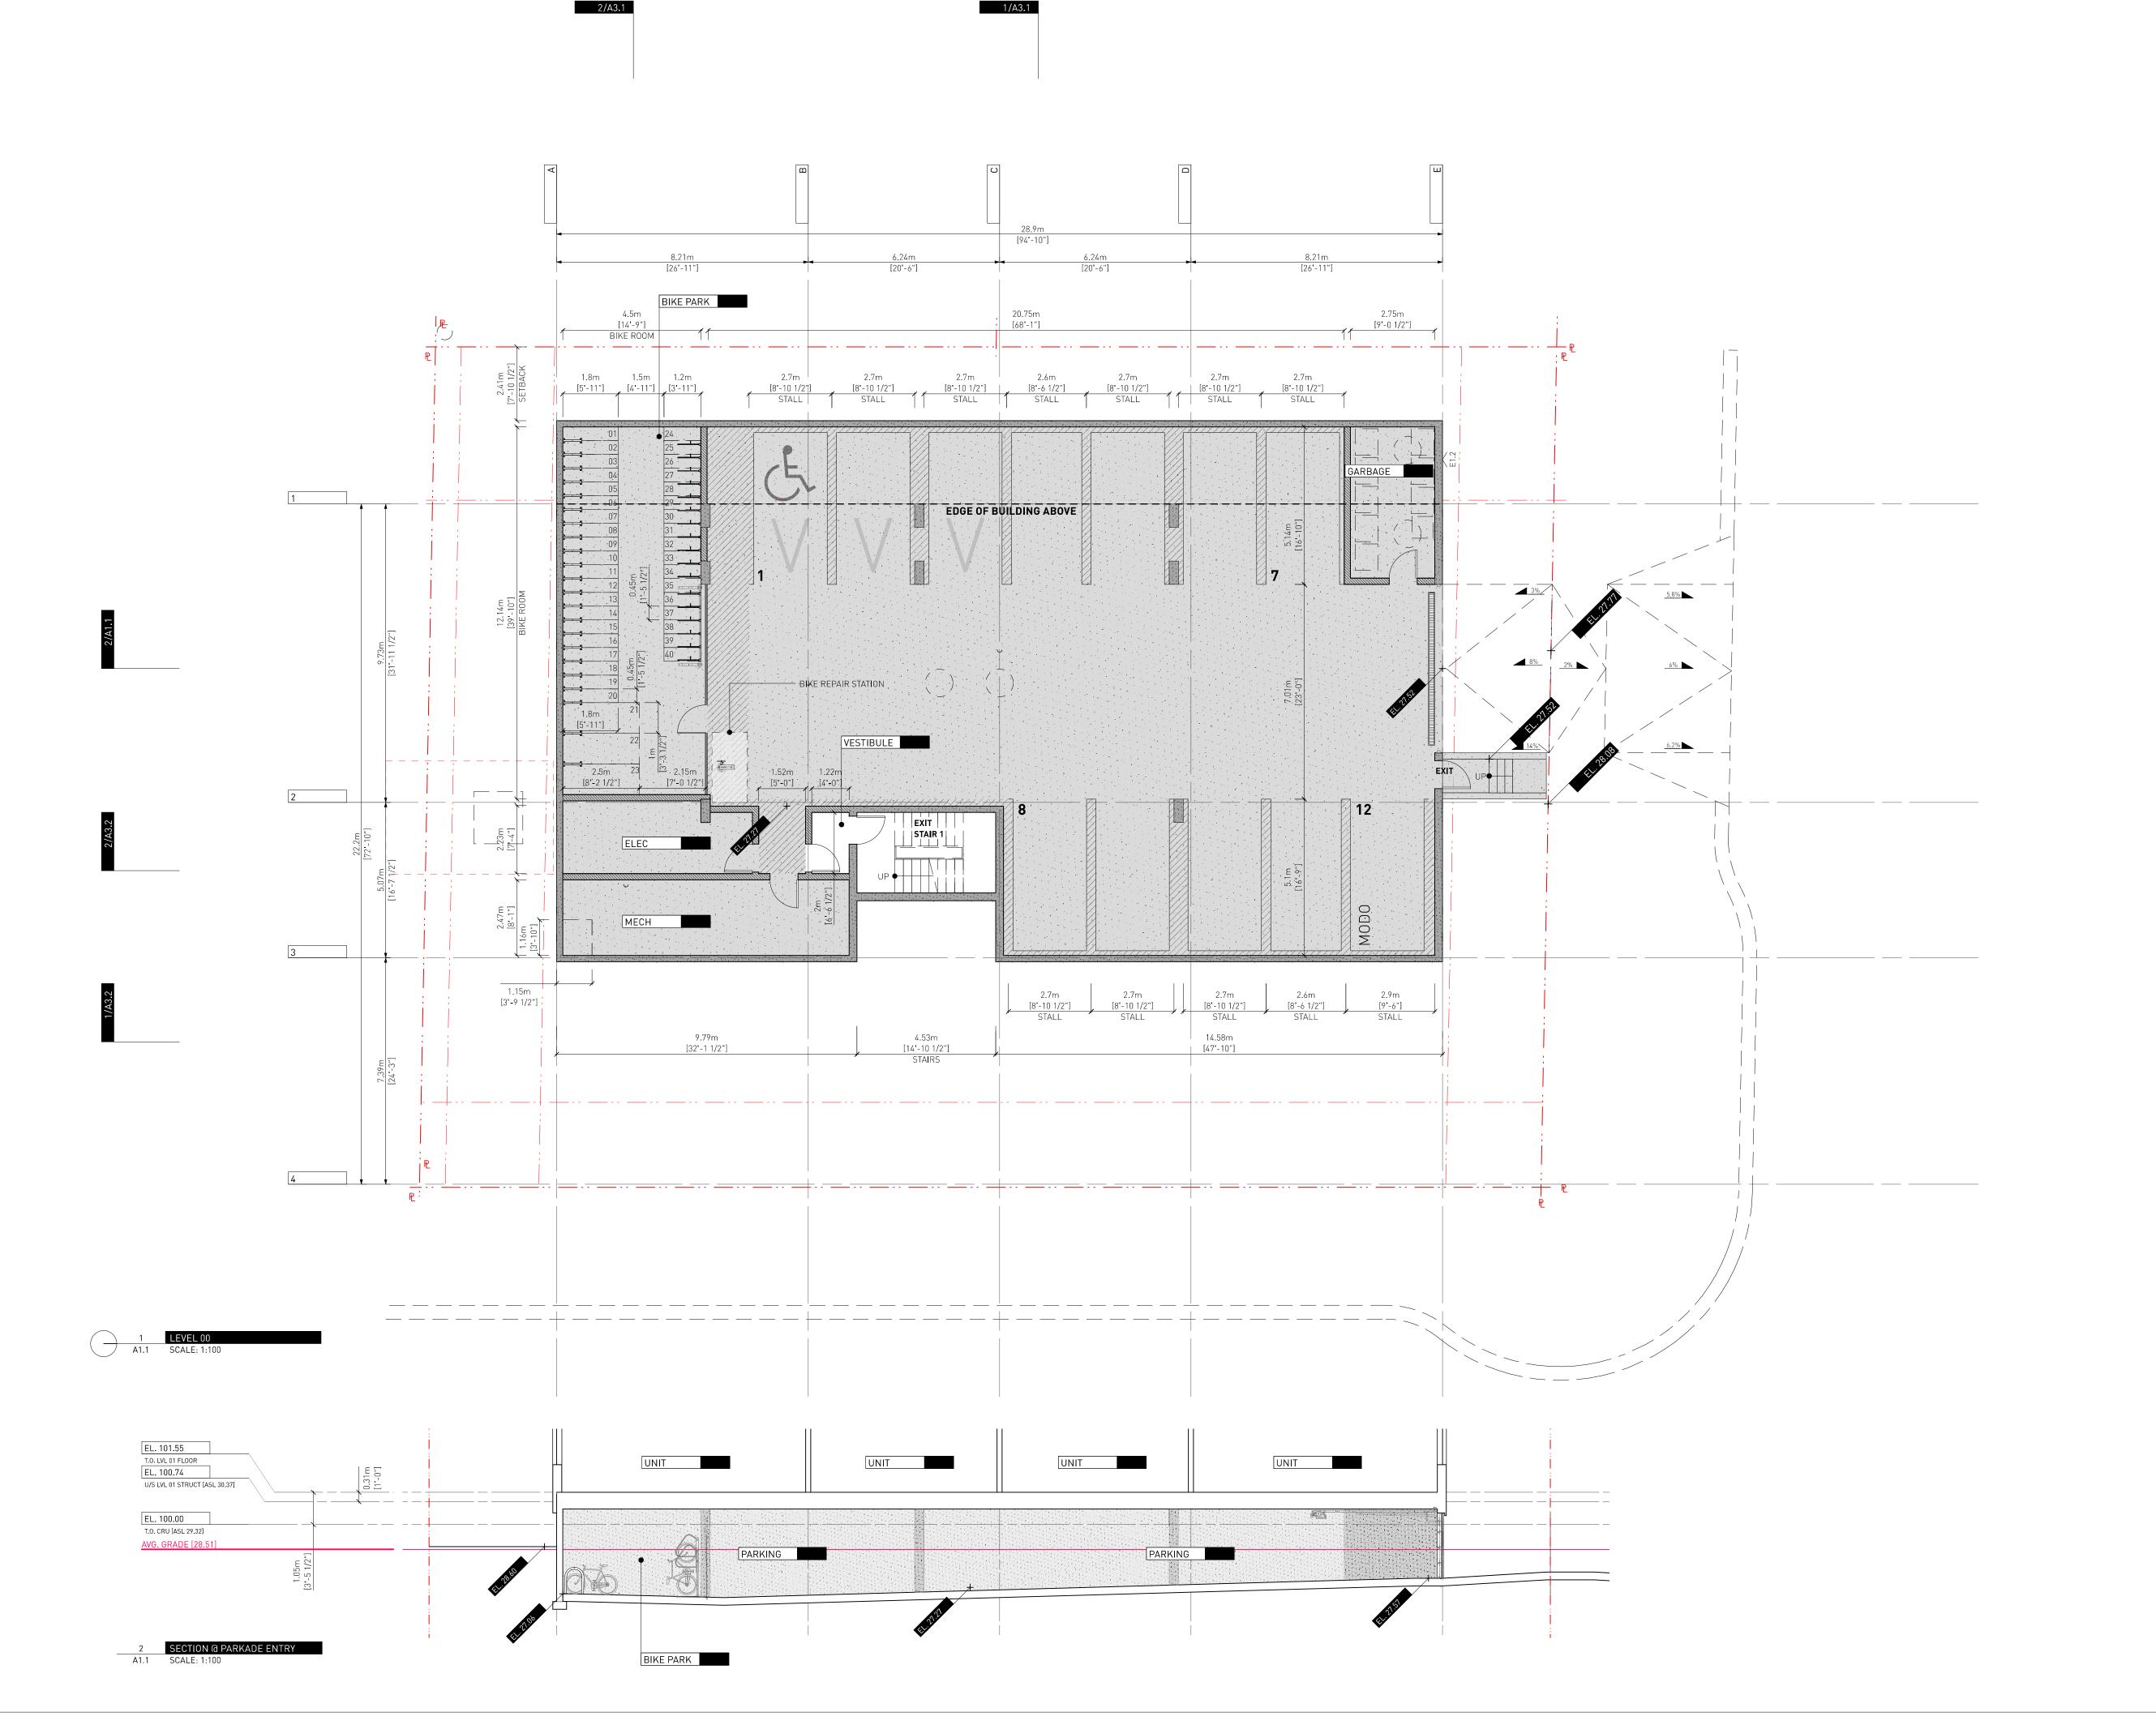

14.07.2023

AR / EA CN / PB 14.07.2023

Drawn By: Checked By: Printing Date:

The Contractor shall verify all dimensions, datums and levels prior to commencement of work.

All errors and omissions to be reported to the Architect before proceeding.

-....


This drawing must not be scaled.

This drawing is the property of the Architect; the copyright in same being reserved to him/her. It is

Any unauthorized alteration of the electronic data which constitute this document will void all responsibility for the altered document by the

responsibility for the altered document by the Architect.

___This <u>drawing is not to be used for building</u>_ purposes until countersigned by:

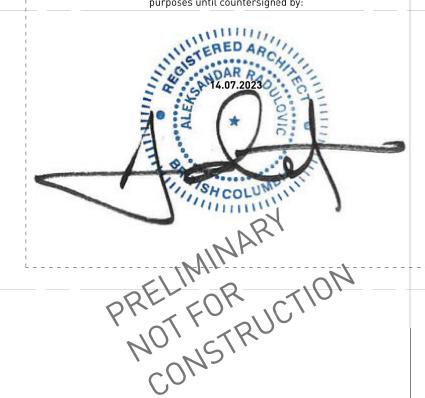




ARCHITECTURE INC 266 MCDERMOT AVE Winnipeg MB R3B 0S8 P: 204.480.8421 F: 204.480.8876

822 CATHERINE STREET + 304 LANGFORD STREET

VICTORIA, BC

LEVEL 00 PLAN
Project
0646
Sheet

A1.1

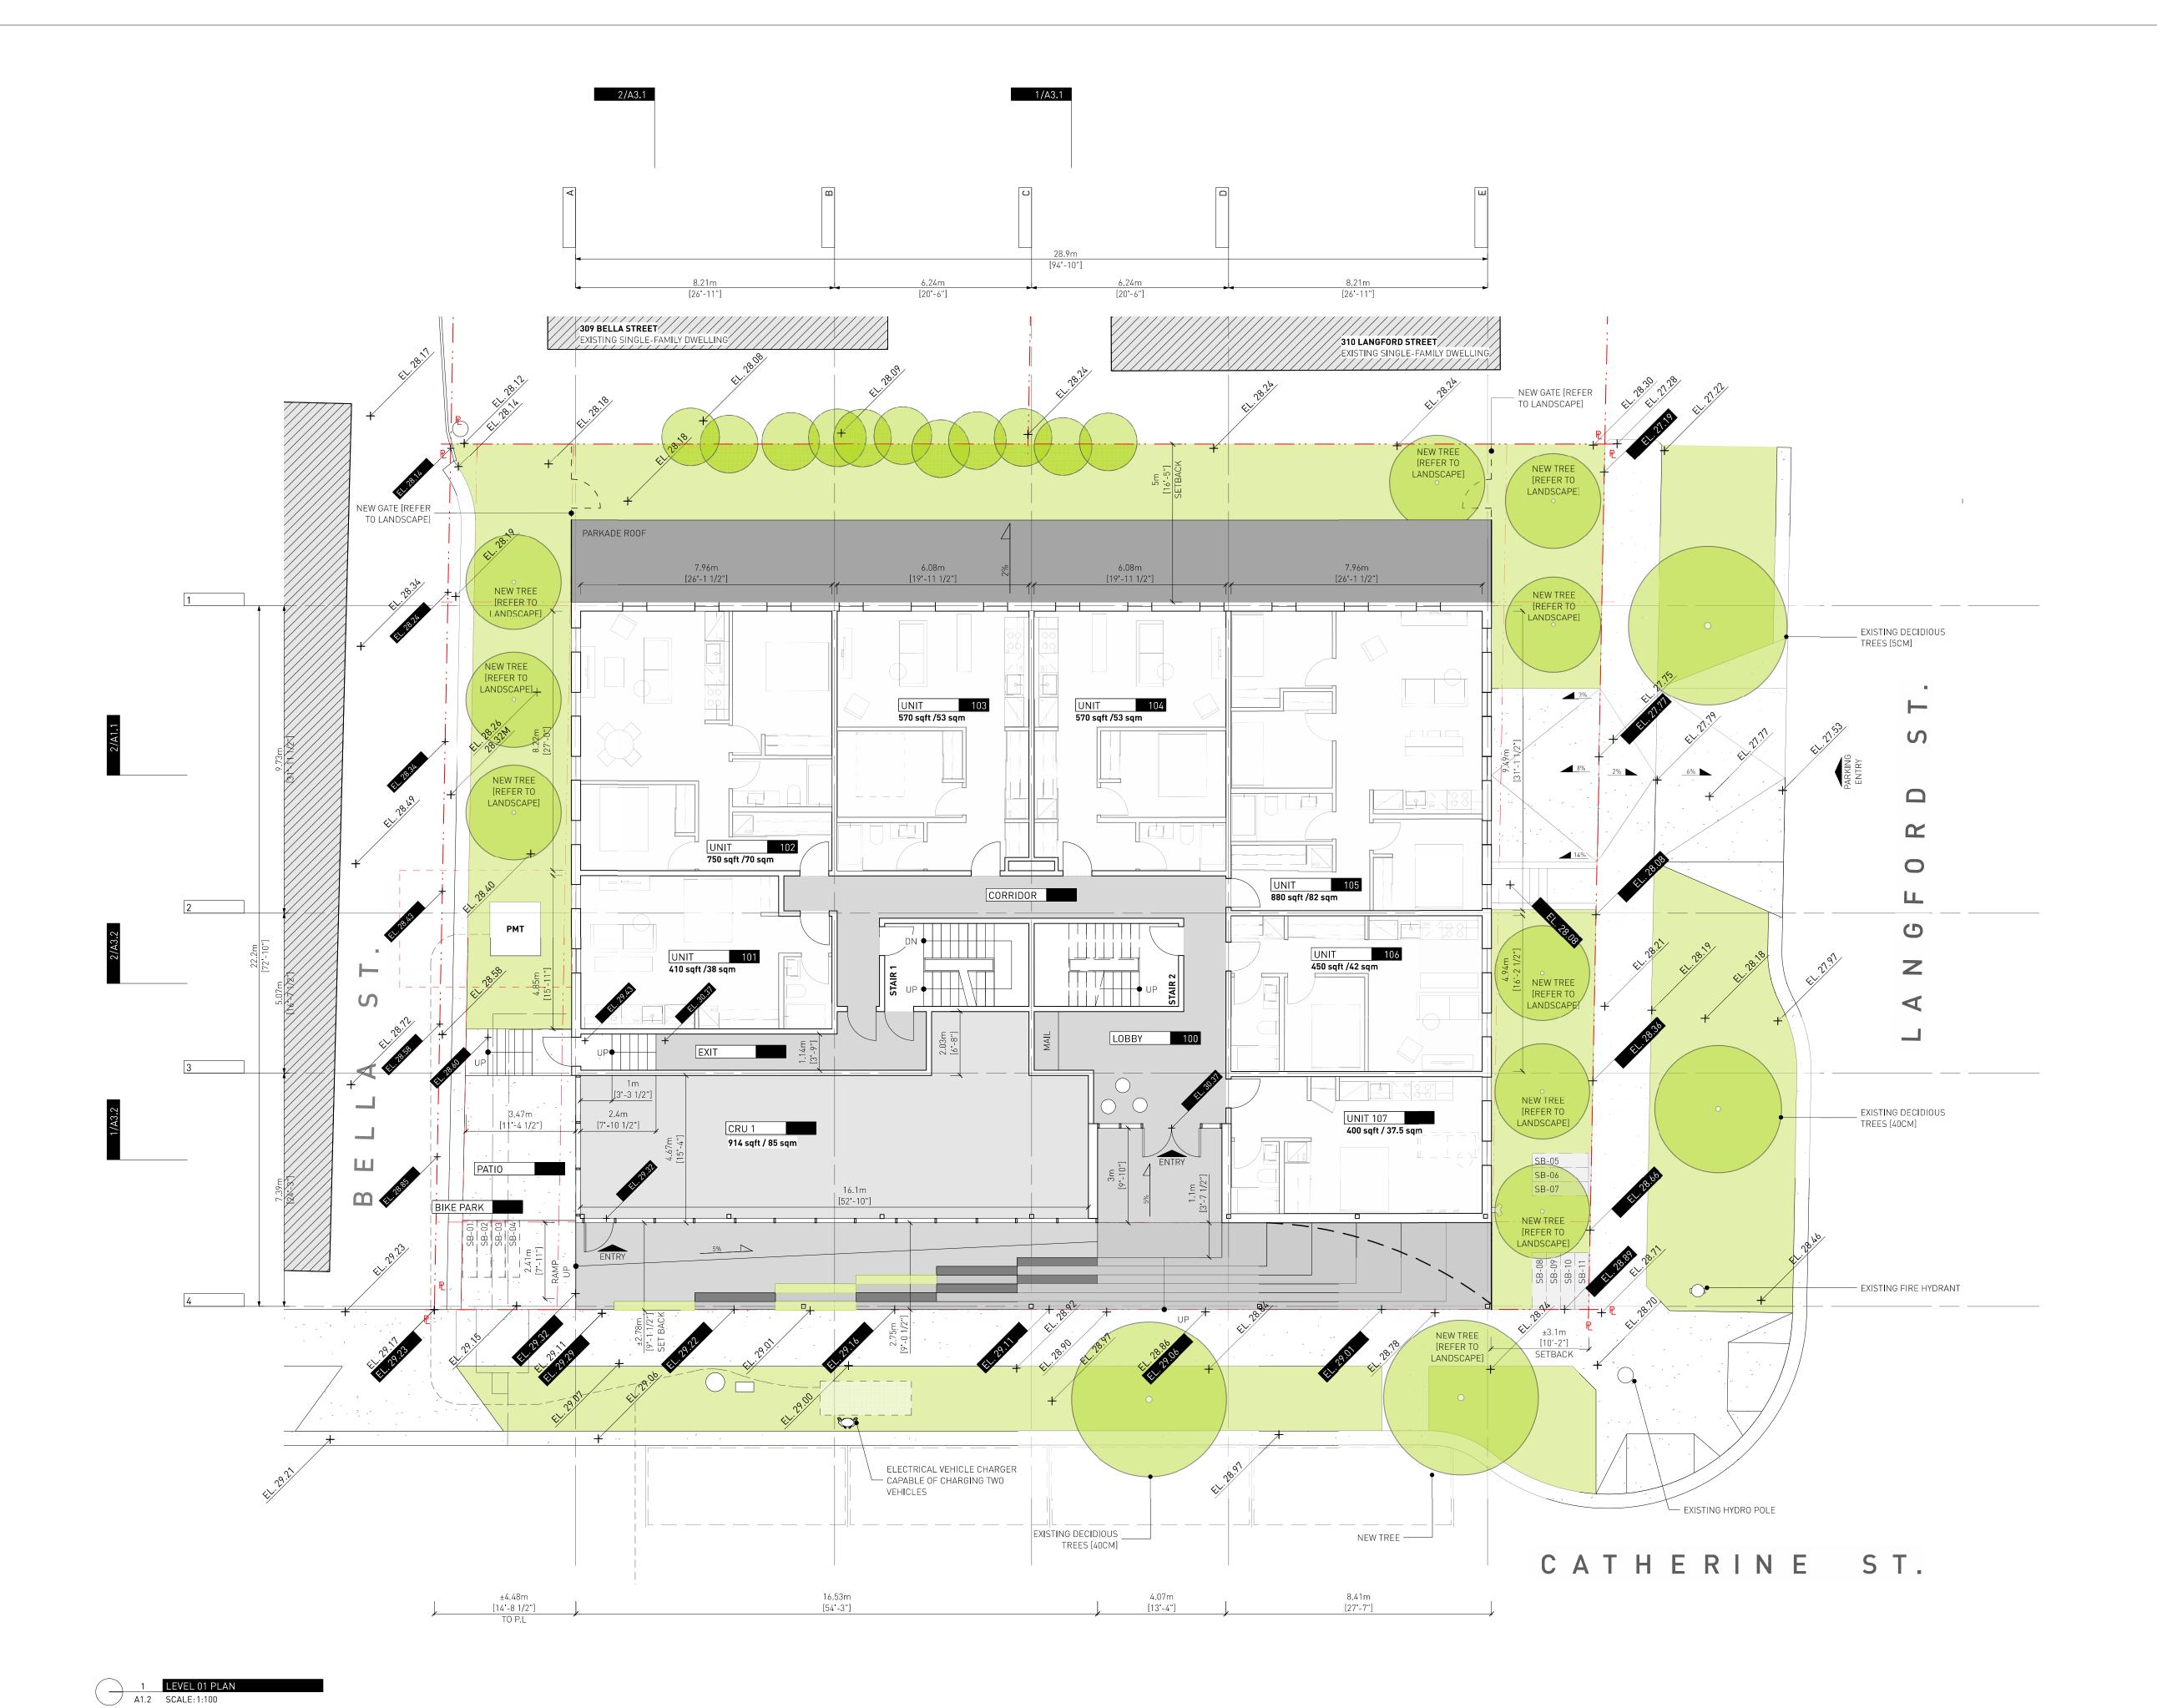

14.07.2023

EA CN / PB 14.07.2023

Drawn By: Checked By: Printing Date:

The Contractor shall verify all dimensions, datums and levels prior to commencement of work.

All errors and omissions to be reported to the Architect before proceeding.


This drawing must not be scaled.


This drawing is the property of the Architect; the copyright in same being reserved to him/her. It is not to be reproduced without his/her permission.

Any unauthorized alteration of the electronic data which constitute this document will void all responsibility for the altered document by the

This description is not to be used for building

This drawing is not to be used for building purposes until countersigned by:

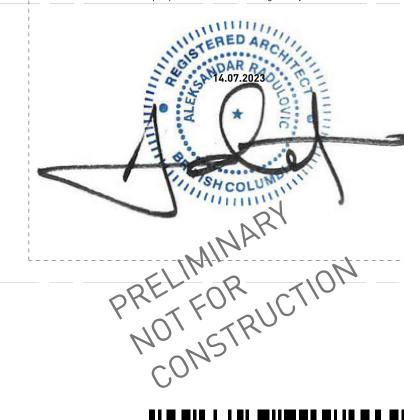

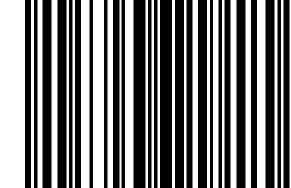


ARCHITECTURE INC 266 MCDERMOTAVE Winnipeg MB R3B 0S8 P: 204.480.8421 F: 204.480.8876

822 CATHERINE STREET + 304 LANGFORD STREET

VICTORIA, BC

LEVEL 01 PLAN

Sheet A1.2

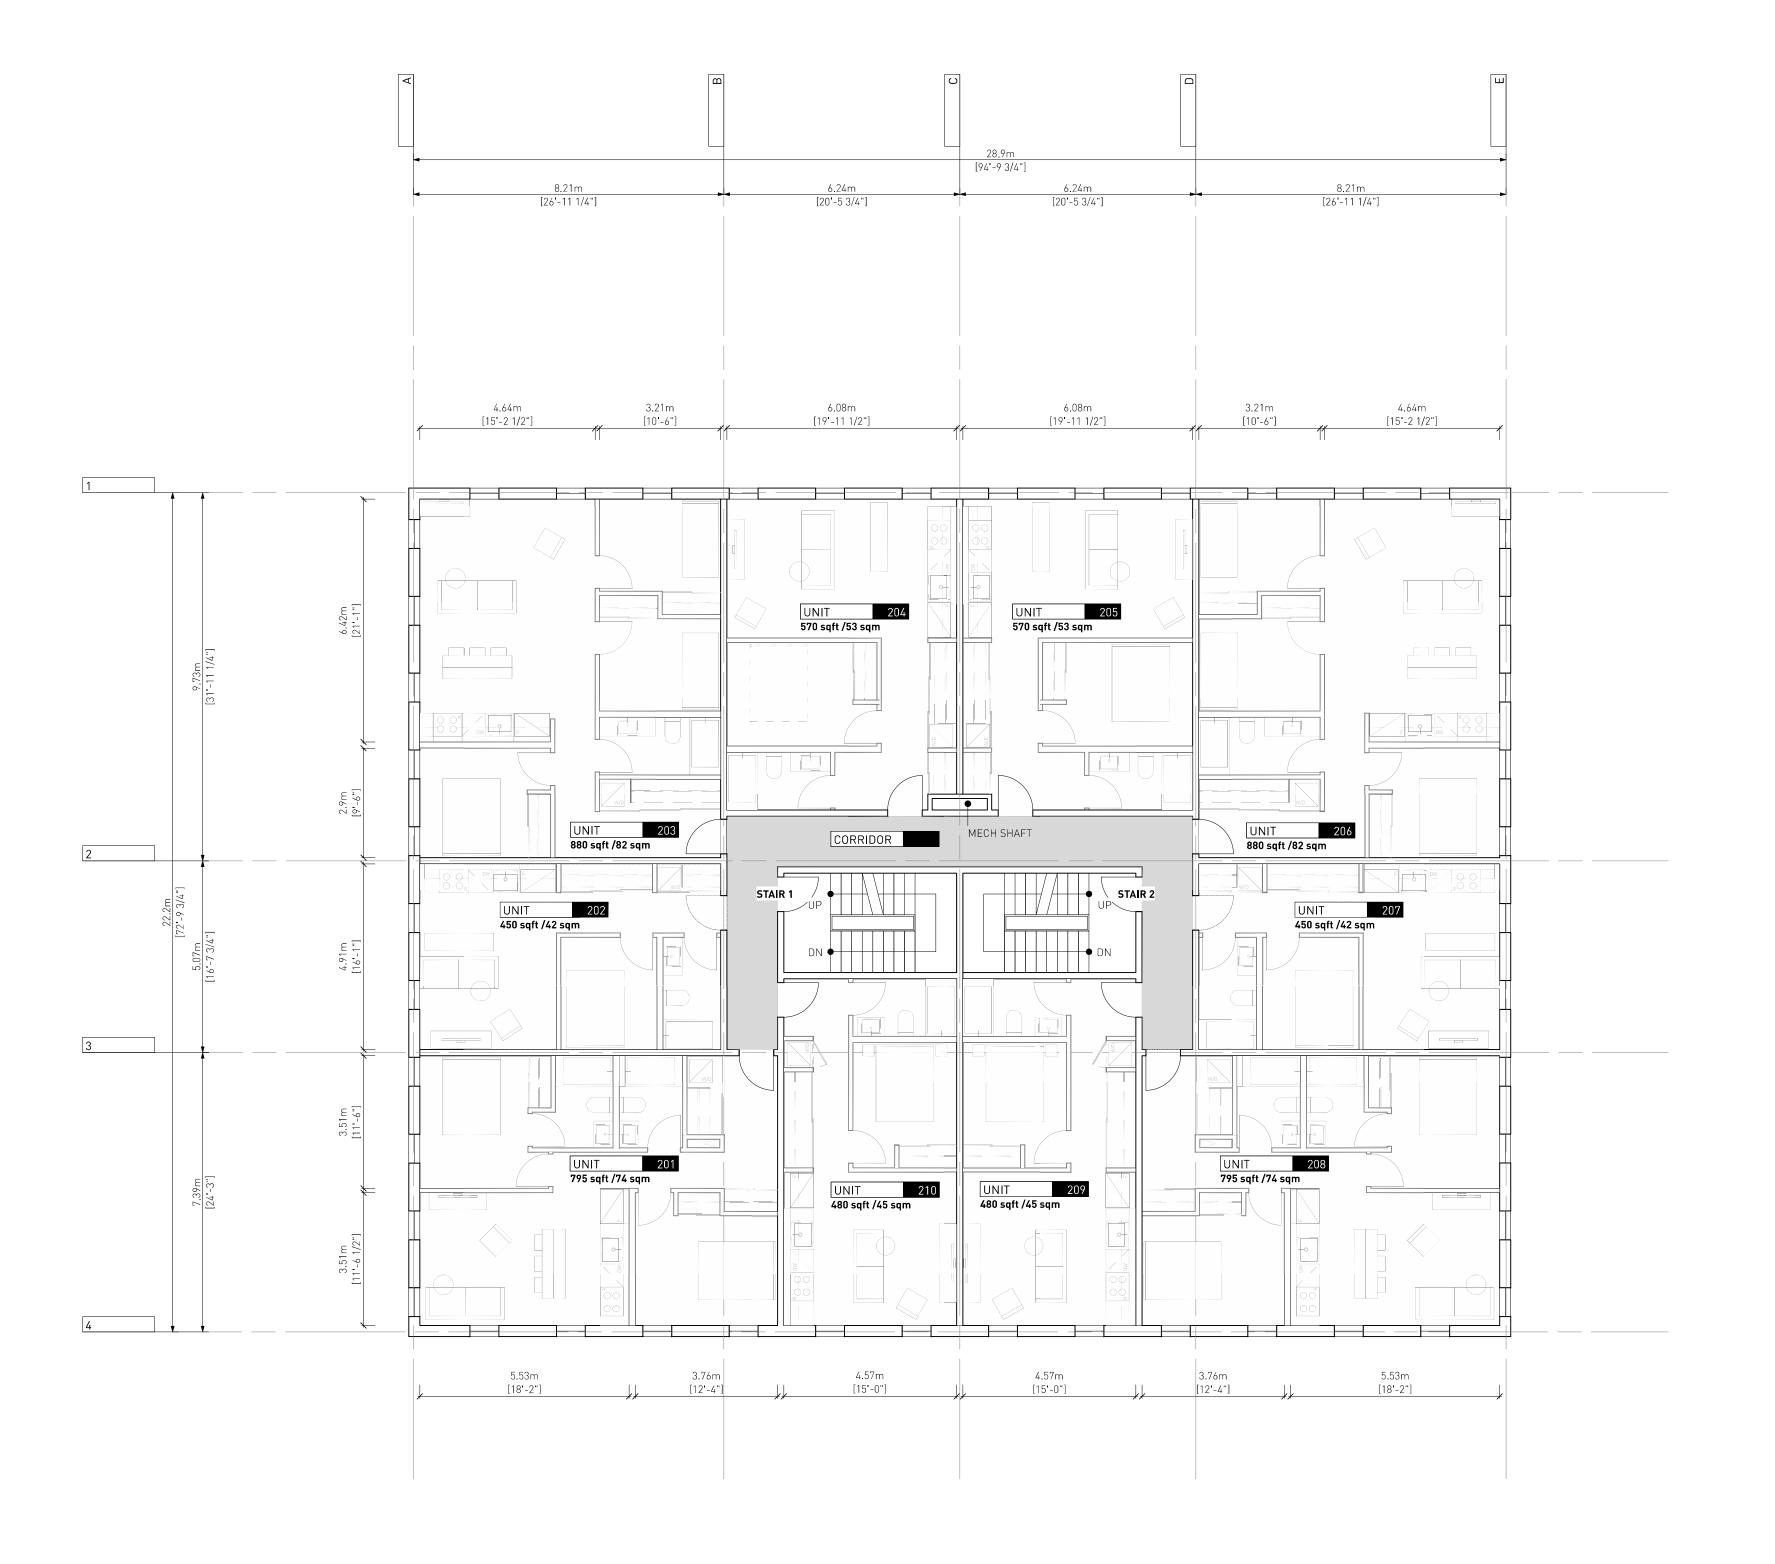

14.07.2023

EA CN / PB 14.07.2023

Drawn By: Checked By: Printing Date:

The Contractor shall verify all dimensions, datums and levels prior to commencement of work.

All errors and omissions to be reported to the Architect before proceeding.


This drawing must not be scaled.

This drawing is the property of the Architect; the copyright in same being reserved to him/her. It is

Any unauthorized alteration of the electronic data which constitute this document will void all responsibility for the altered document by the

Architect.

__T<u>his_drawing is not to be used for building</u>__ purposes until countersigned by:

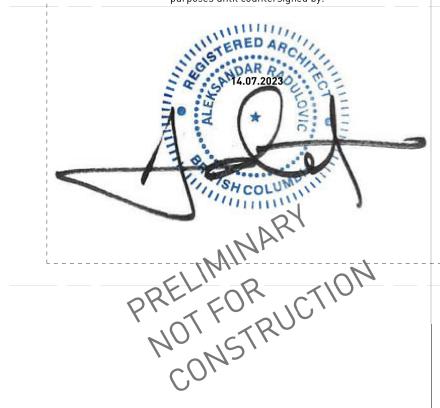



266 MCDERMOT AVE Winnipeg MB R3B 0S8 P: 204.480.8421 F: 204.480.8876

822 CATHERINE STREET + 304 LANGFORD STREET


VICTORIA, BC


LEVEL 02 / 03 PLAN

A1.3

Sheet



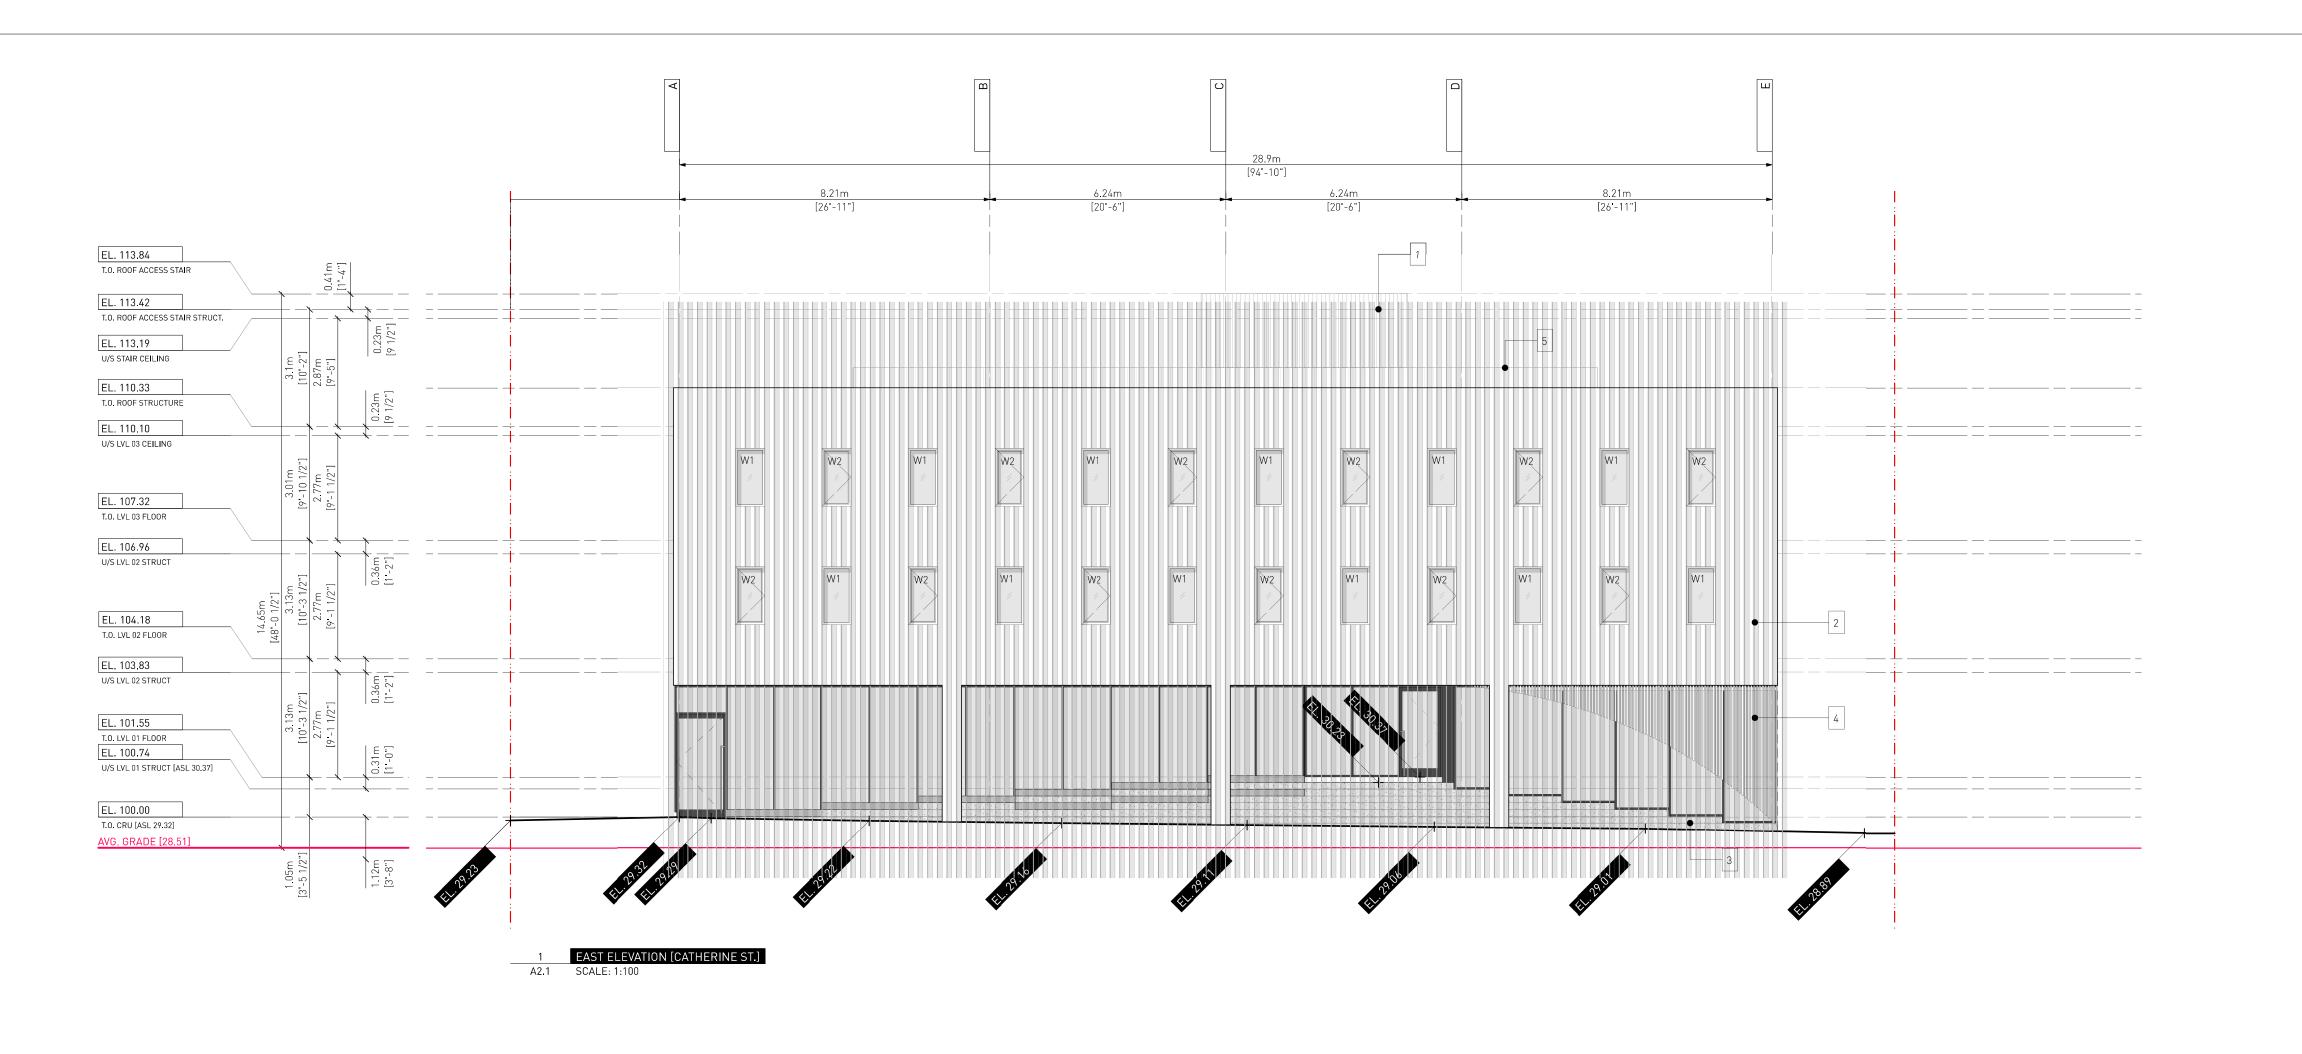


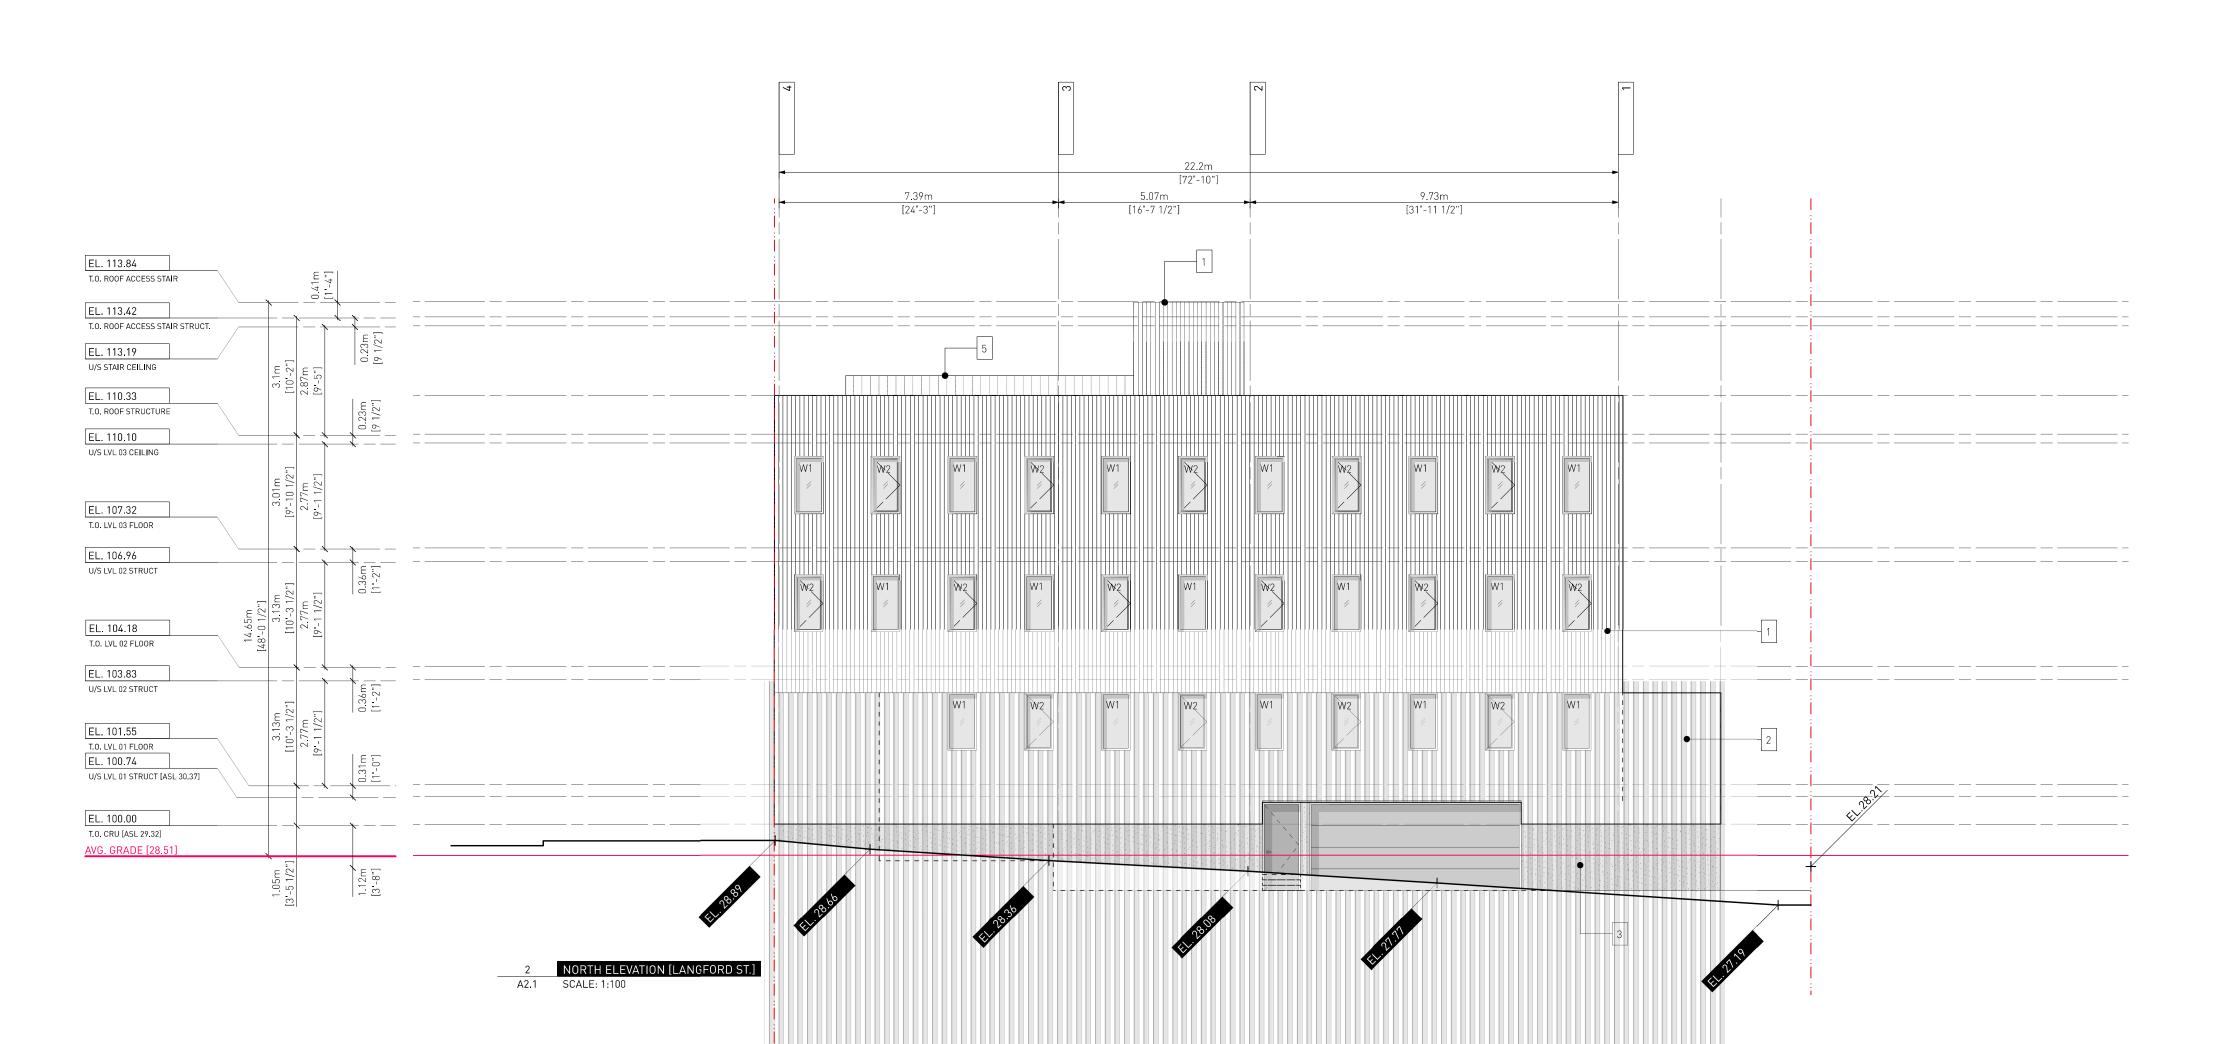





LEGEND:

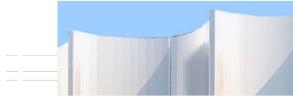

2 CUSTOM CURVED METAL CLADDING





3 CONCRETE



4 WOOD SOFFIT / WALL FEATURE



5 METAL PICKET GUARDRAIL

1 ISSUED FOR DP

Drawn By: Checked By: Printing Date:

The Contractor shall verify all dimensions, datums and levels prior to commencement of work.

14.07.2023

AR/ JY CN / PB 14.07.2023


All errors and omissions to be reported to the Architect before proceeding.

This drawing must not be scaled.

This drawing is the property of the Architect; the copyright in same being reserved to him/her. It is not to be reproduced without his/her permission.

Any unauthorized alteration of the electronic data which constitute this document will void all responsibility for the altered document by the Architect.

This drawing is not to be used for building purposes until countersigned by:

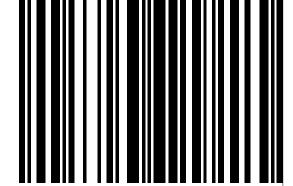


5 4 6 8 7 9 6 ARCHITECTURE INC 266 MCDERMOT AVE Winnipeg MB R3B 0S8 P: 204.480.8421 F: 204.480.8876

822 CATHERINE STREET + 304 LANGFORD STREET

VICTORIA, BC

BUILDING ELEVATIONS

A2.1

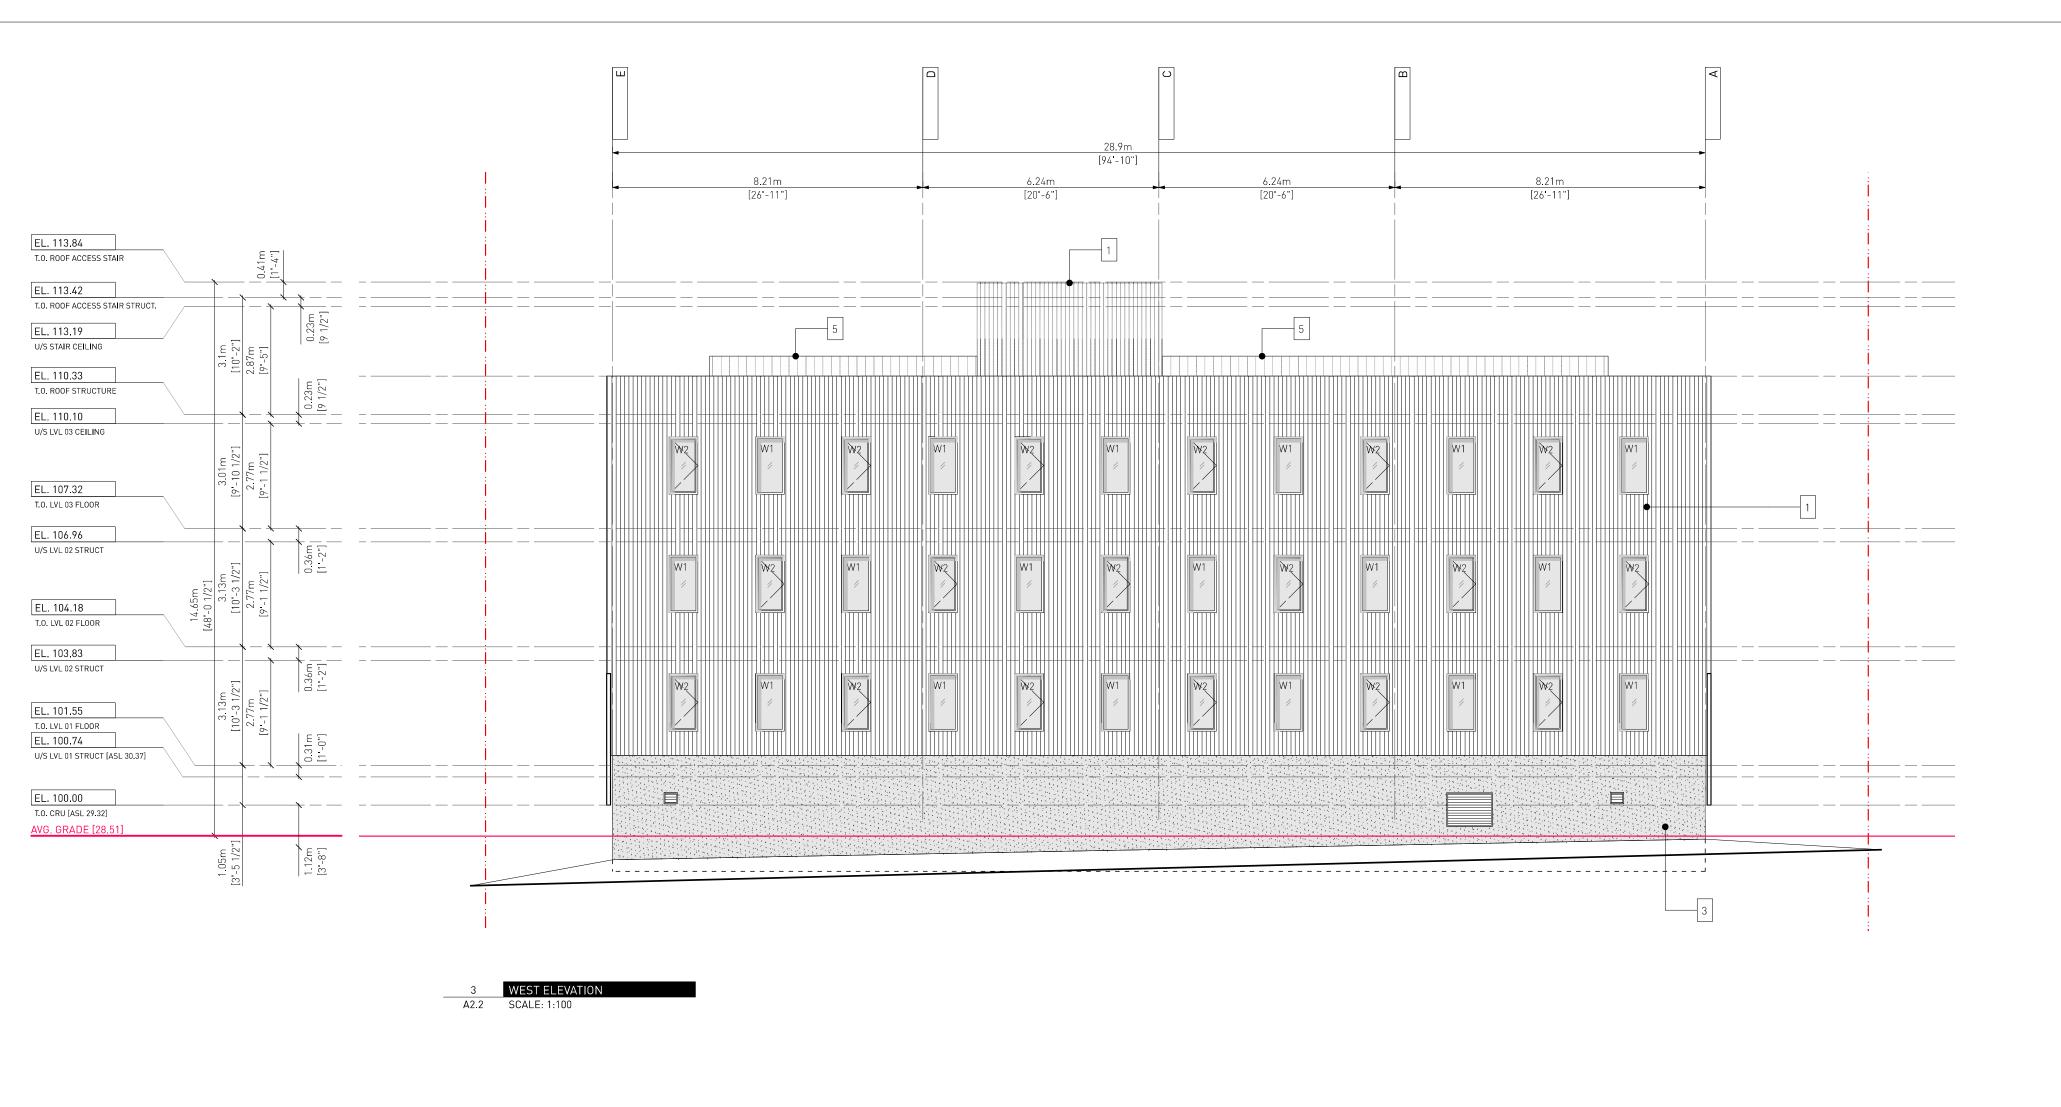







LEGEND:



2 CUSTOM CURVED METAL CLADDING





3 CONCRETE







5 METAL PICKET GUARDRAIL

1 ISSUED FOR DP 14.07.2023



The Contractor shall verify all dimensions, datums and levels prior to commencement of work.


All errors and omissions to be reported to the Architect before proceeding.

This drawing must not be scaled.

This drawing is the property of the Architect; the copyright in same being reserved to him/her. It is not to be reproduced without his/her permission.

Any unauthorized alteration of the electronic data which constitute this document will void all responsibility for the altered document by the Architect.

This drawing is not to be used for building purposes until countersigned by:

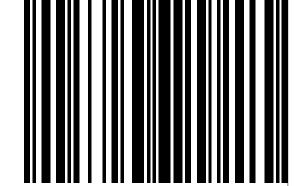

5 4 6 8 7 9 6 ARCHITECTURE INC 266 MCDERMOT AVE Winnipeg MB R3B 0S8 P: 204.480.8421 F: 204.480.8876


822 CATHERINE STREET + 304 LANGFORD STREET


VICTORIA, BC

BUILDING ELEVATIONS

A2.2

Sheet

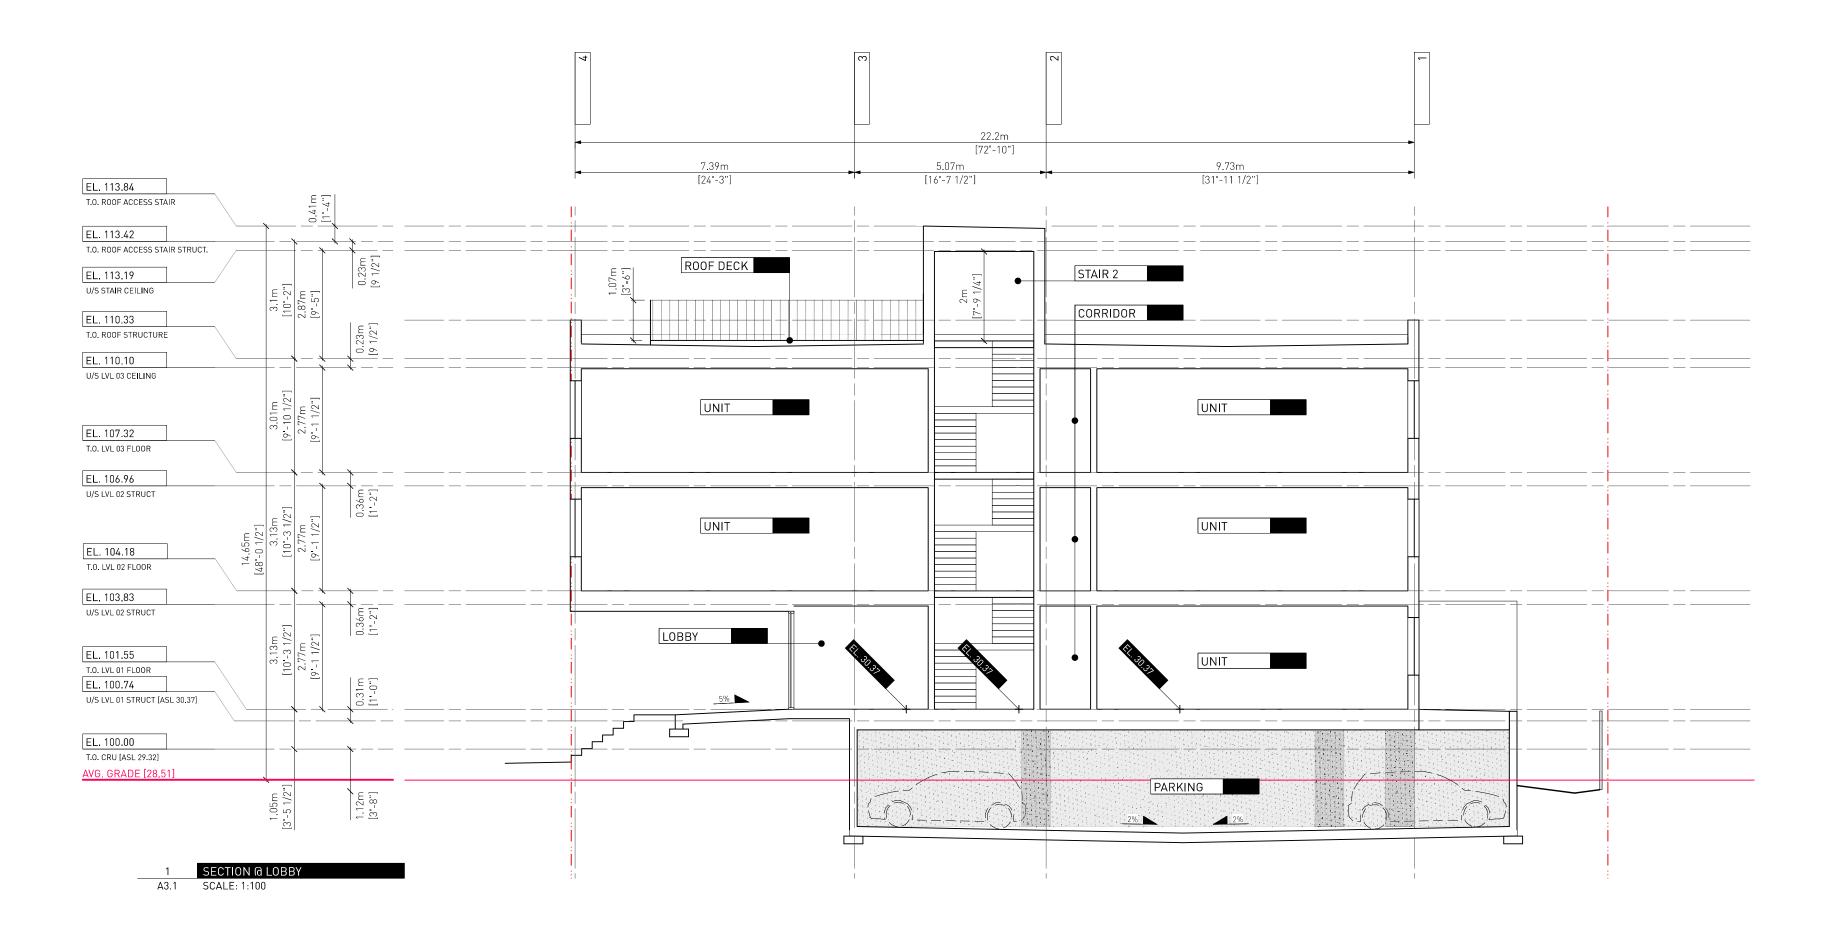

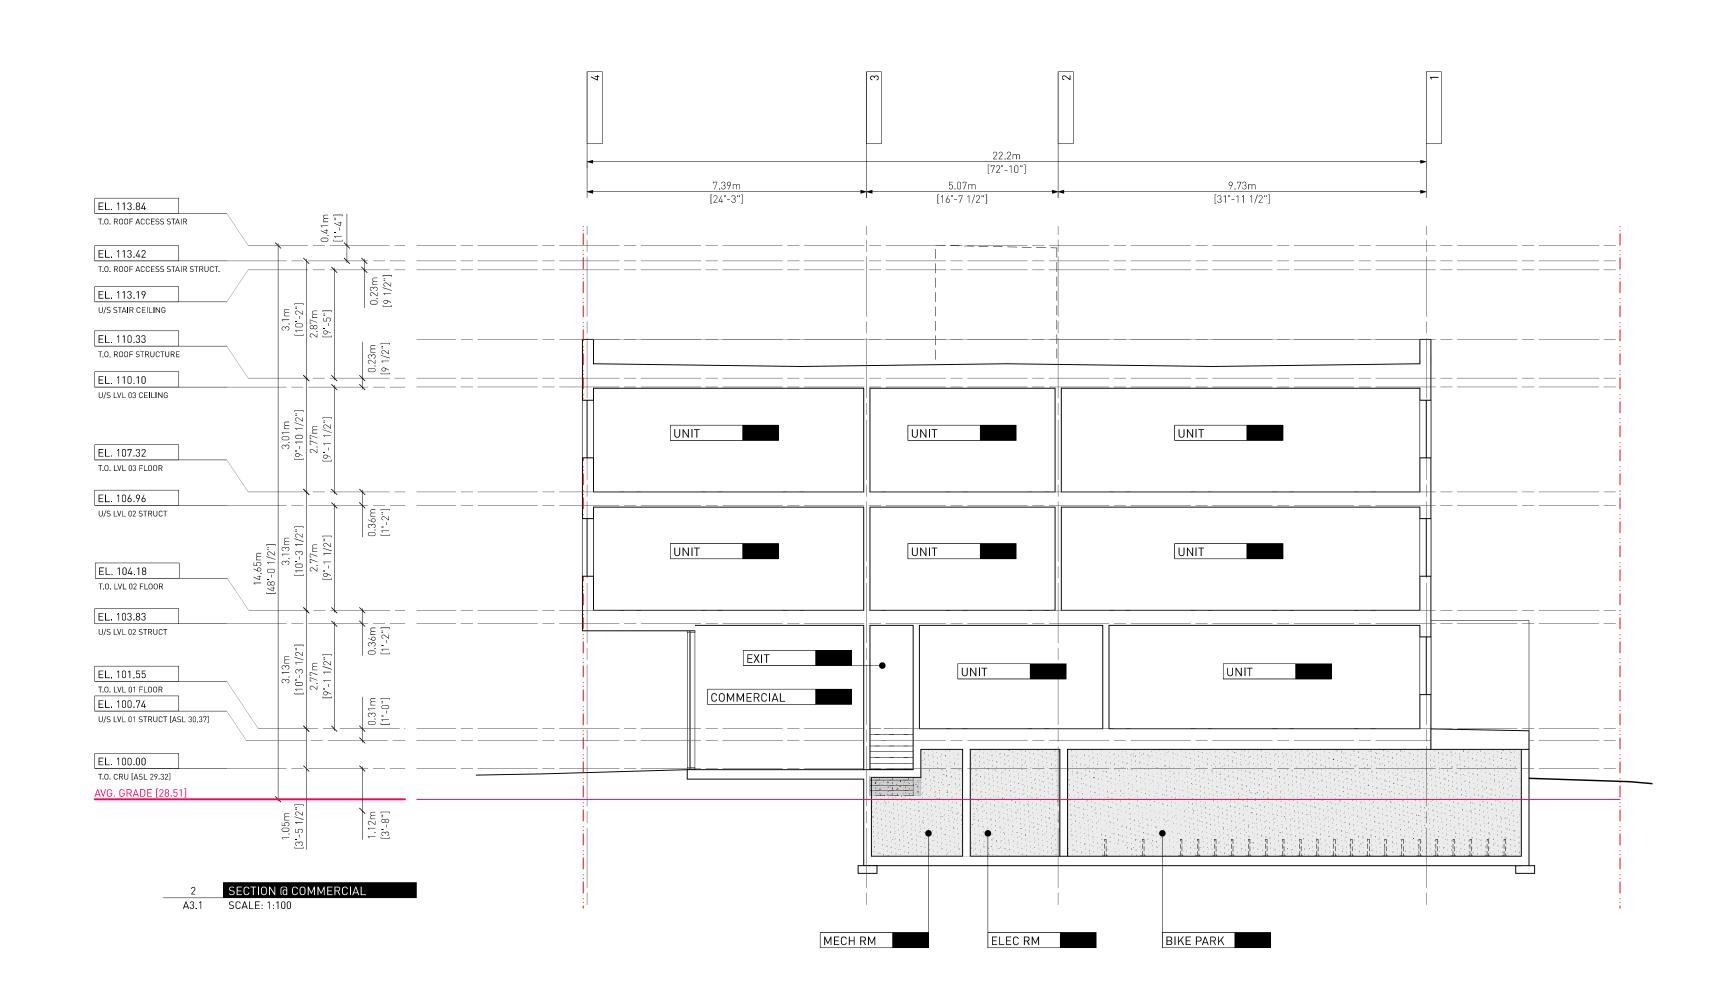

Drawn By: Checked By: Printing Date: AR/ JY CN / PB 14.07.2023

14.07.2023

The Contractor shall verify all dimensions, datums and levels prior to commencement of work.

All errors and omissions to be reported to the Architect before proceeding.


This drawing must not be scaled.

This drawing is the property of the Architect; the

copyright in same being reserved to him/her. It is not to be reproduced without his/her permission. Any unauthorized alteration of the electronic data

which constitute this document will void all responsibility for the altered document by the Architect.

_ <u>This drawing is not to be used for building</u> _ purposes until countersigned by:

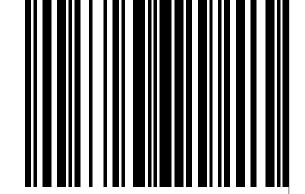

266 MCDERMOT AVE Winnipeg MB R3B 0S8 P: 204.480.8421 F: 204.480.8876


822 CATHERINE STREET + 304 LANGFORD STREET


BUILDING SECTIONS

Sheet A3.1

0646

VICTORIA, BC

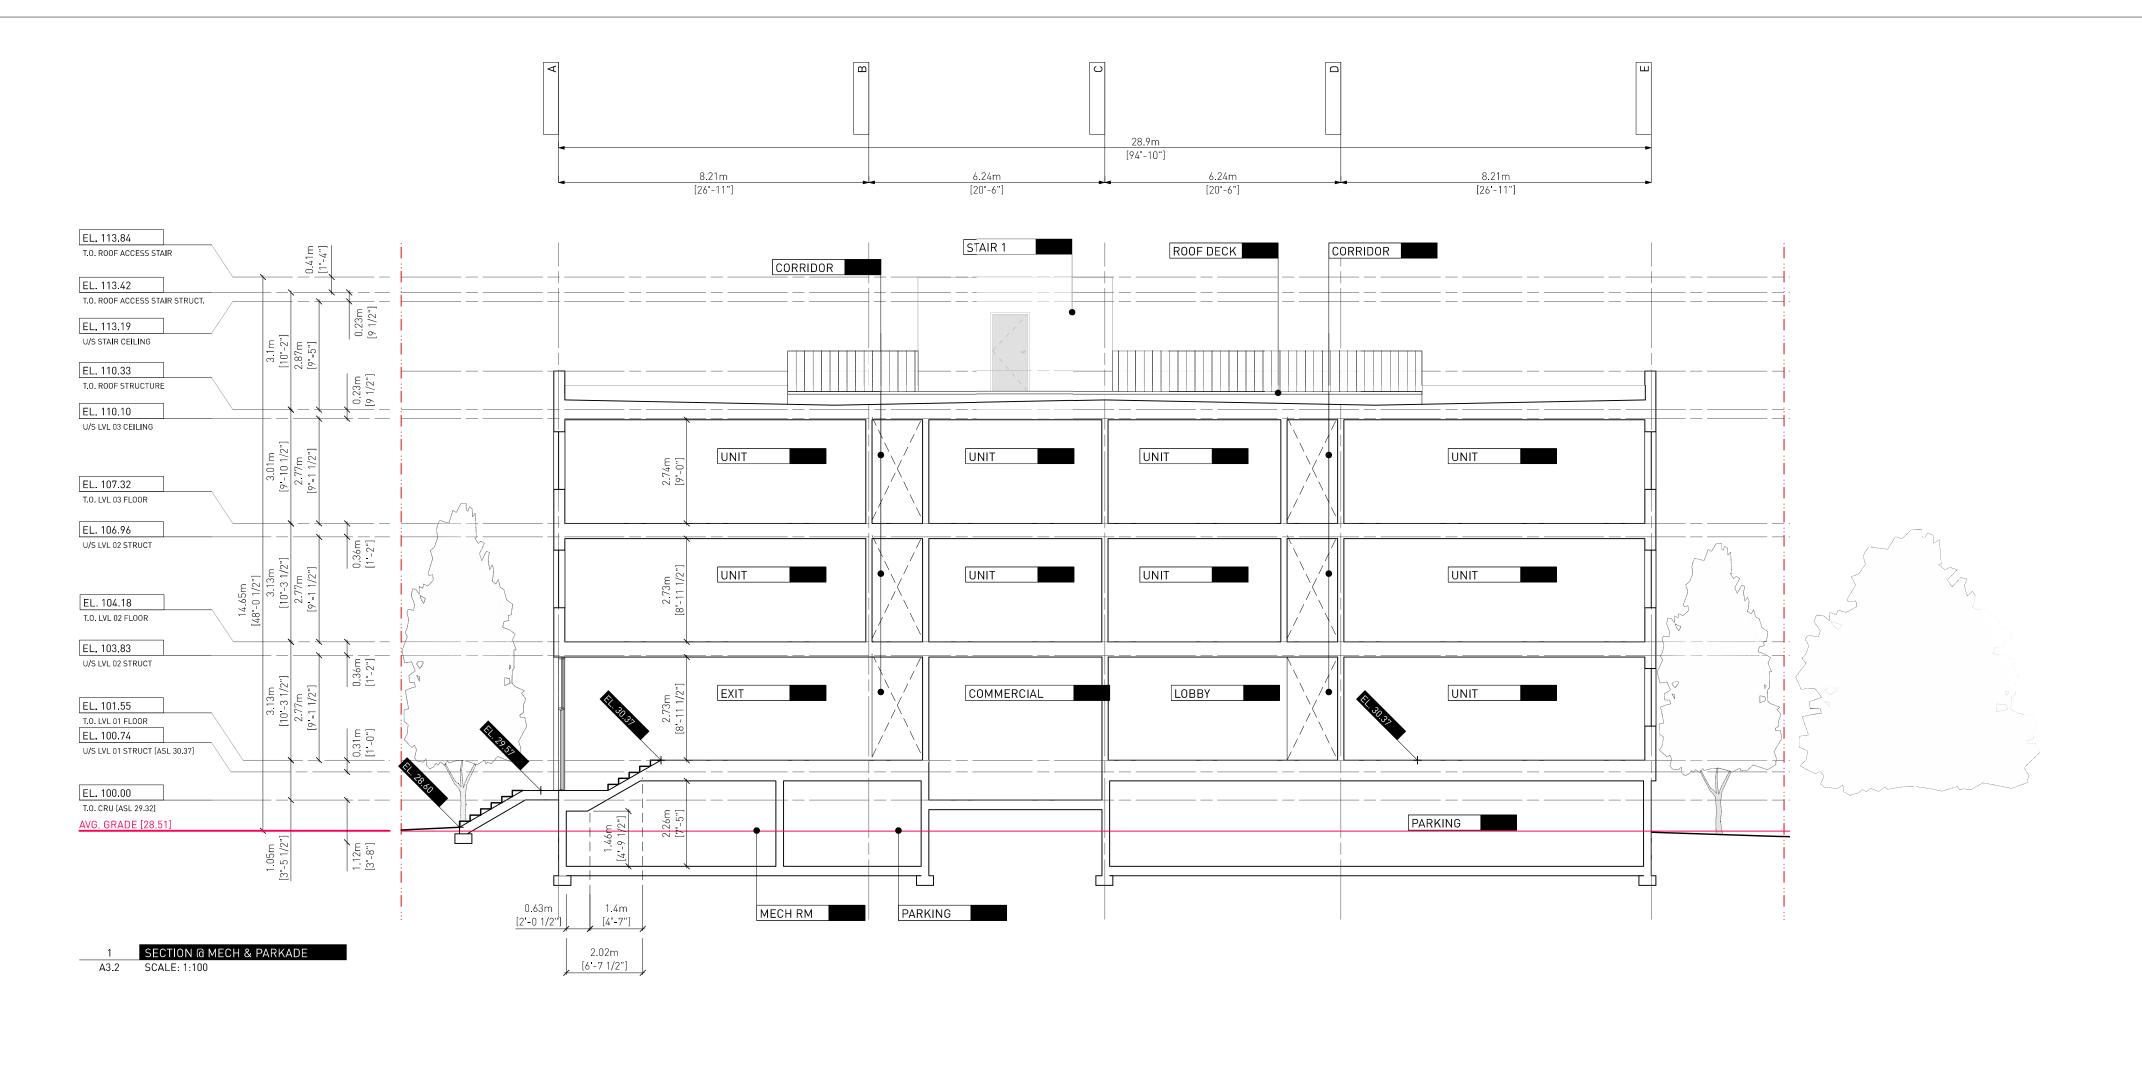

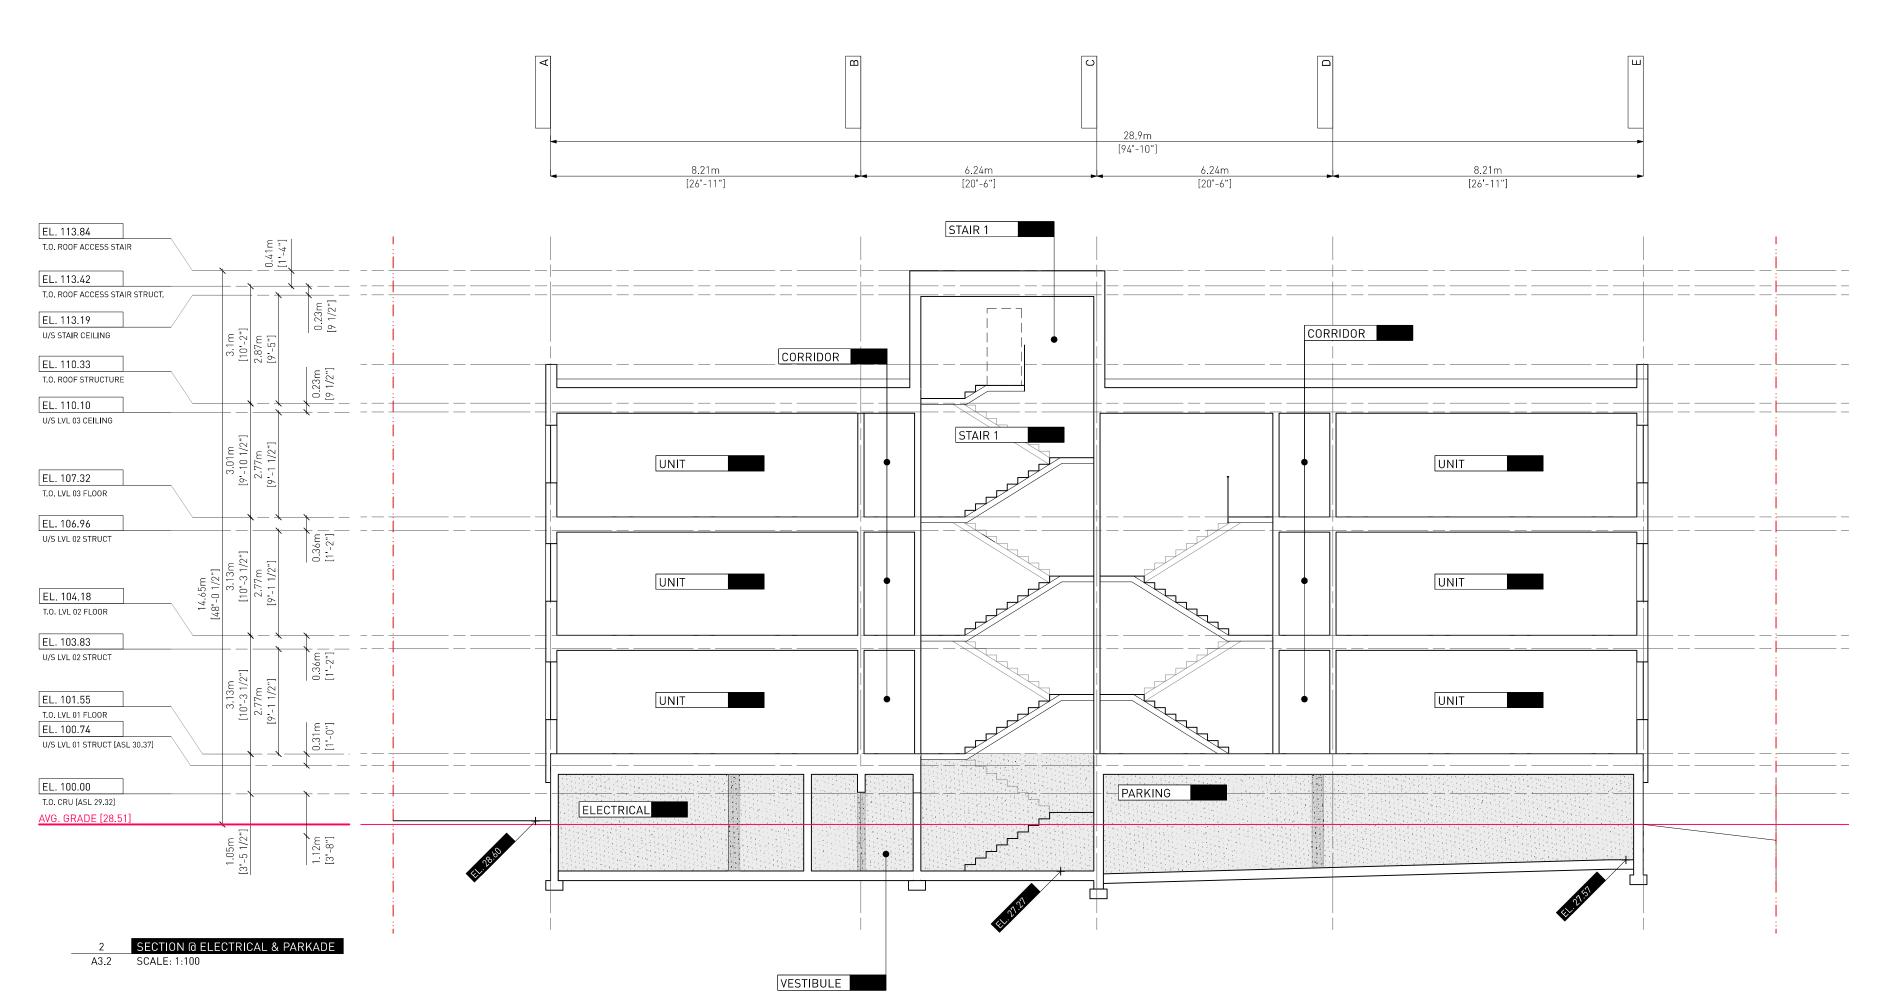

Drawn By: Checked By: Printing Date:

The Contractor shall verify all dimensions, datums and levels prior to commencement of work.

14.07.2023

AR/ JY CN / PB 14.07.2023

All errors and omissions to be reported to the Architect before proceeding.

This drawing must not be scaled.

This drawing is the property of the Architect; the

copyright in same being reserved to him/her. It is not to be reproduced without his/her permission.


Any unauthorized alteration of the electronic data which constitute this document will void all responsibility for the altered document by the Architect.

This drawing is not to be used for building purposes until countersigned by:

14.07.2023

PRELIFOR UCTION

CONSTRUCTION

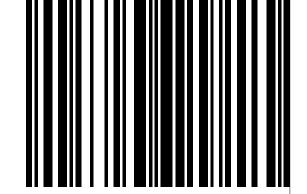


822 CATHERINE STREET + 304 LANGFORD STREET


VICTORIA, BC

BUILDING SECTIONS

Sheet

A3.2

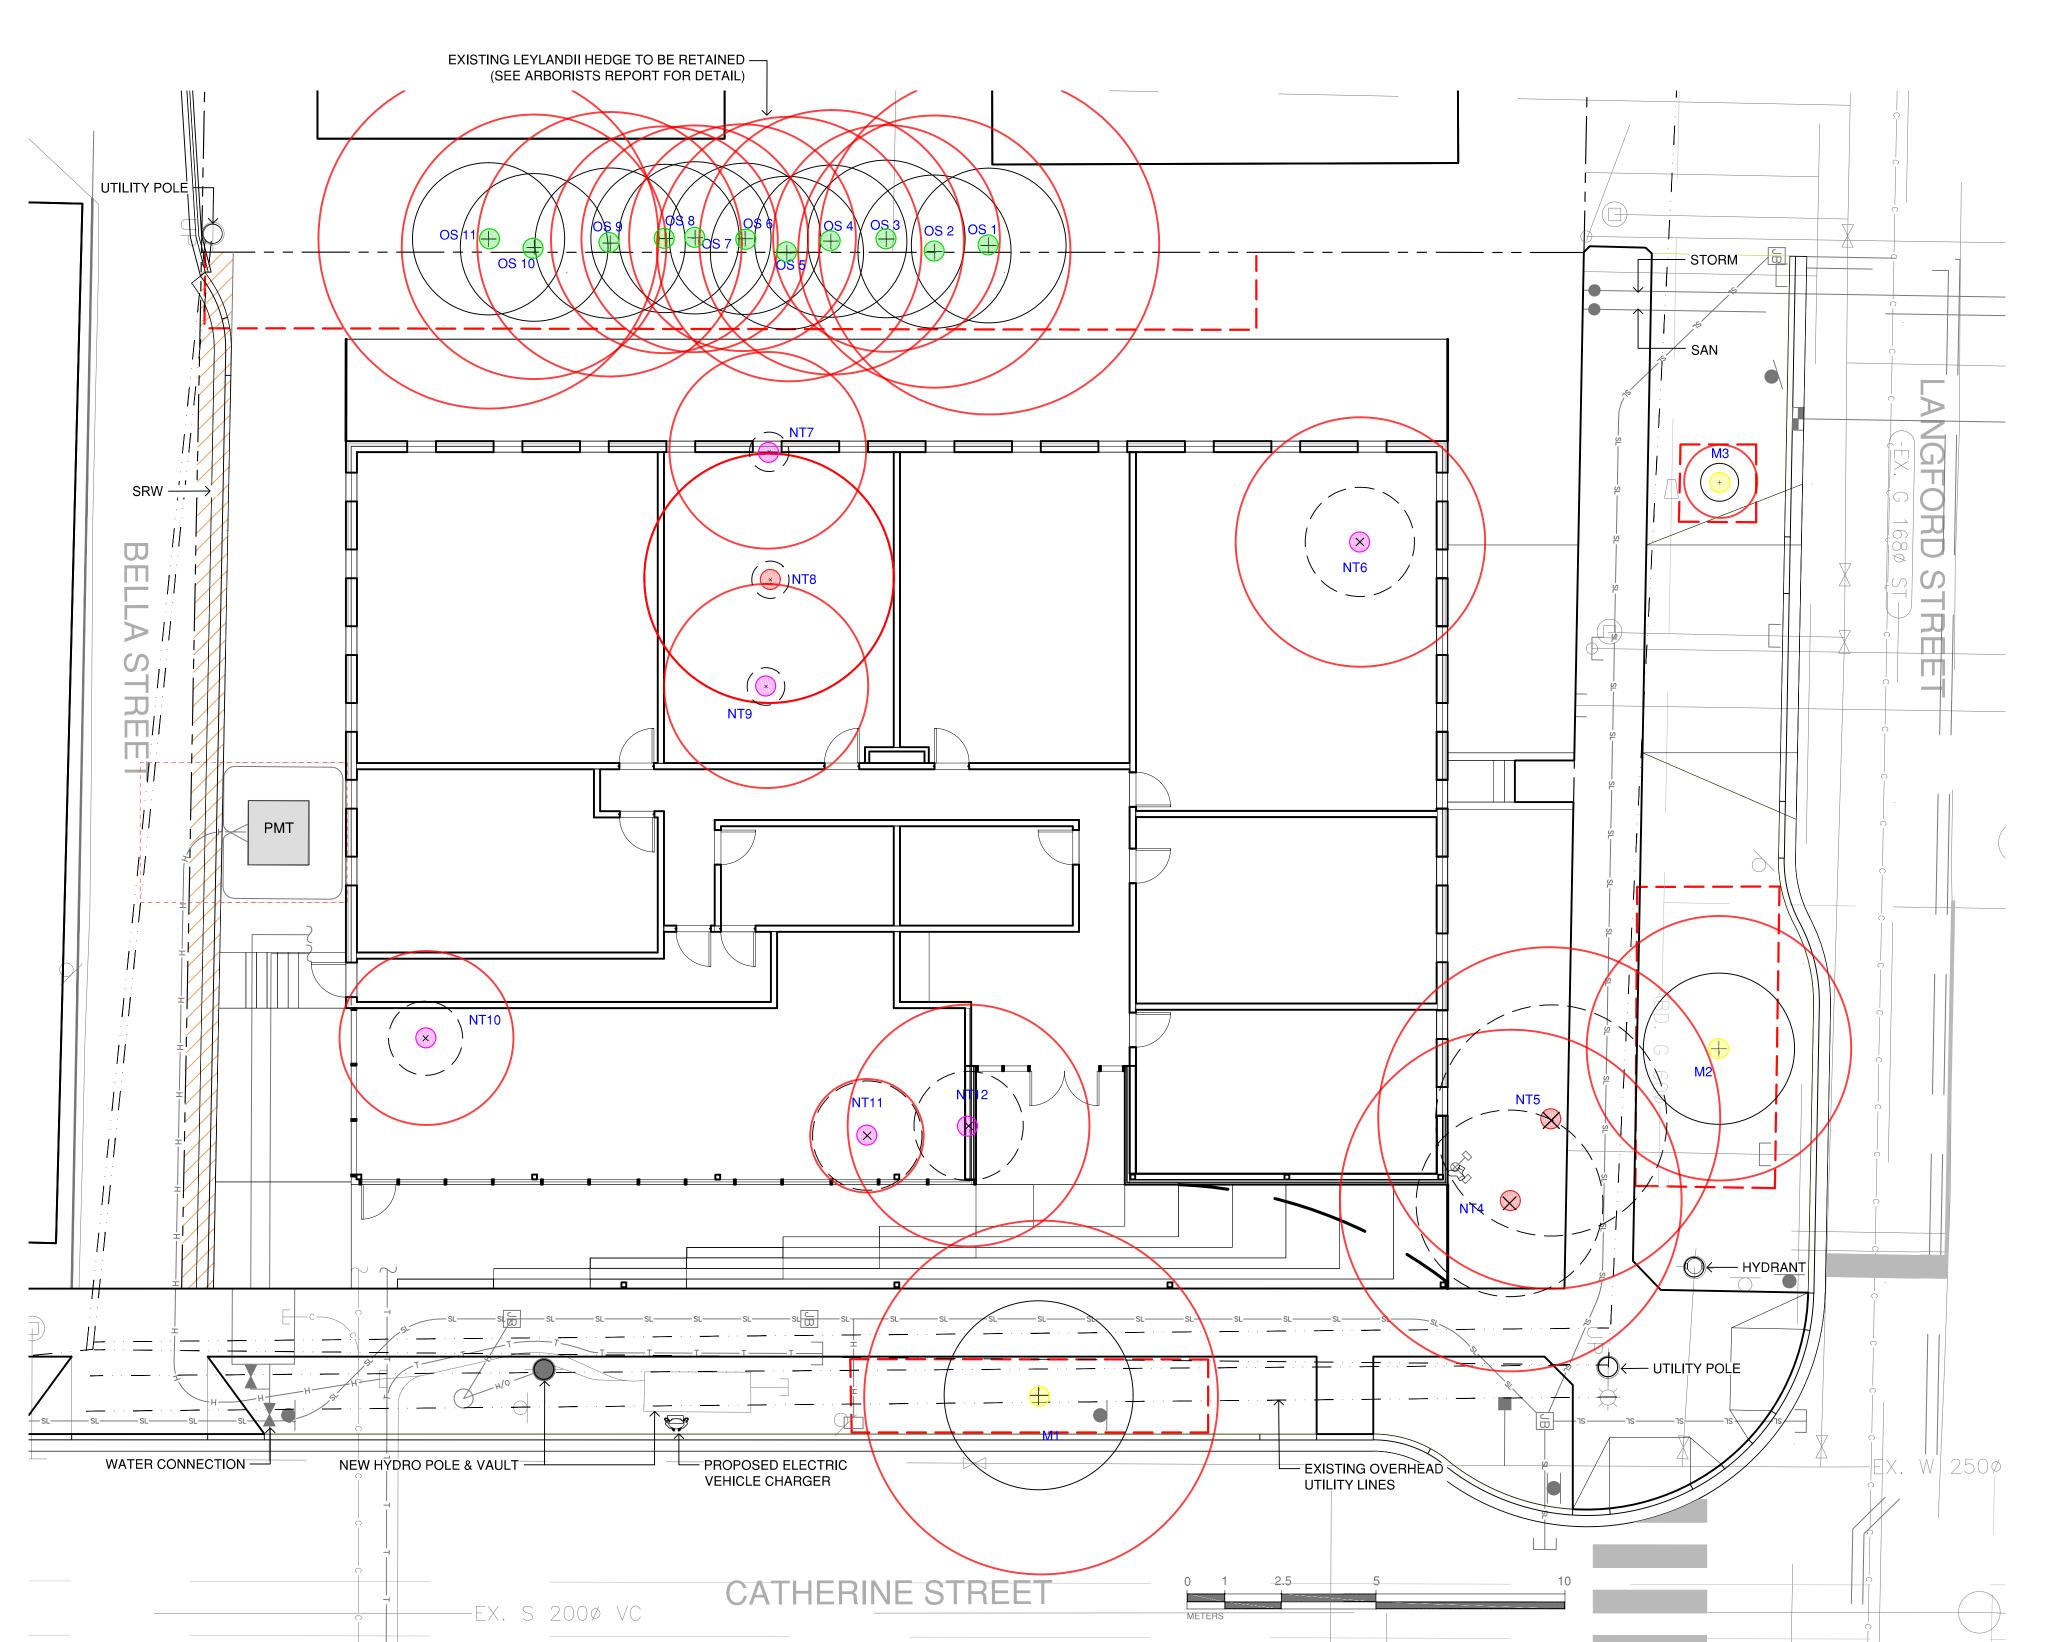

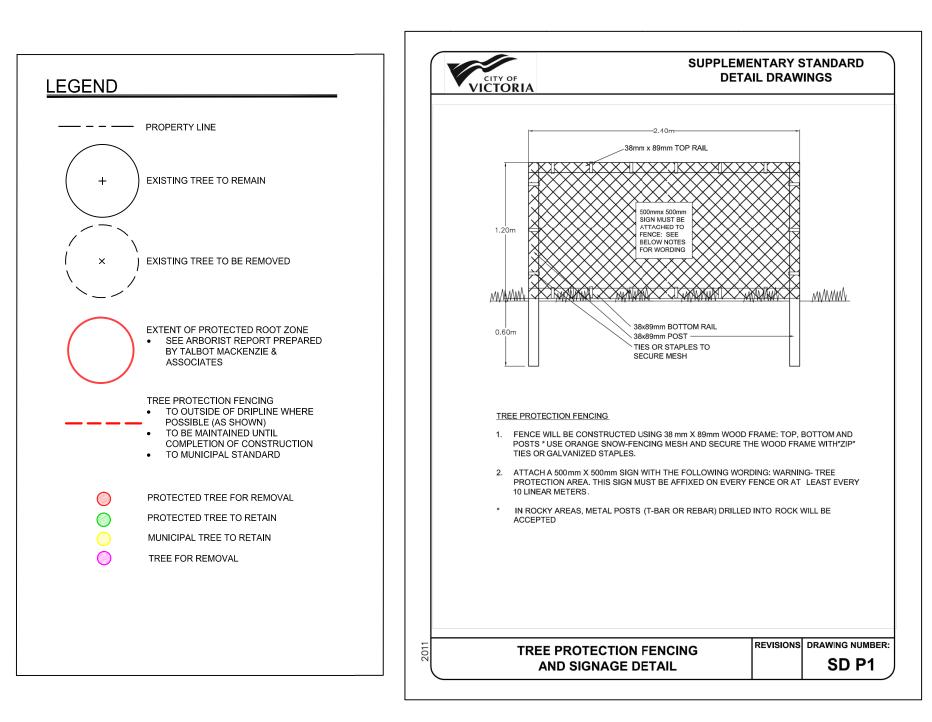

Inventory date: September 17, 2020 | November 1, 2021

rev.	Tagler	Surveyed ?	Location (On, Off, Shared,	Bylaw protected ?	Name		dbh	Critical root zone radius	Dripline diameter	Condition		Retention Suitability	Relative	General field	Tree retention / location	Retenti
ag#		(Yes/No)	City)	(Yes/No)	Common	Botanical	(cm)	(m)	(m)	Health	Structural	(onsite trees)		observations/remarks	comments	status
IT1	M1	Yes	Municipal	Municipal	Cherry Plum	Prunus cerasifera	39	4.7	5	Fair-poor	Fair-poor		Moderate	Dieback, decay in 2 of 4 scaffold limbs.	May be impacted by sidewalk construction. Municipal ID# 32333.	Retain
IT2	M2	Yes	Municipal	Municipal	Cherry Plum	Prunus cerasifera	32	3.8	4	Fair	Fair		Moderate	Canopy competition with NT4.	Municipal ID# 32334.	Retain
Т3	М3	Yes	Municipal	Municipal	Cherry Plum	Prunus cerasifera	2	1	1	Fair	Fair		Moderate	Newly planted.	Municipal ID# 32335.	Retain
	NT4	Yes	On-site	Yes	English Holly	llex aquifolium	21,21,1 9	4.5	5	Fair	Fair	Suitable	Good	Fill and green waste in CRZ.	Conflict with building footprint.	x
	NT5	Yes	On-site	Yes	European Hawthorn	Crataegus monogyna	~30,25	4.5	6	Fair	Fair	Suitable	Good	Pruning stubs, sapsucker damage.	Conflict with building footprint.	x
	NT6	Yes	On-site	No	Chinese Juniper	Juniperus chinensis	22	3.3	4	Fair	Fair	Suitable	Poor	Codominant leaders, sparse foliage. Close proximity to existing building.	Within building footprint.	x
	NT7	Yes	On-site	No	Pyramidal Cedar	Thuja occidentalis	9,8,8,7, 3,3	2.6	1	Fair	Fair	Suitable	Good	Maintained as shrub.	Within building footprint.	x
	NT8	Yes	On-site	Yes	Pyramidal Cedar	Thuja occidentalis	11,11,7 ,7,6,6	3.3	1	Fair	Fair	Suitable	Good	Maintained as shrub.	Within building footprint.	x
	NT9	Yes	On-site	No	Pyramidal Cedar	Thuja occidentalis	12,11,6 ,4,4	2.7	1	Fair	Fair	Suitable	Good	Maintained as shrub.	Within building footprint.	x
	NT10	Yes	On-site	No	English Holly	llex aquifolium	23	2.3	2	Fair-poor	Fair-poor	Suitable	Good	Pruning stubs, topped historically, new leaders.	Within building footprint.	x
	NT11	Yes	On-site	No	English Holly	llex aquifolium	15	1.5	3	Fair	Fair	Suitable	Good	Deflected trunk, close proximity to existing building.	Within building footprint.	x
	NT12	Yes	On-site	No	Chinese Juniper	Juniperus chinensis	21	3.2	3	Fair-poor	Fair-poor	Suitable	Poor	Multiple leaders, sparse foliage.	Within building footprint.	x

822 Catherine Street - Tree Resource Spreadsheet



1608 Camosun Street, Victoria BC V8T 3E6 Info@biophiliacollective.ca 250 590 1156

OWNER/CLIENT: ARYZE

PROJECT NAME:

822 CATHERINE STREET+ 304 LANGFORD STREET

PROJECT ADDRESS:

822 CATHERINE ST. VICTORIA, BC

DESIGNED BY: BIANCA BODLEY DRAWN BY: OLIVIA LYNE

9	DEVELOPMENT PERMIT	2023-07-14	
8	ISSUED FOR BUILDING PERMIT	22\10\05	
7	ISSUED FOR DDP	22\10\05	
6	ISSUED FOR 50% DD REVIEW	22\06\17	
5	REVISED AND RE-ISSUED FOR RZ/DP	22\06\02	
4	ISSUED FOR REVIEW SUMMARY RESPONSE 02	22\02\11	
3	ISSUED FOR REVIEW SUMMARY RESPONSE 02	21\11\03	
2	ISSUED FOR TRD RESPONSE	21\07\14	
1	ISSUED FOR RZ/DP	21\05\12	
NO.	ISSUE	YY\MM\DD	



NORTH ARROW




DRAWING TITLE:

TREE REMOVAL & PROTECTION

DWG NO:

SCALE: 1:100

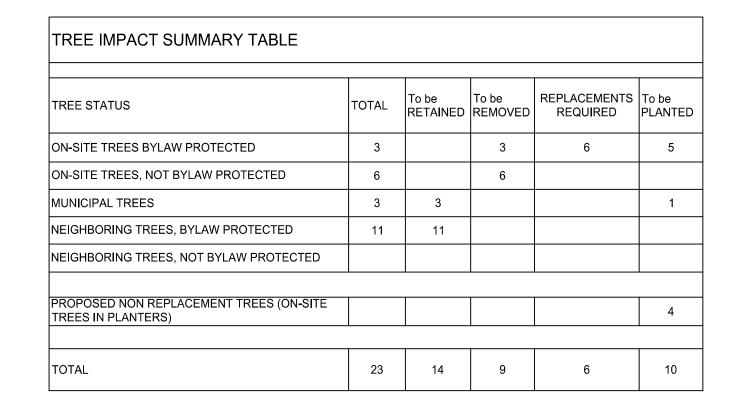


6


0

REPLACEMENT TREES REQUIRED

REPLACEMENT TREES PROPOSED

REPLACEMENT TREE SHORTFALL

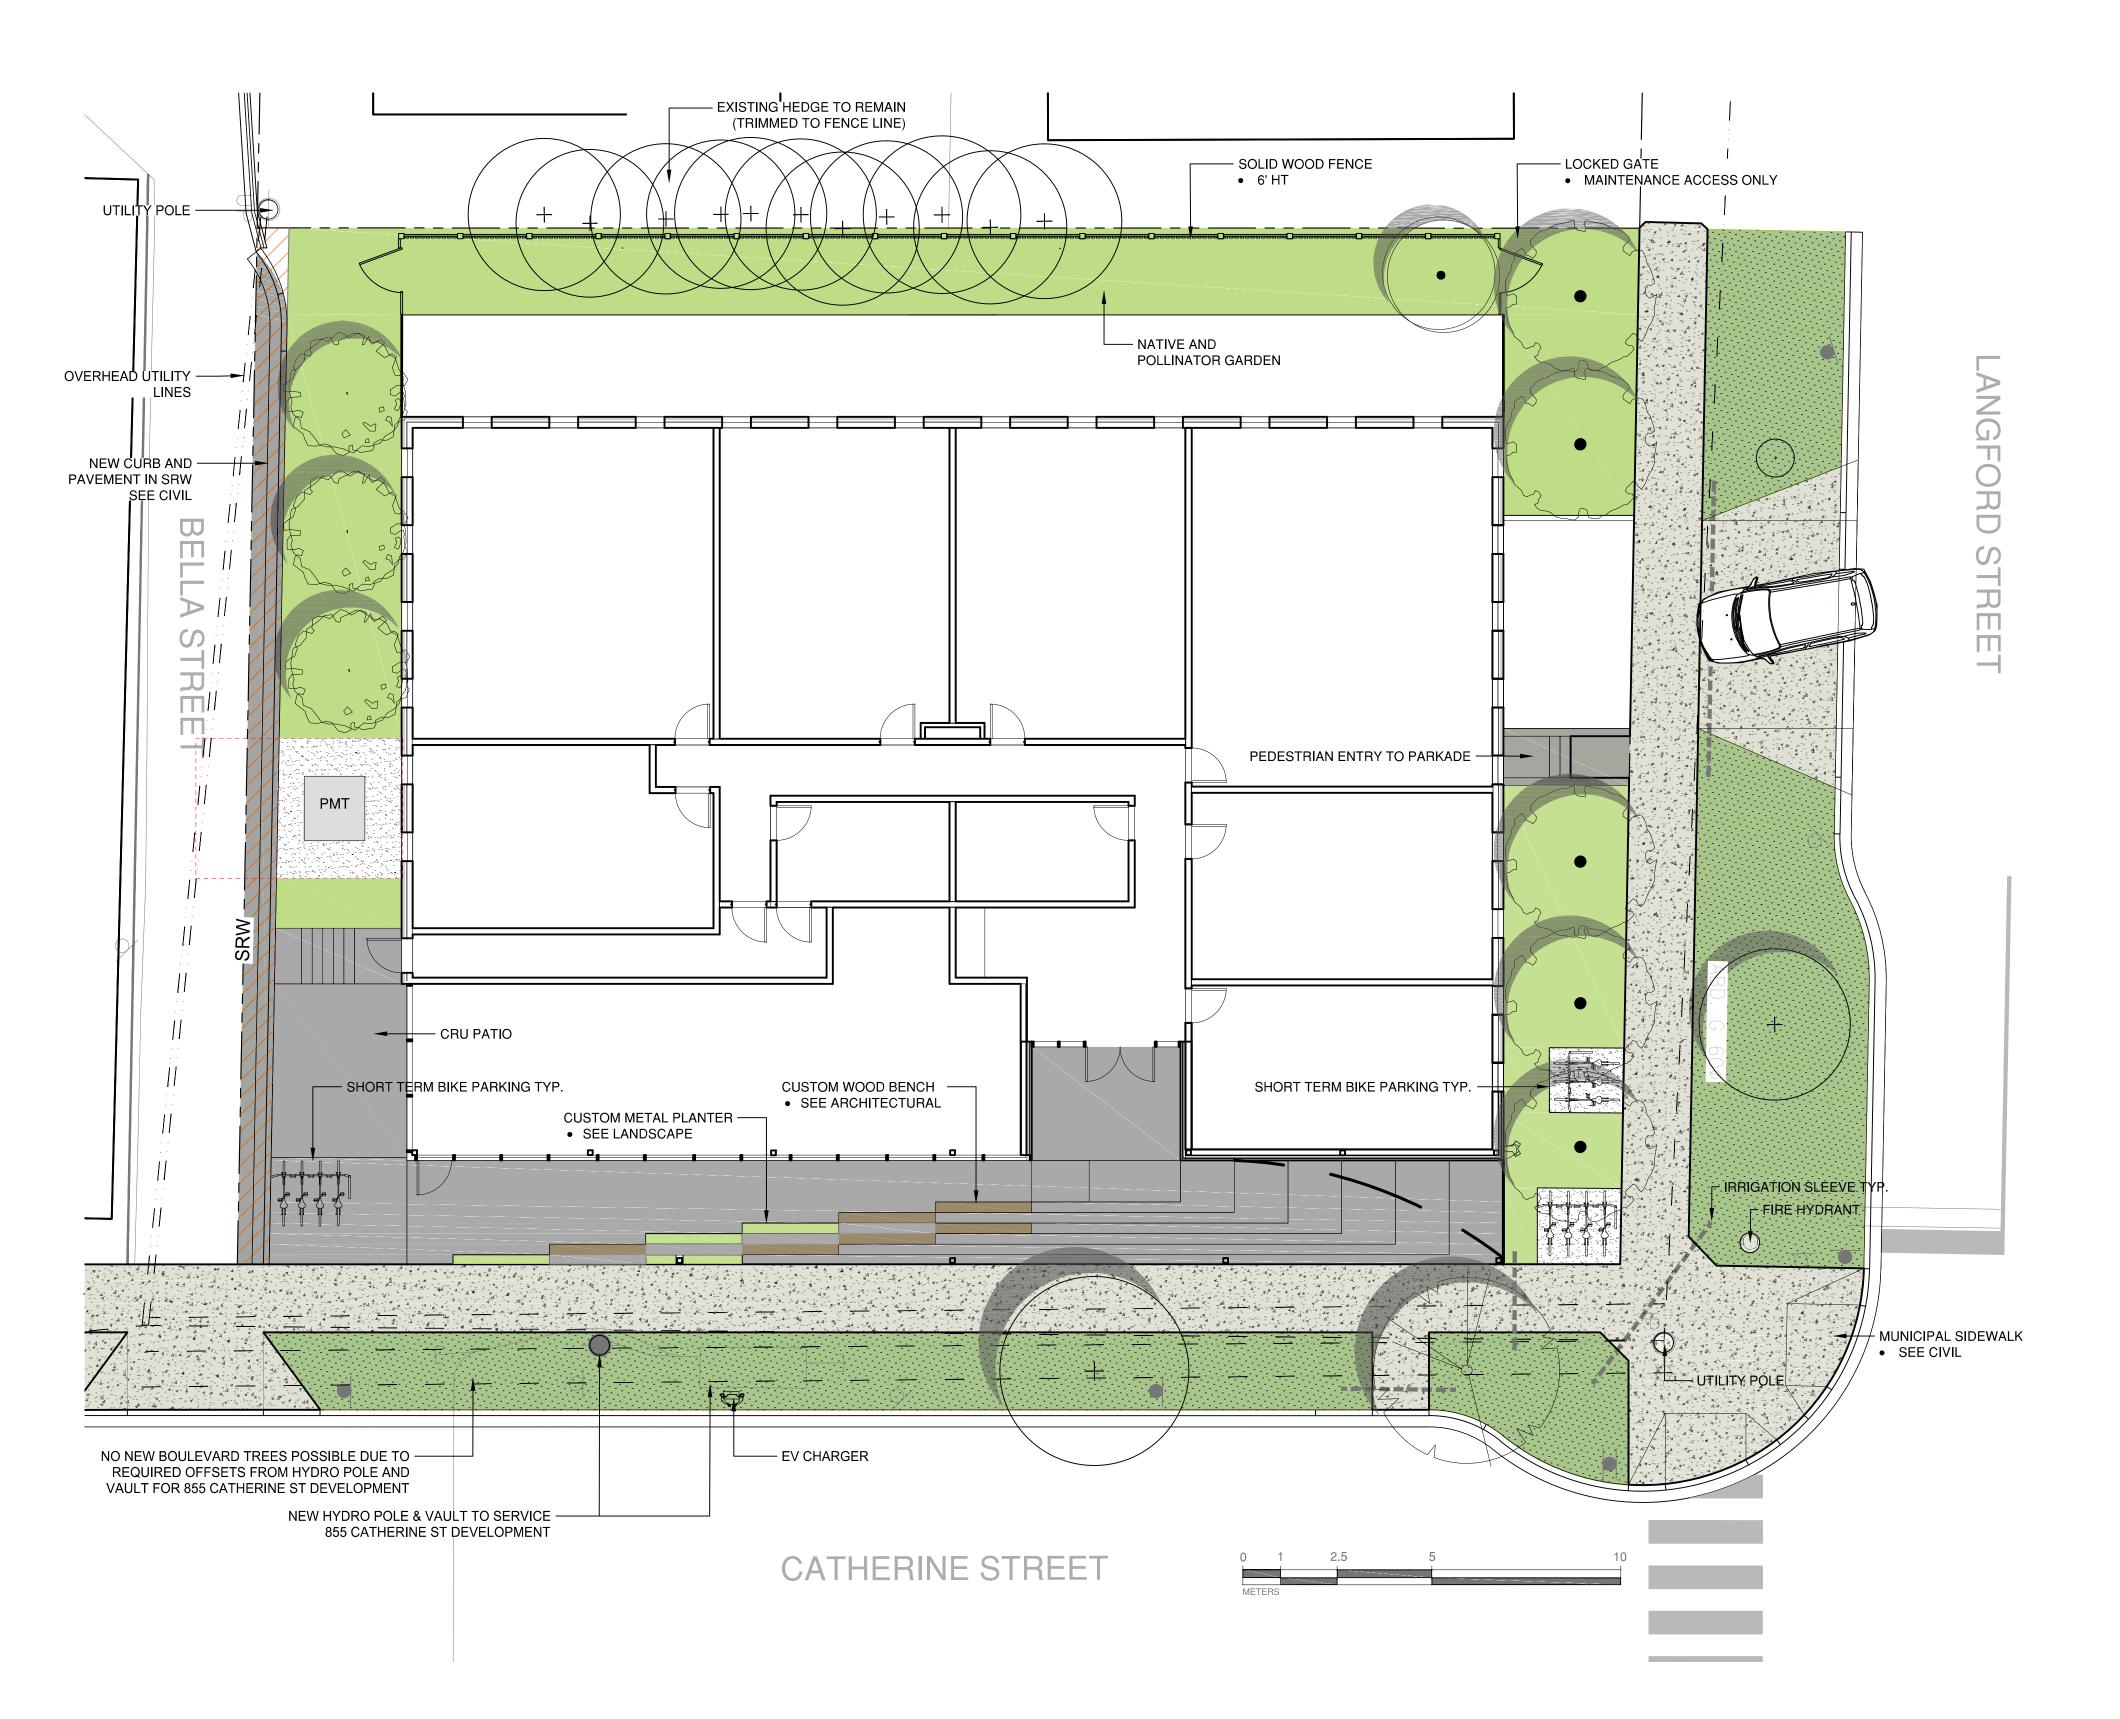

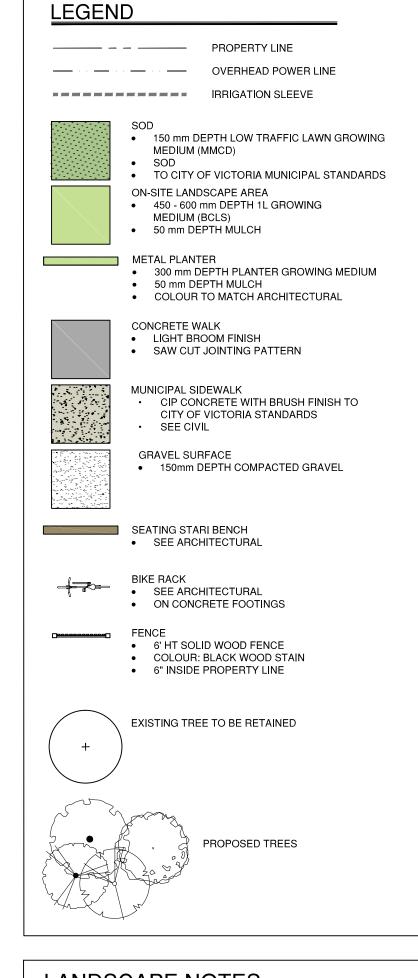



LANDSCAPE NOTES

PROPOSED BOULEVARD TREES

TREE SPECIES TO BE COORDINATED WITH PARKS PRIOR TO PLANTING
 TREES MUST HAVE ONE DOMINANT CENTRAL LEADER OR SINGLE STRAIGHT TRUNK, 5-8 cm DIAMETER, CALIPER

MEASURED 15 cm ABOVE GROUND, WELL BALANCED CROWN WITH BRANCHING STARTING AT 1.8m-2.5m ABOVE GROUND TREES TO BE PLANTED AS PER PLANTIG OF TREES, SHRUBS AND GROUND COVERS (32 93 01 MMCD 2009 AND CITY OF VICTORIA SUPPLEMENTAL DRAWINGS SD P3 AND SD P4)

PARKS WILL REQUIRE (3) INSPECTIONS FOR TREE PLANTING: 1)INSPECTION OF SOIL AND PLANTING AREA, 2) INSPECTION OF STOCK UPON DELIVERY, 3) INSPECTION OF INSTALLED TREE WITH MULCH AND STAKING. TRUNK FLARE MUST BE VISIBLE AND PLANTED AT OR SLIGHTLY ABOVE GRADE UPON INSPECTION. • THE APPLICANT MUST MAINTAIN THE TREE IN GOOD HEALTH AND STRUCTURAL CONDITION FOR 1 YEAR FROM THE

SUBSTANTIAL COMPLETION TO BE ELIGIBLE FOR DEPOSIT RETURN.

BOULEAVARD IRRIGATION

IRRIGATION PLAN TO BE PROVIDED AT BP STAGE.

 ALL IRRIGATION WORK, INCLUDING REQUIRED INSPECTIONS, SHALL FOLLOW THE SUPPLEMENTARY SPECIFICATIONS FOR STREET TREES AND IRRIGATION, SCHEDULE C TO THE VICTORIA SUBDIVISION AND DEVELOPMENT SERVICING BYLAW 12-042, AND COMPLY WITH THE IRRIGATION INDUSTRY ASSOCIATION OF BC STANDARDS.

• IRRIGATION DESIGN SHALL BE SUBMITTED FOR REVIEW AND APPROVAL TO CITY OF VICTORIA PARKS NO LESS THAN 30 DAYS PRIOR TO SCHEDULED INSTALLATION. IRRIGATION INSPECTIONS REQUIRED FOR ALL SLEEVING, OPEN TRENCH MAINLINE AND LATERAL LINES, SYSTEM OPERATION, CONTROLLER, AND BACKFLOW PREVENTER (INCL. INSPECTION TAG AND TESTING REPORT). CALL PARKS AT 250-361-0600 AT LEAST 2 DAYS IN ADVANCE TO ARRANGE FOR IRRIGATION INSPECTIONS.

 THE LANGFORD STREET BOULEVARD LAWN IRRIGATION SYSTEM AND THE NEW STREET TREE ON CATHERINE ST ARE TO BE INSTALLED BY THE DEVELOPPER, AND SHALL BE IRRIGATED FROM A CITY WATER SOURCE AND MAINTAINED BY THE CITY. THE CATHERINE ST BOULEVARD LAWN AREA SHALL BE IRRIGATED FROM A PRIVATE WATER SOURCE UNDER A PERMIT FROM THE CITY ENGINEERING DEPARTMENT. THE MAINTENANCE OF THE CATHERINE BOULEVARD LAWN IS THE RESPONSIBILITY OF THE PROPERTY OWNER AS WOULD BE THE PRIVATE IRRIGATION SYSTEM.

SITE PERMEABILITY

TOTAL SITE PERVIOUS AREA FOR ENTIRE PRIVATE PROPERTY: 180 m2 / 18%



1608 Camosun Street, Victoria BC V8T 3E6 Info@biophiliacollective.ca 250 590 1156

OWNER/CLIENT:

ARYZE

PROJECT NAME:


822 CATHERINE STREET+ 304 LANGFORD STREET

PROJECT ADDRESS:

822 CATHERINE ST. VICTORIA, BC

DESIGNED BY: BIANCA BODLEY DRAWN BY: OLIVIA LYNE

9 DEVELOPMENT PERMIT 2023-07-14 22\10\05 8 ISSUED FOR BUILDING PERMIT 7 ISSUED FOR DDP 22\10\05 6 ISSUED FOR 50% DD REVIEW 22\06\17 5 REVISED AND RE-ISSUED FOR RZ/DP 22\06\02 4 ISSUED FOR REVIEW SUMMARY RESPONSE 02 22\02\11 3 ISSUED FOR REVIEW SUMMARY RESPONSE 02 21\11\03 2 ISSUED FOR TRD RESPONSE 21\07\14 1 ISSUED FOR RZ/DP 21\05\12 NO. ISSUE

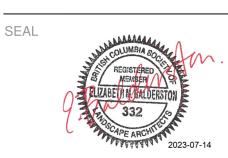


NORTH ARROW




DRAWING TITLE: LANDSCAPE PLAN

DWG NO:

SCALE: 1:100

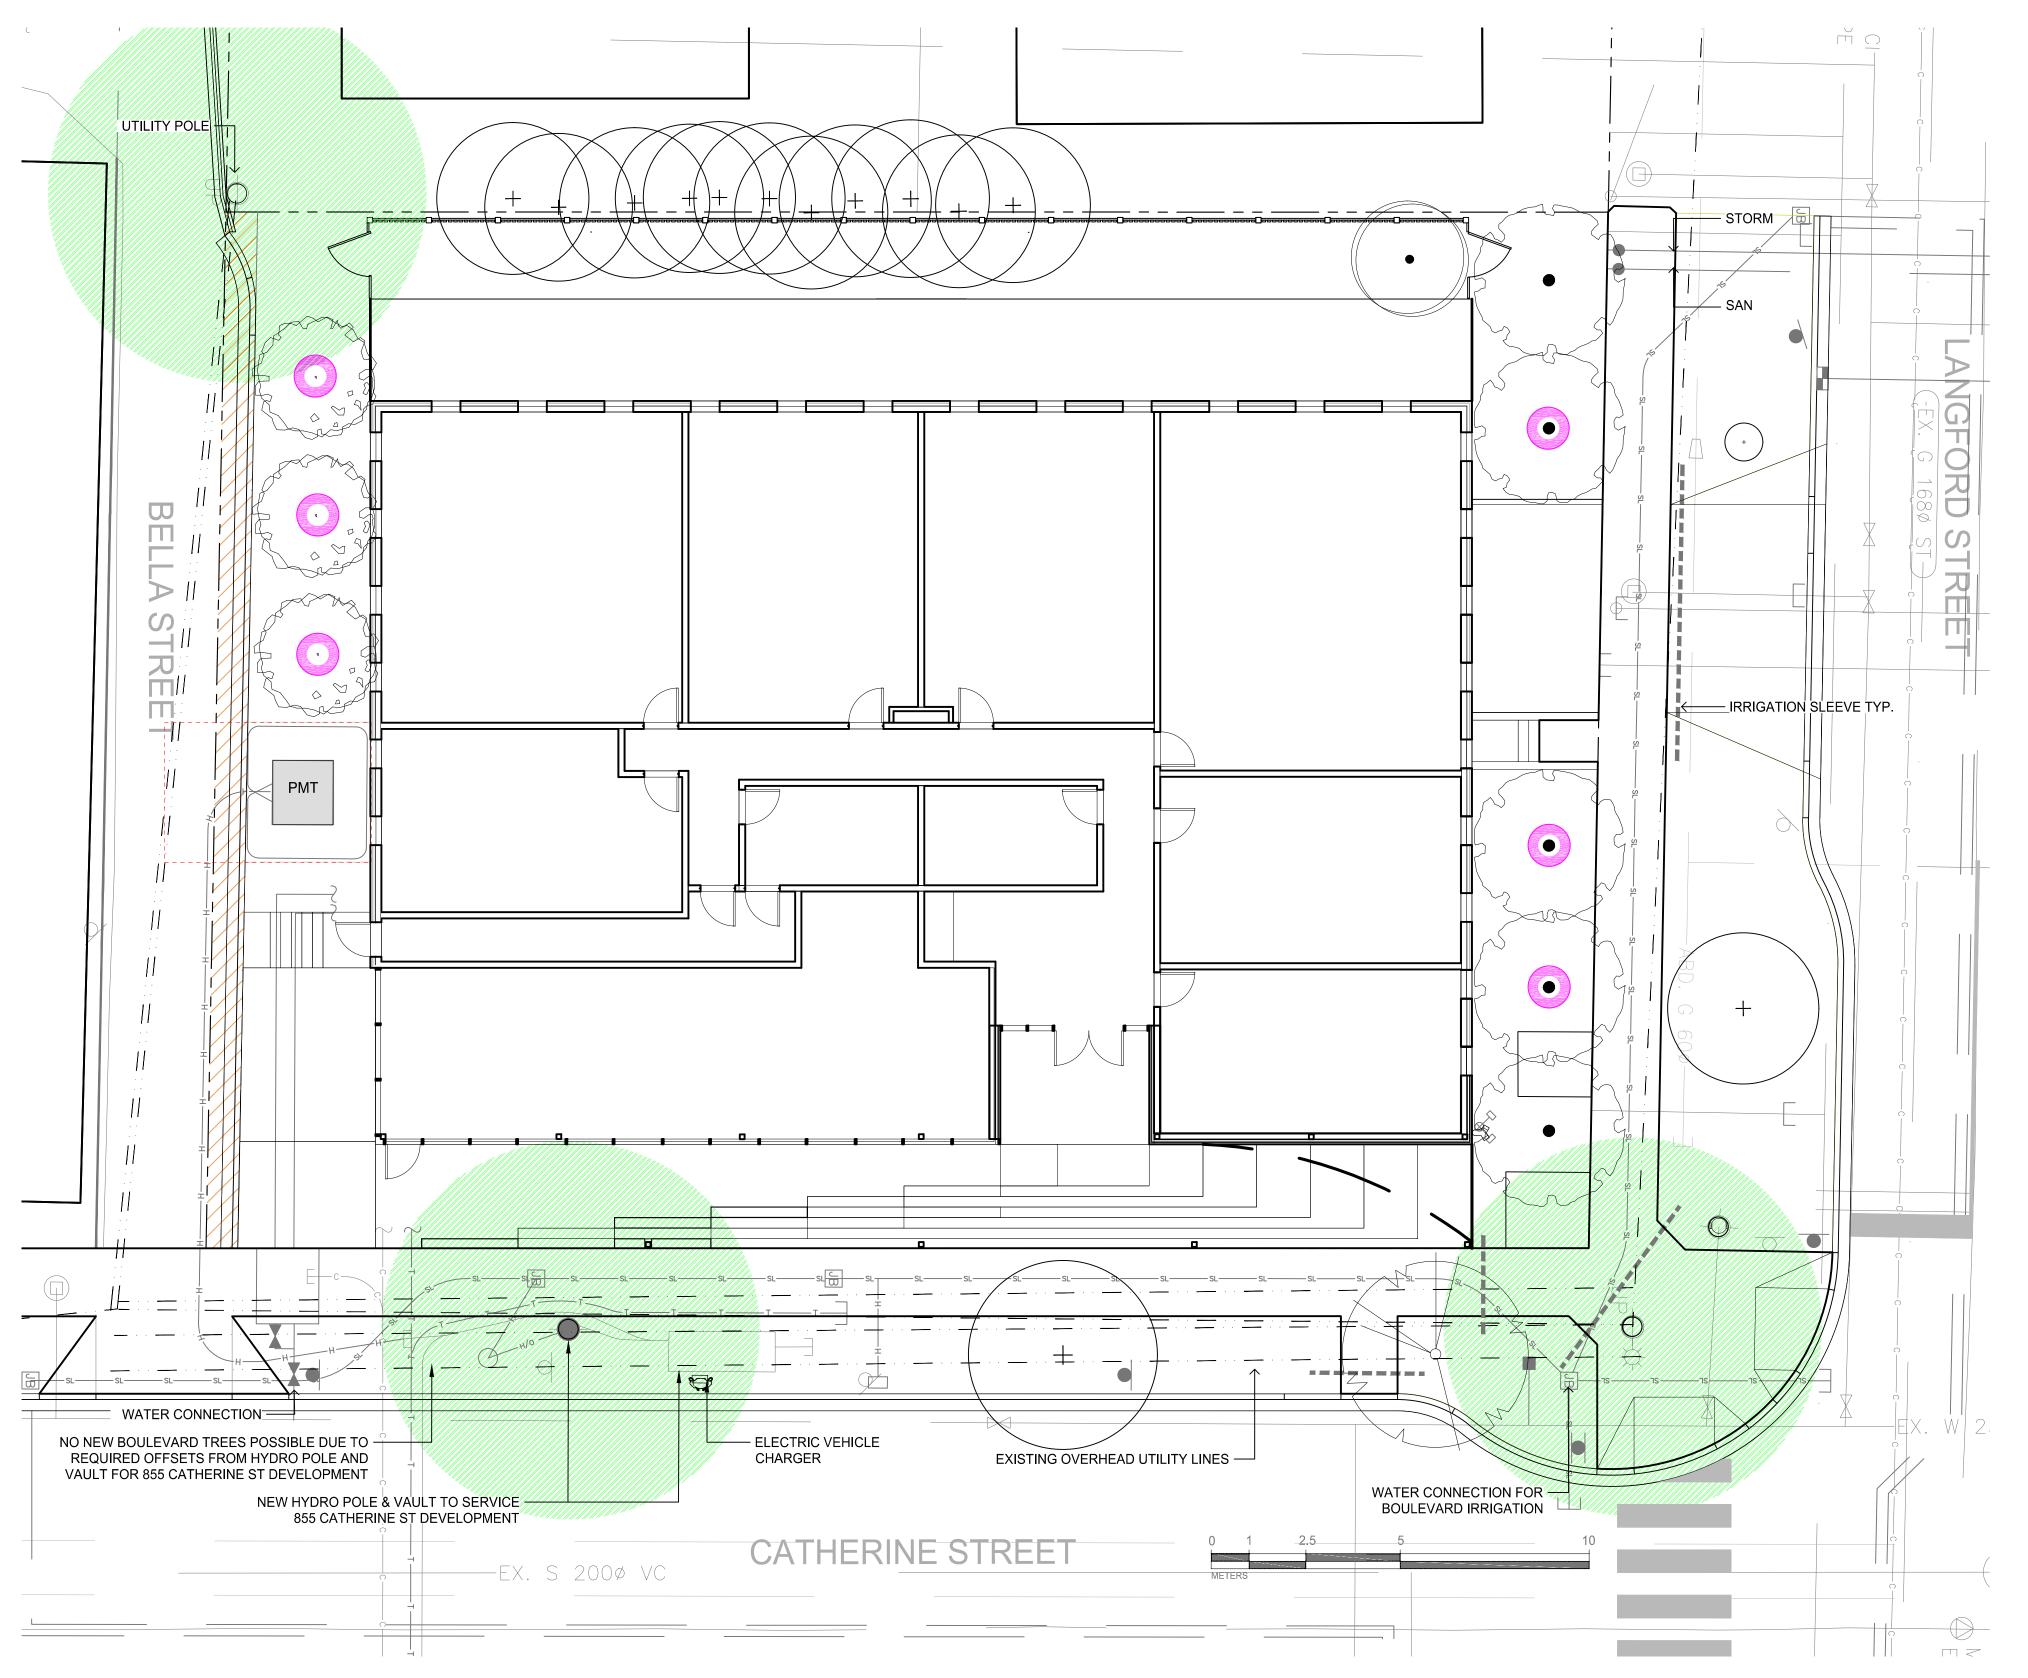

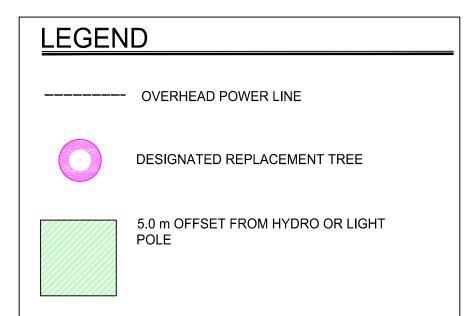

REPLACEMENT TREES REQUIRED	6
REPLACEMENT TREES PROPOSED	6
REPLACEMENT TREE SHORTFALL	0

Tree Pla	anting Sched	ule			
Quantity	Symbol	Latin Name	Common Name	Container	Caliper
1	•	Populus tremuloides	Trembling Aspen	B&B	5 cm
3	final constant	Stewartia rostrata	Stewartia	B&B	5 cm
5		Cornus 'Eddie's White Wonder'	Eddie's White Wonder Dogwood	B&B	70 cm
1		BOULEVARD TREE TO BE DETERMINED BY PARKS AT BP		B&B	6 cm

LANDSCAPE NOTES

PROPOSED BOULEVARD TREES

TREE SPECIES TO BE COORDINATED WITH PARKS PRIOR TO PLANTING

- TREES MUST HAVE ONE DOMINANT CENTRAL LEADER OR SINGLE STRAIGHT TRUNK, 5-8 cm DIAMETER, CALIPER MEASURED 15 cm ABOVE GROUND, WELL BALANCED CROWN WITH BRANCHING STARTING AT 1.8m-2.5m ABOVE GROUND
 TREES TO BE PLANTED AS PER PLANTIG OF TREES, SHRUBS AND GROUND COVERS (32 93 01 MMCD 2009 AND CITY OF
- VICTORIA SUPPLEMENTAL DRAWINGS SD P3 AND SD P4)
 PARKS WILL REQUIRE (3) INSPECTIONS FOR TREE PLANTING: 1)INSPECTION OF SOIL AND PLANTING AREA, 2) INSPECTION OF STOCK UPON DELIVERY, 3) INSPECTION OF INSTALLED TREE WITH MULCH AND STAKING. TRUNK FLARE MUST BE VISIBLE AND PLANTED AT OR SLIGHTLY ABOVE GRADE UPON INSPECTION.
- THE APPLICANT MUST MAINTAIN THE TREE IN GOOD HEALTH AND STRUCTURAL CONDITION FOR 1 YEAR FROM THE SUBSTANTIAL COMPLETION TO BE ELIGIBLE FOR DEPOSIT RETURN.

BOULEAVARD IRRIGATION

- IRRIGATION PLAN TO BE PROVIDED AT BP STAGE.
 ALL IRRIGATION WORK, INCLUDING REQUIRED INSPECTIONS, SHALL FOLLOW THE SUPPLEMENTARY SPECIFICATIONS FOR STREET TREES AND IRRIGATION, SCHEDULE C TO THE VICTORIA SUBDIVISION AND DEVELOPMENT SERVICING BYLAW 12-042, AND COMPLY WITH THE IRRIGATION INDUSTRY ASSOCIATION OF BC STANDARDS.
- IRRIGATION DESIGN SHALL BE SUBMITTED FOR REVIEW AND APPROVAL TO CITY OF VICTORIA PARKS NO LESS THAN 30 DAYS

 PRIOR TO SCHEDULED INSTALLATION.
- PRIOR TO SCHEDULED INSTALLATION.

 IRRIGATION INSPECTIONS REQUIRED FOR ALL SLEEVING, OPEN TRENCH MAINLINE AND LATERAL LINES, SYSTEM OPERATION, CONTROLLER, AND BACKFLOW PREVENTER (INCL. INSPECTION TAG AND TESTING REPORT). CALL PARKS AT 250-361-0600 AT
- LEAST 2 DAYS IN ADVANCE TO ARRANGE FOR IRRIGATION INSPECTIONS.

 THE LANGFORD STREET BOULEVARD LAWN IRRIGATION SYSTEM AND THE NEW STREET TREE ON CATHERINE ST ARE TO BE INSTALLED BY THE DEVELOPPER, AND SHALL BE IRRIGATED FROM A CITY WATER SOURCE AND MAINTAINED BY THE CITY.
- THE CATHERINE ST BOULEVARD LAWN AREA SHALL BE IRRIGATED FROM A PRIVATE WATER SOURCE UNDER A PERMIT FROM
 THE CITY ENGINEERING DEPARTMENT. THE MAINTENANCE OF THE CATHERINE BOULEVARD LAWN IS THE RESPONSIBILITY OF
 THE PROPERTY OWNER AS WOULD BE THE PRIVATE IRRIGATION SYSTEM.



1608 Camosun Street, Victoria BC V8T 3E6 Info@biophiliacollective.ca 250 590 1156

OWNER/CLIENT:

ARYZE

PROJECT NAME:

822 CATHERINE STREET+ 304 LANGFORD STREET

PROJECT ADDRESS: 822 CATHERINE ST. VICTORIA, BC

DESIGNED BY: **BIANCA BODLEY** DRAWN BY: OLIVIA LYNE

9	DEVELOPMENT PERMIT	2023-07-14
8	ISSUED FOR BUILDING PERMIT	22\10\05
7	ISSUED FOR DDP	22\10\05
6	ISSUED FOR 50% DD REVIEW	22\06\17
5	REVISED AND RE-ISSUED FOR RZ/DP	22\06\02
4	ISSUED FOR REVIEW SUMMARY RESPONSE 02	22\02\11
3	ISSUED FOR REVIEW SUMMARY RESPONSE 02	21\11\03
2	ISSUED FOR TRD RESPONSE	21\07\14
1	ISSUED FOR RZ/DP	21\05\12
NO.	ISSUE	YY\MM\DD




NORTH ARROW

DRAWING TITLE:

TREE PLANTING PLAN

DWG NO:

SCALE: 1:100

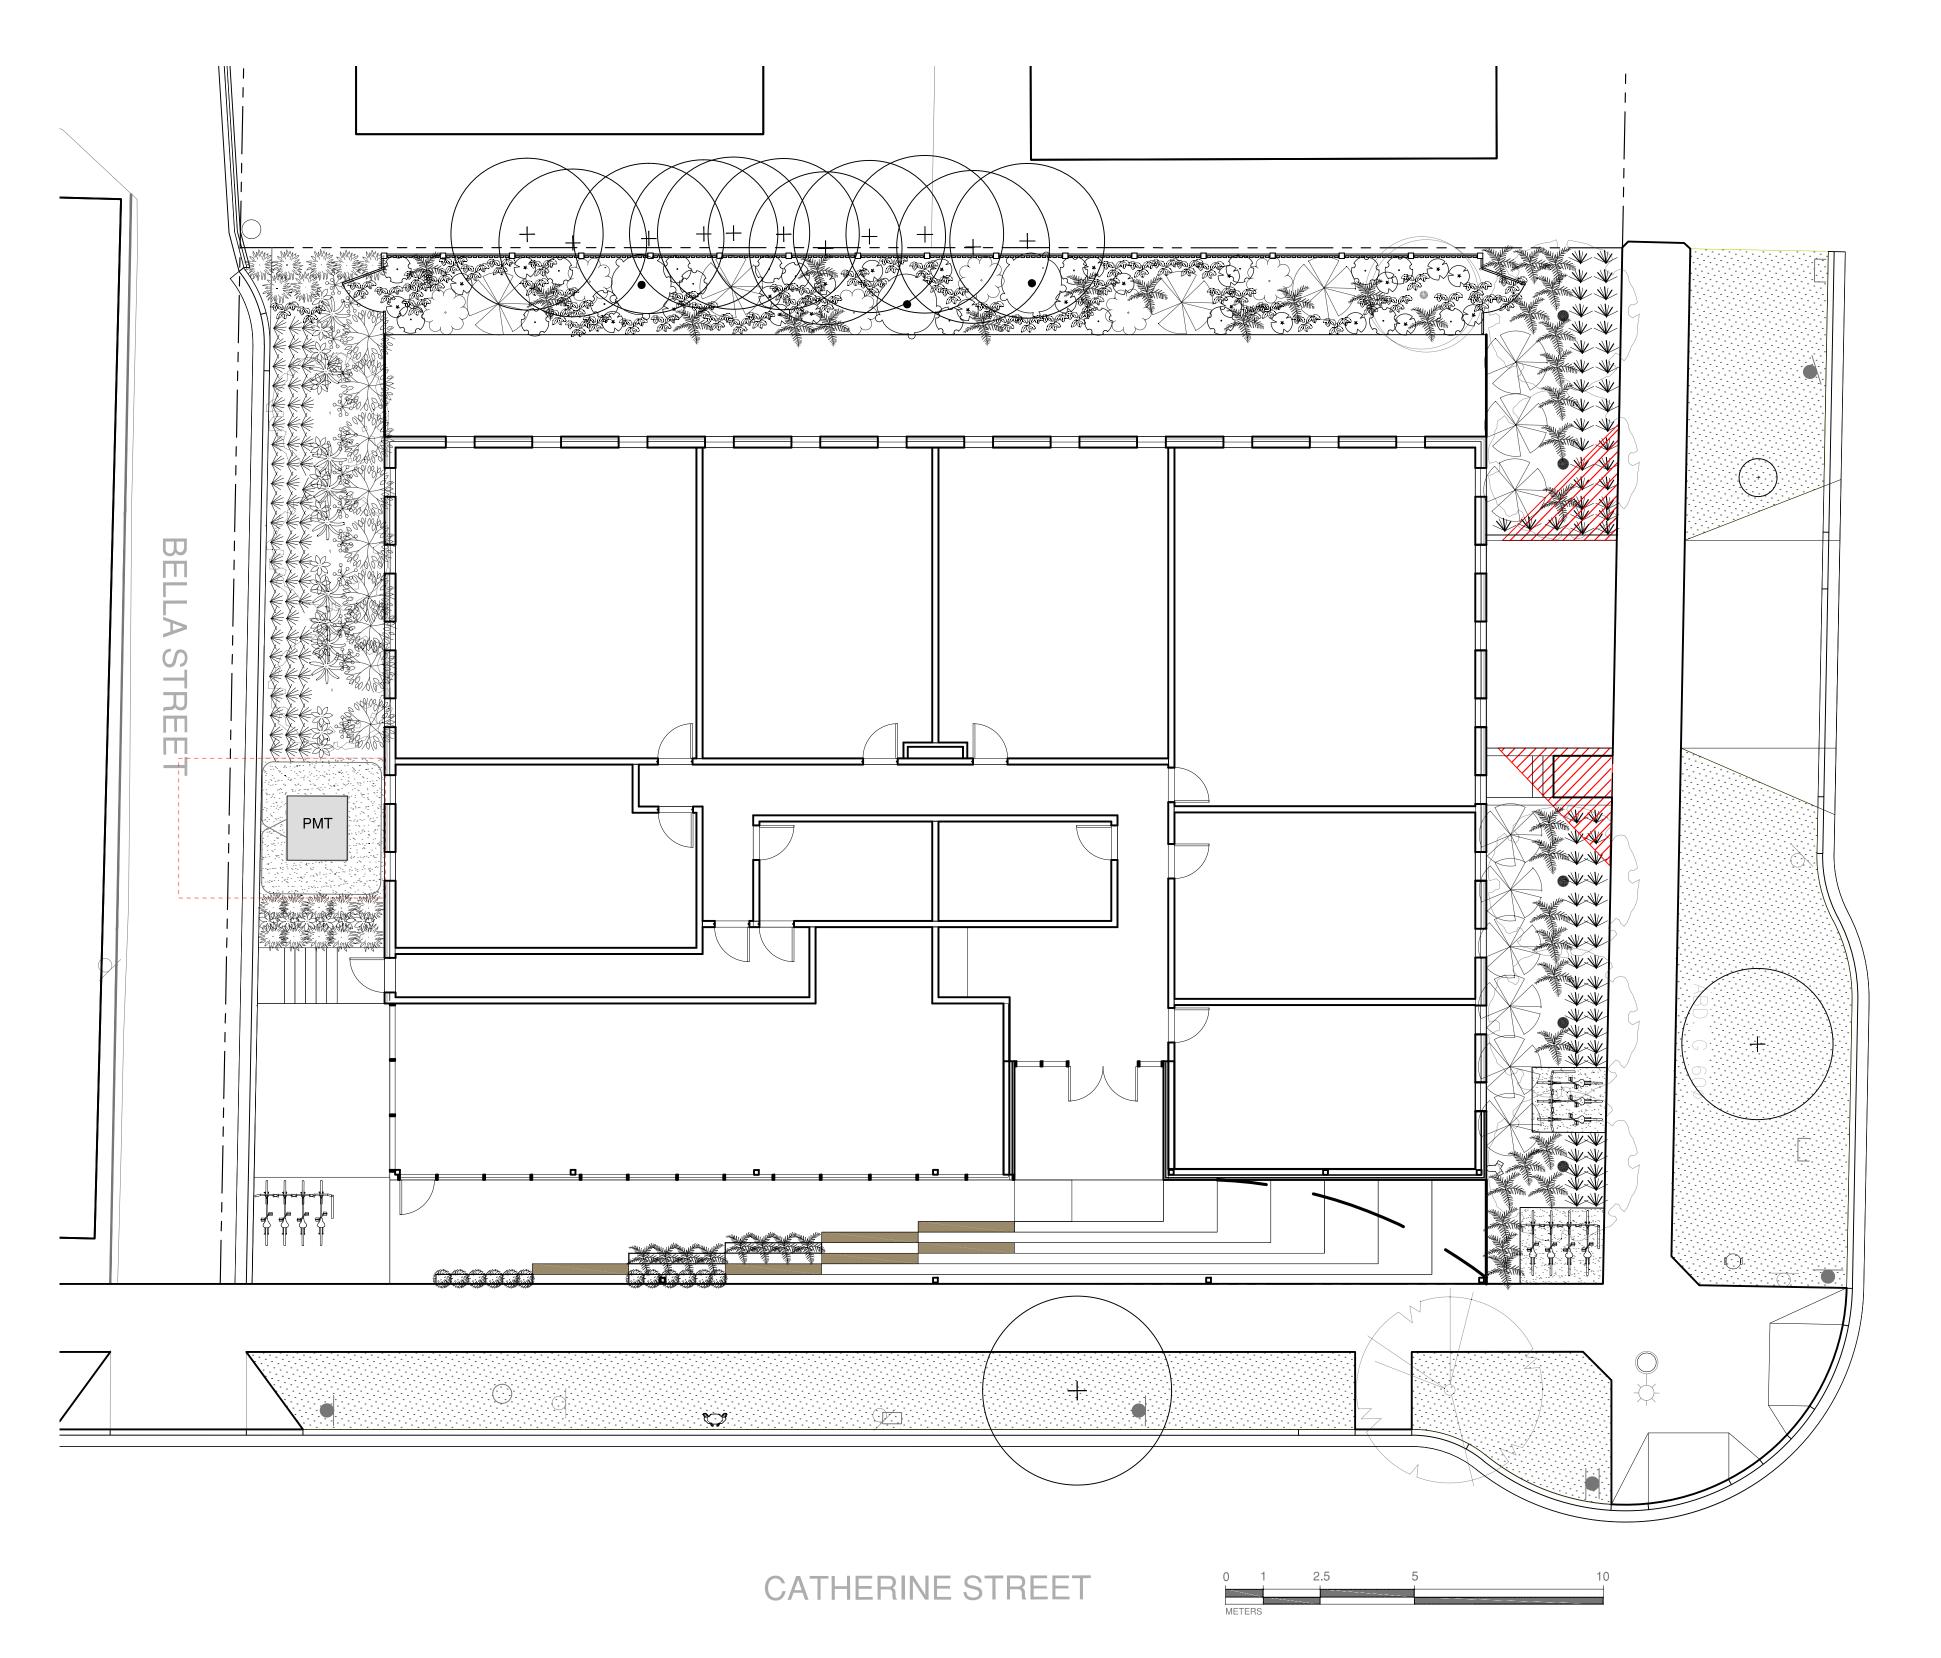

ANGFORD STREE

Quantity	Symbol	Latin Name	Common Name	Container	Native	Pollinato
13	ogo	Anaphalis margaritacea	Pearly everlasting	#1	yes	
36	*	Achillea millefolium	Common yarrow	#1	у	у
72	%	Arctostaphylos Uva-Ursi	Kinnikinnick	10cm	у	у
17	Signature of the second of the	Calamagrostis acutiflora 'Karl Forester'	Karl Forester feather reed grass	#2		
9	20 1 00 pg	Choisya ternata	Mexican mock orange	#2		у
14	*	Echinecea purpurea	Purple coneflower	#1		у
18	$\langle \cdot \rangle$	Gaultheria shallon	Salal		у	у
180	*	Liriope muscari	Liriope	10cm		
44		Ploystichum munitum	Western sword fern	#1	у	
6		Ribes sanguineum	Red-flowering currant	#1	у	у
3		Rosa nutkana	Nootka rose	#1	у	у
12		Sarcococca confusa	Sweet Box	#1		У
13		Vaccinium ovatum	Evergreen huckleberry	#2	у	
9		Verbena bonariensis	Tall verbena	#1		у

9 DEVELOPMENT PERMIT 22\10\05 8 ISSUED FOR BUILDING PERMIT 7 ISSUED FOR DDP 22\10\05 6 ISSUED FOR 50% DD REVIEW 4 ISSUED FOR REVIEW SUMMARY RESPONSE 02 22\02\11 3 ISSUED FOR REVIEW SUMMARY RESPONSE 02 21\11\03 2 ISSUED FOR TRD RESPONSE 1 ISSUED FOR RZ/DP

1608 Camosun Street, Victoria BC V8T 3E6 Info@biophiliacollective.ca 250 590 1156

822 CATHERINE STREET+

304 LANGFORD STREET

OWNER/CLIENT:

PROJECT NAME:

PROJECT ADDRESS:

VICTORIA, BC


822 CATHERINE ST.

DESIGNED BY: **BIANCA BODLEY** DRAWN BY: OLIVIA LYNE

ARYZE



NO. ISSUE

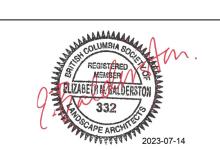

NORTH ARROW



DRAWING TITLE: PLANTING PLAN

DWG NO:

SCALE: 1:100

