937 VIEW STREET



Project Rendering - Main Entry Streetscape at View Street

■LIST OF DRAWINGS ARCHITECTURAL Project Data A100 Survey A101 Site Plan Existing Site Plan Proposed Setback Plans Site Context - Shadow Analysis Site Context - Street Views Site Context - Street Elevations Site Context - Materials Site Context - Rendered Views Livability - Rendered Interior Views A118 Livability - Rendered Interior Views Level 2 Plan Levels 3-5 Plan Levels 6 Plan Levels 7-22 Plan Level 23 Plan Roof Plan **Building Elevations Building Elevations** Adjacent Buildings Analysis **Building Sections**

LANDSCAPE

A402 Building Sections
A911 Area Plans

L1.01	Landscape Plan L1
L1.02	Landscape Plans Upper Level
L1.03	Stormwater Mangement
L3.01	Planting Plan L1
L3.02	Planting Plan Upper Levels
_	

CIVIL

1	C100	General Notes
	C200	Site Servicing Plan
	C300	Grading Plan
-	C400	BC Hydro Information Plan

View St. Residential

937 View Street

Cover



Victoria 977 Fort Street

Revisions **Received Date:**

937 VIEW STREET





LIST OF ABBREVIATIONS

Glass Block


Hollow Core Hollow Core Wood

GBL GL

Georgian Wire Glass

Gypsum Wallboard

The following abbreviations are used on door, window, and finish schedules as well as on architectural drawings and details.

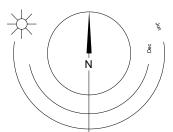

	ACST	Acrylic Stucco	H/C	Handicap	SPC	Solid Particleboard Core	
	ACT	Acoustical Tile	HM	Hollow Metal	ST	Structure	
	AFF	Above Finished Floor	HP	High Point	STL	Steel	
	AL	Aluminum	HSS	Hollow Steel Section	STN	Stain(ed)	
	AO	Auto-Opener	H/W	Hardware	STNT	Stone Tile	
	AP	Annunciator Panel	INSUL	Insulated	SS	Stainless Steel	
	BG	Building Grade	LAM	Laminated Glass	SVF	Sheet Vinyl Flooring	
	CEM	Cementitious Backing Board	LP	Low Point	TB	Towel Bar	
	Conc	Concrete	MDFB	Medium Density Fibreboard Base	T/D	Tempered / Double Glazed	
	CBK	Concrete Block	MR	Mirror	TLAM	Tempered Laminated Glass	
	C/L	Centerline	MP	Metal Panel	TGL	Tempered Glass	
	CPT	Carpet Tile	O/H	Overhead	TLGL	Translucent Glass	
	CT	Ceramic Tile	OW	Operable Window	TOC	Top of Concrete	
	C/W	Complete With	PF	Prefinished	TOD	Top of Drain	
	DD	Deck Drain	PLAM	Plastic Laminate	TOI	Top of Insulation	
	EB	Electric Bike Storage	PLS	Plaster	TOP	Top of Parapet	
	EL	Elevation	PSF	Pressed Steel Frame	TOS	Top of Slab	
	EPC	Epoxy Polymer Coating	PT	Paint	TOW	Top of Wall	
	EV	Electric Vehicle Parking	PTD	Paper Towel Dispenser	TP	Toilet Paper	
	EXP AGG	Exposed Aggregate	PTD/W	Paper Towel Dispenser / Waste	UNF	Unfinished (for GWB means taped and filled by not sanded to	
	EXT	Exterior	PTW	Paper Towel Waste		minimum ULC requirements where applicable)	
	FD	Floor Drain	RA	Roof Anchor	UNO	Unless Noted Otherwise	
	FEC	Fire Extinguisher Cabinet	RB	Rubber Base	U/S	Underside of	
	FFE	Finished Floor Elevation	RES	Resilient Flooring	VCT	Vinyl Composition Tile	
	FG	Finished Grade	RD	Roof Drain	VI	Vision Glass	
	GB	Grab Bar	RD-P	Roof Drain - Planter	VIS	Vinyl Impact Sheet	
П	CRI	Glass Block	D\A/I	Pain Water Leader	\/T	Vinyl Tilo	

Rain Water Leader

Solid Core Wood

Soap Dispenser

Spandrel Glass

Spray Applied Fibrous Insulation

RWL SAFI SCW

		annotations are used on rawings and details:
blid Particleboard Core tructure	BEDROOM 201	ROOM NAME & ROOM NUMBER
tain(ed) tone Tile tainless Steel heet Vinyl Flooring	(101a)	DOOR NUMBER See Door Schedule
owel Bar empered / Double Glazed empered Laminated Glass empered Glass	W-10	WINDOW NUMBER See Window Schedule
ranslucent Glass op of Concrete op of Drain op of Insulation	W1	WALL TYPE See Assemblies Schedule
op of Parapet op of Slab op of Wall oilet Paper	2.0 hr	RATED WALL DESIGNATION
nfinished (for GWB means taped and filled by not sanded to inimum ULC requirements where applicable) nless Noted Otherwise nderside of	00.00	ELEVATION DATUM
inyl Composition Tile ision Glass inyl Impact Sheet inyl Tile	2440	CEILING HEIGHT
inyl Wall Covering /ater Closet /ood /aterproof Membrane		AREA OF DROP CEILING
ater Repellant Coating	1	KEYNOTE SYMBOL
	12	MATERIAL TAG

ANNOTATIONS LEGEND

INTERIOR ELEVATION REFERENCE

W1 C1 F1 B1 ROOM FINISHES

BUILDING CODE SUMMARY

REFERENCED DOCUMENTS: BRITISH COLUMBIA BUILDING CODE 2018 - PART 3 CANADIAN STANDARDS ASSOCIATION B651-18

MAJOR OCCUPANCY CLASSIFICATION: GROUP C - RESIDENTIAL

BUILDING AREA: 1087 m² (11 700 s.f.)

BUILDING HEIGHT: 23 STOREYS

NUMBER OF STREETS FACING:

ACCESSIBLE FACILITIES ACCESSIBLE ENTRANCE

CONSTRUCTION REQUIREMENTS: 3.2.2.47 GROUP C, ANY HEIGHT, ANY AREA, SPRINKLERED NON-COMBUSTIBLE CONSTRUCTION WITH 2 HR MIN. FIRE RESISTANCE RATING TO FLOORS AND LOADBEARING

ADDITIONAL REQUIREMENTS FOR HIGH BUILDINGS Ref. 3.2.6.1 (1)(d)

937 VIEW STREET, VICTORIA, BC. Nelson Investments Inc. 595 Howe Street, 10th Floor Chris Nelson LEGAL DESCRIPTION: tel: 604.318.6877 Vancouver, BC LOT A, OF LOTS 785, 786, and 787, VICTORIA CITY, V6C 2T5 chris@nelsoninvestmentsinc.com PLAN 36505 **ZONING BYLAW SUMMARY ARCHITECT** Charles Kierulf dHKarchitects 977 Fort Street tel: 250.658.3367 **BUILDING DESCRIPTION:** Victoria, B.C. fax: 250.658.3397 23 STOREY RESIDENTIAL BUILDING crk@dhk.ca RESIDENTIAL RENTAL STRUCTURAL R-48 HARRIS GREEN 3600 Uptown Blvd Chris Jaques Building 15, Suite 301 DEVELOPMENT PERMIT AREA: DPA 713 (HC) tel: 778.834.2331 Victoria, BC V8Z 0B9 Chris.Jaques@wsp.com SITE AREA: 1 572.3 m² (16 924 s.f.) FLOOR AREA: 707 m² (7 610 s.f.) Level 1: MECHANICAL 735 m² (7 911 s.f.) Level 2: Avalon Mechanical Consultants Ltd. 801 m² (8 622 s.f.) x 3 = 2 403 m² Level 3-5: 1245 Esquimalt Rd #300, Jamie Clarke Level 6-22: 477.5 m² (5 140 s.f.) x 17 = 8 118 m² tel: 250.384.4128 Victoria, BC 327 m² (6 168 s.f.) Level 23: V9A 3P2 jclarke@avalonmechanical.com TOTAL PROPOSED: 12 356 m² (132 999 s.f.) **ELECTRICAL CONSULTANT** FLOOR SPACE RATIO: Nemetz & Ass Ltd SITE COVERAGE: 2009 W 4th Ave Bijan Valagohar tel: 604.736.6562 Vancouver, BC V6J 1N3 bijan@nemetz.com OPEN SITE SPACE: **GREEN STORMWATER INFRASTRUCTURE:** LANDSCAPE CONSULTANT *Minimum 30% of paving area, refer to Murdoch de Greeff Inc. Scott Murdoch Landscape drawing L1.01 200-524 Culduthel Rd. tel: 250.412.2819 fax: 250.412.2892 Victoria, BC GRADE OF BUILDING: 17.7 m (GEODETIC AVG GRADE) V8Z 1G1 scott@mdidesign.ca See Site Plan for Grade Calculations HEIGHT OF BUILDING: **GEOTECHNICAL** Shane Moore SETBACKS: Ryzuk Geotechnical FRONT (View Street): 28 Crease Avenue tel: 250.475.3131 REAR (S): Victoria, BC fax: 250.475.3611 shane@ryzuk.com SIDE (È): SIDE (W): NUMBER OF STOREYS: 23 STOREYS **CIVIL CONSULTANT** Sarah Campden tel: 250.590.4875 Herold Engineering SUITE COMPOSITION: 1051 Vancouver Street Studio < 30m²: Victoria, BC fax: 250.590.4392 1 Bed / 1 Bath <45m²: SCampden@heroldengineering.com V8V 4T6 2 Bed / 1 Bath <45m²: 3 Bed / 1 Bath > 45m²: 3 Bed / 2 Bath > 45m²: 8 Suites **ENVELOPE CONSULTANT** TOTAL: 269 SUITES Morrison Hershfield 536 Broughton Street, 2nd Floor tel: 250.361.1215 x1142201 RESIDENTIAL PARKING: Victoria, BC fax: 250.361.1235 V8W 1C6

PROJECT DESCRIPTION

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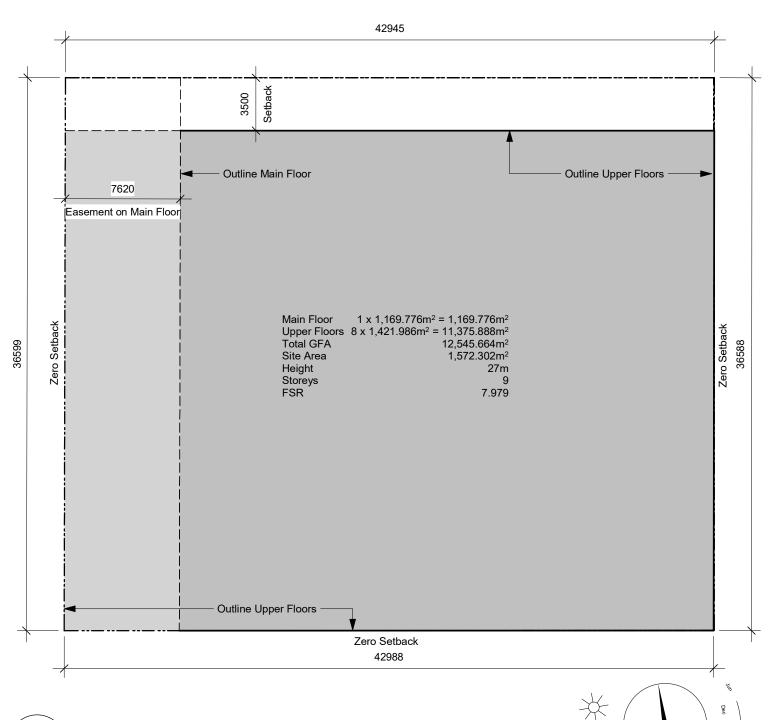
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310 (25% EB)


Required Long Term: Provided Long Term:

Required Short Term: Provided Short Term: **PROJECT DIRECTORY**

craudoy@morrisonhershfield.com



1:250

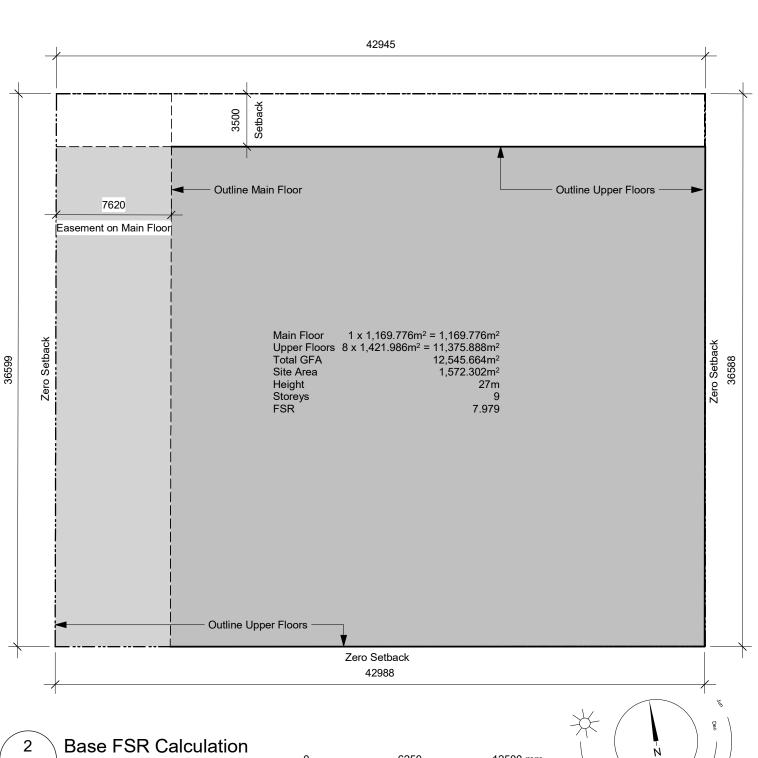

Project Data dHKarchitects

23-08-15

23-05-09

21-05-04

20-08-12

20-01-08

19-10-02

NOTE: All dimensions are shown in millimeters.

937 View Street

23-05-09 Drawing File

View St. Residential

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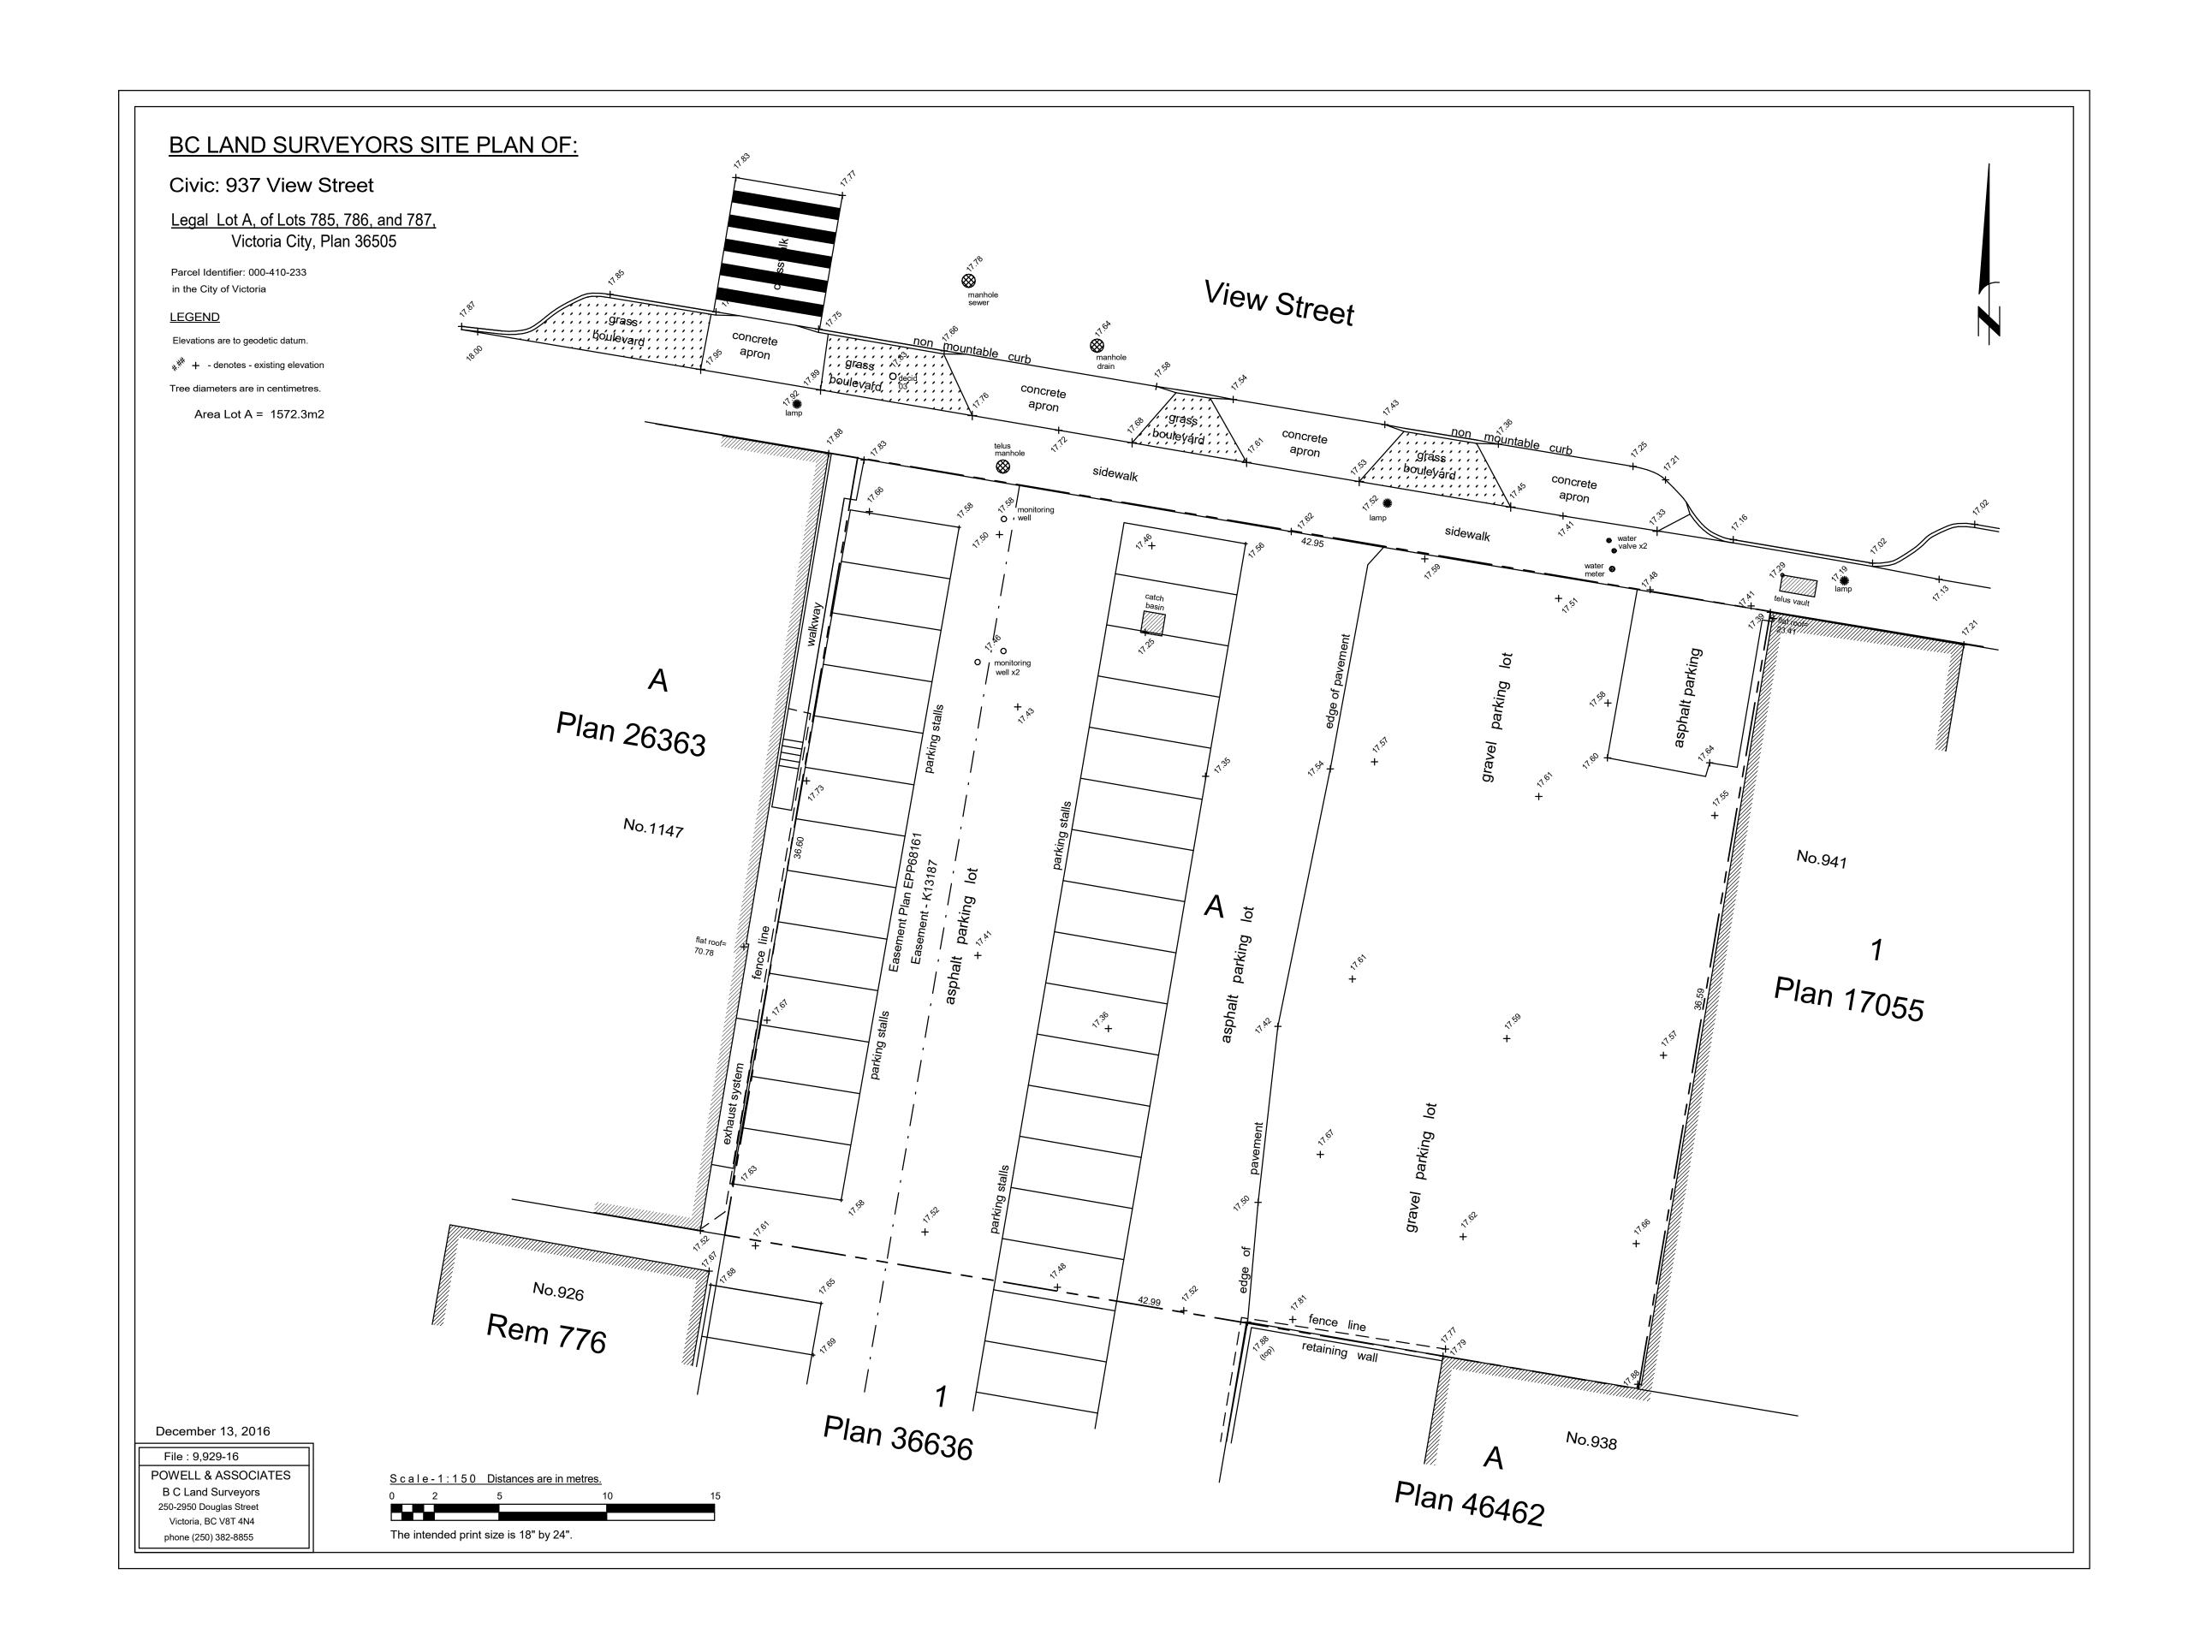
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Issued for DP



19-10-02 Issued for DP
of Date 23-05-09 Drawing File
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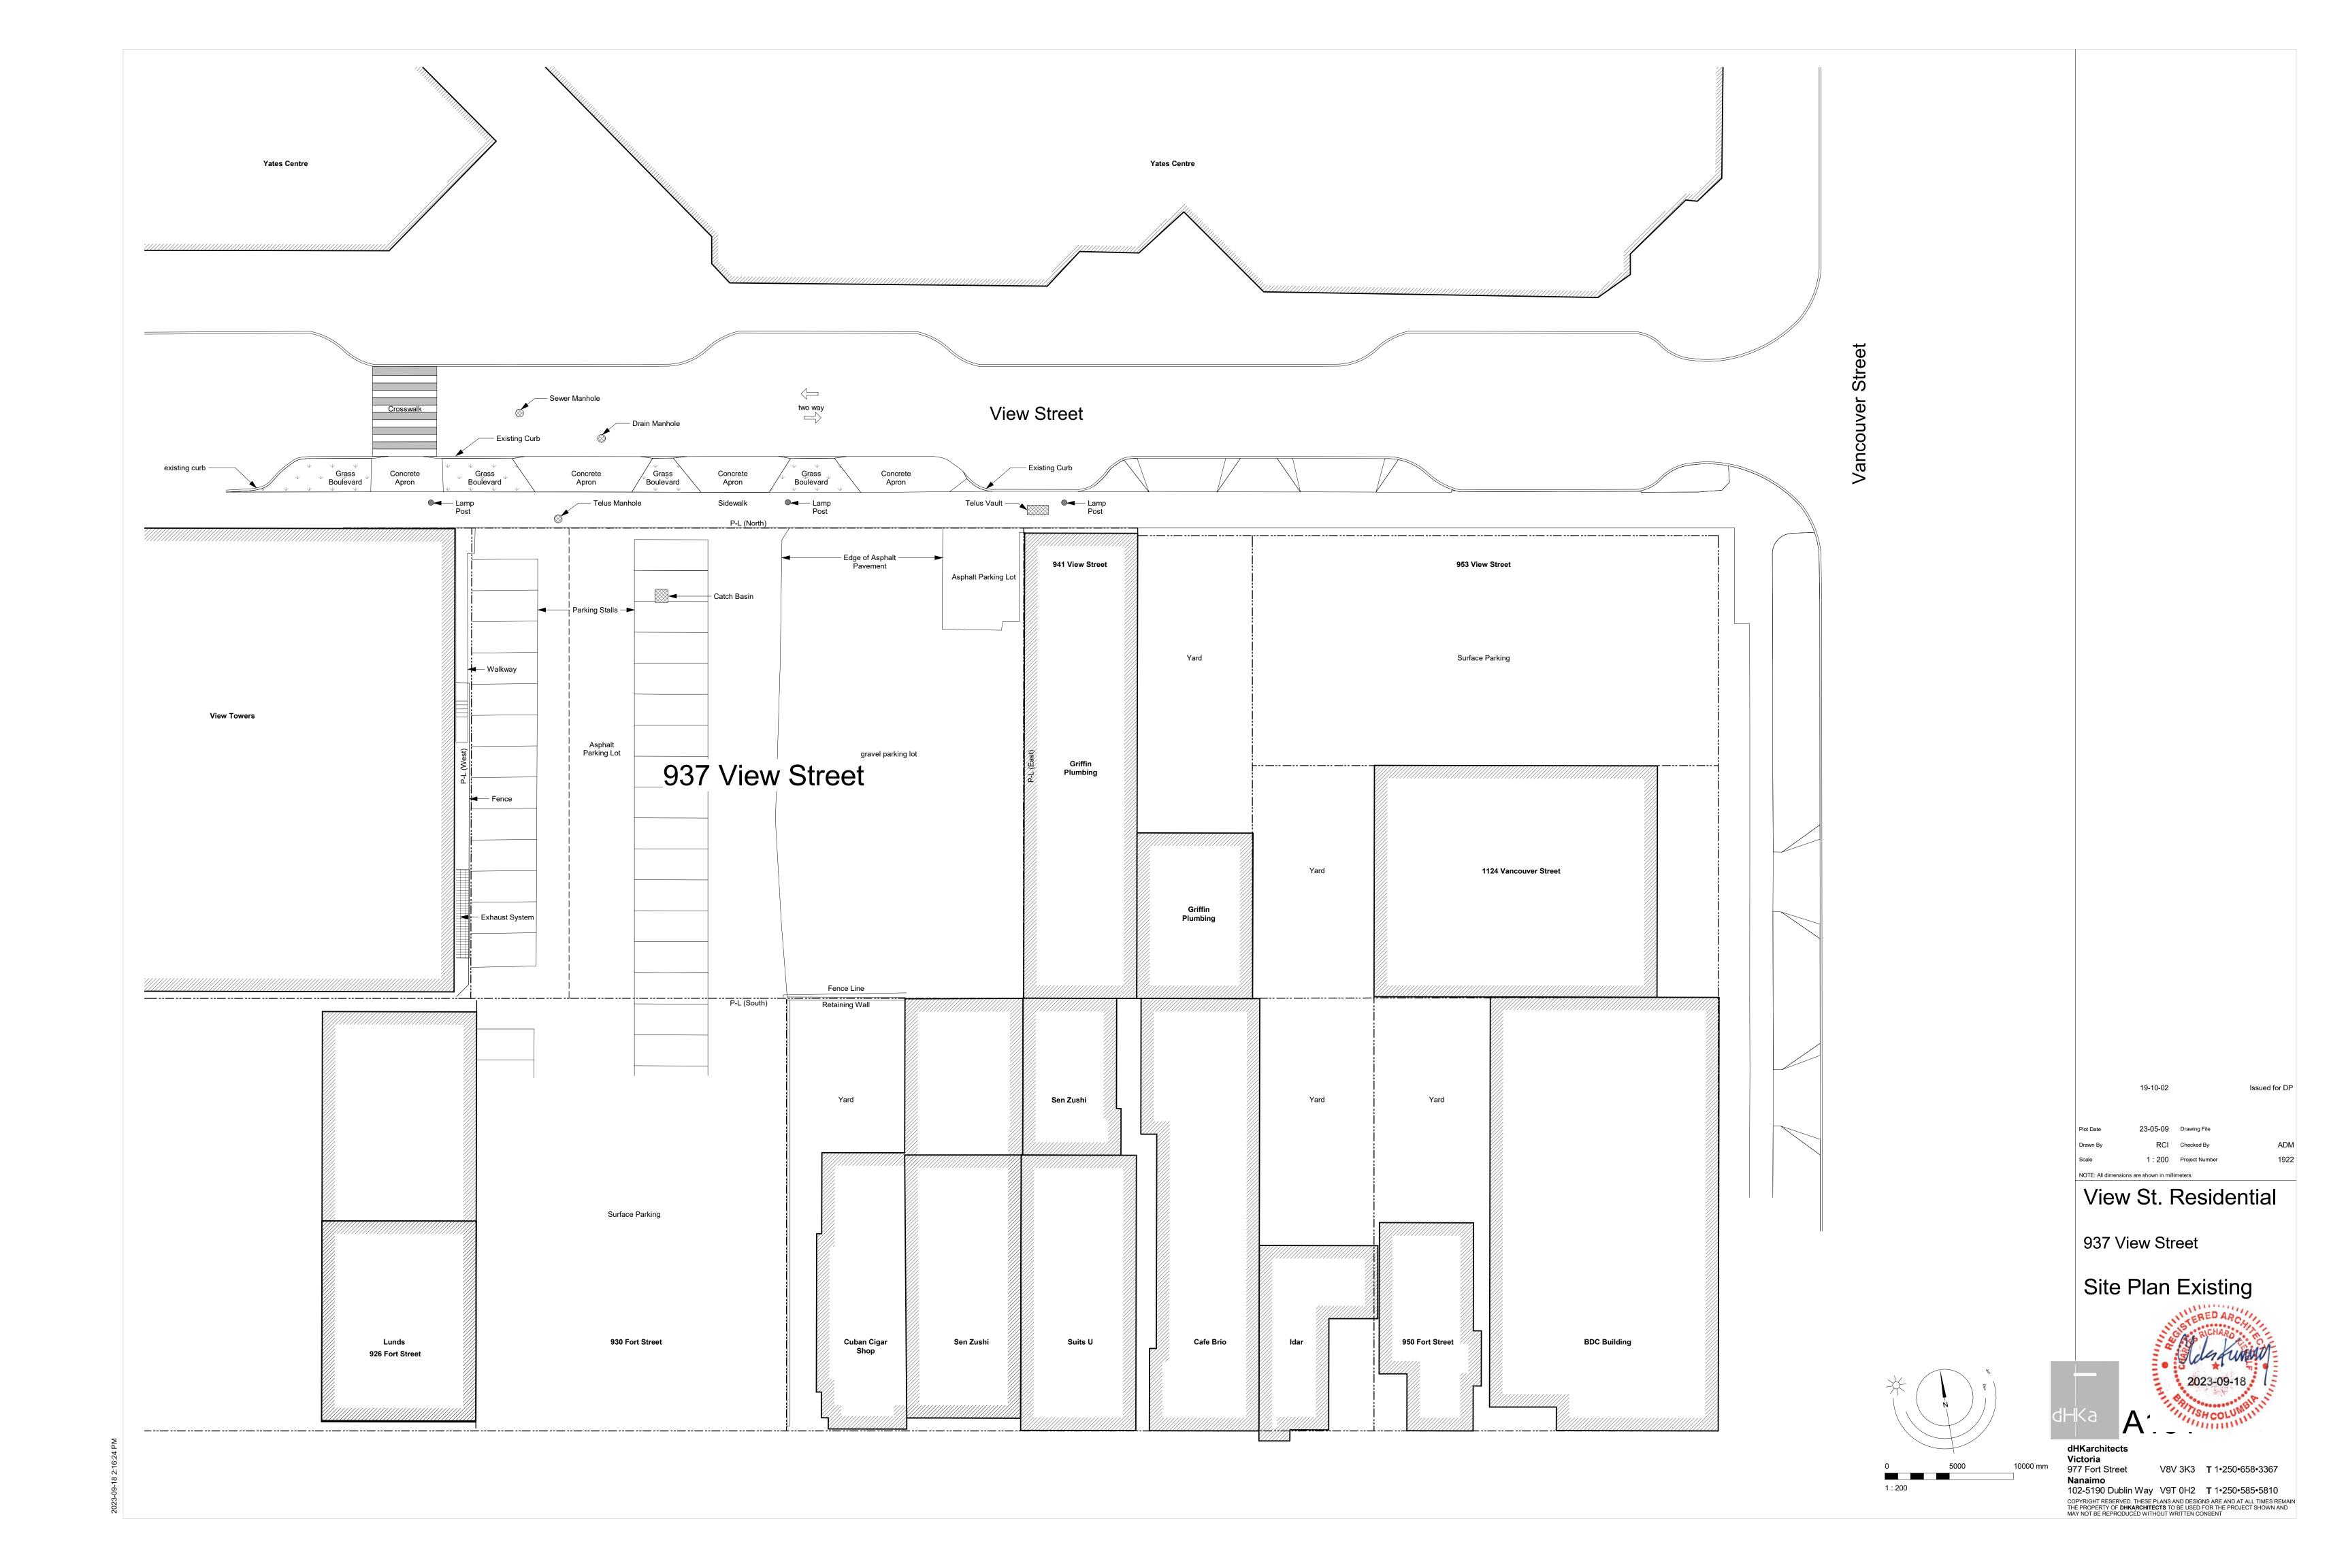
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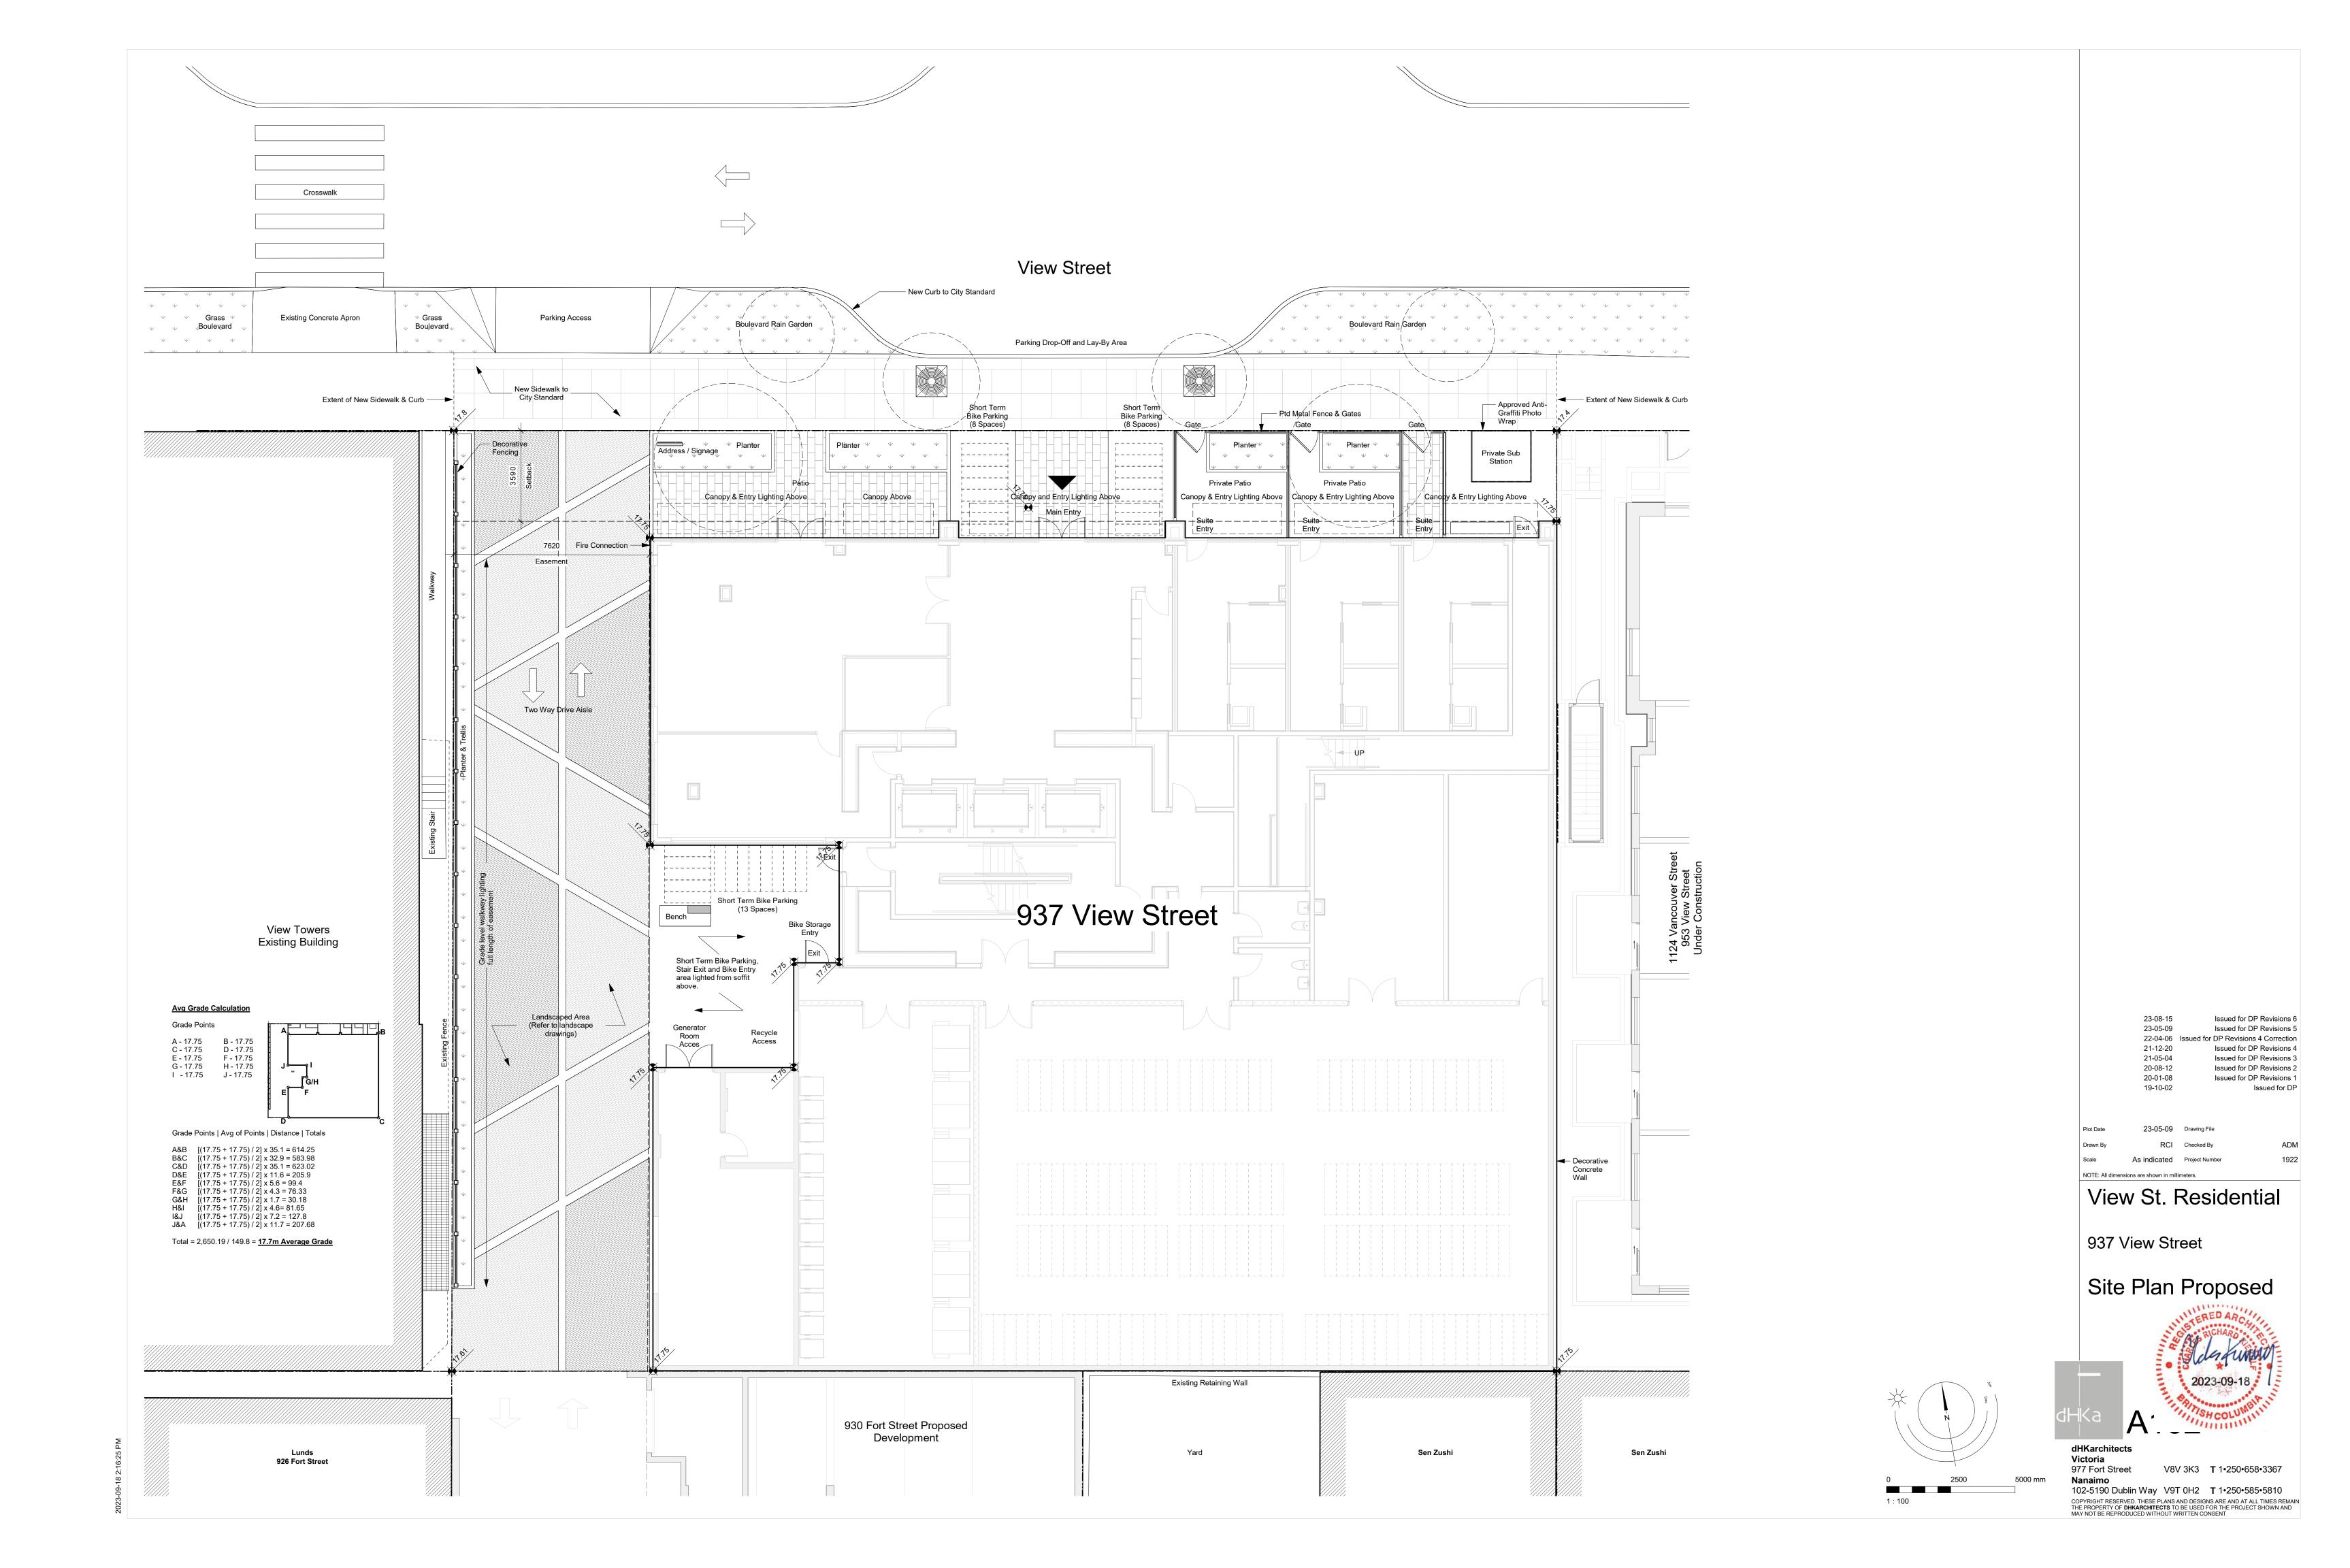
937 View Street


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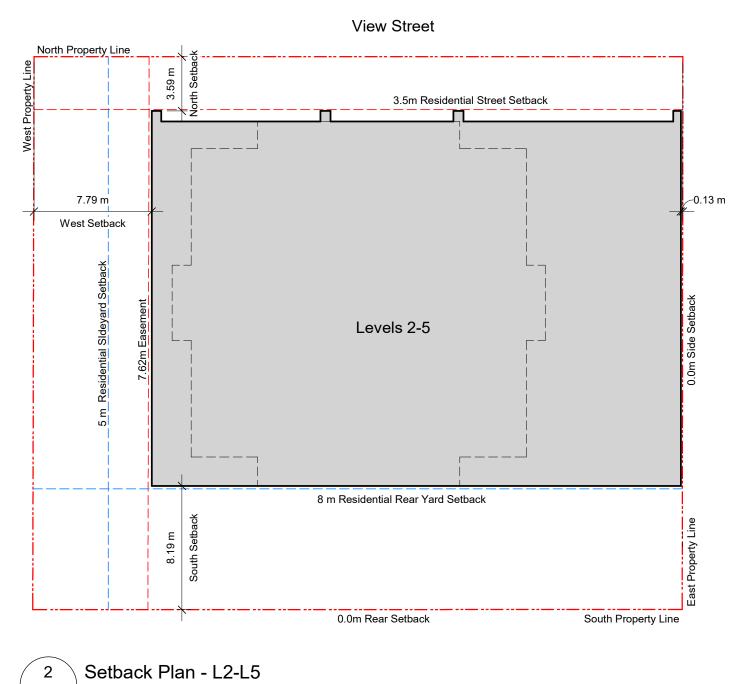


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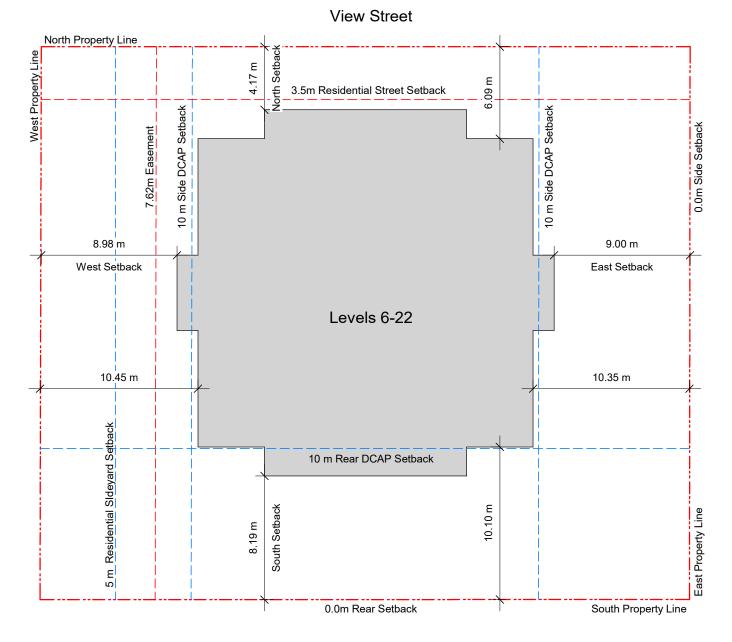






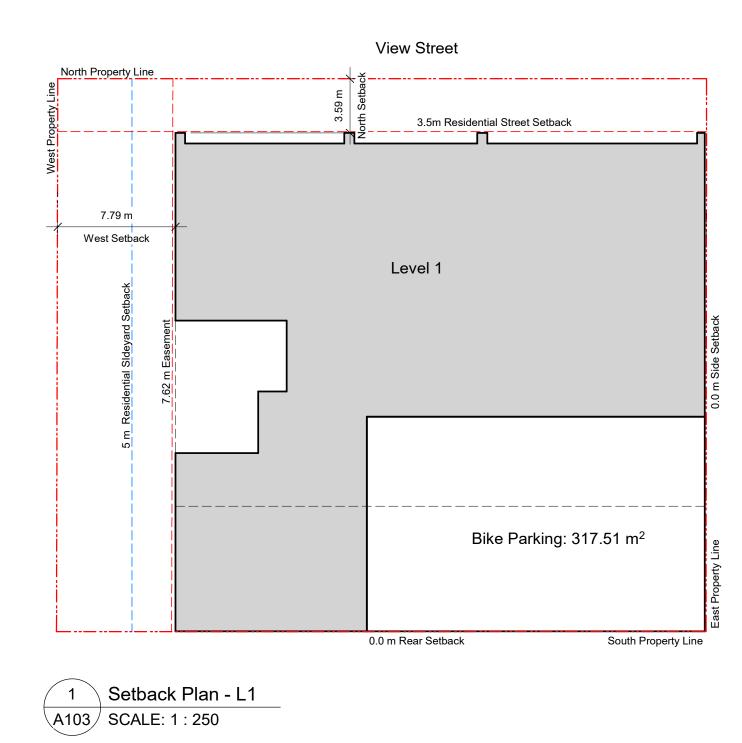

A103 SCALE: 1 : 250



3 Setback Plan - L6-L22 A103 SCALE: 1 : 250

> 23-05-09 Issued for DP Revisions 5 21-05-04 Issued for DP Revisions 3 20-08-12 Issued for DP Revisions 2

 Plot Date
 23-05-09
 Drawing File

 Drawn By
 RCI
 Checked By

 Scale
 1 : 250
 Project Number

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937 View Street


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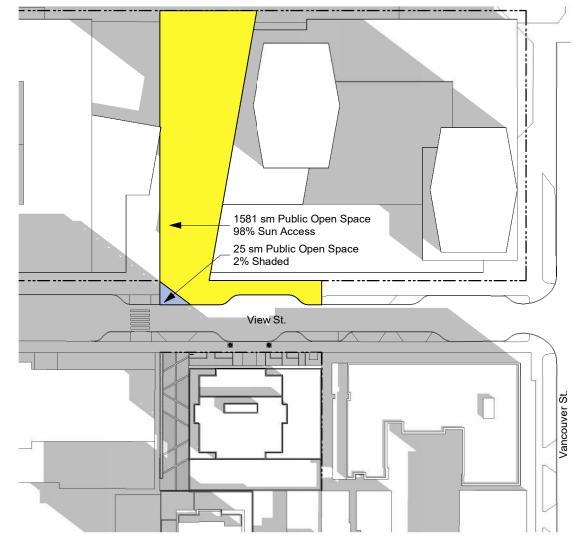
Setback Plans




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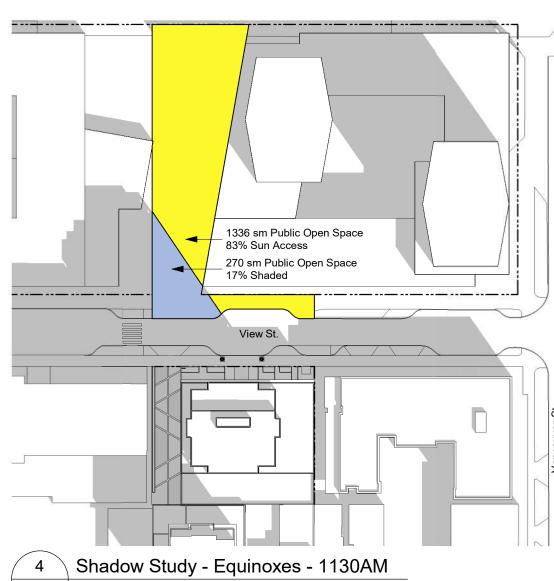





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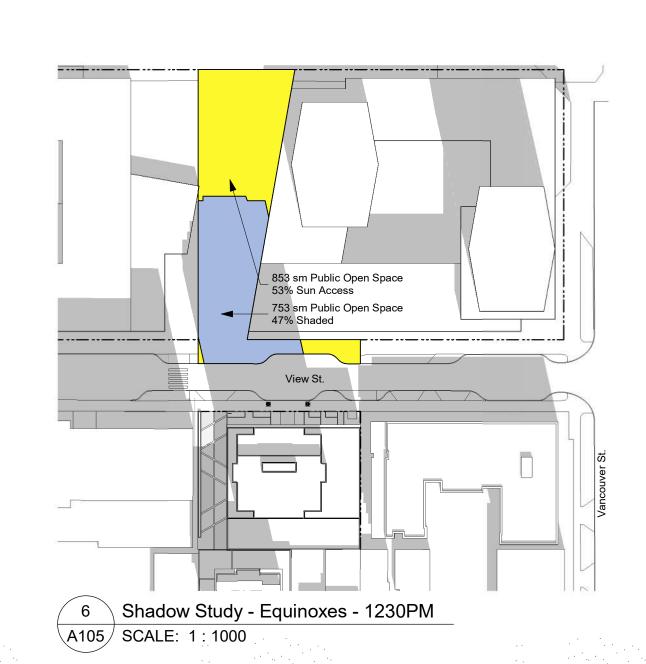


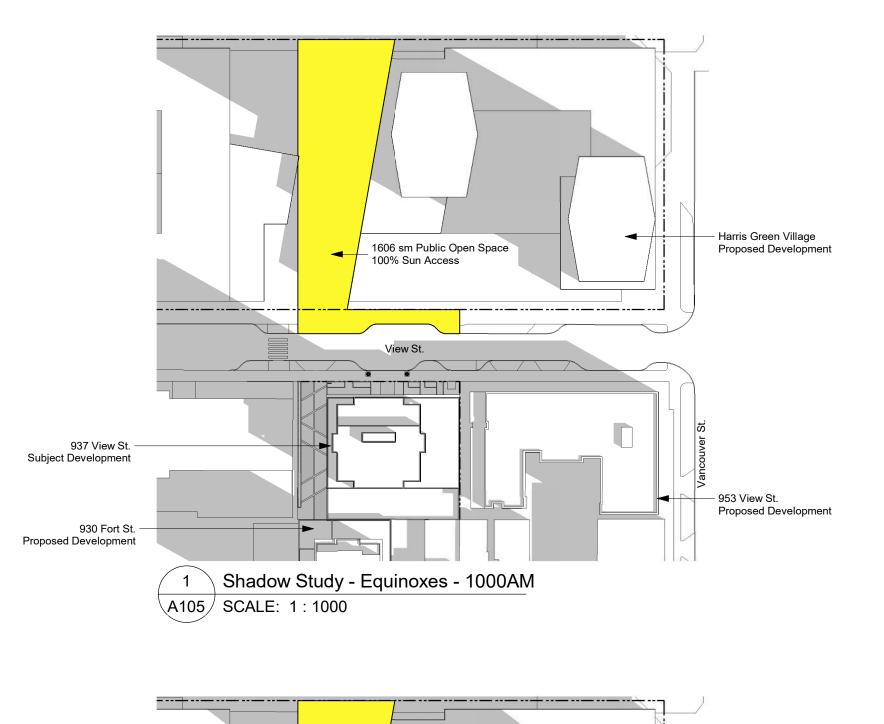
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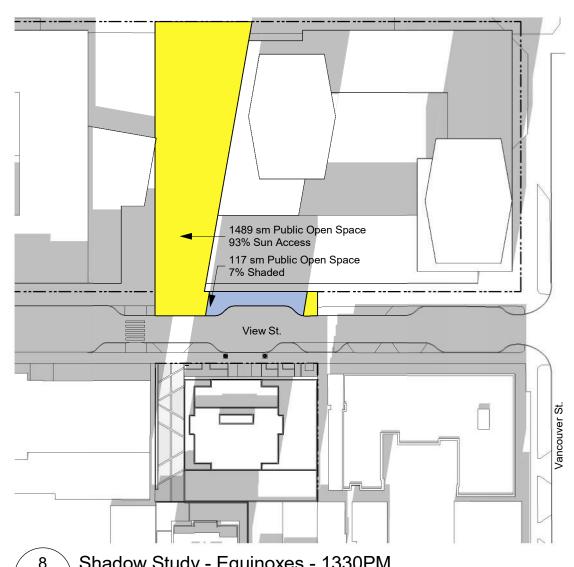
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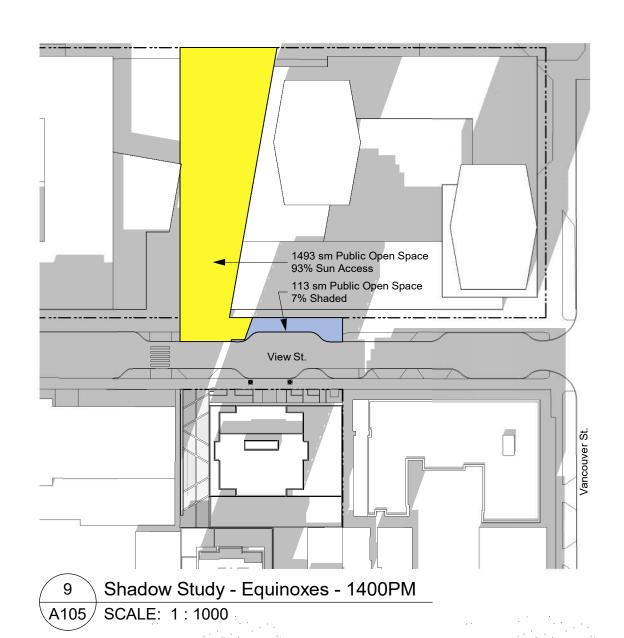


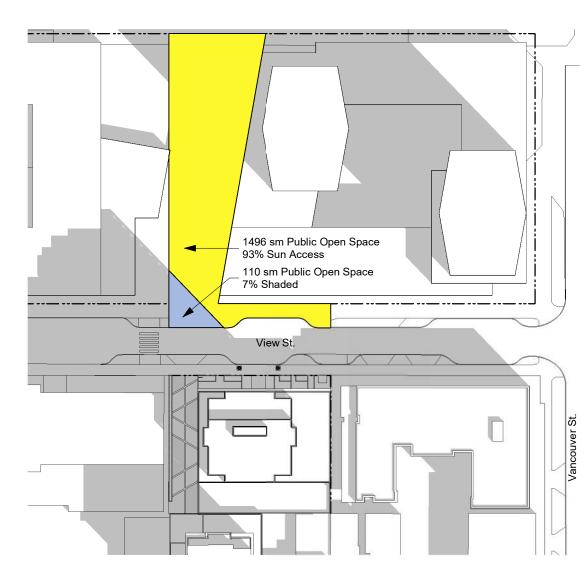


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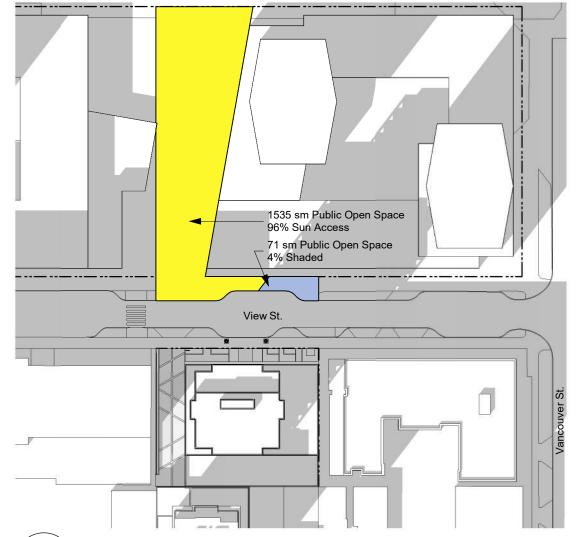


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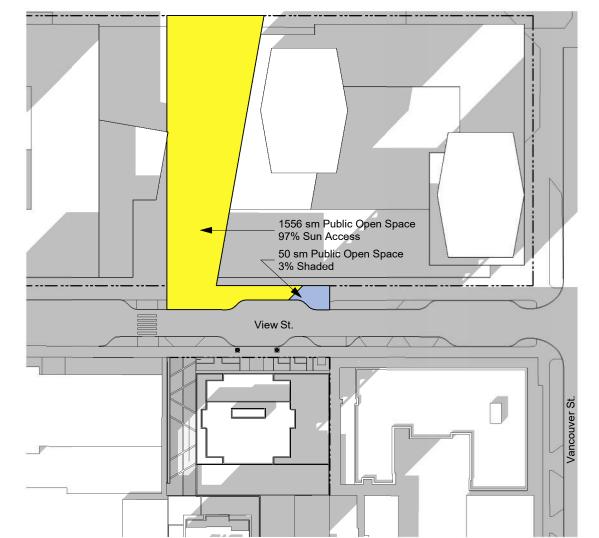


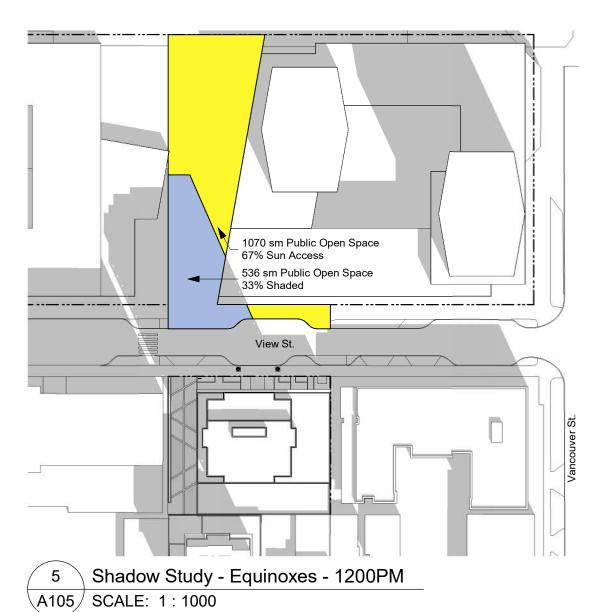
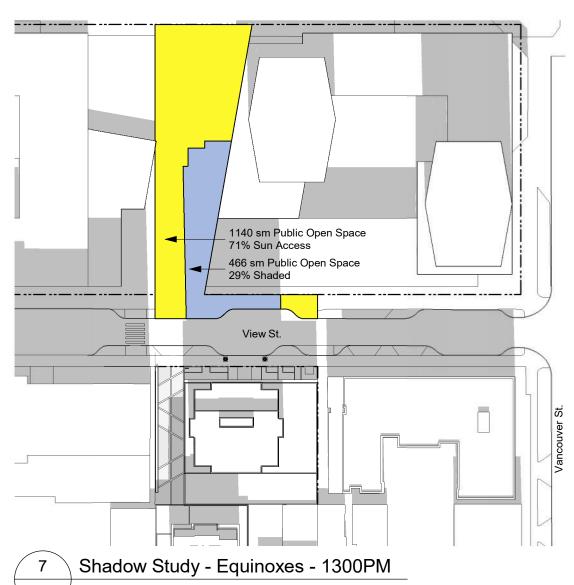
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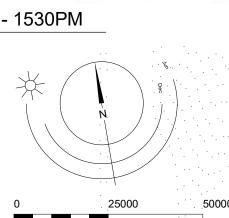


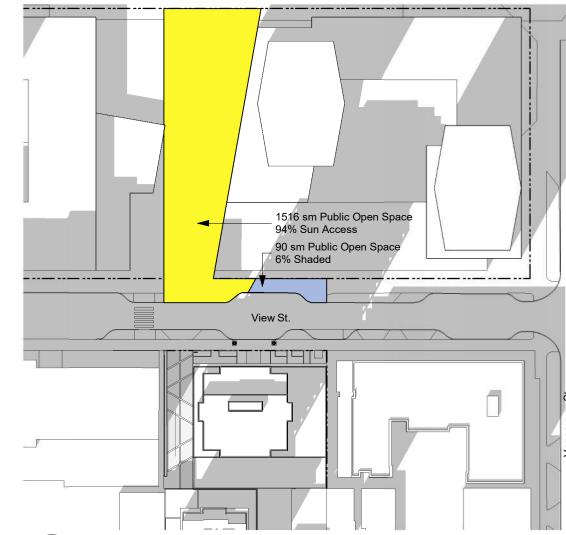11 Shadow Study - Equinoxes - 1500PM A105 SCALE: 1:1000



Shadow Study - Equinoxes - 1530PM

A105 SCALE: 1:1000



1:1000

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21-05-04 20-08-12

20-01-08

19-10-02

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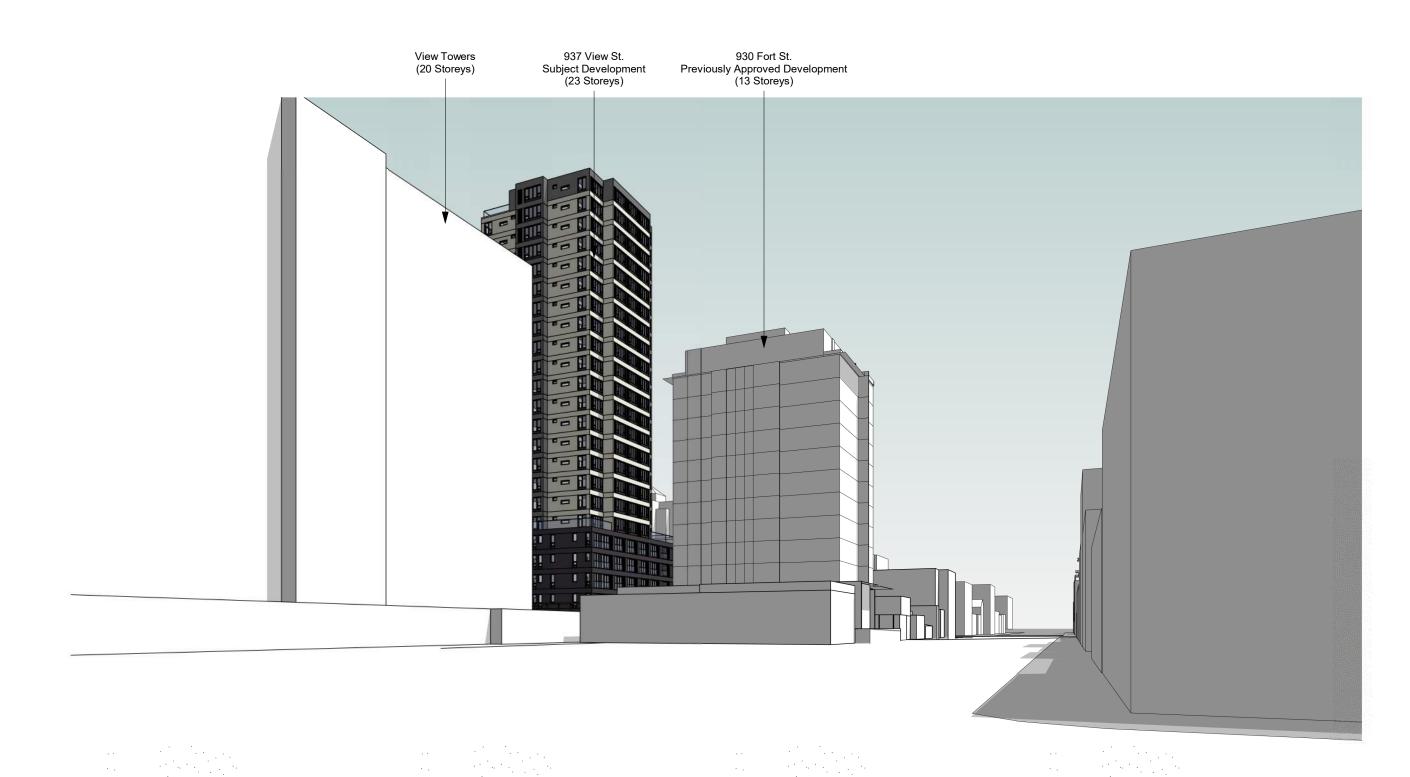
937 View Street


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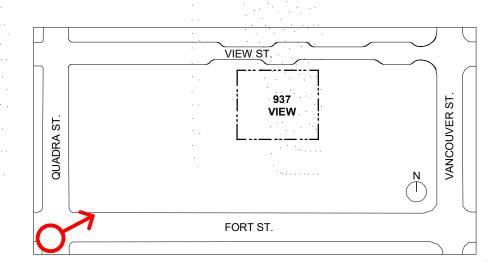



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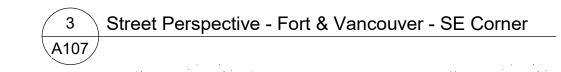
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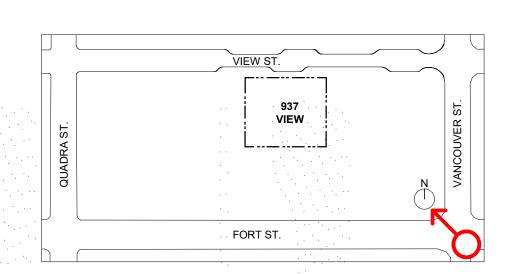










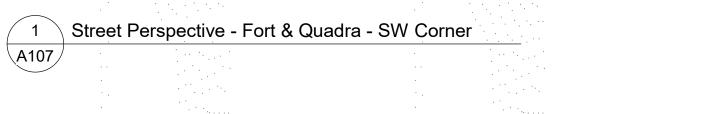


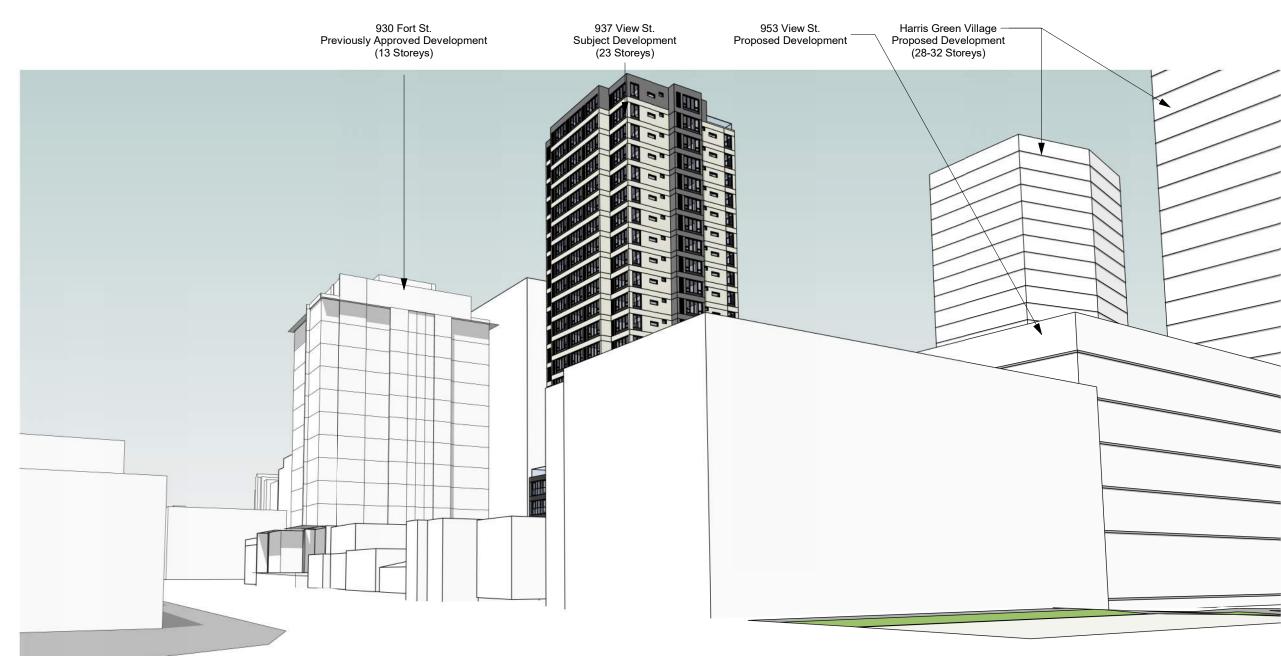

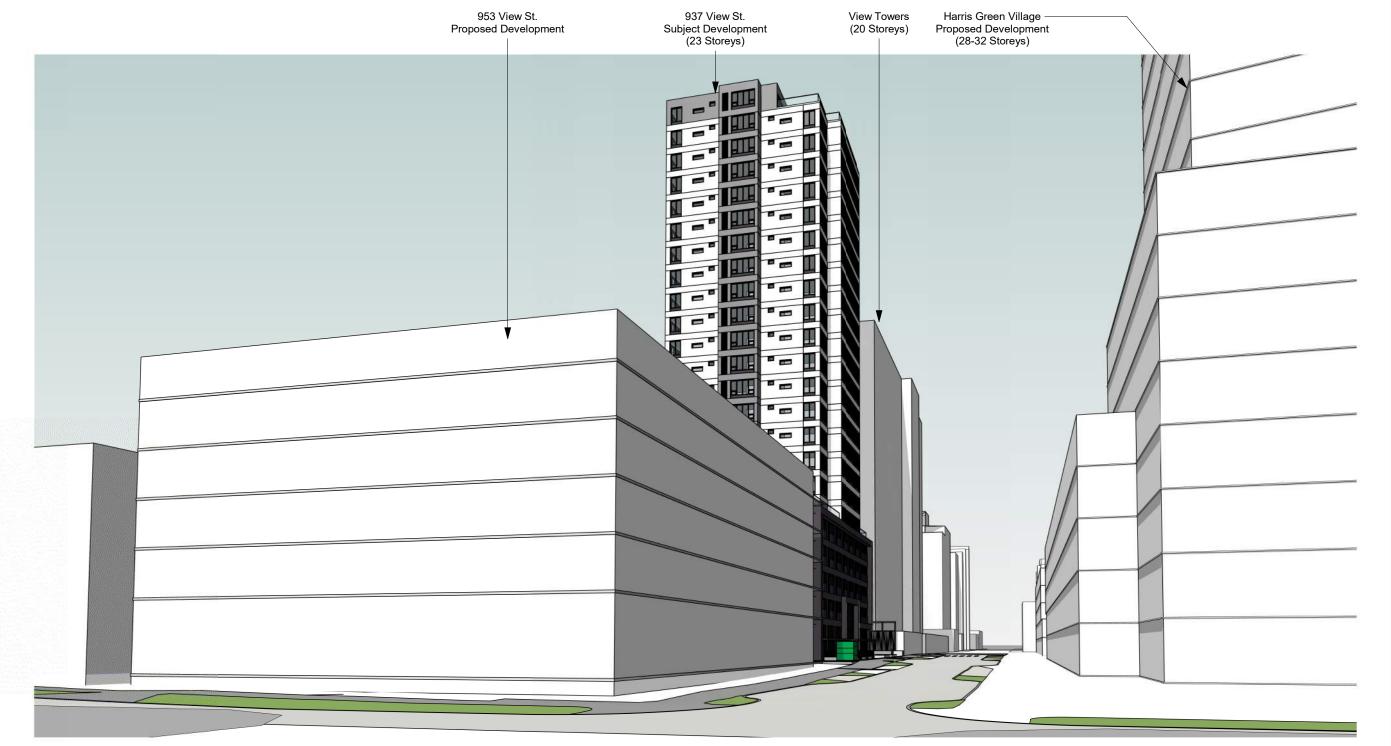


2 Street Perspective - View & Vancouver - NE Corner

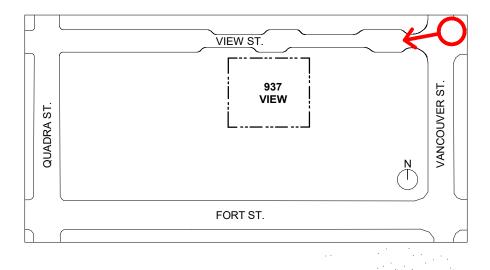

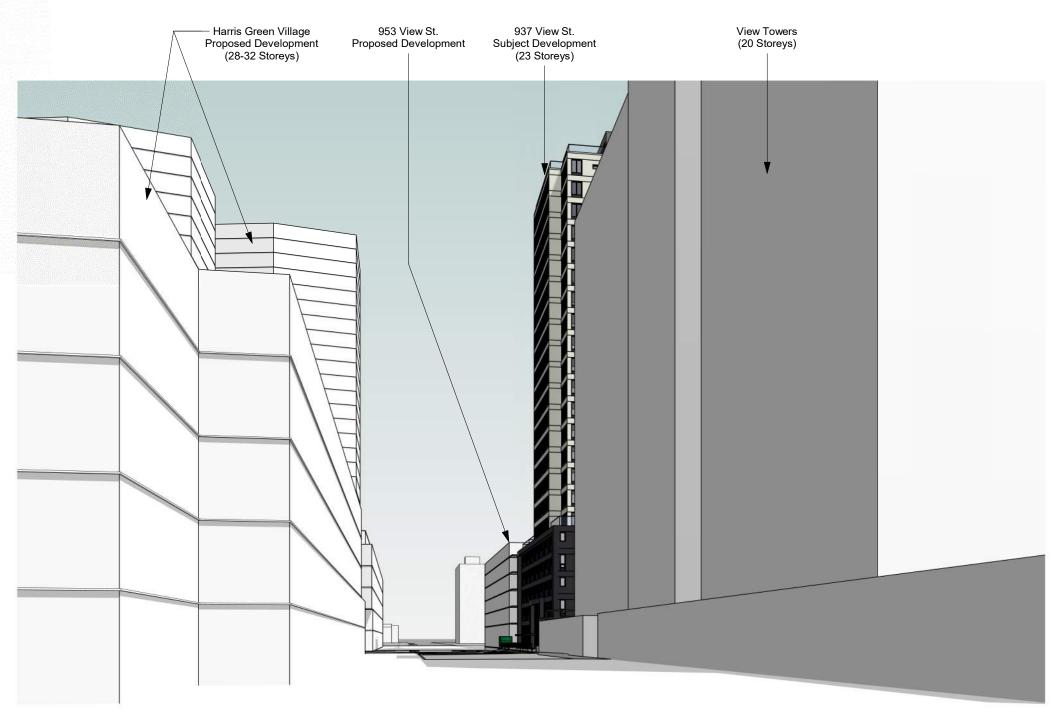

Street Perspective - View & Quadra - NW Corner

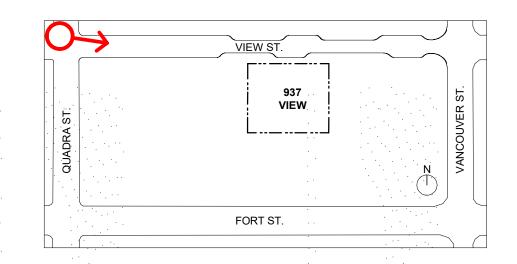

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20-08-12 Issued for DP Revisions 2
20-01-08 Issued for DP Revisions 1
19-10-02 Issued for DP

Plot Date 23-05-09 Drawing File

Drawn By RCI Checked By

Scale 1: 2000 Project Number

View St. Residential

937 View Street

Site Context - Street Views



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V8V 3K3



Street Elevation - North

∖A108 / SCALE: 1 : 300.

21-12-20 21-05-04 20-08-12 Issued for DP Revisions 2 20-01-08 19-10-02


View St. Residentia

937 View Street

Site Context - Street Elevati



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Tempered and Laminated Structural Glass Guardrail w/

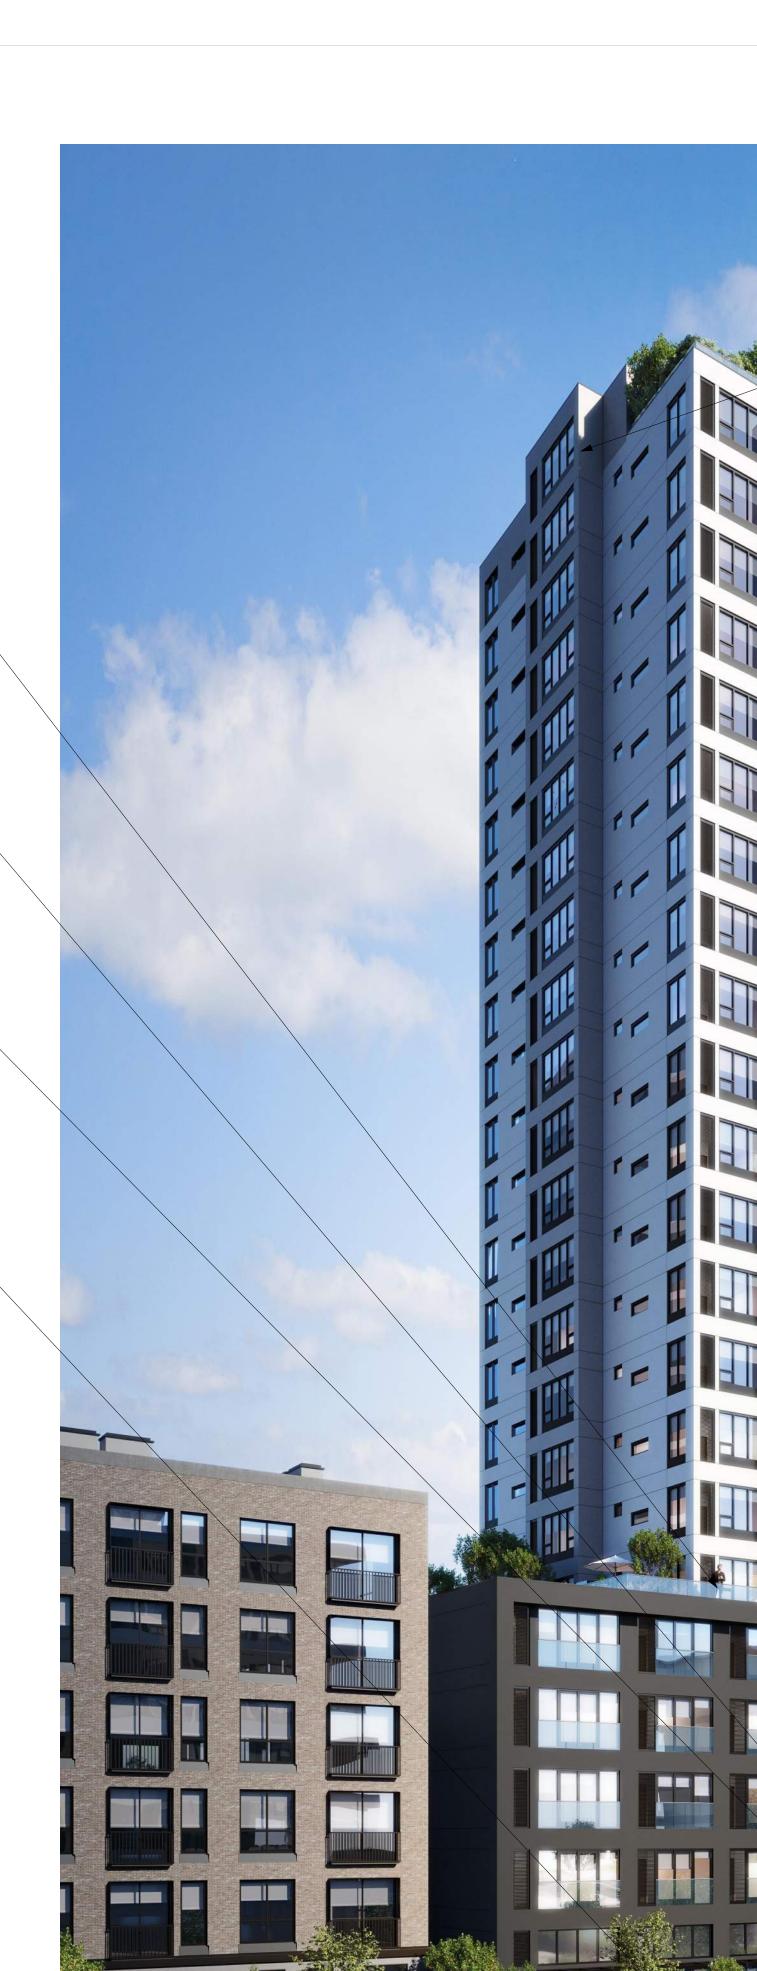Aluminum Cap Rail

Anodized

Dimensional Backlit Address


Window Wall -System w/ Low E


Insulated Glass & LED Coloured

Painted Metal — Gates, Trellis, Guards & Fencing

Backlit Feature

Signage

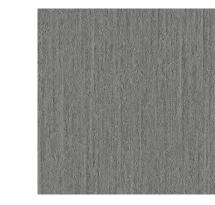

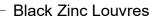


Rainscreen PanelSystem - Gray



Rainscreen Panel System - White



─ Black Zinc Flashing

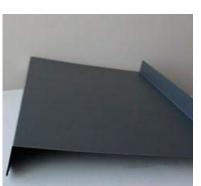

Low E Insulated windows



Rainscreen Panel System - Dark Gray Textured

Architectural Exposed
 Concrete
 Benches/Planters



027 \ /; avv Ctra at

937 View Street

Site Context -

21-05-04 20-08-12

20-01-08

19-10-02



2023-09-18

View St. Residential

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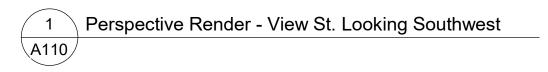
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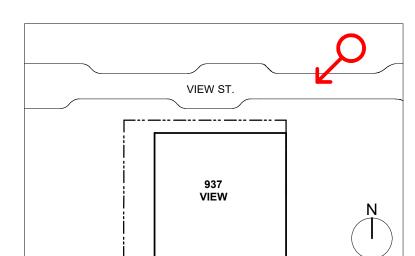
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Victoria


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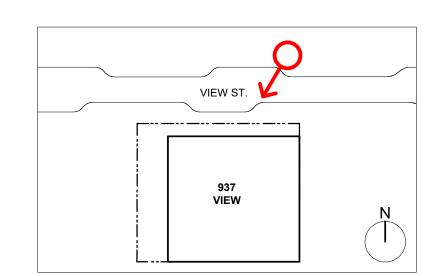








Perspective Rendering - L6 Terraces Overlooking View St
A110

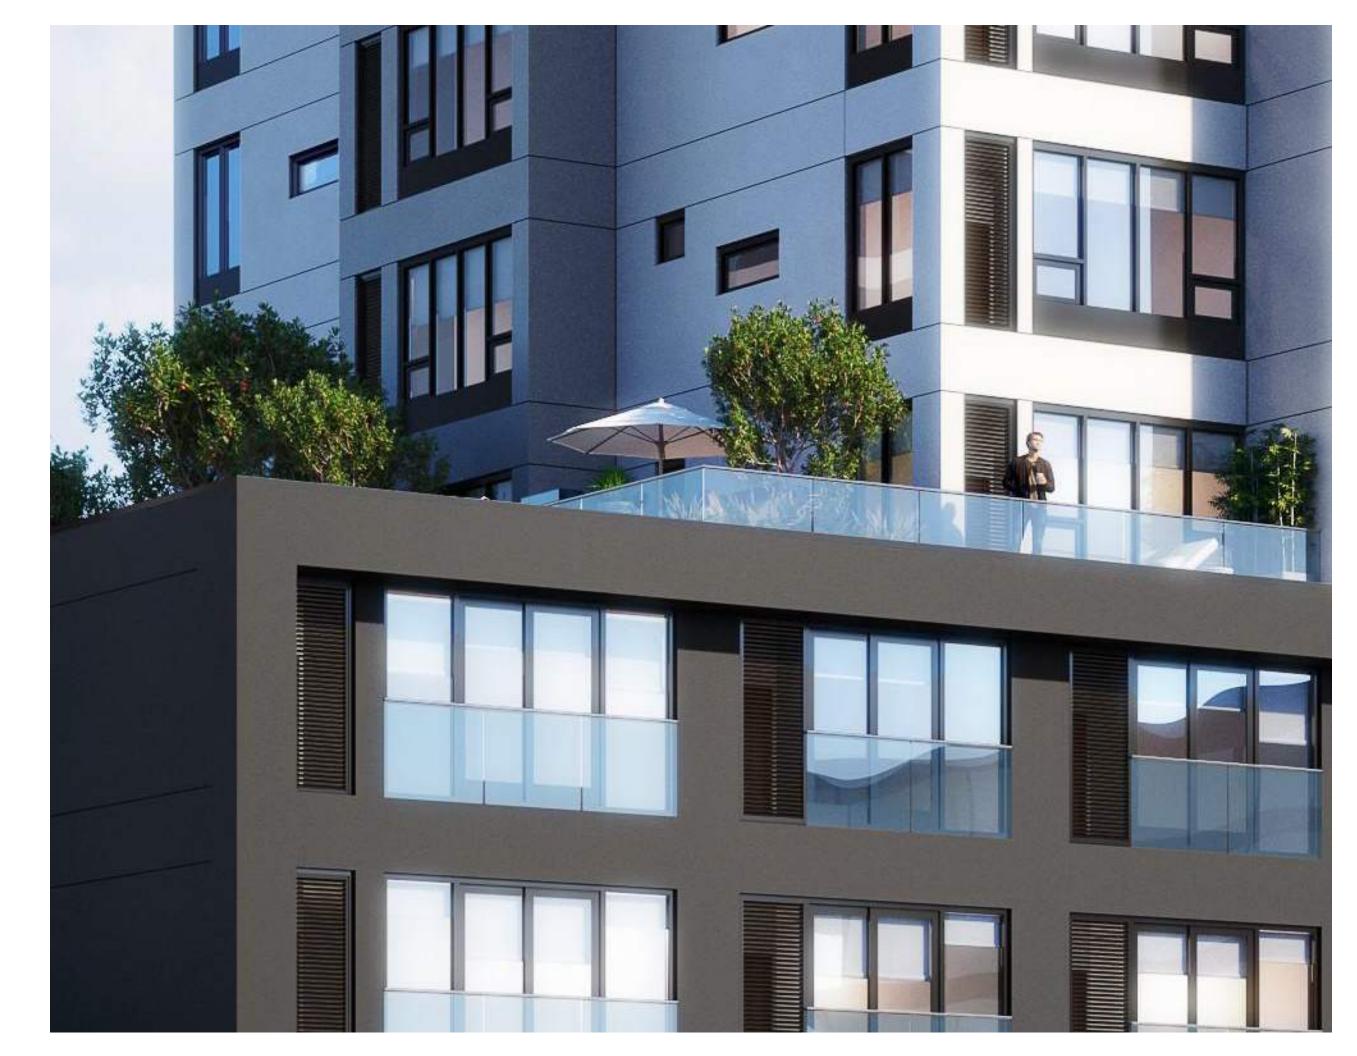

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View St. Residential


937 View Street

Site Context -Rende





Perspective Rendering - Main Entry Interface at View St
A111

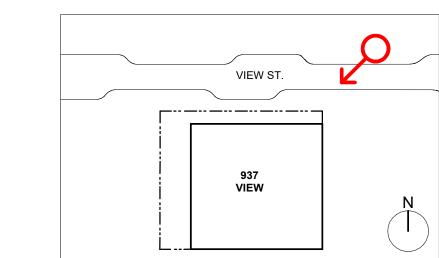

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937 View Street

Site Context -Rende




Victoria 977 Fort Street



Perspective Rendering - Easement Looking at Bike Entry

A112 SCALE: 1:1

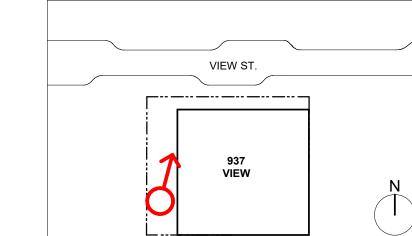

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View St. Residential


937 View Street

Site Context -Rende





1 Perspective Rendering - L6 Amenity Terrace
A113 SCALE: 1:1

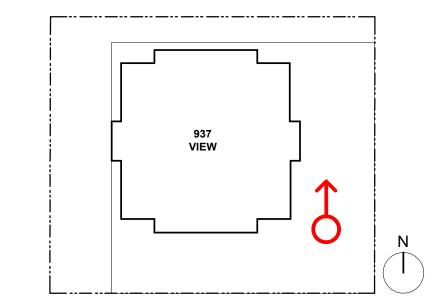

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View St. Residential

937 View Street


Site Context -



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Perspective Rendering - L23 Amenity Terrace
A114




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937 View Street

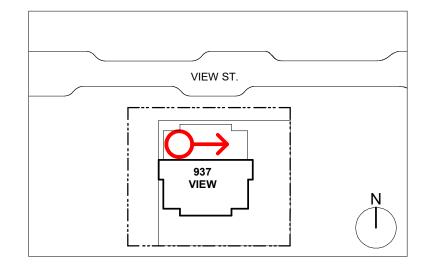Site Context -Rende





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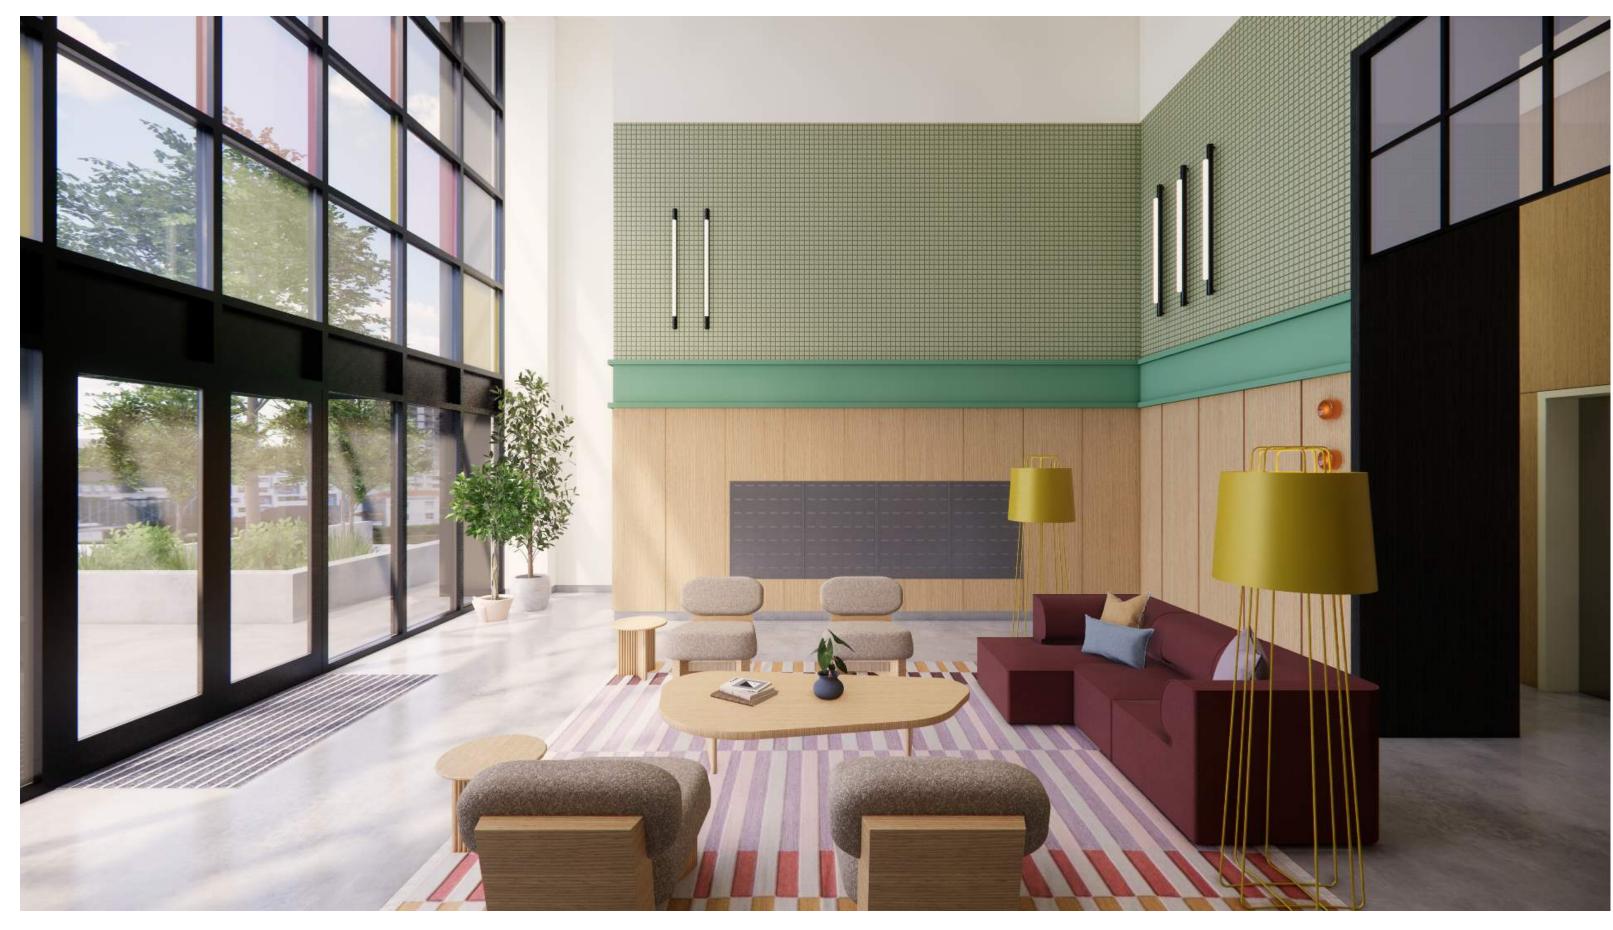
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937 View Street

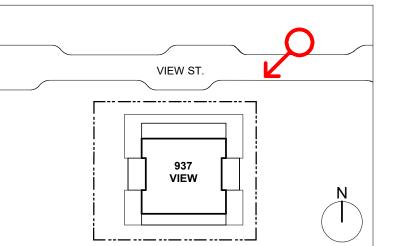Site Context -Rende




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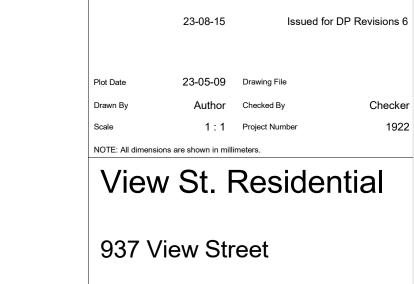


Rendered View of Main Lobby Area - East Elevation

1 Perspective Rendering - Main Lobby Area A117 SCALE: 1:1

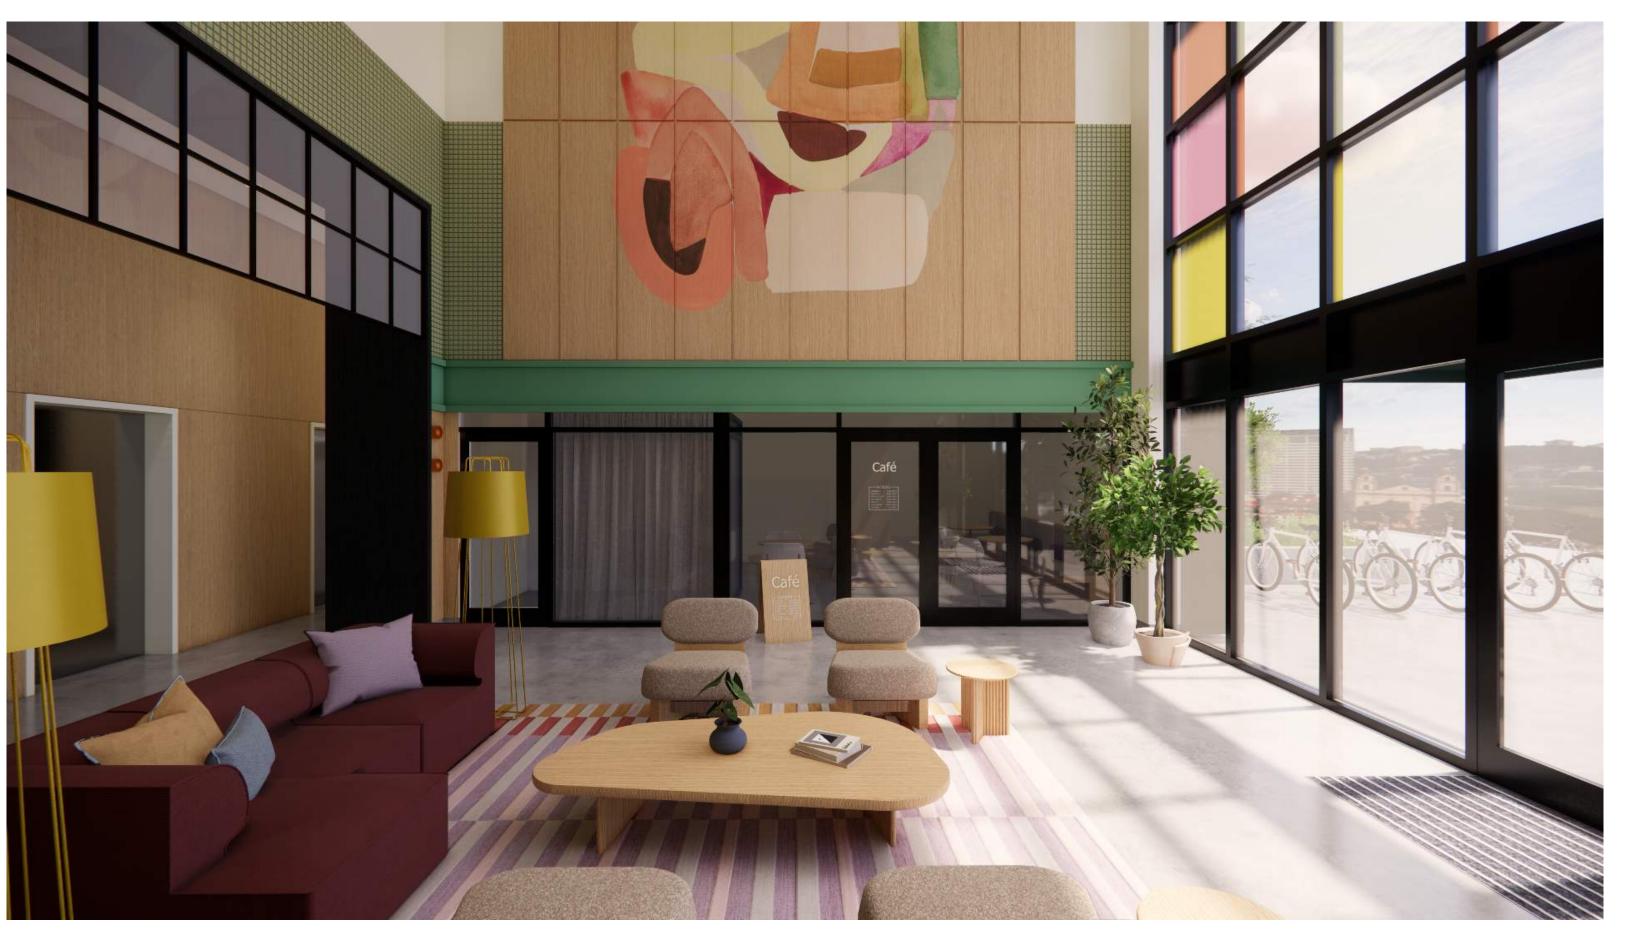


Rendered View of Main Lobby Area - West Elevation



Livability - Rendered Interior



1 3 6 5

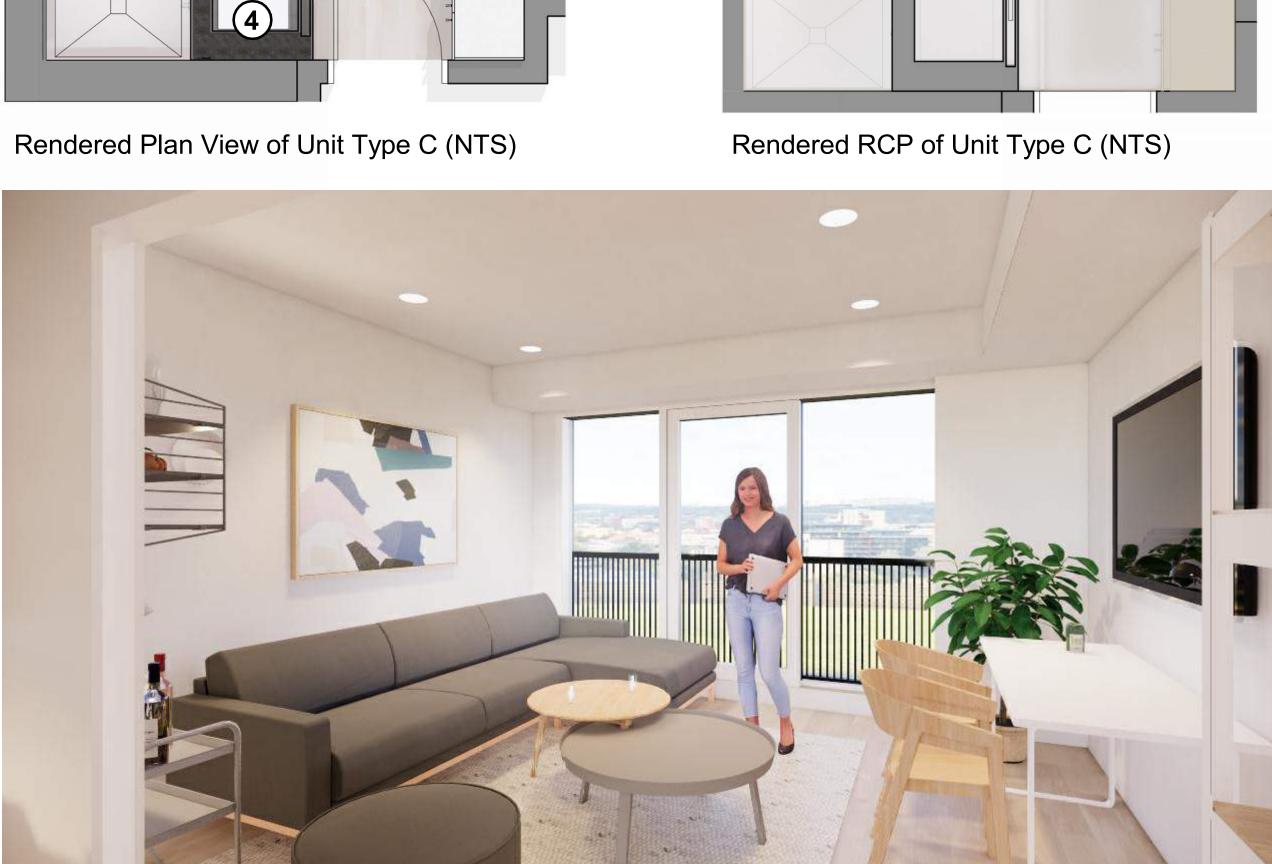

Rendered View of Living Area

TYPICAL UNIT TYPE C

LIVABILITY NOTES

0


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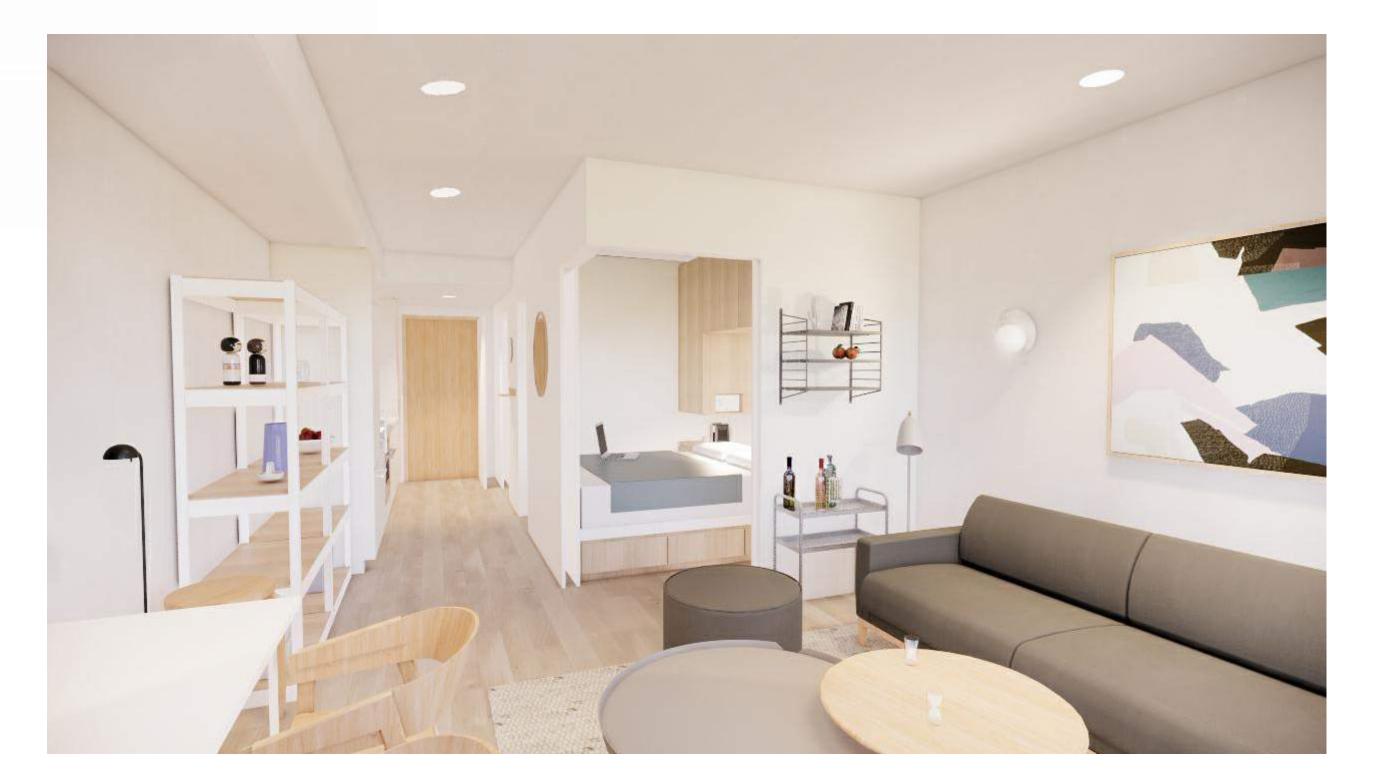
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8


- 33 m sq average size (min 32.16 max 33.09 m sq)
 Juliette Balcony and full height windows on primary elevation for light and air access.
 Built in storage and bedroom furniture.
- 4. W/D in every unit.
- 5. Three piece bathrooms with built in linen storage and medicine cabinets.
 6. Full featured galley style kitchen and cabinets including tub style stailess steel sink, microwave, electric induction range and electric oven.
 7. Living area sized for flexibility with prewired for high speed data / cable.
 8. High ceilings with high performance LED lighting.



Rendered View of Kitchen Area

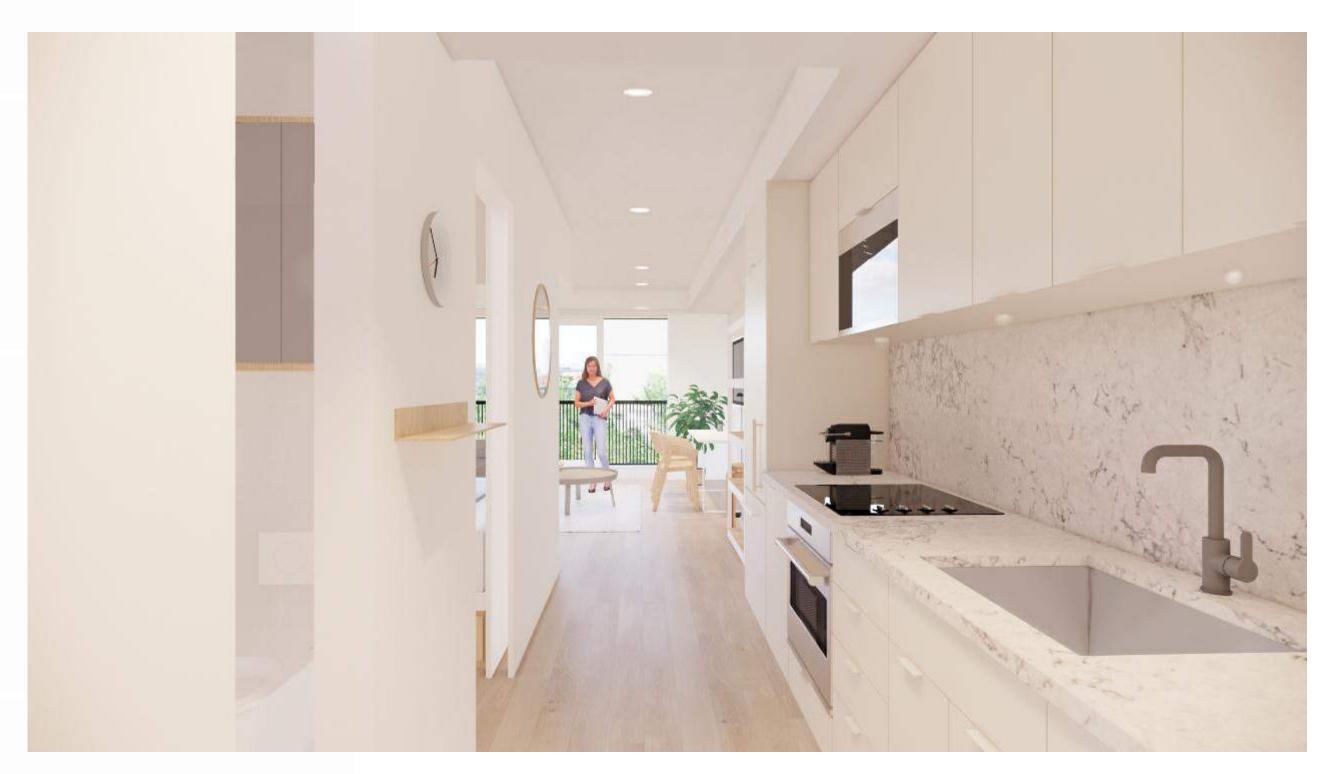

Rendered View of Living and Bedroom Area

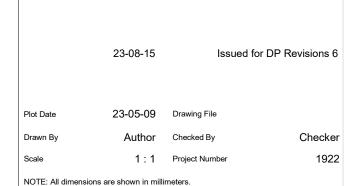


View St. Residential

937 View Street


Livability - Rendered Interior



Victoria 977 Fort Street

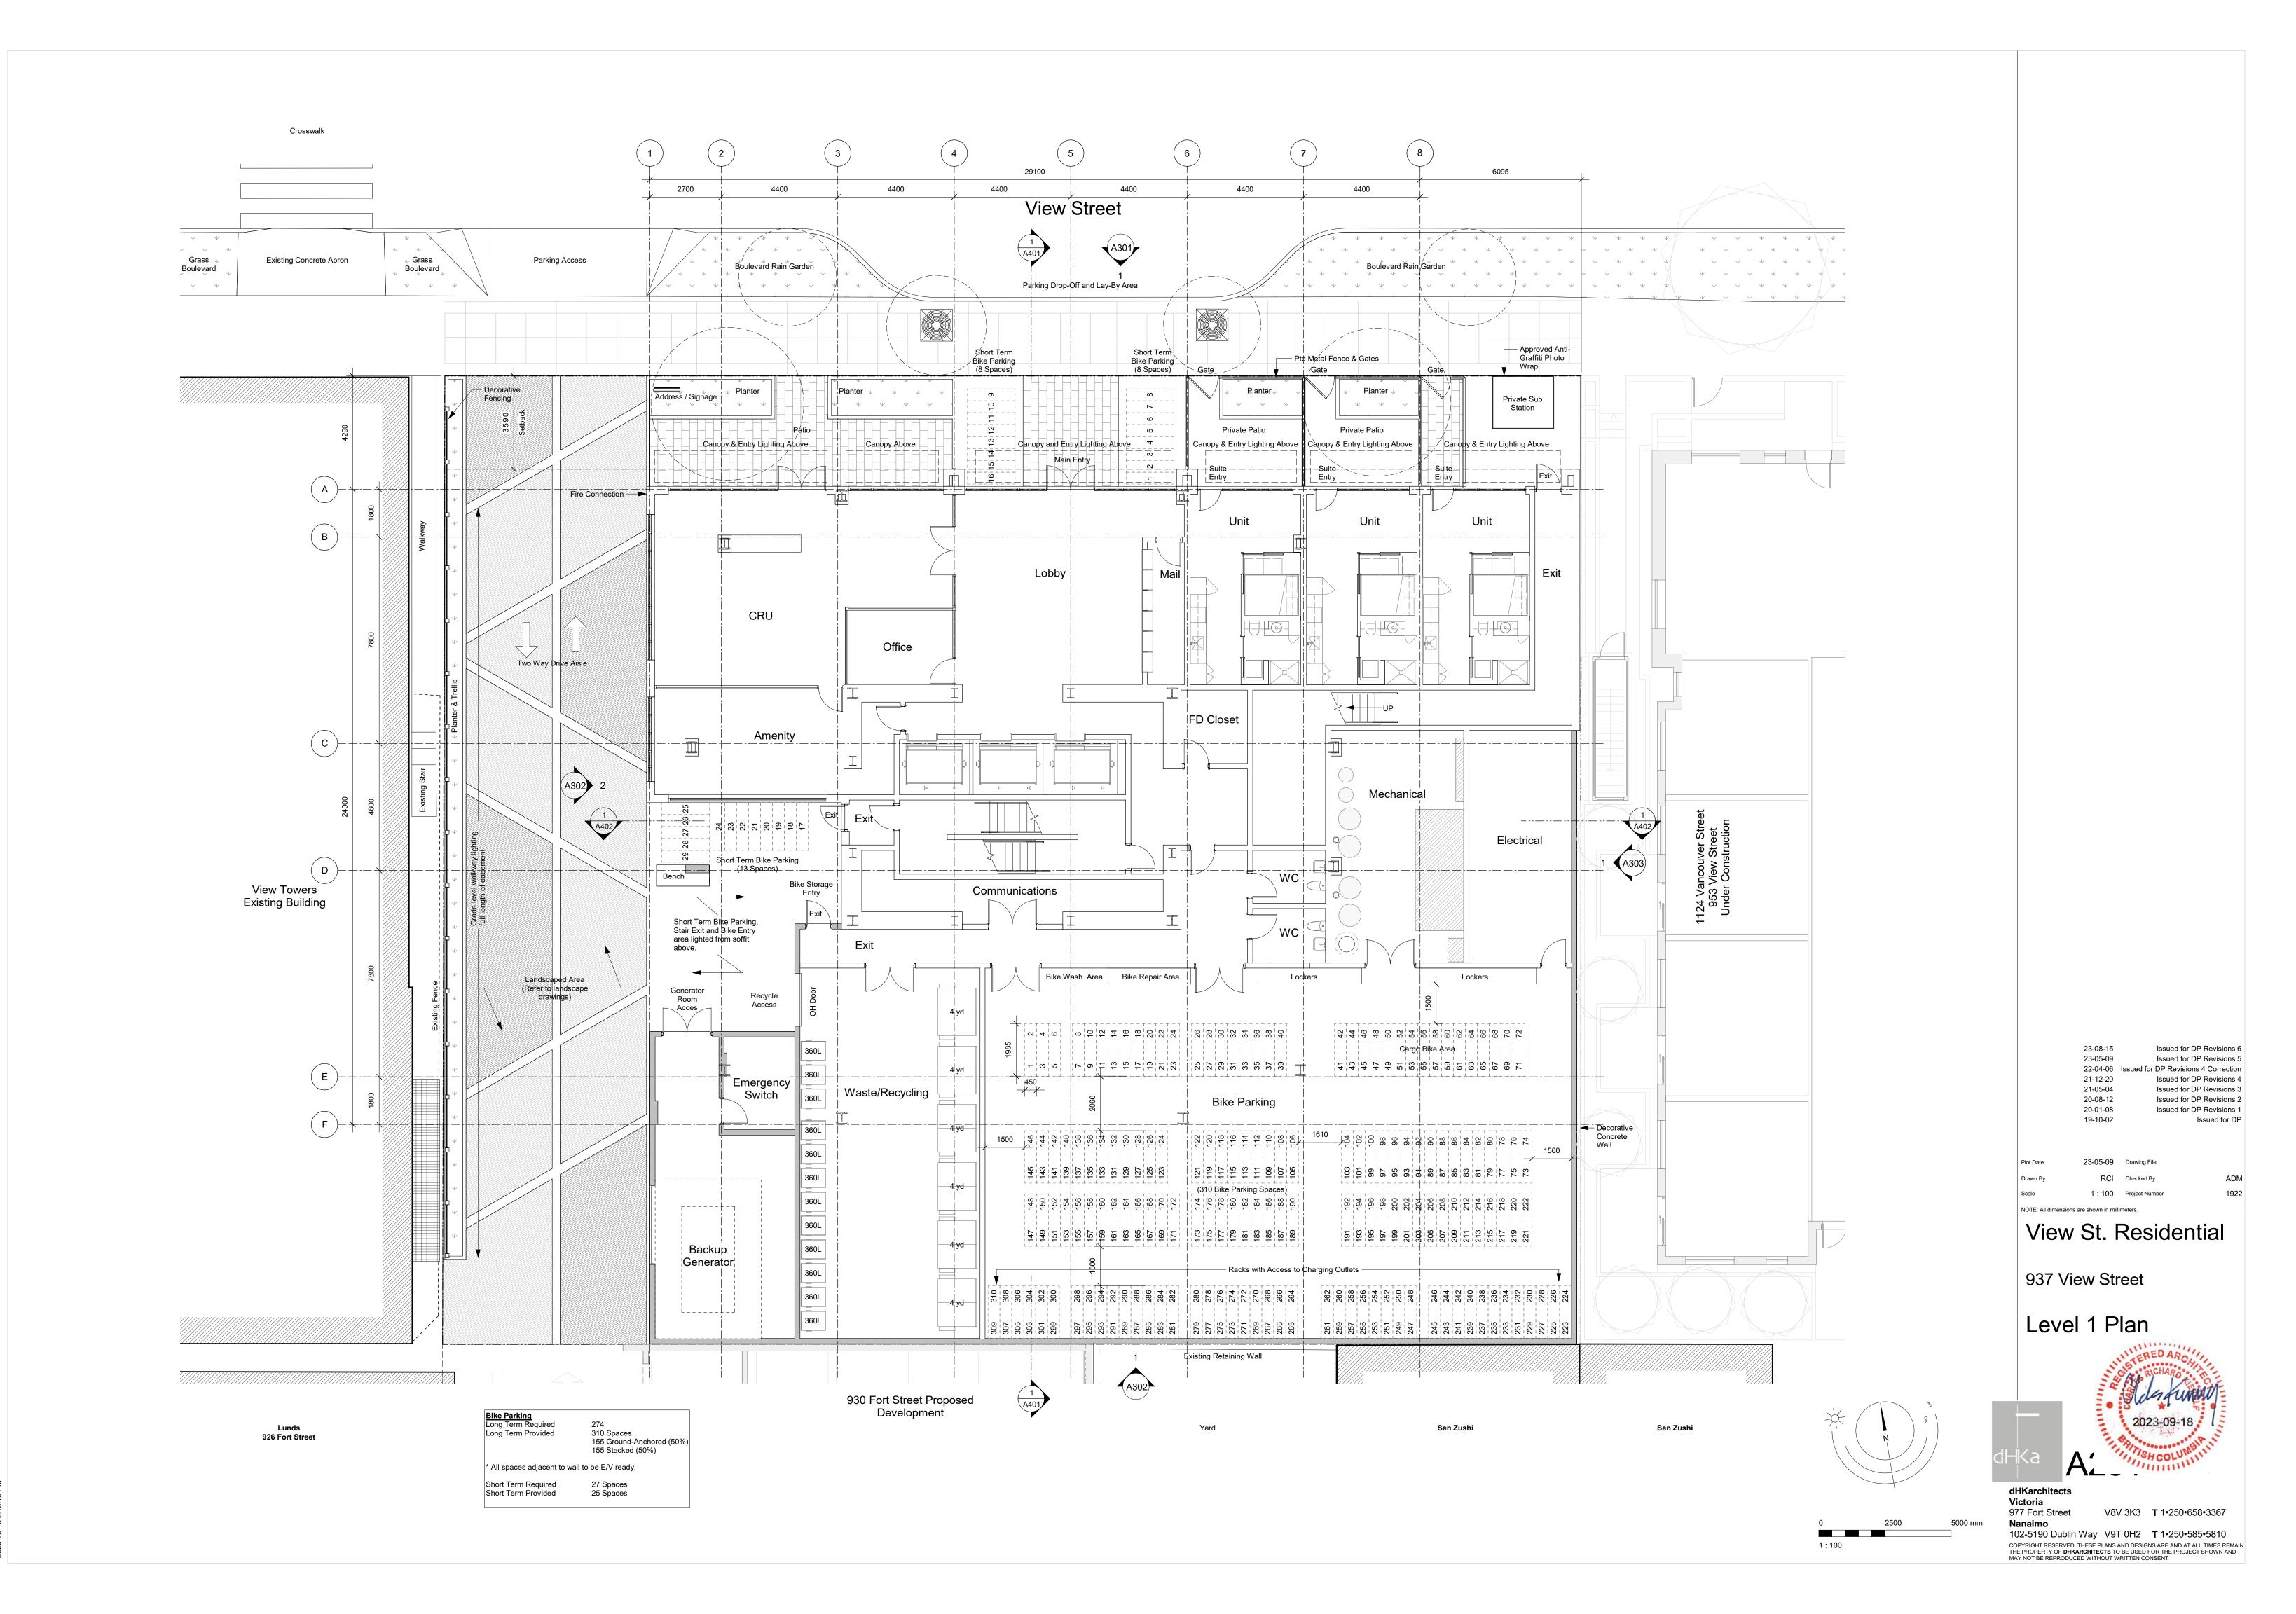

00 18 0.18 10 DM

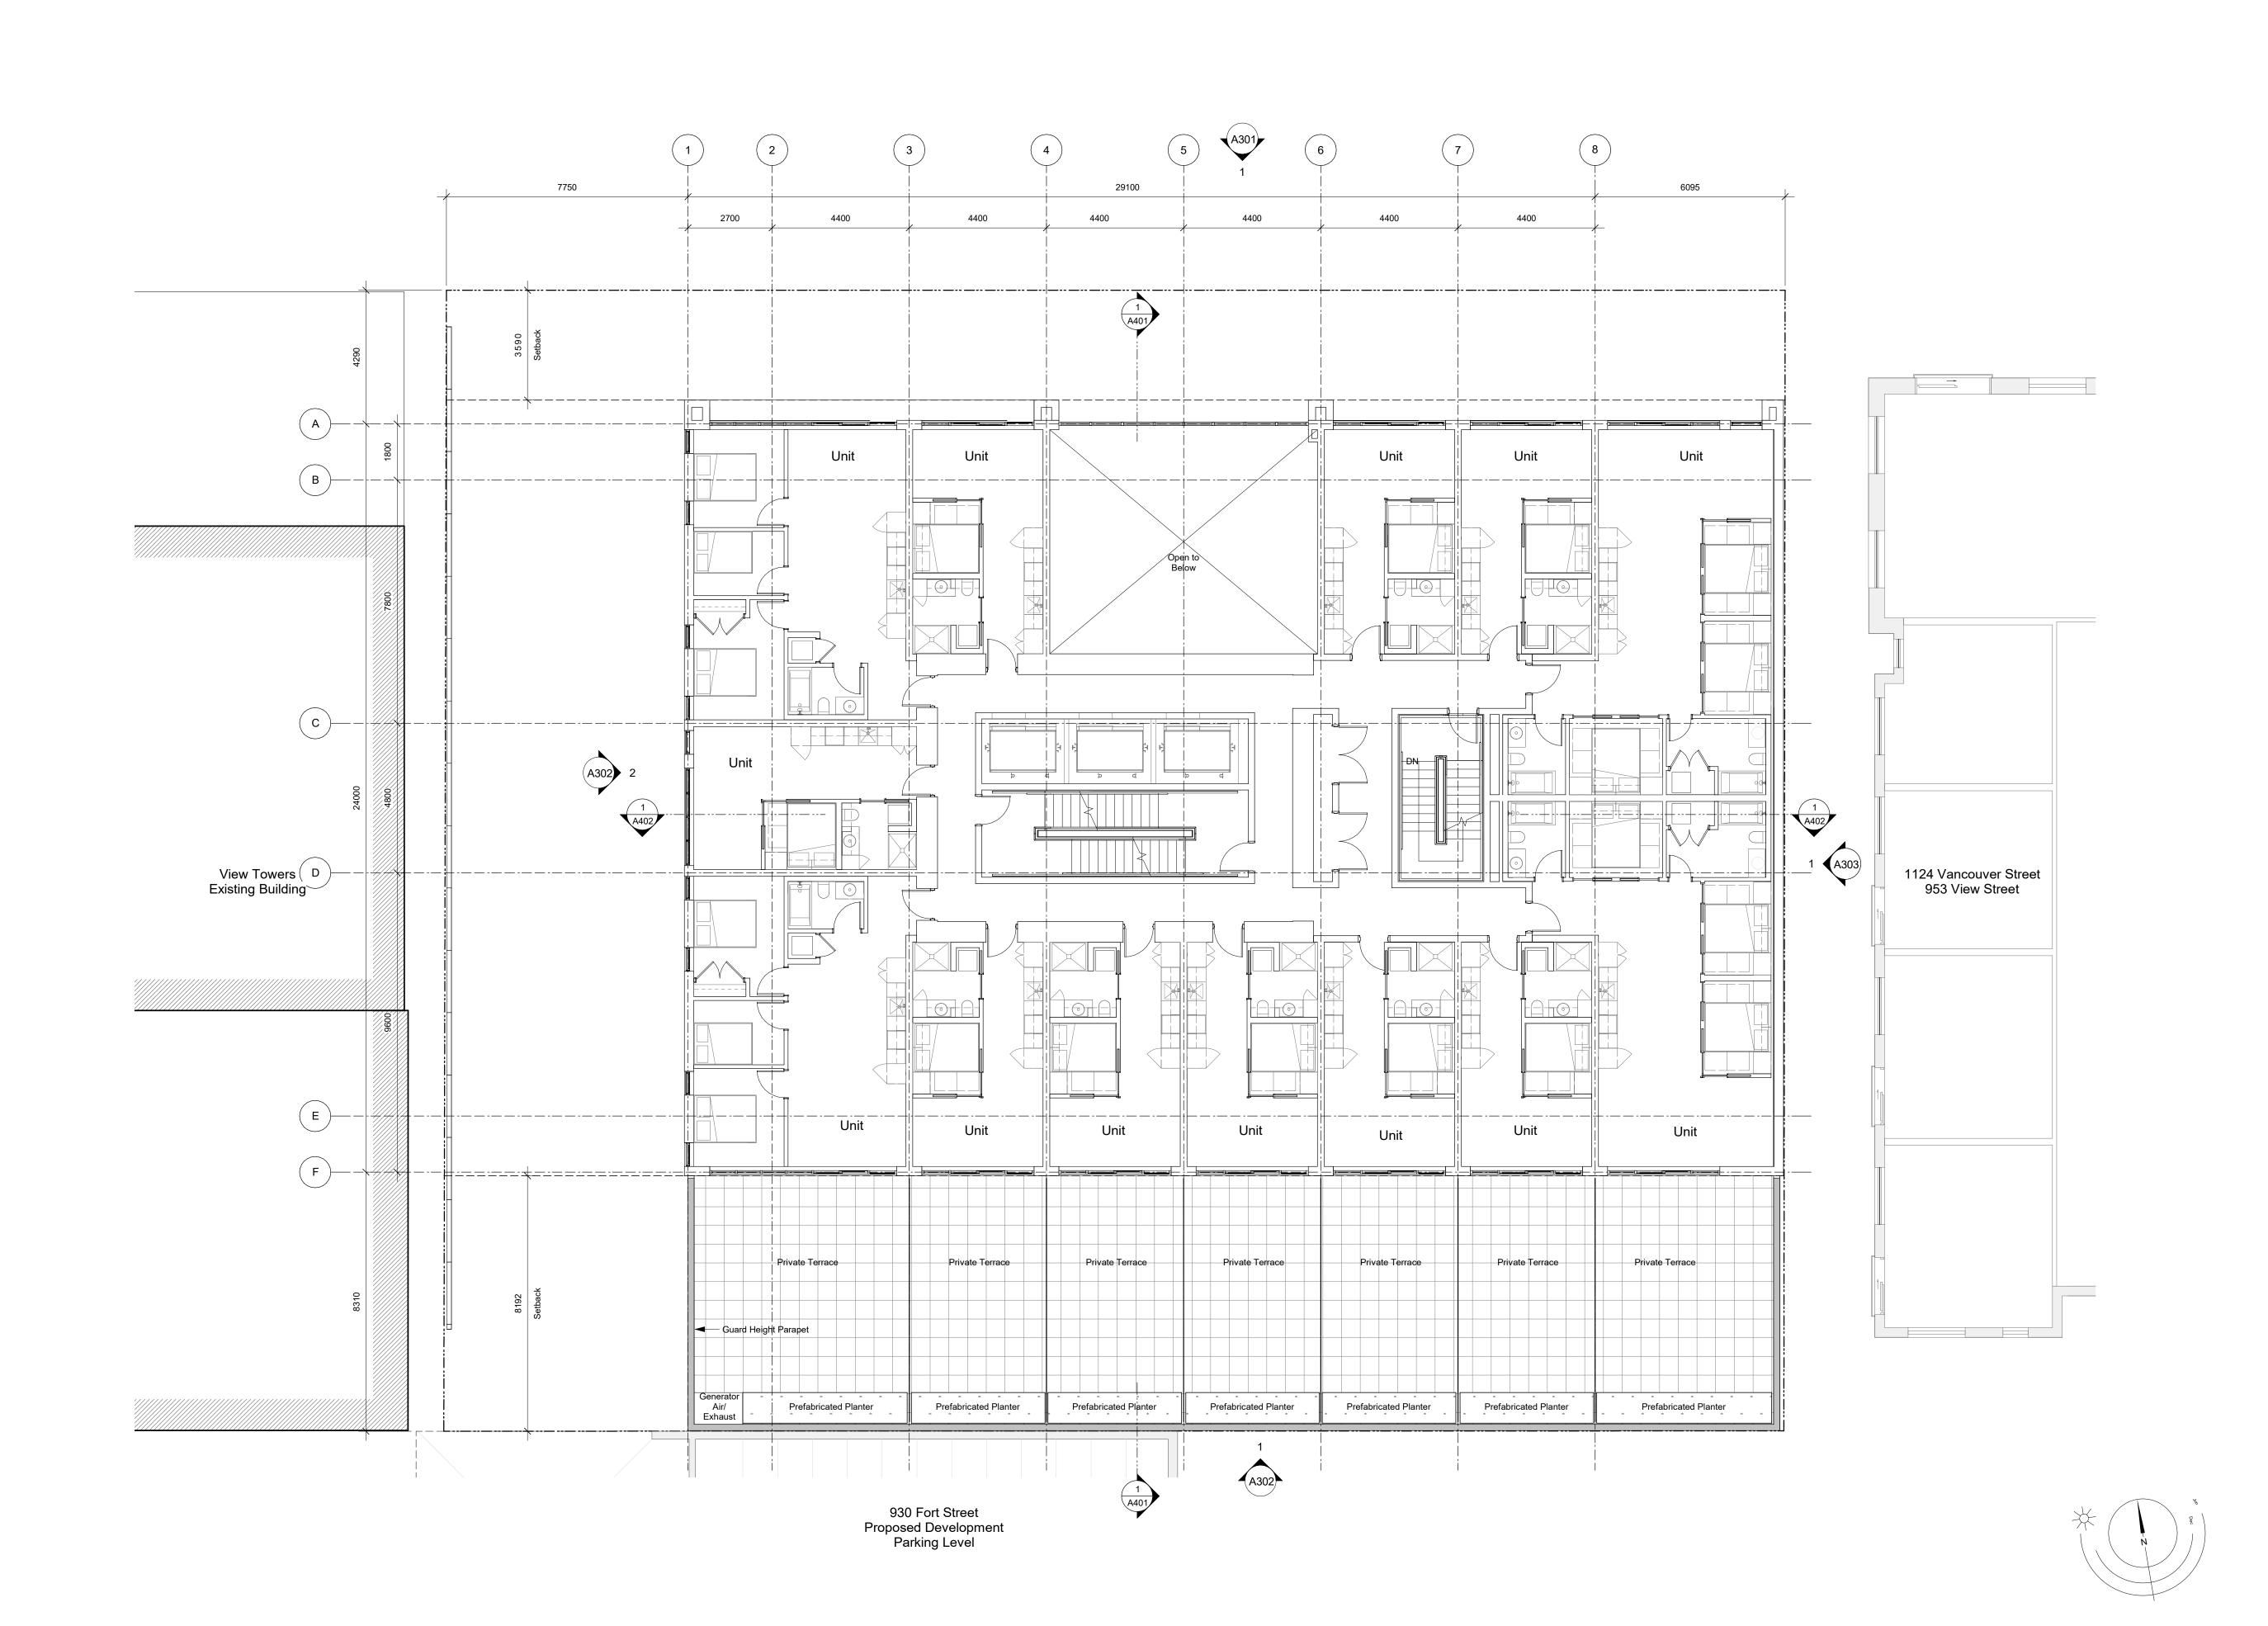

Issued for DP Revisions 6
Issued for DP Revisions 5 23-08-15 23-05-09 21-05-04 20-08-12 20-01-08 Issued for DP Revisions 3 Issued for DP Revisions 2
Issued for DP Revisions 1 19-10-02 Issued for DP

23-05-09 Drawing File

NOTE: All dimensions are shown in millimeters.


View St. Residential

937 View Street

Level 2 Plan



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Issued for DP Revisions 6 23-05-09 Issued for DP Revisions 5 Issued for DP Revisions 3 21-05-04 20-08-12 20-01-08 Issued for DP Revisions 2
Issued for DP Revisions 1 19-10-02

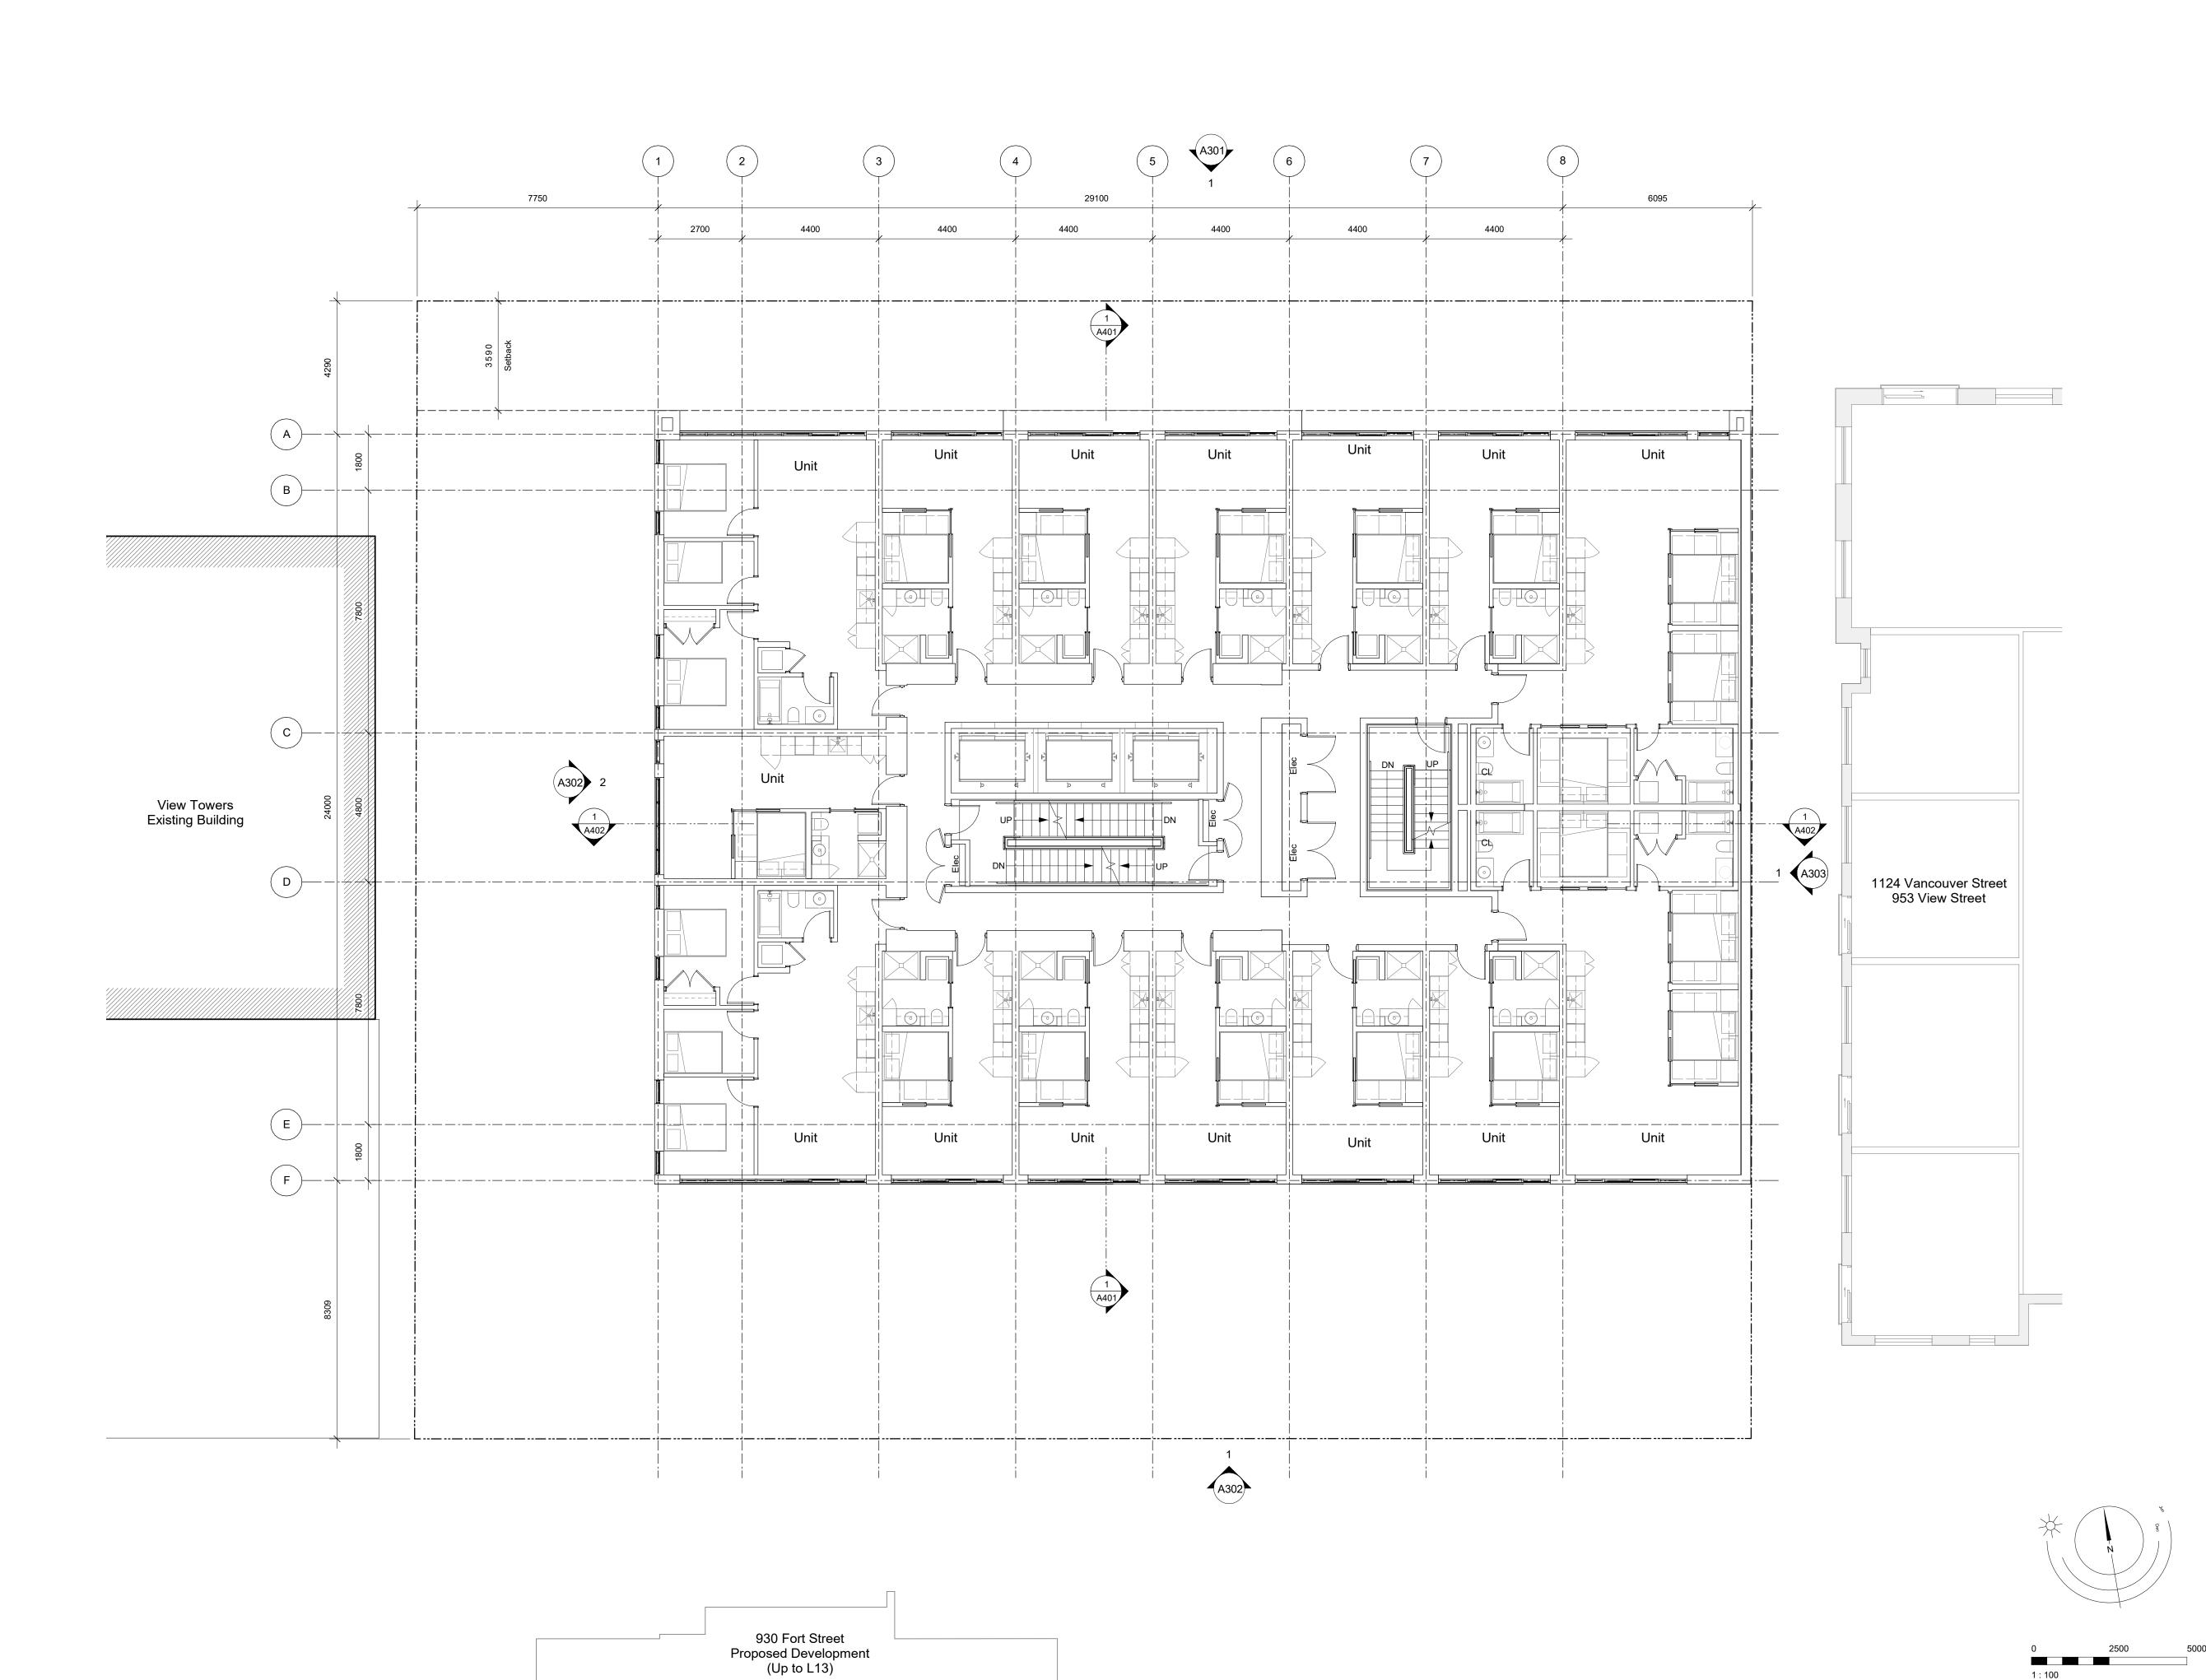
View St. Residential

937 View Street

Levels 3-5 Plan




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Issued for DP Revisions 6 Issued for DP Revisions 5 Issued for DP Revisions 3 Issued for DP Revisions 2 Issued for DP Revisions 1

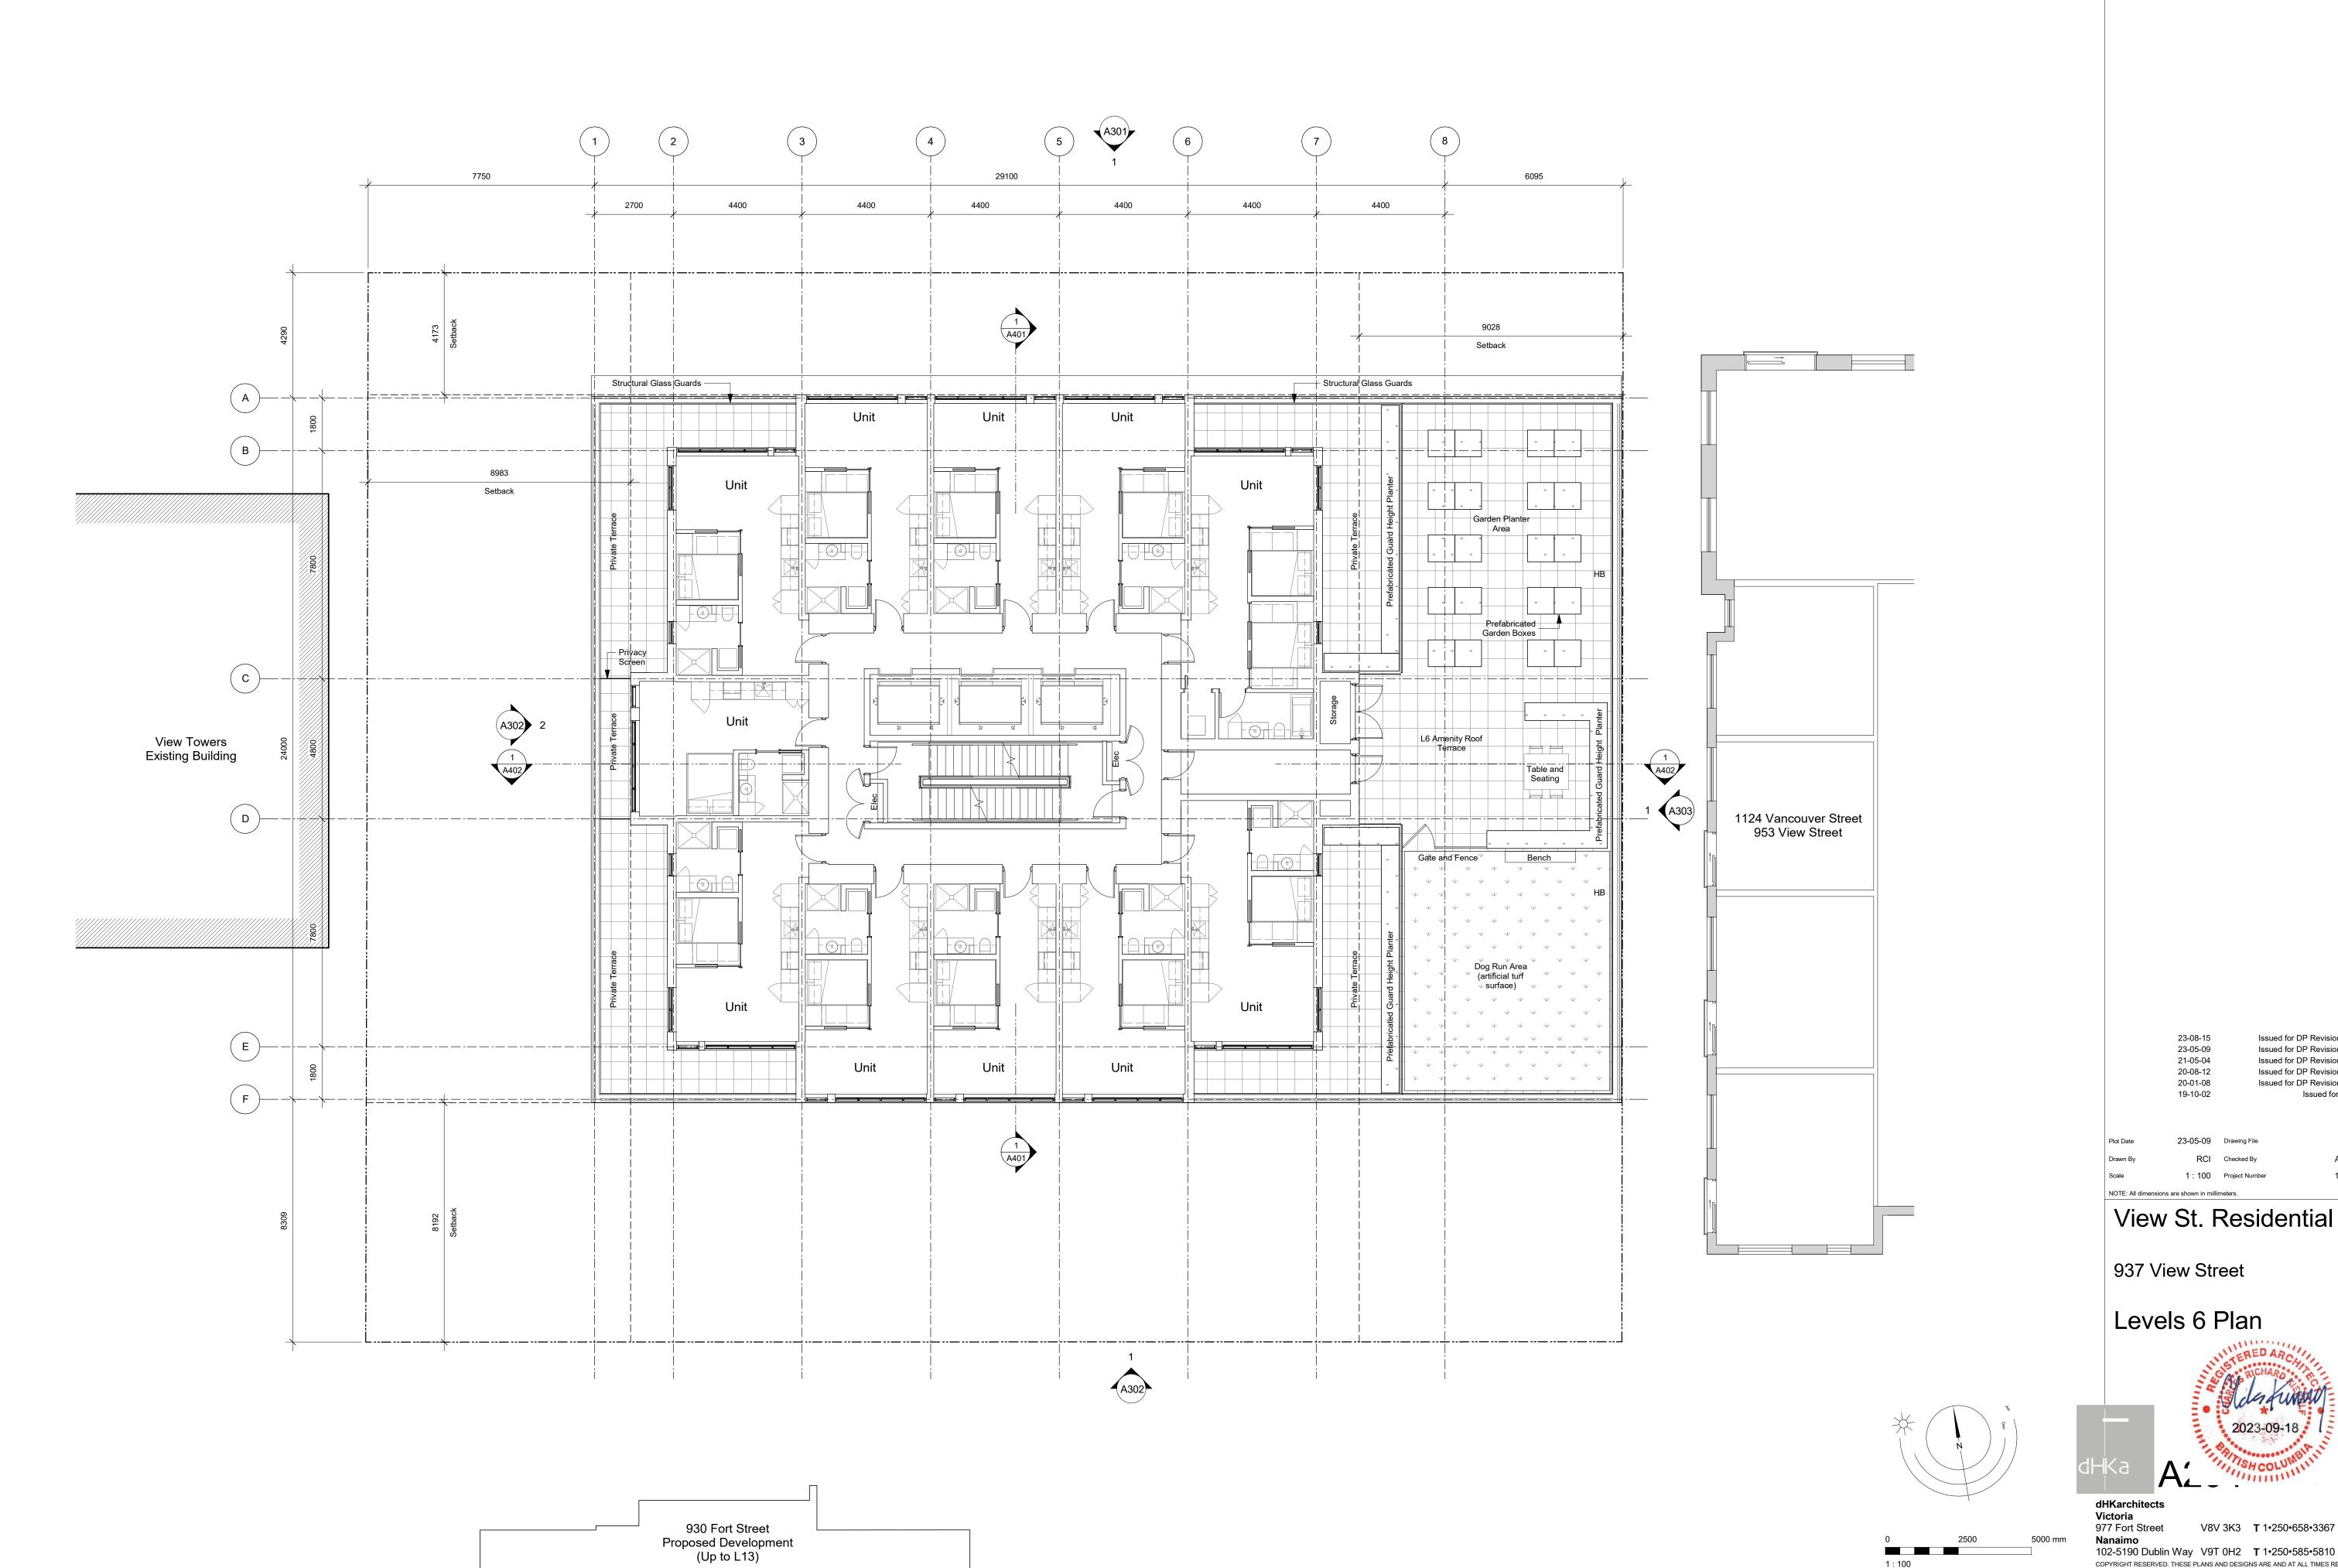



930 Fort Street Proposed Development (Up to L13)

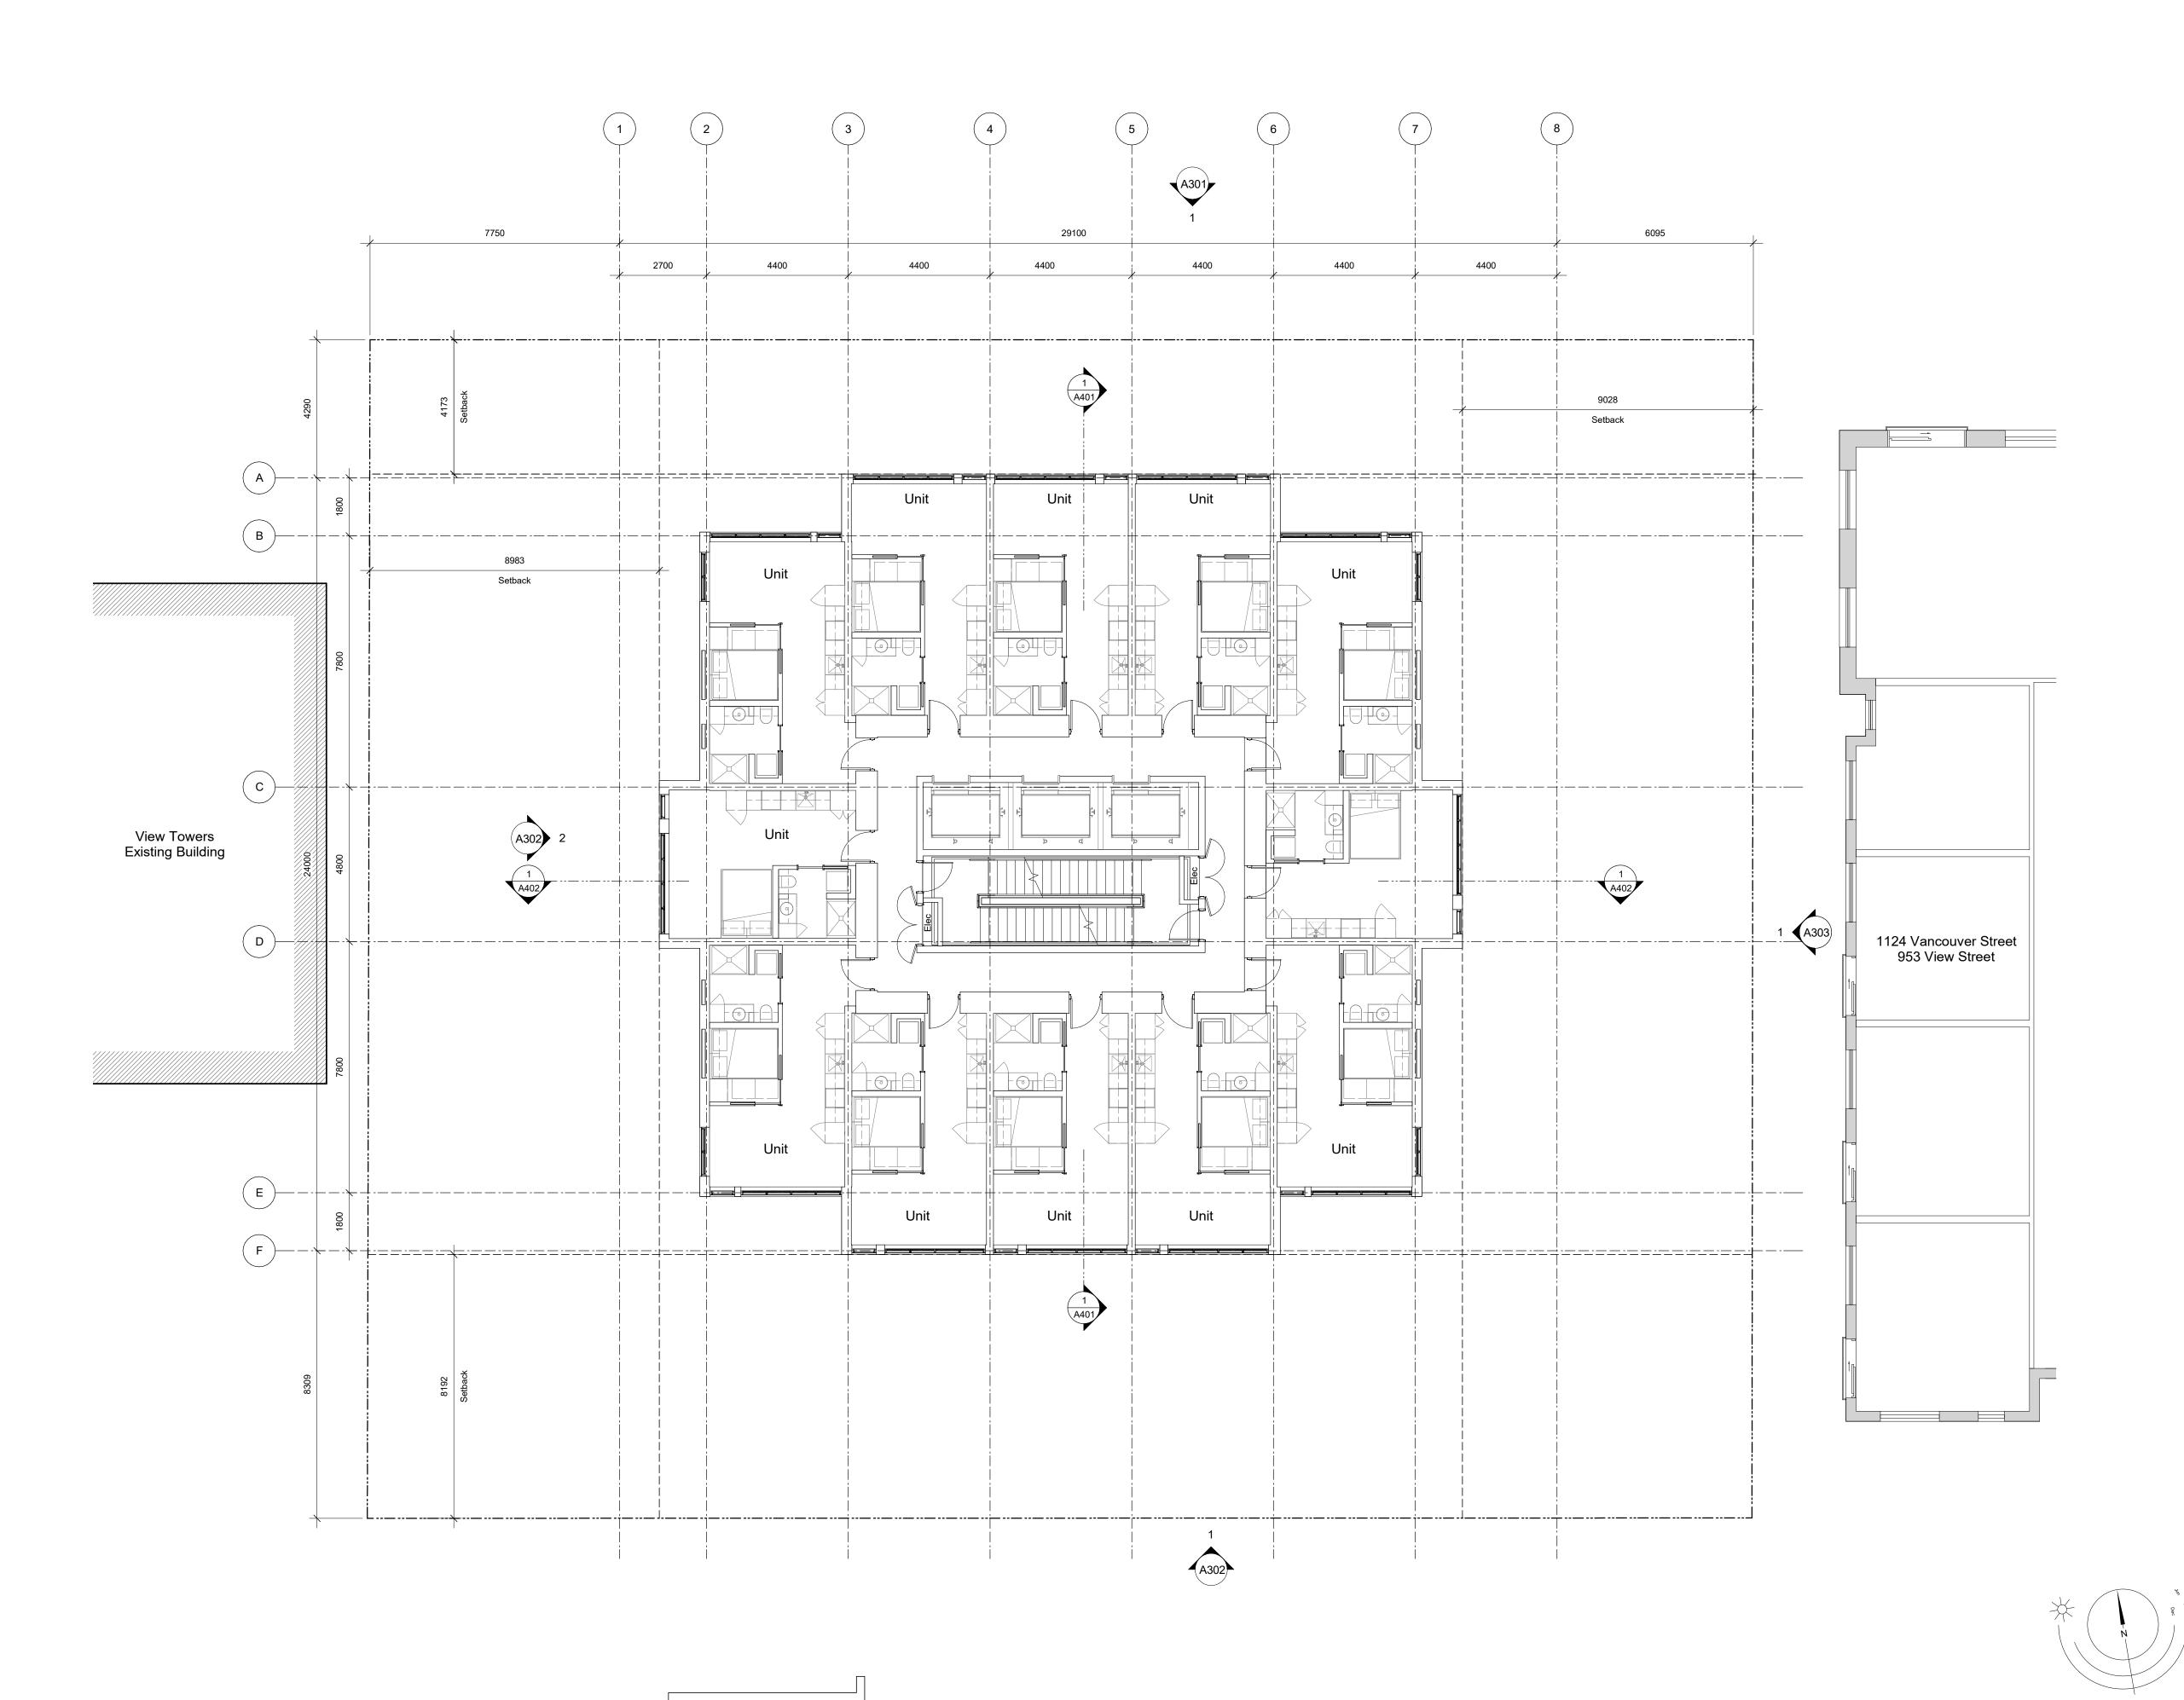Issued for DP Revisions 5 Issued for DP Revisions 3 21-05-04 20-08-12 Issued for DP Revisions 2 20-01-08 Issued for DP Revisions 1 19-10-02


View St. Residential

937 View Street

Levels 7-22 Plan



Victoria 977 Fort Street

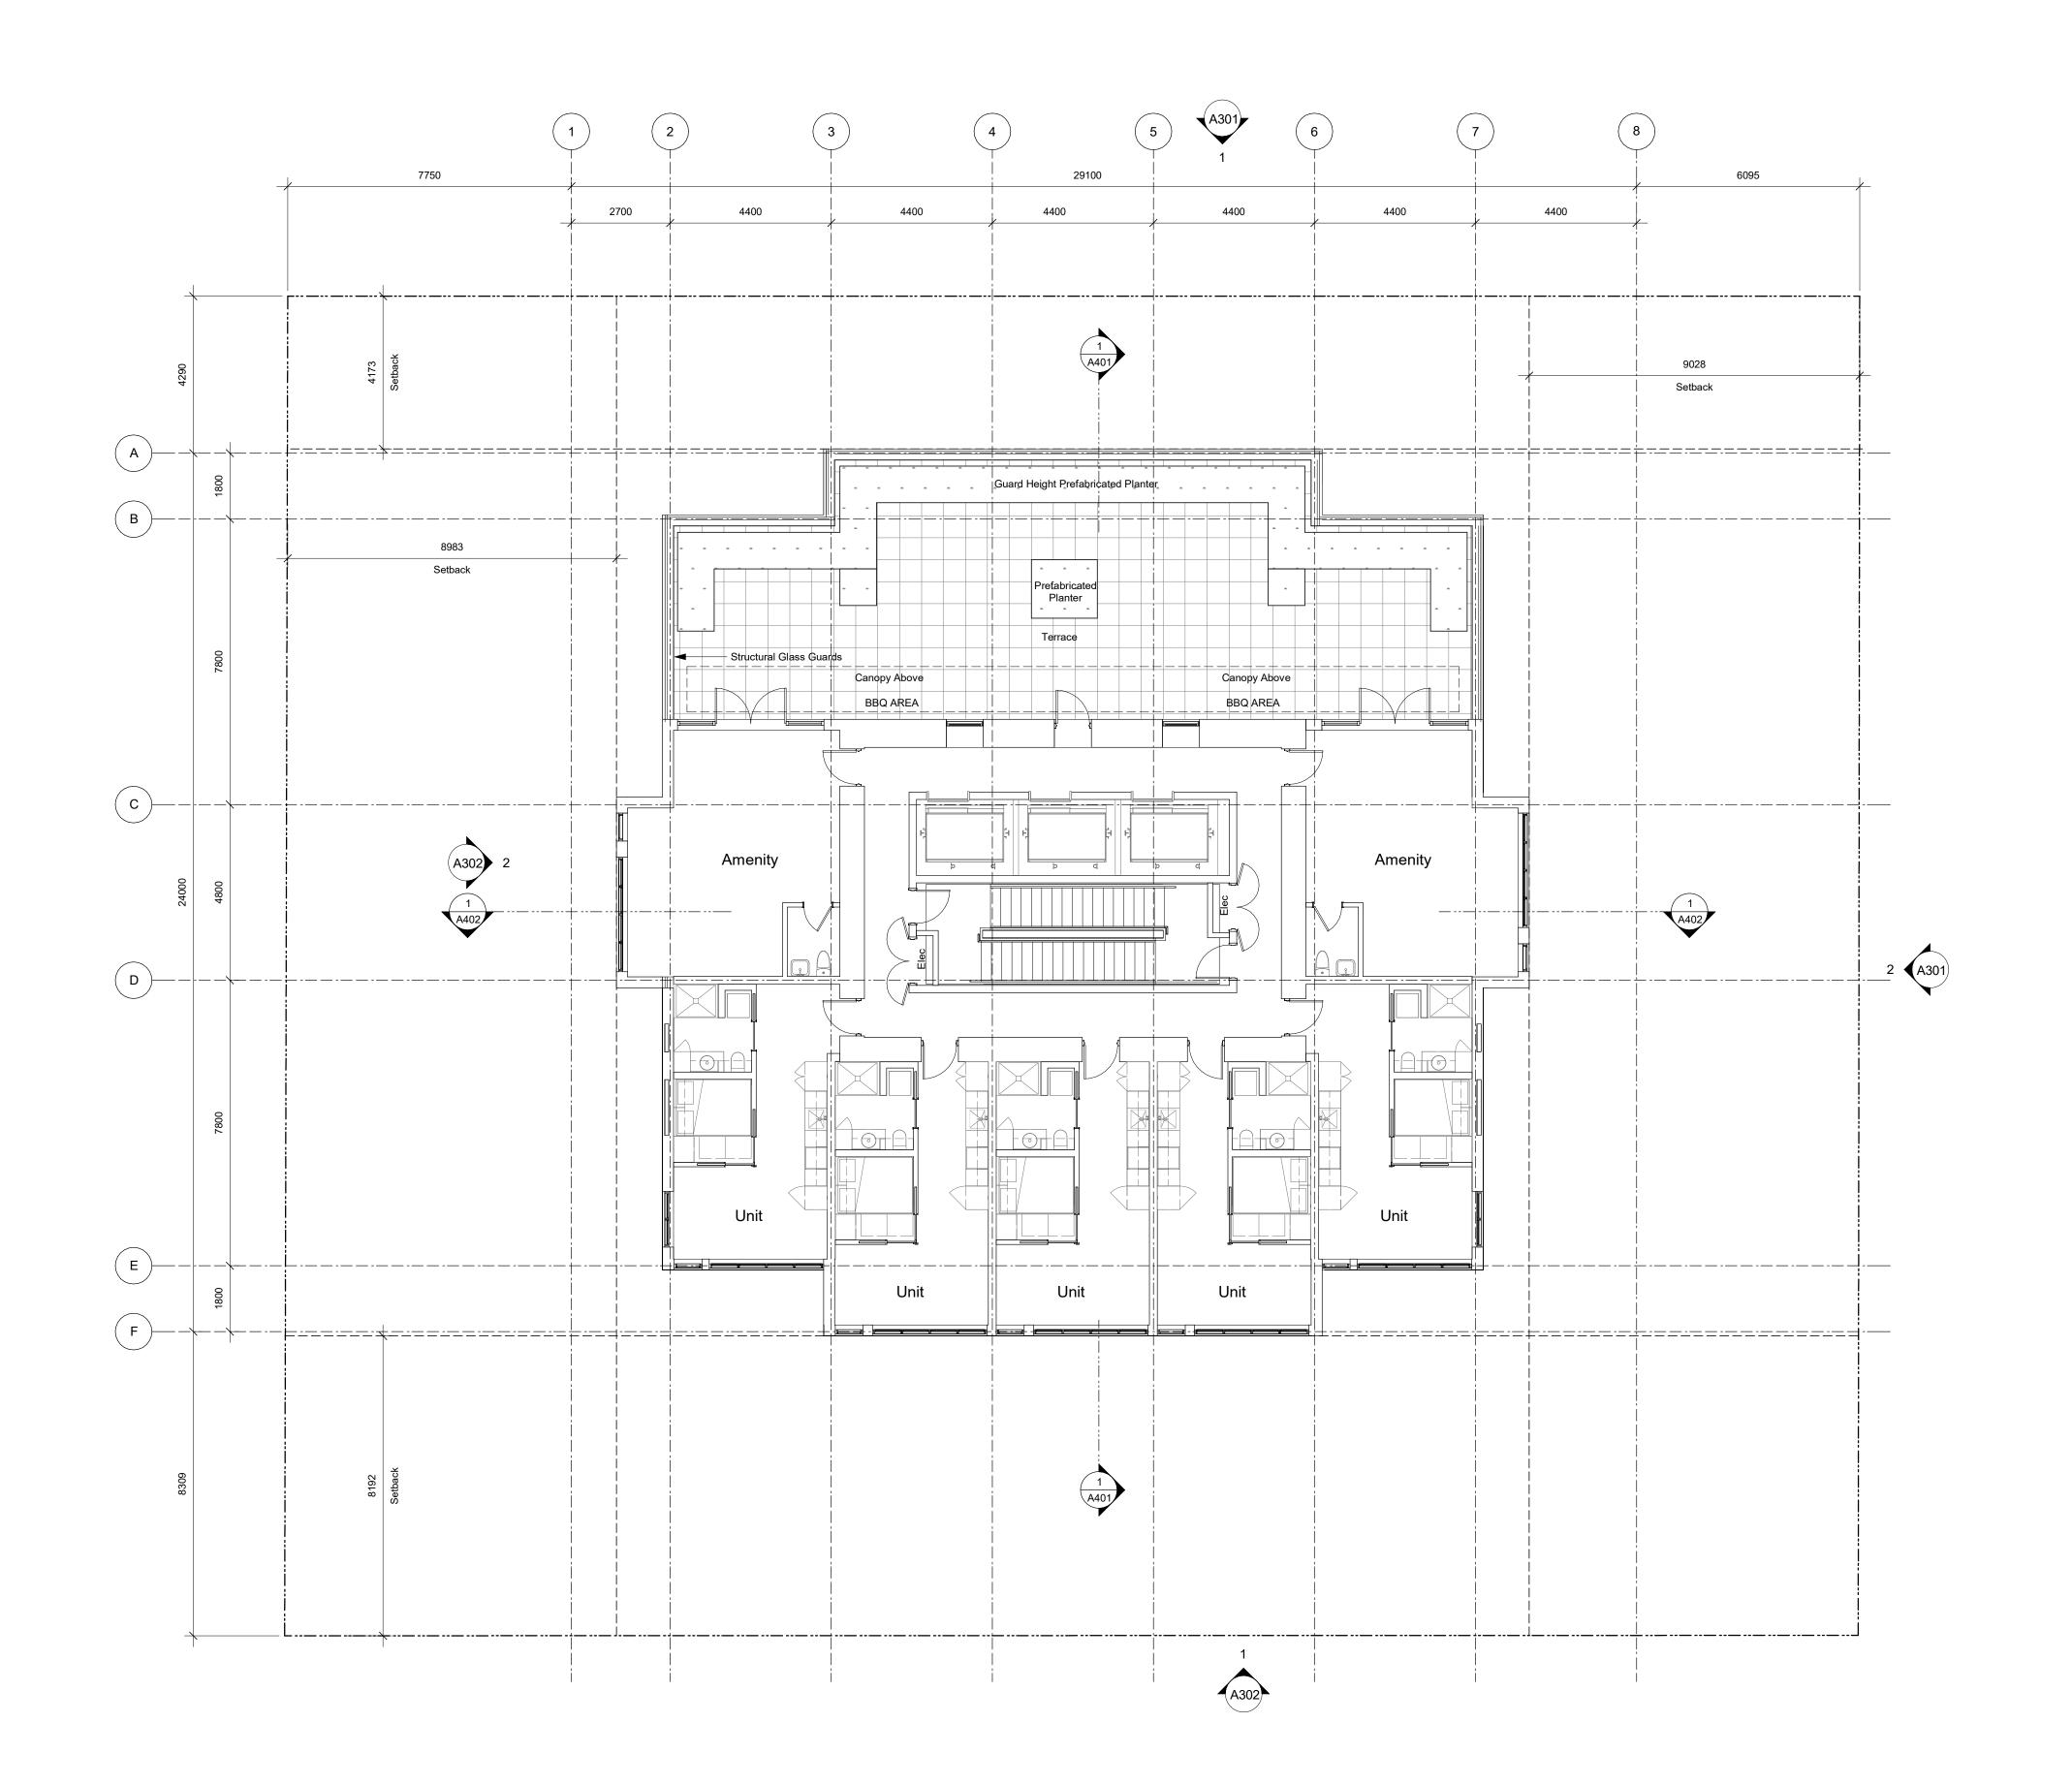

20-08-12 20-01-08 19-10-02


Issued for DP Revisions 2 Issued for DP Revisions 1


Issued for DP Revisions 3

View St. Residential


937 View Street

Level 23 Plan

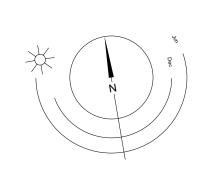

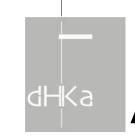

dHKarchitects Victoria 977 Fort Street

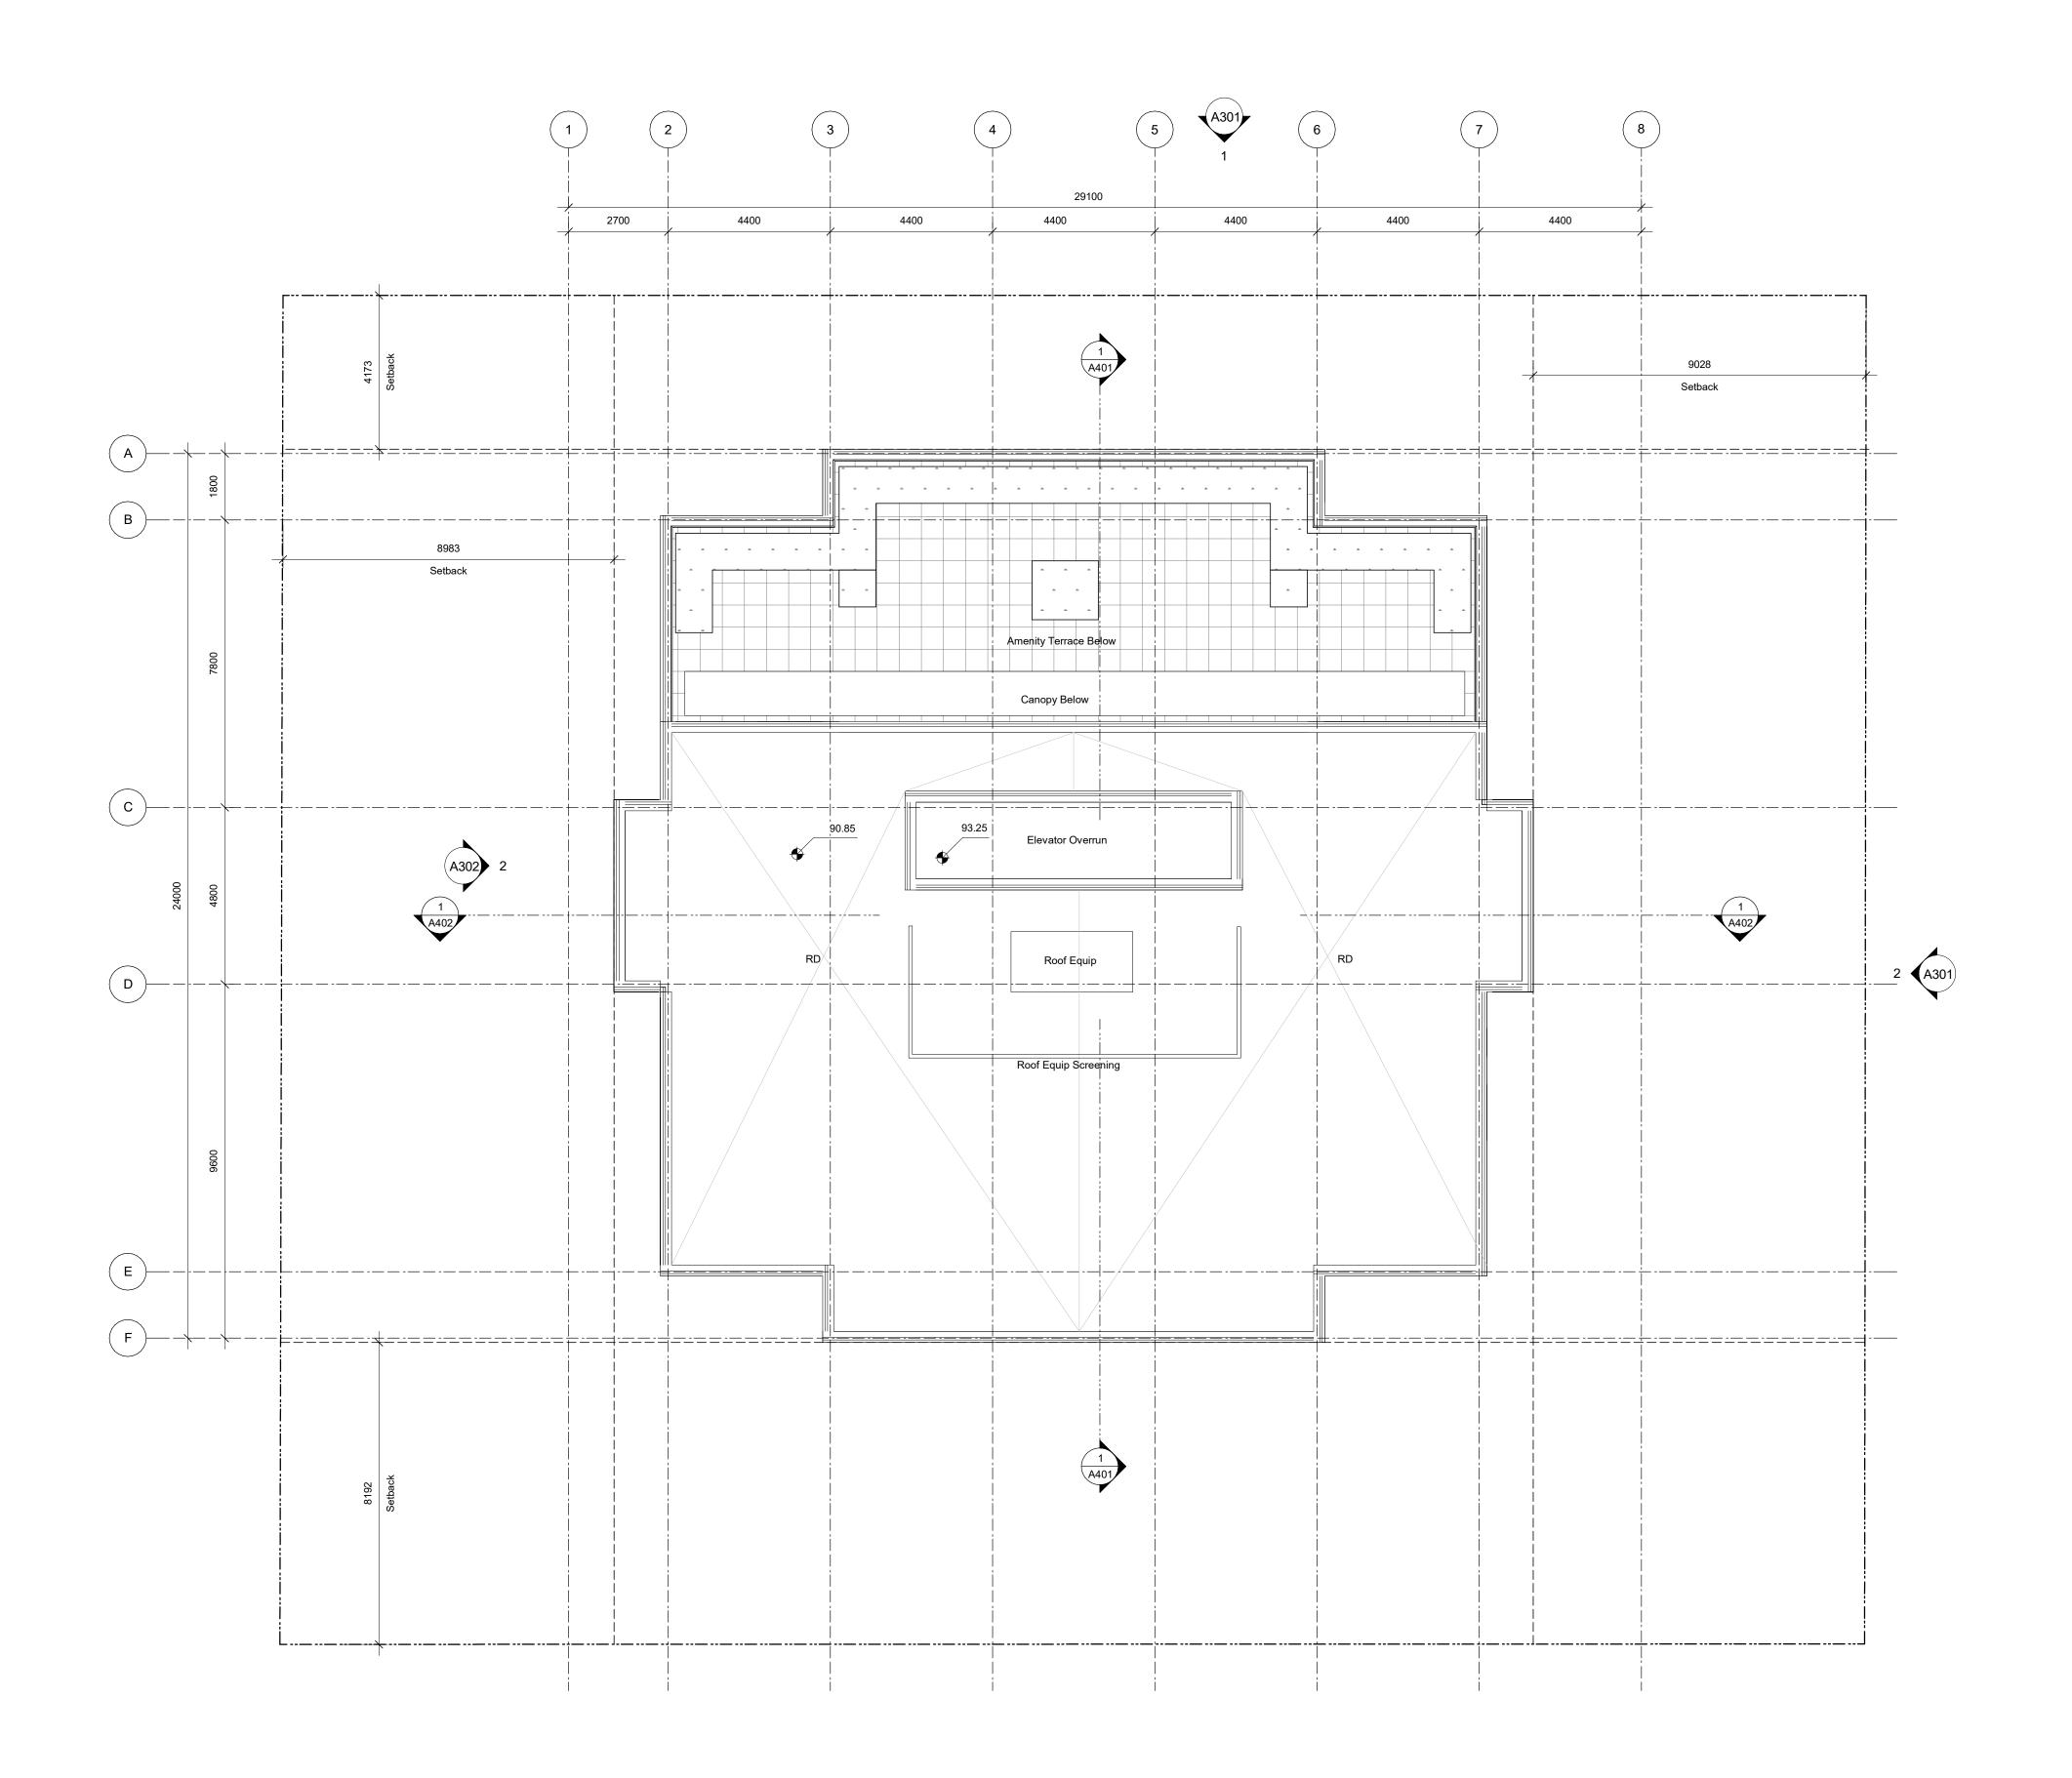

21-05-04 20-08-12 20-01-08

Issued for DP Revisions 1 19-10-02

Issued for DP Revisions 3

Issued for DP Revisions 2

View St. Residential

937 View Street

Roof Plan



Victoria 977 Fort Street V8V 3K3 **T** 1•250•658•3367 102-5190 Dublin Way V9T 0H2 **T** 1•250•585•5810 COPYRIGHT RESERVED. THESE PLANS AND DESIGNS ARE AND AT ALL TIMES REMAIN THE PROPERTY OF **DHKARCHITECTS** TO BE USED FOR THE PROJECT SHOWN AND MAY NOT BE REPRODUCED WITHOUT WRITTEN CONSENT


1 Roof - Overall A209 SCALE: 1:100









1 Building Elevation - East - Adjacent Window Overlay
A303 SCALE: 1:100

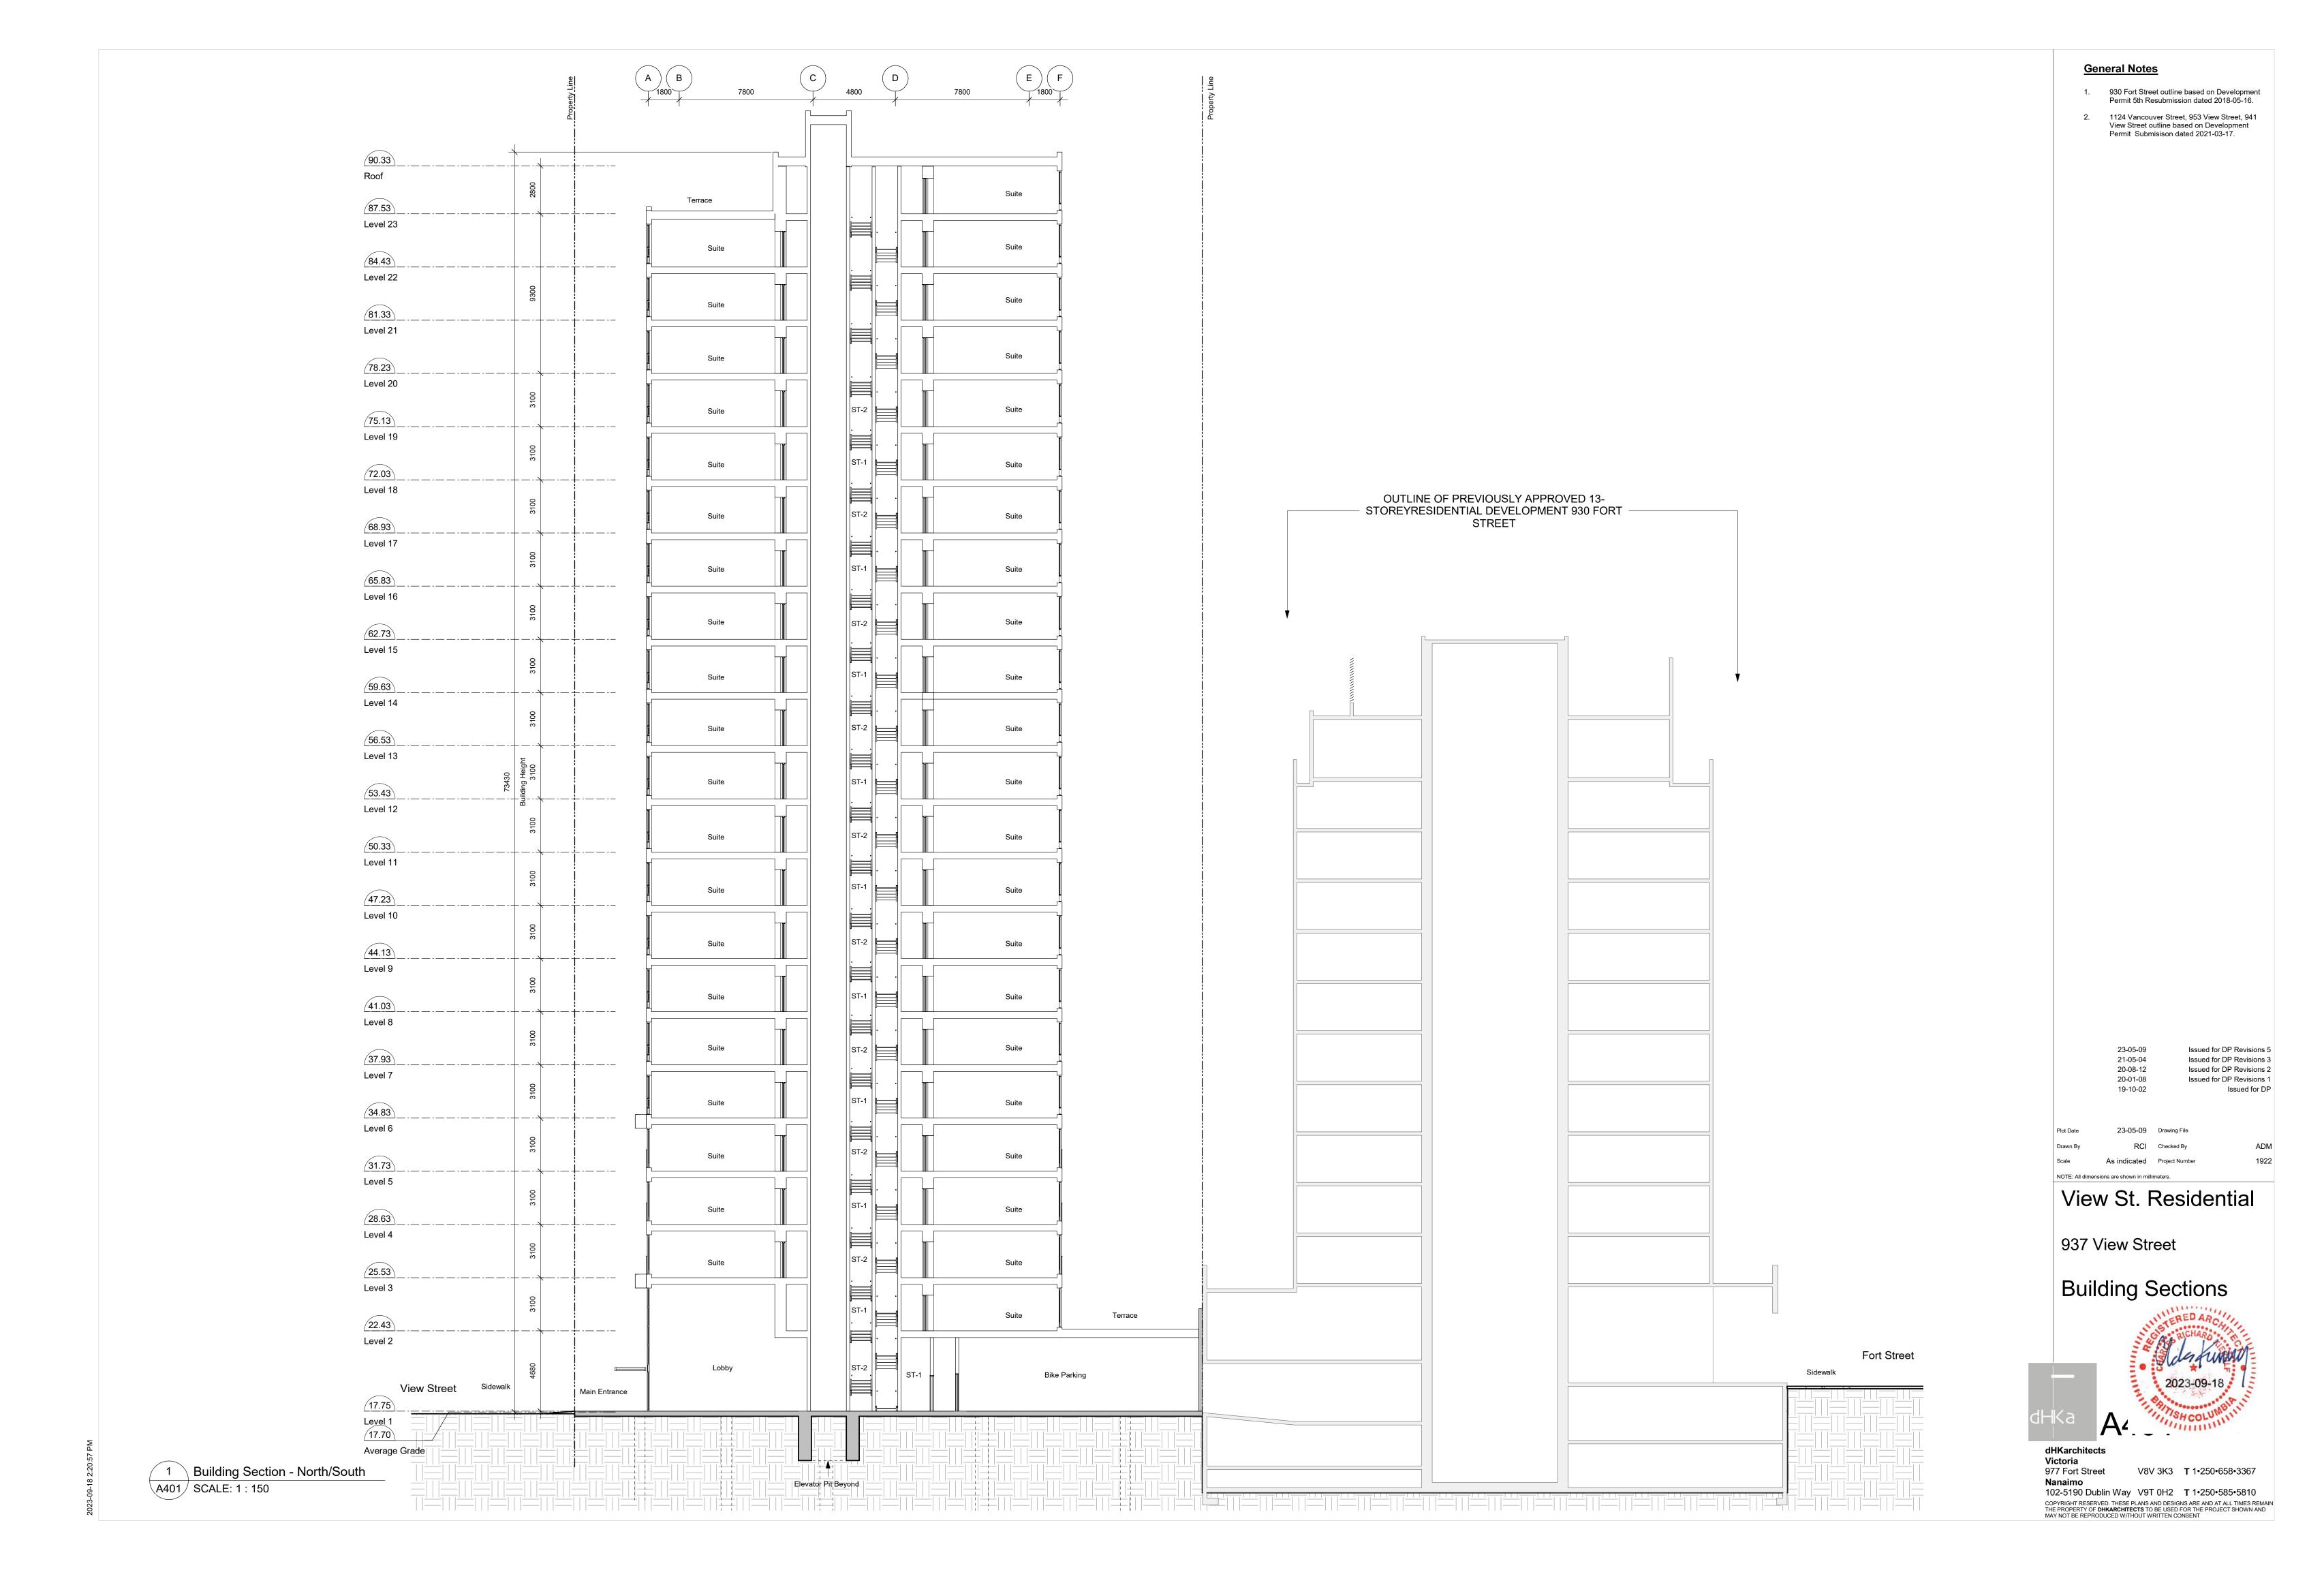


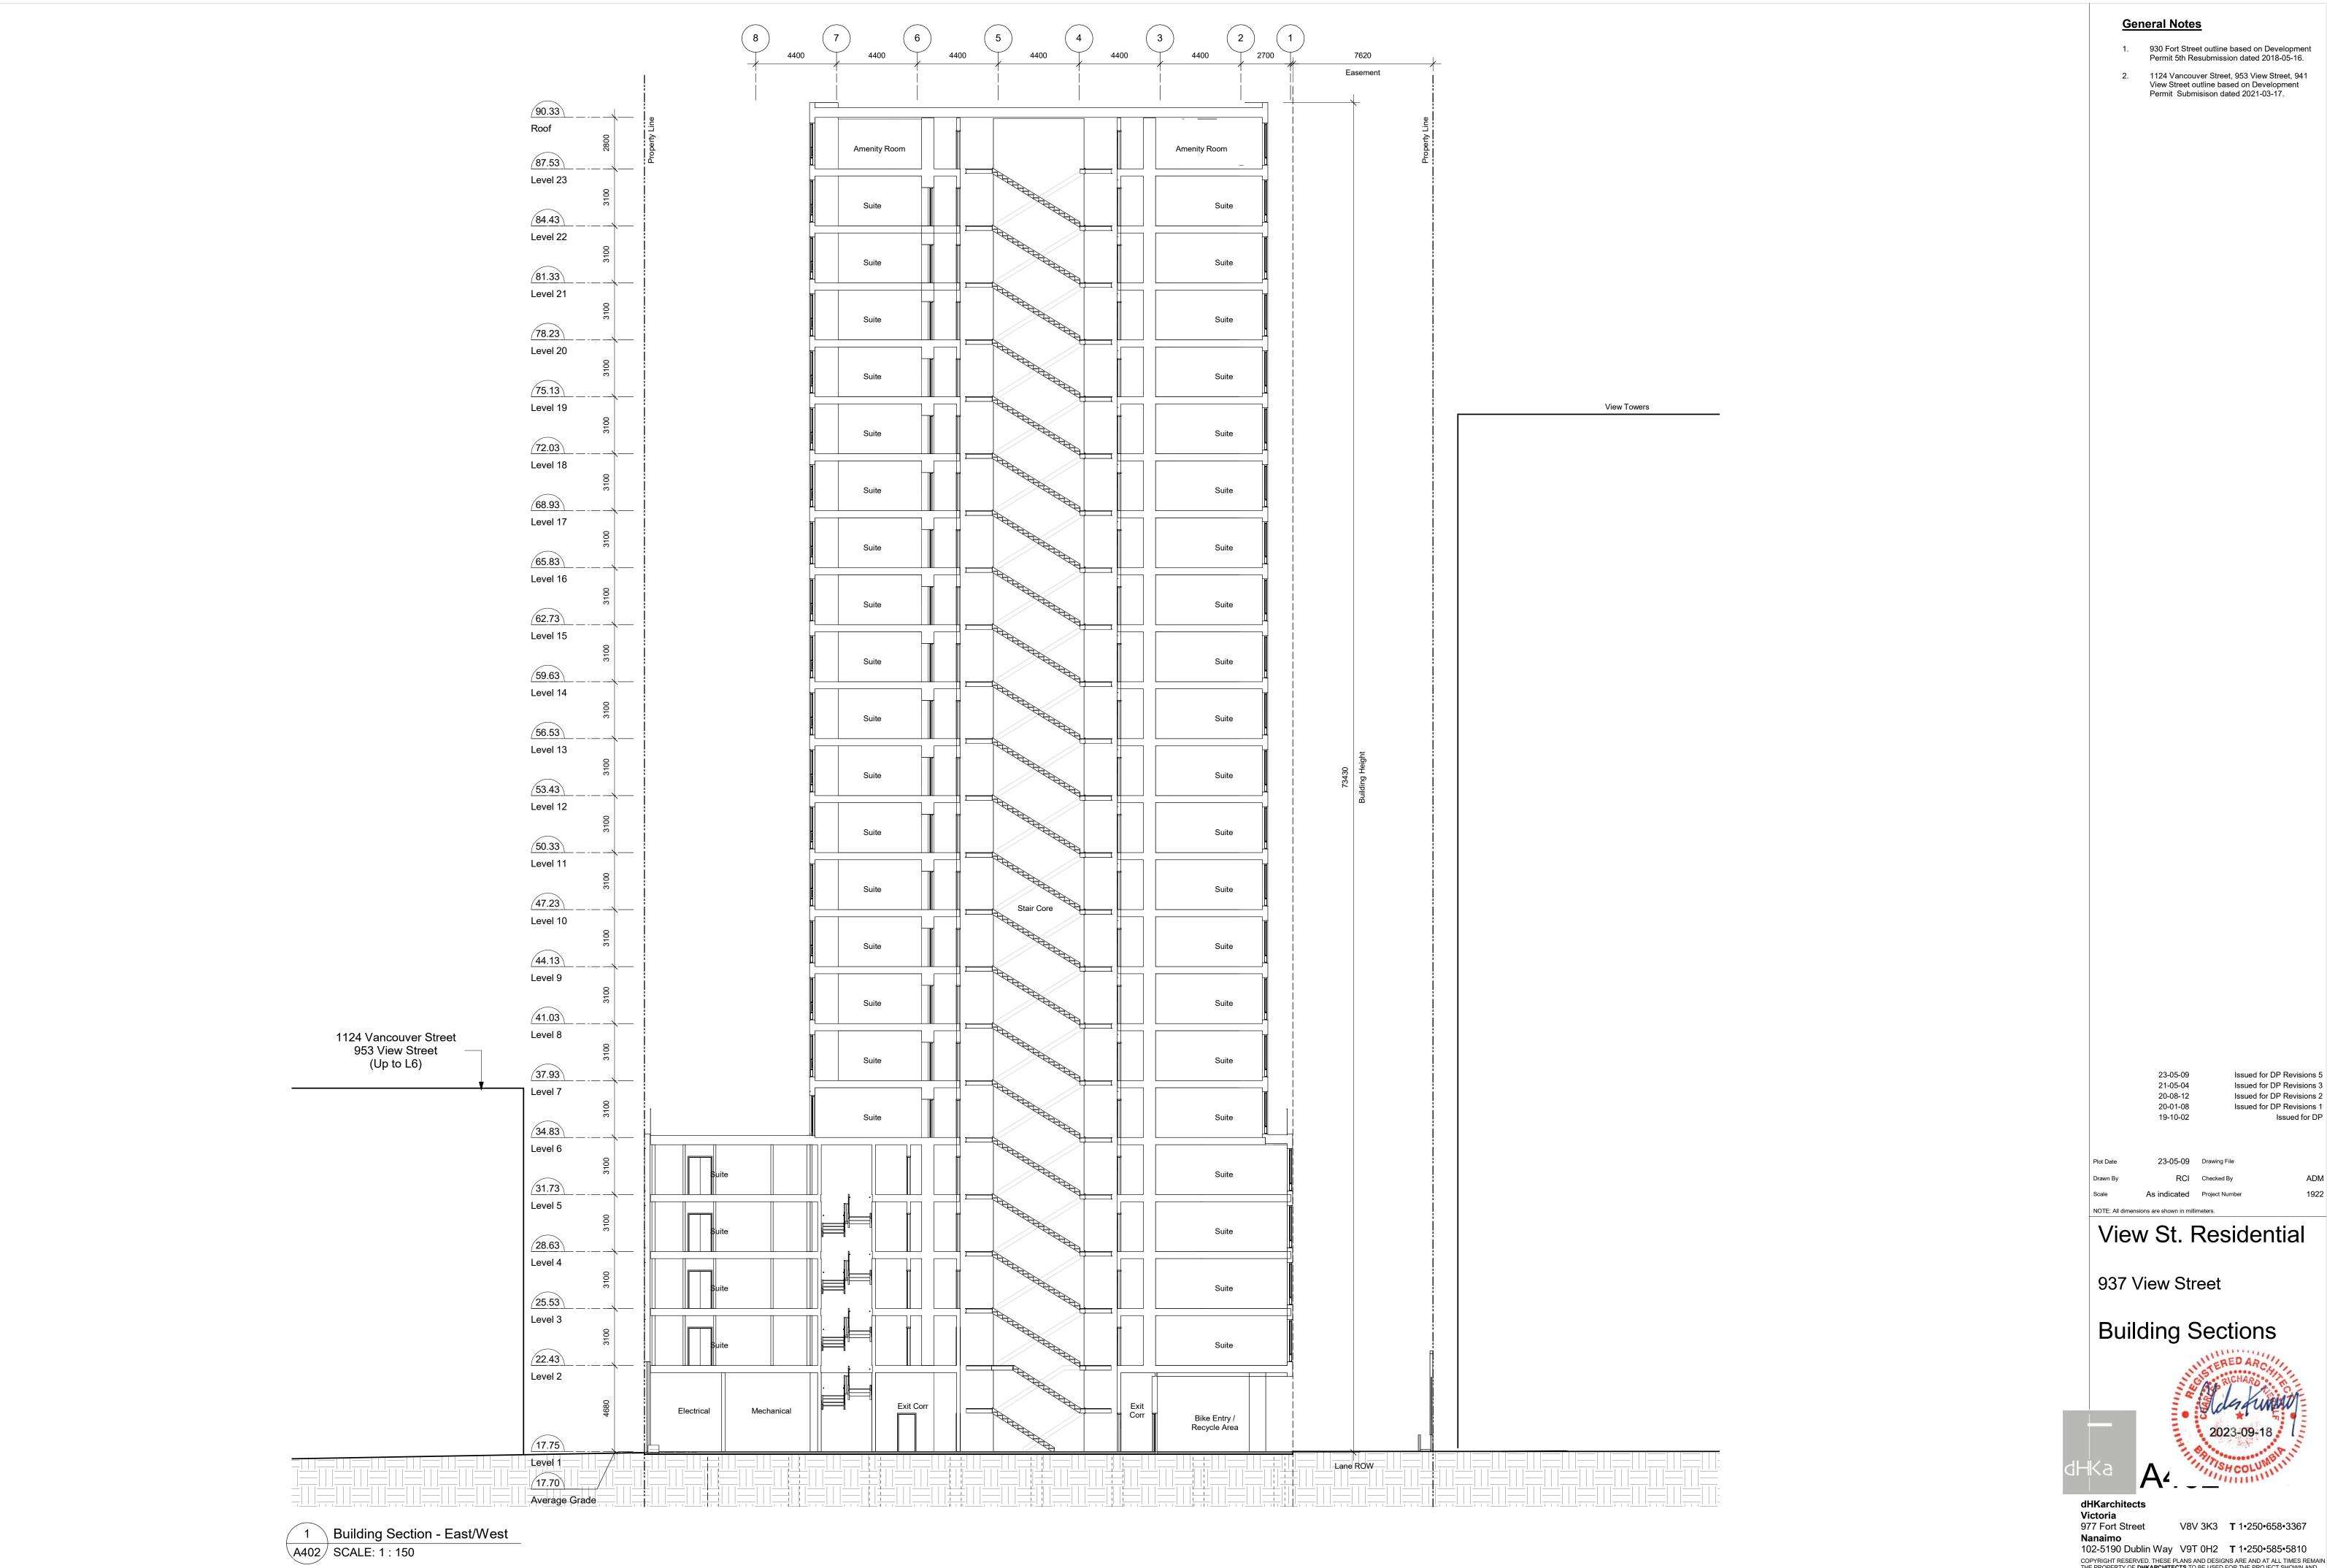

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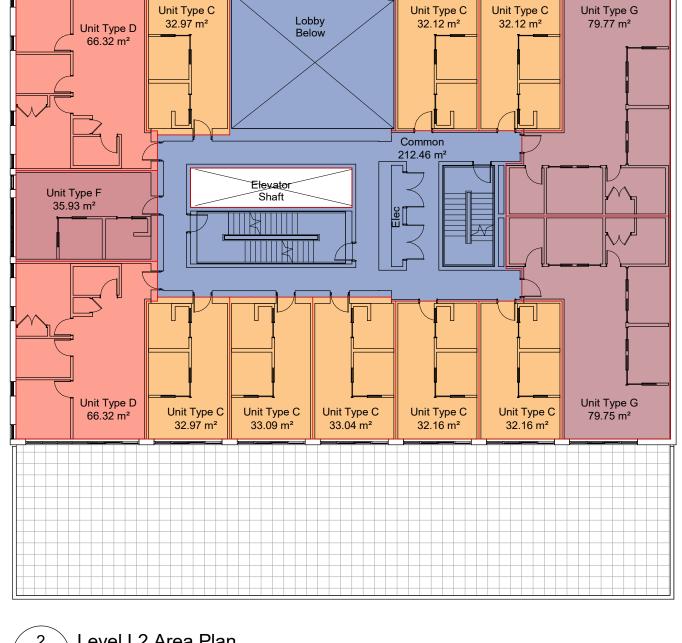


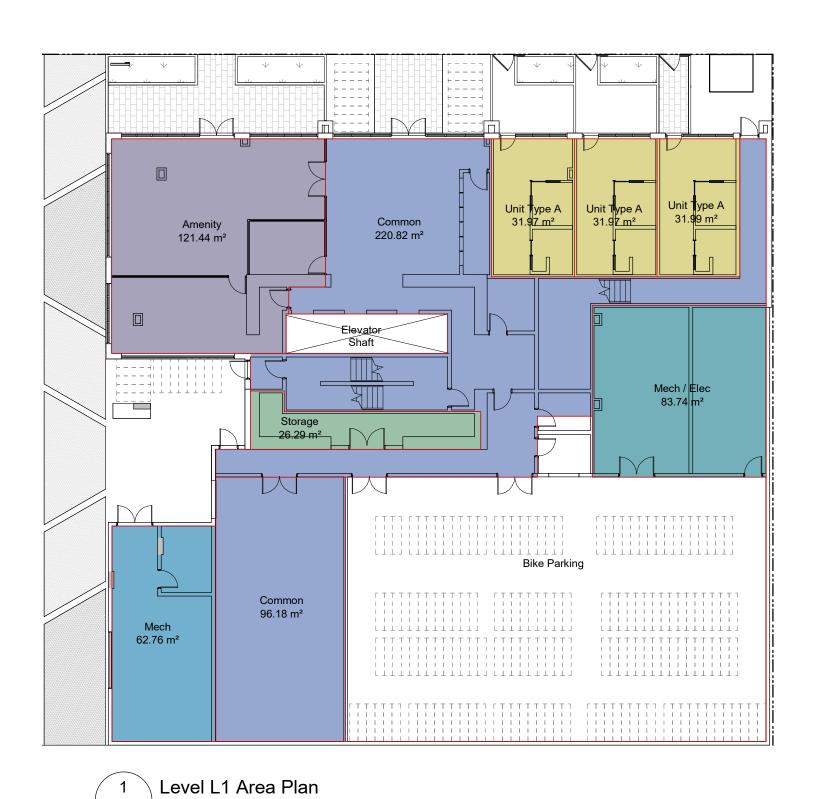


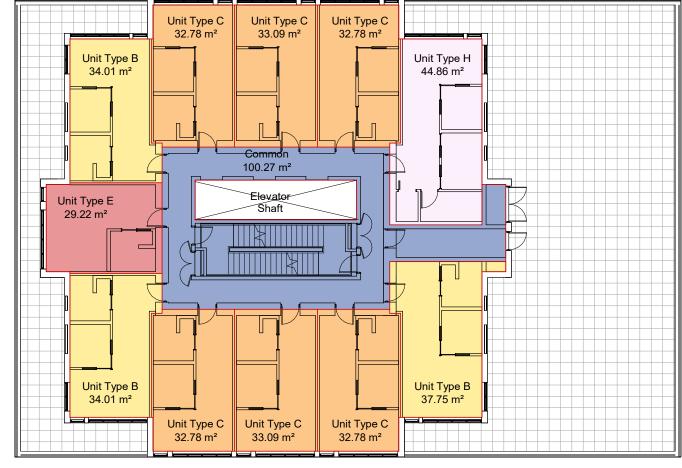


5 Level L6 Area Plan A911 | SCALE: 1:200


A911 SCALE: 1:200



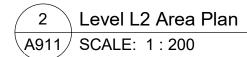

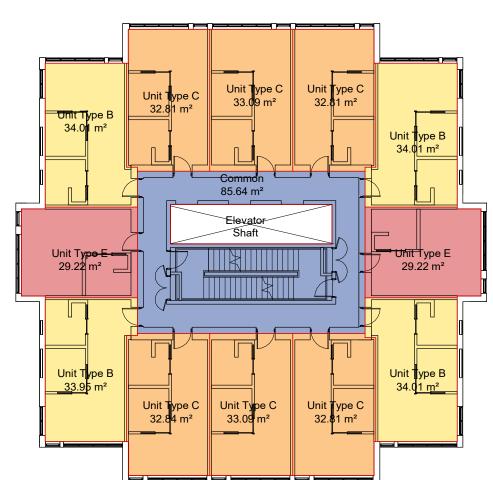

6 Levels L7-L22 Area Plan

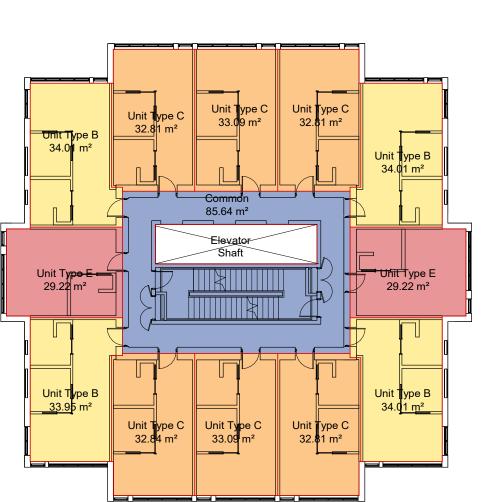


A911 | SCALE: 1:200

Floor Areas


Level	Area
Not Placed	0 m²
Level 1	707 m ²
Level 2	801 m ²
Level 3	801 m ²
Level 4	801 m²
Level 5	801 m²
Level 6	477 m²
Level 7	478 m²
Level 8	477 m²
Level 9	478 m²
Level 10	478 m²
Level 11	478 m²
Level 12	478 m²
Level 13	478 m²
Level 14	477 m²
Level 15	478 m²
Level 16	478 m²
Level 17	478 m²
Level 18	478 m²
Level 19	478 m²
Level 20	478 m²
Level 21	478 m²
Level 22	478 m²
Level 23	327 m²

Area Summary		Unit Type and Count Su	mmary
Site Area Total FAR Areas	1,572 sm 12,356 sm	Studio (Types E) 1BR (Types A, B, C, F)	33 219
FAR	7.86	2BR (Type H) 3BR (Types D, G)	1 16
		Total Units	269

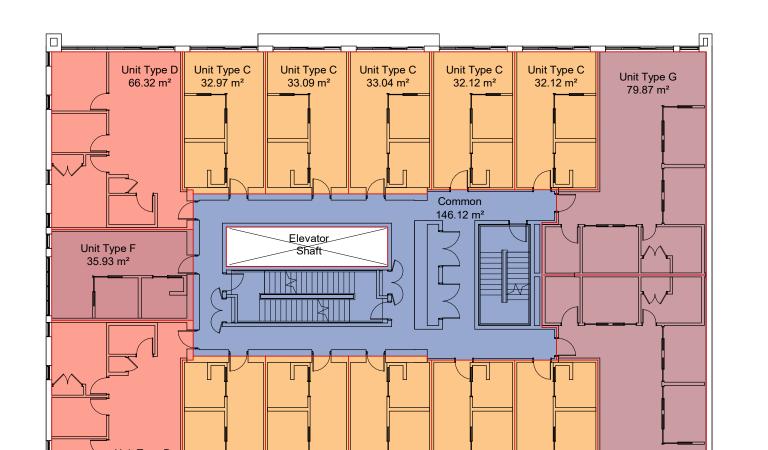

66.32 m² Unit Type C 32.97 m² 33.09 m² 33.04 m² 32.16 m² 32.16 m²

3 Levels L3-L5 Area Plan A911 SCALE: 1:200

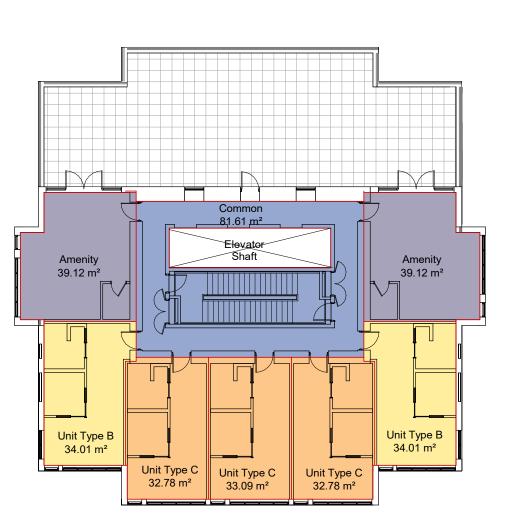

4 Level L23 Area Plan A911 | SCALE: 1:200

23-05-09 Drawing File

Issued for DP Revisions 6 Issued for DP Revisions 5

Issued for DP Revisions 3

Issued for DP Revisions 2

Issued for DP Revisions 1

View St. Residential

23-05-09 21-05-04

20-08-12

20-01-08

937 View Street

General Notes

demising walls.

2. See A001 for required bike counts.

wall finish on all sides.

1. Plans and Area Schedule show areas measured to inside face of exterior walls, and centre of

Unit Schedule areas measured to inside face of

Area Plans





LEGEND

— · · — Property line — ·· — ·· – Extent Of Underground Parking (indicative) **---** Extent Of Roof / Canopy Line (indicative) ---- Rain garden - TOP OF POOL Rain garden - **BOTTOM OF POOL** •17.75 Architectural grade, provided for reference only • 17.62 Civil grade, provided for reference only • 17.75 Proposed landscape grade TW Top of Wall BW Bottom of Wall TC Top of Curb BC Bottom of Curb TP Top of Pool BP Bottom of Pool TS Top of Stairs BS Bottom of Stairs

UNDERGROUND UTILITIES

LANDSCAPE MATERIALS

Main Entry Paving
Concrete Unit Paving

Patio Paving
Concrete Unit Paving

Permeable Paving
Permeable Concrete Unit Paving

Driveway Paving

Driveway Paving

Vehicular Concrete Unit Paving, natural/light colour

Vehicular Concrete Unit Paving, charcoal/dark colour

Cast in place concrete paving
Fine broom finish

Rain Garden Area on Grade
450 mm depth growing medium

Raised Planting Area
Growing medium depth varies, minimum 450 mm

Structural Soil Cells
1 soil cell depth

LANDSCAPE FURNISHINGS

Wood Bench with Backrest
2 total @ 1765mm Length x 610mm Depth

Maglin MBE-0870-00025

Type A: Modern Metal Bin

Bicycle Rack
14 total

GENERAL NOTES

1. Work performed shall comply with the following: a) These General Notes, and Construction Documents and Specifications; b) Canadian Landscape Standards, Current Edition (CLS-CE); and c) All applicable local, provincial, and federal codes, ordinances,

 Contractor shall be responsible for verifying all existing site conditions including location of all property lines, existing structures, utilities, and buried infrastructure. Verify all field conditions prior to commencing work.

Contractor is responsible for determining means and methods for construction. These drawings may indicate a limit of proposed improvements or limit of work for the delineation of expected extents of disturbance. Should limits of disturbance exceed boundaries defined in drawings, contractor shall contact Landscape Architect for resolution.


4. Contractor is responsible for repairing all work disturbed by construction outside of limit lines defined on drawings or through their means and methods to a condition better than or equal to the existing conditions prior to commencement of construction at no additional cost to the owner.

Contractor is responsible for maintaining a complete up-to-date set of drawings and specifications at the construction site and ensuring the documents are readily available for review by the Landscape Architect and governing agency.

6. Contractor is responsible for coordination of all designs, drawings, specifications and other documents or publications upon which construction is based. Any discrepencies with the drawings and/or specifications and site conditions shall be brought to the attention of the Landscape Architect, prior to proceeding with construction.
7. The drawings and specifications are complementary to one another and implied to

Landscape Architect for resolution immediately.8. General Contractor and/or sub-contractors are responsible for all costs related to production and submission to consultant of all landscape as-built information including irrigation.

correspond with one another. Any discrepencies should be brought to the attention of the

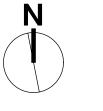

DP REV	23.09.1
DP REV	23.05.10
DP REV	21.04.30
Dev Permit Revisions	20.08.11
Issued for DP revisions	20.01.08
DP REV	19.10.17
DEV PERMIT	17.07.07
description	date



duthel Road Phone: 250.412 /8Z 1G1 Fax: 250.412



2023-09-15

NELSON INVESTMENTS, INC.


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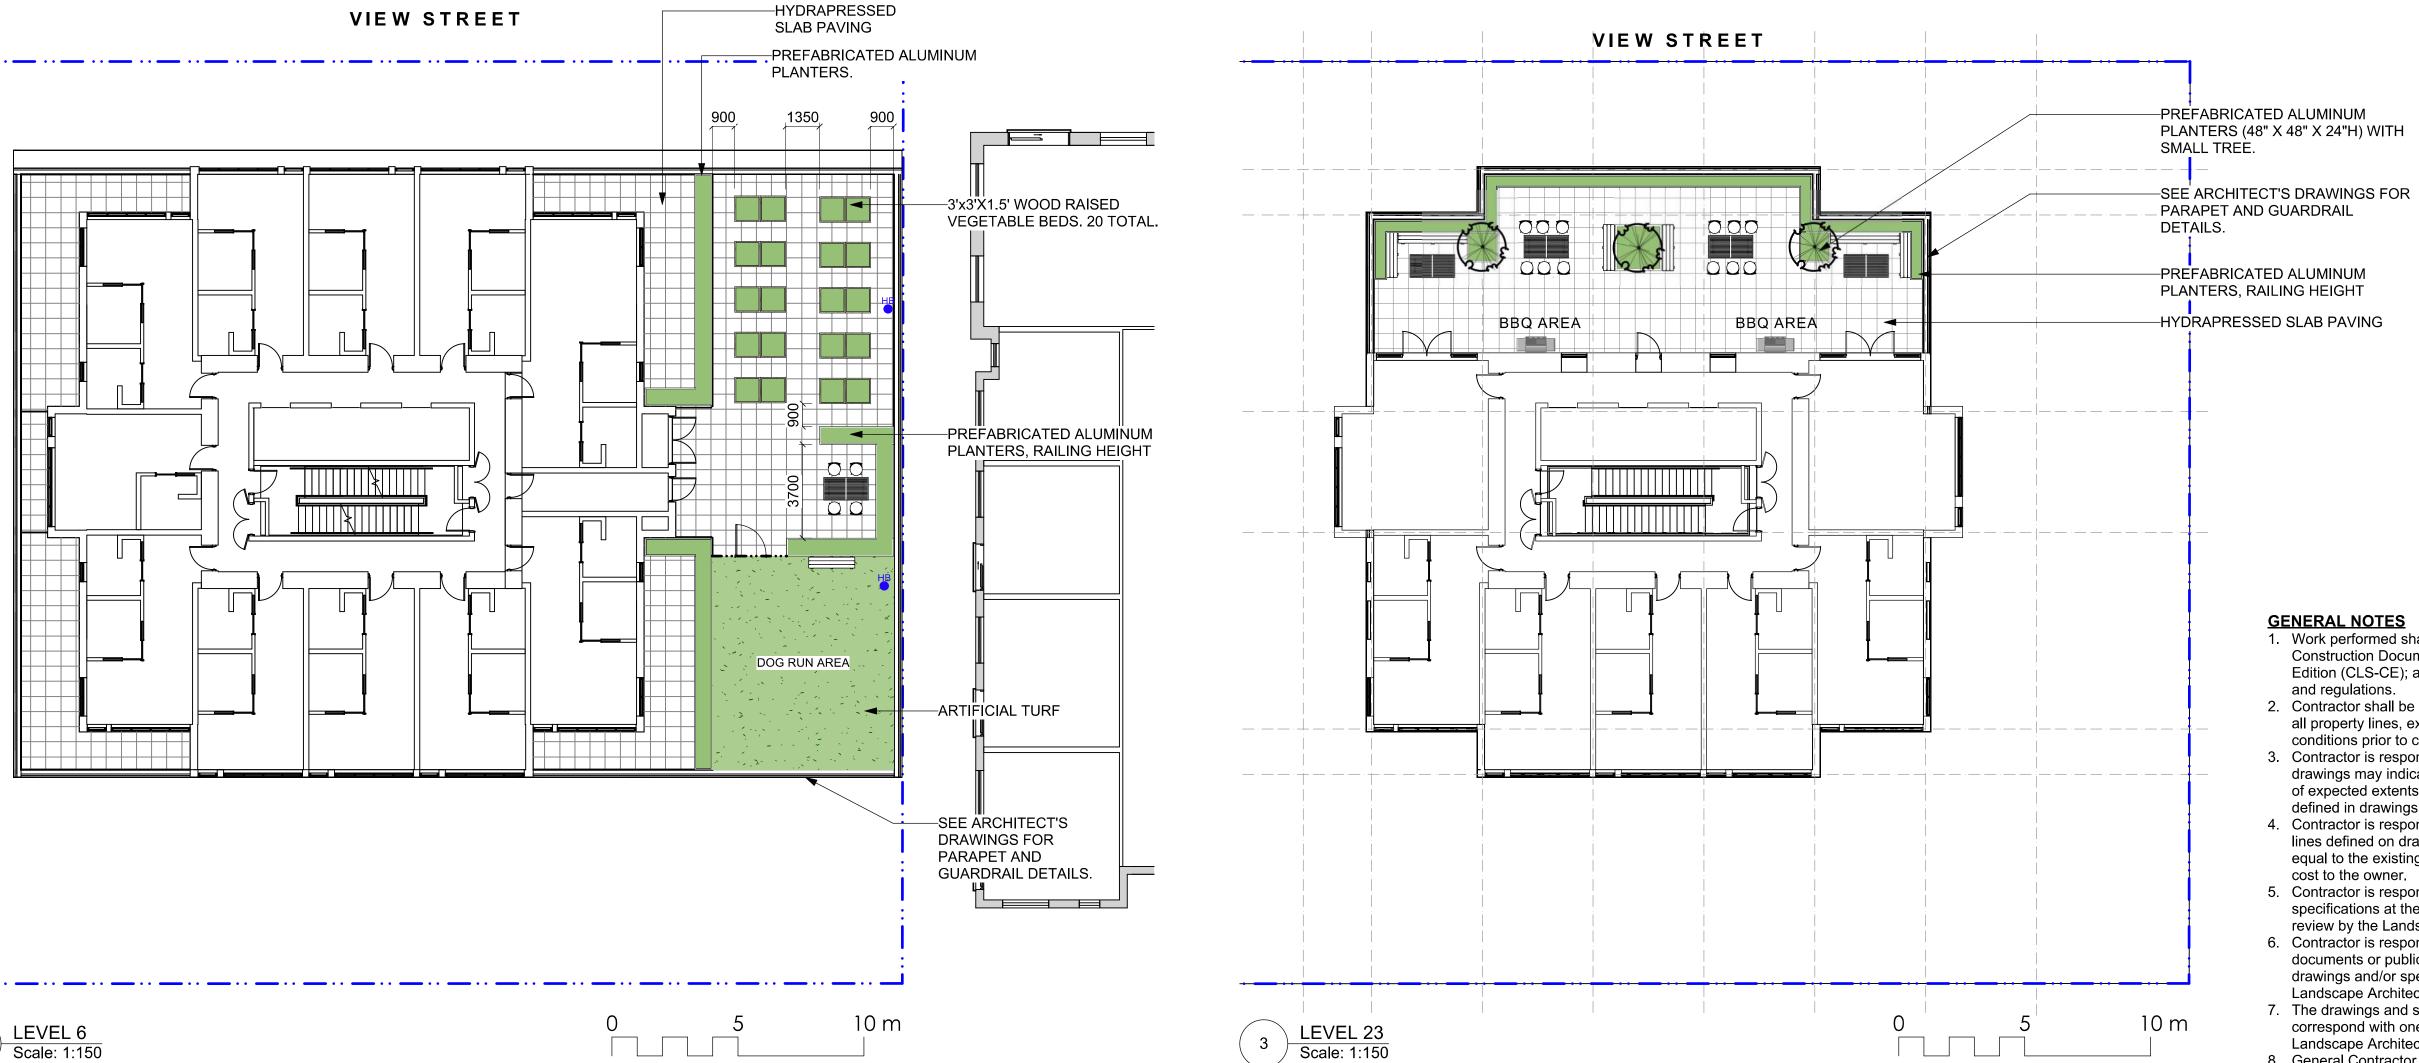
VIEW STREET RESIDENTIAL 937 VIEW STREET VICTORIA, BC


sheet title

Landscape Materials: Ground Level

project no.		119.24
scale	AS NOTED	@ 24"x36"
drawn by		ML
checked by		SM/PdG
revison no.	sheet no.	
<u>7</u>	L	1.01



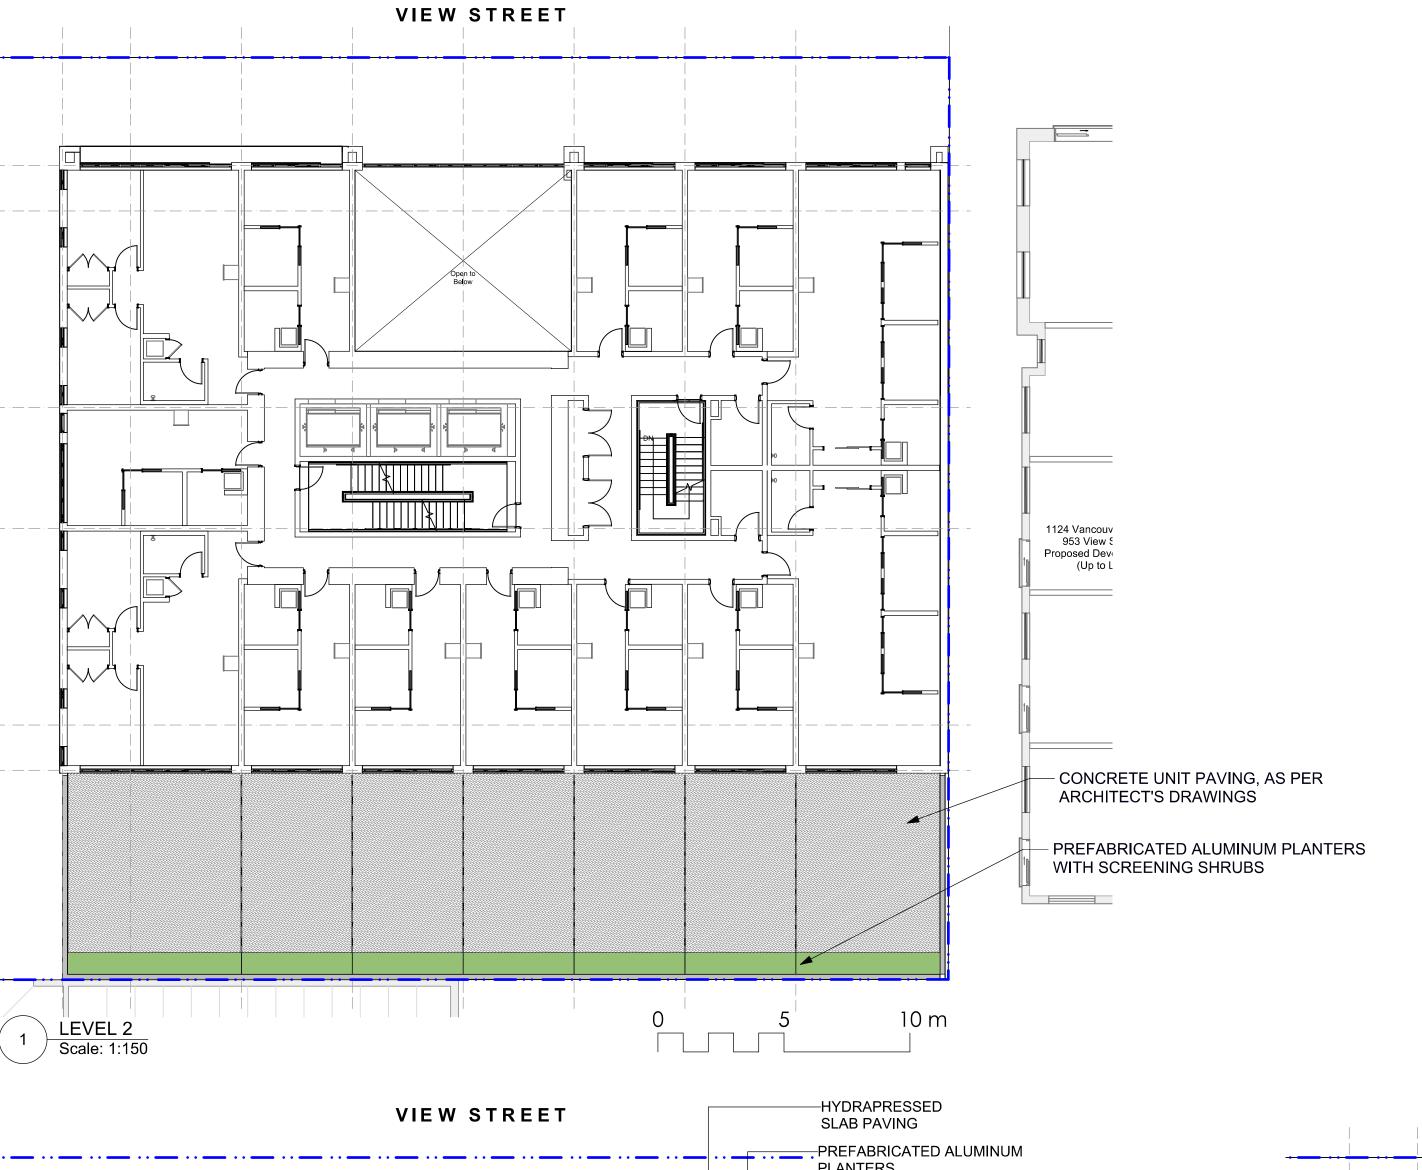

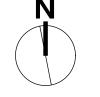

7	DP REV	23.09.1
6	DP REV	23.05.10
5	DP REV	21.04.30
4	Dev Permit Revisions	20.08.11
3	Issued for DP revisions	20.01.08
2	DP REV	19.10.17
1	DEV PERMIT	17.07.07
ev no	description	date





2023-09-15

NELSON INVESTMENTS, INC.

VIEW STREET RESIDENTIAL 937 VIEW STREET VICTORIA, BC

sheet title

Landscape **Materials: Upper** Levels

project no.		119.24
scale	AS NOTED	@ 24"x36"
drawn by		ML
checked by		SM/PdG
revison no.	sheet no.	
7	L	1.02

GENERAL NOTES


irrigation.

- 1. Work performed shall comply with the following: a) These General Notes, and Construction Documents and Specifications; b) Canadian Landscape Standards, Current Edition (CLS-CE); and c) All applicable local, provincial, and federal codes, ordinances,
- 2. Contractor shall be responsible for verifying all existing site conditions including location of all property lines, existing structures, utilities, and buried infrastructure. Verify all field
- conditions prior to commencing work.


 3. Contractor is responsible for determining means and methods for construction. These drawings may indicate a limit of proposed improvements or limit of work for the delineation of expected extents of disturbance. Should limits of disturbance exceed boundaries
- defined in drawings, contractor shall contact Landscape Architect for resolution. 4. Contractor is responsible for repairing all work disturbed by construction outside of limit lines defined on drawings or through their means and methods to a condition better than or equal to the existing conditions prior to commencement of construction at no additional
- cost to the owner. 5. Contractor is responsible for maintaining a complete up-to-date set of drawings and specifications at the construction site and ensuring the documents are readily available for
- review by the Landscape Architect and governing agency.


 6. Contractor is responsible for coordination of all designs, drawings, specifications and other documents or publications upon which construction is based. Any discrepencies with the drawings and/or specifications and site conditions shall be brought to the attention of the Landscape Architect, prior to proceeding with construction.
- correspond with one another. Any discrepencies should be brought to the attention of the Landscape Architect for resolution immediately. 8. General Contractor and/or sub-contractors are responsible for all costs related to production and submission to consultant of all landscape as-built information including

7. The drawings and specifications are complementary to one another and implied to

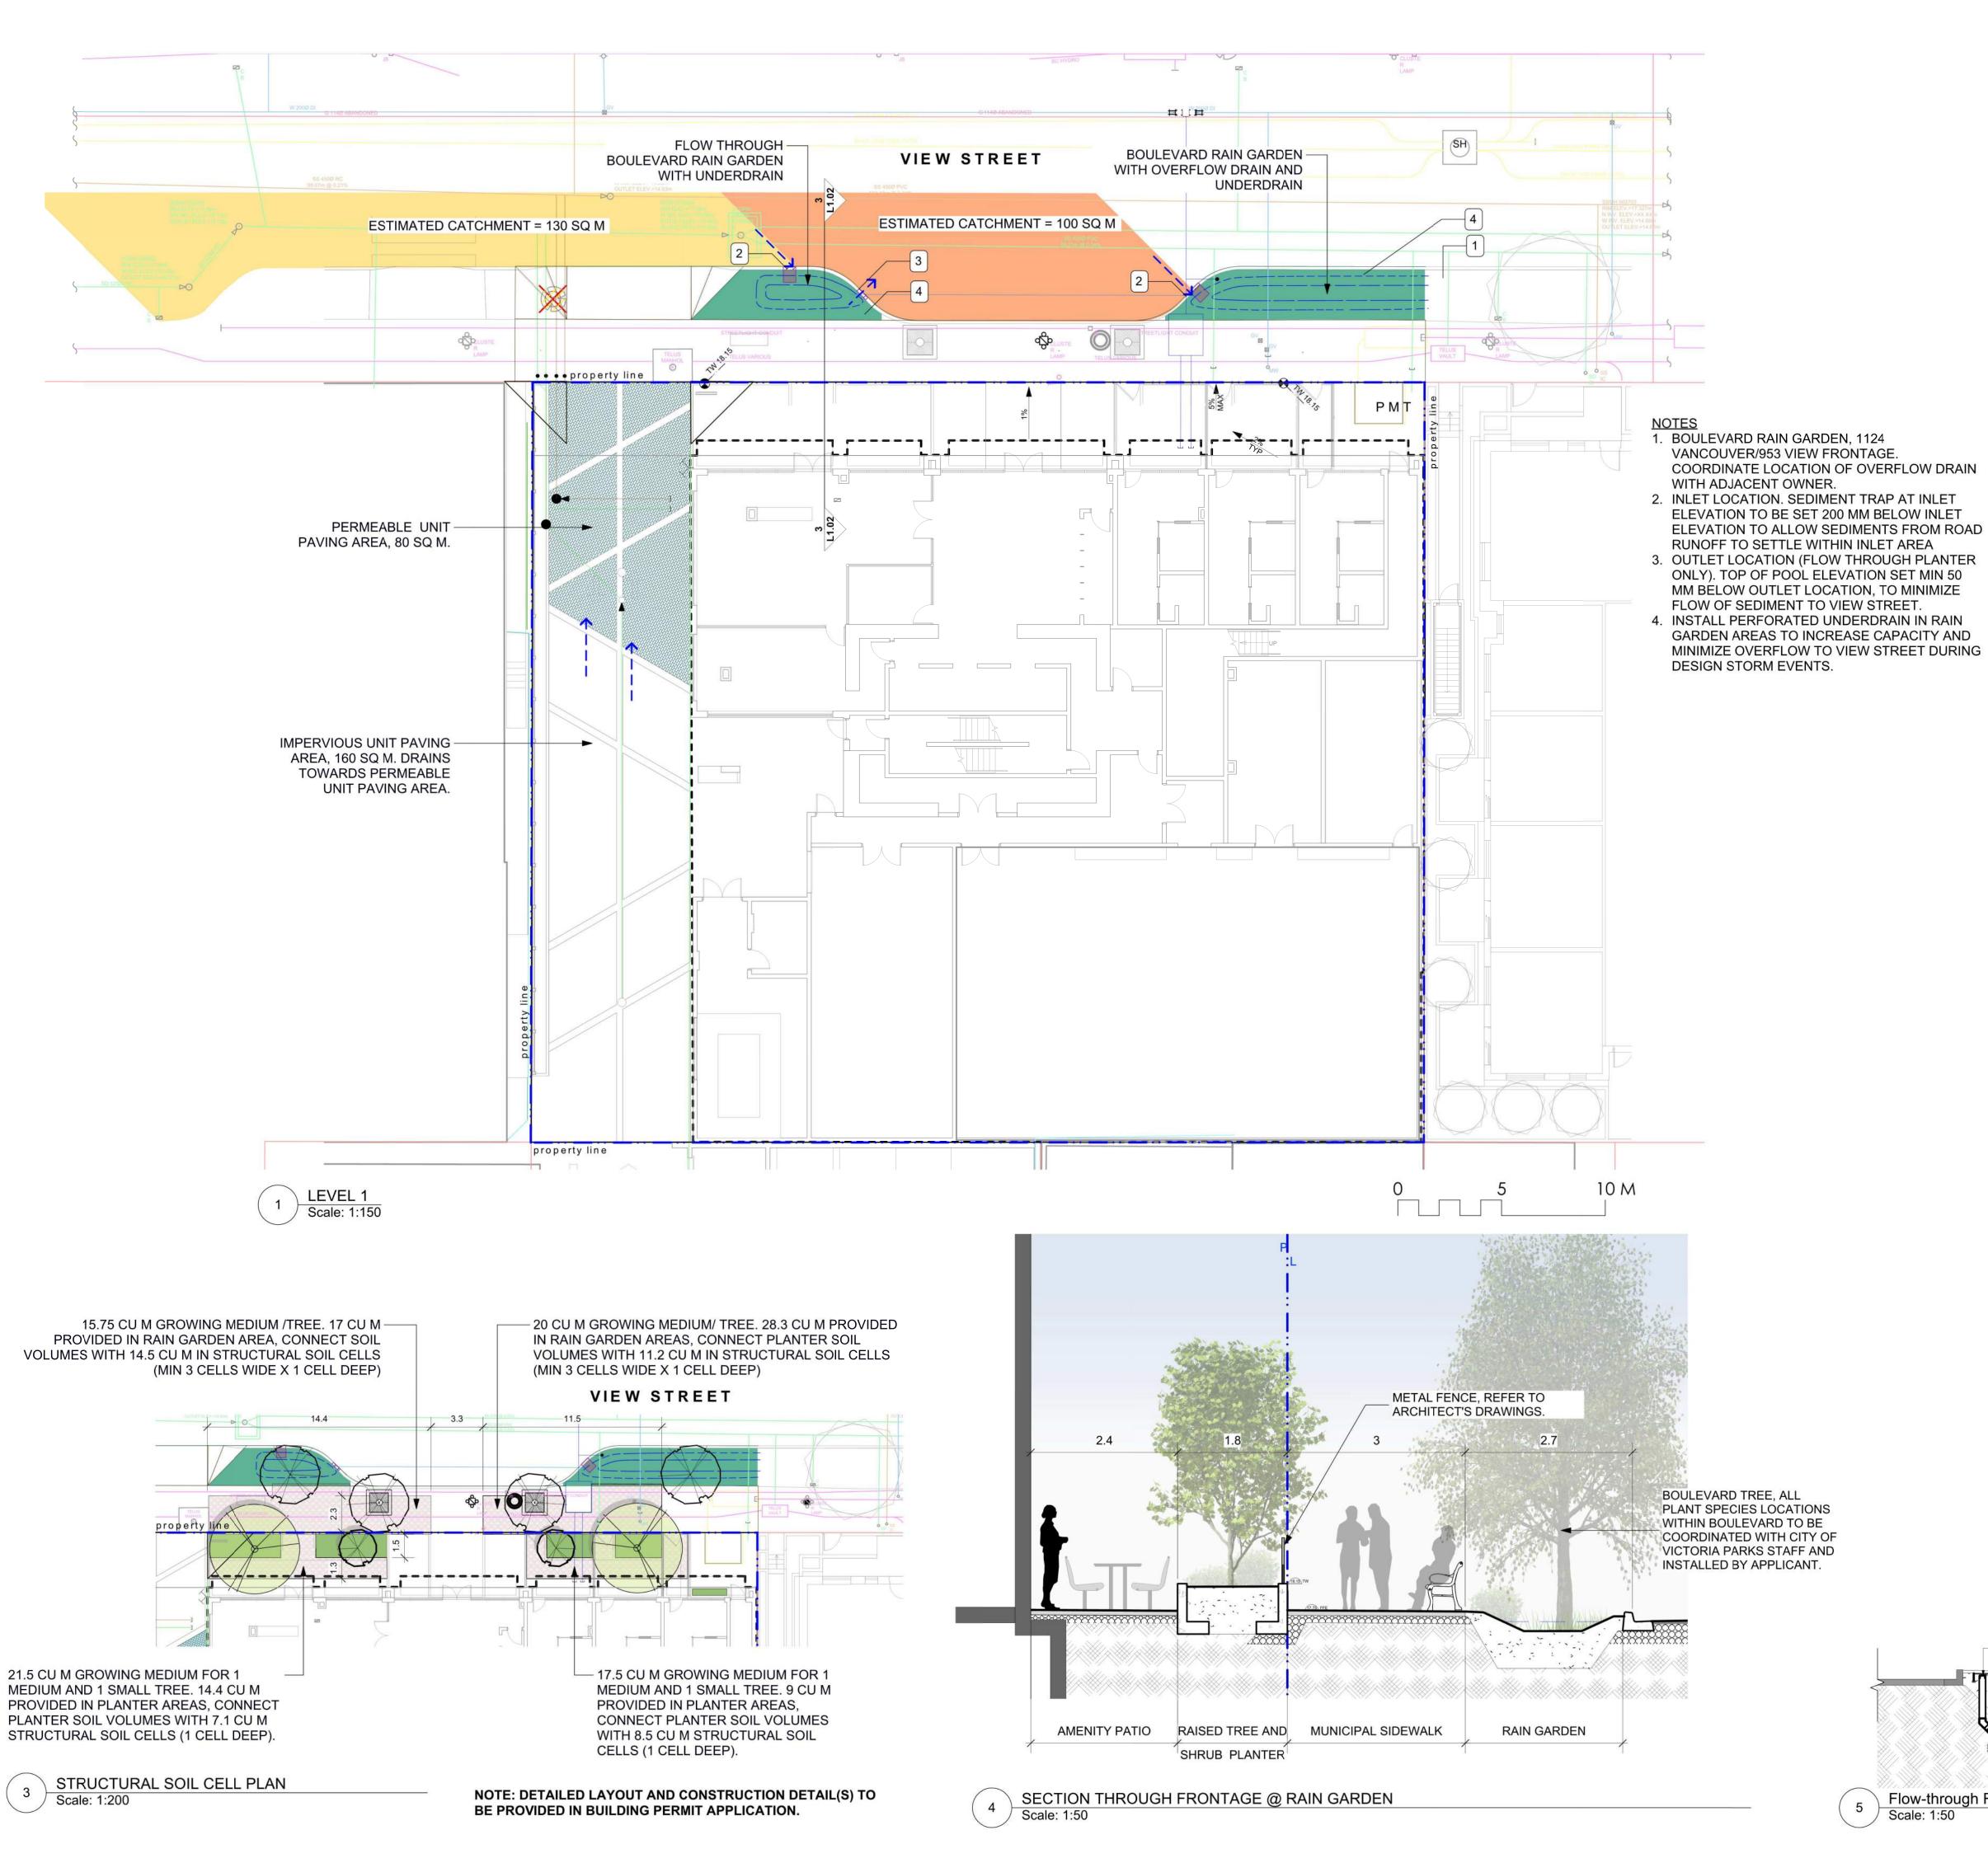



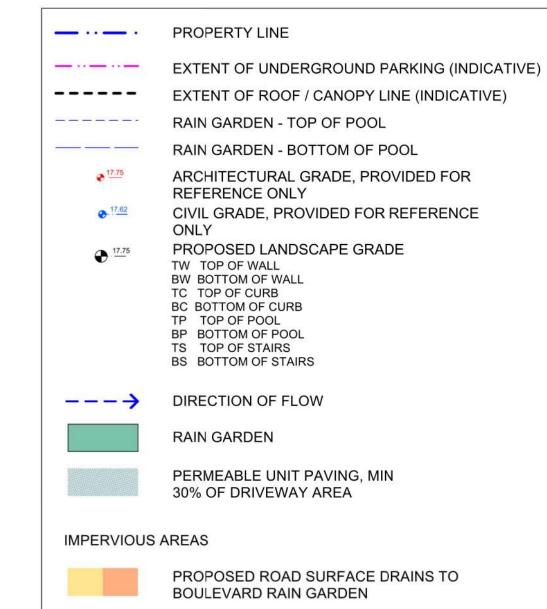

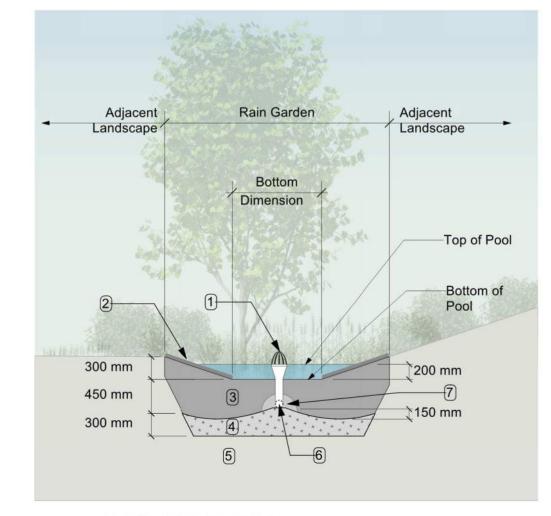

RAIN GARDEN MATERIALS

- 1. Overflow drain, 200 mm domed grate + adapter
- 2. Composted mulch, 50 -70 mm depth. Sides of rain garden only. 3. Bio-retention growing medium, 450 mm depth
- 4. Scarified/tilled subgrade, 300 mm depth
- 5. Existing subgrade/native material
- 6. 100 mm diameter (min) perforated pipe
- 7. 25 mm diameter drain rock. 100 mm depth

TYPICAL RAIN GARDEN


RAIN WATER MANAGEMENT NOTES


Rain gardens are integrated landscape bulges within streetscape areas and are designed to capture, slow flows, and treat runoff from roadways.

The west rain garden is appproximately 2% of the contributing impervious area, and will be designed as flow through planter.

The east rain garden will be designed with underdrains and a high-capacity overflow drain that will be connected to the municipal stormdrain system. The 937 View portion of east rain garden is approximately 20% of the contributing impervious area. Grading, drainage, and planting for the east rain garden will be fully integrated with the adjacent rain garden area, fronting the current development on 1124 Vancouver/953 View Street.

Permeable unit paving will be installed along the north portion of the driveway, as is sized at 30% of driveway area. Impervious areas of driveway will drain towards permeable unit paving area. Refer to Civil Engineers for permeable paving details.

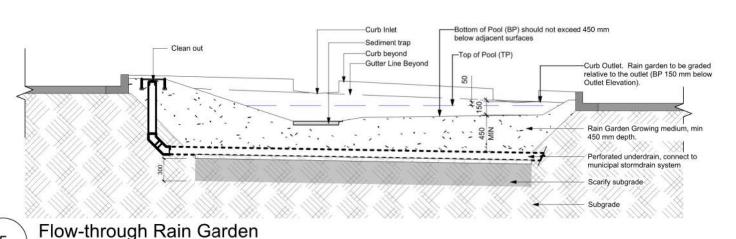

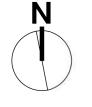

7	DP REV	23.09.1
6	DP REV	23.05.10
5	DP REV	21.04.30
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2	DP REV	19.10.17
1	DEV PERMIT	17.07.07
ev no	description	date





2023-09-15


NELSON INVESTMENTS, INC.

VIEW STREET RESIDENTIAL 937 VIEW STREET VICTORIA, BC

sheet title

Stormwater Management

project no.		119.24
scale	AS NOTED	@ 24"x36"
drawn by		ML
checked by		SM/PdG
revison no.	sheet no.	
\triangle		1.03

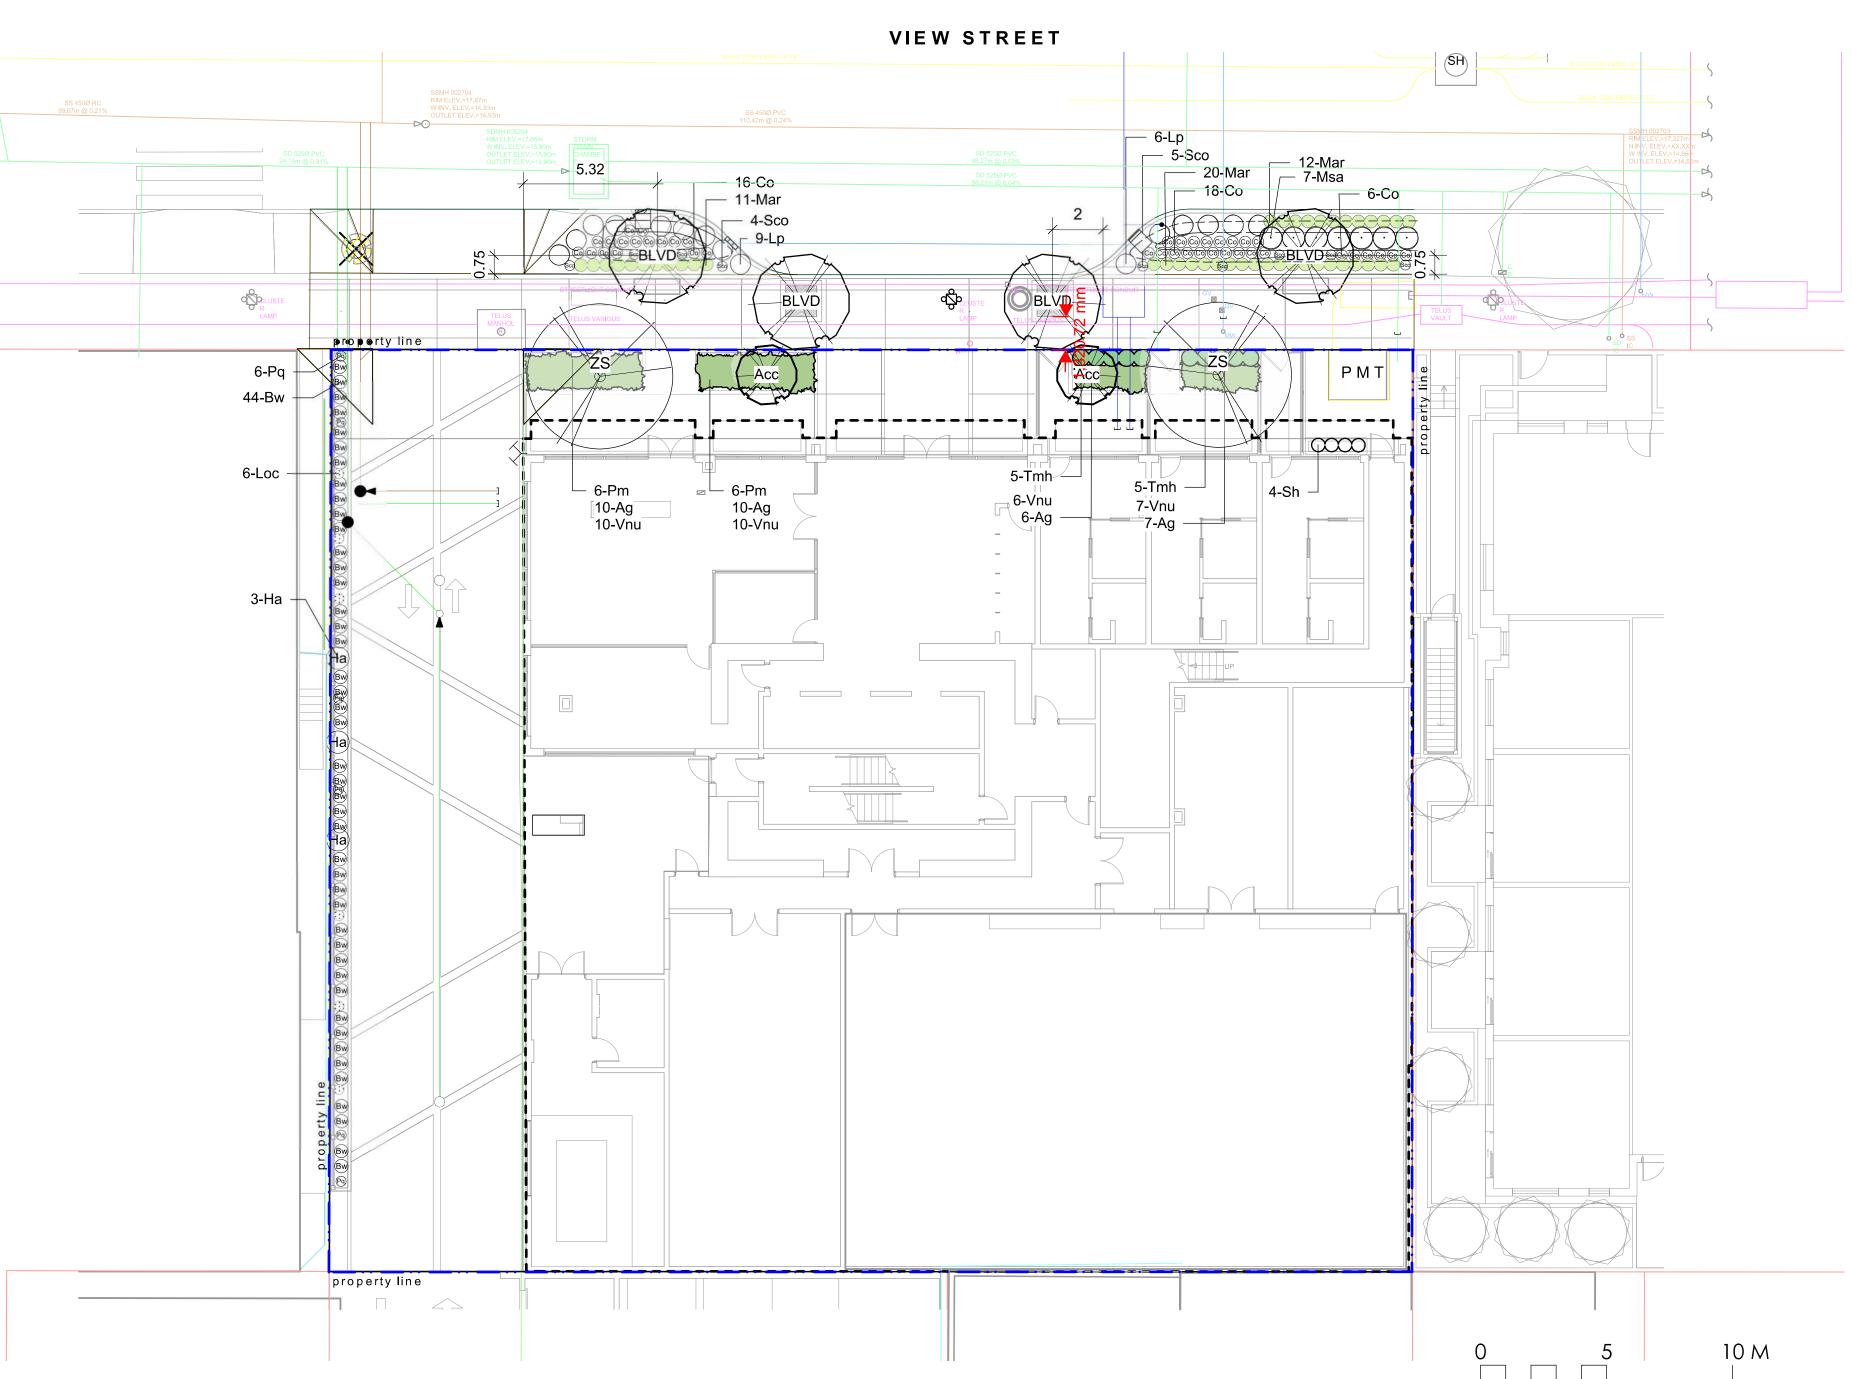



Sym	Qty	Botanical Name	Common Name	Schd. Size / Plant Spacing
		TREES:		
Acc	2	Acer circinatum	Vine Maple	1.8 m height, specimen qualit
BLVD	4	Boulevard Tree as per COV Parks	Boulevard Tree as per COV Parks	6 cm cal, b+b
ZS	2	Zelkova serrata	Japanese Zelkova	6.0cm cal, b&b
		SHRUBS:		
Ag	33	Azalea japonica 'Glacier'	Glacier Azalea	#1 pot
Bw	44	Buxus microphylla 'Winter Gem'	Littleleaf Boxwood	#1 pot
Co	40	Carex obnupta	Slough Sedge	#1 pot
На	3	Hydrangea anomala subsp petiolaris	Climbing Hydrangea	#1 pot
Loc	6	Lonicera ciliosa	Western Trumpet Honeysuckle	#1 pot
Lp	15	Lonicera pileata	Privet Honeysuckle	#2 pot
Mar	43	Mahonia repens	Prostrate Oregon Grape	#1 pot
Msa	7	Miscanthus sinensis 'Adagio'	Adagio Maiden Grass	#1 pot
Pq	6	Parthenocissus quinquefolia	Virginia Creeper	#1 pot
Pm	12	Polystichum munitum	Sword Fern	#1 pot
Sh	4	Sarcococca hookeriana var humilis	Himilayan Sweet Box	#1 pot
Sco	9	Schizostylis coccinea 'Oregon Sunset'	Crimson Flag	#1 pot
Tmh	10	Taxus x media 'Hilii'	Hilii Yew	#3 pot, 0.6 m ht. male only
Vnu	33	Vaccinium nummularia	Coin Whortleberry	#1 pot

GENERAL PLANTING NOTES

- 1. Plant quantities on Plans shall take precedence over plant list quantities.
- 2. Provide layout of all work for approval by Contract Administrator prior to proceeding with work.
- 3. Plant material, installation and maintenance to conform to the current edition of the Canadian Landscape Standard.
- 4. Plant quantities and species may change between issuance of DP and Construction due to plant availability and design changes. Substitutions to be approved by Landscape Architect.

BOULEVARD & GREENWAY PLANTING NOTES

- 1. Final selection and placement of boulevard trees to be determined through consultation with
- 2. Boulevard trees have been placed to avoid existing and proposed infrastructure. Trees planted within 1m of an existing underground municipal service will have a root barrier installed between the root ball and the existing infrastructure.
- 3. Boulevard trees will be place a minimum of 1.5 m from an above ground municipal service such as fire hydrant, streetlight or driveway.
- Proposed Street Trees must comply to City of Victoria Supplementary Specifications for Street
 Trees and Irrigation Schedule C, Bylaw 12-042, Subdivision Bylaw and the current version of the
 Canadian Landscape Standard. Planting details can be found in Schedule B3-4 or on the
 approved landscape plan. The following tree inspections by Parks Staff are required by
 Schedule C. To schedule an inspection please contact Rob Hughes, rhughes@victoria.ca and
- also copy treepermits@victoria.ca 48 hours prior to the required inspection time.

 5. Trees must have one dominant central leader or single straight trunk, 5-8 cm diameter, caliper measured 15 cm above ground, well balanced crown with branching starting at 1.8 m-2.5 m above ground, as per the City of Victoria Supplemental Drawings SD P4 and must comply with the current version of the Canadian Landscape Standard
- 6. Parks will require [3] inspections for tree planting: 1) Inspection of excavated tree pits, soil cells, root barriers. 2) Inspection of trees prior to planting. (Parks staff can inspect trees prior to shipping at local nurseries. Photos can be provided from up-island and mainland nurseries. Tree must meet the spec upon delivery.) 3) Inspection of installed tree with mulch and staking. Contact treepermits@victoria.ca to arrange for inspections, allow for 48 hrs notice.
- 7. The finished grade for boulevards must be firm against footprints, loose textured, free of all stones, roots, and branches. Parks inspection is required to turf installation. Email gstaniforth@victoria.ca to arrange for inspections, allow 48 hrs notice.
- 8. Final inspection of turf shall be conducted once the turf has knit, mowed at least twice to a height of 2.5 inches and no surface soil is visible.
- 9. Plant material and installation must meet or exceed the current edition of the Canadian
- Landscape Standard and specifications for planted landscapes as required in the MMCD.
- 10. Planted Landscape Inspections: 1) Excavated and scarified subgrade prior placement of the growing media 2) Installed and prepared Growing media prior to planting 3) Plant material onsite prior to planting (Parks staff can inspect plants prior to shipping at local nurseries. Photos can be provided from up-island and mainland nurseries.) 4) Planted landscape prior to the installation of mulch. 5) Inspection when the planted and mulched

an inspection please contact Tom Sherbo, tsherbo@victoria.ca

and also copy treepermits@victoria.ca 48 hours prior to the required inspection time.

11. The applicant will be required to pay the appraised value of the small boulevard tree proposed for removal. When the tree fee has been paid, the City will post the tree for [10] working days, after which it can be removed at the expense of the applicant.

landscaping meets the conditions for total performance as required in the MMCD.To schedule

IRRIGATION NOTES

- Contractor to provide irrigation system for all planting areas to current IIABC Standards and Contract Specifications.
- All specified work to meet the project specifications, and all standards or specifications established in the lastest edition of the Canadian Landscape Standard and IIABC standards.
 Design/build drawings for detailed irrigation plan to be submitted to Contract
- Administrator in PDF and .dwg formats at least two weeks prior to commencement of irrigation installation
- 4. Utilties Contractor to verify location of all on-site utilities, prior to construction. Restoration of damaged utilities shall be made at the contractor's expense, to the satisfaction of the owner's representatives.

7. Contractor to verify pressure and flow prior to installation of irrigation and notify

- 5. Refer to electrical drawings for electrical service.6. Controller and backflow prevention device to be located in Mechanical Room, unless otherwise noted. Refer to Mechanical drawings for size and location of irrigation
- owner's representative in writing if such data adversely affects the operation of the system.8. Sleeves shall be installed at the necessary depths, prior to pavement construction.
- 8. Sleeves shall be installed at the necessary depths, prior to pavement construction. Sleeving shall extend 300 mm from edge of paving into planting area, and shall have ends marked above grade unless otherwise shown.
- ends marked above grade unless otherwise shown.9. Contractor to field fit irrigation system around existing trees, to limit disturbance to root systems.
- 10. At various milestones during construction, inspection and testing of components will be required to ensure that the performance of irrigation system meets standards and specifications. Contractor to provide equipment and personnel necessary for performance of inspections and tests. Conduct all inspections and tests in the presence of the contract administrator. Keep work uncovered and accessible until successful completeition of inspection or test.
- 11. Over spray onto hardscape areas to be minimized. Use drip irrigation within small planting areas to avoid overspray.
- 12. Trees within shrub or rain garden areas to be irrigated with spray heads.13. Trees in Plaza in hard pavement (soil cells below) to recieve temporary irrigation system around root collar and permanent drip irrigation system
- 14. Irrigation Systems on City property shall comply to City of Victoria Supplementary Specifications for Street Trees and Irrigation Schedule C, Bylaw 12-042, SubdivisionBylaw. Irrigation drawings must be submitted to Parks Division for review and approval 30 days prior to installation work. The following irrigation and sleeving inspections by Parks Staff are required by Schedule C. To schedule an inspection please contac Tom Sherbo, tsherbo@victoria.ca and also copy treepermits@victoria.ca 48 hours prior to the required inspection time.

Tree ties

PLAN VIEW

Tree tie

Tree stake

Tree

Watering saucer

Mulch

Growing medium


Bottom of root ball rests on recompacted soil. Tamp growing medium below root ball to prevent settling.

Scarify native topsoil

Subgrade/native topsoil



1500 min.

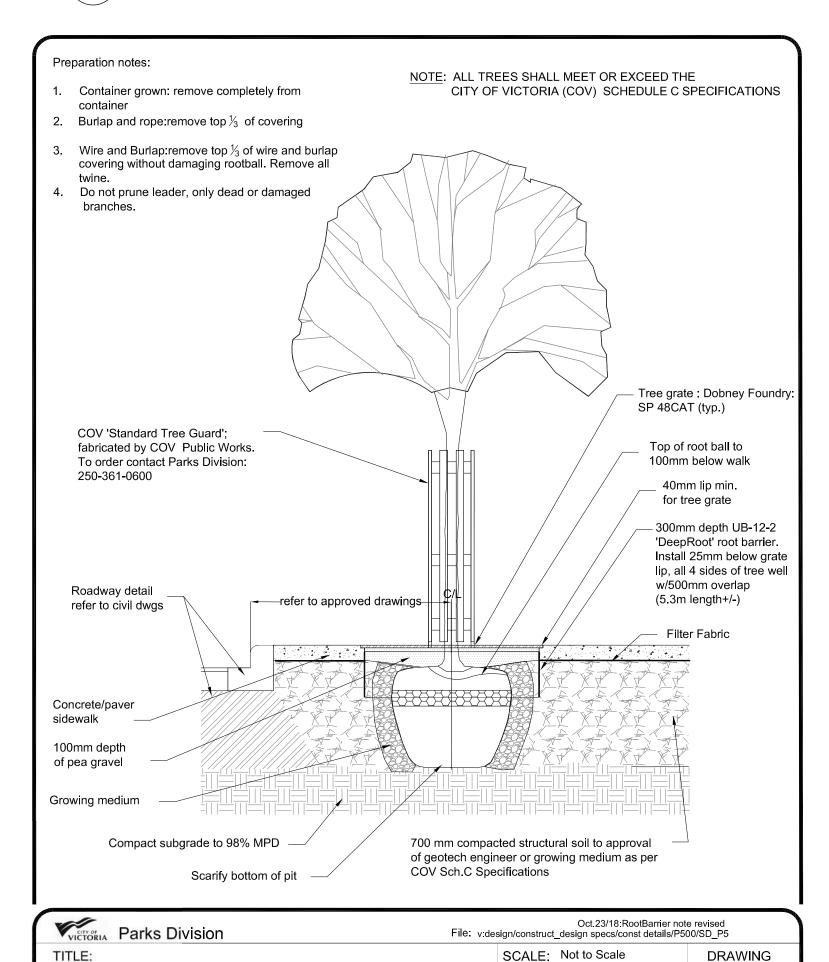

GENERAL NOTES

1. Work performed shall comply with the following: a) These General Notes, and Construction Documents and Specifications; b) Canadian Landscape Standards, Current Edition (CLS-CE); and c) All applicable local, provincial, and federal codes, ordinances, and regulations.

DATE: Feb.27, 2018

DWN.:

APP'D.:


SD-P5

2. Contractor shall be responsible for verifying all existing site conditions including location of all property lines, existing structures, utilities, and buried infrastructure. Verify all field conditions prior to commencing work.

Tree Planting in Sidewalk with Tree Guard

- 3. Contractor is responsible for determining means and methods for construction. These drawings may indicate a limit of proposed improvements or limit of work for the delineation of expected extents of disturbance. Should limits of disturbance exceed boundaries defined in drawings, contractor shall contact Landscape Architect for resolution.
- exceed boundaries defined in drawings, contractor shall contact Landscape Architect for resolution.
 4. Contractor is responsible for repairing all work disturbed by construction outside of limit lines defined on drawings or through their means and methods to a condition better than or equal to the existing conditions prior to commencement of construction at no additional cost to the owner.
- 5. Contractor is responsible for maintaining a complete up-to-date set of drawings and specifications at the construction site and ensuring the documents are readily available for review by the Landscape Architect and governing agency.
- 6. Contractor is responsible for coordination of all designs, drawings, specifications and other documents or publications upon which construction is based. Any discrepencies with the drawings and/or specifications and site conditions shall be brought to the attention of the Landscape Architect, prior to proceeding with construction.
- 7. The drawings and specifications are complementary to one another and implied to correspond with one another. Any discrepencies should be brought to the attention of the Landscape Architect for resolution immediately.
- discrepencies should be brought to the attention of the Landscape Architect for resolution immediately.

 8. General Contractor and/or sub-contractors are responsible for all costs related to production and submission to consultant of all landscape as-built information including irrigation.

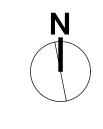

7	DP REV	23.09.1
6	DP REV	23.05.10
5	DP REV	21.04.30
4	Dev Permit Revisions	20.08.11
3	Issued for DP revisions	20.01.08
2	DP REV	19.10.17
1	DEV PERMIT	17.07.07
rev no	description	date



- 524 Culduthel Road Phone: 25 pria, BC V8Z 1G1 Fax: 2



2023-09-15

NELSON INVESTMENTS, INC.

. .

VIEW STREET RESIDENTIAL
937 VIEW STREET


sheet title

VICTORIA, BC


Planting Plan: Ground Level

project no.		119.24
scale	AS NOTED	@ 24"x36"
drawn by		ML
checked by		SM/PdG
revison no.	sheet no.	

revison no. sheet no

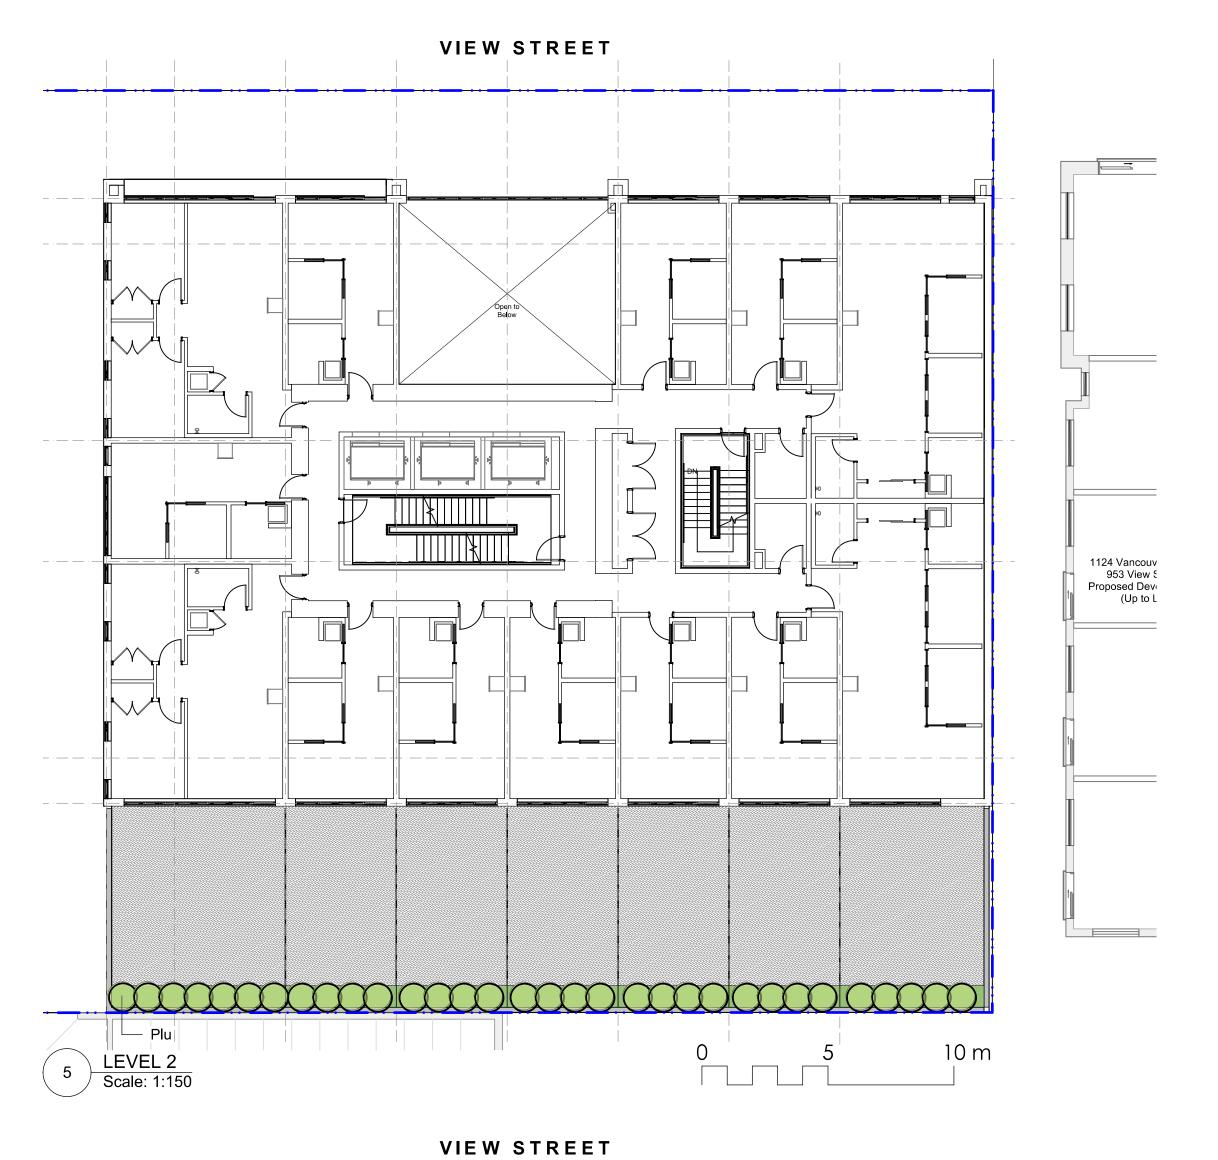


PLANT	LIST			
Sym	Qty	Botanical Name	Common Name	Schd. Size / Plant Spacing
LEVEL	<u>. 2</u>			
Plu	32	Prunus Iusitanica	Portugal Laurel	#3 pot
<u>LEVEL</u>	<u>. 6</u>			
TREES	<u>}:</u>			
SHRUE	3S/PER	ENNIALS:		
Ag	13	Azalea japonica 'Glacier'	Glacier Azalea	
Ptn	54	Pittosporum tobira 'Nana'	Dwarf Pittosporum	
Vo	13	Vaccinium ovatum	Evergreen Huckleberry	
	0			
<u>LEVEL</u>	<u>. 23</u>			
TREES	<u>8:</u>			
Psw	3	Pinus sylvestris 'Waterii'	Bonsai Pine	specimen, cloud pruned min 2 m height,
SHRUE	3S/PER	ENNIALS:		
Cvsk	24	Calluna vulgaris 'Silver Knight'	Silver Knight Scotch Heather	#1 pot
Pvi	29	Pennisetum villosum	Feathertop Grass	#1 pot
St	44	Stipa tenuissima	Mexican Feathergrass	#1 pot

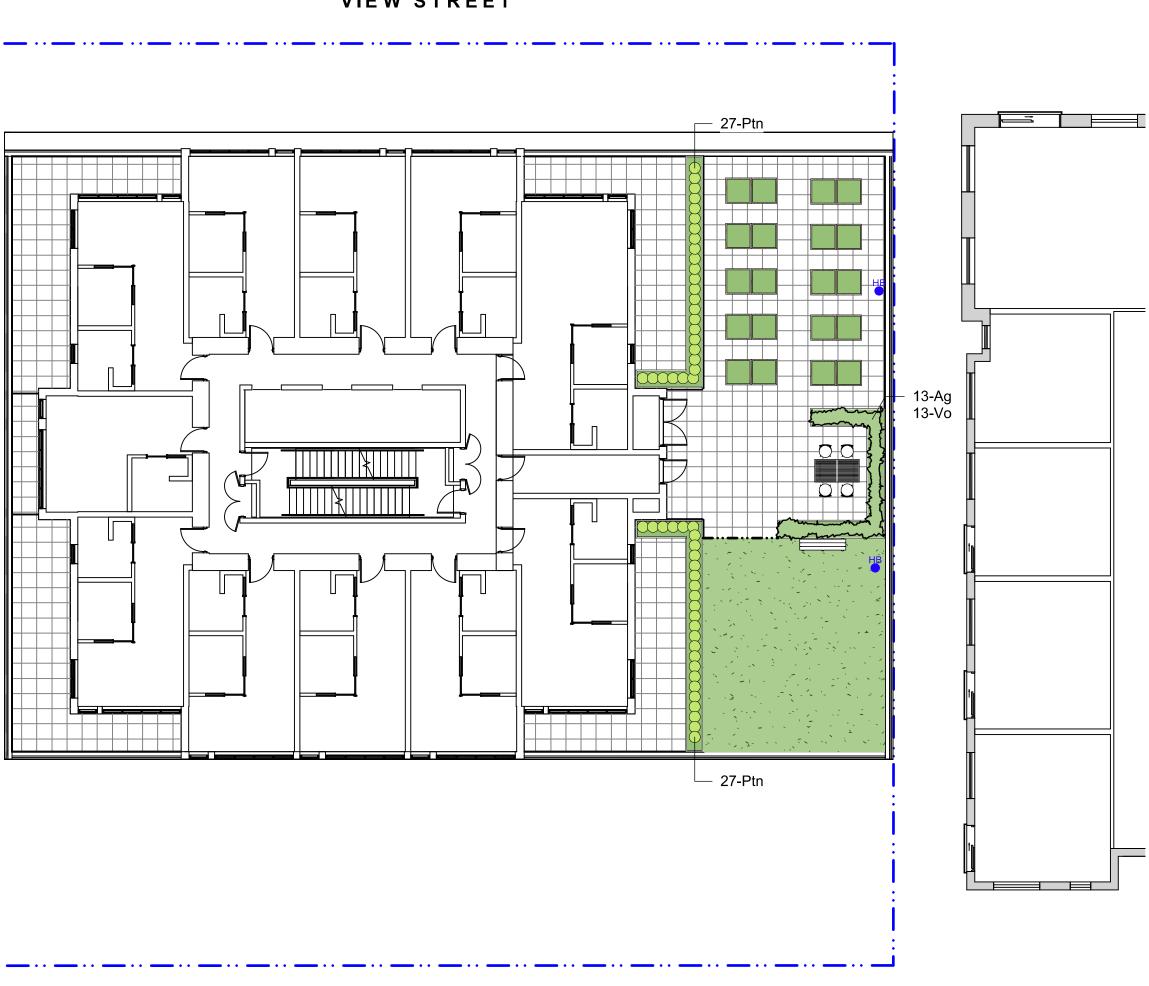

LEVEL 6
Scale: 1:150

0 5 10 m

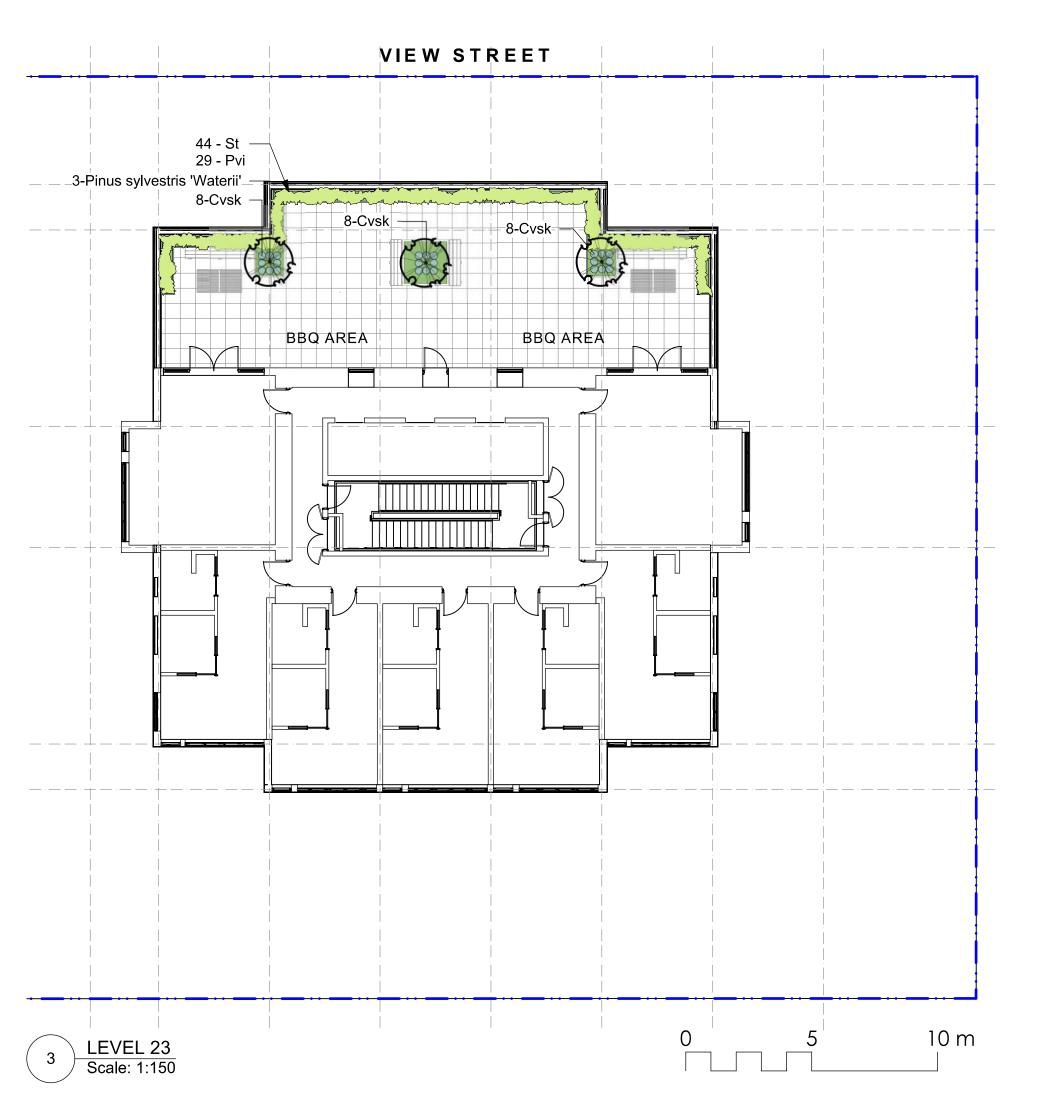

GENERAL NOTES

irrigation.

- Work performed shall comply with the following: a) These General Notes, and Construction Documents and Specifications; b) Canadian Landscape Standards, Current Edition (CLS-CE); and c) All applicable local, provincial, and federal codes, ordinances,
- Contractor shall be responsible for verifying all existing site conditions including location of all property lines, existing structures, utilities, and buried infrastructure. Verify all field conditions prior to commencing work
- conditions prior to commencing work.

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- Contractor is responsible for coordination of all designs, drawings, specifications and other documents or publications upon which construction is based. Any discrepencies with the drawings and/or specifications and site conditions shall be brought to the attention of the
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ev no	description	date



24 Culduthel Road Phone: 250.41 a, BC V8Z 1G1 Fax: 250.41



2023-09-15

NELSON INVESTMENTS, INC.

oject

VIEW STREET RESIDENTIAL 937 VIEW STREET VICTORIA, BC

sheet title

Planting Plan: Upper Levels

project no.		119.24
scale	AS NOTED	@ 24"x36"
drawn by		ML
checked by		SM/PdG
revison no.	sheet no.	
7	L	3.02

LEGEND

EXISTING	PROPOSED	DESCRIPTION	EXISTING	PROPOSED	DESCRIPTION
///		EDGE OF PAVEMENT			REDUCER
CURB		CURB AND GUTTER		-x x x x	FENCE
		EDGE OF GRAVEL	~ ~ ~ ~	~ ~ ~	DITCH/SWALE
TB/BB		TOP/BOTTOM OF BANK		w	WATERMAIN (SIZE AND MATERIAL NOTED)
СВ		CATCH BASIN		s	SANITARY SEWER (SIZE AND MATERIAL NOTE
WV WV		WATER VALVE	D	D	STORM DRAIN (SIZE AND MATERIAL NOTED)
- -	+	FIRE HYDRANT	Т——Т	Т	UNDERGROUND TELEPHONE
=======================================		CAPPED END	Н	——н——	UNDERGROUND HYDRO
\ominus		UTILITY POLE AND STREET LIGHT (LABELED PP,TP,PP/LS ETC.)	· ·		MONUMENT
· MH	-	MANHOLE			PROPERTY LINE
——⊗ CO		CLEANOUT		5+100 5+110	CENTERLINE AND STATIONING
oSSIC/SDIC	SSIC/SDIC	SANITARY/STORM INSPECTION CHAMBER (200# RISER)	· · · · · · · · · · · · · · · · · · ·		SANITARY SEWER SERVICE CONNECTION AT M
JB		JUNCTION BOX	+32.75	43.170)+	ELEVATIONS
——————————————————————————————————————		AIR VALVE			PAVEMENT REMOVAL
WM	wM	WATER METER			ASPHALT MILL AND OVERLAY








DWG NO. DESCRIPTION	DWG No.	DESCRIPTION
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C100 GENERAL NOTES, LOCATION PLAN, KEY PLAN, DRAWINGS LIST & LEGEND

C200 SITE SERVICING PLAN
C300 GRADING PLAN
C400 BC HYDRO INFORMATION PLAN

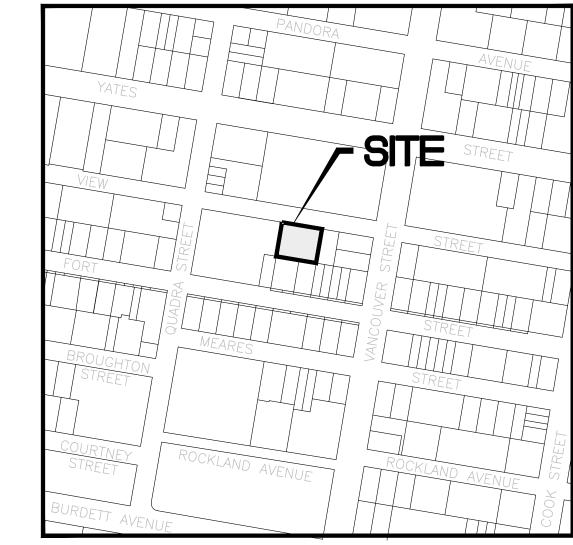

LOCATION PLAN

937 VIEW STREET
LOT A, OF LOTS 785, 786 AND 787, VICTORIA CITY, PLAN 36505.
R-48, HARRIS GREEN
RESIDENTIAL

LAND USE:

PROPOSED:

SITE AREA:

RESIDENTIAL

253 UNIT 15 STOREY RESIDENTIAL BUILDING

1572m²

SITE AREA: 1572m²

DWELLING FOOTPRINT AREA: 725m²

MAIN FLOOR ELEVATION: 17.60m

PLAN TO ACCOMPANY DEVELOPMENT PERMIT APPLICATION

GENERAL NOTES:

CIVIC ADDRESS:

LEGAL:

ZONING:

- 1. ALL WORK AND MATERIALS ARE TO BE IN ACCORDANCE WITH THE CITY OF VICTORIA (CoV)
 SPECIFICATIONS, ITS SUPPLEMENTARY MASTER MUNICIPAL SPECIFICATIONS, STANDARD DETAIL DRAWINGS
 AND MMCD UNLESS OTHERWISE NOTED. IF A CONFLICT BETWEEN SPECIFICATIONS ARISES, THE MOST
 STRINGENT SHALL APPLY.
- 2. THE ENGINEER SHALL BE NOTIFIED 48 HOURS PRIOR TO COMMENCEMENT OF WORK.
- 3. SIGNATURE BLOCK FOR SHALLOW UTILITIES TO BE SIGNED AND DATED PRIOR TO CONSTRUCTION.
 4. PERMITS TO CONSTRUCT WORKS ON THE CoV RIGHT OF WAY MUST BE OBTAINED FROM THE CoV ENGINEERING DEPARTMENT PRIOR TO COMMENCING WORK. PERMITS MUST BE ON SITE FOR REVIEW AS
- 5. CONFIRM LOCATION AND ELEVATION OF ALL EXISTING UTILITIES AT ALL CROSSINGS AND CONNECTIONS AND REPORT ANY DISCREPANCIES TO THE ENGINEER PRIOR TO CONSTRUCTION.
- AND REPORT ANY DISCREPANCIES TO THE ENGINEER PRIOR TO CONSTRUCTION.

 6. CONFIRM THAT ELEVATION, LOCATION AND GRADIENT OF ASPHALT MATCH EXISTING PRIOR TO PLACEMENT
- OF ASPHALT OR CONCRETE.
 7. ALL TREES NOT BEING REMOVED IN THE CONSTRUCTION AREA SHALL BE PROTECTED. CARE TO BE
- TAKEN TO RETAIN AS MANY TREES AS POSSIBLE.

 8. ADJUST ALL MANHOLES, WATER VALVES, HYDRO VAULTS, ETC. TO MATCH NEW CONSTRUCTION.
- 9. ALL LOCATIONS AND ELEVATIONS OF EXISTING UTILITIES SHOWN ARE APPROXIMATE ONLY AND SHOULD BE CONFIRMED BY USE OF A PIPE LOCATOR AND MANUAL DIGGING. ALL OR ANY STRUCTURES NOT NECESSARILY SHOWN.
- 5. ALL EXCAVATED TRENCH AND SUBEXCAVATION MATERIALS TO BE DISPOSED OF OFFSITE.
- 6. ALL ELEVATIONS ARE TO GEODETIC DATUM.
- 7. DATA SOURCES:
 -TOPOGRAPHIC SURVEY COMPLETED BY POWELL & ASSOCIATES BC LAND SURVEYORS, DECEMBER 2016.
 -DIGITAL GIS PROVIDED BY CoV.
 -BC 1 CALL DATA FOR SHALLOW UTILITIES.

ROAD NOTES:

- 1. CONSTRUCT ALL SIDEWALK AND DRIVEWAY CROSSINGS IN ACCORDANCE WITH CoV AND MMCD STANDARDS AS NOTED ON DRAWINGS.
- 2. MAINTAIN VEHICULAR AND PEDESTRIAN ACCESS ALONG VIEW STREET DURING CONSTRUCTION.
 3. ROAD RESTORATION FOR VIEW STREET TO CoV SUPPLEMENTAL DWG. No. SD G5a AND G5b.
- 4. THE PROVISION OF APPROVED SIGNS AND CERTIFIED TRAFFIC CONTROL PERSONNEL IS THE
- CONTRACTOR'S SOLE RESPONSIBILITY.

 5. ALL PAVEMENT EXCAVATIONS TO BE SAWCUT.
- 6. PROJECT FRONTAGE TO BE RESTORED AS NOTED ON CIVIL, LANDSCAPE AND ARCHITECTURAL DRAWINGS AS PER CoV "NEW TOWN" SPECIFICATIONS.
- 7. PEDESTRIAN WALKING AREA TO BE DELINEATED DURING THE CONSTRUCTION OF THE WORKS AND MUST BE EASILY RECOGNIZABLE BY THE PUBLIC AND CONTAIN NO OBSTRUCTIONS TO MOBILITY SCOOTERS OR WHEELCHAIRS AND NO HAZARDOUS CONDITIONS. THE PUBLIC USING THESE AREAS MUST BE ADEQUATELY PROTECTED FROM TRAFFIC.

WATER NOTES:

- 1. WATER SERVICE CONNECTION TO BE PER CoV STD. DWG. No. W2d SS.
- CONTRACTOR TO CONFIRM THAT EXISTING WATER SERVICES HAVE BEEN CAPPED BY CONTRACTOR/DEVELOPER AND INSPECTED BY CoV PLUMBING DEPARTMENT AT DEVELOPER'S EXPENSE.


STORM DRAIN AND SANITARY SEWER NOTES:

- 1. CONTRACTOR TO CONFIRM THAT EXISTING SANITARY AND STORM DRAIN SERVICES HAVE BEEN CAPPED BY CONTACTOR/DEVELOPER AND INSPECTED BY COV PLUMBING DEPARTMENT AT DEVELOPER'S EXPENSE.
- STORM DRAIN AND SANITARY SEWER CONNECTIONS TO BE AS PER CoV STD. DWG. No. S7 SS.
 STORM DRAIN CONNECTION TO BE 2000 PVC SDR28 AT A MINIMUM GRADE OF 2.00% UNLESS OTHERWISE NOTED.
- 4. SANITARY SEWER CONNECTION TO BE 2500 PVC SDR28 AT A MINIMUM GRADE OF 2.00% UNLESS
- 5. UNDERGROUND SERVICES TO BE LOCATED, EXPOSED AND ELEVATIONS CONFIRMED AT CROSSINGS PRIOR
- TO INSTALLATION OF CONNECTIONS.

SHALLOW UTILITY AND STREET LIGHT NOTES:

- 1. EXISTING BC HYDRO, TELUS, SHAW CABLE AND FORTIS BC INFRASTRUCTURE INFORMATION SHOWN ON DRAWINGS IS SCHEMATIC AND FOR INFORMATION ONLY.
- 2. REFER TO UTILITY COMPANY DESIGN DRAWINGS FOR CONSTRUCTION DETAILS. CONSTRUCT UNDERGROUND UTILITIES AS SPECIFIED AND IN ACCORDANCE WITH BC HYDRO, TELUS, SHAW CABLE SPECIFICATIONS AND DRAWINGS.
- 3. CONFIRM AND COORDINATE WITH CoV FORCES REINSTATEMENT OF LAMP STANDARDS AS PER CoV SUPPLEMENTARY STANDARD DETAIL DRAWINGS, INCLUDING BASES, CONDUIT AND JUNCTION BOX.

 4. CONTACT BC 1 CALL AT 1-800-474-6886 A MINIMUM OF 48 HOURS PRIOR TO CONSTRICTION
- 4. CONTACT BC 1 CALL AT 1-800-474-6886 A MINIMUM OF 48 HOURS PRIOR TO CONSTRICTION.
 5. CONTACT BC HYDRO, TELUS, SHAW CABLE AND FORTIS BC 48 HOURS PRIOR TO THE START OF ANY
- EXCAVATION.
 6. BC HYDRO TO COORDINATE AND PROVIDE LIAISON WITH CoV PRIOR TO AND DURING CONSTRUCTION.

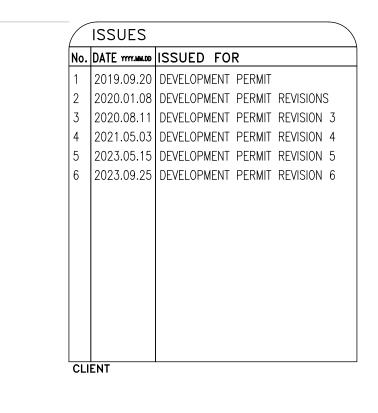

ISSUED FOR EVELOPMENT PERMI'

937 VIEW STREET MARKET RENTAL RESIDENCES

HEROLD

1051 Vancouver St, Victoria, BC V8V 4T6
Tel: 250-590-4875 Fax: 250-590-4392
Email: mail@heroldengineering.com

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GENERAL NOTES, LOCATION PLAN, KEY PLAN, DRAWINGS LIST

DESIGNED
TDL
DESIGN REVIEW
AJH
DRAFTED
LAM
DRAFTING REVIEW
SAC
PROJECT No.
5094-001

SCALE
DESIGN REVIEW
CILENT DRAWING No.

H: AS NOTED
V: —

HEL DRAWING No.

C100

1 OF 4

