



1055 Alston Street
Victoria BC

Rev	2	23-03-30	DP / Re zoning
	1	23-03-29	CALUC
Rev	2	23-03-30	DP / Re zoning
Plot Date	06/19/23	Project Status	DP / Re zoning
Drawn By	BW/S	Checked By	CRK
Scale		Project Number	2304

NOTE: All dimensions are shown in millimeters.

Alston
1055 Alston St, Victoria, BC
V9A 3S6
Cover Sheet



Revisions

Received Date:
April 18, 2024



dHka **A000**

dHkaArchitects
Victoria
977 Fort Street
Nanaimo
102-5190 Dublin Way V8T 0H2 T 1-250-668-3367
1-250-585-5810
©2023 dHka Architects. All rights reserved. This drawing and its contents are the property of dHka Architects and shall remain confidential. No part of this drawing may be reproduced without written consent.

BC LAND SURVEYORS SITE PLAN OF:

Civic: 1055 Alston Street

**Legal: Lot 105, District Lot 119, Esquimalt District,
Plan 3237 Included Within Plan 4010**

Parcel Identifier: 002-094-550
in the City of Victoria

LEGEND

Elevations are geodetic and referenced
to the CG2880 datum.

+ - denotes existing elevation

Tree diameters are in centimetres.

Lot Area = 1406 m²

Scale 1:150 Distances are in meters




The intended print size is 24" by 18"

Setbacks are derived from field survey.

Parcel dimensions shown hereon are
derived from Land Title Office records.

Property Lines and setbacks shown may
vary upon completion of a lot repositing
and preparation of a legal survey plan.

This document shows the relative location
of the surveyed features and shall not be
used to define property boundaries.

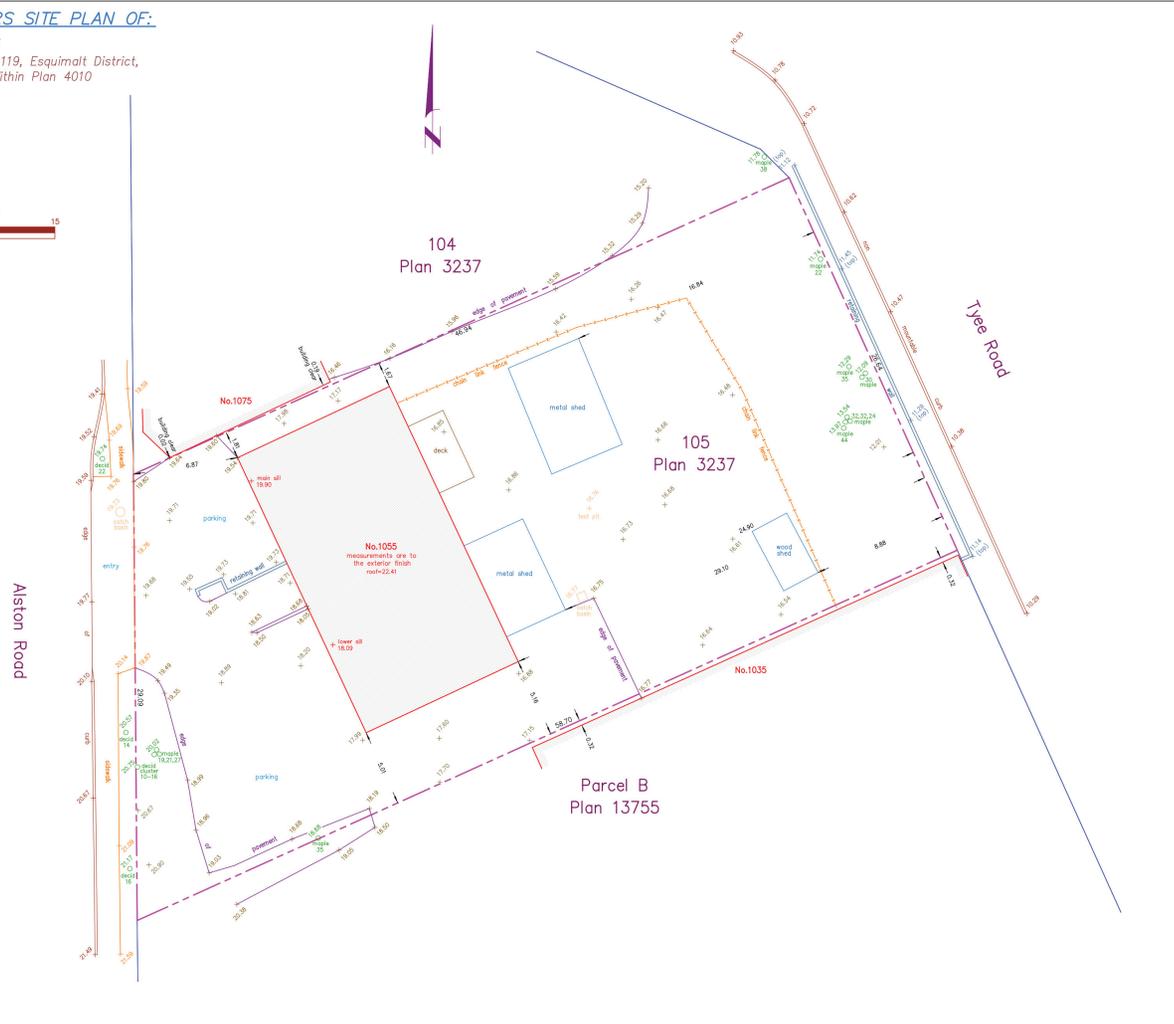

Date	August 9, 2022
File	13,819-23
POWELL & ASSOCIATES	
BC Land Surveyors	
250-290 Douglas Street	
Victoria, BC V8T 4N4	
phone (250) 382-8855	

Rev	1	23-03-25	Description	CALUC
Plot Date	06/19/23	Project Status	DP / Re zoning	
Drawn By	BWS	Checked By	CRK	
Issue		Project Number	2304	

NOTE: All dimensions are shown in millimetres.

Alston
1055 Alston St, Victoria, BC
V9A 3S6
Survey



dHka A002

dHkArchitects
Victoria
977 Fort Street
Nanaimo
102-5190 Dublin Way V8T 0H2 T 1-250-585-5810

BRITISH COLUMBIA REGISTERED ARCHITECTS
VBC 3K3 T 1-250-668-3367
ECP PROJECTS AND ASSOCIATES LTD. (2008) INC. AND AT ALL TIMES HEREBY
WE WILL BE REPRESENTED WITHOUT FURTHER CONSENT.



1075 Alston Street

1055 Alston Street

Alston Street View



736 Tyee Road

740 Tyee Road

790 Tyee Road

Tyee Street View

3	23-06-15	DP / Rezoning Rev. 1
2	23-03-30	DP / Rezoning
1	23-03-29	CALUC
3	23-06-15	Description: DP / Rezoning Rev. 1
	06/19/23	Project Status: DP / Rezoning
Drawn By:	BWS	Checked By: CRK
Scale:	1:3	Project Number: 2304

NOTE: All dimensions are shown in millimeters.


Alston
 1055 Alston St, Victoria, BC
 V9A 3S6
Street View




dHk Architects
 Victoria
 977 Fort Street
 Nanaimo
 102-5190 Dublin Way V9T 0H2 T 1-250-585-5810
 977 Fort Street
 Victoria BC V8V 3K3 T 1-250-668-3367
 Nanaimo
 102-5190 Dublin Way V9T 0H2 T 1-250-585-5810

Summer Solstice

10am

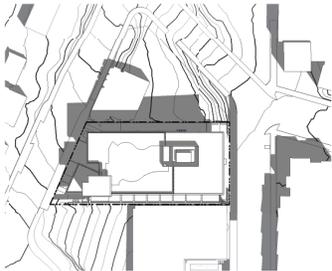


12pm

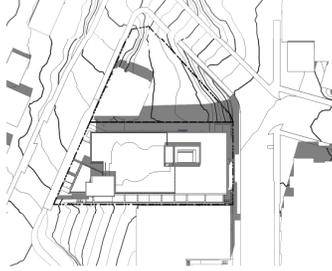

2pm




4pm

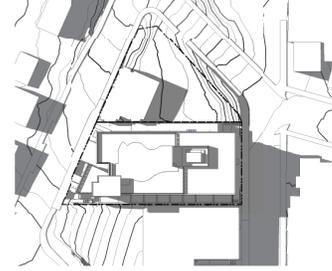

Equinox

10am

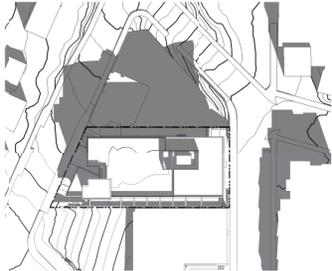

12pm



2pm




4pm




Winter Solstice


10am

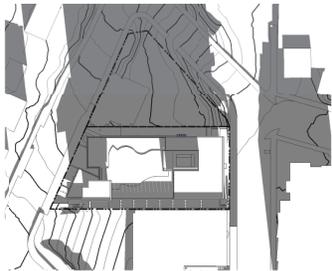


12pm

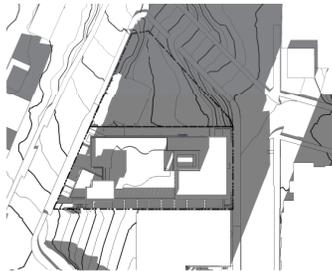

2pm

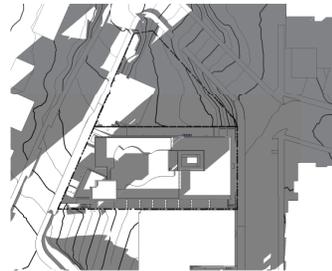

4pm

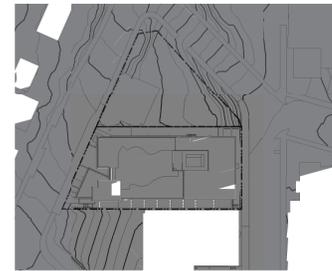

Rev	2	23-03-30	Description	DP / Rezoning
Rev	2	23-03-30	Description	DP / Rezoning
Pre Date	06/1923	Project Date	DP / Rezoning	
Drawn By	AUR/04	Checked By	Checker	
Scale	1:750	Project Number	2304	


NOTE: All dimensions are given in millimeters.

Alston
1055 Alston St, Victoria, BC
V9A 3S6
Shadow Studies



dHk Architects
Victoria
977 Fort Street
Nanaimo
102-5190 Dublin Way V8T 0H2 T 1-250-585-5810

2304-06-01 14:01:11 PM

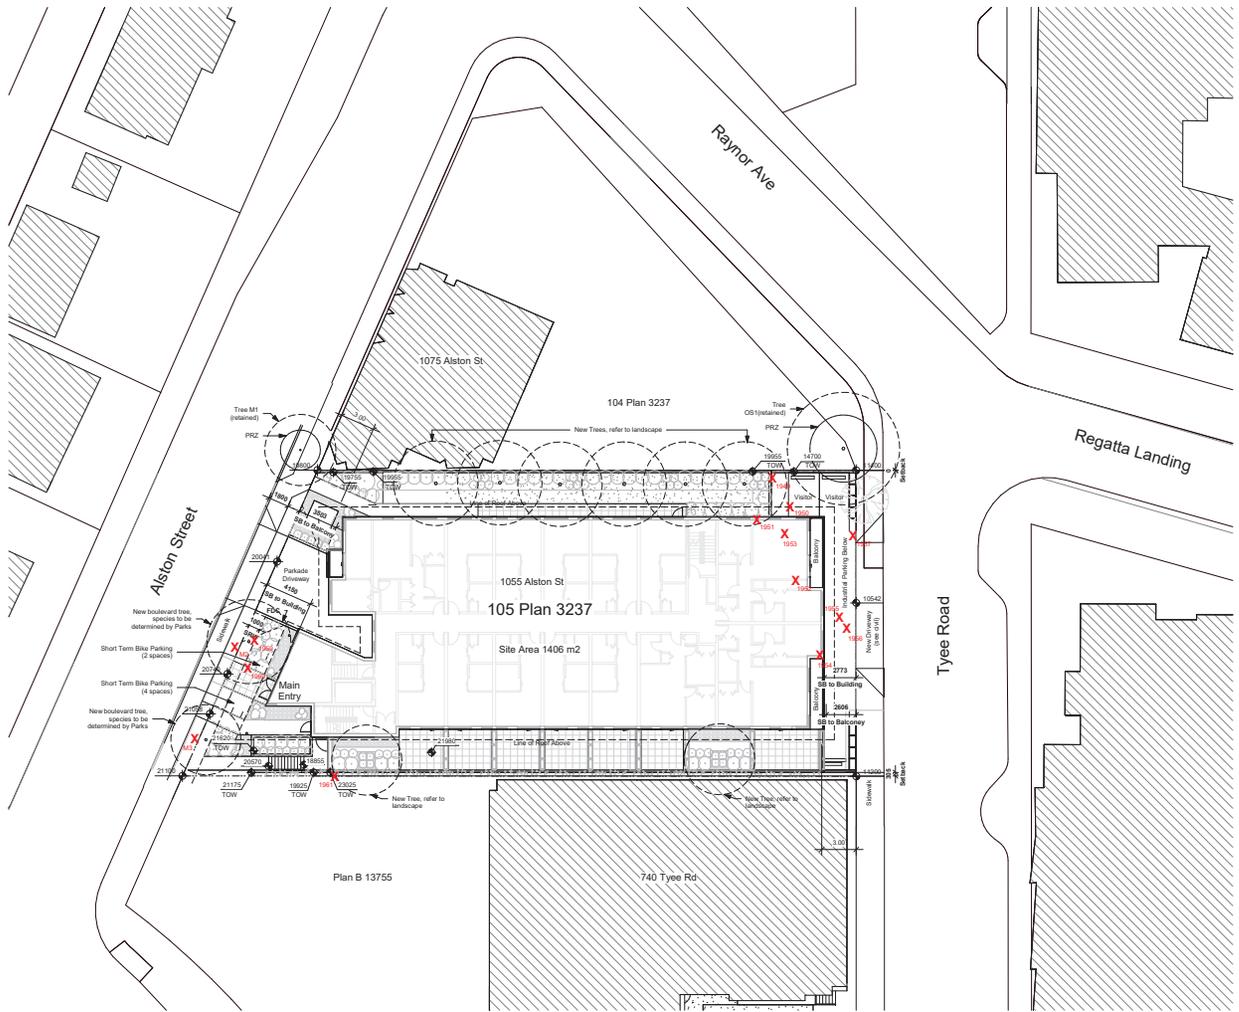

1 Site Plan - Overall
A101 SCALE: 1:200


- General Notes:**
1. Refer to Civil drawings for all roadways, driveways, paths, and grading.
 2. Refer to Landscape drawings for all hard and soft landscaping on site.

7	24-04-11	DP / Rezoning Rev. 5
6	24-02-14	DP / Rezoning Rev. 4
5	23-10-26	DP / Rezoning Rev. 3
4	23-07-25	DP / Rezoning Rev. 2
2	23-03-30	DP / Rezoning
1	23-03-25	CALCUL

Rev.	7	24-04-11	Description	DP / Rezoning Rev. 5
Prep Date	06/19/23	Project Status	DP / Rezoning	
Drawn By	BWS	Checked By	CRK	
Scale	1:200	Project Number	2304	

NOTE: All dimensions are shown in millimeters.

Alston
1055 Alston St, Victoria, BC
V9A 3S6
Site Plan Overall

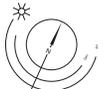


dHka Architects
Victoria
977 Fort Street
Nanaimo
102-5190 Dublin Way V8T 0H2 T 1-250-585-5810

VBV 3K3 T 1-250-658-3367
102-5190 Dublin Way V8T 0H2 T 1-250-585-5810


THIS PROJECT IS THE PROPERTY OF dHka ARCHITECTS LTD. ANY REUSE OR REPRODUCTION OF THIS PROJECT WITHOUT WRITTEN CONSENT IS PROHIBITED.

- General Notes:**
1. Refer to Civil drawings for all roadways, driveways, curbs, and grading.
 2. Refer to Landscape drawings for all hard and soft landscaping on site.

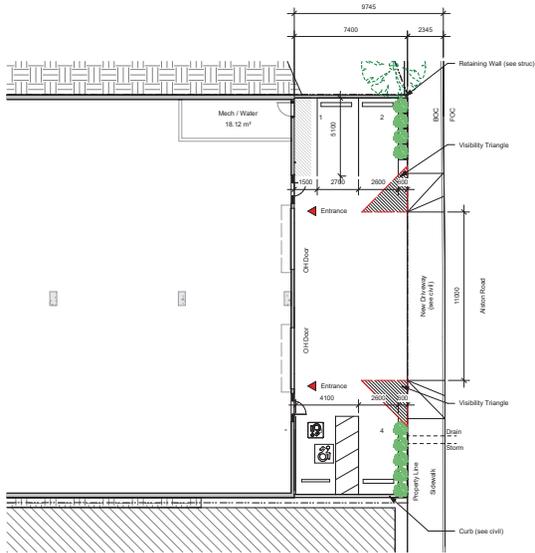


1 Site - Tyee Rd - Circulation
A102 SCALE: 1 : 150


Note:
- Civil to Confirm Sidewalk Elevation
- PMT Conc. Pad to Match Sidewalk Elevation

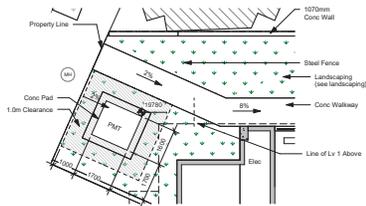

4 Site - Alston St - PMT
A102 SCALE: 1 : 100

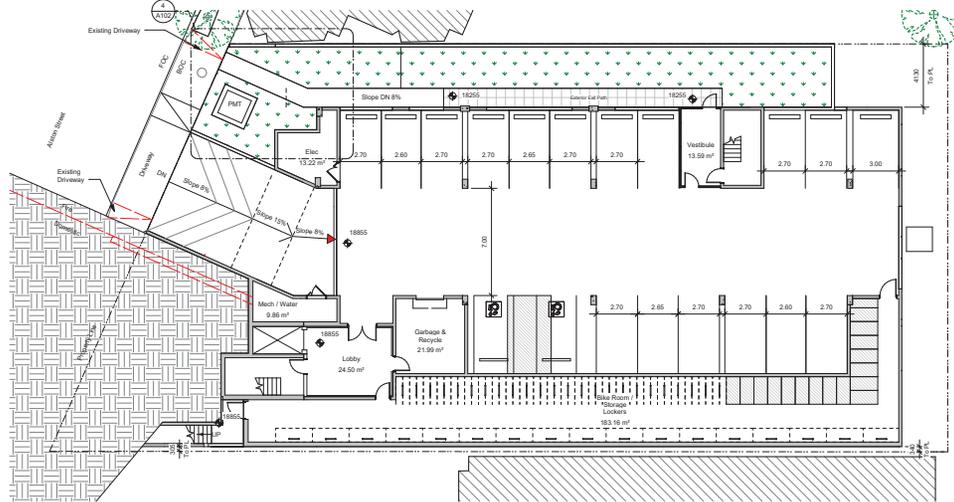

2 Site - Alston St - Parkade Circulation
A102 SCALE: 1 : 150

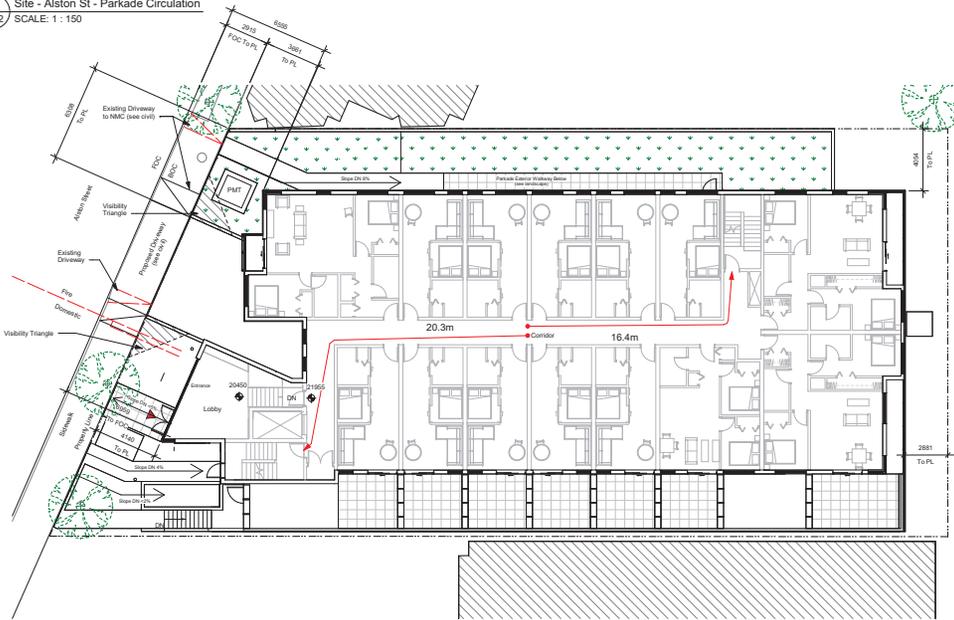

3 Site - Alston St - Level 1 Circulation
A102 SCALE: 1 : 150


5	23-10-26	DP / Re-zoning Rev. 3		
4	23-07-25	DP / Re-zoning Rev. 2		
3	23-06-15	DP / Re-zoning Rev. 1		
2	23-03-30	DP / Re-zoning		
Rev.	5	23-10-26	Description	DP / Re-zoning Rev. 3
Prep Date	06/19/23	Project Status	DP / Re-zoning	
Drawn By	BWS	Checked By	CRK	
Date	As Issued	Project Number	2304	

Alston
1055 Alston St, Victoria, BC
V9A 3S6
Site Plan -
Circulation



dHka Architects
Victoria
977 Fort Street
Nanaimo
102-5190 Dublin Way V8T 0H2 T 1-250-688-3367
V8V 3K3 T 1-250-688-3367
BCP PROJECT NO. 2304 ARCHITECTS' LICENSE NO. 102-5190 AND AT ALL TIMES REMAIN THE PROPERTY OF dHKA ARCHITECTS. THIS DOCUMENT IS THE PROPERTY OF dHKA ARCHITECTS AND IS NOT TO BE REPRODUCED WITHOUT WRITTEN CONSENT.

General Notes:
 1. Refer to Civil drawings for all roadways, driveways, curbs, and grading.
 2. Refer to Landscape drawings for all hard and soft landscaping on site.

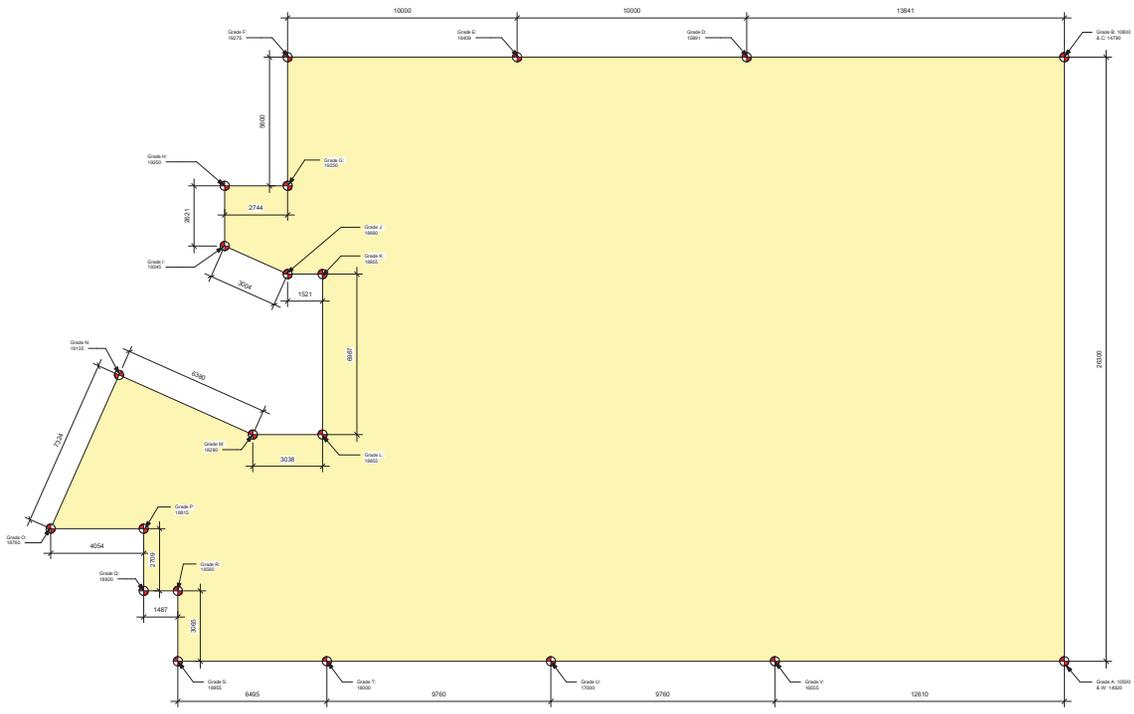

Grade Point


Grade Point	Grade
Grade A	14700
Grade B	14700
Grade C	14700
Grade D	14894
Grade E	14700
Grade F	14700
Grade G	14700
Grade H	14700
Grade I	14700
Grade J	14700
Grade K	14700
Grade L	14700
Grade M	14700
Grade N	14700
Grade O	14700
Grade P	14700
Grade Q	14700
Grade R	14700
Grade S	14700
Grade T	14700
Grade U	14700
Grade V	14700
Grade W	14700

Calculation


Grade Point	Grade Point	Distance	Total
Grade A to B	14700	2700	27.0
Grade B to C	14700	10000	100.0
Grade C to D	14894	10340.5	103.405
Grade D to E	14700	10000	100.0
Grade E to F	14700	17342	173.42
Grade F to G	14700	10000	100.0
Grade G to H	14700	10000	100.0
Grade H to I	14700	10000	100.0
Grade I to J	14700	10000	100.0
Grade J to K	14700	10000	100.0
Grade K to L	14700	10000	100.0
Grade L to M	14700	10000	100.0
Grade M to N	14700	10000	100.0
Grade N to O	14700	10000	100.0
Grade O to P	14700	10000	100.0
Grade P to Q	14700	10000	100.0
Grade Q to R	14700	10000	100.0
Grade R to S	14700	10000	100.0
Grade S to T	14700	10000	100.0
Grade T to U	14700	10000	100.0
Grade U to V	14700	10000	100.0
Grade V to W	14700	10000	100.0
Total			143.14

Grade Calculation
 Average Grade: 14.35m

1 Grading
 A103 SCALE: 1 : 100

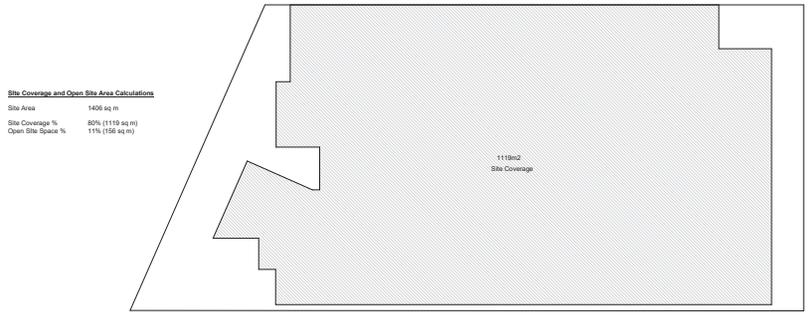

2 Site Coverage
 A103 SCALE: 1 : 200

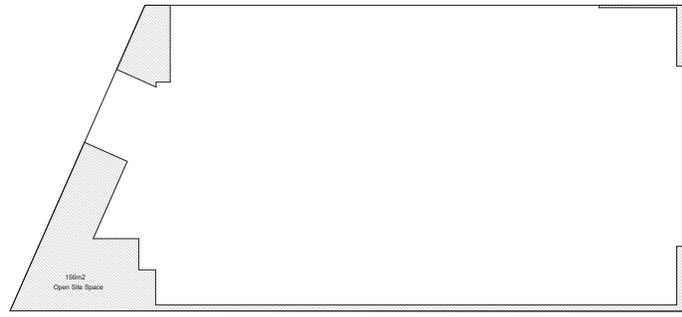

5	23-10-26	DP / Re-zoning Rev. 3
4	23-07-25	DP / Re-zoning Rev. 2
2	23-03-30	DP / Re-zoning
5	23-10-26	Description: DP / Re-zoning Rev. 3
5	06/19/23	Project Status: DP / Re-zoning
Drawn By:	BWS	Checked By: CRK
Scale:	As Indicated	Project Number: 2304


NOTE: All dimensions are shown in millimeters.

Alston
 1055 Alston St, Victoria, BC
 V9A 3S6
 Site Plan - Grading



dHKA
A103
 dHKA Architects
 977 Fort Street
 Nanaimo
 102-5190 Dublin Way V9T 0H2 T 1-250-585-5810
FOR PROFESSIONAL REGULATION PURPOSES ONLY AND NOT TO BE USED FOR ANY OTHER PURPOSES. THIS DOCUMENT IS THE PROPERTY OF dHKA ARCHITECTS AND IS NOT TO BE REPRODUCED WITHOUT WRITTEN CONSENT.



2024.06.05 14:51:07 PM

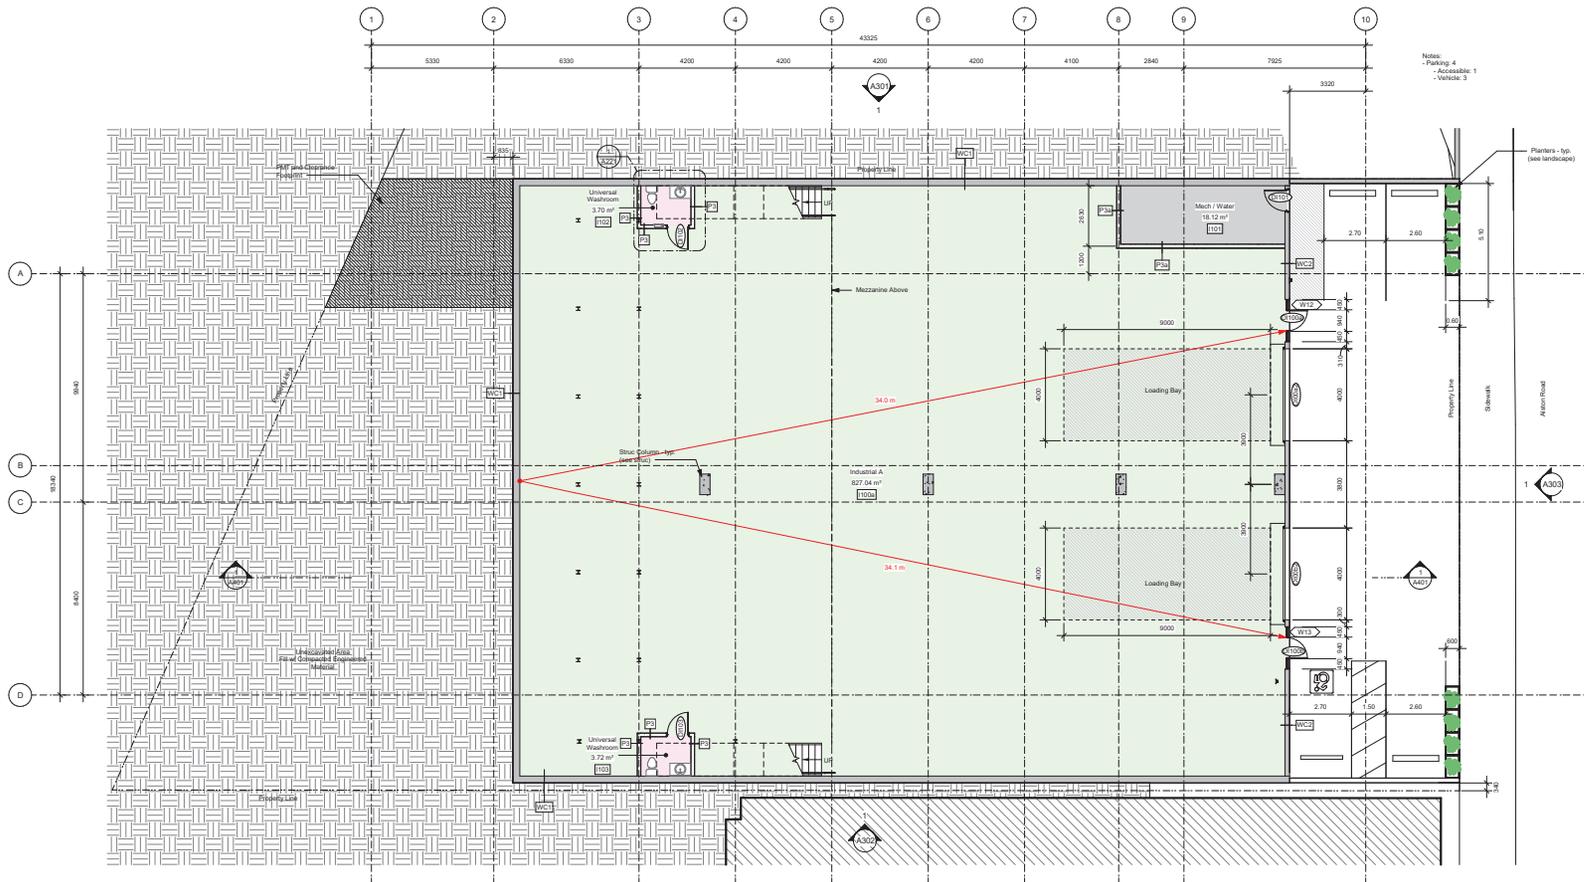

1 Industrial - Tyee Rd
A201 SCALE: 1:100

5	23-10-26	DP / Re zoning Rev. 3		
4	23-07-25	DP / Re zoning Rev. 2		
2	23-03-30	DP / Re zoning		
1	23-03-25	CALCUL		
Rev.	5	23-10-26	Description	DP / Re zoning Rev. 3
Pre Date	06/19/23	Project Date	DP / Re zoning	
Drawn By	BWS	Checked By	CRK	
Scale	1:100	Project Number	2304	


Alston
1055 Alston St, Victoria, BC
V9A 3S6
Lower Commercial /
Industrial - Tyee Rd

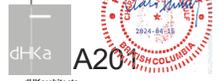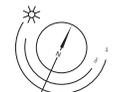

dHKA Architects
Victoria
977 Fort Street
Nanaimo
102-5190 Dublin Way V8T 0H2 T 1-250-585-5810

Victoria
977 Fort Street
Nanaimo
102-5190 Dublin Way V8T 0H2 T 1-250-585-5810

2024.04.01 14:05:05 PM

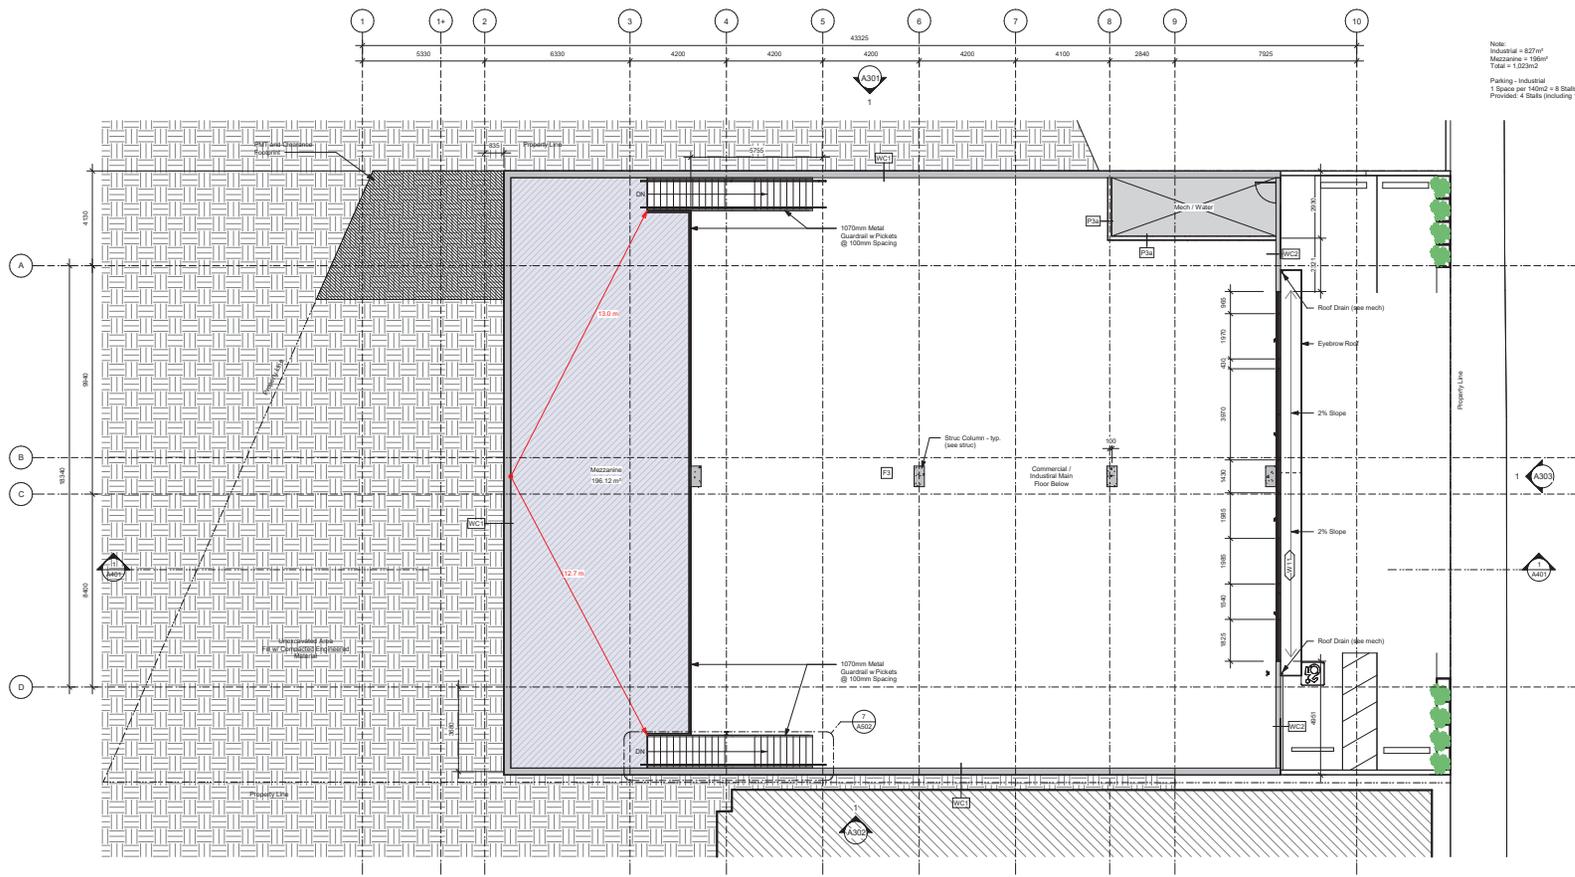

Note:
 Industrial = 827m²
 Mezzanine = 196m²
 Total = 1,023m²
 Parking - Industrial
 3 Spaces per 100m² = 8 Stalls
 Provided 4 Stalls (including 1 HC)

1 Industrial - Mezzanine
 A202 SCALE: 1 : 100

5	23-10-26	DP / Re-zoning Rev. 3		
2	23-03-30	DP / Re-zoning CALUC		
1	23-03-25			
Rev.	5	23-10-26	Description	DP / Re-zoning Rev. 3
Prep Date	06/19/23	Project Date	DP / Re-zoning	
Drawn By	BWS	Checked By	CRK	
Scale	1 : 100	Project Number	2304	

NOTE: All dimensions are shown in millimeters.


Alston
 1055 Alston St, Victoria, BC
 V9A 3S6
Mezzanine



dHKA **A202**
dHKA Architects
 Victoria
 977 Fort Street
 Nanaimo
 102-5190 Dublin Way V9T 0H2 T 1-250-585-5810
 V9V 3K3 T 1-250-688-3367
 102-5190 Dublin Way V9T 0H2 T 1-250-585-5810

 dHKA ARCHITECTS INC. IS A MEMBER OF THE ARCHITECTS ASSOCIATION OF BRITISH COLUMBIA AND THE ARCHITECTS ASSOCIATION OF CANADA. dHKA ARCHITECTS INC. IS A MEMBER OF THE ARCHITECTS ASSOCIATION OF BRITISH COLUMBIA AND THE ARCHITECTS ASSOCIATION OF CANADA.

2024.04.01 14:00 PM

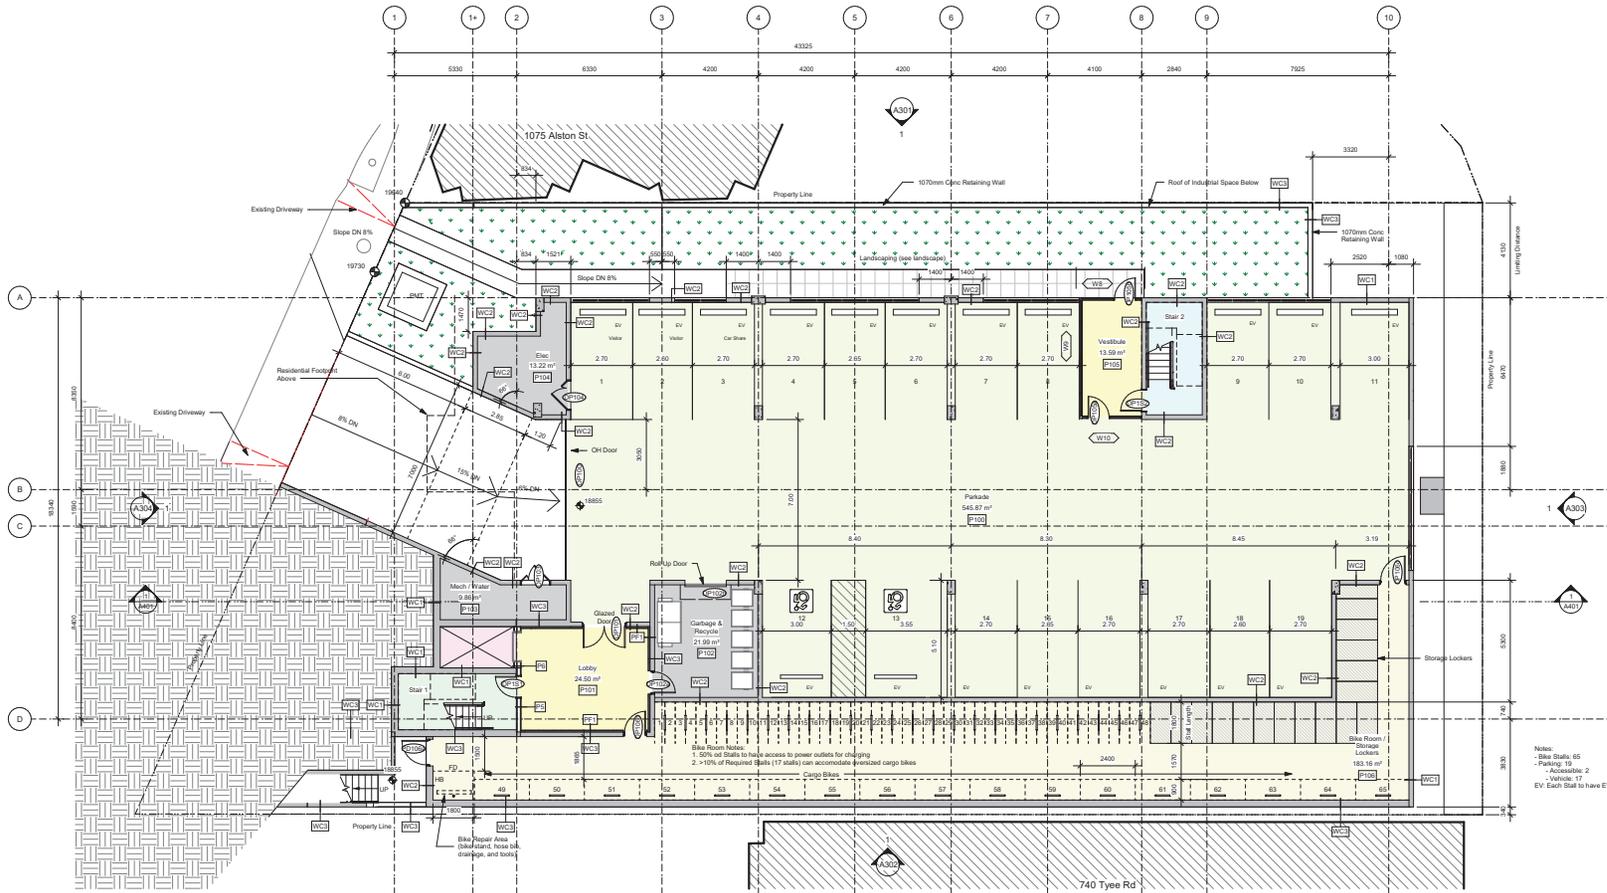

1 Parkade - Alston St
A203 SCALE: 1:100

On Site Parking	Required	Proposed	Parkade - Alston St	Industrial - Vee Rd
Total	20	15	15	4
Standard Stall	60	20	17	3
Accessible Parking	4	3	7	1
Visitor Parking	6	0	0	0

Min Parking Spaces	One Bedroom	Two Bedroom	Two Bedroom	Visitor	Total
Condo	40 1 per 245m ² 0.25	4 1 per 45m ² 70m ²	12 1 per 370m ² 3.45	1 unit x 0.1 54 Units 6	61.40
Industrial	34 1 per 140m ²	4 Industrial Area	17 Divided by	140	8.75
Total Vehicle Parking Req^d					69.65

Bicycle Parking	Required	Proposed
Total	60	64
Long Term	6	6


Long Term Bike Parking	Required	Proposed	Total Req'd	Total Provided
Multiple Dwelling	1 per 140m ²	1.25 per 140m ²	16	65
Industrial	40 one bedroom 16 two bed	40 70	60	65
Short Term Bike Parking	The greater of either 6 spaces per building or 0.1 spaces per unit		6	6

Min Accessible Parking	Req'd per Spaces	Req'd Accessible	Req'd Accessible Van	Provided Accessible	Provided Accessible Van
Multiple Dwelling	2.5%	2	1	2	0
Industrial	6.25%	0	1	1	0
Min Accessible Visitor Parking	Req'd per Spaces	Req'd Accessible	Req'd Accessible Van	Provided Accessible	Provided Accessible Van
Multiple Dwelling	51.75%	0	1	0	0
Industrial	6.25%	0	1	0	0


- Notes:
- Site Stalls: 65
- Parking: 15
- Accessible: 2
- Vehicle: 17
EV: Each Stall to have EV Charging

Rev	Date	Description	DP / Reasoning
7	24-04-11	Drawings	DP / Reasoning Rev. 5
6	24-02-14	Project Data	DP / Reasoning Rev. 4
5	23-10-28	Project Data	DP / Reasoning Rev. 3
4	23-07-25	Project Data	DP / Reasoning Rev. 2
3	23-06-15	Project Data	DP / Reasoning Rev. 1
2	23-03-30	Project Data	DP / Reasoning
1	23-03-25	Project Data	CALCULATED

Alston
1055 Alston St, Victoria, BC
V9A 3S6
Parkade - Alston
Street

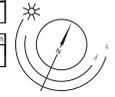

dKa Architects
Victoria
977 Fort Street
Nanaimo
102-5190 Dublin Way V9T 0H2 T 1-250-585-5810
V9V 3K3 T 1-250-668-3367
dKa PROJECTS: RESIDENTIAL, COMMERCIAL AND INDUSTRIAL AND ALL TRADES INCLUDING
dKa PROJECTS: RESIDENTIAL, COMMERCIAL AND INDUSTRIAL AND ALL TRADES INCLUDING
dKa PROJECTS: RESIDENTIAL, COMMERCIAL AND INDUSTRIAL AND ALL TRADES INCLUDING

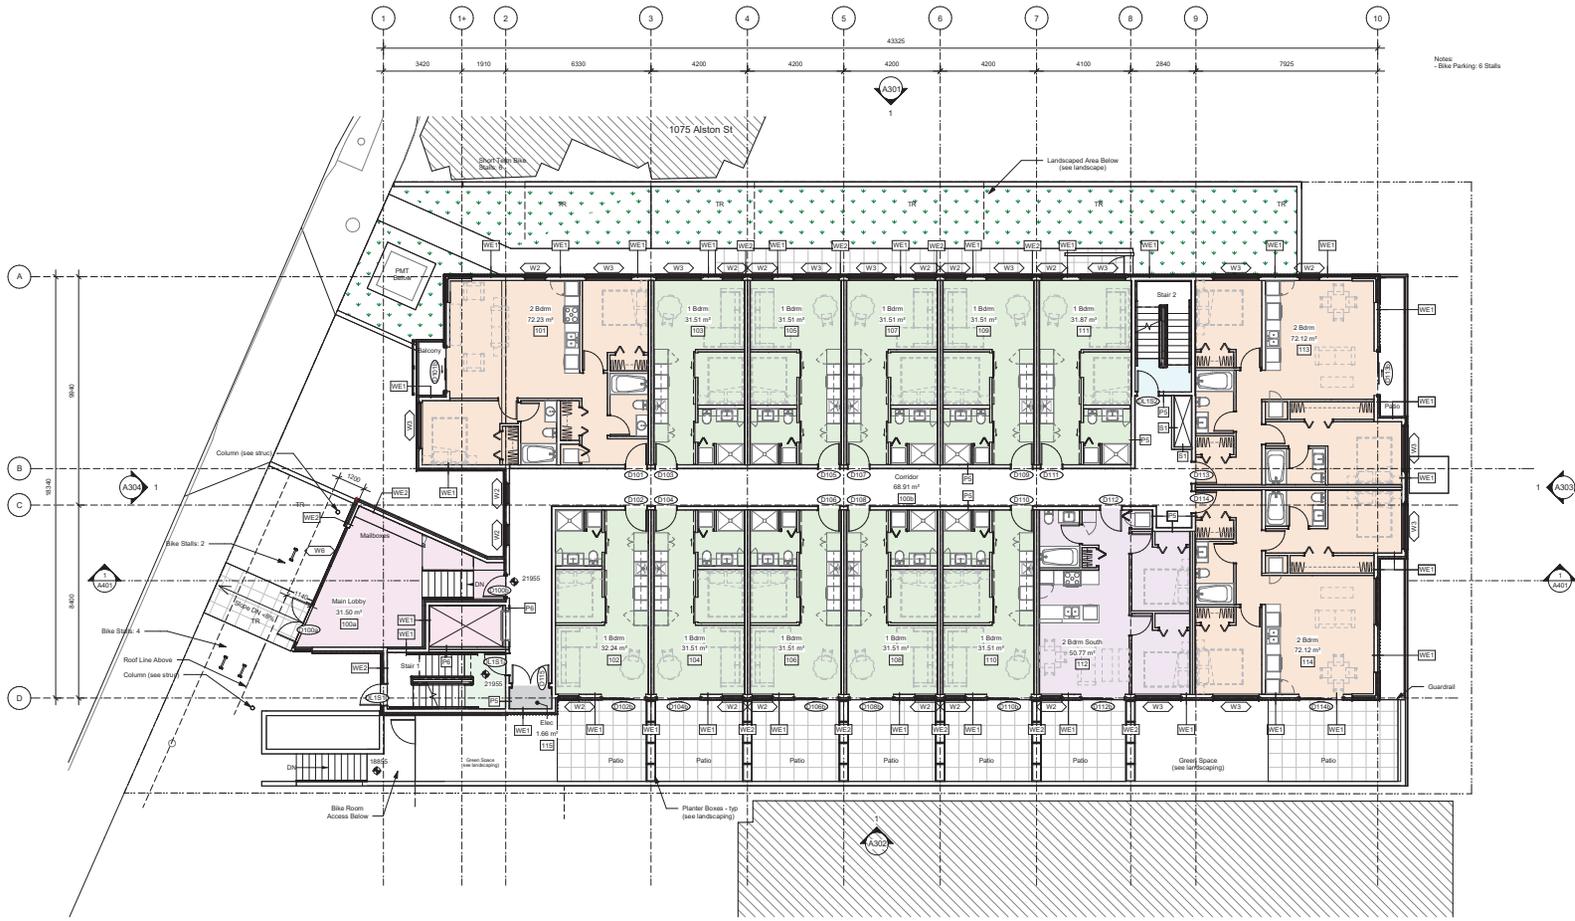

1 Level 1 - Overall
A204 SCALE: 1 : 100

Plan B 13755 / Parking


740 Tye Rd

5	23-10-26	DP / Rezoning Rev. 3		
4	23-07-25	DP / Rezoning Rev. 2		
3	23-06-15	DP / Rezoning Rev. 1		
2	23-03-30	DP / Rezoning		
1	23-03-25	CALUC		
Rev.	5	23-10-26	Description	DP / Rezoning Rev. 3
Prep Date	06/19/23	Project Name	DP / Rezoning	
Drawn By	BWS	Checked By	CRK	
Scale	1 : 100	Project Number	2304	

Alston
1055 Alston St, Victoria, BC
V9A 3S6
Level 1



dHk Architects
Victoria
977 Fort Street
Nanaimo
102-5190 Dublin Way V8T 0H2 T 1-250-585-5810
V8V 3K3 T 1-250-668-3367

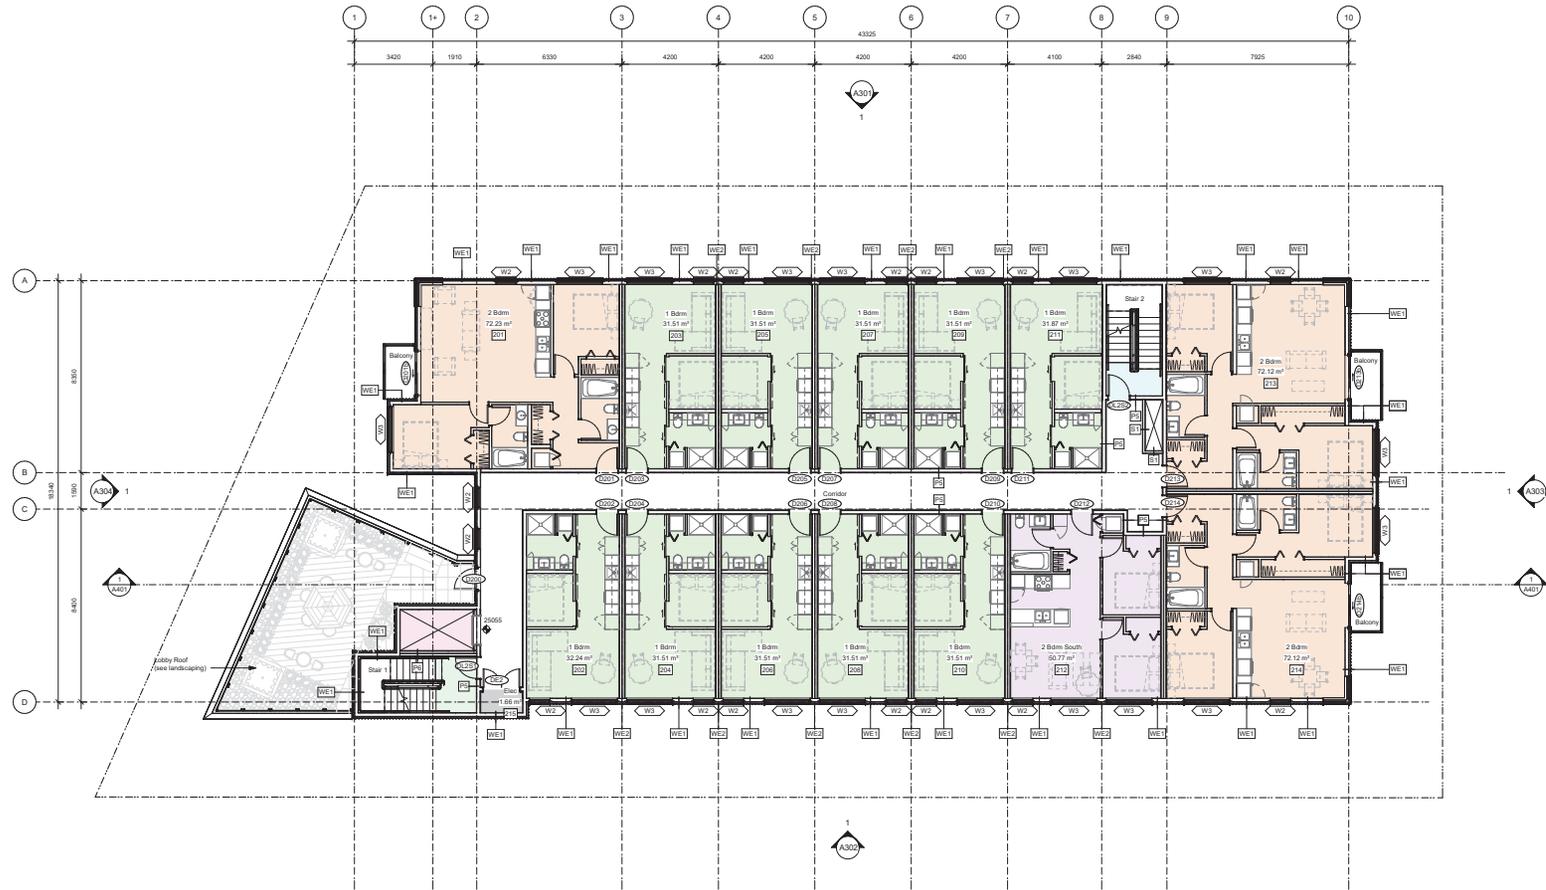

1 Level 2 - Overall
A205 SCALE: 1:100

2	23-03-30	DP / Reznoring		
1	23-03-29	CALUC		
Rev	2	23-03-30	Description	DP / Reznoring
Plan Date	06/19/23	Project Date	DP / Reznoring	
Drawn By	BWS	Checked By	CRK	
Scale	1:100	Project Number	2304	


NOTE: All dimensions are shown in millimeters.

Alston
1055 Alston St, Victoria, BC
V9A 3S6
Level 2



dHk Architects
Victoria
977 Fort Street
Nanaimo
102-5190 Dublin Way V8T 0H2 T 1-250-688-3367



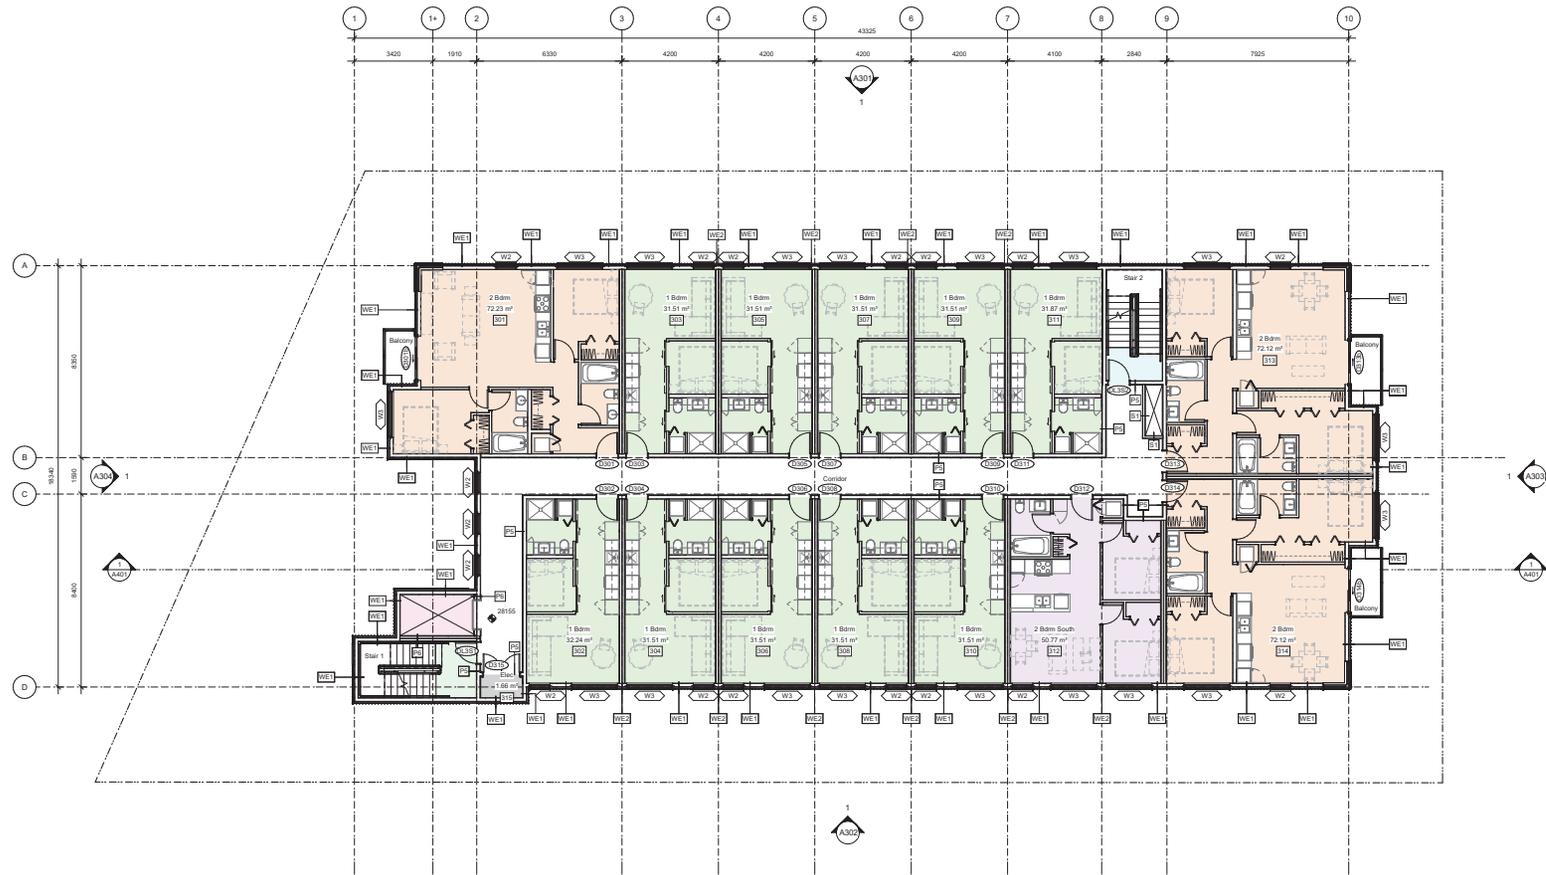

1 Level 3 - Overall
A206 SCALE: 1 : 100


2	23-03-30	DP / Re zoning	CALUC	
1	23-03-29			
Rev	2	23-03-30	Description	DP / Re zoning
Proj Date	06/19/23	Project Status	DP / Re zoning	
Drawn By	BWS	Checked By	CRK	
Scale	1 : 100	Project Number	2304	

Alston
1055 Alston St, Victoria, BC
V9A 3S6
Level 3



dHk Architects
Victoria
977 Fort Street
Nanaimo
102-5190 Dublin Way V8T 0H2 T 1-250-585-5810

VBV 3K3 T 1-250-688-3367
2314-840-035
BC PROFESSIONAL ARCHITECTS
BC PROFESSIONAL ARCHITECTS
BC PROFESSIONAL ARCHITECTS

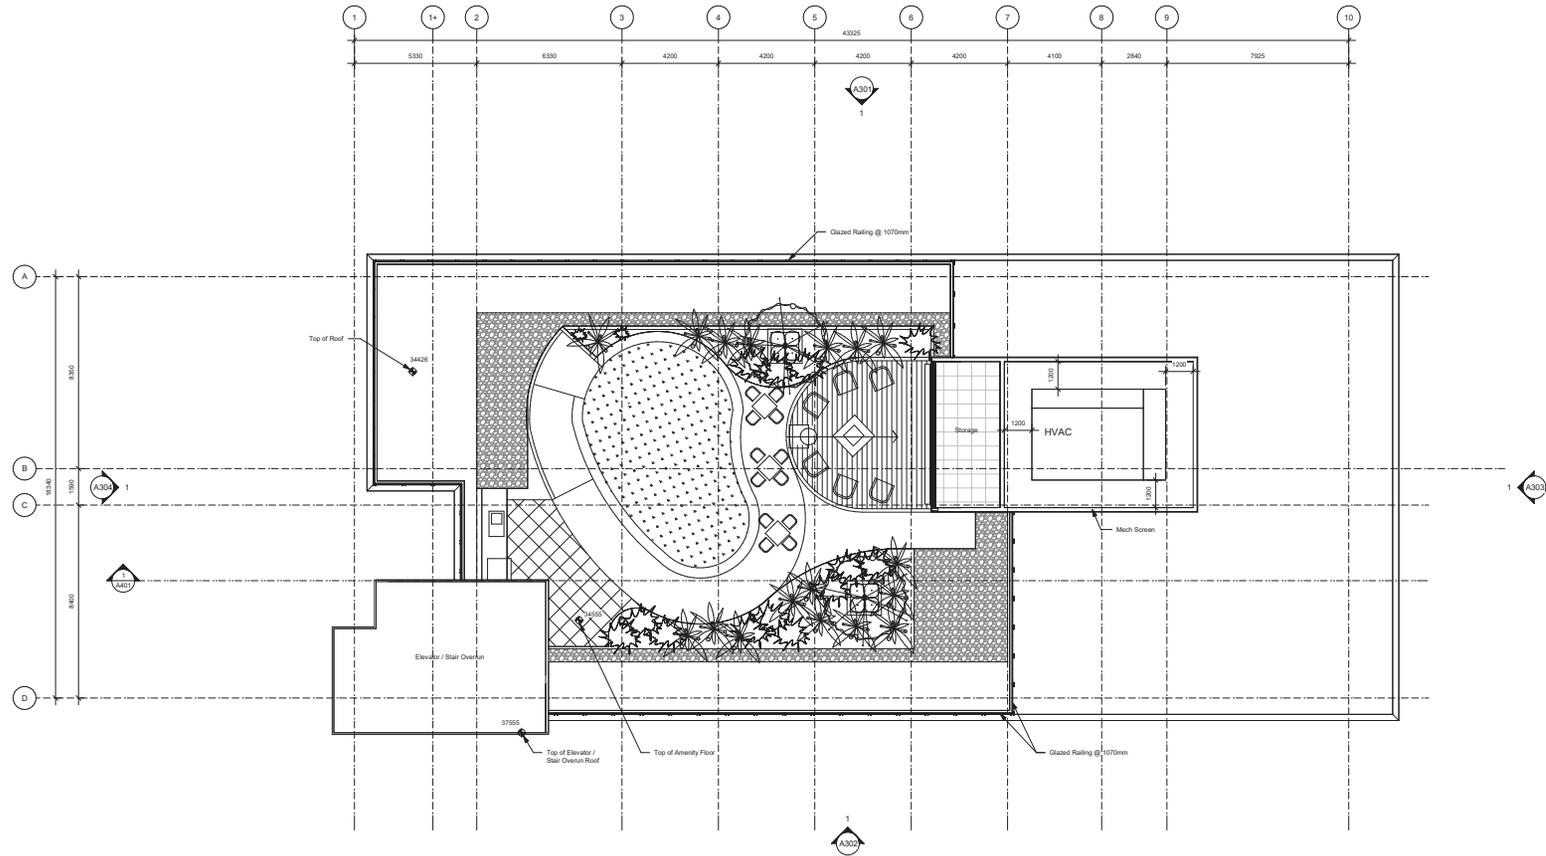

1 Roof
A208 SCALE: 1 : 100

Rev.	4	23-07-25	Description	DP / Re-zoning Rev. 2
	3	23-06-15	Project Status	DP / Re-zoning Rev. 1
	2	23-03-30	Checked By	DP / Re-zoning
	1	23-03-25	Project number	CALCUL
Prep Date	06/19/23	Project Status	DP / Re-zoning	
Drawn By	BWS	Checked By	CRK	
Scale	1 : 100	Project number	2304	

Alston
1055 Alston St, Victoria, BC
V9A 3S6
Roof



dHka A208


dHkArchitects
Victoria
977 Fort Street
Nanaimo
102-5190 Dublin Way V8T 0H2 T 1-250-668-3367

2500 3000
1 : 100

REGISTERED ARCHITECT
2014-2024
2500 3000
1 : 100

BC REG. NO. 12345
2014-2024
1 : 100

BC REG. NO. 12345
2014-2024
1 : 100

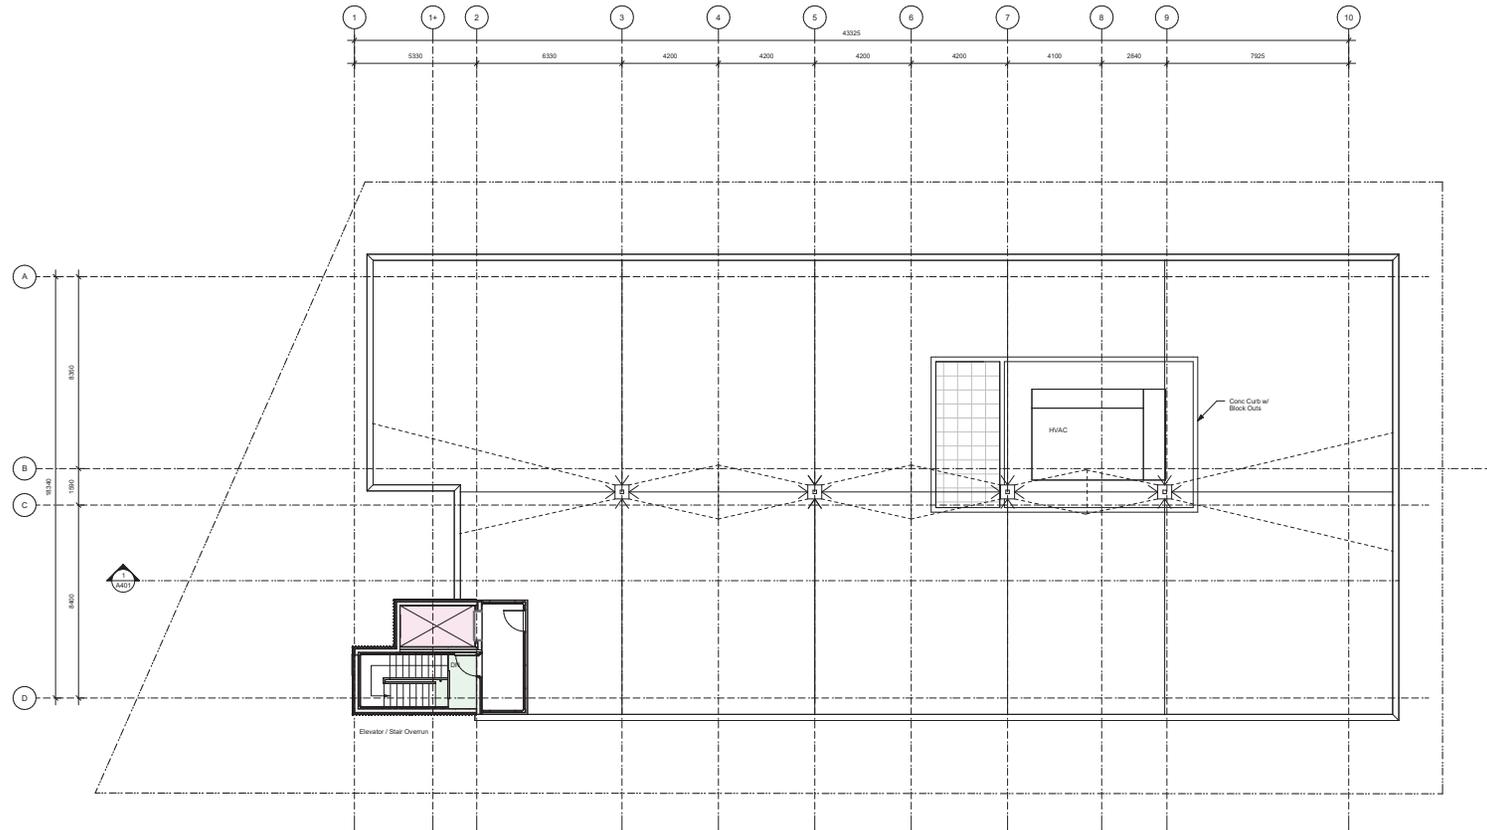

1 Roof Drainage
A208b SCALE: 1 : 100

Rev	3	23-06-15	Description	DP / Re-zoning Rev. 1
Plot Date	06/19/23	Project Date	DP / Re-zoning	
Drawn By	BWS	Checked By	CRK	
Scale	1 : 100	Project Number	2304	

NOTE: All dimensions are shown in millimeters.

Alston
1055 Alston St, Victoria, BC
V9A 3S6
Roof Drainage



dHKA Architects
Victoria
977 Fort Street
Nanaimo
102-5190 Dublin Way V8T 0H2 T 1-250-585-5810
V8V 3K3 T 1-250-658-3367
BC PROFESSIONAL REGULATORY BOARD FOR ARCHITECTS AND ARCHITECTS-IN-TRAINING
NOT BE REPRODUCED WITHOUT WRITTEN CONSENT

Materials Legend

- 1 Pre-finished Aluminum Flashing - Grey
- 2 Panelset - Metal Composite Panel - Grey
- 3 Guardrail - Tempered Glass w/ Aluminum Rails - Black
- 4 Corrugated Metal Panel - Vertical Orientation - Grey and Black
- 5 Corrugated Metal Panel - Horizontal Orientation - Grey and Black
- 6 Bakery / Patis Sliding Door - Black
- 7 Vinyl Frame Window - Black
- 8 Planter - (see landscaping)
- 9 1070mm Guard - Concrete
- 10 Perakade Wall - Architectural Concrete
- 11 Perforated Metal Screen
- 12 Retaining Wall - Concrete
- 13 Metal Composite Panel - Grey and Red
- 14 Metal Door - Black
- 15 Anodized Aluminum Storefront - Glazing w/ Doors - Black
- 16 Overhead Door - Black
- 17 Canopy Structural Column (see structural) - Black
- 18 Lobby Canopy / Roof - Metal Composite Panel - Grey
- 19 Eyebrow Roof - Metal Composite Panel - Red
- 20 Architectural Concrete
- 21 RWL Guard
- 22 Signage

Note: see A103 for grades

Rev	5	23-10-26	Description	DP / Re-zoning Rev. 3
	4	23-07-25		DP / Re-zoning Rev. 2
	3	23-06-15		DP / Re-zoning Rev. 1
	2	23-03-30		DP / Re-zoning
	1	23-03-25		CALCUL
Rev	5	23-10-26	Description	DP / Re-zoning Rev. 3
Prep Date	06/19/23	Project Date		DP / Re-zoning
Drawn By	BWS	Checked By	CRK	
Scale	As Indicated	Project Number	2304	

Alston
 1055 Alston St, Victoria, BC
 V9A 3S6
Building Elevation



dHKA **A301**

dHKA Architects
 Victoria 977 Fort Street
 Nanaimo 811-11th Street
 102-5180 Dublin Way V8T 0H2 T 1-250-585-5810

©2023 dHKA ARCHITECTS. ALL RIGHTS RESERVED. THIS DOCUMENT AND ALL OTHER DOCUMENTS ARE THE PROPERTY OF dHKA ARCHITECTS. NO PART OF THIS DOCUMENT MAY BE REPRODUCED WITHOUT WRITTEN CONSENT.



1 Elevation - North
 A301 SCALE: 1:100

Material Board

Material #	Material	Colour	
4	716' Corrugated Metal Panel	<div style="display: flex; justify-content: space-around;"> <div style="text-align: center;"> <p>Ebony #822 (R=26, G=26, B=26)</p> </div> <div style="text-align: center;"> <p>Light Pewter #2897 (R=100, G=100, B=100)</p> </div> </div>	<div style="display: flex; justify-content: space-around;"> <div style="text-align: center;"> <p>1 Aluminum Flashing</p> </div> <div style="text-align: center;"> <p>20 Architectural Concrete</p> </div> </div>
2	Metal Composite Panel	<div style="display: flex; justify-content: space-around;"> <div style="text-align: center;"> <p>Nash Red</p> </div> <div style="text-align: center;"> <p>Nash Grey</p> </div> </div>	
13		<div style="text-align: center;"> <p>Dark Red</p> </div>	
18		<div style="text-align: center;"> <p>Dark Grey</p> </div>	
19		<div style="text-align: center;"> <p>Brushed Carbon</p> </div>	



- Materials Legend**
- 1 Pre-finished Aluminum Flashing - Grey
 - 2 Panel - Metal Composite Panel - Grey
 - 3 Guardrail - Tempered Glass w/ Aluminum Rails - Black
 - 4 Corrugated Metal Panel - Vertical Orientation - Grey and Black
 - 5 Corrugated Metal Panel - Horizontal Orientation - Grey and Black
 - 6 Bakery / Patis Sliding Door - Black
 - 7 Vinyl Frame Window - Black
 - 8 Planter - (see landscaping)
 - 9 1070mm Guard - Concrete
 - 10 Parkade Wall - Architectural Concrete
 - 11 Perforated Metal Screen
 - 12 Retaining Wall - Concrete
 - 13 Metal Composite Panel - Grey and Red
 - 14 Metal Door - Black
 - 15 Anodized Aluminum Storefront - Glazing w/ Doors - Black
 - 16 Overhead Door - Black
 - 17 Canopy Structural Column (see structural) - Black
 - 18 Lobby Canopy / Roof - Metal Composite Panel - Grey
 - 19 Eyebrow Roof - Metal Composite Panel - Red
 - 20 Architectural Concrete
 - 21 RWL Guard
 - 22 Signage
- Note: see A103 for grades

Rev.	Description	DP / Revising Rev.
5	23-10-26	DP / Revising Rev. 3
4	23-07-25	DP / Revising Rev. 2
3	23-06-15	DP / Revising Rev. 1
2	23-03-30	DP / Revising
1	23-03-25	CALCUL

Rev.	Date	Description	DP / Revising Rev.
5	23-10-26	Description	DP / Revising Rev. 3
	06/19/23	Project Name	DP / Revising
		Checked By	CRK
		Project Number	2304

NOTE: All dimensions are in millimeters.

1 Elevation - South
A302 SCALE: 1 : 100

Material Board

Material #	Material	Colour	Image
4	7'6" Corrugated Metal Panel	Ebony 982 (D1gal)	
5		Light Pewter 209 (D4gal)	
2	Metal Composite Panel	Neon Red	
13		Neon Grey	
16		Brushed Carbon	
19			
1	Aluminum Flashing		
20	Architectural Concrete		


Alston
1055 Alston St, Victoria, BC
V9A 3S6
Building Elevation



dHKA Architects
Victoria
777 Fort Street
Nanaimo
102-5180 Dublin Way VST 0H2 T 1-250-585-5810
V8V 3K3 T 1-250-658-3367



1 Elevation - East
A303 SCALE: 1: 100

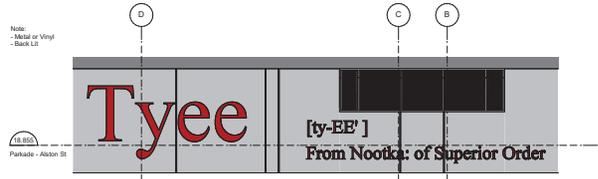

2 Signage - Tyee Street
A303 SCALE: 1: 75

Material Board

Material #	Material	Colour	Image
4	78" Corrugated Metal Panel	Ebony #02 (20ga)	
5		Light Pewter #07 (20ga)	
2	Metal Composite Panel	Neon Red	
13		Neon Grey	
18		Black	
19		Brushed Copper	
1	Aluminum Flashing		
20	Architectural Concrete		

Materials Legend

- 1 Pre-finished Aluminum Flashing - Grey
- 2 Panel - Metal Composite Panel - Grey
- 3 Gridrail - Tempered Glass w/ Aluminum Rails - Black
- 4 Corrugated Metal Panel - Vertical Orientation - Grey and Black
- 5 Corrugated Metal Panel - Horizontal Orientation - Grey and Black
- 6 Bakery / Patis Sliding Door - Black
- 7 Vinyl Frame Window - Black
- 8 Planter - (see landscaping)
- 9 1070mm Guard - Concrete
- 10 Parkade Wall - Architectural Concrete
- 11 Perforated Metal Screen
- 12 Retaining Wall - Concrete
- 13 Metal Composite Panel - Grey and Red
- 14 Metal Door - Black
- 15 Anodized Aluminum Storefront - Glazing w/ Doors - Black
- 16 Overhead Door - Black
- 17 Canopy Structural Column (see structural) - Black
- 18 Lobby Canopy / Roof - Metal Composite Panel - Grey
- 19 Eyebrow Roof - Metal Composite Panel - Red
- 20 Architectural Concrete
- 21 RWL Guard
- 22 Signage

Note: see A103 for grades

Rev	Description	DP / Reasoning
5	23-10-26	DP / Reasoning Rev. 3
4	23-07-25	DP / Reasoning Rev. 2
3	23-06-15	DP / Reasoning Rev. 1
2	23-03-30	DP / Reasoning
1	23-03-25	CALUC


Alston
1055 Alston St, Victoria, BC
V9A 3S6
Building Elevation



dHka Architects
Victoria 977 Fort Street V8V 3K3 T 1-250-668-3367
Nanaimo 102-5180 Dublin Way VST 0H2 T 1-250-585-5810
BCP PROJECT REVIEWED BY: JAMES WILSON AND TESSA WILSON AND AT ALL TIMES REMAIN THE PROPERTY OF dHka ARCHITECTS LTD. NO PART OF THIS DOCUMENT IS TO BE REPRODUCED WITHOUT THE WRITTEN CONSENT OF dHka ARCHITECTS LTD.



1 Elevation - West
A304 SCALE: 1 : 100

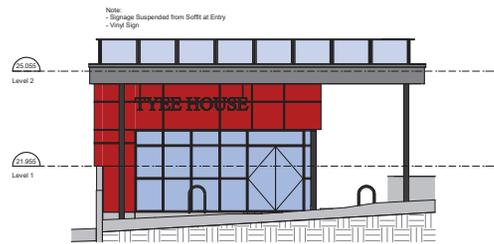

2 Signage - Alston Street
A304 SCALE: 1 : 75

Material Board

Material #	Material	Colour	
4	7/8" Corrugated Metal Panel	<div style="display: flex; justify-content: space-around;"> <div style="text-align: center;"> <p>● Ebony 9823 (25gall)</p> </div> <div style="text-align: center;"> <p>● Light Pewter 2997 (24gall)</p> </div> </div>	<div style="display: flex; justify-content: space-around;"> <div style="text-align: center;"> <p>● 1 Aluminum Flashing</p> </div> <div style="text-align: center;"> <p>● 20 Architectural Concrete</p> </div> </div>
2	Metal Composite Panel	<div style="display: flex; justify-content: space-around;"> <div style="text-align: center;"> <p>● Neon Red</p> </div> <div style="text-align: center;"> <p>● Neutr Grey</p> </div> </div>	
13		<div style="text-align: center;"> <p>● Brushed Carbon</p> </div>	
18			
19			

Materials Legend

- 1 Pre-finished Aluminum Flashing - Grey
- 2 Panelset - Metal Composite Panel - Grey
- 3 Guardrail - Tempered Glass w/ Aluminum Rails - Black
- 4 Corrugated Metal Panel - Vertical Orientation - Grey and Black
- 5 Corrugated Metal Panel - Horizontal Orientation - Grey and Black
- 6 Bakery / Patis Sliding Door - Black
- 7 Vinyl Frame Window - Black
- 8 Planter - (see landscaping)
- 9 1070mm Guard - Concrete
- 10 Parkade Wall - Architectural Concrete
- 11 Perforated Metal Screen
- 12 Retaining Wall - Concrete
- 13 Metal Composite Panel - Grey and Red
- 14 Metal Door - Black
- 15 Anodized Aluminum Storefront - Glazing w/ Doors - Black
- 16 Overhead Door - Black
- 17 Canopy Structural Column (see structural) - Black
- 18 Lobby Canopy / Roof - Metal Composite Panel - Grey
- 19 Eyebrow Roof - Metal Composite Panel - Red
- 20 Architectural Concrete
- 21 RWL Guard
- 22 Signage


Note: see A103 for grades

Rev	Description	DP / Revising Rev.
4	23-07-25	DP / Revising Rev. 2
3	23-06-15	DP / Revising Rev. 1
2	23-03-30	DP / Revising
1	23-03-25	CALUC

Alston
1055 Alston St, Victoria, BC
V9A 3S6
Building Elevation



dHk Architects
Victoria
777 Fort Street
Nanaimo
102-5190 Dublin Way V8T 0H2 T 1-250-668-3367
1-250-668-5810
dHk ARCHITECTS INC. IS AN EQUAL OPPORTUNITY EMPLOYER AND IS AN AFFIRMATIVE ACTION EMPLOYER. WE DO NOT DISCRIMINATE ON THE BASIS OF RACE, ETHNICITY, GENDER, RELIGION, AGE, SEX, OR NATIONAL ORIGIN.

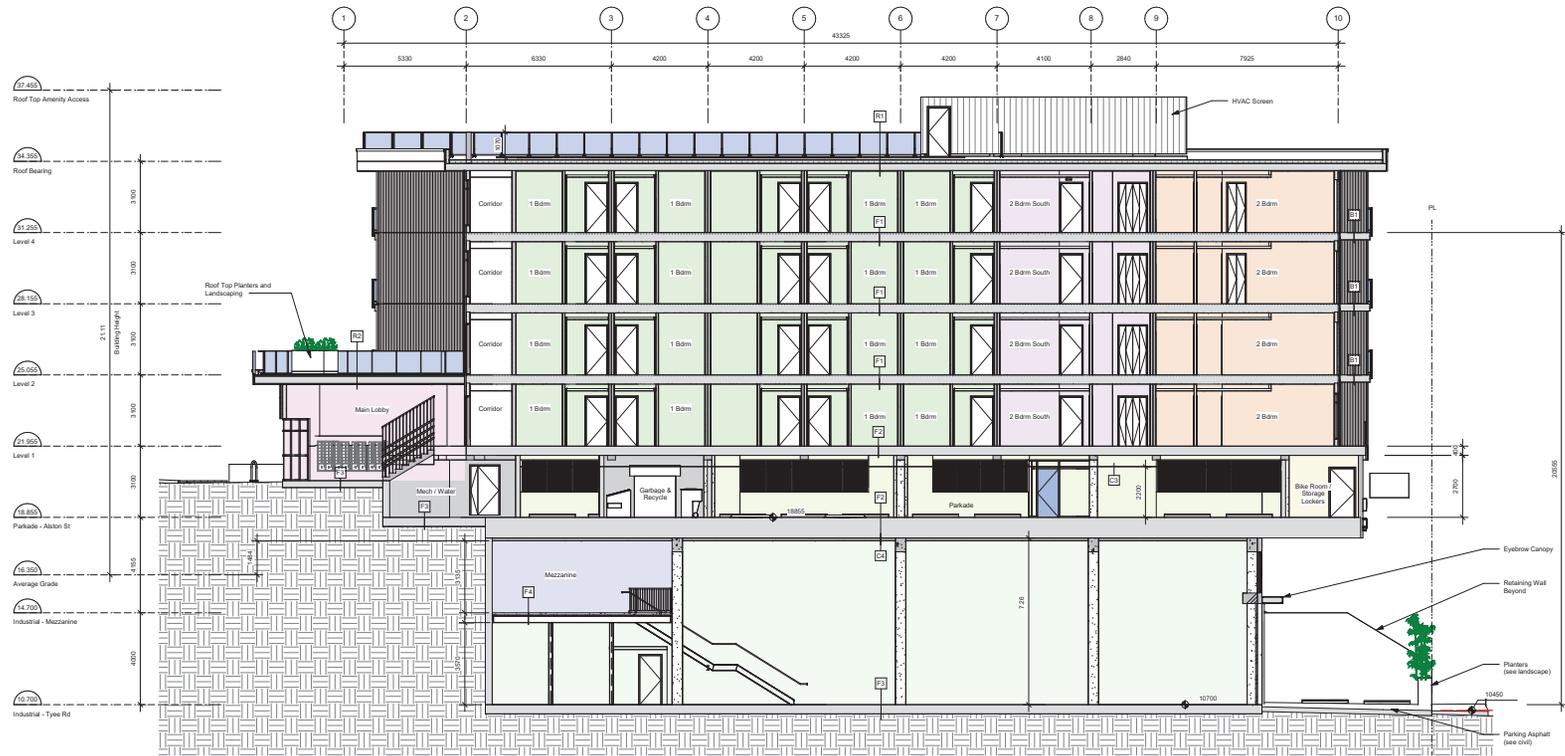

Fire Separation Legend

--- (Yellow dashed line)	0.0 HR
--- (Green dashed line)	0.75 HR
--- (Blue dashed line)	1.0 HR
--- (Red dashed line)	2.0 HR

Rev	5	23-10-26	Description	DP / Re zoning Rev. 3
	4	23-07-25		DP / Re zoning Rev. 2
	3	23-05-15		DP / Re zoning Rev. 1
Rev	5	23-10-26	Description	DP / Re zoning Rev. 3
Pre Date	06/1923	Project Date		DP / Re zoning
Drawn By	BWS	Checked By	CRK	
Scale	As Indicated	Project Number	2304	

NOTE: All dimensions are shown in millimeters.

1 Building Section - Looking North - Lobby
A401 SCALE: 1 : 100

Alston

1055 Alston St, Victoria, BC
V9A 3S6

Building Section - Looking North


dHka A40

dHka Architects
Victoria
977 Fort Street
Nanaimo
102-5190 Dublin Way VST 0H2 T 1-250-585-5810


VBV 3K3 T 1-250-658-3367

©2023 dHka Architects. All rights reserved. This drawing and its contents are the property of dHka Architects and shall remain confidential. No part of this drawing may be reproduced without written consent.

2024-06-01 14:04:05 PM

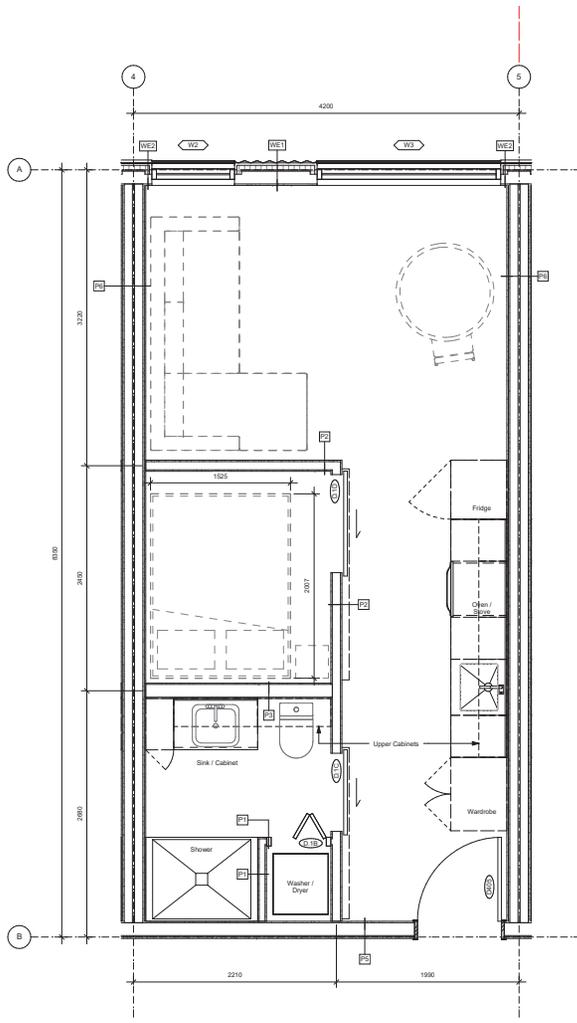

1 One Bedroom
A901 SCALE: 1 : 25

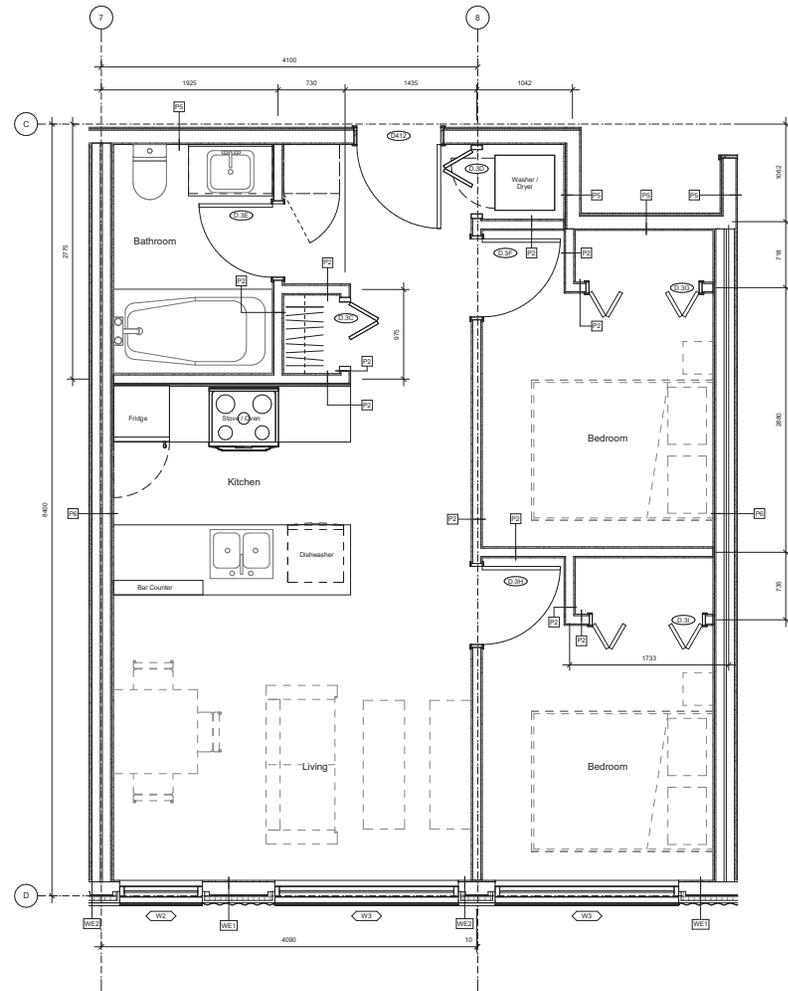

2 Two Bedroom South
A902 SCALE: 1 : 25

Ceiling Legend

- Extent of Drop Ceiling / Bulk Head - 2400 AFF
- Extent of Underside of Floor Slab - 2700 AFF
- Extent of Acoustic Ceiling Tile - 2400 AFF
- Extent of Exposed Beamed Concrete
- Extent of Metal Panel Soffit - Breaks @ 1200mm - Breaks @ Soffit to Match Breaks @ Perimeter

Rev	2	23-03-30	DP / Re-zoning
Rev	2	23-03-30	Description DP / Re-zoning
Plot Date	06/19/23	Project Date	DP / Re-zoning
Drawn By	BWS	Checked By	CRK
Scale	As Indicated	Project Number	2304


NOTE: All dimensions are shown in millimeters.

Alston
1055 Alston St, Victoria, BC
V9A 3S6
Unit Plan - One
Bedroom



dHka Architects
Victoria
977 Fort Street
Nanaimo
102-5190 Dublin Way V8T 0H2 T 1-250-585-5810

©2023 dHka Architects. All rights reserved. This document and its contents are the property of dHka Architects. No part of this document may be reproduced without written consent.

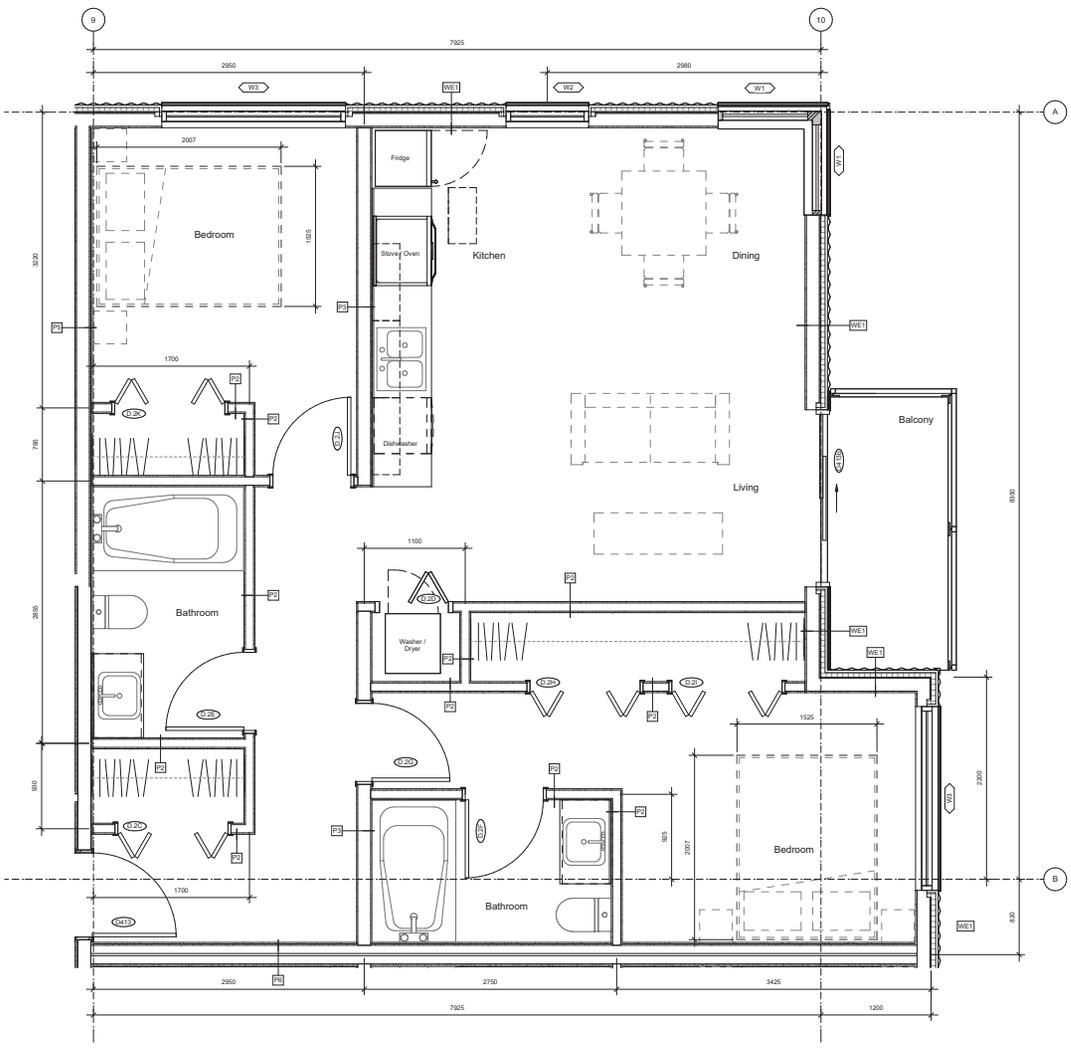

1 Two Bedroom
A902 SCALE: 1 : 25

Ceiling Legend

- Extent of Drop Ceiling / Bulk Head - 2400 AFF
- Extent of Underside of Floor Slab - 2700 AFF
- Extent of Acoustic Ceiling Tile - 2400 AFF
- Extent of Exposed Beamed Concrete
- Extent of Metal Panel Soffit - Breaks @ 1200mm
- Breaks @ Soffit to Match Breaks @ Perimeter

Rev	2	23-03-30	DP / Re-zoning
Rev	2	23-03-30	Description DP / Re-zoning
Plot Date	06/19/23	Project Date	DP / Re-zoning
Drawn By	BWS	Checked By	CRK
Scale	As Indicated	Project Number	2304

NOTE: All dimensions are shown in millimeters.

Alston
1055 Alston St, Victoria, BC
V9A 3S6
Unit Plan - Two
Bedroom

dHKA **A902**

dHKA Architects
Victoria
777 Fort Street
Nanaimo
102-5190 Dublin Way V8T 0H2 T 1-250-668-3367

REGISTERED ARCHITECT
2314-84135
COLUMBIA

CONSTRUCTION DOCUMENTS
DATE: 06/19/23
PROJECT: 2304
SHEET: A902
SCALE: 1:25
NOT TO BE REPRODUCED WITHOUT WRITTEN CONSENT