## ATTACHMENT B





## **Contacts + Drawing List**

## Owner

One Pointe Property Team
c/o Mike Geric Construction
4520 West Saanich Road
Saanich, BC V8Z 3G4
Niall Paltiel, niall@gericconstruction.com

Architect
D'Ambrosio architecture + urba

D'Ambrosio architecture + urbanism 2960 Jutland Road Victoria, BC V8T 5K2 250.384.2400 x 103 Erica Sangster - esangster@daustudio.ca

Landscape Architect

Murdoch de Greeff Inc. 200 - 524 Culduthel Road Victoria, BC V8Z 1G1 250.412.2891 Scott Murdoch - scott@mdidesign.ca Architectural

A0.0 Cover
A0.1 Context Views
A0.2 Context Views
A0.3 Context Views
A0.4 Height & Massing Analysis

A0.6 Context Elevations
A0.7 Skyline Analysis
A0.8 Sun and Shade Study
A1.0 Existing Site Survey
A1.1 Site Plan
A1.2 Average Grade Calculations

A1.3 Level 1 Phasing Plan
A1.4 P1 Phasing Plan
A2.0 P2 Parking Plan
A2.1 P1 Parking Plan
A2.2 Level 1 Plan
A2.3 Level 2 Plan

A2.4 Level 3 Plan A2.5 Level 4 Plan

A3.3 West Elevation

A4.0 Building Sections
A4.1 Building Sections

A2.6 Level 5-13 Plan
A2.7 Penthouse + Roof Plan
A3.0 North Elevation
A3.1 East Elevation
A3.2 South Elevation

A4.2 Building Section / Elevations

Landscape

L0.00 Cover
L0.01 General Information Sheet
L0.02 Tree Survey Plan
L0.03 Tree Management Plan
L1.01 Landscape Materials - Grou

L1.01 Landscape Materials - Ground
L1.02 Landscape Materials - Roof
L1.03 Stormwater Management & Grading
L1.04 Landscape Precedents
L1.05 Landscape Materials - Sections

L1.05 Landscape Materials - Sections
L1.06 Landscape Materials - Sections
L1.07 Soil Volumes
L3.01 Planting Plan
L3.02 Planting Plan

L4.01 Landscape Details

Civil

C1.0 Conceptual Site DemolitionC2.0 Conceptual Site Servicing PlantC3.0 Conceptual Site Surface Works


Electrical

E100 Off-site Lighting Design & Details
E101 Off-site Lighting Design & Details



2960 Jutland Road Victoria BC Canada V8T5K2

tel 250.384.2400 eml mail@daustudio.ca web www.daustudio.ca

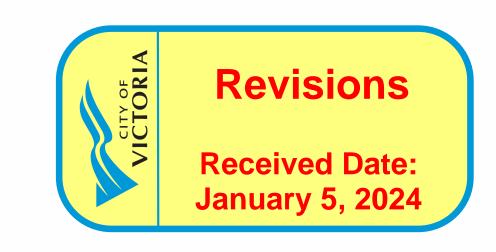

#21-18
Montreal and Quebec
205 Quebec Street
Victoria, BC

## Rezoning/DP Resubmission

23.12.22

## **Civil Consultant**


WSP 301 - 3600 Uptown Blvd. Victoria, BC V8Z 0B9 250.389.8068 Jeff Sumerville - Jeff.Somerville @wsp.com


## **Electrical Consultant**

AES Engineering 500 - 3795 Carey Road, Victoria, BC V8Z 6T8 778-746-2003 Bal Klear - bal.klear@aesengr.com

## **Transportation Consultant**

Watt Consulting Group 302 - 740 Hillside Avenue Victoria, BC V8T 1Z4 250.388.9877 x 423 Nadine King - nking @wattconsultinggroup.com

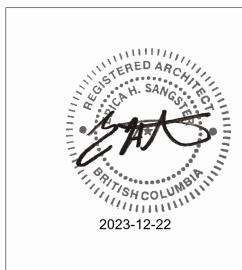

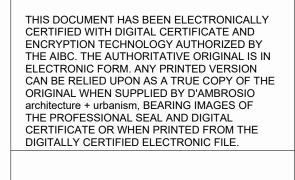






1 Rendered Context View NTS

2 Rendered Context View NTS

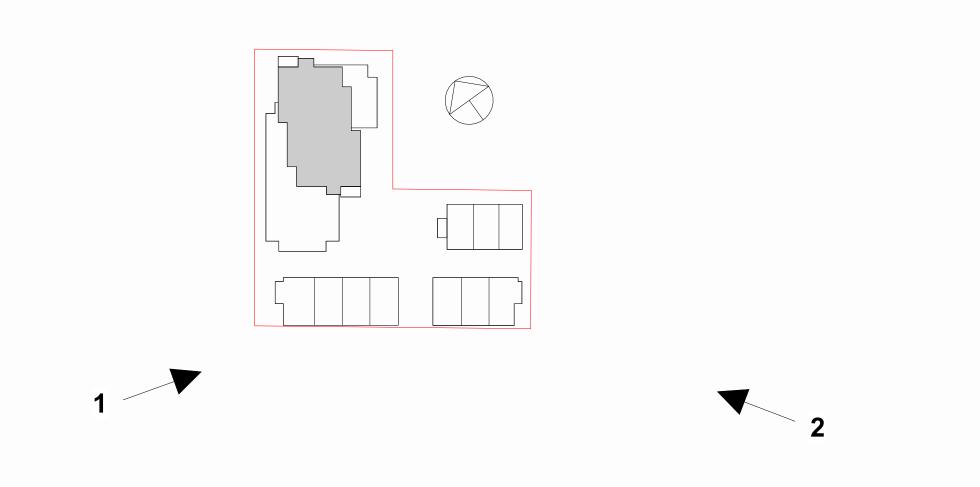

6	Rezoning/DP Resubmission	
5	Rezoning/DP Resubmission	22.12.0
4	loound for ADD	22 00 0

6 Rezoning/DP Resubmission 23.12.22
5 Rezoning/DP Resubmission 22.12.06
4 Issued for ADP 22.08.02
2 Issued for Rezoning / DP 21.12.15
1 Issued for Dev. Tracker 21.10.19
rev no description date
copyright reserved, these drawings and designs are and at all times remain the property of d'ambrosio architecture to be used for the project shown and may not be reproduced without written consent.

project name

Montreal and Quebec
205 Quebec Street
Victoria, BC


## sheet title Context Views

project no.	#21-18	AM
scale	As indicated	10:33:45 AM
drawn by	CF	10:3
date issued	sheet no.	2-22
12/06/22	A0.1	2023-12-22





2 Montreal Entry Render
NTS

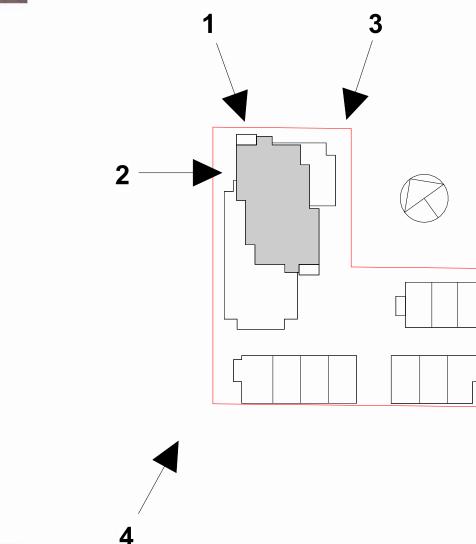






4 Rendered Context View
1:1



1 Rendered Context View NTS

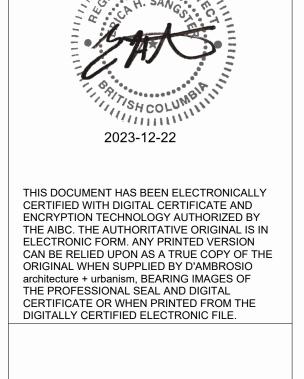

D'AMBROSIO architecture + urbanism

Rezoning/DP Resubmission 23.12.22
Rezoning/DP Resubmission 22.12.06
Issued for ADP 22.08.02
Issued for Rezoning / DP 21.12.15
Issued for Dev. Tracker 21.10.19

5 Rezoning/DP Resubmission 22.12.06
4 Issued for ADP 22.08.02
2 Issued for Rezoning / DP 21.12.15
1 Issued for Dev. Tracker 21.10.19
rev no description date
copyright reserved. these drawings and designs are and at all times remain the property of d'ambrosio architecture to be used for the project shown and may not be reproduced without written consent.


project name

Montreal and Quebec
205 Quebec Street
Victoria, BC

sheet title
Context Views

project no.	#21-18	10-33-47 AM
scale	As indicated	3.47
drawn by	CF	10.5
date issued	sheet no.	2-22
12/06/22	A0.2	123-12-22



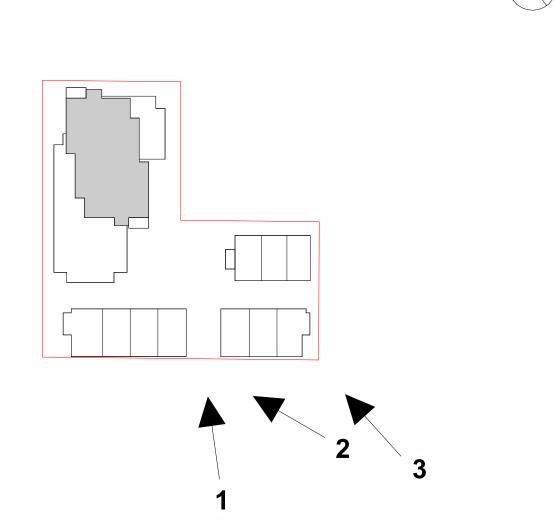

1 Redered Context View NTS







THIS DOCUMENT HAS BEEN ELECTRONICALLY CERTIFIED WITH DIGITAL CERTIFICATE AND ENCRYPTION TECHNOLOGY AUTHORIZED BY THE AIBC. THE AUTHORITATIVE ORIGINAL IS IN ELECTRONIC FORM. ANY PRINTED VERSION CAN BE RELIED UPON AS A TRUE COPY OF THE ORIGINAL WHEN SUPPLIED BY D'AMBROSIO architecture + urbanism, BEARING IMAGES OF THE PROFESSIONAL SEAL AND DIGITAL CERTIFICATE OR WHEN PRINTED FROM THE DIGITALLY CERTIFIED ELECTRONIC FILE.


6 Rezoning/DP Resubmission 23.12.22
5 Rezoning/DP Resubmission 22.12.06
4 Issued for ADP 22.08.02
rev no description date
copyright reserved. these drawings and designs are and at all times remain the property of d'ambrosio architecture to be used for the project shown and may not be reproduced without written consent.

project name

Montreal and Quebec
205 Quebec Street
Victoria, BC


sheet title
Context Views

12/06/22	A0.3
date issued	sheet no.
drawn by	CF
scale	As indicated
project no.	#21-18

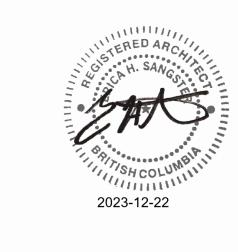





URBAN HEIGHT DIAGRAM: Taller building forms wrap around the Downtown Core Area and bracket the marine entrance to the Inner Harbour.

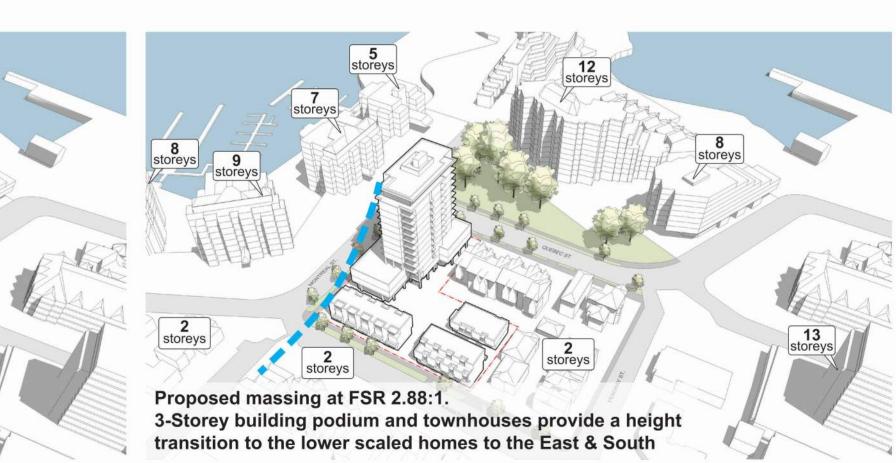

6–9 storeys

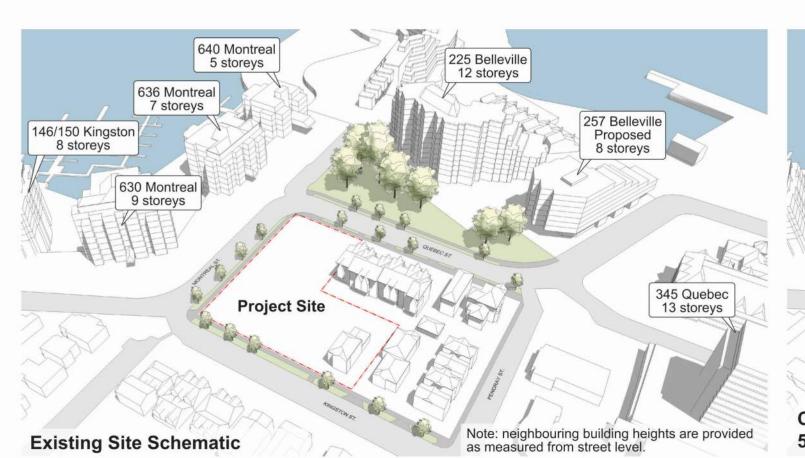

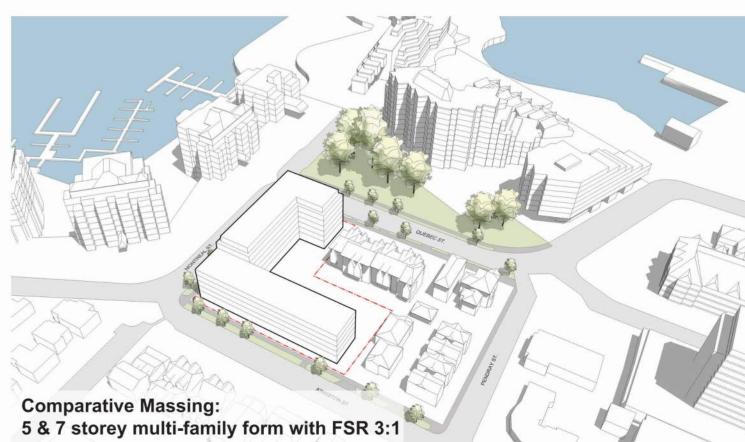






MASSING/HEIGHT RATIONALE


Rezoning/DP Resubmission 23.12.22
Rezoning/DP Resubmission 22.12.06
Issued for Rezoning / DP 21.12.15
no description date copyright reserved. these drawings and designs are and at all times remain the property of d'ambrosio architecture to be used for the project shown and may not be reproduced without written consent.

Montreal and Quebec 205 Quebec Street Victoria, BC

sheet title
Height & Massing
Analysis

project no.	#21-18	y AM
scale	NTS	33:56
drawn by	DZ	10:3
date issued	sheet no.	2-22
12/06/22	A0.4	2023-12-22 10:33:56 AM

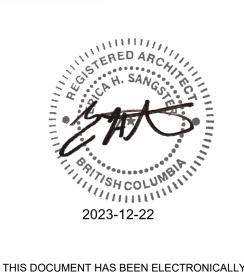

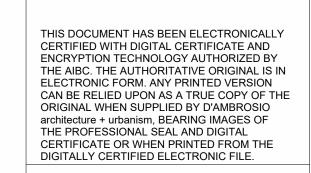





Section B - Kingston St. 1:300 146/150 KINGSTON ST. 630 MONTREAL ST.



Section C - Montreal St. 1:300

225 BELLEVILLE ST.

QUEBEC ST.

6 Rezoning/DP Resubmission 23.12.22
5 Rezoning/DP Resubmission 22.12.06
4 Issued for ADP 22.08.02

2 Issued for Rezoning / DP 21.12.15

Issued for Dev. Tracker 21.10.19

rev no description date


copyright reserved, these drawings and designs are and at all times remain the property of d'ambrosio architecture to be used for the project shown and may not be reproduced without written consent.

project name

Montreal and Quebec
205 Quebec Street
Victoria, BC

sheet title
Context Elevations


project no.	#21-18	<
scale	1:300	10.00.67
drawn by	CF	
date issued	sheet no.	0,000
12/06/22	A0.6	4,

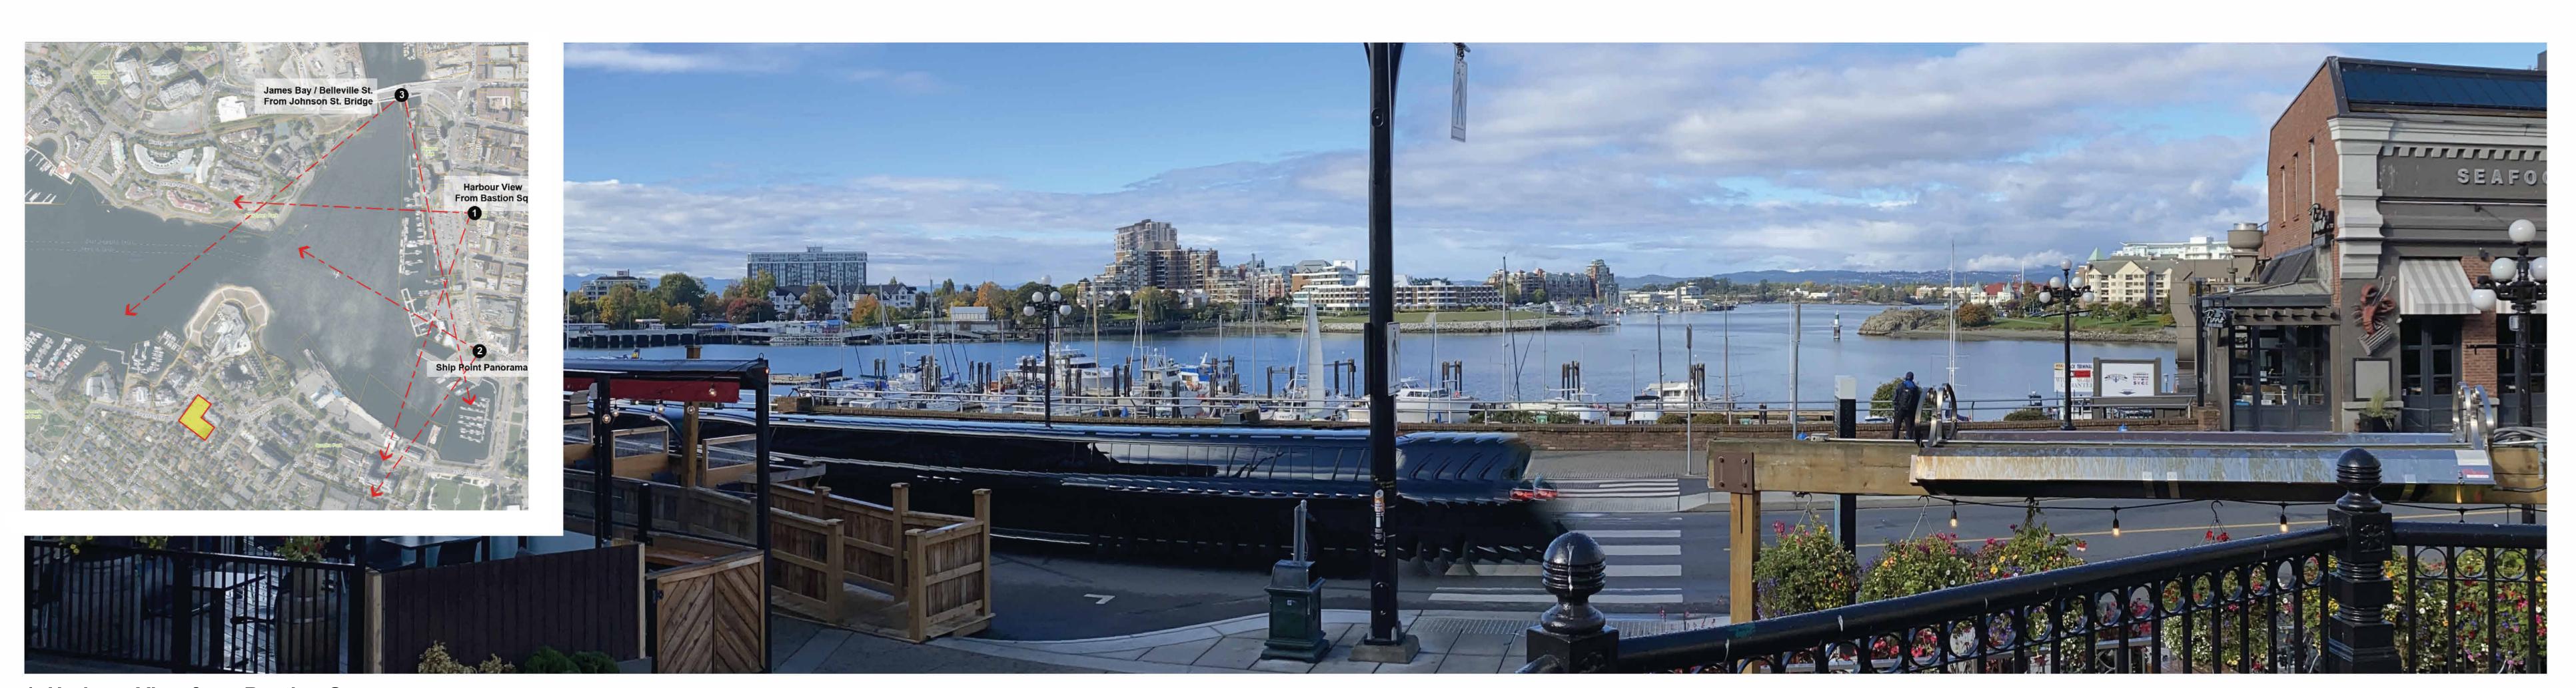

1. Harbour View from Bastion Square



2. Ship Point Panoroma

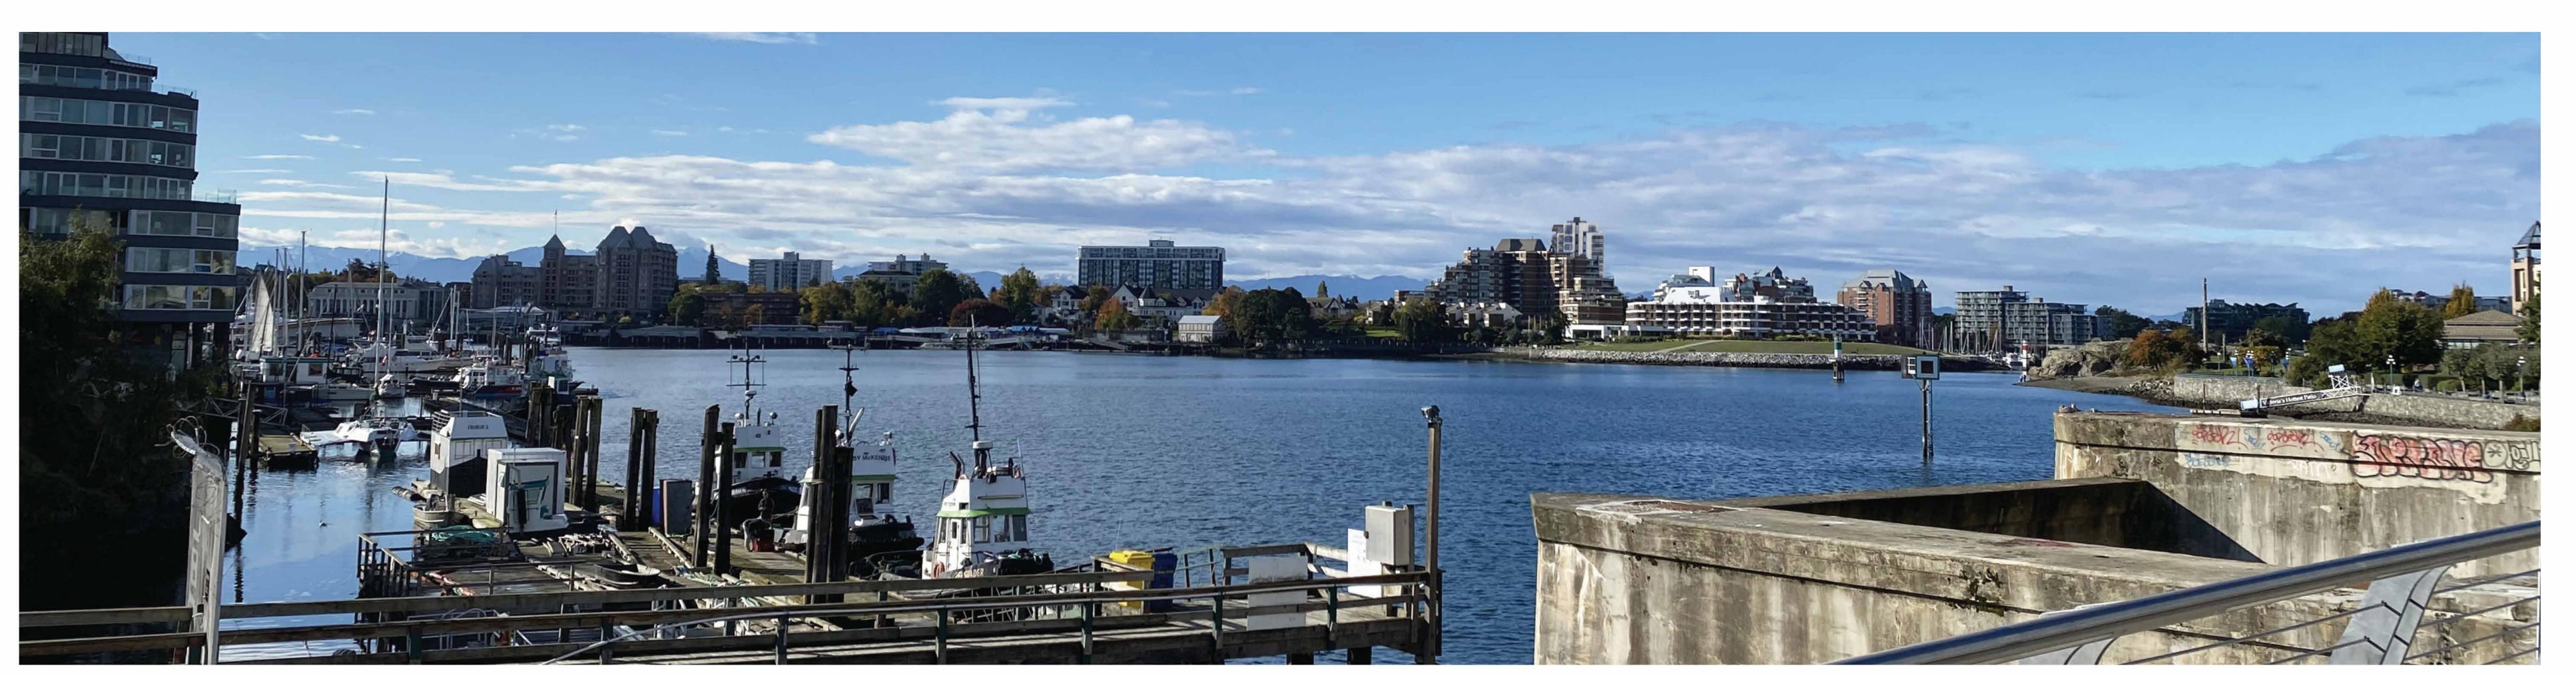

3. James Bay / Belleville Street from Johnson Street Bridge





	Rezoning/DP Resubmission	23.12
	Rezoning/DP Resubmission	22.12
	Issued for ADP	22.08
	Issued for Rezoning / DP	21.12
no	description	da
riaht	reserved, these drawings and designs a	re and at


project name

Montreal and Quebec
205 Quebec Street
Victoria, BC


sheet title
Skyline Analysis

project no.	#21-18	AM (
scale	NTS	33:56
drawn by	CF	10:3
date issued	sheet no.	2-22
12/06/22	A0.7	2023-12-22 10:33:59 AM


## Spring / Fall Equinox

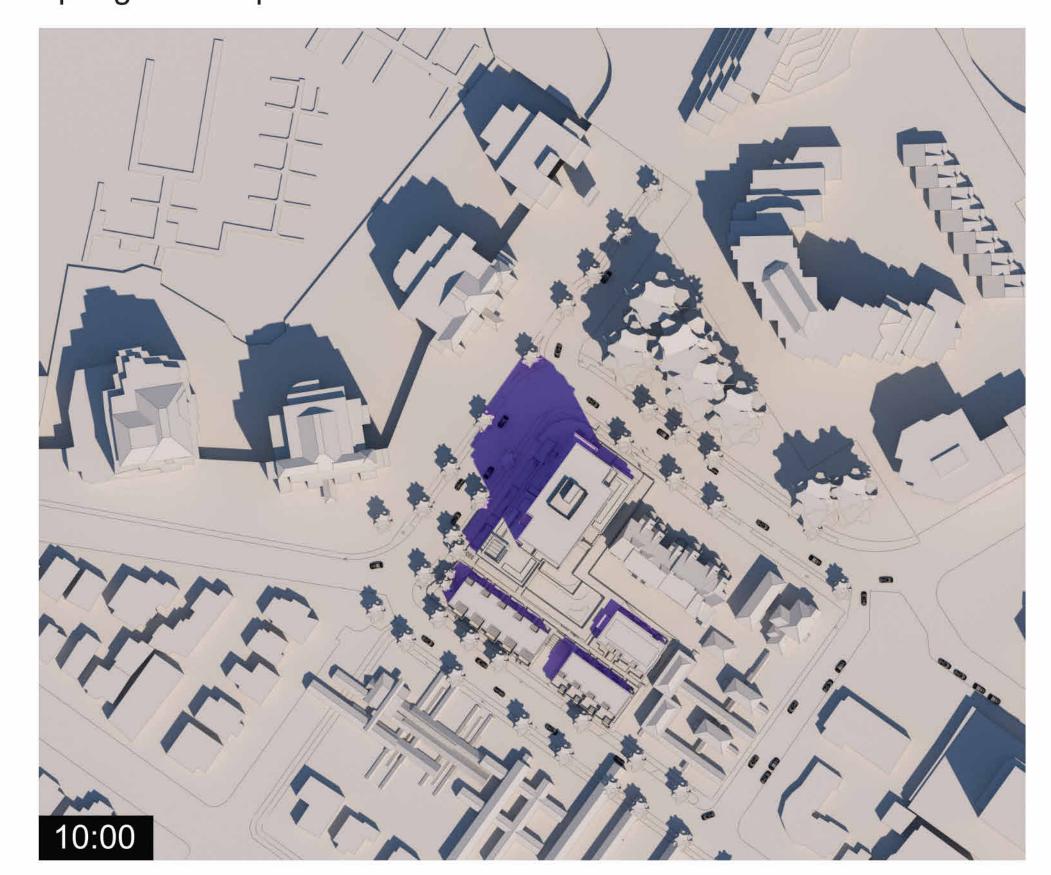




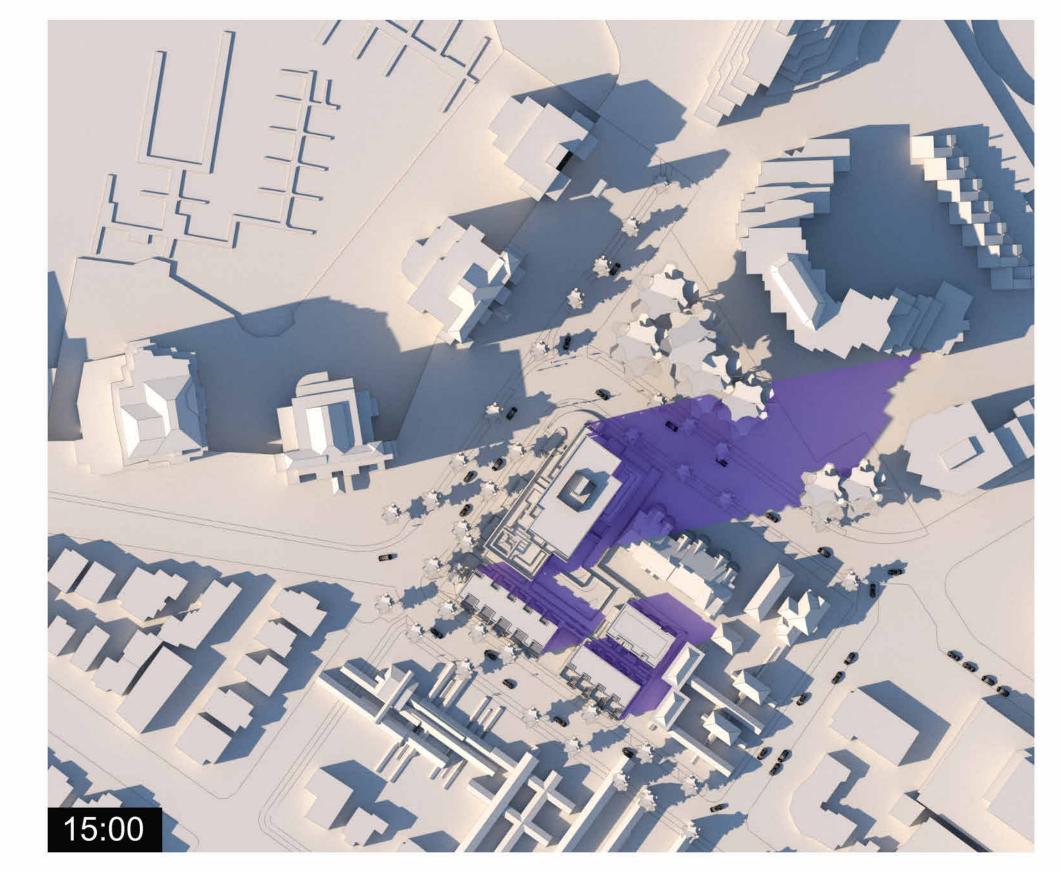


## Winter Solstice

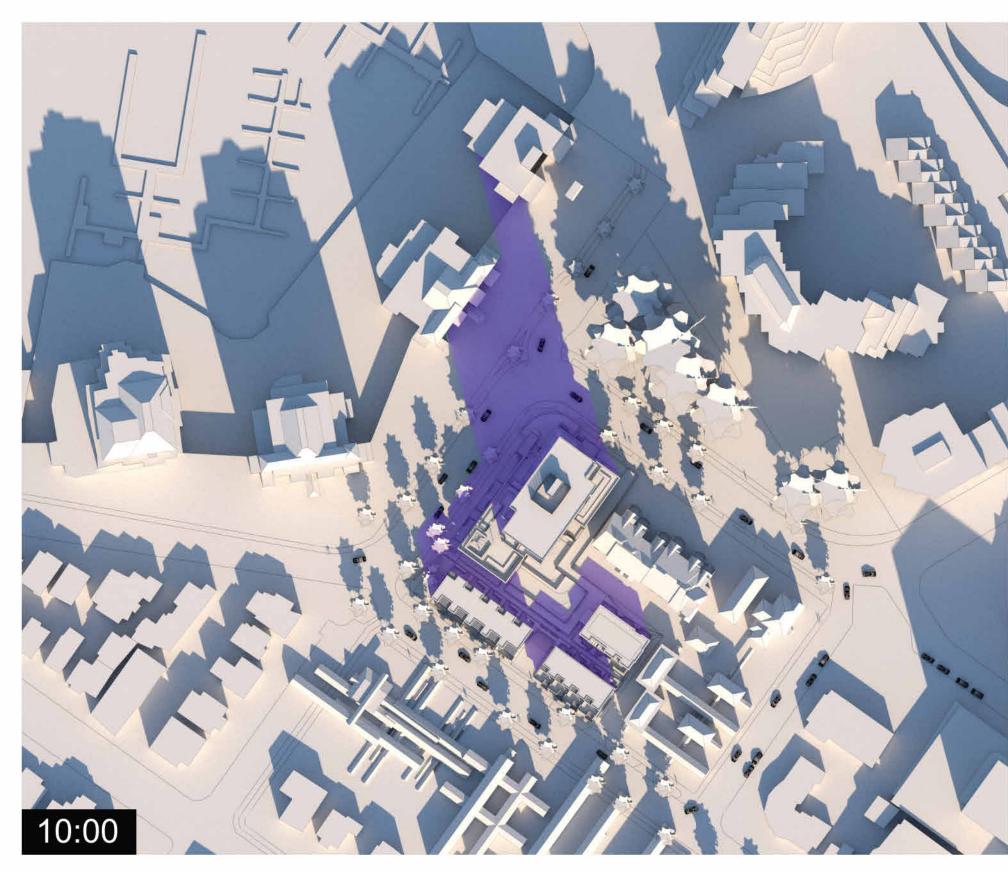

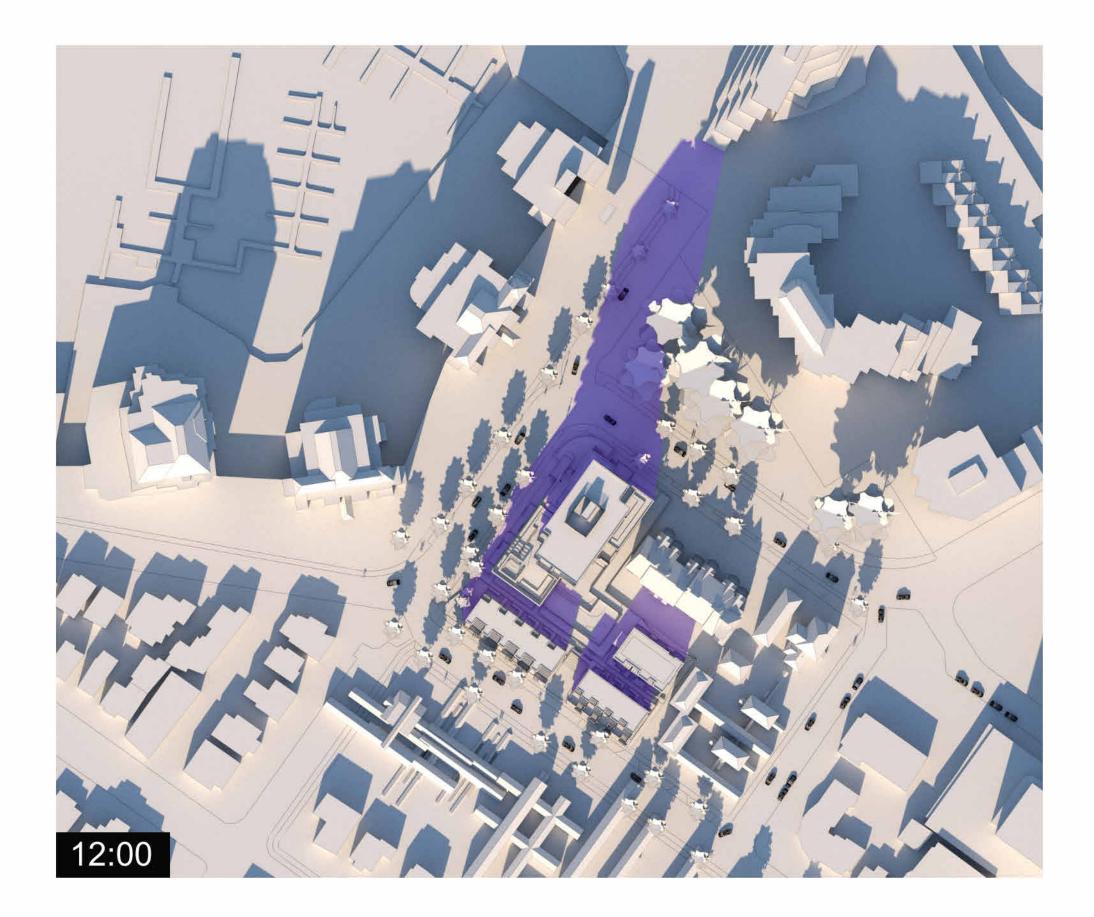





## Summer Solstice

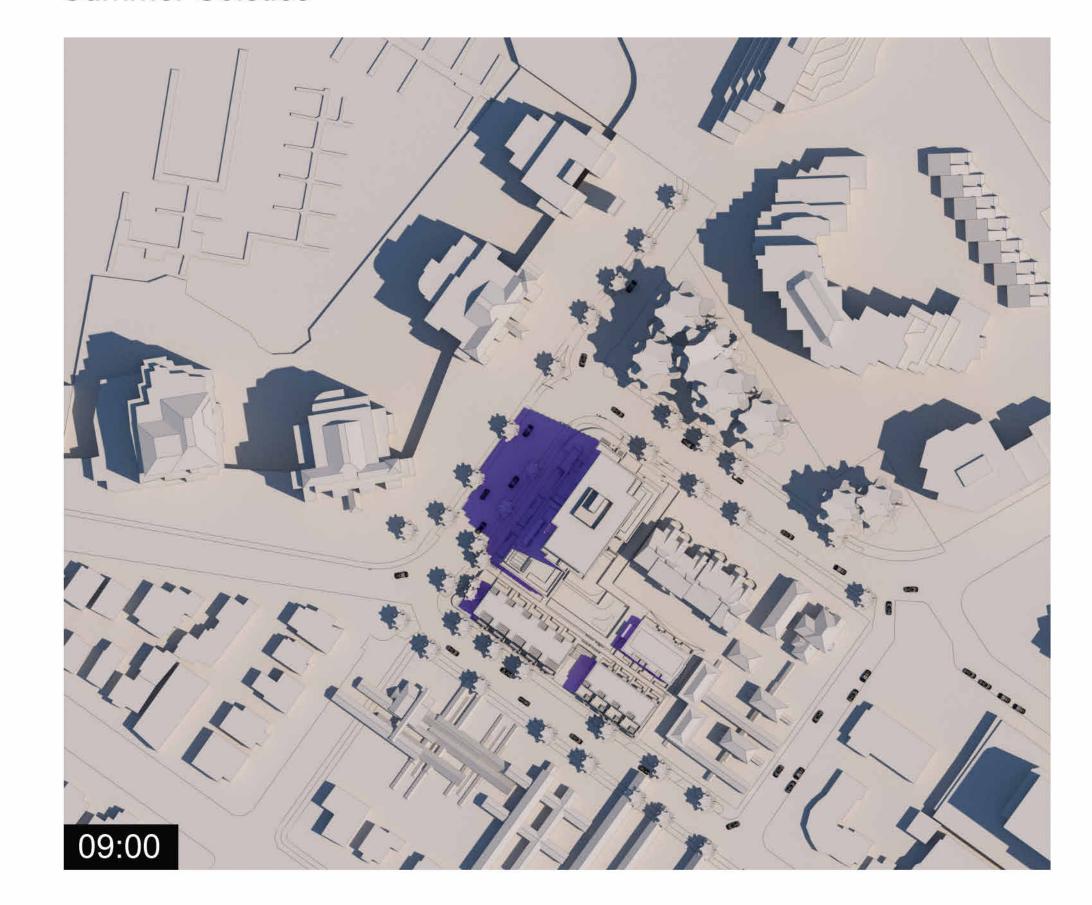



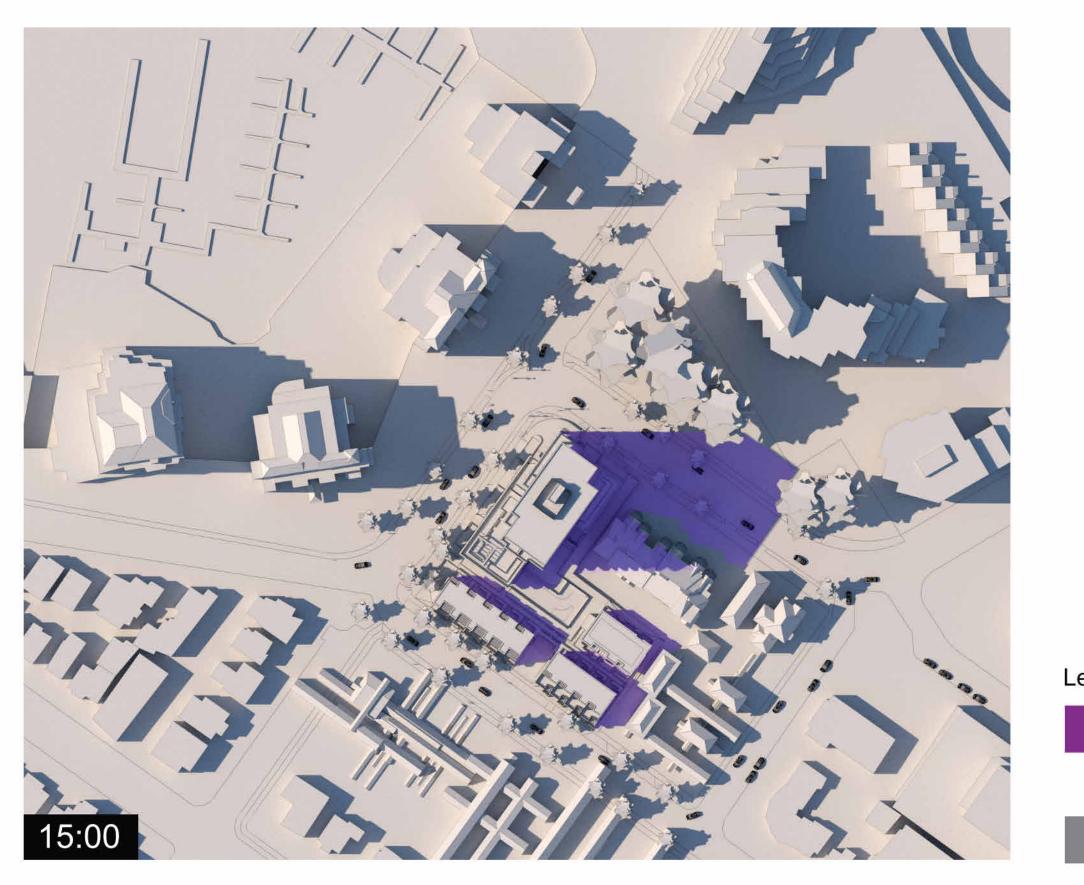

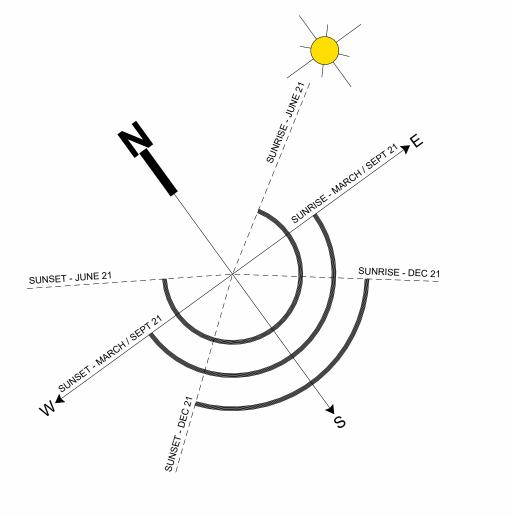

Legend
Shadows from Proposed Building

Shadows from Existing Buildings

Montreal and Quebec 205 Quebec Street Victoria, BC

sheet title Sun and Shade Study

project no. #21-18
scale
drawn by DZ, GK

6 Rezoning / DP Resubmission 23.12.22
5 Rezoning/DP Resubmission 22.12.06
2 Issued for Rezoning / DP 21.12.15

rev no description date

copyright reserved. these drawings and designs are and at all times remain the property of d'ambrosio architecture to be used for the project shown and may not be reproduced without written consent.

project name

date issued

THIS DOCUMENT HAS BEEN ELECTRONICALLY CERTIFIED WITH DIGITAL CERTIFICATE AND ENCRYPTION TECHNOLOGY AUTHORIZED BY THE AIBC. THE AUTHORITATIVE ORIGINAL IS IN ELECTRONIC FORM. ANY PRINTED VERSION CAN BE RELIED UPON AS A TRUE COPY OF THE ORIGINAL WHEN SUPPLIED BY D'AMBROSIO architecture + urbanism, BEARING IMAGES OF THE PROFESSIONAL SEAL AND DIGITAL CERTIFICATE OR WHEN PRINTED FROM THE DIGITALLY CERTIFIED ELECTRONIC FILE.

D'AMBROSIO architecture + urbanism



D'AMBROSIO architecture + urbanism

THIS DOCUMENT HAS BEEN ELECTRONICALLY CERTIFIED WITH DIGITAL CERTIFICATE AND ENCRYPTION TECHNOLOGY AUTHORIZED BY THE AIBC. THE AUTHORITATIVE ORIGINAL IS IN ELECTRONIC FORM. ANY PRINTED VERSION CAN BE RELIED UPON AS A TRUE COPY OF THE ORIGINAL WHEN SUPPLIED BY D'AMBROSIO architecture + urbanism, BEARING IMAGES OF THE PROFESSIONAL SEAL AND DIGITAL CERTIFICATE OR WHEN PRINTED FROM THE DIGITALLY CERTIFIED ELECTRONIC FILE.

6 Rezoning/DP Resubmission 23.12.22
5 Rezoning/DP Resubmission 22.12.06
2 Issued for Rezoning / DP 21.12.15


rev no description date

copyright reserved. these drawings and designs are and at all times remain the property of d'ambrosio architecture to be used for the project shown and may not be reproduced without written consent.


project name

Montreal and Quebec
205 Quebec Street
Victoria, BC

sheet title
Existing Site Survey

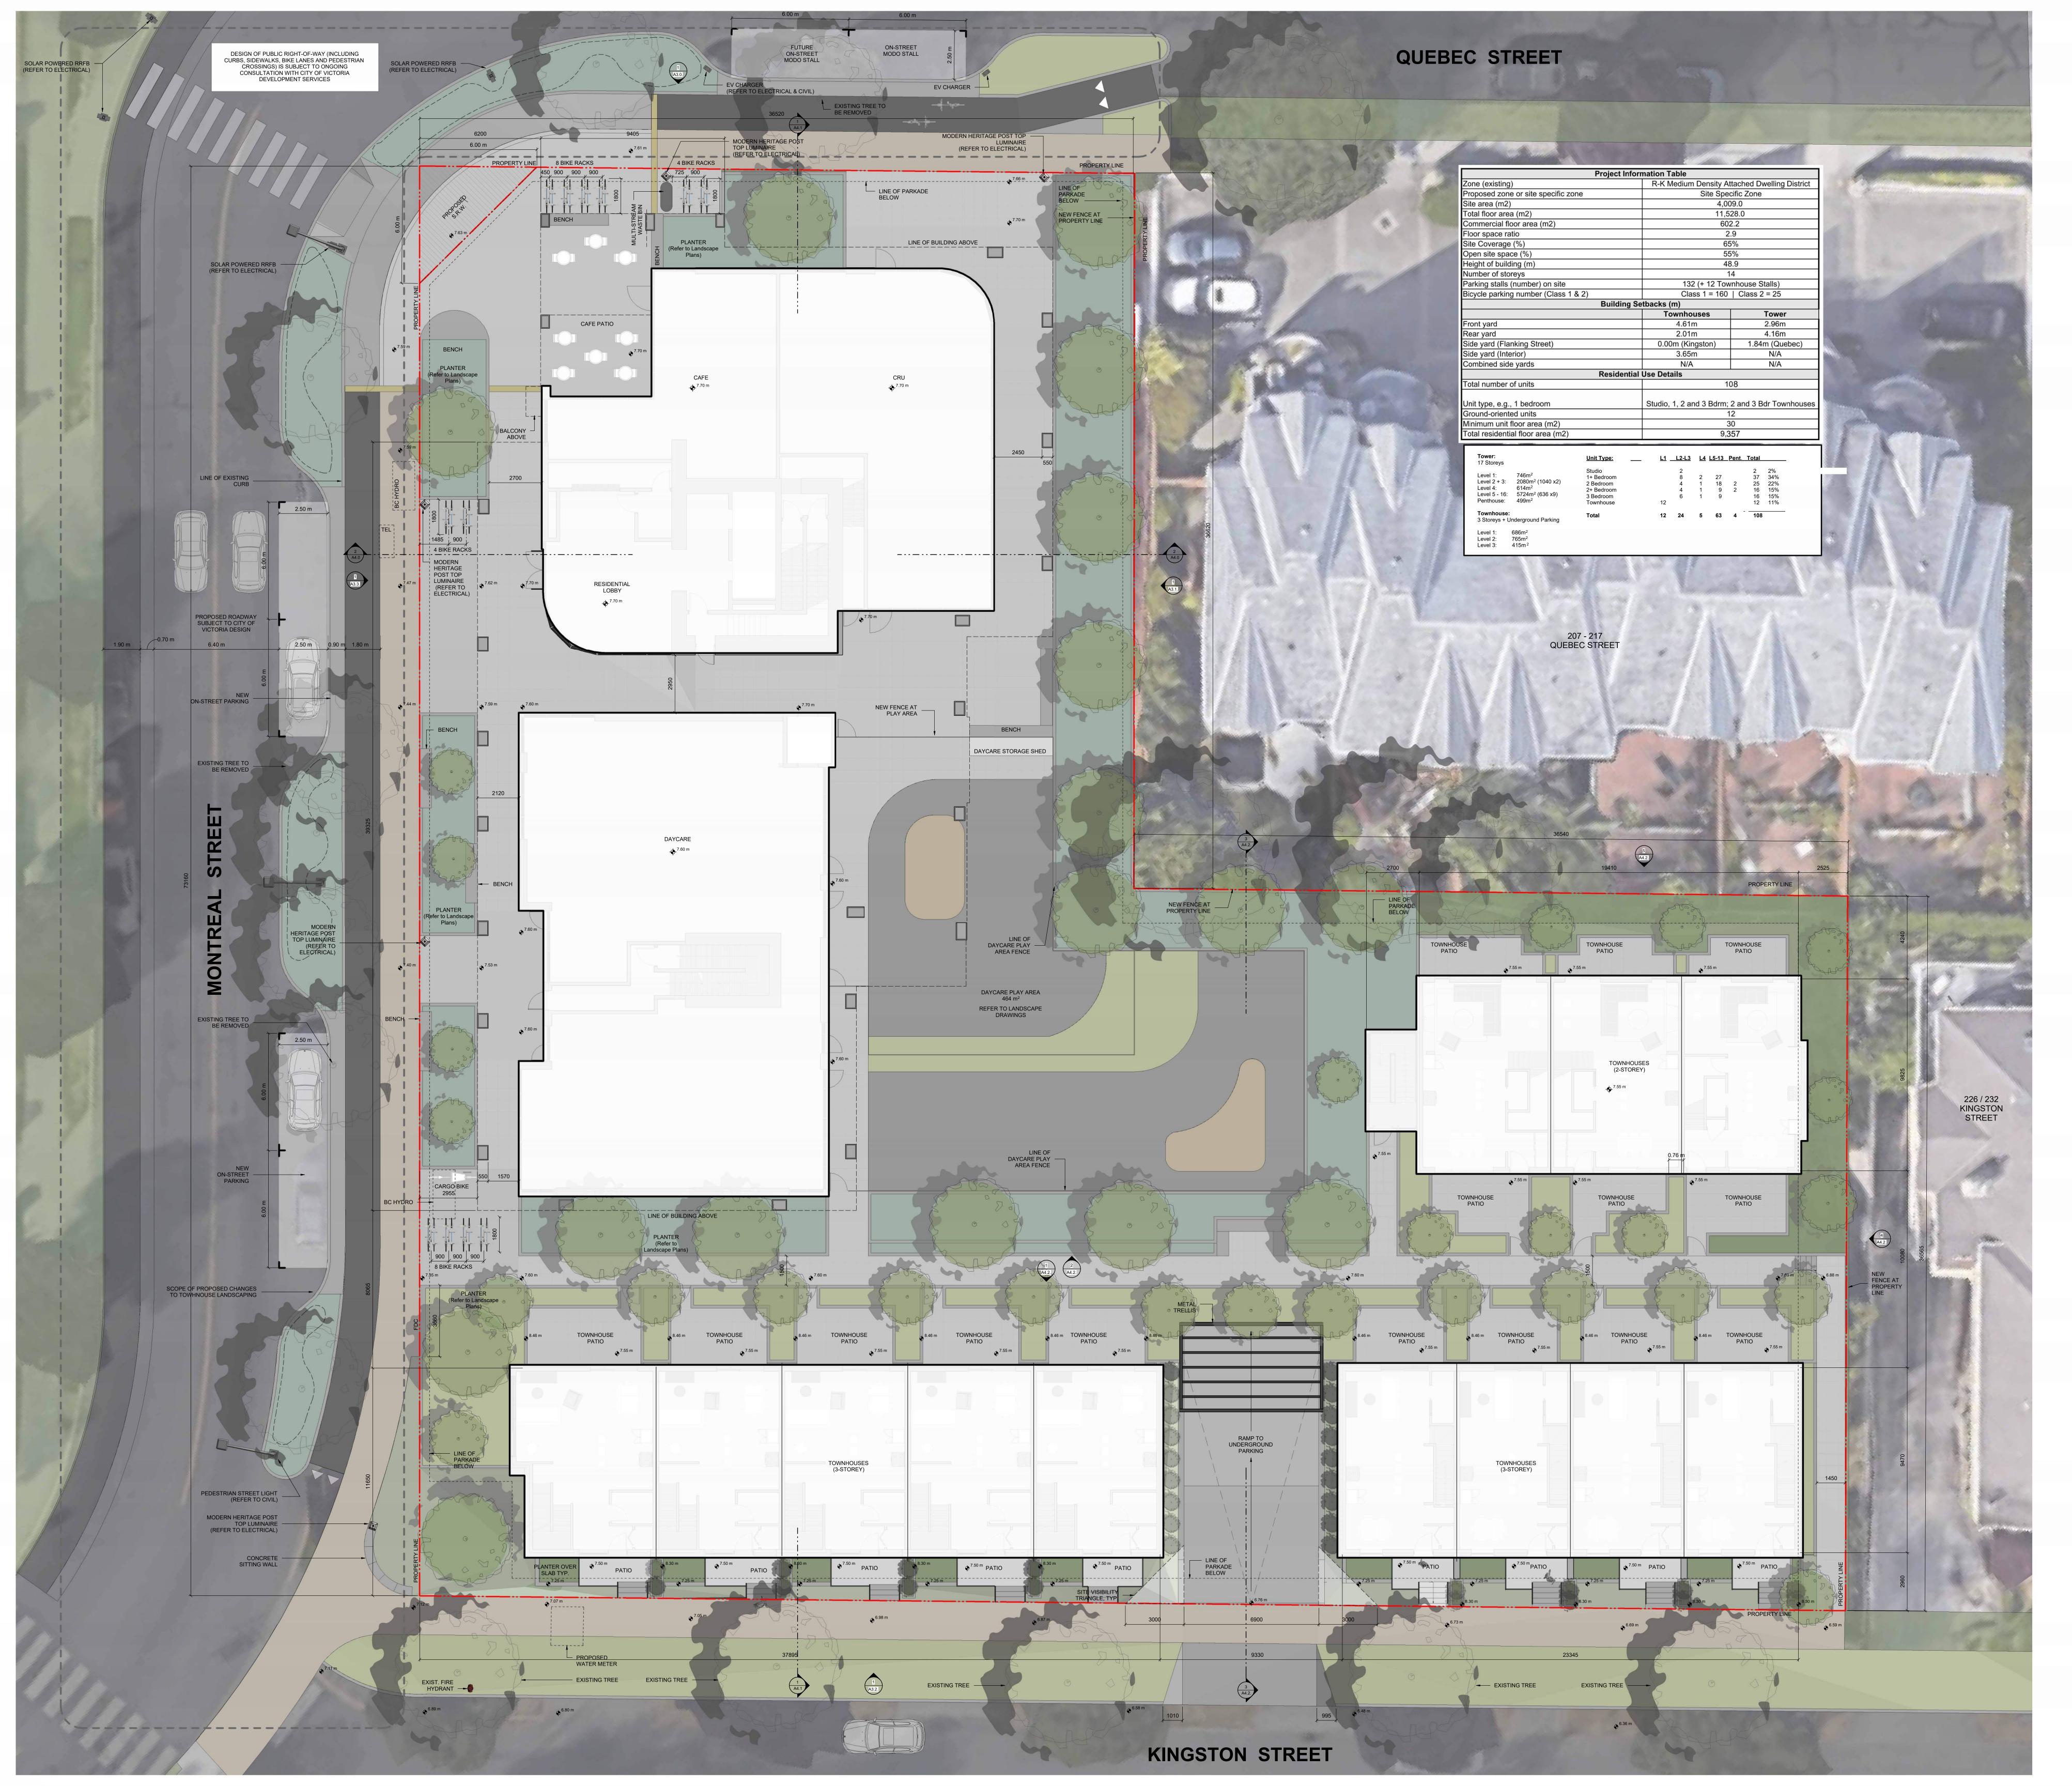

D'AMBROSIO

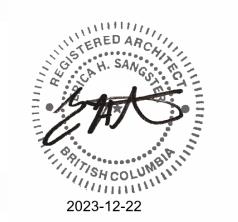

THIS DOCUMENT HAS BEEN ELECTRONICALLY CERTIFIED WITH DIGITAL CERTIFICATE AND ENCRYPTION TECHNOLOGY AUTHORIZED BY THE AIBC. THE AUTHORITATIVE ORIGINAL IS IN ELECTRONIC FORM. ANY PRINTED VERSION CAN BE RELIED UPON AS A TRUE COPY OF THE ORIGINAL WHEN SUPPLIED BY D'AMBROSIO architecture + urbanism, BEARING IMAGES OF THE PROFESSIONAL SEAL AND DIGITAL CERTIFICATE OR WHEN PRINTED FROM THE DIGITALLY CERTIFIED ELECTRONIC FILE.

NOTES:

REFER TO LANDSCAPE PLANS FOR INFORMATION ON PAVING ON PAVING, FENCING, PLANTING AND TREES.

scale in meters

Rezoning/DP Resubmission 23.12.22
Rezoning/DP Resubmission 22.12.06
Issued for ADP 22.08.02

4 Issued for ADP 22.08.02
2 Issued for Rezoning / DP 21.12.15
1 Issued for Dev. Tracker 21.10.19
rev no description date


copyright reserved. these drawings and designs are and at all times remain the property of d'ambrosio architecture to be used for the project shown and may not be reproduced without

project name


Montreal and Quebec
205 Quebec Street
Victoria, BC

sheet title
Site Plan

project no. #21-18
scale 1:100
drawn by RP, GK, GB
date issued sheet no.
12/06/22 A 1.1

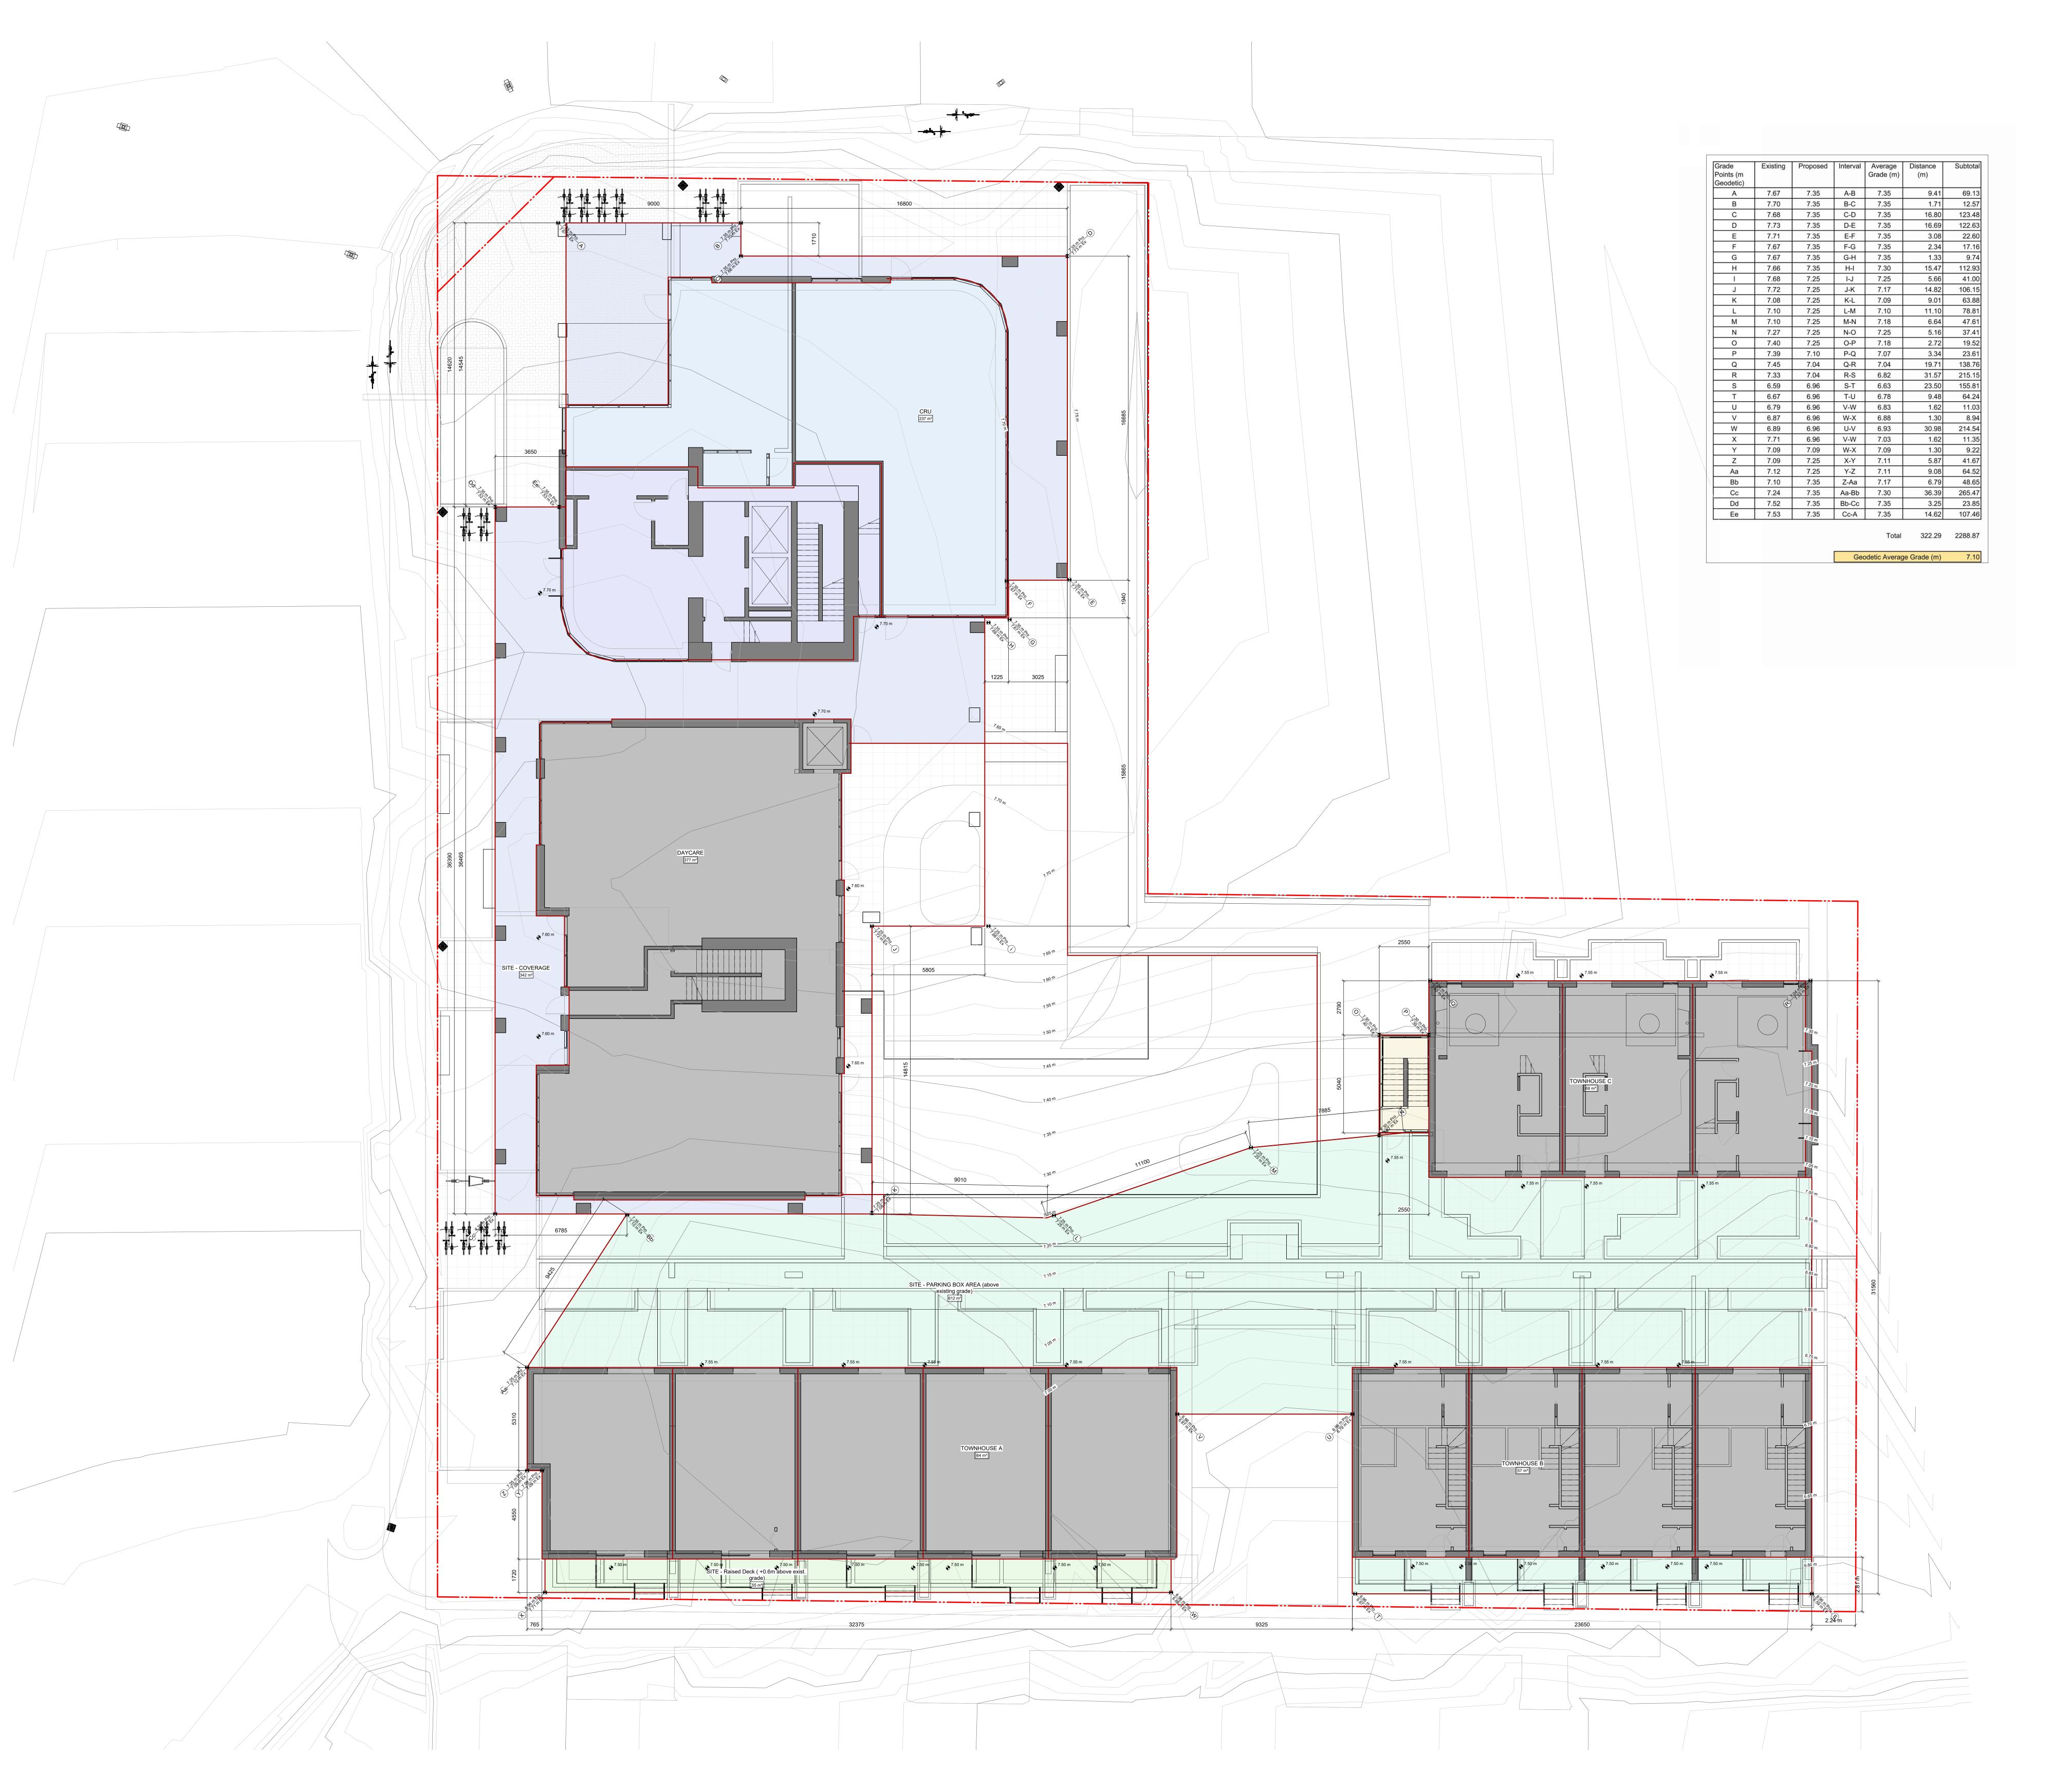

D'AMBROSIO architecture + urbanism

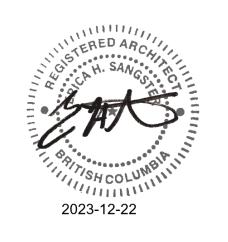

THIS DOCUMENT HAS BEEN ELECTRONICALLY CERTIFIED WITH DIGITAL CERTIFICATE AND ENCRYPTION TECHNOLOGY AUTHORIZED BY THE AIBC. THE AUTHORITATIVE ORIGINAL IS IN ELECTRONIC FORM. ANY PRINTED VERSION CAN BE RELIED UPON AS A TRUE COPY OF THE ORIGINAL WHEN SUPPLIED BY D'AMBROSIO architecture + urbanism, BEARING IMAGES OF THE PROFESSIONAL SEAL AND DIGITAL CERTIFICATE OR WHEN PRINTED FROM THE DIGITALLY CERTIFIED ELECTRONIC FILE.


Rezoning/DP Resubmission 23.12.22
Rezoning/DP Resubmission 22.12.06
Issued for ADP 22.08.02
Issued for Rezoning / DP 21.12.15

6 Rezoning/DP Resubmission 23.12.22
5 Rezoning/DP Resubmission 22.12.06
4 Issued for ADP 22.08.02
2 Issued for Rezoning / DP 21.12.15
rev no description date
copyright reserved. these drawings and designs are and at all times remain the property of d'ambrosio architecture to be used for the project shown and may not be reproduced without written consent.

Montreal and Quebec 205 Quebec Street Victoria, BC

sheet title
Average Grade
Calculations

project no.	#21-18	ΑA
scale	1 : 100	10:34:26 AN
drawn by	RP, GK, GB	10:3
date issued	sheet no.	2-22
12/06/22	A1.2	2023-12-22

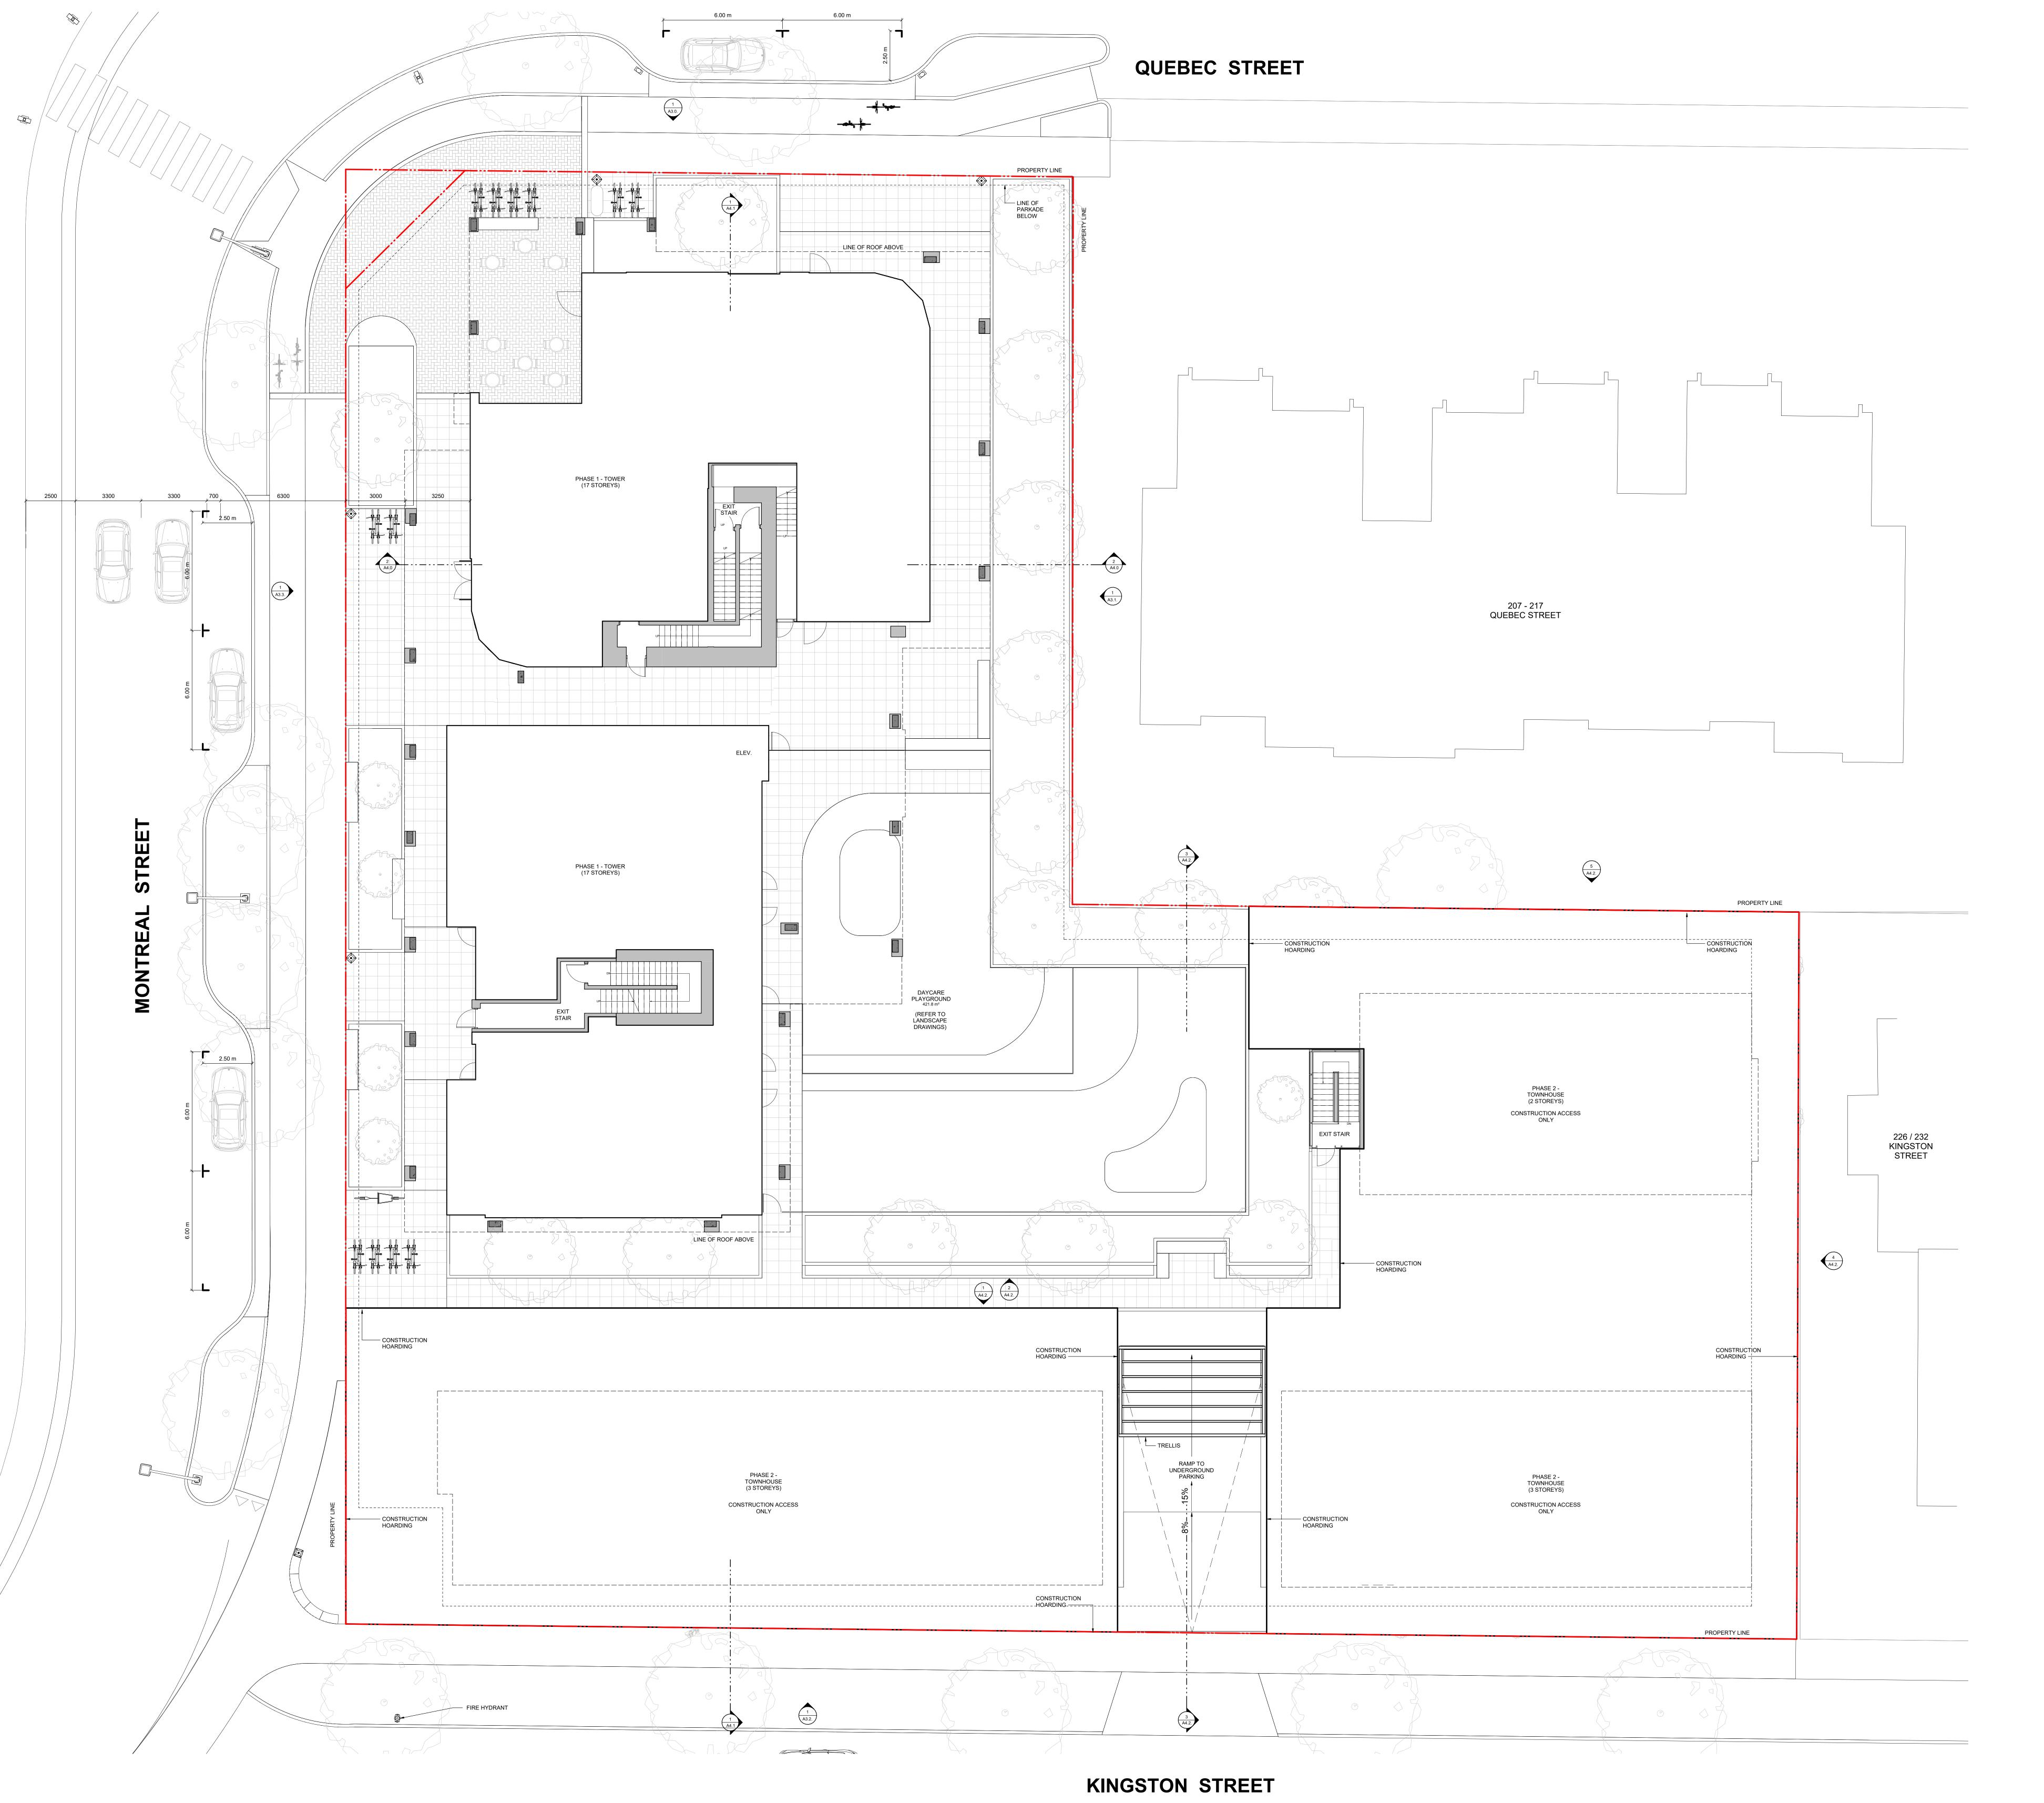

D'AMBROSIO

ANG TO THE PARTY OF THE PARTY O

THIS DOCUMENT HAS BEEN ELECTRONICALLY CERTIFIED WITH DIGITAL CERTIFICATE AND ENCRYPTION TECHNOLOGY AUTHORIZED BY THE AIBC. THE AUTHORITATIVE ORIGINAL IS IN ELECTRONIC FORM. ANY PRINTED VERSION CAN BE RELIED UPON AS A TRUE COPY OF THE ORIGINAL WHEN SUPPLIED BY D'AMBROSIO architecture + urbanism, BEARING IMAGES OF THE PROFESSIONAL SEAL AND DIGITAL CERTIFICATE OR WHEN PRINTED FROM THE DIGITALLY CERTIFIED ELECTRONIC FILE.

0m 5m scale in meters

Rezoning/DP Resubmission 23.12.22
Rezoning/DP Resubmission 22.12.06
Issued for ADP 22.08.02
Issued for Rezoning / DP 21.12.15
Issued for Dev. Tracker 21.10.19
o description date

rev no description date

copyright reserved. these drawings and designs are and at all times remain the property of d'ambrosio architecture to be used for the project shown and may not be reproduced without written consent.

project name

Montreal and Quebec
205 Quebec Street

victoria, BC

sheet title

Level 1 Phasing Plan

 project no.
 #21-18


 scale
 1 : 100


 drawn by
 Author

 date issued
 sheet no.

 12/06/22
 Δ 1 3



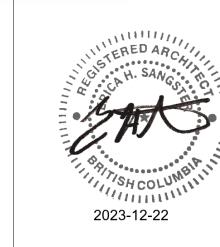

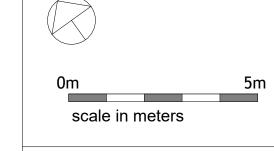

scale in meters

6 Rezoning/DP Resubmission 23.12.22
5 Rezoning/DP Resubmission 22.12.06


5 Rezoning/DP Resubmission 22.12.06
4 Issued for ADP 22.08.02
2 Issued for Rezoning / DP 21.12.15
1 Issued for Dev. Tracker 21.10.19
rev no description date
copyright reserved. these drawings and designs are and at all times remain the property of d'ambrosio architecture to be used for the project shown and may not be reproduced without written consent.


Montreal and Quebec 205 Quebec Street Victoria, BC

sheet title
P1 Phasing Plan

project no.	#21-18
scale	1 : 100
drawn by	Author
date issued	sheet no.
12/06/22	A1.4



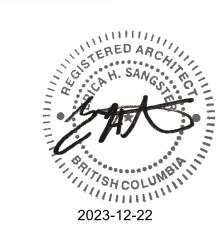

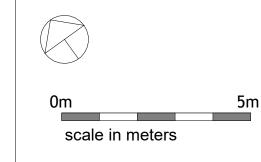

scale in meters

6 Rezoning/DP Resubmission 23.12.22
5 Rezoning/DP Resubmission 22.12.06
4 Issued for ADP 22.08.02
2 Issued for Rezoning / DP 21.12.15
1 Issued for Dev. Tracker 21.10.19
rev no description date

copyright reserved. these drawings and designs are and at all times remain the property of d'ambrosio architecture to be used for the project shown and may not be reproduced without written consent.


project name


Montreal and Quebec
205 Quebec Street
Victoria, BC

sheet title
P2 Parking Plan

	J
#21-18	AM (
1 : 100	10:34:49
RP / GK	10:3
sheet no.	2-22
A2.0	2023-12
	1:100 RP / GK sheet no.



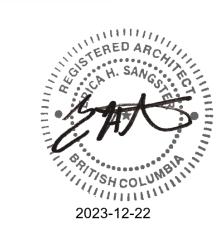

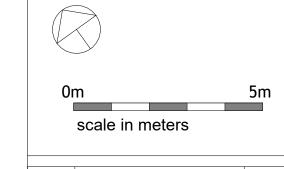

6 Rezoning/DP Resubmission 23.12.22
5 Rezoning/DP Resubmission 22.12.06
4 Issued for ADP 22.08.02
2 Issued for Rezoning / DP 21.12.15
1 Issued for Dev. Tracker 21.10.19
rev no description date

copyright reserved. these drawings and designs are and at all times remain the property of d'ambrosio architecture to be used for the project shown and may not be reproduced without written consent.


project name

Montreal and Quebec
205 Quebec Street

sheet title
P1 Parking Plan


Victoria, BC

project no.	#21-18
scale	1 : 100
drawn by	RP / GK
date issued	sheet no.
12/06/22	A2.1

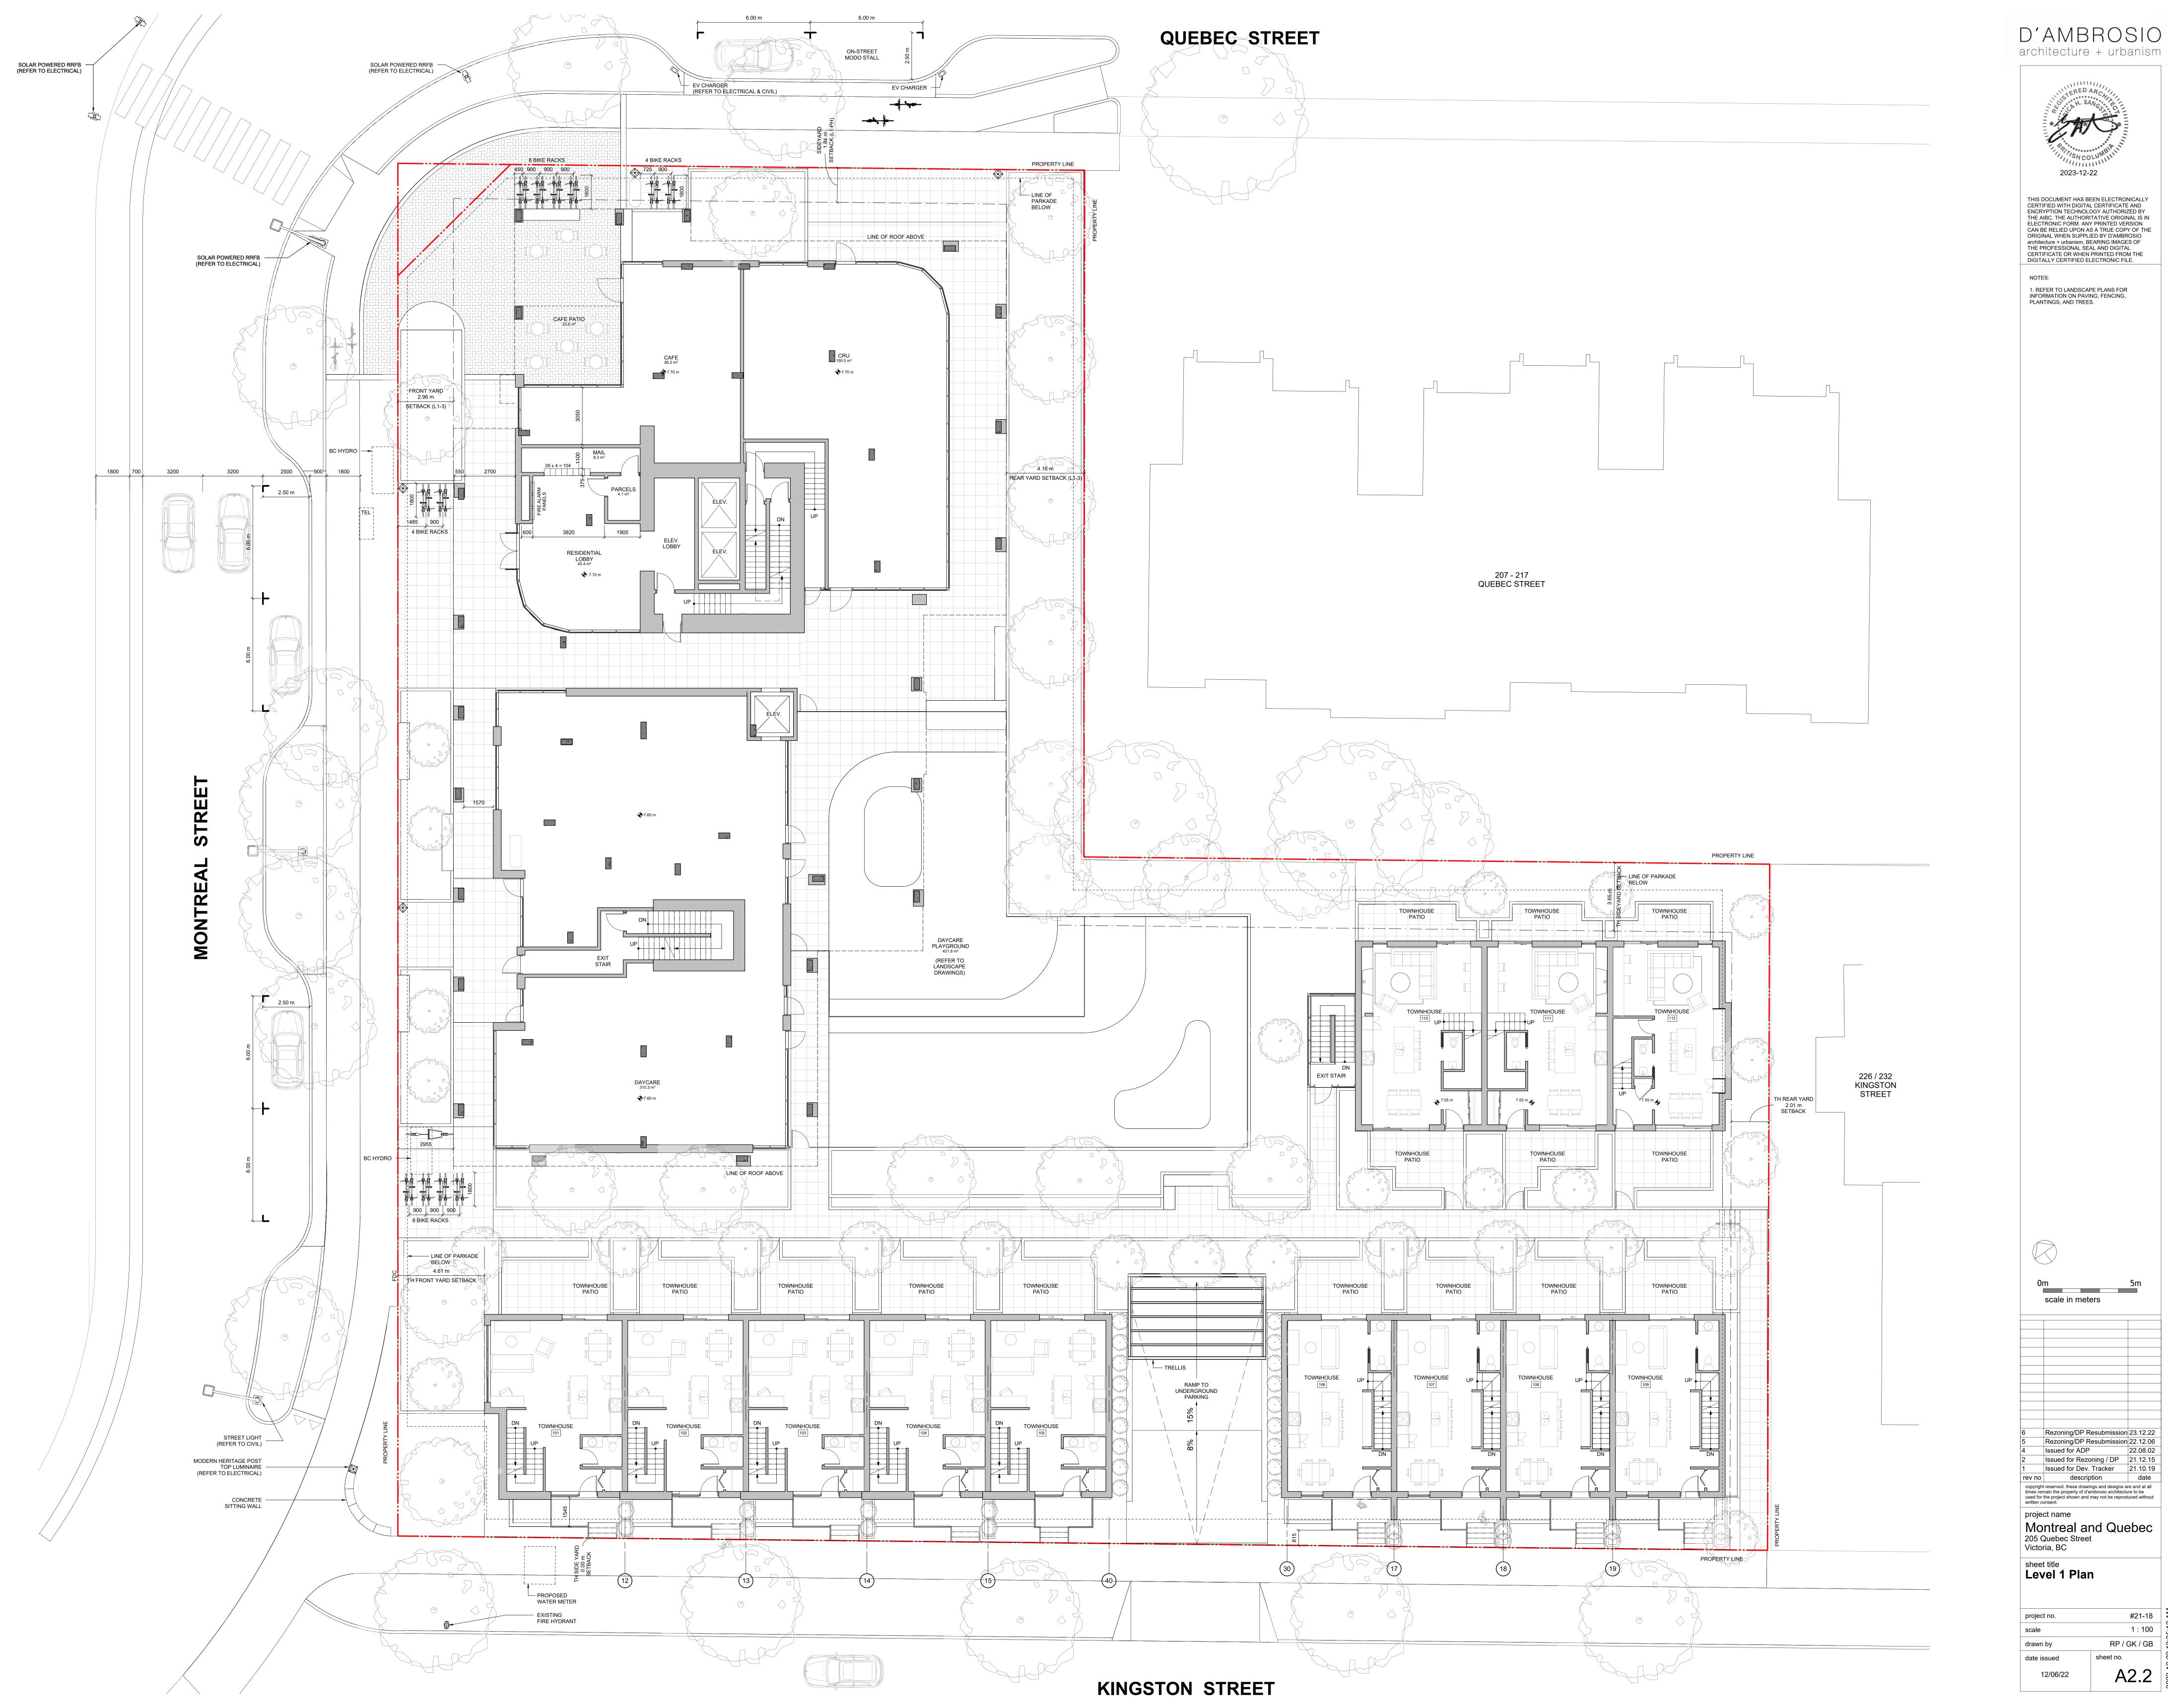

#21-18 1:100



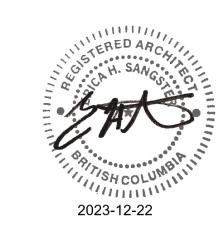

0m 5m scale in meters

6 Rezoning/DP Resubmission 23.12.22
5 Rezoning/DP Resubmission 22.12.06
4 Issued for ADP 22.08.02
2 Issued for Rezoning / DP 21.12.15
1 Issued for Dev. Tracker 21.10.19
rev no description date
copyright reserved. these drawings and designs are and at all times remain the property of d'ambrosio architecture to be used for the project shown and may not be reproduced without written consent.

rev no description date

copyright reserved. these drawings and designs are and at all times remain the property of d'ambrosio architecture to be used for the project shown and may not be reproduced without written consent.

project name

Montreal and Quebec
205 Quebec Street
Victoria, BC

Victoria, BC
sheet title
Level 2 Plan

project no. #21-18


scale 1:100

drawn by RP / GK / GB

date issued sheet no.

12/06/22 A2.3



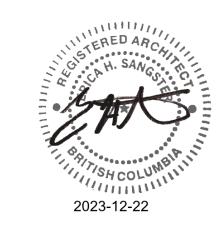

NOTES:

1. REFER TO LANDSCAPE PLANS FOR INFORMATION ON PAVING, FENCING, PLANTINGS, AND TREES.

0m 5m scale in meters

6 Rezoning/DP Resubmission 23.12.22
5 Rezoning/DP Resubmission 22.12.06
4 Issued for ADP 22.08.02
2 Issued for Rezoning / DP 21.12.15
1 Issued for Dev. Tracker 21.10.19

1 Issued for Dev. Tracker 21.10.19

rev no description date

copyright reserved. these drawings and designs are and at all times remain the property of d'ambrosio architecture to be used for the project shown and may not be reproduced without written consent.

project name

Montreal and Quebec
205 Quebec Street
Victoria, BC

sheet title Level 3 Plan

project no. #21-18


scale 1:100

drawn by RP / GK / GB

date issued sheet no.

12/06/22 A2.4



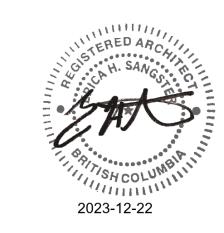

NOTES:

1. REFER TO LANDSCAPE PLANS FOR INFORMATION ON PAVING, FENCING, PLANTINGS, AND TREES.

0m 5m scale in meters

Rezoning/DP Resubmission 23.12.22
Rezoning/DP Resubmission 22.12.06
Issued for ADP 22.08.02

6 Rezoning/DP Resubmission 23.12.22
5 Rezoning/DP Resubmission 22.12.06
4 Issued for ADP 22.08.02
2 Issued for Rezoning / DP 21.12.15
1 Issued for Dev. Tracker 21.10.19
rev no description date

rev no description date

copyright reserved. these drawings and designs are and at all times remain the property of d'ambrosio architecture to be used for the project shown and may not be reproduced without written consent.

project name


Montreal and Quebec
205 Quebec Street
Victoria, BC


sheet title
Level 4 Plan

project no. #21-18
scale 1 : 100
drawn by RP / GK / GB
date issued sheet no.

12/06/22 A 2 5



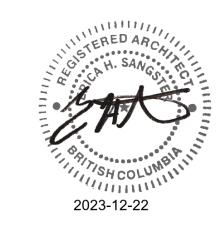

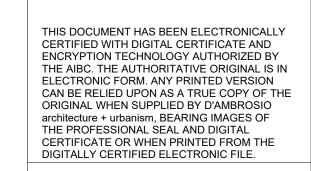

0m 5m scale in meters

6 Rezoning/DP Resubmission 23
5 Rezoning/DP Resubmission 22

6 Rezoning/DP Resubmission 23.12.22
5 Rezoning/DP Resubmission 22.12.06
4 Issued for ADP 22.08.02
2 Issued for Rezoning / DP 21.12.15
1 Issued for Dev. Tracker 21.10.19
rev no description date

copyright reserved. these drawings and designs are and at all times remain the property of d'ambrosio architecture to be used for the project shown and may not be reproduced without written consent.

project name

Montreal and Quebec
205 Quebec Street


victoria, BC
sheet title
Level 5-13 Plan

project no. #21-18


scale 1:100


drawn by RP / GK / GB

date issued sheet no. 42.6

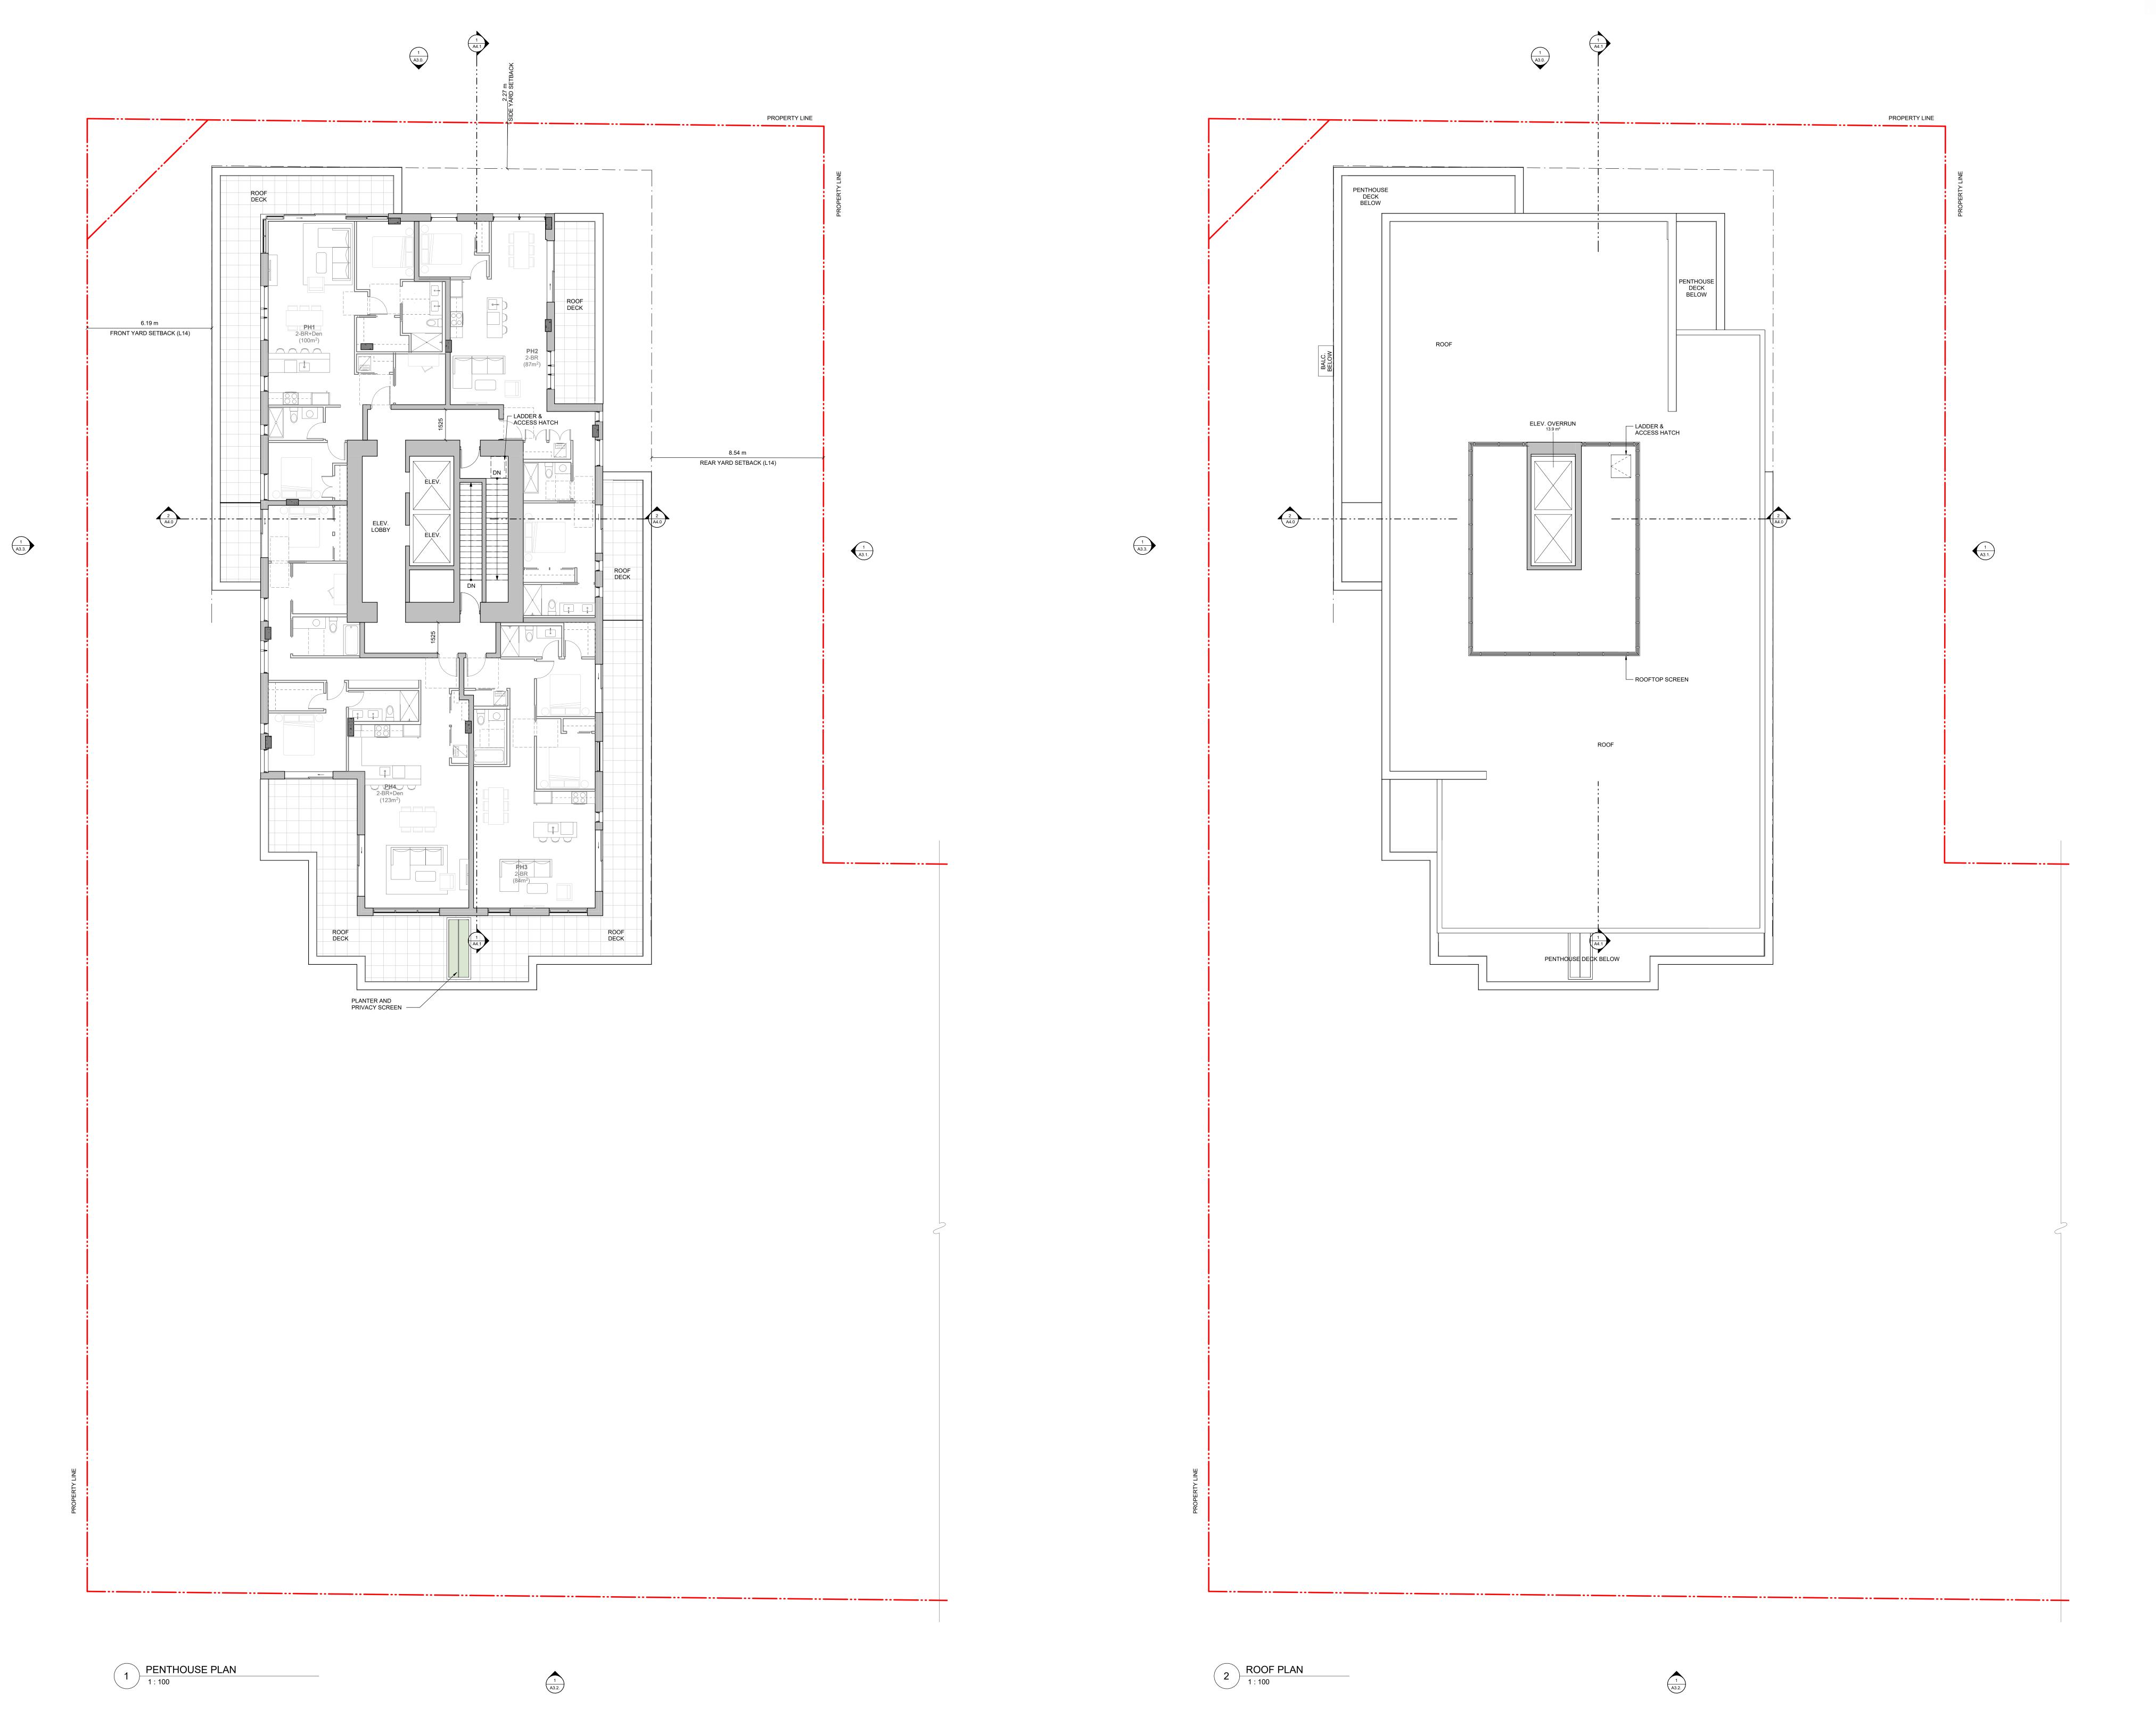



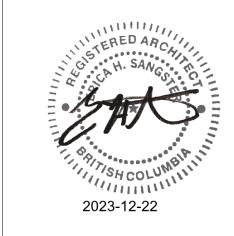

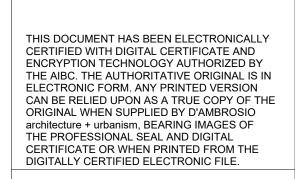

0m 5m
scale in meters

6 Rezoning/DP Resubmission 23.1
5 Rezoning/DP Resubmission 22.1

6 Rezoning/DP Resubmission 23.12.22
5 Rezoning/DP Resubmission 22.12.06
4 Issued for ADP 22.08.02
2 Issued for Rezoning / DP 21.12.15
1 Issued for Dev. Tracker 21.10.19
rev no description date
copyright reserved. these drawings and designs are and at all times remain the property of d'ambrosio architecture to be used for the project shown and may not be reproduced without written consent.


project name

Montreal and Quebec
205 Quebec Street
Victoria, BC

sheet title
Penthouse + Roof Plan

project no. #21-18
scale 1 : 100
drawn by RP / GK / GB
date issued sheet no.
12/06/22 A2.7



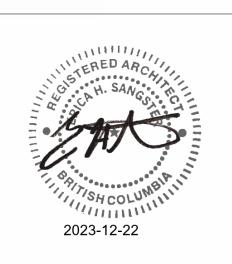

# ELEVATION MATERIALS KEY:

1 Cement Panel System Colour: Sandstone Running Bond Brick Colour: Oatmeal

Fibre Cement Panel Colour: Dark Grey

4 Pre-finished Vertical Wood Siding 5 Soffits: T&G Wood

6 Glass Guards in Pre-finished Aluminum Frames

Glazed Canopies: Laminated Glazing on Painted Steel Structure Colour: Iron / Ore

8 Prefinished Metal Parapet Flashing Colour: Iron / Ore 9 Prefinished Metal Fascia Colour: Iron / Ore

Perforated Metal Balcony Guard Colour: Iron / Ore Painted Metal Pergolas and Gates Colour: Iron / Ore

Window and Doors: Clear Glazing in Dark Anodized Aluminum Frames Colour: Iron / Ore

Glass Walls and Guards w/ Aluminum Frame Colour: Iron / Ore

(14) Exposed Architectural Concrete

Prefinished Metal Louvers Colour: Iron / Ore


Prefinished Metal Panel Colour: Iron / Ore

6 Rezoning/DP Resubmission 23.12.22
5 Rezoning/DP Resubmission 22.12.06
4 Issued for ADP 22.08.02
2 Issued for Rezoning / DP 21.12.15
1 Issued for Dev. Tracker 21.10.19
rev no description date
copyright reserved. these drawings and designs are and at all times remain the property of d'ambrosio architecture to be used for the project shown and may not be reproduced without written consent. project name Montreal and Quebec 205 Quebec Street Victoria, BC

sheet title
North Elevation

#21-18 project no. 1 : 100 CF / RP / GB drawn by date issued A3.0 12/06/22

## D'AMBROSIO architecture + urbanism

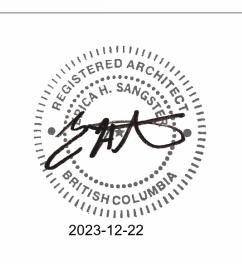

THIS DOCUMENT HAS BEEN ELECTRONICALLY CERTIFIED WITH DIGITAL CERTIFICATE AND ENCRYPTION TECHNOLOGY AUTHORIZED BY THE AIBC. THE AUTHORITATIVE ORIGINAL IS IN THE AIBC. THE AUTHORITATIVE ORIGINAL IS IN ELECTRONIC FORM. ANY PRINTED VERSION CAN BE RELIED UPON AS A TRUE COPY OF THE ORIGINAL WHEN SUPPLIED BY D'AMBROSIO architecture + urbanism, BEARING IMAGES OF THE PROFESSIONAL SEAL AND DIGITAL CERTIFICATE OR WHEN PRINTED FROM THE DIGITALLY CERTIFIED ELECTRONIC FILE.

ELEVATION MATERIALS KEY: Cement Panel System Colour: Sandstone Running Bond Brick Colour: Oatmeal

Fibre Cement Panel Colour: Dark Grey

4 Pre-finished Vertical Wood Siding 5 Soffits: T&G Wood

(6) Glass Guards in Pre-finished Aluminum Frames

Glazed Canopies: Laminated Glazing on Painted Steel Structure Colour: Iron / Ore

8 Prefinished Metal Parapet Flashing Colour: Iron / Ore

9 Prefinished Metal Fascia Colour: Iron / Ore Perforated Metal Balcony Guard Colour: Iron / Ore

Painted Metal Pergolas and Gates Colour: Iron / Ore Window and Doors: Clear Glazing in Dark Anodized Aluminum Frames Colour: Iron / Ore

Glass Walls and Guards w/ Aluminum Frame Colour: Iron / Ore

(14) Exposed Architectural Concrete

Prefinished Metal Louvers

Colour: Iron / Ore

Prefinished Metal Panel Colour: Iron / Ore

6 Rezoning/DP Resubmission 23.12.22
5 Rezoning/DP Resubmission 22.12.06
4 Issued for ADP 22.08.02
2 Issued for Rezoning / DP 21.12.15
1 Issued for Dev. Tracker 21.10.19
rev no description date

copyright reserved. these drawings and designs are and at all times remain the property of d'ambrosio architecture to be used for the project shown and may not be reproduced without written consent. project name Montreal and Quebec 205 Quebec Street Victoria, BC

sheet title
East Elevation

12/06/22

#21-18 project no. 1:100 CF / RP / GB drawn by date issued





## ELEVATION MATERIALS KEY: (1) Cement Panel System

- Cement Panel System
  Colour: Sandstone

  Running Bond Brick
- Running Bond Brick
  Colour: Oatmeal

  Fibre Cement Panel
  Colour: Dark Grey
- 4 Pre-finished Vertical Wood Siding
- 5 Soffits: T&G Wood
- 6 Glass Guards in Pre-finished Aluminum Frames
- Glazed Canopies: Laminated Glazing on Painted Steel Structure Colour: Iron / Ore
- 8 Prefinished Metal Parapet Flashing Colour: Iron / Ore
- 9 Prefinished Metal Fascia Colour: Iron / Ore
- 10 Perforated Metal Balcony Guard Colour: Iron / Ore
  11 Painted Metal Pergolas and Gates Colour: Iron / Ore
- Window and Doors: Clear Glazing in Dark
  Anodized Aluminum Frames
  Colour: Iron / Ore
- Glass Walls and Guards w/ Aluminum Frame Colour: Iron / Ore
- 14 Exposed Architectural Concrete

6 Rezoning/DP Resubmission 23.12.22
5 Rezoning/DP Resubmission 22.12.06
4 Issued for ADP 22.08.02
2 Issued for Rezoning / DP 21.12.15
1 Issued for Dev. Tracker 21.10.19
rev no description date

copyright reserved. these drawings and designs are and at all times remain the property of d'ambrosio architecture to be used for the project shown and may not be reproduced without written consent.

Montreal and Quebec 205 Quebec Street Victoria, BC

#21-18

1:100

CF / RP / GB

sheet title
South Elevation

project name

project no.

drawn by

date issued

12/06/22

- Prefinished Metal Louvers Colour: Iron / Ore
- Prefinished Metal Panel Colour: Iron / Ore





## Cement Panel System Colour: Sandstone

ELEVATION MATERIALS KEY:

- Colour: Sandstone

  Running Bond Brick
  Colour: Oatmeal
- Fibre Cement Panel Colour: Dark Grey
- 4 Pre-finished Vertical Wood Siding
- 5 Soffits: T&G Wood
- 6 Glass Guards in Pre-finished Aluminum Frames
  Glazed Canopies: Laminated Glazing on
- Glazed Canopies: Laminated Glazing on Painted Steel Structure Colour: Iron / Ore
- 8 Prefinished Metal Parapet Flashing Colour: Iron / Ore
- 9 Prefinished Metal Fascia
  Colour: Iron / Ore

  10 Perforated Metal Balcony Guard
  Colour: Iron / Ore
- Painted Metal Pergolas and Gates
  Colour: Iron / Ore
- Window and Doors: Clear Glazing in Dark Anodized Aluminum Frames Colour: Iron / Ore
- Glass Walls and Guards w/ Aluminum Frame Colour: Iron / Ore
- (14) Exposed Architectural Concrete
- Prefinished Metal Louvers
  Colour: Iron / Ore
- Colour: Iron / Ore
- Prefinished Metal Panel Colour: Iron / Ore

6 Rezoning/DP Resubmission 23.12.22
5 Rezoning/DP Resubmission 22.12.06
4 Issued for ADP 22.08.02
2 Issued for Rezoning / DP 21.12.15
1 Issued for Dev. Tracker 21.10.19
rev no description date
copyright reserved. these drawings and designs are and at all times remain the property of d'ambrosio architecture to be used for the project shown and may not be reproduced without written consent.

Montreal and Quebec 205 Quebec Street Victoria, BC

#21-18

1:100

CF / RP / GB

sheet title
West Elevation


project name

project no.


drawn by

date issued

12/06/22

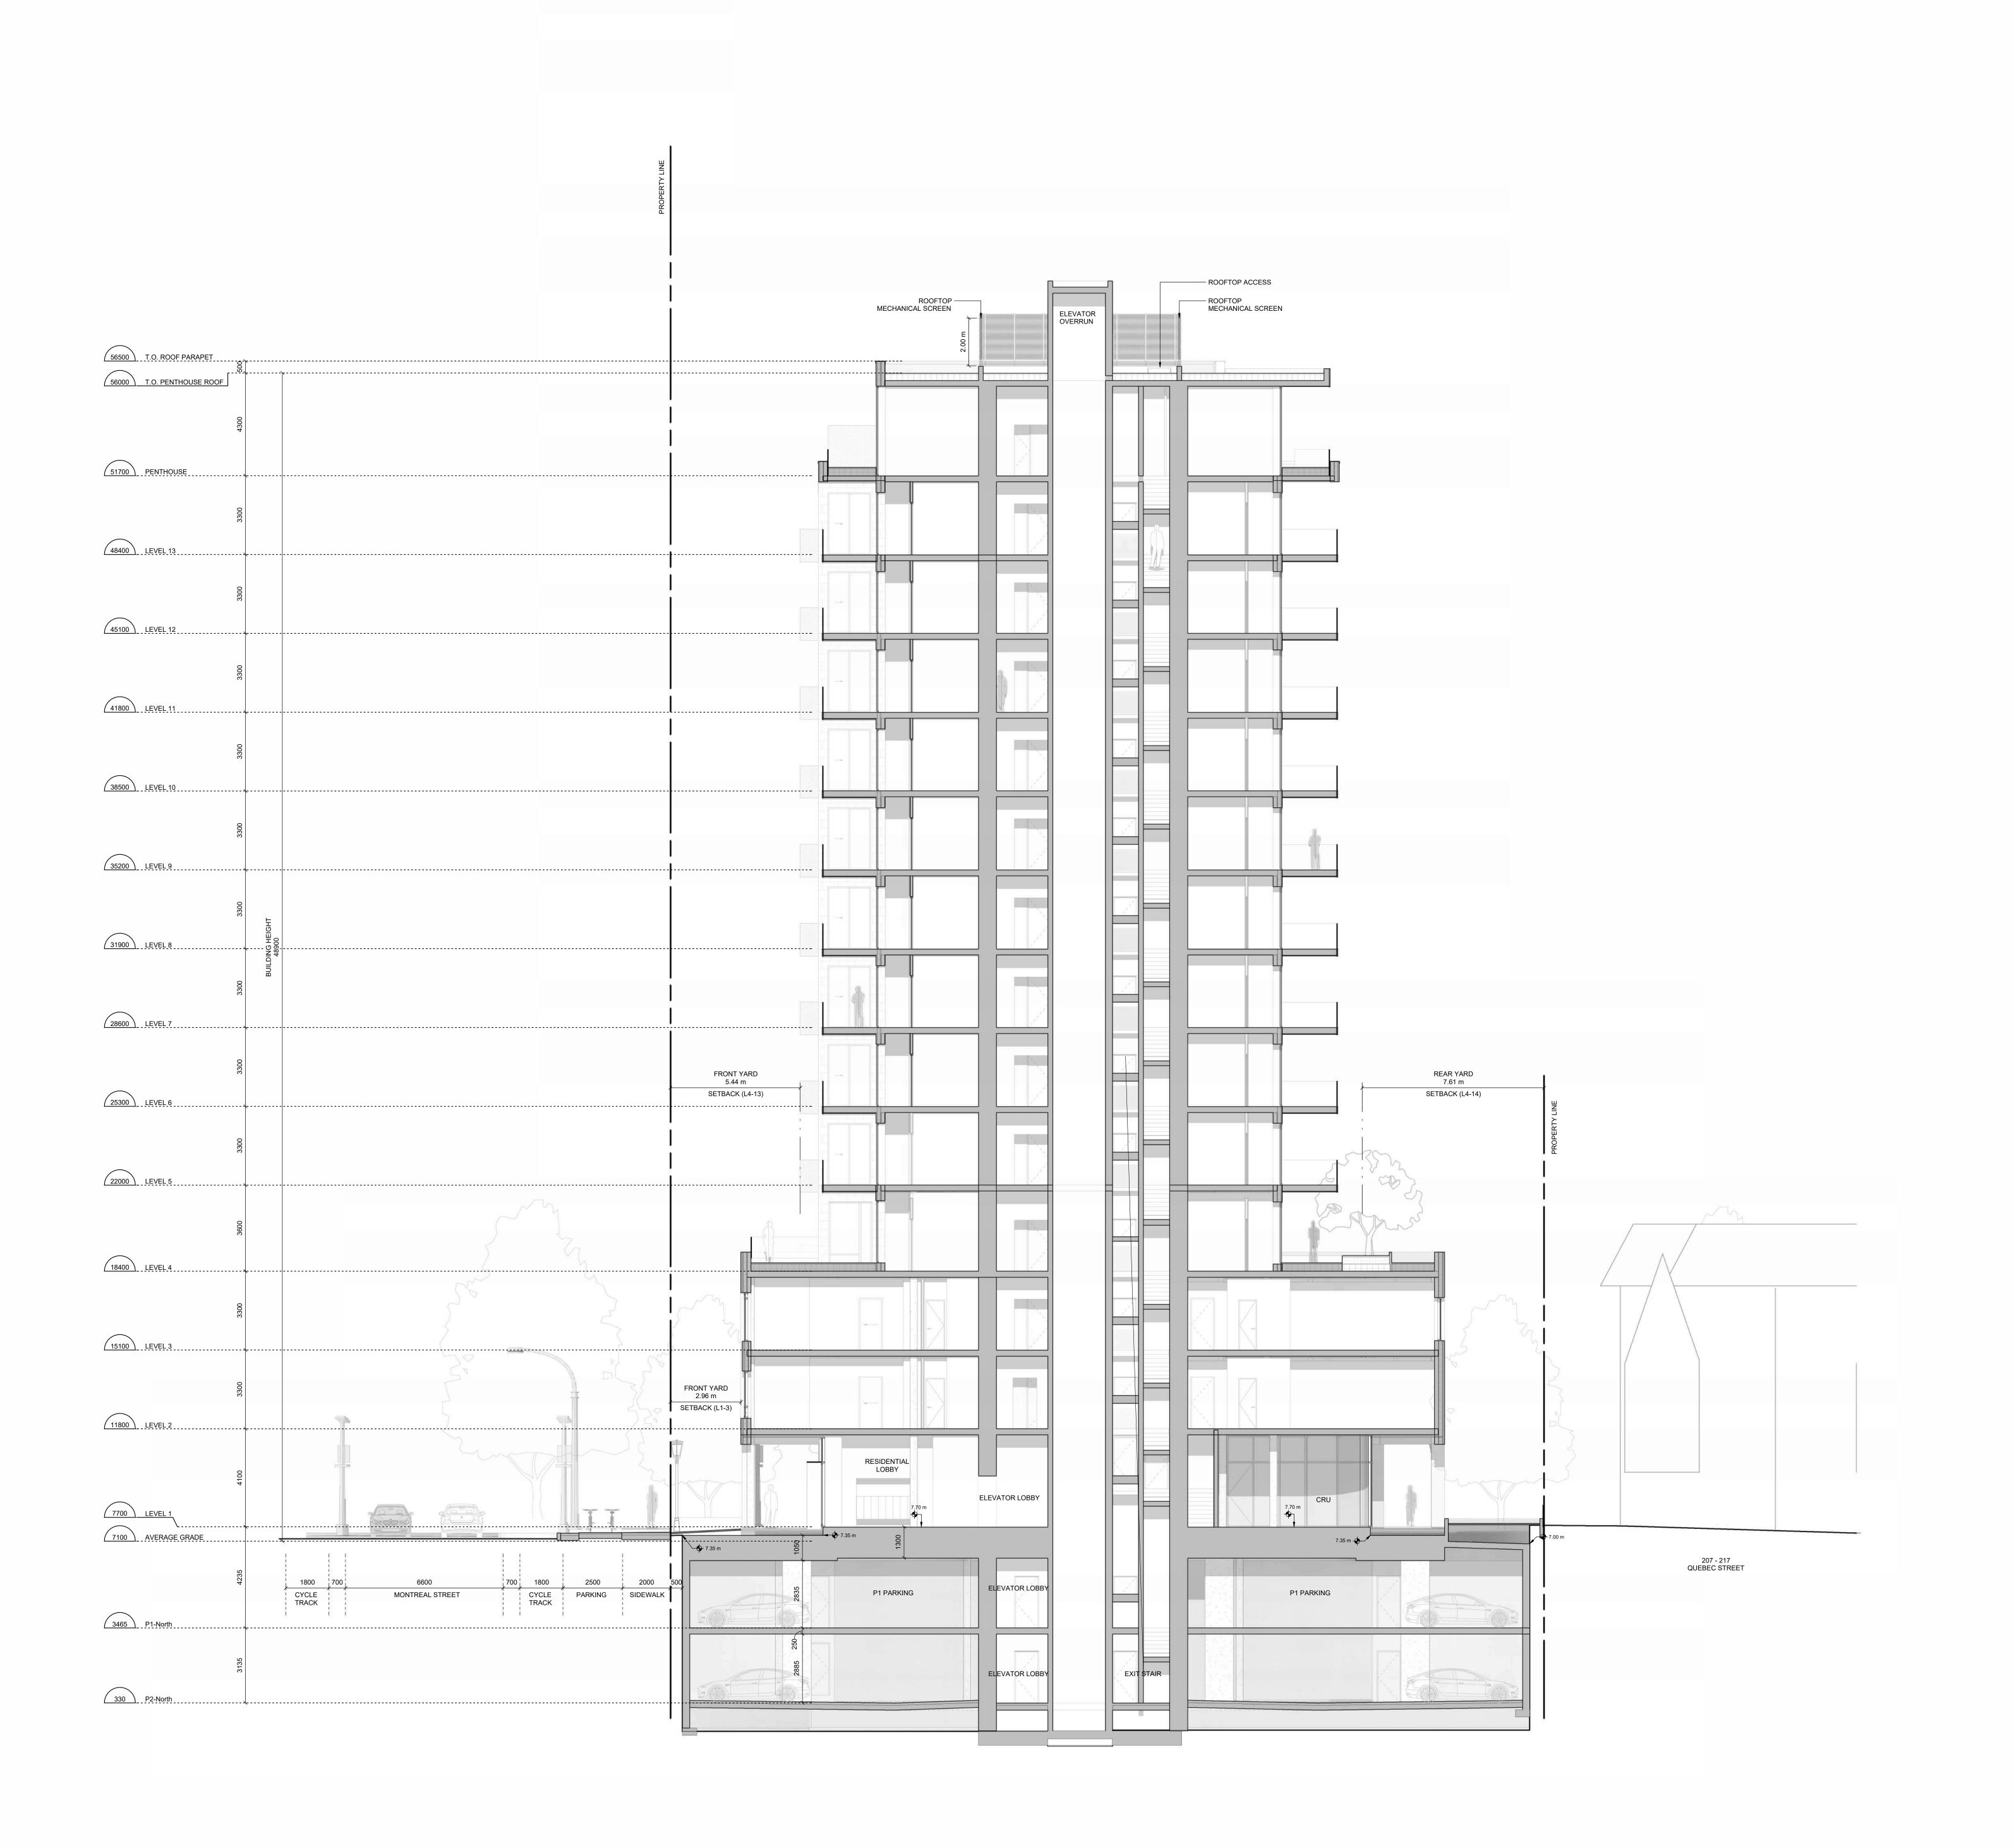



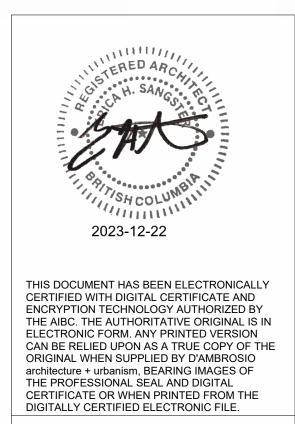


6 Rezoning/DP Resubmission 23.12.22
5 Rezoning/DP Resubmission 22.12.06
4 Issued for ADP 22.08.02
3 Rezoning/DP Resubmission 22.04.14

6 Rezoning/DP Resubmission 23.12.22
5 Rezoning/DP Resubmission 22.12.06
4 Issued for ADP 22.08.02
3 Rezoning/DP Resubmission 22.04.14
2 Issued for Rezoning / DP 21.12.15
rev no description date
copyright reserved. these drawings and designs are and at all times remain the property of d'ambrosio architecture to be used for the project shown and may not be reproduced without written consent.

Montreal and Quebec
205 Quebec Street
Victoria, BC

## sheet title Building Sections

project no.	#21-18
scale	1 : 100
drawn by	RP
date issued	sheet no.
12/06/22	A4.0

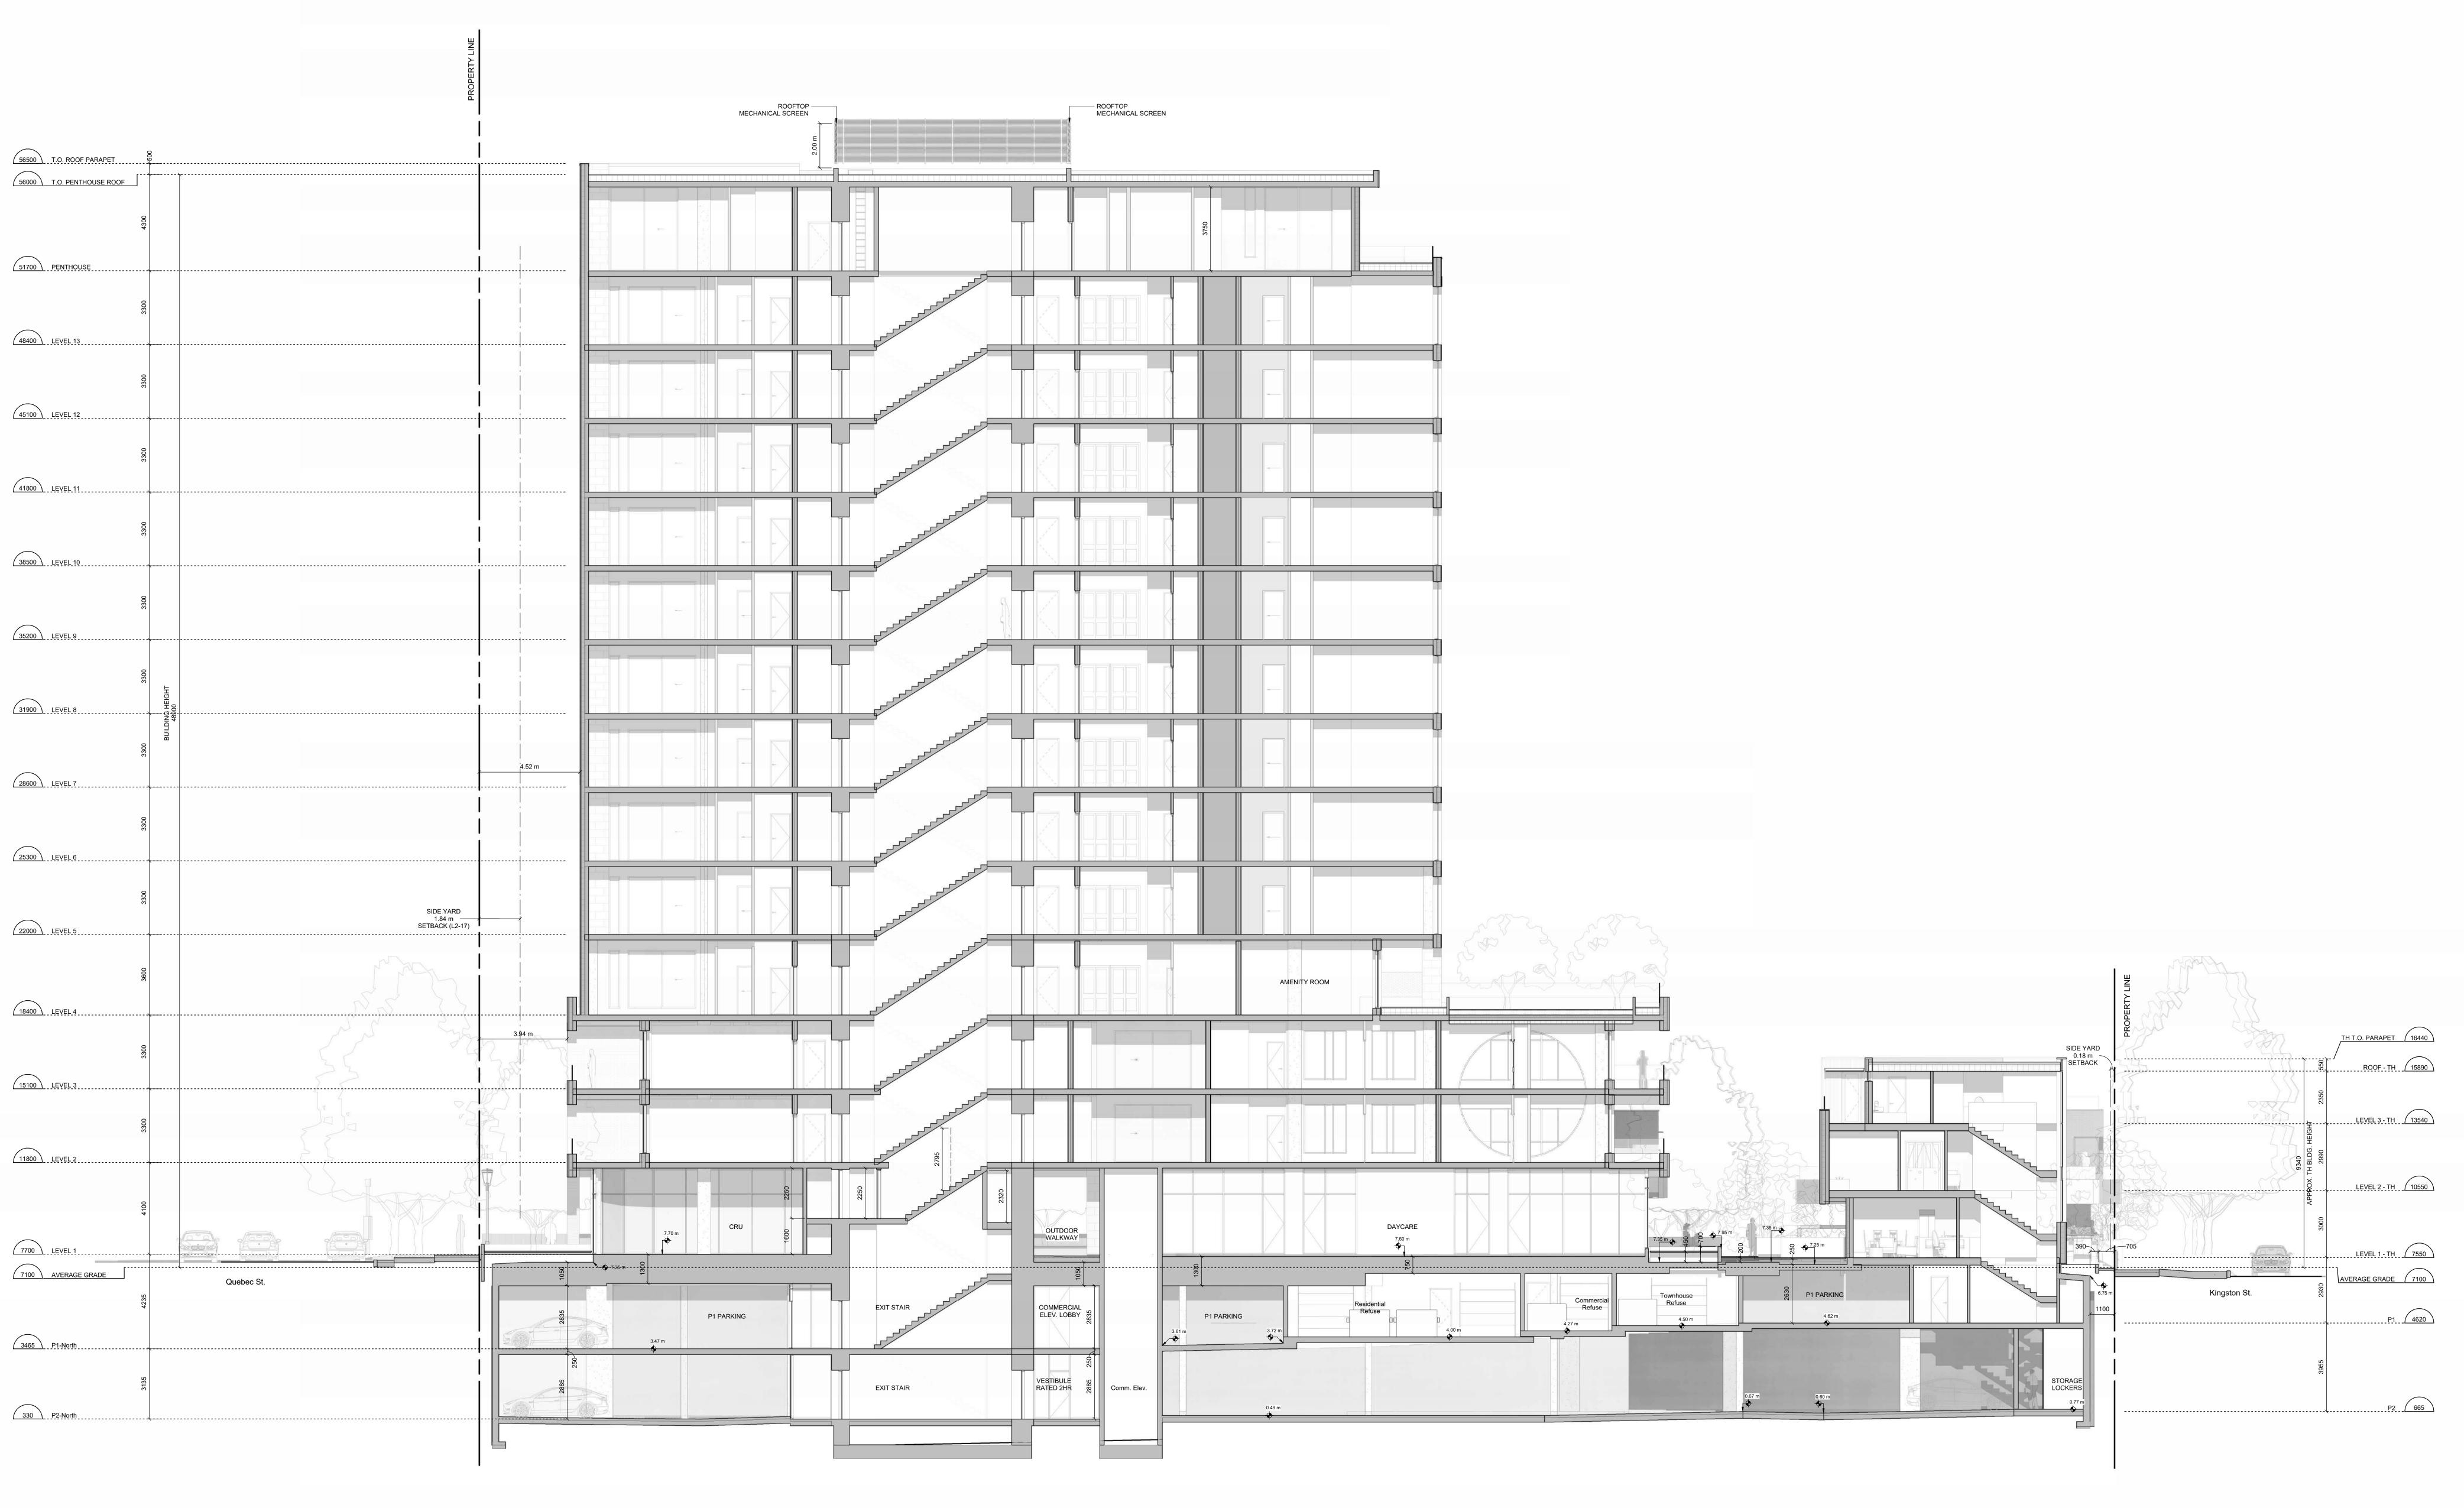

Montreal and Quebec 205 Quebec Street Victoria, BC

sheet title
Building Sections

project no.	#21-18
scale	1 : 100
drawn by	RP
date issued	sheet no.
12/06/22	A4.1






2 South Elevation - Townhouse 1:100







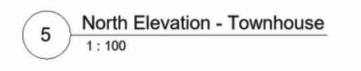





THIS DOCUMENT HAS BEEN ELECTRONICALLY CERTIFIED WITH DIGITAL CERTIFICATE AND ENCRYPTION TECHNOLOGY AUTHORIZED BY THE AIBC. THE AUTHORITATIVE ORIGINAL IS IN ELECTRONIC FORM. ANY PRINTED VERSION CAN BE RELIED UPON AS A TRUE COPY OF THE ORIGINAL WHEN SUPPLIED BY D'AMBROSIO architecture + urbanism, BEARING IMAGES OF THE PROFESSIONAL SEAL AND DIGITAL CERTIFICATE OR WHEN PRINTED FROM THE DIGITALLY CERTIFIED ELECTRONIC FILE.

## ELEVATION MATERIALS KEY: 1 Cement Panel System Colour: Sandstone

Colour: Sandstone

Running Bond Brick
Colour: Oatmeal

Fibre Cement Panel Colour: Dark Grey

4 Pre-finished Vertical Wood Siding

5 Soffits: T&G Wood

6 Glass Guards in Pre-finished Aluminum Frames

7 Glazed Canopies: Laminated Glazing on Painted Steel Structure

Colour: Iron / Ore

8 Prefinished Metal Parapet Flashing
Colour: Iron / Ore

9 Prefinished Metal Fascia Colour: Iron / Ore

Perforated Metal Balcony Guard
Colour: Iron / Ore

Painted Metal Pergolas and Gates
Colour: Iron / Ore

Window and Doors: Clear Glazing in Dark Anodized Aluminum Frames Colour: Iron / Ore

(13) Glass Walls and Guards w/ Aluminum Frame Colour: Iron / Ore

(14) Exposed Architectural Concrete

14) Exposed Architectural Concrete

Prefinished Metal Louvers Colour: Iron / Ore

Prefinished Metal Panel Colour: Iron / Ore

6 Rezoning/DP Resubmission 23.12.22
5 Rezoning/DP Resubmission 22.12.06
4 Issued for ADP 22.08.02
2 Issued for Rezoning / DP 21.12.15
rev no description date
copyright reserved, these drawings and designs are and at all times remain the property of d'ambrosio architecture to be used for the project shown and may not be reproduced without written consent.

project name

Montreal and Quebec
205 Quebec Street
Victoria, BC

sheet title

Building Section /
Elevations

project no. #21-18

scale 1:100


drawn by CF / RP / GK

date issued sheet no. 
12/06/22 A4.2


Mike Geric Construction

## Quebec & Montreal

Victoria, BC

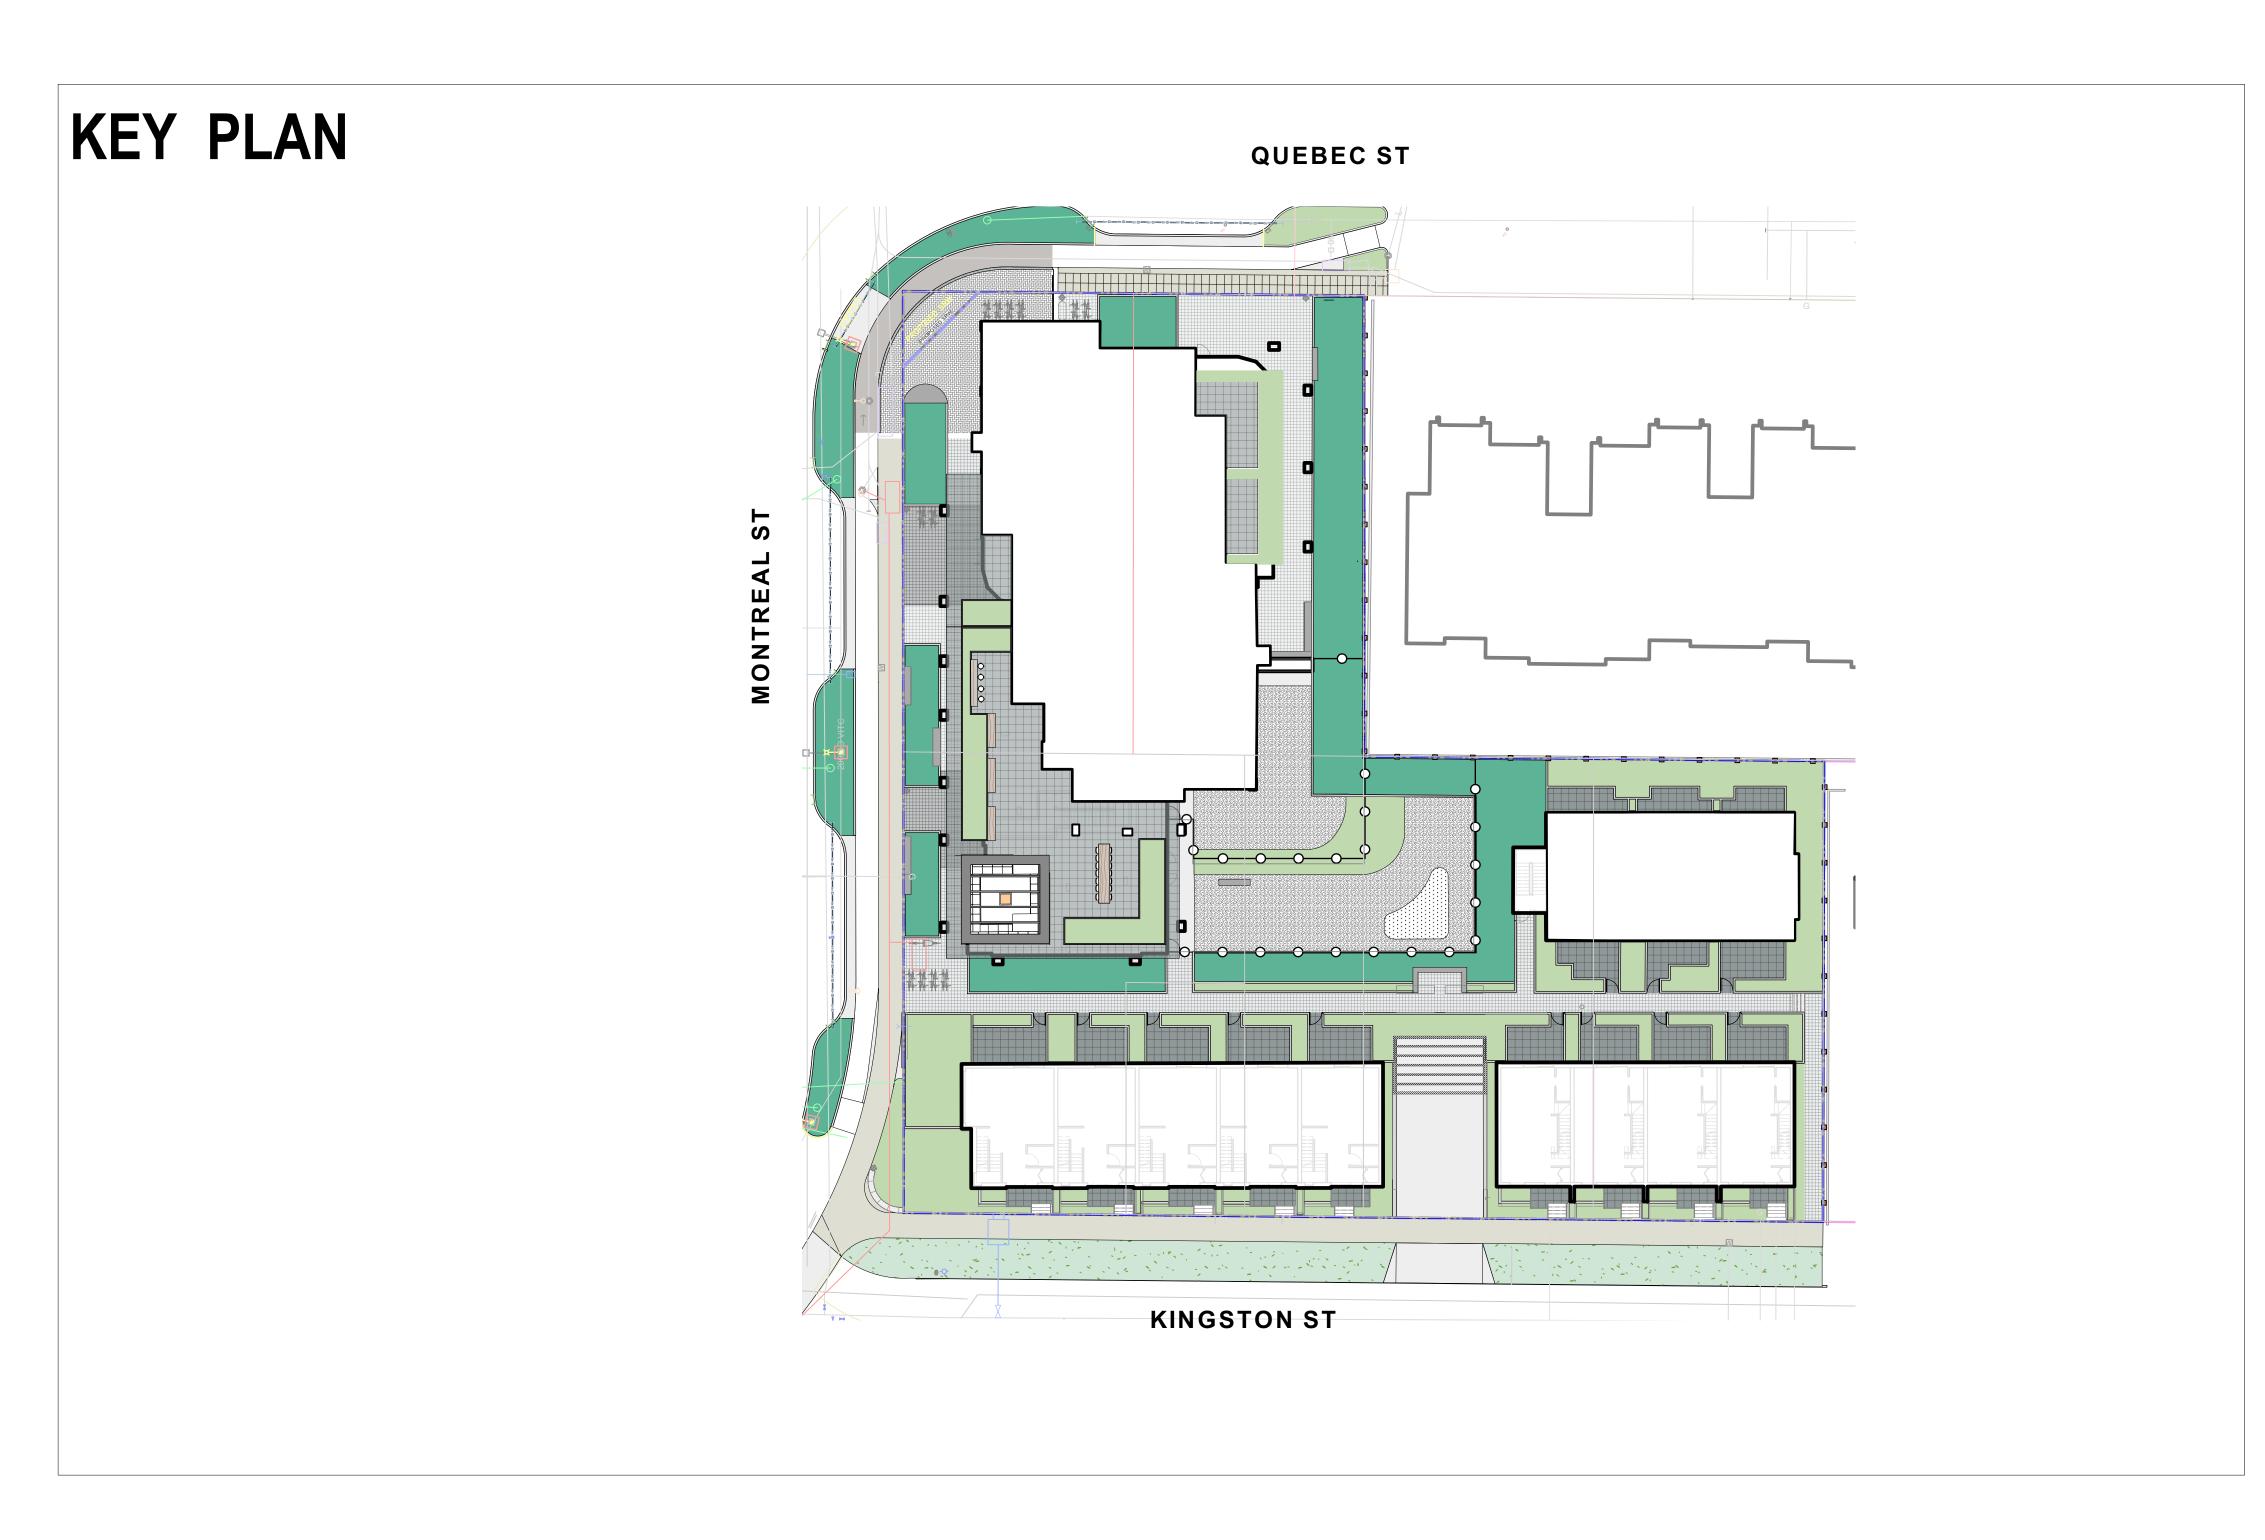

_andscape Sheets		
Sheet No.	Sheet Title	
L0.00	Cover	
L0.01	General Information Sheet	
L0.02	Tree Survey Plan	
L0.03	Tree Management Plan	
L1.01	Landscape Materials - Ground Level	
L1.02	Landscape Materials - Level 4	
L1.03	Stormwater Management & Grading	
L1.04	Landscape Precedents	
L1.05	Landscape Materials - Sections	
L1.06	Landscape Materials - Sections	
L1.07	Replacement Tree Plan	
L3.01	Planting Plan - Ground Level	
L3.02	Planting Plan - Level 4	
L4.01	Landscape Details	

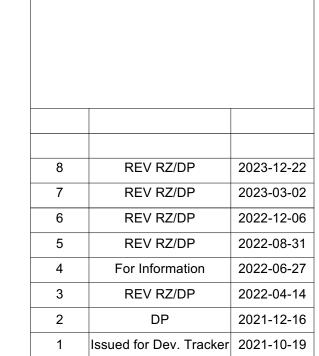



3388A Tennyson Av Victoria, BC V8Z 3F

2023-12-22

Mike Geric Construction 4520 West Saanich Rd Saanich, BC

project

QUEBEC & MONTREAL DEV. 501-502 MONTREAL ST. VICTORIA, BC

sheet title

Cover

project no.		121.23
scale	1: ###	@ 24"x36"
drawn by		MDI
checked by		SM
revison no.	sheet no.	
8		0.00

#### **GENERAL NOTES**

- 1. Work performed shall comply with the following: a) These General Notes, and Construction Documents and Specifications; b) Canadian Landscape Standards, Current Edition (CLS-CE); and c) All applicable local, provincial, and federal codes, ordinances, and regulations.
- 2. Contractor shall be responsible for verifying all existing site conditions including location of all property lines, existing structures, utilities, and buried infrastructure. Verify all field conditions prior to commencing work.
- 3. Contractor is responsible for determining means and methods for construction. These drawings may indicate a limit of proposed improvements or limit of work for the delineation of expected extents of disturbance. Should limits of disturbance exceed boundaries defined in drawings, contractor shall contact Landscape Architect for resolution.
- 4. Contractor is responsible for repairing all work disturbed by construction outside of limit lines defined on drawings or through their means and methods to a condition better than or equal to the existing conditions prior to commencement of construction at no additional cost to the owner.
- 5. Contractor is responsible for maintaining a complete up-to-date set of drawings and specifications at the construction site and ensuring the documents are readily available for review by the Landscape Architect and governing agency.
- 6. Contractor is responsible for coordination of all designs, drawings, specifications and other documents or publications upon which construction is based. Any discrepencies with the drawings and/or specifications and site conditions shall be brought to the attention of the Landscape Architect, prior to
- 7. The drawings and specifications are complementary to one another and implied to correspond with one another. Any discrepencies should be brought to the attention of the Landscape Architect for resolution immediately.
- 8. General Contractor and/or sub-contractors are responsible for all costs related to production and submission to consultant of all landscape as-built information including irrigation.

#### TREE RETENTION AND REMOVAL NOTES

- 1. Tree protection fencing, for existing trees, to be installed prior to commencement of all site work. Refer to Arborist's plans for location of tree protection fencing, and protection fencing detail.
- 2. Refer to arborist's report for detailed information for existing tree resources.

#### **SITE GRADING AND DRAINAGE NOTES**

- All elevations are in meters.
- 2. Refer to Architectural plans, sections and elevations for top of slab elevations. Slab elevations indicated on Landscape drawings are for reference only. Report any discrepancies to consultant for
- 3. All road, public walkway and vehicular drive aisles and parking area elevations indicated on the Landscape drawings are for reference only. Refer to Civil Engineering drawings. Report any discrepancies to consultant for review and response.
- 4. Confirm all existing grades prior to contruction. Report any discrepancies to consultant for review and
- Unless otherwise noted provide a minimum slope of 2% on all hard and soft Landscape areas to ensure positive drainage away from buildings, to rain gardens, or to drainage devices.
- 6. All landscape areas shall not exceed a maximum slope of 3:1 in all instances.
- 7. Upon discovery, contractor to refrain from blasting rock to meet landscape subgrades. Contractor to
- contact Landscape Architect on how to proceed in each instance.

#### IRRIGATION NOTES

- 1. Contractor to provide irrigation system for all planters to current IIABC Standards and Contract
- 2. All specified work to meet the project specifications, and all standards or specifications established in the lastest edition of the Canadian Landscape Standard and IIABC standards.
- 3. Design/build drawings for detailed irrigation plan to be submitted to Contract Administrator in PDF and .dwg formats at least two weeks prior to commencement of irrigation installation
- 4. Utilities Contractor to verify location of all on-site utilities, prior to construction. Restoration of damaged utilities shall be made at the contractor's expense, to the satisfaction of the owner's representatives.

#### 5. Refer to electrical drawings for electrical service.

- 6. Controller and backflow prevention device to be located in Mechanical Room, unless otherwise noted. Refer to Mechanical drawings for size and location of irrigation service.
- Contractor to verify pressure and flow prior to installation of irrigation and notify owner's representative in writing if such data adversely affects the operation of the system.
- 8. Sleeves shall be installed at the necessary depths, prior to pavement construction. Sleeving shall extend 300 mm from edge of paving into planting area, and shall have ends marked above grade
- unless otherwise shown. Contractor to field fit irrigation system around existing trees, to limit disturbance to root systems. 10. At various milestones during construction, inspection and testing of components will be required to ensure that the performance of irrigation system meets standards and specifications. Contractor to provide equipment and personnel necessary for performance of inspections and tests. Conduct all
- accessible until successful completeition of inspection or test. 11. Over spray onto hardscape areas to be minimized. Use drip irrigation within small planting areas to

inspections and tests in the presence of the contract administrator. Keep work uncovered and

- avoid overspray. 12. Trees within shrub or rain garden areas to be irrigated with spray heads.
- 13. Trees in Plaza in hard pavement (soil cells below) to recieve temporary irrigation system around root collar and permanent drip irrigation system
- 14. Irrigation design shall be submitted for review and approval to City of Victoria Parks no less than 30
- days prior to scheduled installation. 15. Irrigation Inspections: required for all sleeving, open trench mainline and lateral lines, system
- operation, controller, backflow preventer (incl. inspection tag and testing report). Call CoV Parks 250-361-0600 min. 2 days in advance to arrange for irrigation inspections.

#### **GROWING MEDIUM NOTES**

- 1. Refer to Landscape Specifications for growing medium properties by soil type.
- 2. Advise Contract Administrator of sources of growing medium to be utilized 14 days in advance of
- Growing medium properties and handling shall meet CLS-CE (see Section 6 CLS-CE).
- Contractor is responsible for soil analysis and amendment requirements to supply suitable growing medium, as specified by testing agency. Soil analysis and amendment costs shall be included in the price for the work.
- 5. Submit to the Landscape Architect a copy of the soil analysis report from Pacific Soil Analysis Inc. 5-11720 Voyageur Way, Richmond, BC, V6X 3G9. p. 604- 273-8226. The analysis shall be of tests done on the proposed growing medium from stratified samples taken from the supply source. Costs of the initial and all subsequent tests to ensure compliance with the specifications shall be borne by the Contractor.
- 6. Contract Administrator will collect sample of growing medium in place and determine acceptance of material, depth of growing medium and finish grading. Approval of growing medium material subject to soil testing and analysis. Planting is not to occur until finished grades have been approved by Contract Administrator.

#### **SITE LAYOUT NOTES**

- 1. Provide layout of all work for approval by Contract Administrator prior to proceeding with work. Requests for site review as required 48 hours in advance of performing any work, unless otherwise
- 2. Layout and verify dimensions prior to construction. Bring discrepancies to the attention of the Contract
- 3. Written dimensions take precedence over scale. Do not scale drawings.
- 4. All plan dimensions in metres and all detail dimensions in millimetres, unless otherwise noted.
- 5. Where dimensions are called as 'equal' or 'eq', space referenced items equally, measured to centre

#### **GENERAL PLANTING NOTES**

- 1. Plant quantities on Plans shall take precedence over plant list quantities.
- 2. Provide layout of all work for approval by Contract Administrator prior to proceeding with work. 3. Plant material, installation and maintenance to conform to the current edition of the Canadian Landscape Standard.
- 4. Plant quantities and species may change between issuance of DP and Construction due to plant availability and design changes.
- 5. Landscape installation to carry a 1 year warranty from date of acceptance. This warranty is based on adequate maintenance by the Owner after Acceptance. The Contractor will not be responsible for plant loss due to extreme climatic conditions such as abnormal freezing temperatures or hail which occur after Acceptance. The Contractor shall be responsible for plant loss due to inadequate acclimatization of plants for their planted location.

#### **ON-SLAB TREE PLANTING NOTES**

- 1. For on-slab landscape, a root barrier will be installed to protect exposed water proof membranes. A dimple board (drain mat) will be installed over the root barrier.
- 2. Parkade walls and foundation walls will be protected with a dimple board (drain mat) to convey water to the perimeter drain and protect wall from roots.
- 3. A root barrier will be installed between the tree roots and perimeter drain, to minimize tree root interference with the drain, where the follow conditions exist in on-grade planting areas: a)where trees less than 8m tall are located closer than 2m from a parkade or foundation wall; b) where trees more than 8m tall are located closer than 3m from a parkade or foundation wall; and c) where perimeter drains are less than 2m deep.

#### **BOULEVARD PLANTING NOTES**

- 1. Boulevard trees have been placed to avoid existing and proposed infrastructure. Trees planted within 1m of an existing underground municipal service will have a root barrier installed between the root ball and the existing infrastructure.
- 2. Boulevard trees will be place a minimum of 1.5m from an above ground municipal service such as fire hydrant, streetlight or driveway.
- 3. Boulevard tree species have been picked from the municipality's list of recommended boulevard trees or have been selected due their site-adapted qualities. Final selection of boulevard trees to be determined through consultation with municipal parks staff.
- 4. Irrigation to be installed as per Municipal Specifications, for all boulevard planting areas (unless otherwise indicated).
- 5. Design/build drawings for boulevard irrigation to be submitted to Contract Administrator in PDF and .dwg formats, at least two weeks prior to commencement of irrigation installation and will be reviewed
- 6. Refer to Civil drawings for location of boulevard irrigation point of connection. Separate water meter and timer/controller, to be provided at point of connection. Timer/controller for boulevard areas must be readily accessible to municipal staff.
- Boulevard irrigation to be inspected as per municipal specification by municipal staff. Boulevard tree irrigation system will be maintained and operated by municipality, after it is inspected and approved by
- 8. Soil volume for boulevard trees to be as follows: 8 cu. m. for small trees, 12 cu. m. for medium trees, and 16 cu. m. for large trees.

#### **OFF-SITE IRRIGATION**

- 1. Irrigation drawings must be submitted to Parks Division for review and approval 30 days prior to
- 2. Irrigation Systems on City Property shall comply to City of Victoria Supplementary Specifications for Street Trees and Irrigation Schedule C, Bylaw 12-042, Subdivision Bylaw.
- 3. The following irrigation and sleeving inspections by Parks Staff are required by Schedule C. Please contact Tom Sherbo, tsherbo@victoria.ca and copy treepermits@victoria.ca 48 hours prior to the
  - required inspection time to schedule an inspection.
  - (1) Irrigation sleeving prior to backfilling
  - (2) Open trench main line and pressure test
  - (3) Open trench lateral line
  - (4) irrigation system, controller, coverage test, backflow preventer assembly test report required, backflow assembly is to have an inspection tag completed and attached.

#### **OFF-SITE HORTICULTURE INSPECTIONS REQUIRED**

- 1. The following inspections are required for all off-site horticulture areas:
  - (1) Excavated and scarified subgrade prior to placement of growing media.
  - (2) Installed and prepared growing media prior to planting.
  - (3) Plant material on-site prior to planting. (4) Planted landscape prior to mulch installation.
  - (5) At time that planted and mulched landscape meets the conditions for Total Performance as required by MMCD.

#### **LIST OF ABBREVIATIONS**

JOINT

INCLUDE(D)

LINEAR FEET

LOW POINT

INCL

FIST OF ADI	DIVE VIA HONO		METRE
		M	METRE
APPROX	APPROXIMATE	MAX	MAXIMUM
		MH	MANHOLE
ARCH	ARCHITECT	MIN	MINIMUM
AVG	AVERAGE	MISC	MISCELLANEOUS
B&B	BALLED AND BURLAPPED	MM	MILLIMETRE
BC	BOTTOM OF CURB		
BLDG	BUILDING	N	NORTH
BM	BENCHMARK	NIC	NOT IN CONTRACT
		NO	NUMBER
BC	BOTTOM OF CURB	NOM	NOMINAL
BR	BOTTOM OF RAMP	NTS	NOT TO SCALE
BS	BOTTOM OF STEP	OC	ON CENTER
BW	BOTTOM OF WALL	OD	OUTSIDE DIAMETER
CAL	CALIPER		
СВ	CATCH BASIN	PC	POINT OF CURVATURE
CF	CUBIC FEET	PE	POLYURETHANE
		PI	POINT OF INTERSECTION
CIP	CAST IN PLACE	PL	PROPERTY LINE
CL	CENTER LINE	PT	POINT, POINT OF TANGENCY
CLR	CLEARANCE	PVC	POLYVINYL CHLORIDE
CM	CENTIMETER		
CO	CLEAN OUT	QTY	QUANTITY
CONT	CONTINUOUS	R	RADIUS
CU M	CUBIC METRE	REF	REFERENCE
		REINF	REINFORCE(D)
DEG	DEGREE	REQ'D	REQUIRE(D)
DEMO	DEMOLISH, DEMOLITION	REV	REVISION
DIA	DIAMETER	ROW	RIGHT OF WAY
DIM	DIMENSION		
DTL	DETAIL	S	SOUTH
DWG	DRAWING	SAN	SANITARY
		SD	STORM DRAIN
E	EAST	SF	SQUARE FOOT (FEET)
EA	EACH	SHT	SHEET
EL	ELEVATION	SIM	SIMILAR
ENG	ENGINEER	SPECS	SPECIFICATIONS
EQ	EQUAL		
EST	ESTIMATE	SQ M	SQUARE METRE
E.W.	EACH WAY	ST	STORM SEWER
EXIST	EXISTING	STA	STATION
		STD	STANDARD
EXP	EXPANSION, EXPOSED	SYM	SYMMETRICAL
FFE	FINISHED FLOOR ELEVATION	T&B	TOP AND BOTTOM
FG	FINISHED GRADE	TC	TOP OF CURB
FL	FLOW LINE	TF	
FOC	FACE OF CURB		TOP OF FOOTING
FT	FOOT (FEET)	TH	THICK
FTG	FOOTING	TOPO	TOPOGRAPHY
		TR	TOP OF RAMP
GA	GAUGE	TS	TOP OF STEP
GEN	GENERAL	TW	TOP OF WALL
GR	GRADE ELEVATION	TYP	TYPICAL
HORIZ	HORIZONTAL	VAR	
HP	HIGH POINT		VARIES
HT	HEIGHT	VOL	VOLUME
		W	WITH
ID	INSIDE DIAMETER	W/O	WITHOUT
INV	INVERT ELEVATION	WT	WEIGHT
IN	INCH(FS)	140	14/4 TED 1 E1/E1

WL

WWF

ΥD

WATER LEVEL

YARD

ΑT

WELDED WIRE FRAME

#### MATERIALS LEGEND

#### **HARDSCAPE** $\langle 1.0 \rangle$



CIP Concrete Light Broom Finish with Tooled Control Joints. Colour: Natural.

**CIP Concrete** Light Broom Finish with Radial Control Joints. Colour: Natural

Standard Paver 8x8 tile pattern, colour Natural

Standard Paver 8x8 tile pattern, colour Charcoal

Patio

'Texada' Hydrapressed Slabs. 457 mm x 457 mm x40 mm. Charcoal colour. Square Grid. Supplier: Abbotsford Concrete. Nonpermeable.

#### HARDSCAPE: CITY STANDARDS

See 'Downtown Public Realm Plan & StreetScape Standards', Section 5.1.1 Inner Harbour, for details.

Trowel Joint Concrete. See L4.01 For Pattern Details

**Granite Pavers** 

@ 300mm x 100mm x 80mm. Mortar set. Paving field. Grey granite Flamed Finish. Nonpermeable.

All caps, Finish Flamed

**Grey Basalt Entry Band** Sandblasted Street name insert. 450mm width, Font Tisa Bro Bold -

**Granite Pavers** 

Solider Course Border 200mm Granite Pavers DAYCARE Design TBD by imput from Daycare provider

Sand

1.9


Safety Surfacing

 $\langle 3.0 \rangle$ WALLS Concrete Retaining Wall Concrete Bench

## **FURNISHINGS**

4.1

4.3

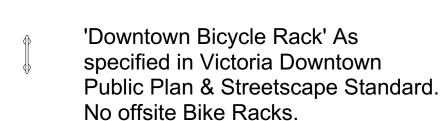

Concrete Curb - See Civil.

Fire pit

Trash Bin

Benches

Shed. See Architecture

## **FENCES AND BARRIERS**

1800mm Wood Fence

See Arch and Electrical

Picket Fence

**PLANTING AREAS** 

Shrub Area Rain Garden (See Dwg 1 L1.03 & 4.01)

#### LINE TYPE LEGEND

Property line Extent of Parkade, below Pedestrian Sightline

#### **UNDERGROUND UTILITIES**

(Shown for reference only - refer to Civil Engineer's drawings).

Civil Typical Inlet Drain

#### **GRADING LEGEND**

Existing Landscape Grade Civil Grade, provided for reference only



Architectural grade, provided for reference only Proposed Landscape Grade TOW Top of Wall BP Bottom of Pool BW Bottom of Wall TS Top of Stairs TOC Top of Curb BS Bottom of Stairs

BC Bottom of Curb

TP Top of Pool

#### **IRRIGATION LEGEND**



**Irrigation Point of Connection** Proposed Irrigation Point of Connection. Provide water service and electrical service from irrigation controller to valves.


HP High Point

LP Low Point

— Irr SI — Irr SI —

**Irrigation Sleeve** Schedule 40 PVC, dia. shall be min 3x main line diameter, or 2x lateral line diameter. Install irrigation wiring in separate 2" electrical conduit. Extend sleeve 300 mm past edge of hard surface or walls.

#### LANDSCAPE DRAINAGE LEGEND

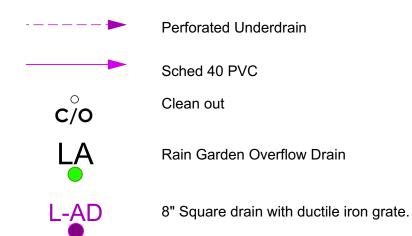



#### DRAINS BY OTHERS

Mechanical Drains ( For reference only)

Aco K100 Trench Drain, Load Class 'A'.

Trench Drain

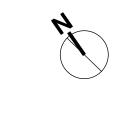

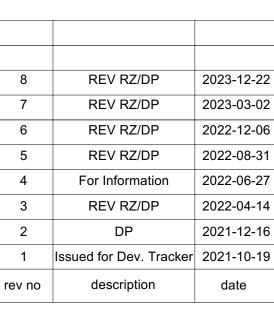



2023-12-22

Mike Geric Construction 4520 West Saanich Rd Saanich, BC

QUEBEC & MONTREAL DEV. 501-502 MONTREAL ST. VICTORIA, BC


**General Information** Sheet


sheet title

/8\


121.23 project no. scale NA @ 24"x36" MDI drawn by checked by revison no. sheet no.

L0.01

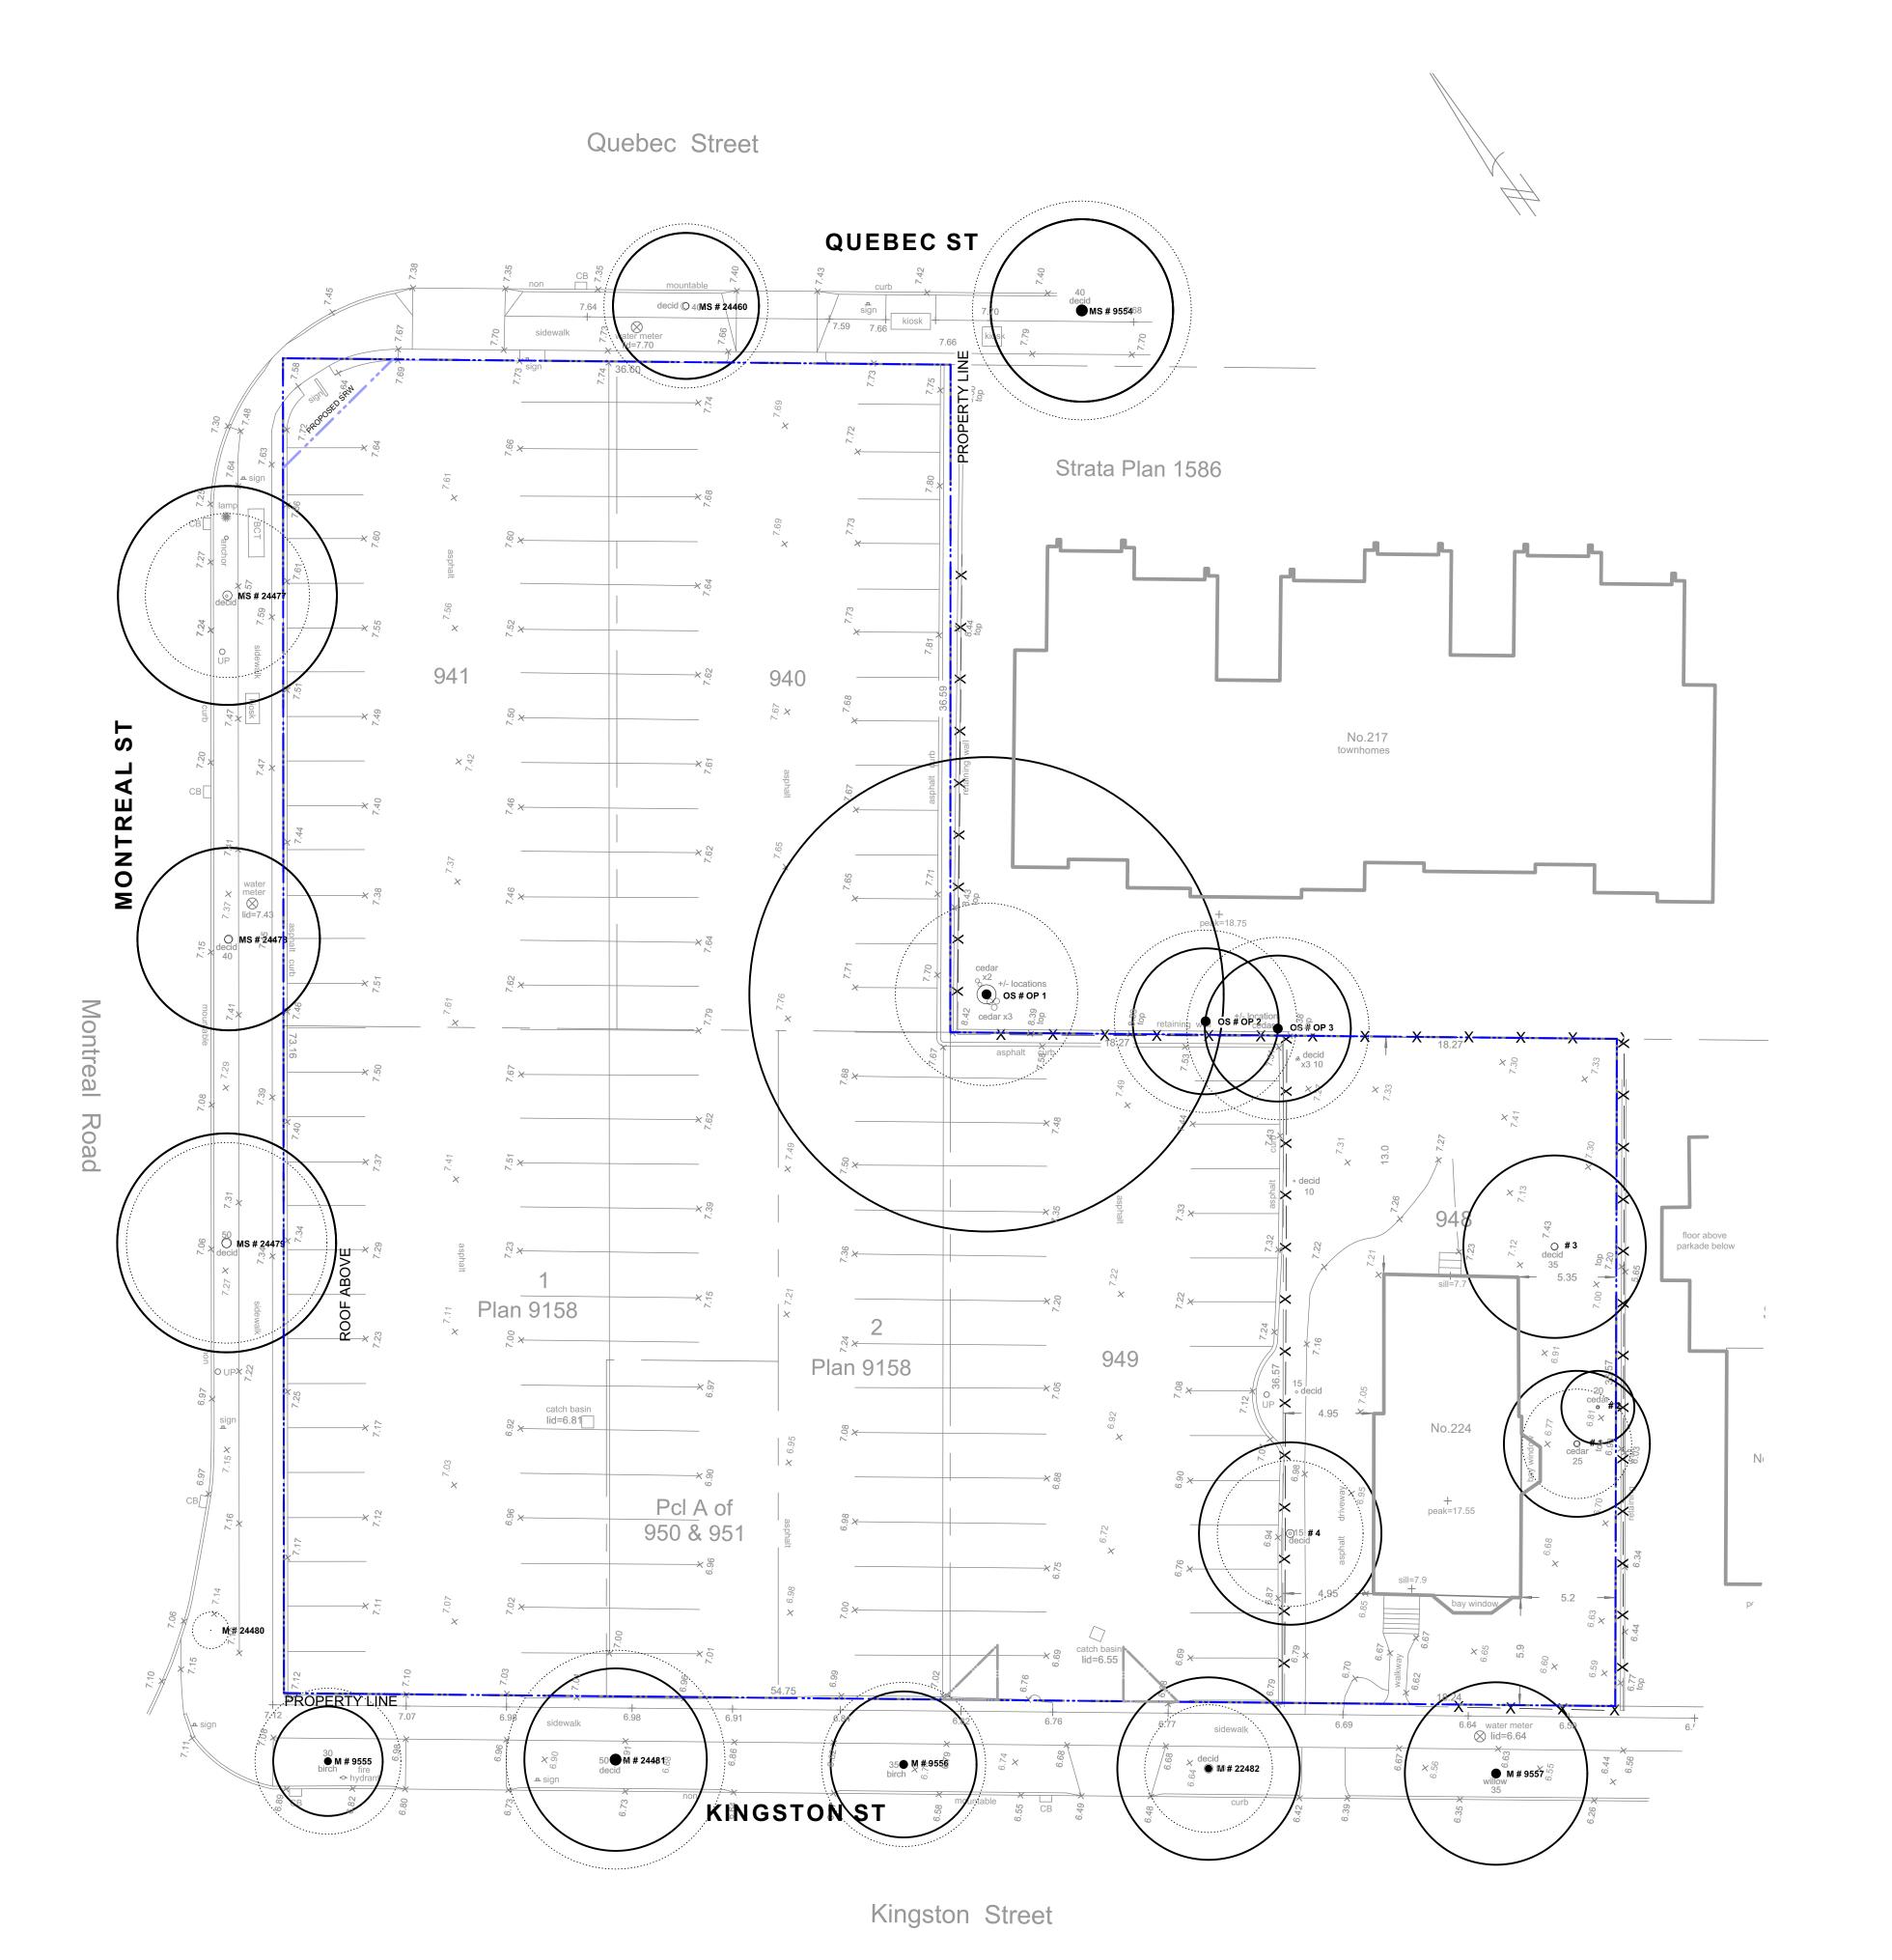

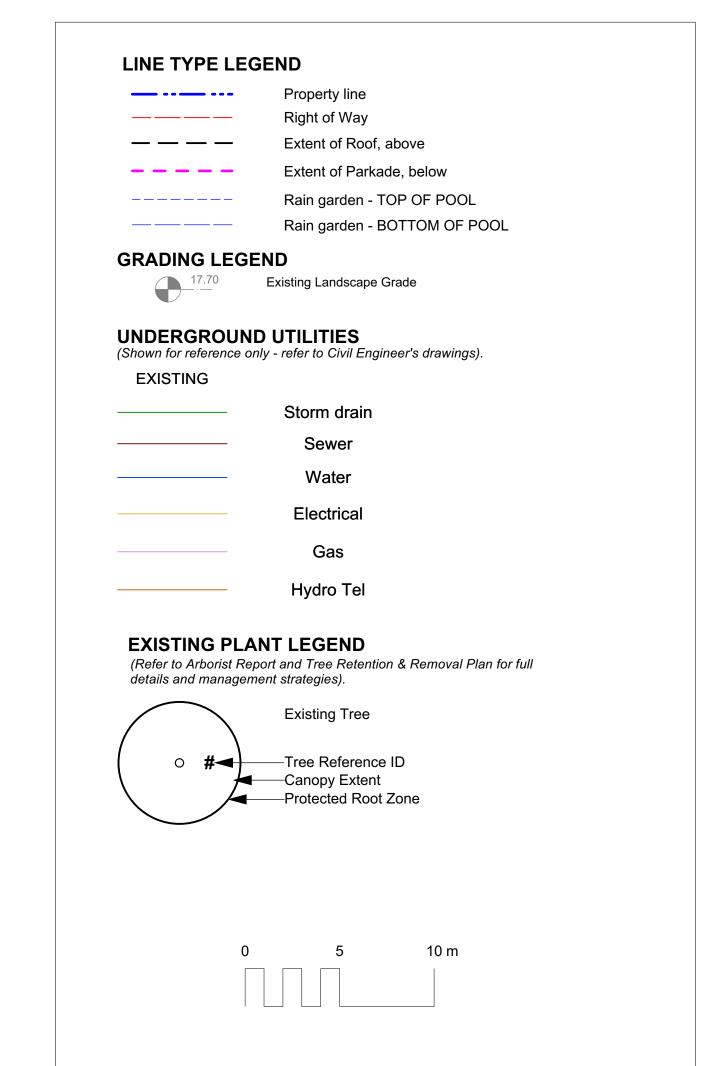

TREE TAG#	DBH (cm)	CRZ	Species	Crown Spread (m)	Heigh (m)
9555	27	3	Betula papyrifera	8	9
24481	39	5	Prunus cerasifera	12	9
24482	38	5	Prunus cerasifera	7	9
9557	39	4	Betula pendula	10	11
9554	42	5	Aesculus carnea	12	9
Op1	105	12	Thuja plicata	10	14
Op2	35	4	Cedrus dreadar	9	18
Op3	35	4	Sequoiadendron giganteum	9	10
	0.4	4	Betula papyrifera	9	10
2556  FOTAL TREES  REMOVED TR  TREE TAG #		4 AINED:		Crown Spread (m)	
TOTAL TREES REMOVED TR	<b>S TO BE RET</b> EES		: 9	Crown	Heigh
TOTAL TREES REMOVED TR TREE TAG#	S TO BE RET EES DBH (cm)		Species	Crown Spread (m)	Heigh (m)
TOTAL TREES REMOVED TR TREE TAG # 24460	S TO BE RET EES DBH (cm) 35		Species Sorbus intermedia	Crown Spread (m)	<b>Heigh</b> ( <b>m)</b> 0
TOTAL TREES REMOVED TR TREE TAG # 24460 24480	EES  DBH (cm) 35 3		Species Sorbus intermedia Prunus sargentii	Crown Spread (m) 9 1	Heigh (m) 0 3
TOTAL TREES REMOVED TR TREE TAG # 24460 24480 24479	<b>TO BE RET</b> EES <b>DBH (cm)</b> 35 3 53		Species Sorbus intermedia Prunus sargentii Prunus cerasifera	Crown Spread (m) 9 1 11	Heigh (m) 0 3 8
TOTAL TREES REMOVED TR TREE TAG # 24460 24480 24479 24478	S TO BE RET EES  DBH (cm)  35  3  53  44		Species Sorbus intermedia Prunus sargentii Prunus cerasifera Prunus cerasifera	Crown Spread (m) 9 1 11 10	Heigh (m) 0 3 8
TOTAL TREES REMOVED TR TREE TAG # 24460 24480 24479 24478 24477	TO BE RET EES  DBH (cm) 35 3 53 44 50		Species Sorbus intermedia Prunus sargentii Prunus cerasifera Prunus cerasifera Prunus cerasifera	Crown Spread (m) 9 1 11 10 9	Heigh (m) 0 3 8 8
TOTAL TREES REMOVED TR  TREE TAG #  24460 24480 24479 24478 24477 1	5 TO BE RET EES  DBH (cm) 35 3 53 44 50 35		Species Sorbus intermedia Prunus sargentii Prunus cerasifera Prunus cerasifera Prunus cerasifera Prunus cerasifera Thuja plicata smaragd	Crown Spread (m)  9 1 11 10 9 3	Heigh (m) 0 3 8 8 8
TOTAL TREES REMOVED TR  TREE TAG #  24460 24480 24479 24478 24477 1 2	TO BE RET EES  DBH (cm) 35 3 53 44 50 35 14		Species Sorbus intermedia Prunus sargentii Prunus cerasifera Prunus cerasifera Prunus cerasifera Prunus cerasifera Thuja plicata smaragd Thuja plicata smaragd	Crown Spread (m)  9  1  11  10  9  3  2	Heigh (m) 0 3 8 8 8 6 6

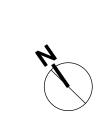



3	REV RZ/DP	2023-12-22
•	REV RZ/DP	2023-03-02
6	REV RZ/DP	2022-12-06
5	REV RZ/DP	2022-08-31
	For Information	2022-06-27
3	REV RZ/DP	2022-04-14
2	DP	2021-12-16
	Issued for Dev. Tracker	2021-10-19
no	description	date
	MI	DI

Landscape Architects

2023-12-22


Mike Geric Construction 4520 West Saanich Rd Saanich, BC


project
QUEBEC & MONTREAL DEV.
501-502 MONTREAL ST.
VICTORIA, BC

sheet title

Tree Survey Plan

project no.		121.23
scale	1: 200	@ 24"x36
drawn by		MDI
checked by		SM
revison no.	sheet no.	
8	L	.0.02

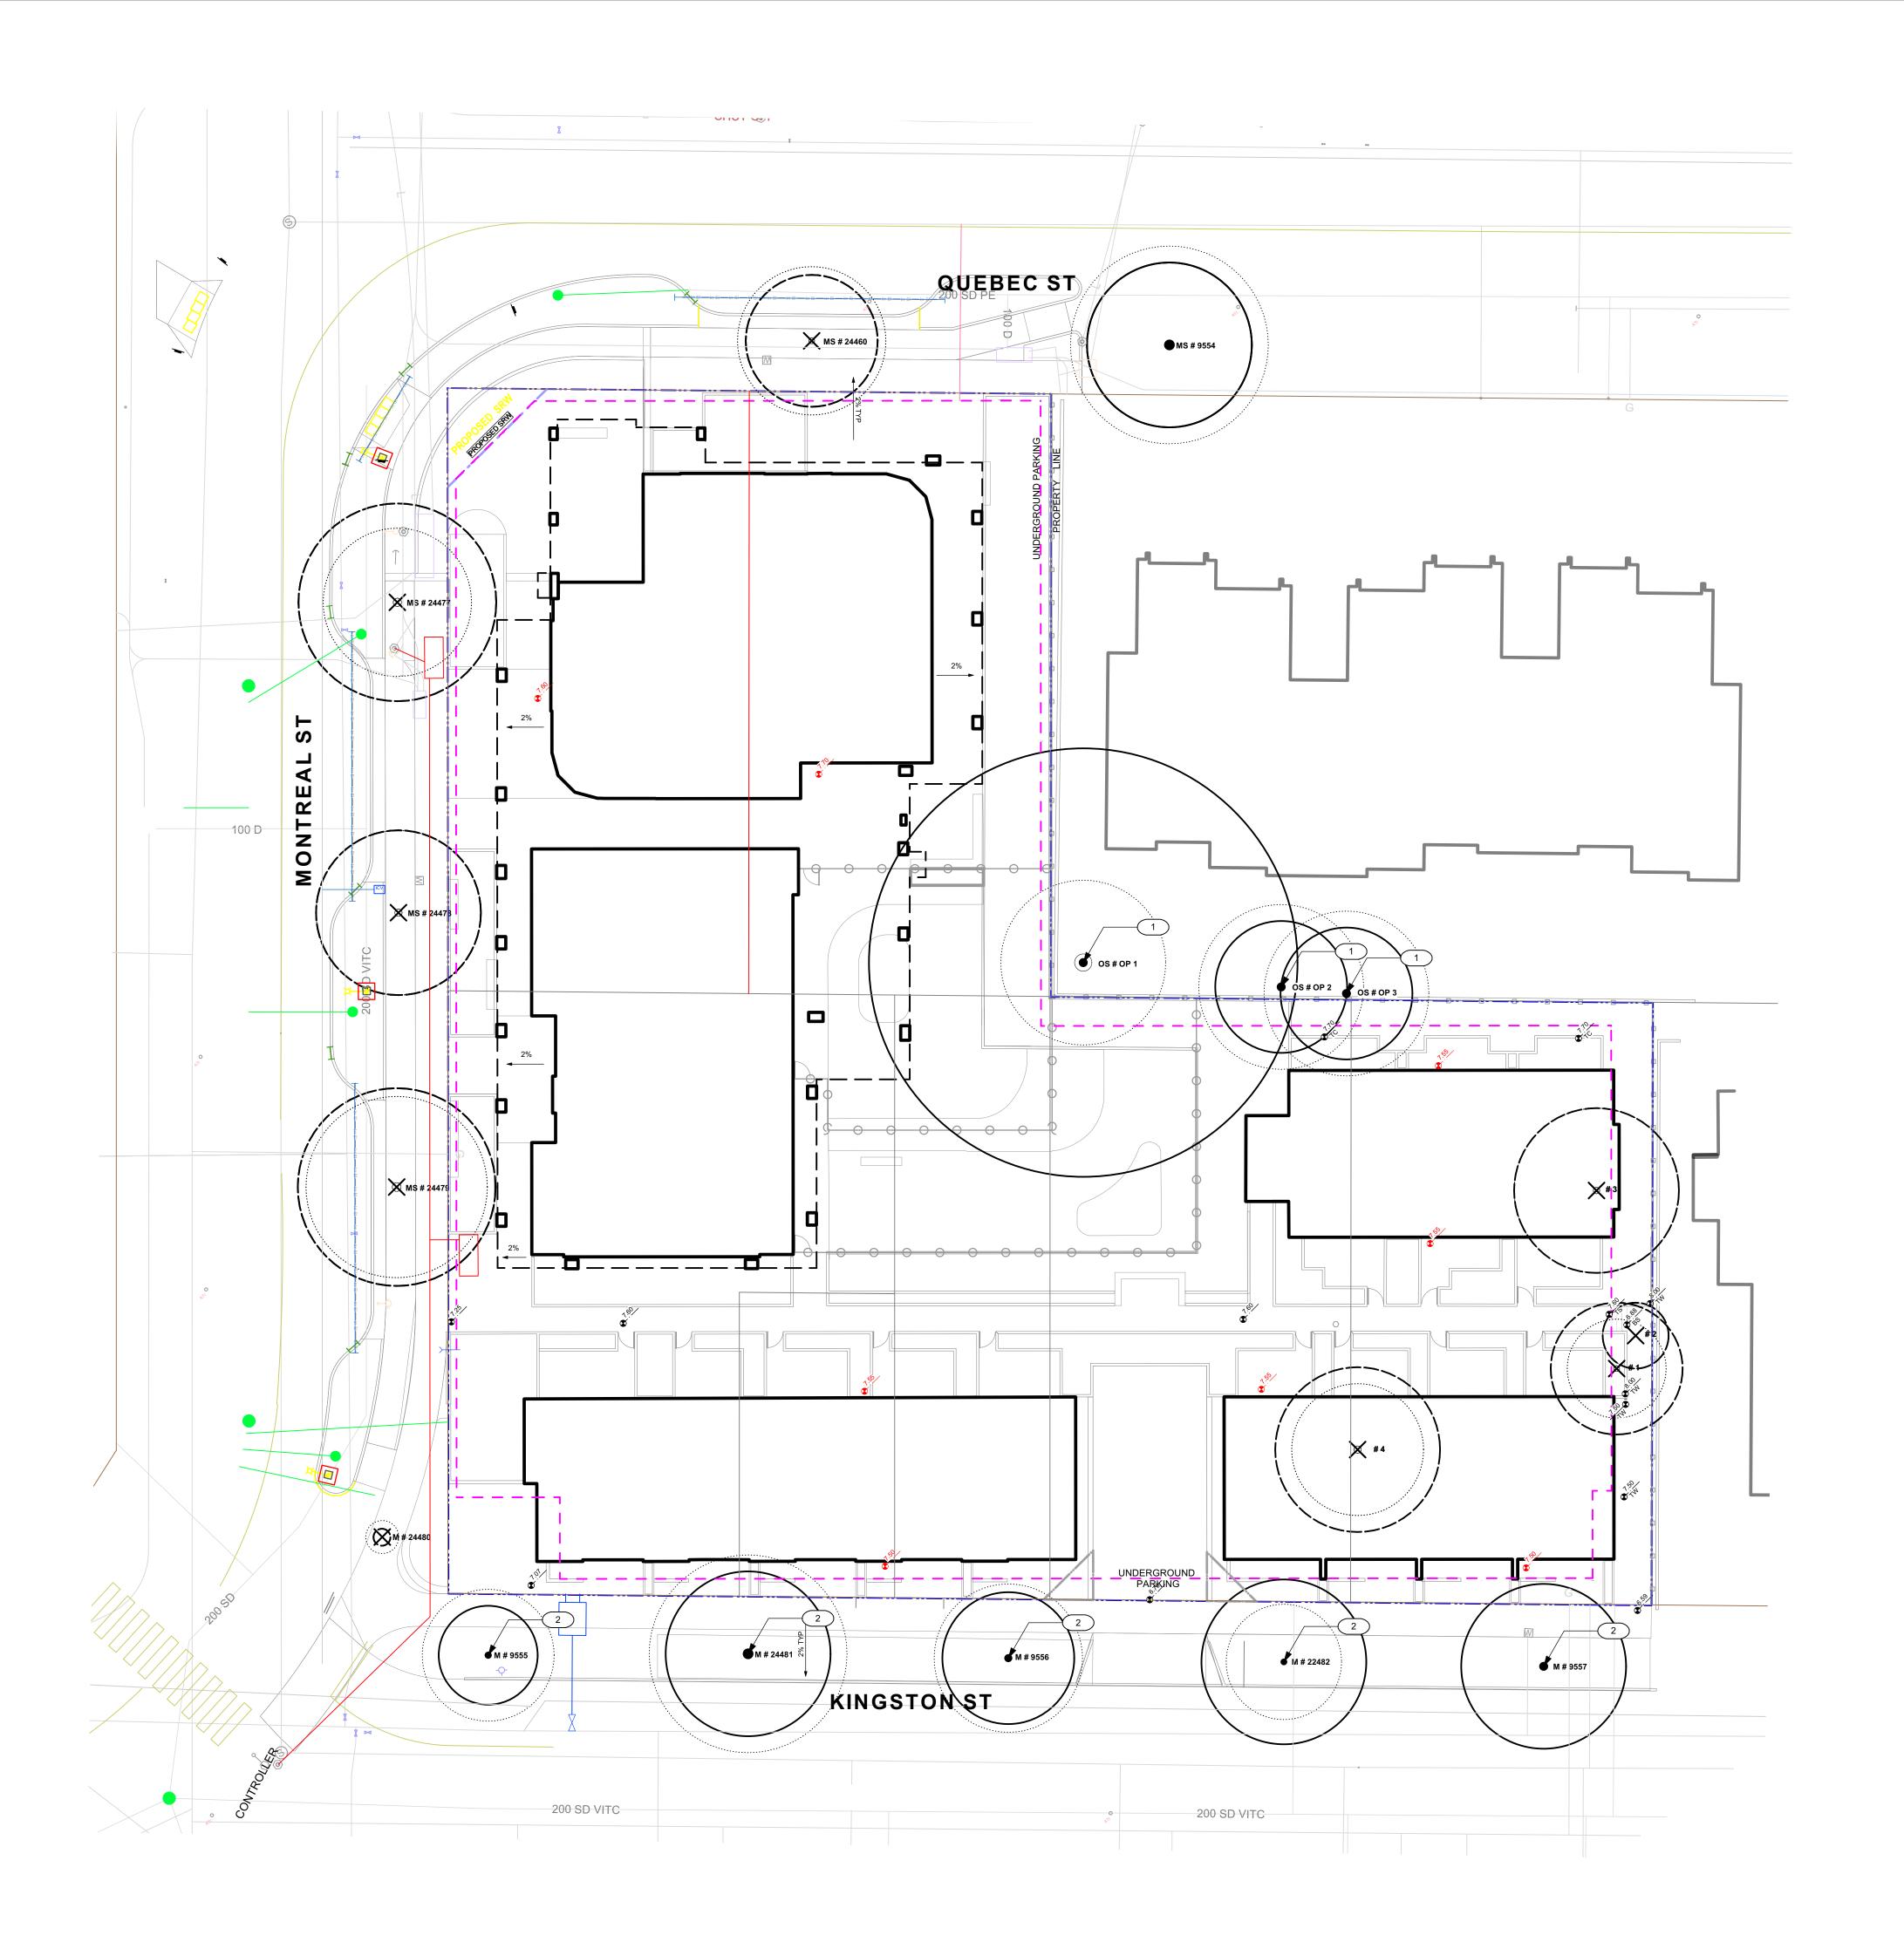

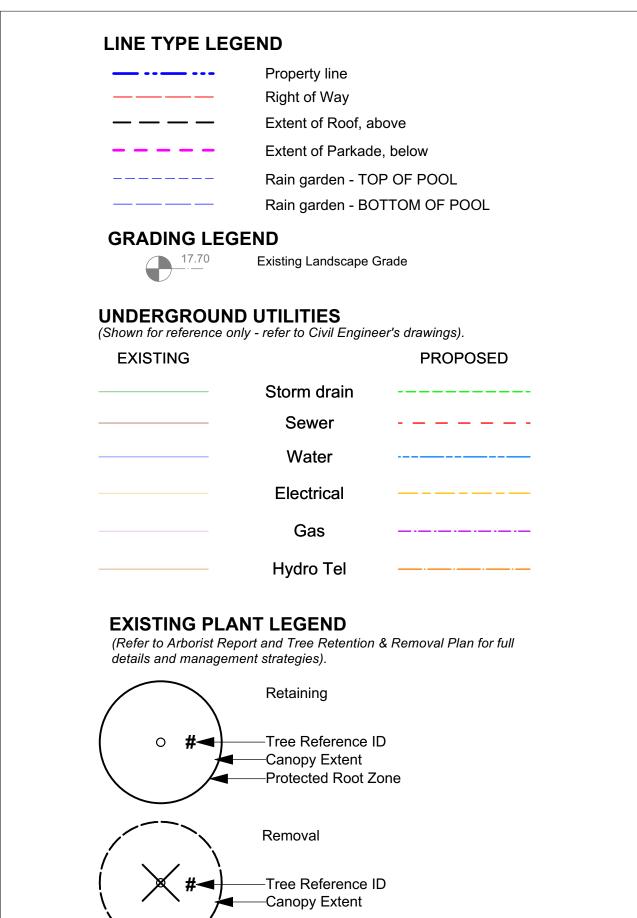


RETAINED TR	EES			Crown	Height
TREE TAG#	DBH (cm)	CRZ	Species	Spread (m)	(m)
9555	27	3	Betula papyrifera	8	9
24481	39	5	Prunus cerasifera	12	9
24482	38	5	Prunus cerasifera	7	9
9557	39	4	Betula pendula	10	11
9554	42	5	Aesculus carnea	12	9
Op1	105	12	Thuja plicata	10	14
Op2	35	4	Cedrus dreadar	9	18
Op3	35	4	Sequoiadendron giganteum	9	10
2556	34	4	Betula papyrifera	9	10
REMOVED TR		AINED		Crown	Height
REMOVED TR	EES	AINED			_
REMOVED TR	_	AINED	Species Sorbus intermedia	Crown Spread (m)	Height (m)
REMOVED TR	DBH (cm)	AINED	Species	Spread (m)	(m)
REMOVED TR TREE TAG # 24460	DBH (cm)	AINED:	Species Sorbus intermedia	Spread (m) 9	<b>(m)</b>
REMOVED TR TREE TAG # 24460 24480	DBH (cm) 35 3	AINED	Species Sorbus intermedia Prunus sargentii	<b>Spread (m)</b> 9 1	( <b>m</b> ) 0 3
REMOVED TR TREE TAG # 24460 24480 24479	DBH (cm) 35 3 53	AINED	Species Sorbus intermedia Prunus sargentii Prunus cerasifera	<b>Spread (m)</b> 9 1 11	(m) 0 3 8
REMOVED TR  TREE TAG #  24460  24480  24479  24478	DBH (cm) 35 3 53 44	AINED	Species Sorbus intermedia Prunus sargentii Prunus cerasifera Prunus cerasifera	<b>Spread (m)</b> 9 1 11 10	(m) 0 3 8 8
REMOVED TR  TREE TAG #  24460  24480  24479  24478  24477	DBH (cm) 35 3 53 44 50	AINED	Species Sorbus intermedia Prunus sargentii Prunus cerasifera Prunus cerasifera Prunus cerasifera	9 1 11 10 9	(m) 0 3 8 8
REMOVED TR  TREE TAG #  24460  24480  24479  24478  24477  1	DBH (cm) 35 3 53 44 50 35	AINED	Species Sorbus intermedia Prunus sargentii Prunus cerasifera Prunus cerasifera Prunus cerasifera Thuja plicata smaragd	9 1 11 10 9 3	(m) 0 3 8 8 8
REMOVED TR  TREE TAG #  24460 24480 24479 24478 24477 1 2	DBH (cm) 35 3 53 44 50 35 14	AINED	Species Sorbus intermedia Prunus sargentii Prunus cerasifera Prunus cerasifera Prunus cerasifera Prunus cerasifera Thuja plicata smaragd Thuja plicata smaragd	9 1 11 10 9 3 2	(m) 0 3 8 8 8 6 6

Requires onsite supervision of trees during excavation

Potentially impacted by site serving and grading

REFERENCE NOTES

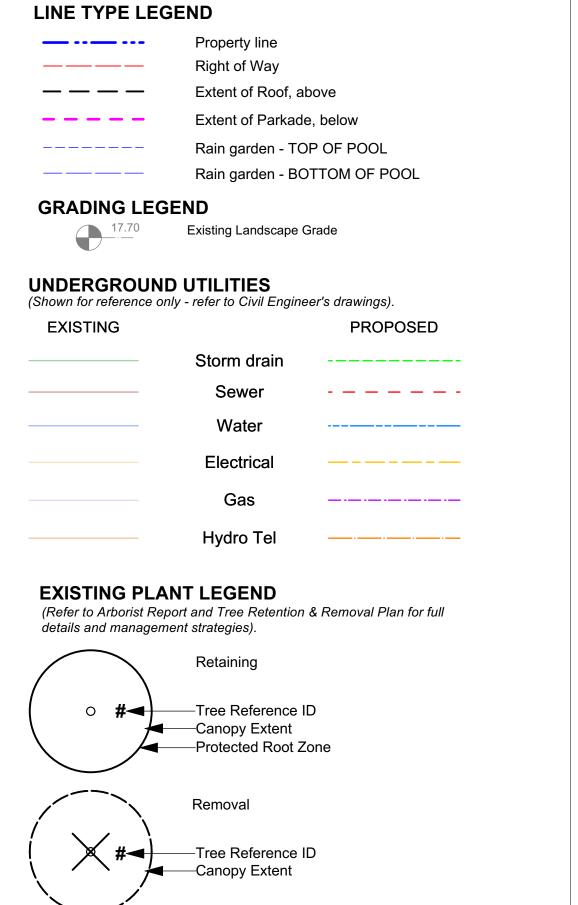



REV RZ/DP

REV RZ/DP

REV RZ/DP

REV RZ/DP For Information 2023-12-22

2023-03-02

2022-12-06 2022-08-31

2022-06-27

D. Clark Arboriculture
2741 The Rise Victoria B.C. V8T-3T4
(250)474-1552 (250)208-1568
clarkarbor@gmail.com
www.dclarkarboriculture.com

Certified Arborist PN-6523A

2023-12-22


Mike Geric Construction 4520 West Saanich Rd Saanich, BC

QUEBEC & MONTREAL DEV. 501-502 MONTREAL ST. VICTORIA, BC

sheet title

Tree Management Plan

project no.		121.23
scale	1: 200	@ 24"x36"
drawn by		MDI
checked by		SM
revison no.	sheet no.	
8		0.03

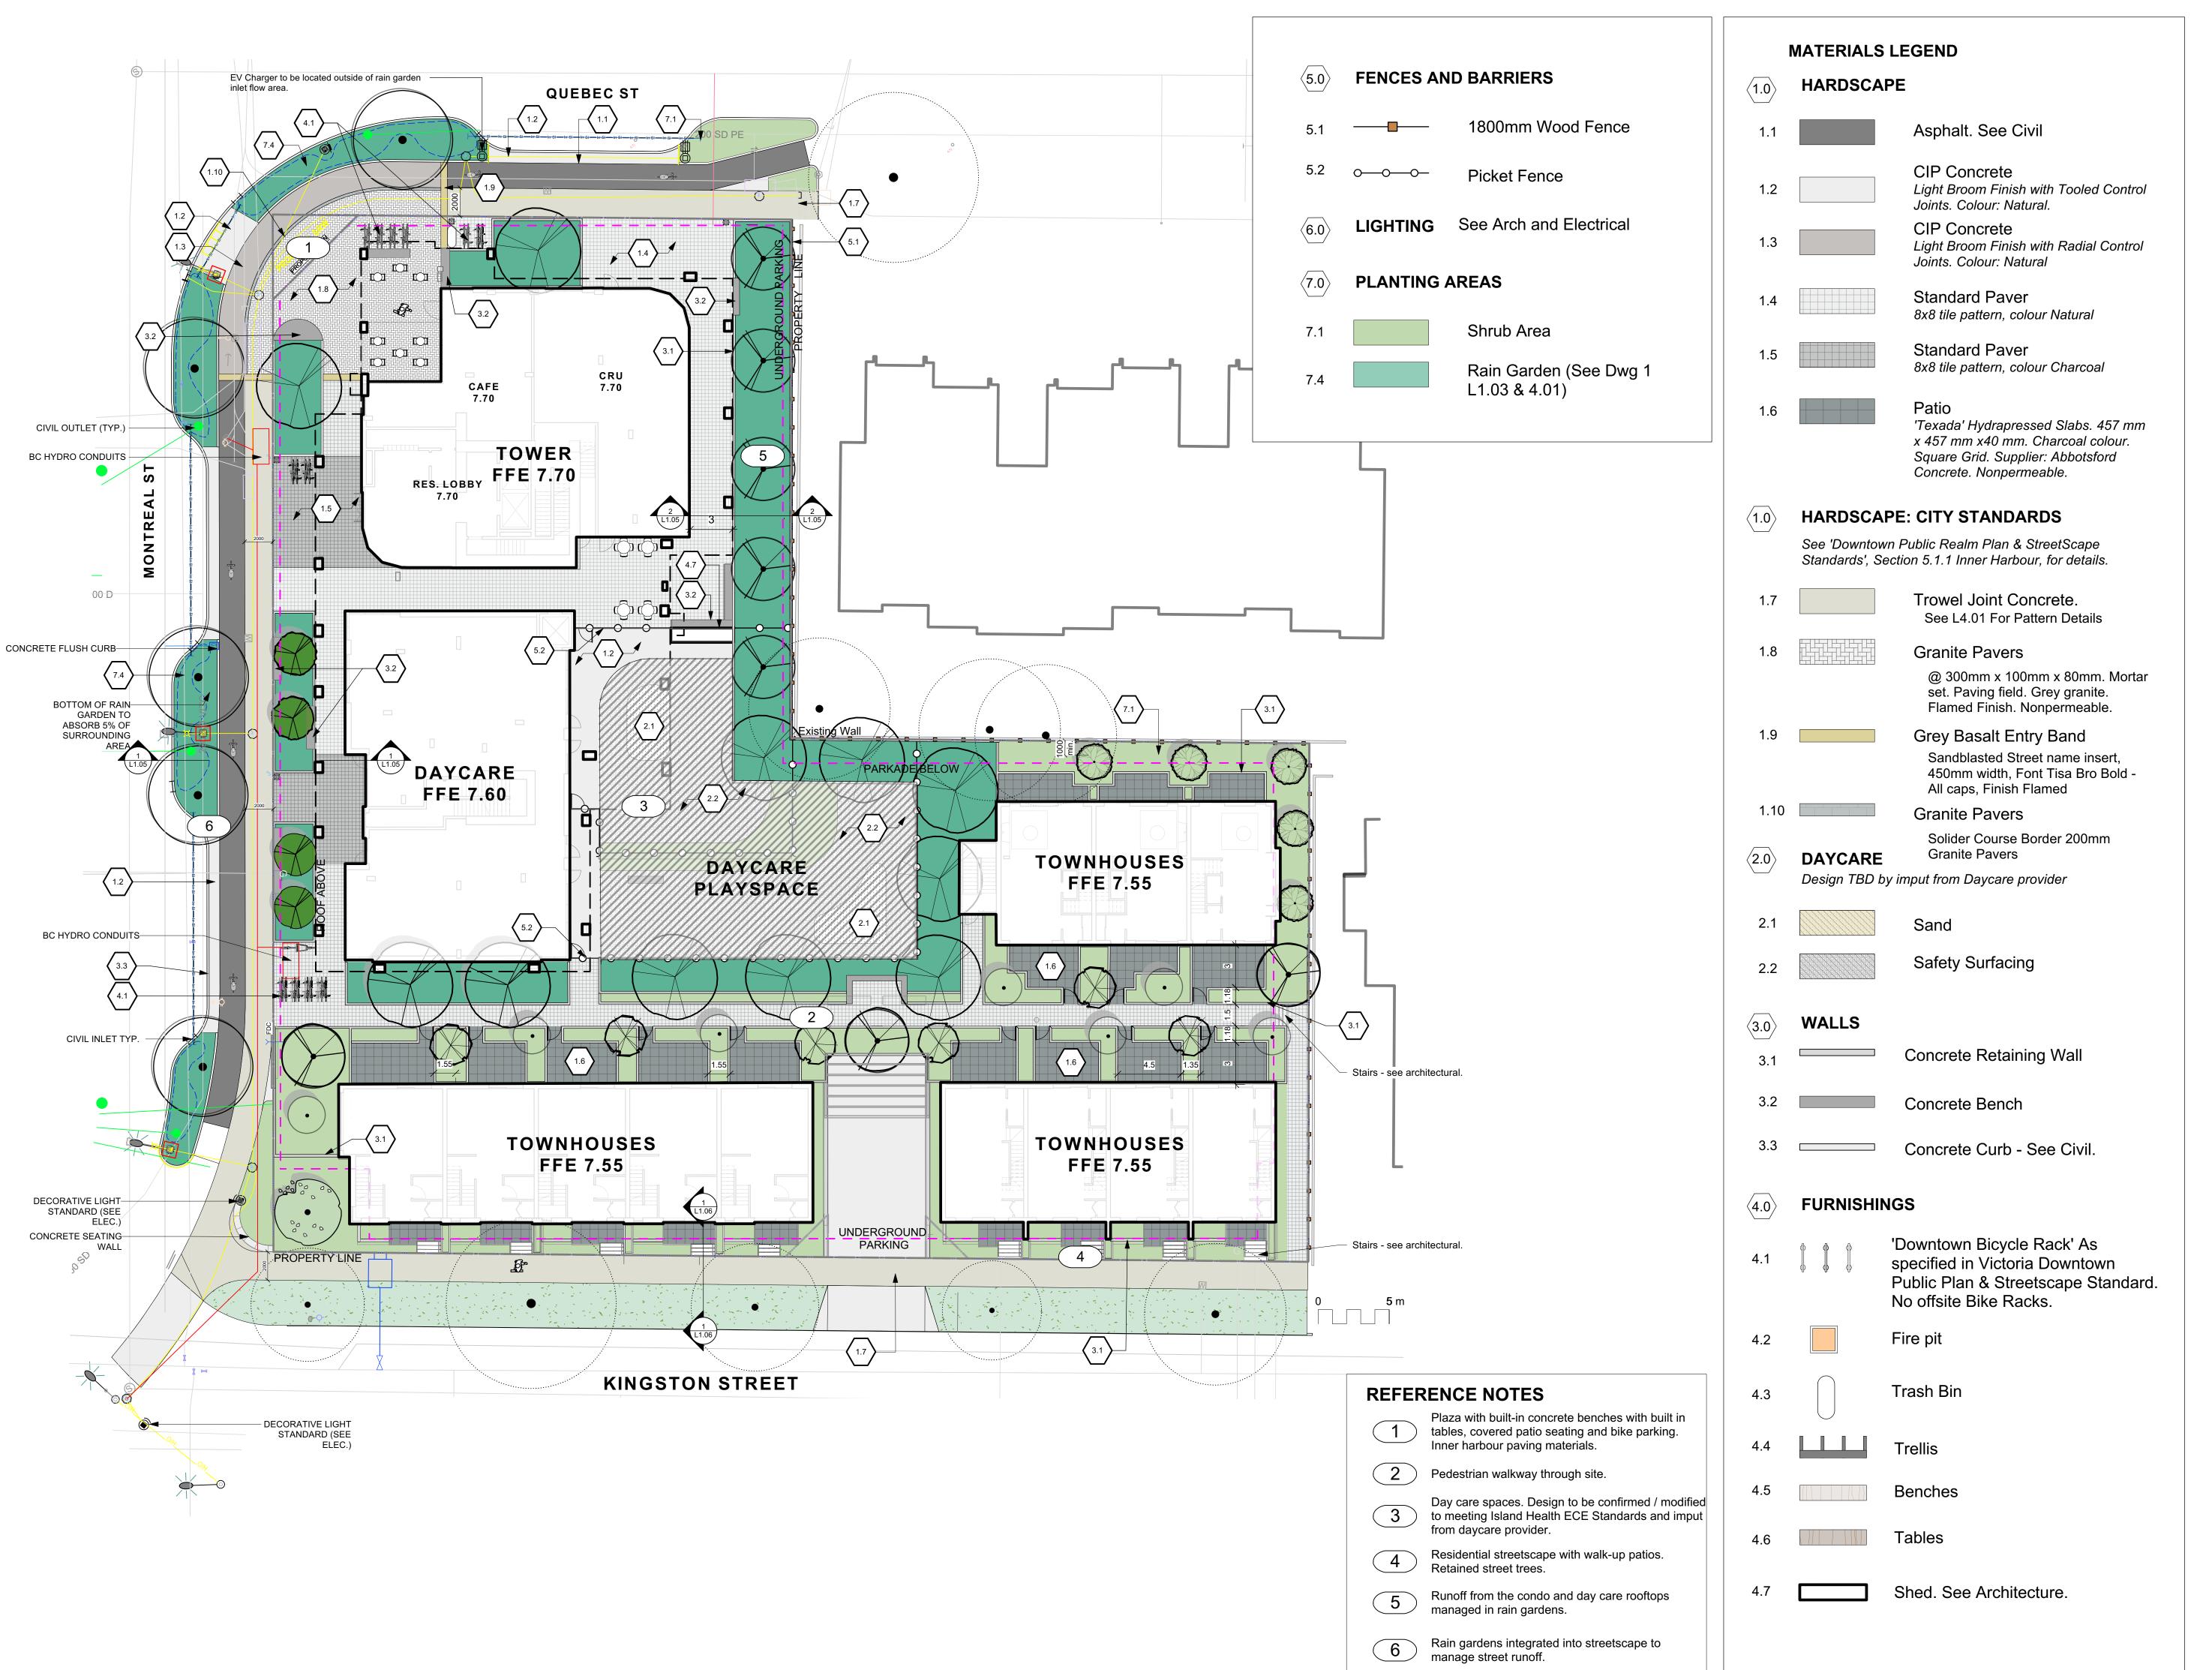

REV RZ/DP 2023-12-22 REV RZ/DP 2023-03-02 REV RZ/DP 2022-12-06 REV RZ/DP 2022-08-31 For Information 2022-06-27 REV RZ/DP 2022-04-14 3 2021-12-16 1 Issued for Dev. Tracker 2021-10-19 description



2023-12-22


Mike Geric Construction 4520 West Saanich Rd Saanich, BC

project
QUEBEC & MONTREAL DEV.
501-502 MONTREAL ST.
VICTORIA, BC

sheet title

Landscape Materials - Ground Level

project no.		121.23
scale	1:200	@ 24"x36
drawn by		MDI
checked by		SM
revison no.	sheet no.	
8	L	1.01

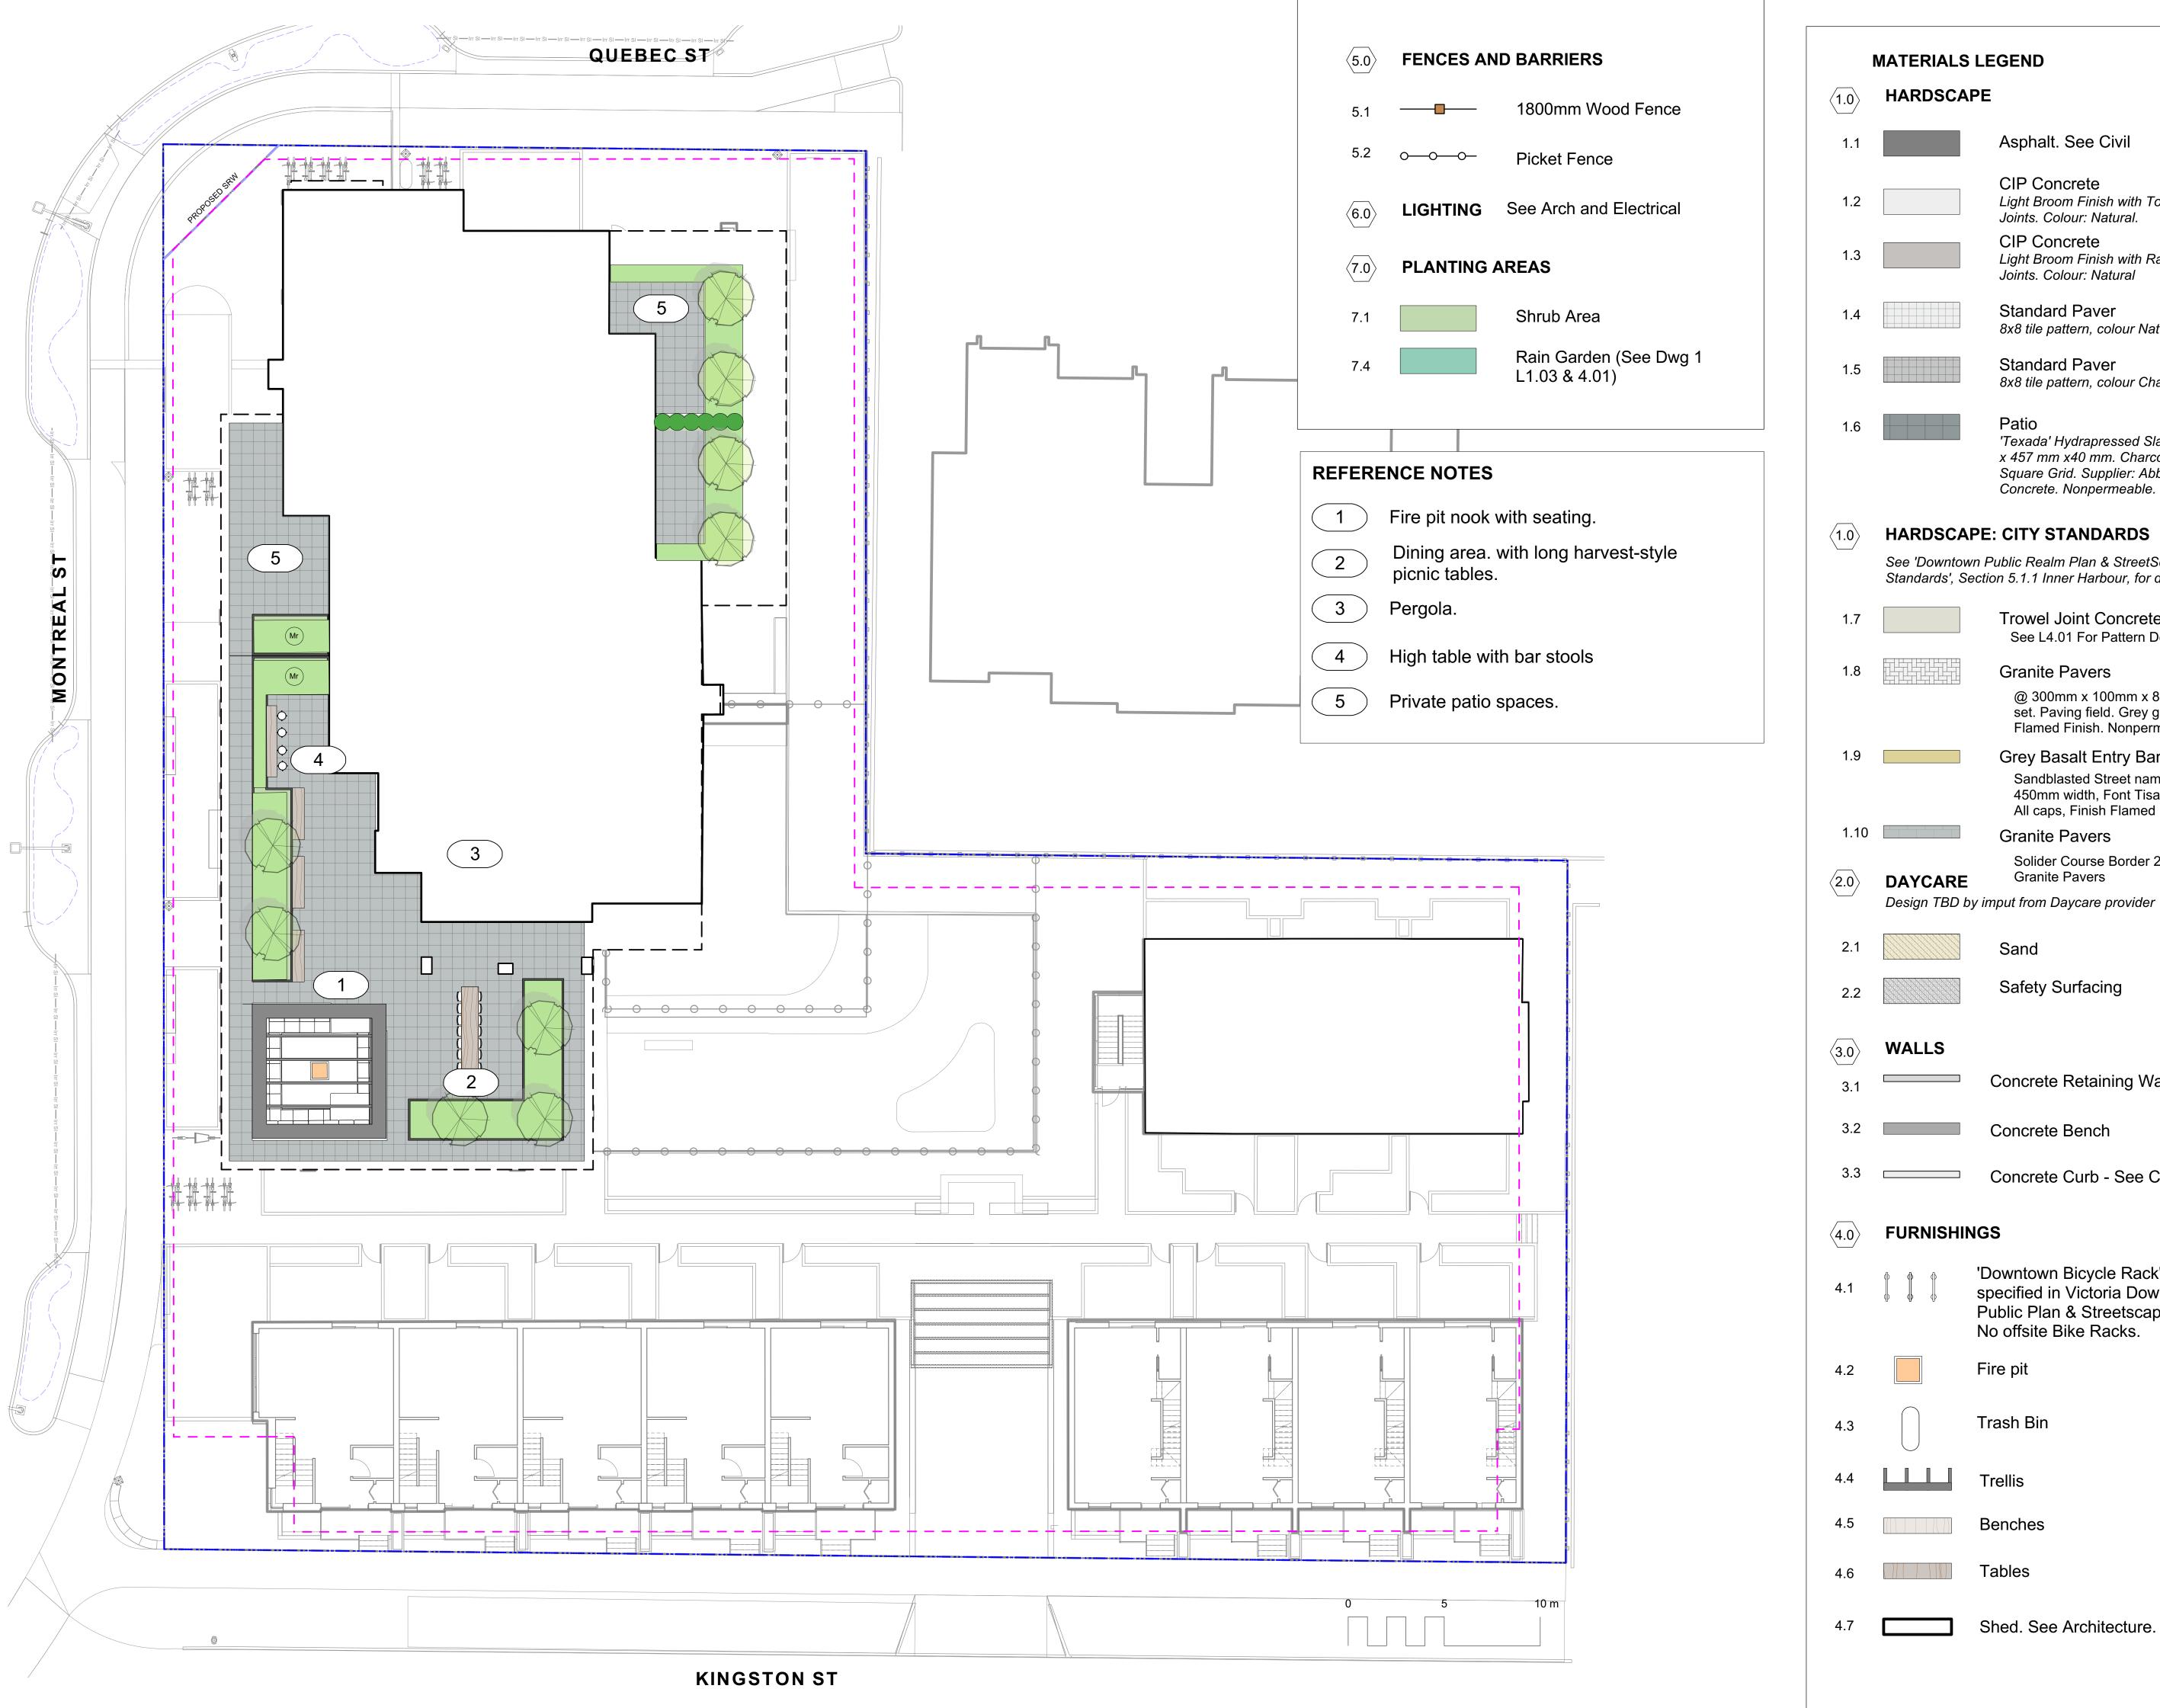

#### **MATERIALS LEGEND**

**HARDSCAPE** 

Asphalt. See Civil

CIP Concrete Light Broom Finish with Tooled Control Joints. Colour: Natural.

**CIP Concrete** Light Broom Finish with Radial Control Joints. Colour: Natural

Standard Paver 8x8 tile pattern, colour Natural

Standard Paver 8x8 tile pattern, colour Charcoal

Patio 'Texada' Hydrapressed Slabs. 457 mm x 457 mm x40 mm. Charcoal colour. Square Grid. Supplier: Abbotsford Concrete. Nonpermeable.

HARDSCAPE: CITY STANDARDS

See 'Downtown Public Realm Plan & StreetScape Standards', Section 5.1.1 Inner Harbour, for details.

Trowel Joint Concrete. See L4.01 For Pattern Details

**Granite Pavers** @ 300mm x 100mm x 80mm. Mortar set. Paving field. Grey granite. Flamed Finish. Nonpermeable.

> Grey Basalt Entry Band Sandblasted Street name insert, 450mm width, Font Tisa Bro Bold -

All caps, Finish Flamed

**Granite Pavers** 

Solider Course Border 200mm **Granite Pavers** 

Sand

Safety Surfacing

Concrete Retaining Wall

Concrete Bench

Concrete Curb - See Civil.

'Downtown Bicycle Rack' As specified in Victoria Downtown Public Plan & Streetscape Standard. No offsite Bike Racks.

Fire pit

Trash Bin

Benches

Tables

Shed. See Architecture.



8	REV RZ/DP	2023-12-22
7	REV RZ/DP	2023-03-02
6	REV RZ/DP	2022-12-06
5	REV RZ/DP	2022-08-31
4	For Information	2022-06-27
3	REV RZ/DP	2022-04-14
2	DP	2021-12-16
1	Issued for Dev. Tracker	2021-10-19
rev no	description	date
	MI	71
	JIVIL	

Landscape Architects

2023-12-22 **Mike Geric Construction** 

Saanich, BC

4520 West Saanich Rd

QUEBEC & MONTREAL DEV. 501-502 MONTREAL ST. VICTORIA, BC

sheet title

Landscape Materials - Level 4

project no.		121.23
scale	1:150	@ 24"x36
drawn by		MDI
checked by		SM
revison no.	sheet no.	
8	L	1.02



#### LEGEND

PROPERTY LINE ----EXTENT OF UNDERGROUND PARKING (INDICATIVE) EXTENT OF ROOF / CANOPY LINE (INDICATIVE) RAIN GARDEN - TOP OF POOL RAIN GARDEN - BOTTOM OF POOL EXISTING GRADE (APPROXIMATE) PROPOSED ARCH GRADE PROPOSED LANDSCAPE GRADE TP TOP OF POOL BP BOTTOM OF POOL DIRECTION OF FLOW ---> RAIN GARDEN ON GRADE IMPERVIOUS AREAS ROOF DRAINS TO RAIN GARDEN ROAD / HARDSCAPE DRAINS TO

#### RAIN WATER MANAGEMENT NOTES

**RAIN GARDEN** 


Water collected from road areas, building roofs, flow to the rain gardens located throughout the site.

Rain gardens are integrated building landscapes and landscape bulges within streetscape areas and are designed to capture, slow flows, and treat runoff from roadways.

## Rain gardens will be designed with underdrains and a high-capacity overflow drain that will be connected to the onsite piped drainage system.

The rain gardens are sized such that the bottom of the rain garden is 5% of the impervious area to meet or exceed City of Victoria Green Stormwater Infrastructure Guidelines.

#### Boulevard rain gardens to be designed to City of Victoria Standards

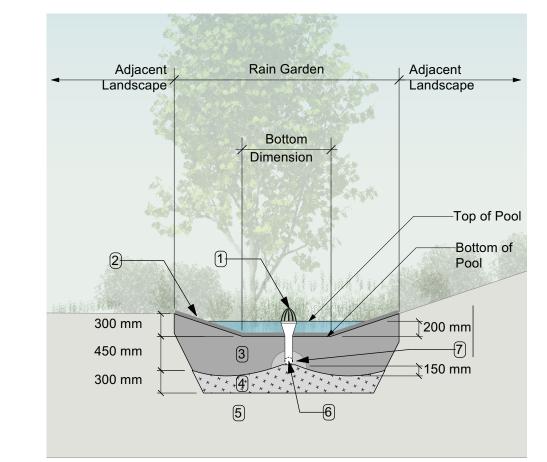

RAIN GARDEN MATERIALS

- Overflow drain, 200 mm domed grate + adapter
- 2. Composted mulch, 50 -70 mm depth
- 3. Bio-retention growing medium, 450 mm depth


7. 25 mm diameter drain rock, 100 mm depth

- 4. Scarified/tilled subgrade, 300 mm depth5. Existing subgrade/native material
- 6. 100 mm diameter (min) perforated pipe

1 Typical Rain Garden
Scale: 1:50

#### **GRADING NOTES**

- 1. All grades slope 2% from the building to back of curb.
- 2. Slab grade varies
- 3. All landscape walls are an average of 500mm height.
- 4. Kingston St Townhouses require 3-4 risers to meet grade.
- 5. Proposed curb grades to be determined by Civil (proposed grades will be similar to existing grades. See Civil for details)
- 6. All sidewalk slope 2% to back of curb.

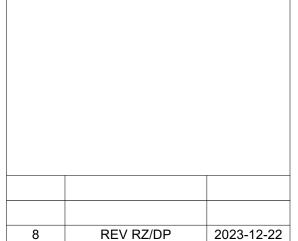

REV RZ/DP

REV RZ/DP

REV RZ/DP
For Information

REV RZ/DP

3

2023-03-02

2022-08-31

2022-06-27

2022-04-14

2021-12-16



1 Issued for Dev. Tracker 2021-10-19

aliant

Mike Geric Construction 4520 West Saanich Rd Saanich, BC


project QUEBEC


QUEBEC & MONTREAL DEV. 501-502 MONTREAL ST. VICTORIA, BC

sheet title

Stormwater
Management &
Grading


project no.		121.23
scale	1: ###	@ 24"x36"
drawn by		MDI
checked by		SM
revison no.	sheet no.	
8	L	1.03

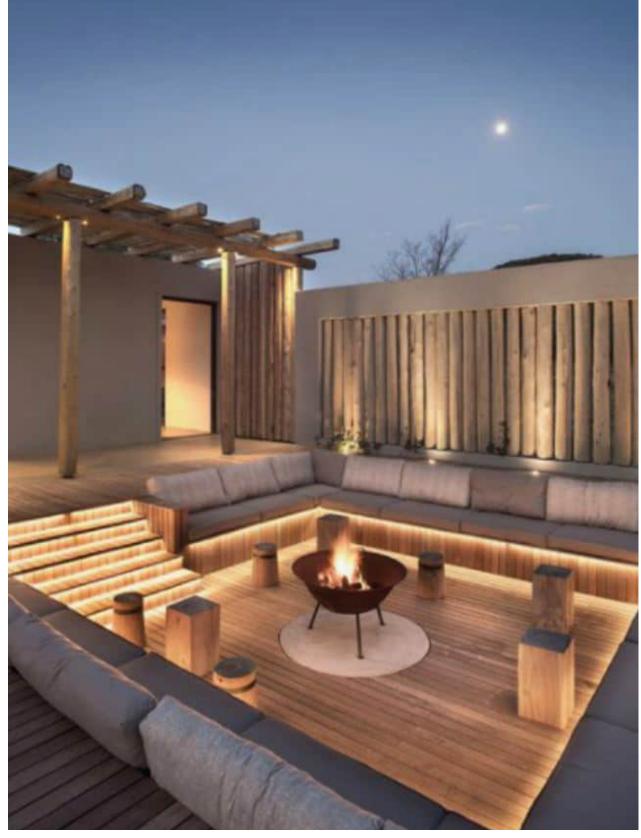

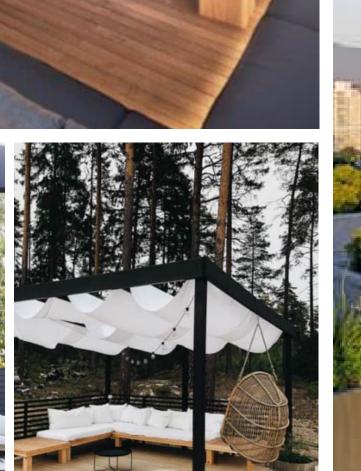






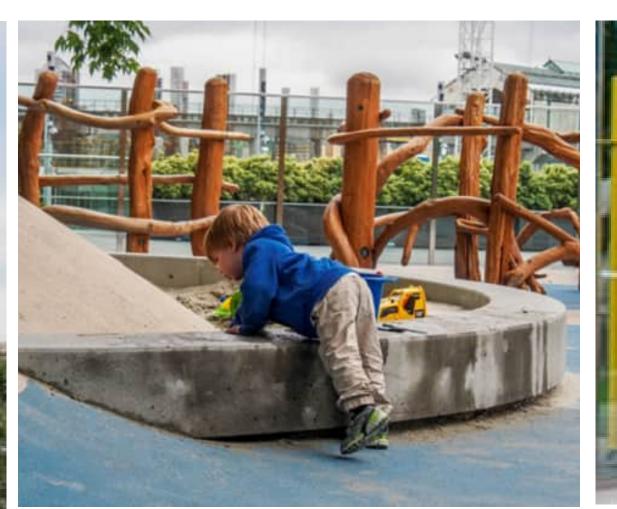





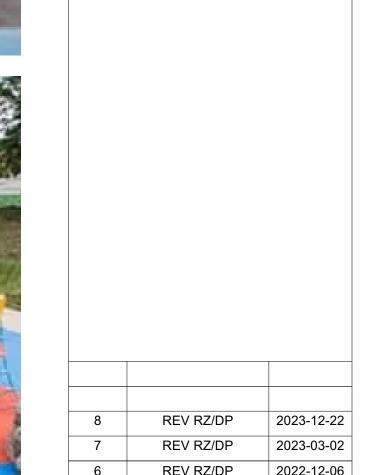





Mike Geric Construction 4520 West Saanich Rd Saanich, BC

QUEBEC & MONTREAL DEV.

501-502 MONTREAL ST. VICTORIA, BC sheet title

Landscape Precedents

project no.		121.23
scale	N/A	@ 24"x30
drawn by		MD
checked by		SM
revison no.	sheet no.	
8	L	_1.04

## **ROOFTOP COMMON SPACE**









**DAYCARE - PLAY** 













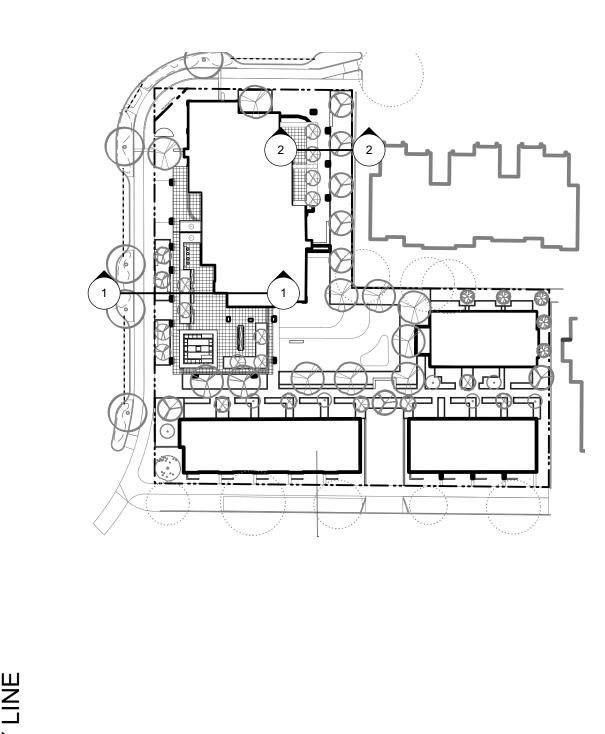

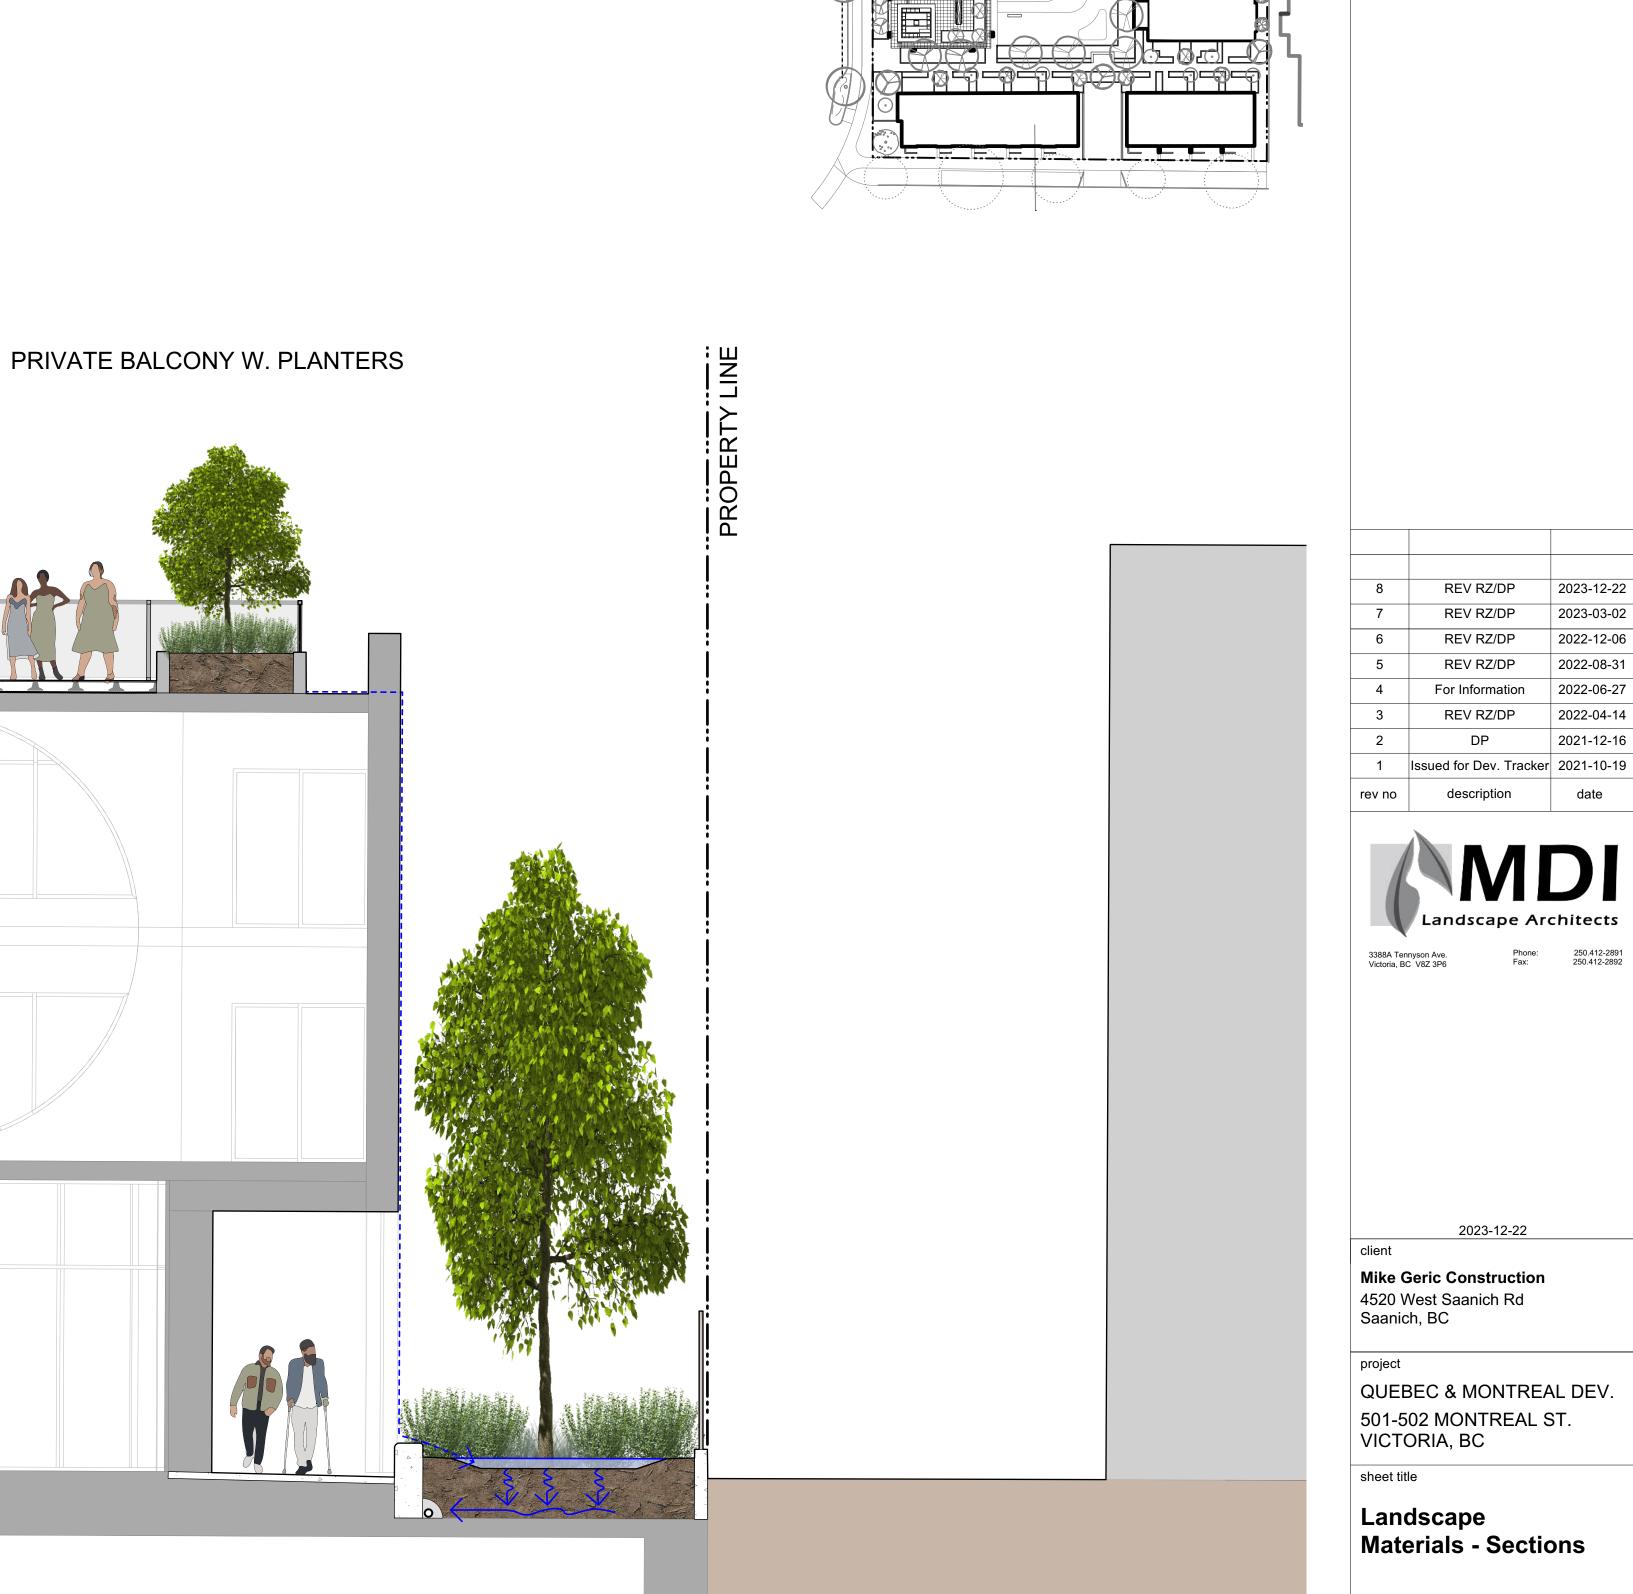

Mike Geric Construction 4520 West Saanich Rd Saanich, BC

QUEBEC & MONTREAL DEV. 501-502 MONTREAL ST. VICTORIA, BC

2023-12-22

REV RZ/DP REV RZ/DP REV RZ/DP REV RZ/DP For Information REV RZ/DP

2022-04-14

sheet title


Landscape Materials - Sections

project no.		121.23
scale	1:50	@ 24"x36"
drawn by		MDI
checked by		SM
revison no.	sheet no.	
8	L	1.05





COMMON AREA WITH PLANTER, SEATING &

**TRELLIS** 

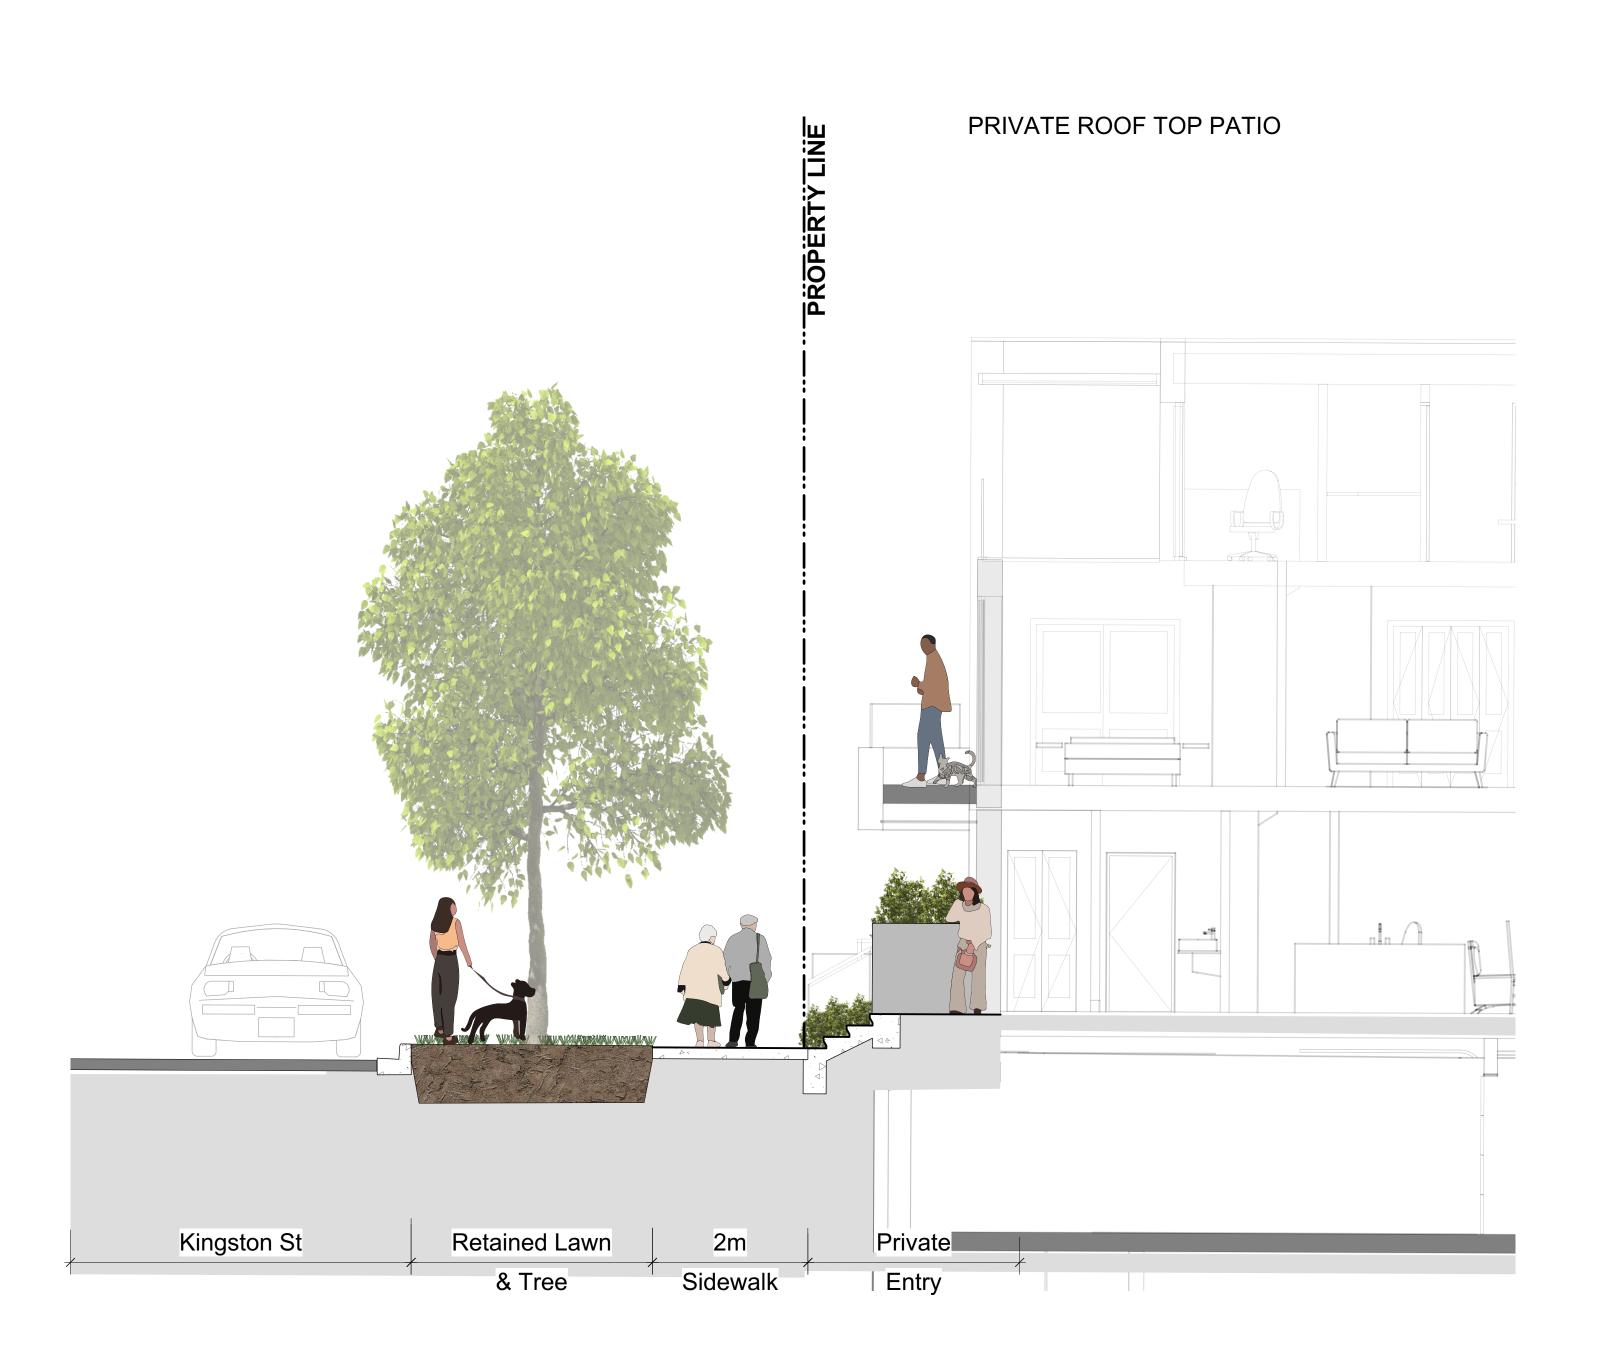

1 Typical Kingston Street Section

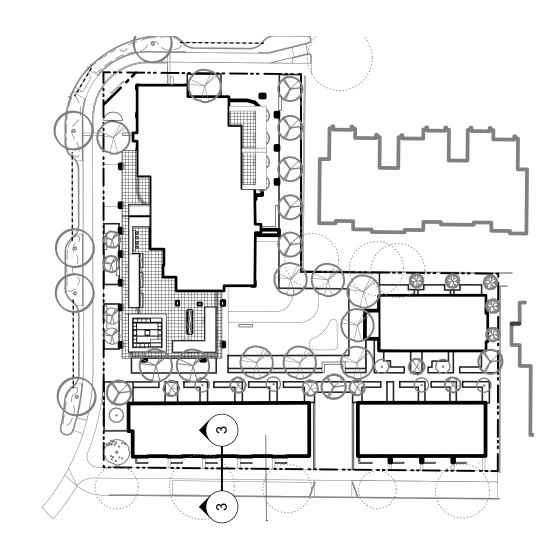

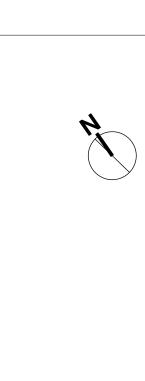

8	REV RZ/DP	2023-12-22
7	REV RZ/DP	2023-03-02
6	REV RZ/DP	2022-12-06
5	REV RZ/DP	2022-08-31
4	For Information	2022-06-27
3	REV RZ/DP	2022-04-14
2	DP	2021-12-16
1	Issued for Dev. Tracker	2021-10-19
ev no	description	date



2023-12-22

Mike Geric Construction 4520 West Saanich Rd Saanich, BC


project


QUEBEC & MONTREAL DEV. 501-502 MONTREAL ST. VICTORIA, BC

sheet title

Landscape Materials - Sections

_		
project no.		121.23
scale	1:50	@ 24"x36"
drawn by		MDI
checked by		SM
revison no.	sheet no.	
8	L	1.06

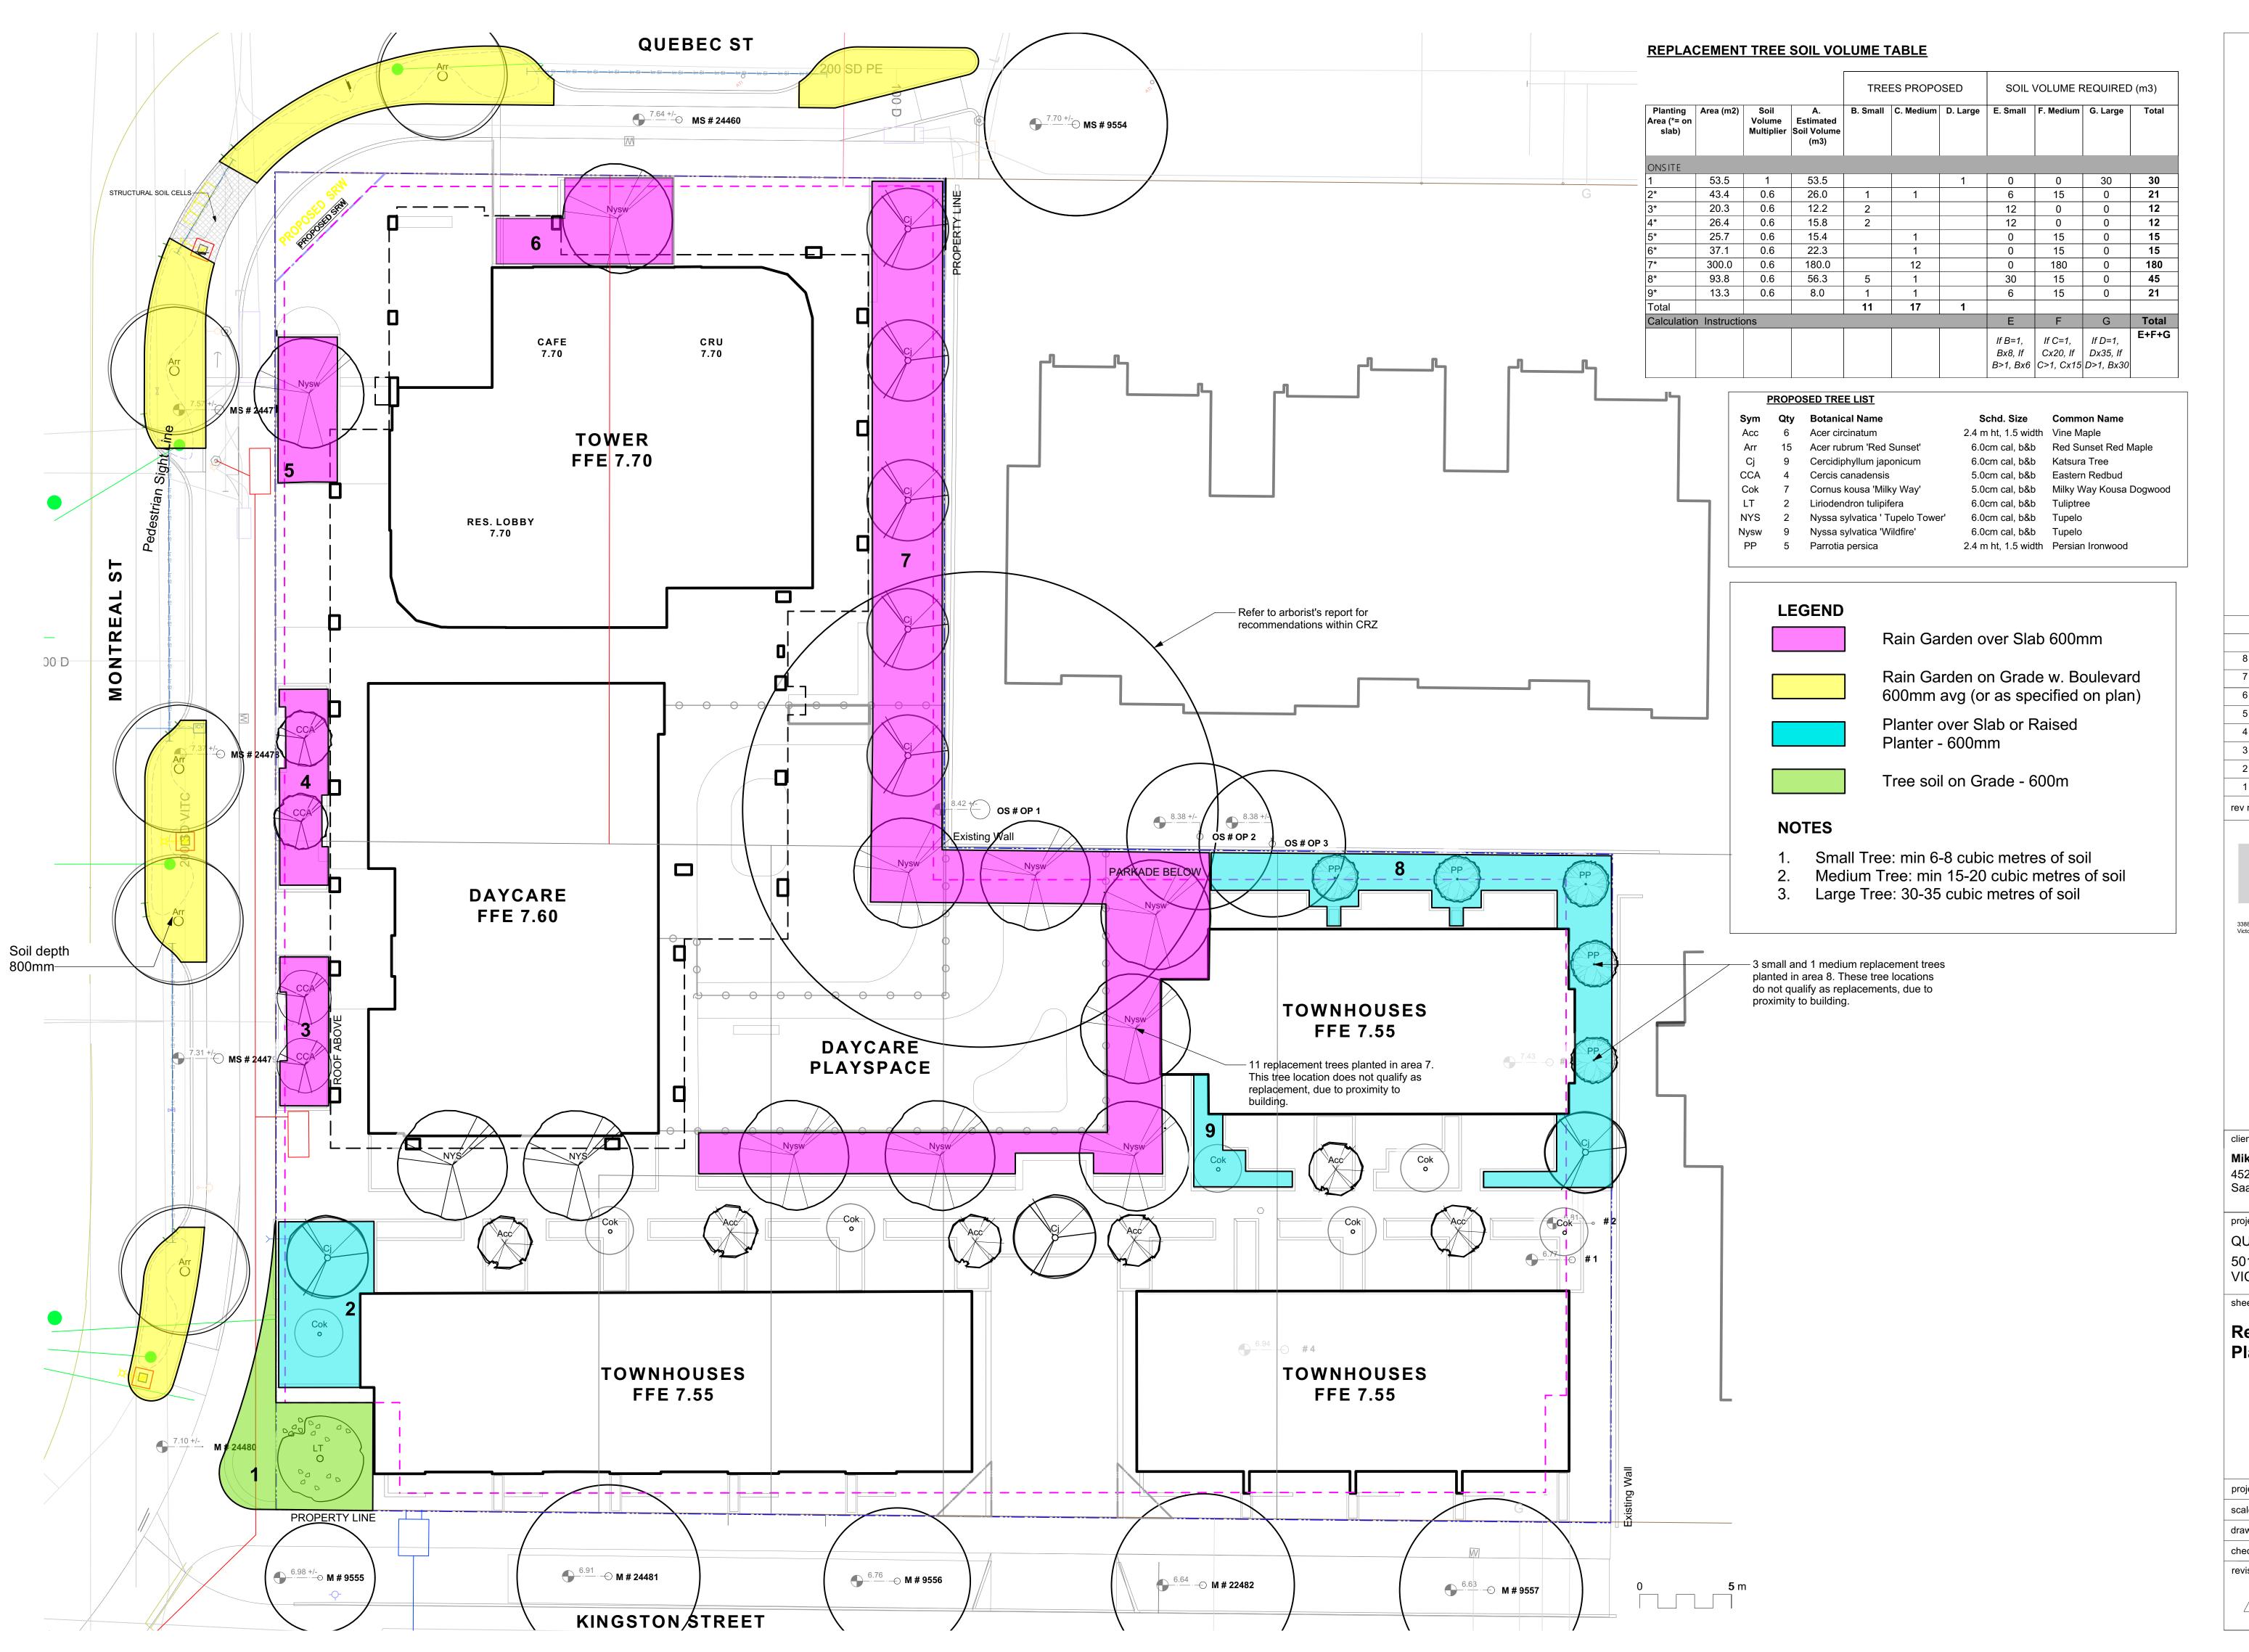

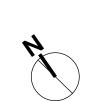

8	REV RZ/DP	2023-12-22
7	REV RZ/DP	2023-03-02
6	REV RZ/DP	2022-12-06
5	REV RZ/DP	2022-08-31
4	For Information	2022-06-27
3	REV RZ/DP	2022-04-14
2	DP	2021-12-16
1	Issued for Dev. Tracker	2021-10-19
v no	description	date



2023-12-22

Mike Geric Construction 4520 West Saanich Rd Saanich, BC

roject

QUEBEC & MONTREAL DEV. 501-502 MONTREAL ST. VICTORIA, BC

sheet title

Replacement Tree Plan


	121.23
1:150	@ 24"x36"
	MDI
	SM
sheet no.	
L	1.07
	sheet no.



S	Sym Qty	Botanical Name	Common Name	Schd. Size / Plant Spacing
<u>T</u>	REES:			
,	Acc 6	Acer circinatum	Vine Maple	2.4 m ht, 1.5 width
ي	Arr 15	Acer rubrum 'Red Sunset'	Red Sunset Red Maple	6.0cm cal, b&b
	Cj 9	Cercidiphyllum japonicum	Katsura Tree	6.0cm cal, b&b
C	CCA 4	Cercis canadensis	Eastern Redbud	5.0cm cal, b&b
(	Cok 7	Cornus kousa 'Milky Way'	Milky Way Kousa Dogwood	5.0cm cal, b&b
	LT 2	Liriodendron tulipifera	Tuliptree	6.0cm cal, b&b
N	NYS 2	Nyssa sylvatica ' Tupelo Tower'	Tupelo	6.0cm cal, b&b
N	lysw 9	Nyssa sylvatica 'Wildfire'	Tupelo	6.0cm cal, b&b
	PP 5	Parrotia persica	Persian Ironwood	2.4 m ht, 1.5 width
<u>s</u>	HRUBS:			
	178	Athyrium filix-femina var. cyclosorum	Northwestern Lady Fern	#1 pot
	85	Chamaecyparis pisifera 'Sungold'	False Cypress 'Sungold'	#2 pot
	43	Cornus sanguinea 'Midwinter Fire'	Midwinter Fire Dogwood	#1 pot
	70	Eupatorium cannabinum	Hemp Agrimony	Sp3
	419	Gaultheria shallon	Salal	#1 pot
	503	Liriope muscari	Lily turf	#1 pot
	262	Lonicera pileata	Privet Honeysuckle	#1 pot
	70	Miscanthus sinensis 'Adagio'	Adagio Maiden Grass	#1 pot
	57	Polystichum munitum	Sword Fern	#1 pot
	178	Taxus baccata 'Repandens'	English Weeping Yew	#1 pot
	130	Vaccinium ovatum 'Thunderbird'	Evergreen Huckleberry	#3 pot
	70	Verbena bonariensis	Purpletop Vervain	#1 pot
<u>R</u>		N PLANTERS STREET:		
	356	Juncus 'Carmen's Grey'	Soft Common Rush	Sp3
	356	Carex obnupta	Slough Sedge	#1 pot
	71	Gaultheria shallon	Salal	Sp3
	71	Mahonia nervosa	Oregon Grape Holly	#1 pot
	43	Spiraea japonica 'Gold Mound'	Gold Mound Spiraea	#1 pot
<u>R</u>	RAIN GARDE			
	431	Carex obnupta	Slough Sedge	Sp3
	34	Cornus sanguinea 'Midwinter Fire'	Midwinter Fire Dogwood	#1 pot
	453	Juncus 'Carmen's Grey'	Soft Common Rush	Sp3
	431	Liriope muscari	Lily turf	#1 pot
	87	Schizostylis coccinea 'Oregon Sunset'	Crimson Flag	#1 pot
_ н	IEDGING/SC			5
	35	Buxus microphylla 'Winter Gem'	Littleleaf Boxwood	#1 pot
0	51	Taxus baccata	English Yew	#10 pot

#### REFERENCE NOTES

30%> of planting scheme has been dedicated ecosystem services. Plants for pollinators are included, via the Pollinator and Allergy-Aware Gardening Guide. This site features native plants that are unique to the Southern Vancouver Island Bioregional zone. Food bearing plants are also added in addition to the guidelines. Additionally, rain garden plants provide stormwater management opportunities.

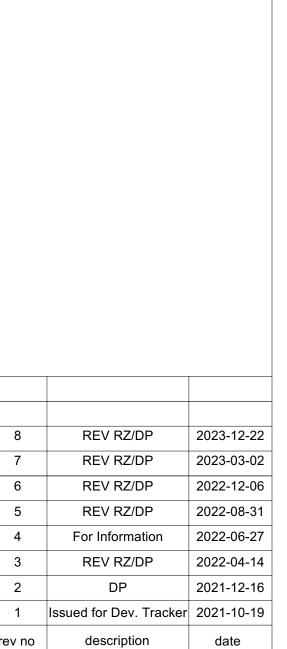



Mike Geric Construction 4520 West Saanich Rd Saanich, BC

roject


QUEBEC & MONTREAL DEV. 501-502 MONTREAL ST. VICTORIA, BC

sheet title

Planting Plan -Ground Level

project no.		121.23
scale	1: ###	@ 24"x36"
drawn by		MDI
checked by		SM
revison no.	sheet no.	
8		.3.01



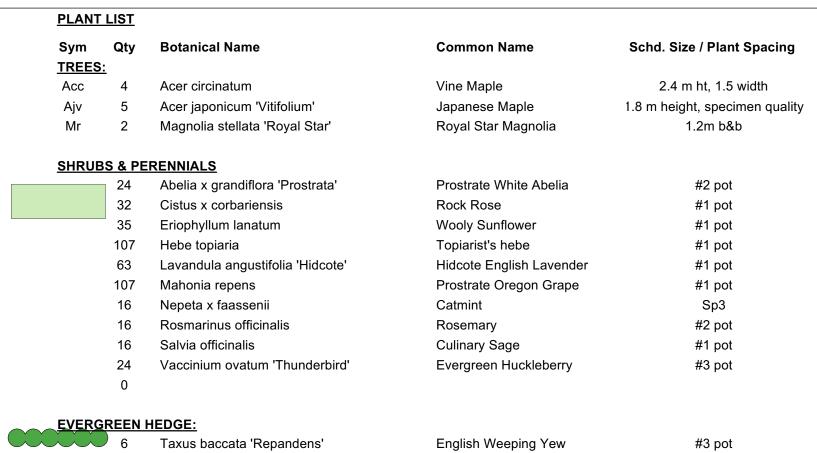

#### REFERENCE NOTES

30%> of planting scheme has been dedicated ecosystem services. Plants for pollinators are included, via the Pollinator and Allergy-Aware Gardening Guide. This site features native plants that are unique to the Southern Vancouver Island Bioregional zone. Food bearing plants are also added in addition to the guidelines. Additionally, rain garden plants provide stormwater management opportunities.

Spacing	
vidth nen quality	

8	REV RZ/DP	2023-12-22
7	REV RZ/DP	2023-03-02
6	REV RZ/DP	2022-12-06
5	REV RZ/DP	2022-08-31
4	For Information	2022-06-27
3	REV RZ/DP	2022-04-14
2	DP	2021-12-16
1	Issued for Dev. Tracker	2021-10-19
rev no	description	date



Mike Geric Construction 4520 West Saanich Rd Saanich, BC


project


QUEBEC & MONTREAL DEV. 501-502 MONTREAL ST. VICTORIA, BC

sheet title

Planting Plan - Level

project no.		121.23
scale	1: ###	@ 24"x36"
drawn by		MDI
checked by		SM
revison no.	sheet no.	
8	L	3.02

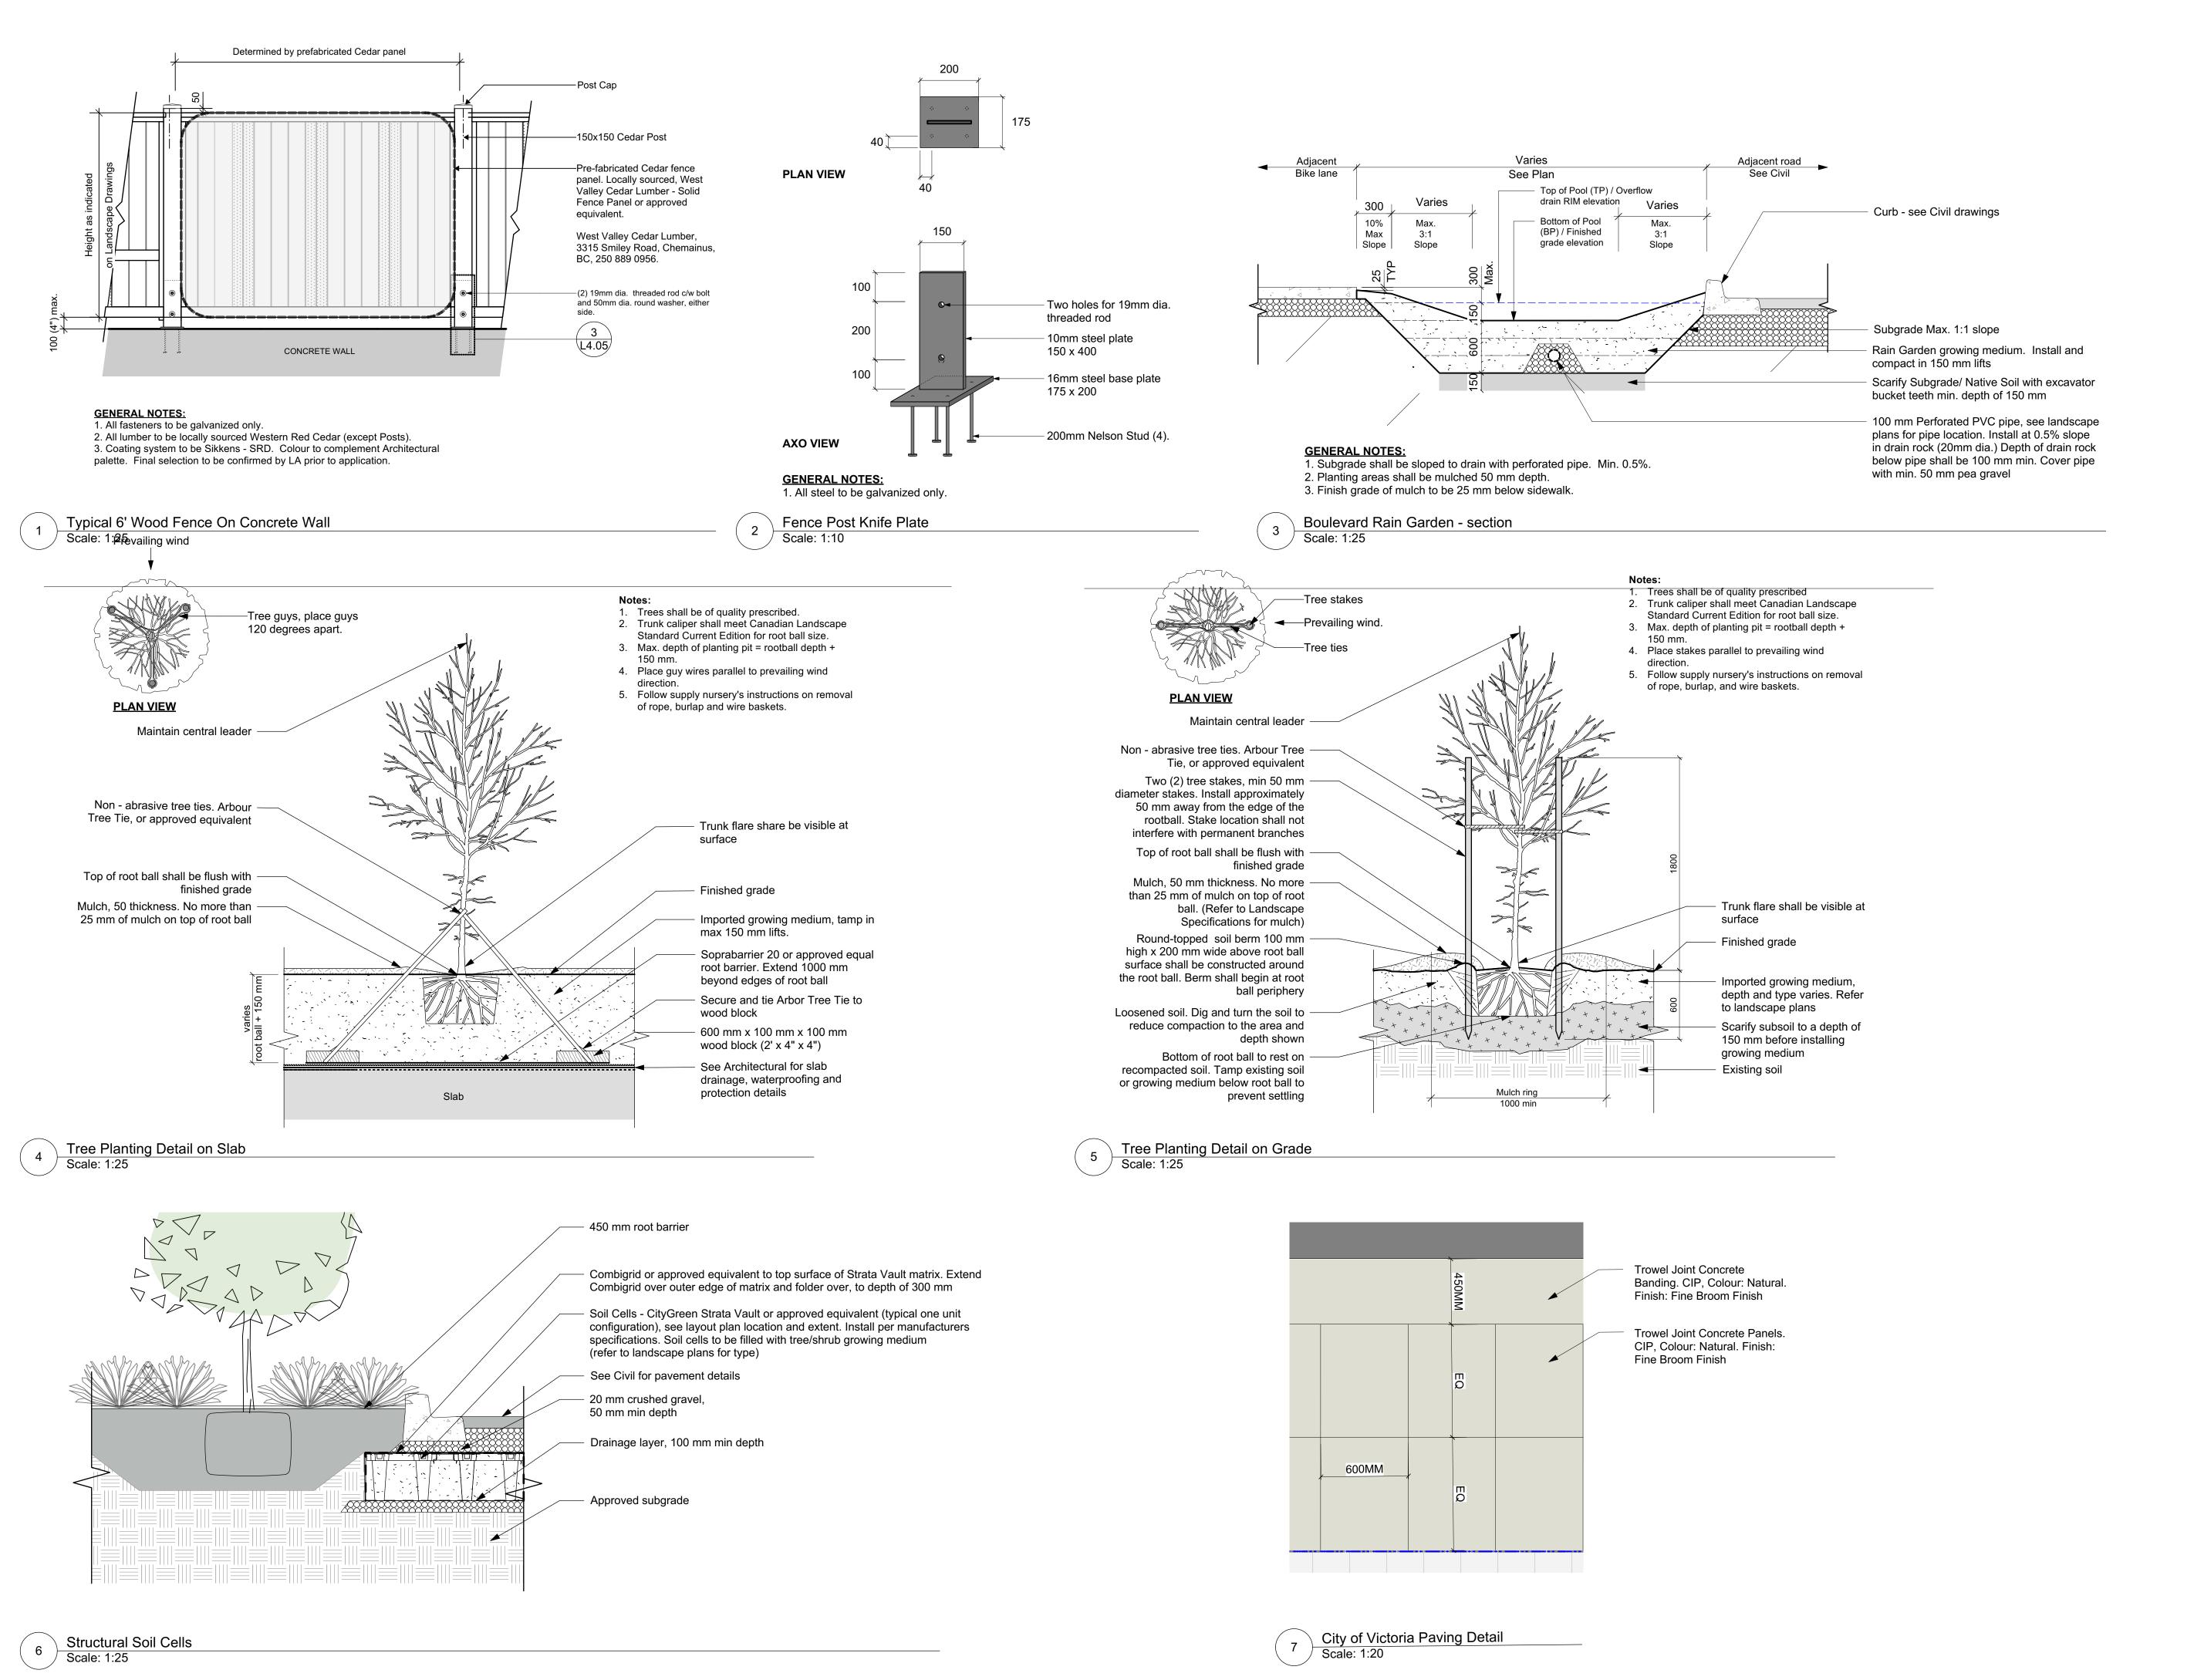

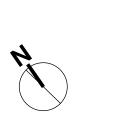

8	REV RZ/DP	2023-12-22
7	REV RZ/DP	2023-03-02
6	REV RZ/DP	2022-12-06
5	REV RZ/DP	2022-08-31
4	For Information	2022-06-27
3	REV RZ/DP	2022-04-14
2	DP	2021-12-16
1	Issued for Dev. Tracker	2021-10-19
rev no	description	date

Mike Geric Construction 4520 West Saanich Rd Saanich, BC

QUEBEC & MONTREAL DEV. 501-502 MONTREAL ST. VICTORIA, BC

sheet title

Landscape Details

project no. 121.23

scale AS SHOWN @ 24"x36"

drawn by MDI
checked by SM

revison no. sheet no.

A L4.01