# NORTHERN JUNK

1314 + 1318 WHARF STREET, VICTORIA BC LOT 182F

BUILDING PERMIT APPLICATION, REVISION 3 APRIL 9, 2023

## PROJECT TEAM

OWNER/DEVELOPER **ARCHITECT** CROSSTOWN PROPERTIES (WHARF ST.) BONIFACE OLEKSIUK POLITANO [MANAGED BY RELIANCE PROPERTIES LTD.] 305 - 111 WATER ST. VANCOUVER BC, V6B 1A7

TEL: (604) 694-8896

FAX: (604) 683-6719

& FIRE PROTECTION

INTEGRAL GROUP

VICTORIA BC

TEL: (250) 418-1288

MECHANICAL, ELECTRICAL

101 - 1019 WHARF STREET

180-510 NICOLA STREET VANCOUVER BC, V6G 3J7 TEL: (236) 521-6568

STRUCTURAL READ JONES CHRISTOFFERSEN

645 TYEE ROAD, SUITE 220 VICTORIA BC, V9A 6X5 TEL: (250) 386-7794

**GEOTECHNICAL** RYZUK

> 28 CREASE AVENUE VICTORIA BC, V8Z 1S3 TEL: (250) 475-3131

LANDSCAPE ARCHITECTS

**GAUTHIER & ASSOCIATES** 

629 ATLANTIC STREET

TEL: (604) 317-9682

VANCOUVER BC, V6A 2J9

LANDSCAPE ARCHITECTURE INC

VICTORIA BC, V8W 1G2 TEL: (250) 592-6122

**ENGINEERING** 

TRANSPORTATION

BUNT AND ASSOCIATES

421 - 645 FORT STREET

HERITAGE CONSULTANT WSP **COMMUNITY DESIGN** STRATEGIES INC.

301-3600 UPTOWN BLVD. VICTORIA BC, V8Z 0B9 TEL: (250) 389-8015

INTERIORS UNTITLED DESIGN

TEL: (604) 716-8801

625-12 AVENUE NE

TEL: (403) 861-8040

CALGARY AB, T2E 1B2

TURNBULL CONSTRUCTION PROJECT MANAGERS LTD.

> 13450 102 AVE, SUITE 1670 SURREY, BC V3T 5X3

> > TEL: (604) 282-1363

CODE CONSULTANT

212 5TH AVE.

**DRAWING LIST - CONSULTANTS** REFER TO CONSULTANT DRAWINGS FOR DRAWING LIST

STRUCTURAL

MECHANICAL

ELECTRICAL

LANDSCAPE

FIRE PROTECTION

GEOTECHNICAL

BUILDING CODE COMPLIANCE

TEL: (604) 526-3335

MURRAY JOHNSON ENGINEERING LTD.

NEW WESTMINSTER BC, V3L 1R4

PROJECT MANAGER

A 2022-06-24 BUILDING PERMIT APPLICATION B 2022-09-29 BUILDING PERMIT APPLICATION

**Boniface** 

Oleksiuk

Politano

C 2022-10-14 ISSUED FOR TENDER

RELIANCE

D 2022-11-10 IFT ADDENDUM 2

E 2022-12-01 BUILDING PERMIT APPLICATION

**REVISION 2** 

F 2023-02-21 POST-TENDER ADDENDUM G 2023-03-27 POST-TENDER ADDENDUM 02

H 2023-04-09 BUILDING PERMIT APPLICATION



## **DRAWING LIST - ARCHITECTURAL**

A-000	COVER SHEET	1
A-001	PROJECT DATA	1
A-002	ANNOTATIONS, SYMBOLS AND	A
	ABBREVIATIONS	1
A-003	ASSEMBLY SCHEDULE 1	ı
A-004	ASSEMBLY SCHEDULE 2	A
A-005	ROOM FINISH SCHEDULE	A
A-006	DOOR, TYPES & FRAMES	
A-007	DOOR SCHEDULE, LEVEL 0-3	1
A-008	DOOR SCHEDULE, LEVEL 04-ROOF	,
A-050	WINDOW SCHEDULE, TYPES & FRAMES	,
A-051	WINDOW WALL, ELEVATIONS 1	,
A-052	WINDOW WALL, ELEVATIONS 2	•
A-053	INTERIOR GLAZING SCHEDULE	,
A-054	<b>EXTERIOR CURTAIN WALL ELEVATIONS 1</b>	,
A-055	EXTERIOR CURTAIN WALL ELEVATIONS 2	,
		,
A-101	SITE SURVEY	,
		•

A-102 SITE PLAN

PLAN - LEVEL 3-4 PLAN - LEVEL 5 PLAN - ROOF PARTIAL PLANS CEILING PLAN - LEVEL 2-4 CEILING PLAN - LEVEL 5 WEST ELEVATION NORTH ELEVATION EAST ELEVATION

**ENLARGED ELEVATIONS** 

SECTION - B1 SECTION - B2 SECTION - B3 SECTION - B4 SECTION - B5 TYPICAL STAIR DETAILS TYPICAL STAIR DETAILS STAIR 01 + ELEV 01 - PLANS AND SECTIONS STAIR 02 - PLANS AND SECTIONS STAIR 03, 04 + ELEV 02 - PLANS AND STAIR 03 + RAILING DETAILS STAIR 05 + 06 - PLANS AND SECTIONS

EAST FACADE WALL SECTIONS

EAST FACDE WALL SECTIONS

TYPICAL ENVELOPE DETAILS - PLAN 3 A-808 TYPICAL ENVELOPE DETAILS - PLAN 4 TYPICAL ENVELOPE DETAILS - SECTION 1 TYPICAL ENVELOPE DETAILS - SECTION 2 TYPICAL ROOF DETAILS 1

TYPICAL SUITE LAYOUTS - 1BD TYPICAL SUITE LAYOUTS - 1BD & 2 BD TYPICAL SUITE LAYOUTS - C 2BD TYPICAL SUITE LAYOUTS - D 3BD DETAIL PLANS - RES. LOBBY TYPICAL DETAILS - CONCRETE & MASONRY TYPICAL DETAILS - HERITAGE OPENINGS TYPICAL DOORS AND FRAMES TYPICAL DETAILS - FIRESTOPPING TYPICAL ENVELOPE DETAILS - PLAN 1 TYPICAL ENVELOPE DETAILS - PLAN 2

A-701 TYPICAL SUITE LAYOUTS - A STUDIO

BELOW GRADE DETAILS 1

BELOW GRADE DETAILS 2

A-814 AT GRADE DETAILS

AT GRADE DETAILS 3 ABOVE GRADE DETAILS 1 - EXISTING ABOVE GRADE SECTION DETAILS 2 ABOVE GRADE SECTION DETAILS 3 ABOVE GRADE SECTION DETAILS 4 ABOVE GRADE SECTION DETAILS 5 ABOVE GRADE SECTION DETAILS 6 MISC METALS + GATES

A-815 AT GRADE DETAILS 2

THIS DRAWING IS COPYRIGHTED AND MUST NOT BE USED, REPRODUCED, OR REVISED WITHOUT WRITTEN PERMISSION

ALL DIMENSIONS ARE IN FEET AND INCHES UNLESS OTHERWISE DO NOT SCALE THIS DRAWING

REPORT INCONSISTENCIES AND OMISSIONS TO THE CONSULTANT FOR CLARIFICATION BEFORE COMMENCING WITH THE WORK.

DEVIATIONS FROM THE CONTRACT DOCUMENTS WITHOUT WRITTEN APPROVAL FROM THE CONSULTANT ARE SUBJECT TO CORRECTION AT THE CONTRACTOR'S EXPENSE.

ARCHITECT BONIFACE OLEKSIUK POLITANO ARCHITECTS 180-510 NICOLA STREET VANCOUVER BC, V6G 3J7

Tel: 236.521.6568

This document has been digitally certified with digital certificate and encryption technology authorized by the Architectural Institute of BC and the Engineers and Seoscientists BC. The authoritative original has been transmitted to you in digital form. Any printed version can be relied upon as a true copy of the original when supplied by the architect, bearing images of the professional seal and digital certificate, or when printed from the digitally-certified electronic file provided by the architect.



## NORTHERN JUNK

1314 WHARF STREET

**COVER SHEET** 

CHECKED: SO/AP PLOT DATE: 2023-04-07 7:59:44 PM

A-000

19004C

Level	Name	Total Area (sf)	Total Area (m2)
LEVEL 00	CIRCULATION/SERVICE	1977 SF	183.6 m²
LEVEL 00	COMMERCIAL	3590 SF	333.5 m²
		5567 SF	517.2 m <sup>2</sup>
LEVEL 01	CIRCULATION/SERVICE	1042 SF	96.8 m²
LEVEL 01	COMMERCIAL	4850 SF	450.6 m <sup>2</sup>
		5893 SF	547.5 m <sup>2</sup>
LEVEL 02	CIRCULATION/SERVICE	830 SF	77.1 m²
LEVEL 02	RESIDENTIAL SUITE	6599 SF	613.1 m²
		7429 SF	690.2 m²
LEVEL 03	CIRCULATION/SERVICE	830 SF	77.1 m²
LEVEL 03	RESIDENTIAL SUITE	6599 SF	613.1 m <sup>2</sup>
		7429 SF	690.2 m²
LEVEL 04	CIRCULATION/SERVICE	830 SF	77.1 m²
LEVEL 04	RESIDENTIAL SUITE	6599 SF	613.1 m²
		7429 SF	690.2 m²
LEVEL 05	CIRCULATION/SERVICE	830 SF	77.1 m²
LEVEL 05	RESIDENTIAL SUITE	6599 SF	613.1 m <sup>2</sup>
		7429 SF	690.2 m <sup>2</sup>
ROOF LEVEL	CIRCULATION/SERVICE	141 SF	13.1 m²
		141 SF	13.1 m <sup>2</sup>
		41318 SF	3838.6 m <sup>2</sup>

	AREAS -COMMERCIAL							
Level								
LEVEL 01	COMMERCIAL	2339 SF	2339 SF	217.3 m²				
LEVEL 00	COMMERCIAL	2106 SF	2106 SF	195.7 m²				
LEVEL 01	COMMERCIAL	2511 SF	2511 SF	233.3 m²				
LEVEL 00	COMMERCIAL	1484 SF	1484 SF	137.9 m²				
		8440 SF	8440 SF	784 1 m²				

AREAS -RESIDENTIAL							
Level	Name	Area per Level	Total Area (sf)	Total Area (m2)			
<varies></varies>	CIRCULATION/SERVICE	6481 SF	6481 SF	602.1 m <sup>2</sup>			
<varies></varies>	RESIDENTIAL SUITE	26396 SF	26396 SF	2452.3 m²			
	·	32877 SF	32877 SF	3054.4 m²			

**UNIT TYPE SUMMARY** 

Level	Comments	Area Mark	Area	Area (m2)
1BD	T	T	T	
LEVEL 02	1BD	203	543 SF	50.4 m <sup>2</sup>
LEVEL 02	1BD	204	536 SF	49.8 m²
EVEL 02	1BD	208	467 SF	43.4 m²
LEVEL 02	1BD	209	529 SF	49.2 m²
LEVEL 03	1BD	303	543 SF	50.4 m²
EVEL 03	1BD	304	536 SF	49.8 m²
EVEL 03	1BD	308	467 SF	43.4 m²
LEVEL 03	1BD	309	529 SF	49.2 m²
EVEL 04	1BD	403	543 SF	50.4 m <sup>2</sup>
EVEL 04	1BD	404	536 SF	49.8 m²
LEVEL 04	1BD	408	467 SF	43.4 m²
EVEL 04	1BD	409	529 SF	49.2 m²
EVEL 05	1BD	503	543 SF	50.4 m²
EVEL 05	1BD	504	536 SF	49.8 m²
EVEL 05 5	1BD	508	529 SF	49.2 m <sup>2</sup>
PBD EVEL 02 EVEL 02 EVEL 03	2BD 2BD 2BD	202 212 212	832 SF 669 SF 669 SF	77.3 m <sup>2</sup> 62.1 m <sup>2</sup> 62.1 m <sup>2</sup>
EVEL 03	2BD	302	832 SF	77.3 m²
EVEL 04	2BD	402	832 SF	77.3 m²
EVEL 04	2BD	412	669 SF	62.1 m²
EVEL 05	2BD	502	832 SF	77.3 m²
EVEL 05	2BD	507	948 SF	88.1 m²
EVEL 05	2BD	511	669 SF	62.1 m²
LEVEL 02 LEVEL 03 LEVEL 04	3BD 3BD 3BD	201 301 401	851 SF 851 SF 851 SF	79.0 m <sup>2</sup> 79.0 m <sup>2</sup> 79.0 m <sup>2</sup>
LEVEL 04 LEVEL 05	3BD	501	851 SF	79.0 m <sup>2</sup>
ST LEVEL 02	ST	205	419 SF	39.0 m²
LEVEL 02 LEVEL 02	ST	205	419 SF 482 SF	44.8 m <sup>2</sup>
EVEL 02 EVEL 02	ST	207	481 SF	44.0 m <sup>2</sup>
EVEL 02 EVEL 02	ST	210	395 SF	36.7 m <sup>2</sup>
EVEL 02 EVEL 02	ST	211	396 SF	36.8 m <sup>2</sup>
EVEL 03	ST	305	419 SF	39.0 m²
EVEL 03	ST	306	482 SF	44.8 m²
EVEL 03	ST	307	481 SF	44.7 m <sup>2</sup>
EVEL 03	ST	310	395 SF	36.7 m <sup>2</sup>
EVEL 03	ST	311	396 SF	36.8 m²
EVEL 04	ST	405	419 SF	39.0 m²
EVEL 04	ST	406	482 SF	44.8 m²
EVEL 04	ST	407	481 SF	44.7 m <sup>2</sup>
EVEL 04	ST	410	395 SF	36.7 m <sup>2</sup>
v	ST	411	396 SF	36.8 m <sup>2</sup>
FVFI 04	U 1		419 SF	39.0 m <sup>2</sup>
	ST	1505		100.0111
EVEL 05	ST ST	505		
LEVEL 04 LEVEL 05 LEVEL 05	ST	506	482 SF	44.8 m²
LEVEL 05				

LEGAL DESCRIP	ΓΙΟΝ	MUNICIPAL ADDRESS
LOT 182F		1314+1318 WHARF STREET
BUILDING CODE	SYNOPSIS	
LEVEL 00-01 TO BE COMME NEW ADDITION OF 47 APAR	RCIAL SPACE AND RES TMENTS ABOVE AND T	TING VACANT 2-STOREY WAREHOUSE BUILDINGS. BIDENTIAL SERVICE AND LOBBY SPACES WITH A TO THE SOUTH OF THE EXISTING STRUCTURES FO ONE BELOW ACCESSED FROM WATER SIDE).
GOVERNING CODE:	BCBC 2018	
AUTHORITY HAVING JURIS	DICTION: CITY OF	VICTORIA
<b>HAP #</b> 00236		
OCCUPANCY (S):	GROUPS A2, C, D ,E	
NUMBER OF STOREYS:	ABOVE GRADE: 6 S	TOREYS BELOW GRADE: 0 STOREYS
HIGH BUILDING:	⊠ NO ☐ YES	
MEZZANINE(S):	⊠ NO ☐ YES	
BUILDING HEIGHT:	26.4m (above Wharf St.	
NUMBER OF FACING STRE	ETS / ACCESS ROUTES	: 1
BUILDING CLASSIFICATION	1:3.2.2.50	
TYPE OF CONSTRUCTION:		: COMBUSTIBLE PERMITTED TION: COMBUSTIBLE PERMITTED
SPRINKLER SYSTEM:	⊠ YES [	□NO
STANDPIPE REQUIRED:	⊠ YES [	□ NO
FIRE ALARM REQUIRED:	⊠ YES [	□ NO
BARRIER FREE PROVISION	S: XES [	□ NO
FIRE RESISTANCE RATING:	FIREWALLS: FLOORS: MEZZANINE: ROOF:	NONE
	LOAD BEARING WALL AND STRUCTURE:	S MUST HAVE A FIRE RESISTANCE RATING EQUA TO THAT OF THE SUPPORTED ASSEMBLY
EXTERIOR WALL CONSTI	RUCTION:	1 HOUR / 2 HOUR (FLOOR OF LEVEL 01 & 02)
	EVELS 1&2 AND A 1-HF	INPROTECTED OPENINGS; NORTH WALL WILL R FRR FOR LEVELS 3-6 ALONG NORTH PROPERTY UCTION
NOTES:		

INNER HARBOUR HERITAGE DISTRICT
1218 m2
1375 m2
3838.6 m2
784.2 m2
3.16
65.5%
34.5%
19.1 m
5 STOREYS FROM WHARF (6 FROM HARBOUR
C
55 res + 6 Commercia
AN)
0 m
15.51 m
0 m
0 m
NIT TYPE TABLE)
47
STUDIO (ST), 1BD, 2BD, 3BE
C
36.7 sqn



Boniface Oleksiuk Politano Architects





### ISSUED FOR

- A 2022-06-24 BUILDING PERMIT APPLICATION B 2022-09-29 BUILDING PERMIT APPLICATION
- **REVISION 1** C 2022-10-14 ISSUED FOR TENDER
- D 2023-04-09 BUILDING PERMIT APPLICATION REVISION 3

## **IMPERIAL**

THIS DRAWING IS COPYRIGHTED AND MUST NOT BE USED, REPRODUCED, OR REVISED WITHOUT WRITTEN PERMISSION.

ALL DIMENSIONS ARE IN FEET AND INCHES UNLESS OTHERWISE VERIFY DIMENSIONS.

DO NOT SCALE THIS DRAWING. REPORT INCONSISTENCIES AND OMISSIONS TO THE CONSULTANT

FOR CLARIFICATION BEFORE COMMENCING WITH THE WORK.

DEVIATIONS FROM THE CONTRACT DOCUMENTS WITHOUT WRITTEN APPROVAL FROM THE CONSULTANT ARE SUBJECT TO CORRECTION AT THE CONTRACTOR'S EXPENSE.

ARCHITECT BONIFACE OLEKSIUK POLITANO ARCHITECTS 180-510 NICOLA STREET VANCOUVER BC, V6G 3J7 Tel: 236.521.6568 Email: info@bop.ca

This document has been digitally certified with digital certificate and encryption technology authorized by the Architectural Institute of BC and the Engineers and Geoscientists BC. The authoritative original has been transmitted to you in digital form. Any printed version can be relied upon as a true copy of the original when supplied by the architect, bearing images of the professional seal and digital certificate, or when printed from the digitally-certified electronic file provided by the architect.





## NORTHERN JUNK

1314 WHARF STREET

PROJECT DATA

DRAWN: LM PLOT DATE: 2023-04-07 7:59:45 PM

CHECKED: SO/AP

19004C

### **ANNOTATIONS SYMBOLS ABBREVIATIONS** ROOM ACC **ACCESSIBLE** ROLLING DOOR ACFL ACCESS FLOOR HOSE BIB **DRAWING ANNOTATION SYMBOLS** RAPID ROLL DOOR ACT ACOUSTICAL CEILING TILE **HOLLOW CORE RSF** RESILIENT SHEET FLOORING ΑD AREA DRAIN HANDICAP RUB ADJ **ADJACENT** HCW HOLLOW CORE WOOD RAINWATER LEADER AFF ABOVE FINISHED FLOOR HDHANGAR DOOR LEVEL NAME ALUM HDR DETAIL NUMBER **ALUMINUM HEADER** S/A SUPPLY AIR NAME -ANNP **HDWD** REFERENCE LEVEL TAG ANNUNCIATOR PANEL HARDWOOD SAM SELF-ADHERED MEMBRANE SIM / TYP / REV ANOD **HDWR ANODIZED** HARDWARE SOLID CORE LEVEL ELEVATION **APPROXIMATE HOLLOW METAL** PLAN DETAIL REFERENCE SCW SOLID CORE WOOD **ARCH** HOLLOW METAL INSULATED ARCHITECTURA SD SINGLE SWING DOOR DRAWING NUMBER AUTO **AUTOMATIC** HONEY-COMB HO HEIGHT ELEVATION TAG SQUARE FEET AVB AIR VAPOUR BARRIER HOR **HORIZONTAL** SFL SAFETY FLOOR HPC HIGH PERFORMANCE COATING AVM AIR VAPOUR MOISTURE BARRIER SECTION NUMBER STRUCTURAL GLAZING HOUR REFERENCE SHEET SPOT ELEVATION TAG **HSKG** HOUSEKEEPING SIM / TYP / REV SIAMESE CONNECTION **BIFOLD DOOR** HSS HOLLOW STEEL SECTION SIMILAR **BUILDING SECTION REFERENCE** BLDG BUILDING **HEIGHT ROOM TAG** SLIDING DOOR DRAWING NUMBER BM BEAM **HVAC** HEATING / VENTING / AIR CONDITIONING ROOM NAME ← STEEL METAL CARRIER ROOM NAME B/O **BOTTOM OF** HVY SOG SLAB ON GRADE **ROOM NUMBER** BOL **BOLLARD** HW HOT WATER 000.00 m2 STAND PIPE **ROOM AREA** BUR **BUILT UP ROOFING** SPECIFICATION REFERENCE INSIDE DIAMETER SIM / TYP / REV SQ SQUARE CAB INFO CABINET INFORMATION STAINLESS STEEL DOOR NUMBER TAG **WALL / DETAIL SECTION REFERENCE** CB **CATCH BASIN** INSUL **INSULATION** 101 SSM 0000 SOLID SURFACING MATERIAL CD INT **COILING DOOR** INTERIOR DRAWING NUMBER STONE CG IMP **INSULATED METAL PANEL CORNER GUARD** STC SOUND TRANSMISSION CLASS CIP ISO CAST IN PLACE **POLYISOCYANURATE** STD STANDARD REFERENCE **EXTERIOR WINDOW TAG** CJ **CONTROL JOINT** STL STEEL SIM / TYP / REV C/L CENTRE LINE JAN JANITOR CLOSET **STOR** STORAGE **ELEVATION NUMBER** CLG CEILING STRUC STRUCTURAL EXTERIOR ELEVATION REFERENCE CLK CHAIN LINK FENCE KITCHEN SUSP SUSPENDED BL01 INTERIOR WINDOW CLR **CLEARANCE** DRAWING NUMBER **BORROWED LITE TAG** CMP **COMPOSITE METAL PANEL** LENGTH TO BE DETERMINED CMU CONCRETE MASONRY UNIT LAV LAVATORY TRENCH DRAIN DRAWING NUMBER COL LINO LINOLEUM COLUMN TEL **TELEPHONE REVISION TAG** REFERENCE COM **CUSTOMERS OWN MATERIAL** LIVE LOAD **TEMP TEMPORARY** SIM / TYP / REV CONC CONCRETE L'SCAPE LANDSCAPE TERR TERRAZZO CONSTRUCTION CONST LOUVER LVR ( A00.00 ) INTERIOR ROOM ELEVATION REFERENCE TMP TEXTURED METAL PANEL **KEYNOTE TAG** CONT **CONTINUOUS** T/O TOP OF ELEVATION NUMBER CORR CORRIDOR METER TOC TOP OF CURB FLOOR ASSEMBLY TAG CPT MATL CARPET **MATERIAL** TOF TOP OF FLOOR CPT-T CARPET TILE MAX MAXIMUM TOS TOP OF STEEL CT **WALL / PARTITION ASSEMBLY CERAMIC TILE** MECH **MECHANICAL** TPO THERMOPLASTIC POLYOLEFIN MED CW **CURTAIN WALL** MEDIUM TAG TRANSITION STRIP C/W COMPLETE WITH MEL MELAMINE TYPICAL **ROOF ASSEMBLY TAG** $\langle R_{-} \rangle$ CS **COUNTER SHUTTER** MEP MECHANICAL, ELECTRICAL AND PLUMBING TSG TEMPERED SAFETY GLASS CP **COMMUNICATIONS PANEL** MEZZ PLAN / SECTION **MEZZANINE** TPG TEMPERED GLAZING UNIT MINERAL FIBRE NORTH INDICATOR **CEILING ASSEMBLY TAG** DD MFR **DOUBLE SWING DOOR MANUFACTURER** U/G UNDER GROUND DEG **DEGREES MANHOLE** UNO UNLESS NOTED OTHERWISE **CEILING ASSEMBLY** DEMO DEMOLITION MINIMUM U/S UNDERSIDE DF DRINKING FOUNTAIN MISC **MISCELLANEOUS** CEILING HEIGHT A.F.F MLDG DIAMETER MOULDING VENEER DIM MLWK SEE ALSO ROOM FINISH SCHEDULE **DIMENSION** MILLWORK VAPOUR BARRIER DEAD LOAD **MILLIMETER** VINYL COMPOSITE TILE STAIR NUMBER TAG DOWN METAL PANEL **VERT** VERTICAL DP DEPTH MRR MIRROR **VEST** VESTIBULE PROPERTY LINE DR **DOOR** MTD MOUNTED **VERIFY IN FIELD** DW **DISH WASHER** MTL METAL VG VISION GLASS DWG DRAWING NOT APPLICABLE **FINISHES ANNOTATION SYMBOLS ANNOTATION SYMBOLS** WIDTH EΑ EACH NO FRAME (FRAMELESS) WC WALL COVERING EJ **EXPANSION JOINT** NOT IN CONTRACT W/C WATER CLOSET AREA DRAIN (SEE MECHANICAL) FINISH SET OUT / START EL **ELEVATION** NUMBER WD WOOD POINT ELEC **ELECTRICAL** NTS NOT TO SCALE WIRED GLASS FLOOR DRAIN (SEE MECHANICAL) ELEV **ELEVATOR** ( C1 ) FINISH TYPE TAG WATER HEATER EMM EXPANDED METAL MESH O/C ON CENTRE ROOF DRAIN (SEE MECHANICAL) WATERPROOF EP **ELECTRICAL PANEL** OD **OUTSIDE DIAMETER** WALL PROTECTION MW000 MILLWORK TYPE TAG **EPDM** ETHYLENE PROPYLENEDIENE M-CLASS OH OVERHEAD DOOR WASHROOM DECK DRAIN (SEE MECHANICAL) (ROOFING) O/H OVERHEAD WOOD VENEER EPX **EPOXY** OPG OPAQUE GLASS <EQ000> EQUIPMENT TYPE TAG PLANTER DRAIN (SEE MECHANICAL) WINDOW WALL/DOOR EQ **EQUAL** OPNG **OPENING** ES **EMERGENCY SHOWER** OPP OPPOSITE EXTRA HEAVY SD SD X-HVY GAS CONNECTION (SEE MECHANICAL) ACCESSORY TYPE TAG EXST **EXISTING** OWSJ OPEN WEB STEEL JOIST EXP **EXPOSED** OS OWNER SUPPLIED EXP-S HOSE BIB (SEE MECHANICAL) **EXPOSED STRUCTURE** 00 FINISH FLOOR TRANSITION EXT **EXTERIOR** PAINT (colour) RAIN WATER LEADER (SEE MECHANICAL) \ A0.00 EWS EYE WASH STATION POWDER COAT P.CONC POLISHED CONCRETE PIPE PENETRATION LOCATION. REFER TO **FRAME** PLUMBING FOR SIZING. PLANTER DRAIN FAAP FIRE ALARM ANNUNCIATOR PANEL PERP PERPENDICULAR DAVIT BASE (DB) /ROOF ANCHOR (RA)/WALL **GLASS FINISH** FAB **FABRIC** PHASE CHOR (WA)/ LIFE LINE. FBR FIBREGLASS PROPERTY LINE CAST IN SLAB JUNCTION BOX LOCATION. FD FLOOR DRAIN PLAM PLASTIC LAMINATE EXTERIOR MATERIAL TAG SEE ELECTRICAL. FC FLASH COVE **PLYWD** PLYWOOD FDN **FOUNDATION** PAINTED METAL PMSTRUCTURAL SLAB SLOPED. FE FIRE EXTINGUISHER **POLYSTYRENE** FDC FIRE DEPARTMENT CONNECTION POLY POLYETHYLENE FFE FINISH FLOOR ELEVATION POLY-U POLYURETHANE FF&E FURNITURE FIXTURES & EQUIPMENT **PREFAB PREFABRICATED** FHC FIRE HOSE CABINET **PREFIN** PREFINISHED FLR **FLOOR** BOLLARD (SEE LANDSCAPE) PRESSED STEEL F/O FACE OF PSFR PRESSED STEEL FRAME FOC FACE OF CONCRETE PSI PRESSED STEEL INSULATED FIRE HYDRANT (SEE CIVIL) FOG FACE OF GLAZING PRESSURE TREATED FOS FACE OF STUD PTD PAINTED FP FRAME PROTECTION ELECTRICAL PANEL (SEE ELEC) FRR FIRE RESISTANCE RATING QUARRY TILE FT FOOT/FEET FTG FROSTED GLASS CP COMMUNICATIONS PANEL (SEE ELEC) RADIUS RETURN AIR G() GLASS (type) RUBBER BASE PM PLUMBING MANIFOLD (SEE MECH) GAUGE RCP REFLECTED CEILING BASE GALV GALVANIZED RD **ROOF DRAIN** GB GRAB BAR **REVOLVING DOOR** GBN **GARBAGE BIN REINF** REINFORCED GC **GENERAL CONTRACTOR** REF REFERENCE GL GLASS / GLAZING REFR REFRIGERATOR GRD GROUND REQ'D REQUIRED GWB GYPSUM WALL BOARD RES RESILIENT FLOORING GEORGIAN WIRE GLASS

REV

REVISION

## **GENERAL NOTES**

### **GENERAL NOTES:**

- 1. SEE CODE REPORT FOR COMPLETE CODE ANALYSIS AND PROJECT DESCRIPTION
- 2. REFER TO OWNER SUPPLIED SITE SURVEY FOR ALL EXISTING CONDITIONS AND SITE BOUNDARIES.
- 3. REFER TO OWNER SUPPLIED GEOTECHNICAL REPORT FOR ALL SOIL CONDITIONS AND OTHER RELATED INFORMATION.
- 4. SEE MECHANICAL ENERGY MODEL REPORT FOR ENERGY COMPLIANCE 5. SEE SPECIFICATIONS FOR DELEGATED DESIGN REQUIREMENTS FOR ITEMS INCLUDING BUT NOT LIMITED TO: WALL CLADDING SYSTEMS, MASONRY LINTELS, TIES AND LEDGERS, STEEL STUD FRAMING, SUSPENDED CEILINGS, WALLS ACTING AS GUARDS + FIRESTOPPING SYSTEMS.
- 6. FOR DETAILED INTERIOR DESIGN REFER TO INTERIOR DRAWINGS (ID)
- 7. FOR DETAILED LANDSCAPE DESIGN REFER TO LANDSCAPE DRAWINGS
- 8. DIMENSIONS SHOWN TO FACE OF CONCRETE, CENTERLINE OF COLUMN, CENTERLINE OF WINDOW/DOOR OR EDGE OF STEEL STUD FRAMING U.N.O.
- EXPOSED INTERIOR COLUMNS TO BE FINISHED PER INTERIOR DESIGN. PROVIDE MOCKUP OF COLUMN FINISHES FOR REVIEW.
- 10. THE CONSOLIDATION SET (CS) IS ISSUED DURING THE CONSTRUCTION PHASE OF THE PROJECT AND CONTAINS A COMPILATION OF ALL DOCUMENTS ISSUED DURING THE BID PERIOD INCLUDING ADDENDA, BID REVISIONS (IF ANY) AND OTHER CHANGES FOR THE CONVENIENCE OF THE PROJECT PARTICIPANTS. IN THE CASE OF A DIFFERENCE BETWEEN THE CONSOLIDATION SET AND THE CONTRACT DOCUMENTS, INTERPRETATION FOR CONTRACT PURPOSES WILL BE BASED ON THE ORIGINALLY ISSUED BID DOCUMENTS, ADDENDA AND BID REVISIONS. BOP MAKES NO WARRANTY OR ASSURANCE AS TO THE COMPLETENESS OF THE CONSOLIDATION SET OF DOCUMENTS.
- 11. SEE LANDSCAPE FOR ALL OFF SITE WORKS.
- 12. SEE LANDSCAPE FOR ALL PLANTER WALLS, PAVING, GRADING, SITE FURNISHINGS, FENCING, STAIRS, KICKRAILS AND HANDRAILS.
- 13. ALL LANDSCAPE CONCRETE AND PLANTER WALLS TO BE ARCHITECTURALLY EXPOSED CONCRETE (AEC).
- 14. ALL INTERIOR PARTITIONS TO EXTEND TO U/S OF STRUCTURE ABOVE UNLESS NOTED OTHERWISE
- 15. REFER TO STRUCTURAL FOR CONTROL JOINTS AND SAW CUTS.
- 16. ALL PARKING STALLS / LINES / ARROWS / SIGNAGE / HATCHING TO BE PAINTED. SEE TYPICAL PARKING PAINTING DETAILS. 17. INSTALL FIRE EXTINGUISHERS TO NFPA-10 + BCBC REQUIREMENTS (SEE FIRE PROTECTION DRAWINGS), REVIEW LOCATIONS WITH CONSULTANT
- 18. ALL ROOF ANCHORS AND LIFE LINE SYSTEMS ARE SHOWN SCHEMATICALLY. LOCATIONS, TYPES, QUANTITIES DESIGNED BY ROOF ANCHOR TRADE AS COMPLETE ENGINEERED SYSTEM.

### **GENERAL SLAB PLAN NOTES**

- REFER TO STRUCTURAL DWGS FOR SLAB AND COLUMN CONSTRUCTION + SIZING. REFER TO STRUCTURAL DWGS FOR STEEL COLUMN AND BRACING CONSTRUCTION
- SEE STRUCTURAL DWGS FOR SLAB THICKNESS.
- 4. ALL DIMENSIONS TO FACE OR CENTERLINE OF WALL COLUMN OR SLAB EDGE.
- 5. REFER TO MECHANICAL AND PLUMBING DRAWINGS TO CONFIRM SIZE AND LOCATION OF SLAB PENETRATIONS. 6. SEE ELECTRICAL FOR JUNCTION BOX LOCATIONS AND SLAB PENETRATIONS.
- 7. COORDINATE WITH ALUMINUM GLAZING CONTRACTOR FOR EMBED ANCHORING FOR GLAZING.
- 8. COORDINATE WITH BUILDING MAINTENANCE SYSTEM CONTRACTOR FOR LOCATIONS OF BUILDING MAINTENANCE AND LIFE LINE ANCHOR LOCATIONS.
- 9. REFER TO LANDSCAPE FOR PLANTER WALLS AND CONSTRUCTION.
- 10. ALL SLOPES MUST BE CONSTRUCTED AS INTEGRAL TO THE SLAB AND CANNOT BE APPLIED AS TOPPING. MINIMUM SLOPE OF 2% REQUIRED AWAY FROM BUILDING.
- 11. ALL EXPOSED ROUND COLUMNS (BOTH INTERIOR AND EXTERIOR) AND LANDSCAPE CONCRETE SHALL BE ARCHITECTURALLY EXPOSED CONCRETE (AEC). 12. COORDINATE WITH HARDWARE SCHEDULE FOR ALL DOOR HARDWARE BLOCK-OUTS AS REQUIRED.

### **GENERAL CEILING PLAN NOTES:**

- LOCATIONS OF LIGHTING FIXTURE AND MECHANICAL GRILLE ARE DIMENSIONED FROM THE CENTER LINES OF FIXTURE & GRILL TO FACE OF STUD OR FACE OF
- STRUCTURE UNLESS NOTED OTHERWISE.
- 2. REFER TO MECHANICAL AND ELECTRICAL FOR DETAIL AND SCHEDULES.
- 3. ALL SUSPENDED GWB CEILINGS TO BE LATERALLY BRACED TO THE STRUCTURE. 4. SPRAY FIBER INSULATION TO EXTEND 3' TO 4' BEYOND HEATED SPACE ABOVE, TYP.
- REFER TO ARCHITECTURAL ROOF ASSEMBLY SCHEDULE FOR BALCONY/TERRACE SOFFIT FINISH UNLESS NOTED OTHERWISE.

### **GENERAL ACCESSIBILITY NOTES:**

1. ACCESSIBILITY PROVIDED IN ACCORDANCE WITH BCBC 2018 AND/OR CSA B651-12

### FLAME SPREAD AND RATING FOR WALL AND CEILING FINISHES:

- 1. MINIMUM FLAME SPREAD RATINGS ALL WALL AND CEILING FINISHES TO BE NOT MORE THAN 150. SEE FURTHER REQUIREMENTS FOR SPECIFIC AREAS. PROVIDE SUBMITTED DATA FOR FSR FOR FINISHES (E.G. VINYL WALL COVERING, WOOD FINISHES ETC.).
- 2. EXIT AND EXIT STAIRS MAXIMUM FLAME SPREAD RATING 25.
- DOOR MAXIMUM FLAME SPREAD RATING 200.
- 4. SERVICE MECHANICAL, ELECTRICAL, AND STORAGE ROOMS' MAXIMUM FLAME SPREAD RATING 25.

## FIRE STOPPING AND FIRE BLOCKING REQUIREMENTS:

- FIRE STOP SYSTEMS MUST MEET CAN/ULC S115 REQUIREMENTS AS PER BCBC 2018 SUBMITTAL REQUIRED FOR APPROVAL
- 2. FIRE BLOCKING MATERIALS MUST MEET CAN/ULC S101 REQUIREMENTS AS PER BCBC 2018 SUBMITTAL REQUIRED FOR APPROVAL 3. ALL PENETRATIONS THROUGH FIRE SEPARATIONS MUST BE FIRESTOPPED OR ENCLOSED IN APPROPRIATE SHAFTS OR EQUIPPED WITH APPROVED CLOSURES.
- 4. ALL PENETRATIONS FROM WITHIN ONE RATED ASSEMBLY TO ANOTHER MUST BE FIRESTOPPED AT THE INTERSECTION WITH APPROVED SYSTEM.
- 5. ALL PIPES, CHASES OR DUCTS PASSING THROUGH ASSEMBLIES WITH FIRE RESISTANCE RATINGS OR SEPARATE CONCEALED SPACES MUST BE FIRESTOPPED OR FIRE BLOCKED WITH APPROVED SYSTEMS.
- 6. ALL PENETRATIONS THROUGH FIRE WALLS AND HORIZONTAL FIRE SEPARATIONS (BCBC SENTENCE 3.2.1.2.) MUST BE FIRE STOPPED WITH FT RATING. 7. FIRE TAPE OR FIRE CAULK ALL SHAFT GWB JOINTS.

### SIGNAGE NOTES (INCLUDING BUT NOT LIMITED TO):

- 1. STREET ADDRESS AT FRONT ENTRANCE OF THE BUILDING (I.E. FIRE DEPARTMENT RESPONSE POINT)
- CRU STREET NUMBERING.
- 3. ELEVATOR NUMBERING/LETTERING
- 4. SIGNAGE INDICATING DESIGNATED FIREFIGHTER'S ELEVATOR(S). DISABLED PERSON IDENTIFICATION (WHEELCHAIR SYMBOL) AT PARKING STALLS FOR PERSONS WITH DISABILITIES.
- "FIRE DOOR KEEP CLOSED" MOUNTED ON THE FLOOR AREA SIDE OF ALL EXIT DOORS
- 7. FLOOR LEVEL NUMBERING MOUNTED INSIDE ALL EXIT STAIRS. WITH GRAPHICS CONFORMING TO SENTENCES 3.4.6.18 & 3.4.6.19 OF THE BCBC.
- 8. "IN CASE OF FIRE USE EXIT STAIRS. DO NOT USE ELEVATOR" (TEXT AND ASSOCIATED DIAGRAM OF PERSON USING EXIT STAIR) MOUNTED ADJACENT TO CALL BUTTONS ON EACH FLOOR.

STANDARD BICYCLE PARKING STALL SIZES

HORIZONTAL

CITY OF VICTORIA MINIMUM BIKE STALL DIMENSIONS

MINIMUM AISLE 1500mm

MINIMUM CLEARANCE FROM DOOR 600mm

- 9. "INSTRUCTIONS TO OCCUPANTS IN CASE OF FIRE" (TEXT AND ASSOCIATED FLOOR PLAN). 10. ILLUMINATED EXIT SIGNS AND DIRECTIONAL EXIT SIGNS TO BE OPERABLE AND VISIBLE.
- 11. GRAPHICS ON THE FIRE ALARM ANNUNCIATOR PANEL TO BE COMPLETE AND ADDITIONAL WAYFINDING SIGNAGE AT EXTERIOR DOORS PROVIDING FIRE DEPARTMENT ACCESS (I.E., "ACCESS TO PARKADE," ETC.)
- 12. ALSO REFER TO DETAILED REQUIREMENTS OF SECTION 3.8 OF THE BCBC FOR SIGNAGE REQUIREMENTS RELATED TO BARRIER-FREE DESIGN/ACCESS. 13. LOADING BAY AND WALKWAY SIGNAGE INDICATING "NO STORAGE/DO NOT BLOCK" ETC.
- 14. NO SMOKING SIGNAGE.
- 15. AMENITY ROOM SIGNAGE.
- 16. SUITE AND ROOM NUMBERING

**CODE COMPLIANCE LEGEND** 

ZERO-HOUR FIRE PARTITION

ONE-HOUR FIRE PARTITION

NINETY MINUTE FIRE PARTITION

TWO-HOUR FIRE PARTITION

\_..\_..

### This document has been digitally certified with digital certificate and encryption technology authorized by the Architectural Institute of BC and the Engineers and eoscientists BC. The authoritative original has been transmitted to you in digital form. Any printed version can be relied upon as a true copy of the original when supplied by the architect, bearing images of the professional seal and digital certificate, or when printed from the digitally-certified electronic file provided by the architect.

**Boniface Oleksiuk** 

PROPERTIES LTD

RELIANCE

A 2022-06-24 BUILDING PERMIT APPLICATION

B 2022-09-29 BUILDING PERMIT APPLICATION

D 2023-04-09 BUILDING PERMIT APPLICATION

THIS DRAWING IS COPYRIGHTED AND MUST NOT BE USED,

REPRODUCED, OR REVISED WITHOUT WRITTEN PERMISSION

ALL DIMENSIONS ARE IN FEET AND INCHES UNLESS OTHERWISE

REPORT INCONSISTENCIES AND OMISSIONS TO THE CONSULTANT

WRITTEN APPROVAL FROM THE CONSULTANT ARE SUBJECT TO

Email: info@bop.ca

FOR CLARIFICATION BEFORE COMMENCING WITH THE WORK.

DEVIATIONS FROM THE CONTRACT DOCUMENTS WITHOUT

CORRECTION AT THE CONTRACTOR'S EXPENSE

BONIFACE OLEKSIUK POLITANO ARCHITECTS

**REVISION 3** 

**REVISION 1** 

C 2022-10-14 ISSUED FOR TENDER

ISSUED FOR

**IMPERIAL** 

**VERIFY DIMENSIONS** 

**ARCHITECT** 

Tel: 236.521.6568

180-510 NICOLA STREET

VANCOUVER BC, V6G 3J7

DO NOT SCALE THIS DRAWING.

### SEAL



## NORTHERN JUNK

### 1314 WHARF STREET

## ANNOTATIONS, SYMBOLS AND **ABBREVIATIONS**

DRAWN: LM PLOT DATE: 2023-04-07 7:59:48 PM

19004C

TYPE MARK	TYPE NAME	TYPE IMAGE	ASSEMBLY	FRR	STC	COMMENTS
R1A	INSULATED ROOF - PAVERS	2%	<ul> <li>PAVER ON PEDESTAL SYSTEM. (SEE LANDSCAPE)</li> <li>FILTER CLOTH</li> <li>5" RIGID XPS INSULATION</li> <li>DRAINAGE MAT C/W FILTER CLOTH &amp; ROOT BARRIER AT PLANTED AREAS</li> <li>CONTINUOUS 2 PLY SBS ROOFING MEMBRANE</li> <li>SLOPED STRUCTURAL SLAB MIN 2% (SEE STRUCTURAL)</li> <li>SEE FINISH SCHEDULE FOR INTERNAL FINISH</li> </ul>	1HR	-	BCBC D-2.1.1 (MIN. 90mm)
R1B	INSULATED EXTENSIVE ROOF	2%	SEDUM MAT AND GROWING MEDIUM (SEE LANDSCAPE) FILTER CLOTH  '5" RIGID XPS INSULATION DRAINAGE MAT C/W FILTER CLOTH & ROOT BARRIER AT PLANTED AREAS CONTINUOUS 2 PLY SBS ROOFING MEMBRANE SLOPED STRUCTURAL SLAB MIN 2% (SEE STRUCTURAL) SEE FINISH SCHEDULE FOR INTERNAL FINISH	1HR	-	BCBC D-2.1.1 (MIN. 90mm)
R1C	INSULATED ROOF - BALLAST	2% 2% 4	ROOFING BALLAST, 4" MINIMUM (SEE LANDSCAPE) FILTER CLOTH  S" RIGID XPS INSULATION DRAINAGE MAT C/W FILTER CLOTH & ROOT BARRIER AT PLANTED AREAS CONTINUOUS 2 PLY SBS ROOFING MEMBRANE SLOPED STRUCTURAL SLAB MIN 2% (SEE STRUCTURAL) SEE FINISH SCHEDULE FOR INTERNAL FINISH	1HR	-	BCBC D-2.1.1 (MIN. 90mm)
R2	CONCRETE SANDWICH SLAB	2%	CONCRETE TOPPING REFER TO STRUCTURAL REFER TO LANDSCAPE FOR PATTERN RIGID INSULATION AS REQUIRED BY STRUCTURAL DRAINAGE MAT CONTINUOUS 2-PLY SBS ROOFING MEMBRANE CONCRETE SLAB, SLOPE TO DRAIN (SEE STRUCTURAL)	1HR	-	BCBC D-2.1.1 (MIN. 90mm)
R2A	CONCRETE SANDWICH SLAB - INSULATED	2%	CONCRETE TOPPING REFER TO STRUCTURAL REFER TO LANDSCAPE FOR PATTERN Z" RIGID XPS INSULATION DRAINAGE MAT CONTINUOUS 2-PLY SBS ROOFING MEMBRANE CONCRETE SLAB, SLOPE TO DRAIN (SEE STRUCTURAL)	1HR		AT WHARF STREET OVER BASEMENT
R3	INSULATED ROOF - GARDEN	18" MIN. DEPTH	PLANTING AND SOIL/GROWING MEDIUM (SEE LANDSCAPE) FILTER CLOTH  5" RIGID XPS INSULATION DRAINAGE MAT C/W FILTER CLOTH & ROOT BARRIER AT PLANTED AREAS CONTINUOUS 2 PLY SBS ROOFING MEMBRANE CONCRETE SLAB, SLOPED TO DRAIN (SEE STRUCTURAL)	1HR	-	BCBC D-2.1.1 (MIN. 90mm)
R4	CONCRETE SLAB w/2 PLY MEMBRANE	2%	CONTINUOUS 2-PLY SBS C/W GRANULATED CAP-SHEET (LIGHT GREY) AND VENTED BASE SHEET     CONCRETE SLAB, SLOPED TO DRAIN (SEE STRUCTURAL)	1HR	-	BCBC D-2.1.1 (MIN. 90mm)  LEVEL 06 - STAIR ROOF
R5	INSULATED ROOF - ELEVATOR SHAFT	2%	CONCRETE PAVERS FILTER CLOTH RIGID XPS INSULATION DRAINAGE MAT C/W FILTER CLOTH & ROOT BARRIER AT PLANTED AREAS CONTINUOUS 2 PLY SBS ROOFING MEMBRANE CONCRETE SLAB, SLOPED TO DRAIN (SEE STRUCTURAL)	1HR	-	BCBC D-2.1.1 (MIN. 90mm)  ELEVATOR SHAFT

**ROOF TYPES** 

	CONCRETE AND MASONRY TYPES						
TYPE MARK	TYPE NAME	TYPE IMAGE	ASSEMBLY	FRR	STC	COMMENTS	
C1	CONCRETE WALL		CAST IN PLACE CONCRETE WALL. THICKNESS VARIES PER STRUCTURAL.	2 HR	-	BCBC D-2.1.1 (MIN. 113mm)	
C2A	CONCRETE FOUNDATION WALL		CONTINUOUS DRAIN MAT C/W FILTER FABRIC CONTINUOUS SBS WATERPROOF MEMBRANE CAST IN PLACE CONCRETE WALL. THICKNESS VARIES PER STRUCTURAL. PAINTED	-	-		
C2B	CONCRETE FOUNDATION WALL W/EXT INSULATION		2" EXT. XPS RIGID INSULATION     CONTINUOUS DRAIN MAT C/W FILER FABRIC     CONTINUOUS SBS WATERPROOF MEMBRANE     CAST IN PLACE CONCRETE WALL. THICKNESS VARIES PER STRUCTURAL.     FINISH AS NOTED	-	-		
C2C	EXST MASONRY FOUNDATION WALL W/EXT INSULATION		2" EXT. XPS RIGID INSULATION     CONTINUOUS DRAIN MAT C/W FILER FABRIC     CONTINUOUS SBS WATERPROOF MEMBRANE     ALLOW FOR PARGING TO EXTERIOR FACE OF EXISTING RUBBLE MASONRY WALL (SHOTCRTE w/GALVANIZED MESH)     EXISTING MASONRY WALL. THICKNESS VARIES.     FINISH AS NOTED	-	-		
C3	CONCRETE ELEVATOR PIT WALL		CAST IN PLACE CONCRETE WALL. THICKNESS VARIES PER STRUCTURAL. INCLUDING CRYSTALLINE WATERPROOF ADMIXTURE IN CONCRETE	-	-	FROM TOP OF SLAB ON GRADE TO BOTTOM OF ELEVATOR PIT IN ALL LOCATIONS, INCLUDING PIT FLOOR	
M1	CMU RATED WALL		• 8" CMU BLOCK WALL	2HR	-	BXUVC.U905  REFER TO STRUCTURAL DRAWINGS FOR CMU CONNECTIONS AND LOCATIONS OF REQ'D INFILL	
M2	CMU UNRATED WALL		• 8" CMU BLOCK WALL	-	-	REFER TO STRUCTURAL DRAWINGS FOR CMU CONNECTIONS AND LOCATIONS OF REO'D INFILL	

REQ'D INFILL

<b>EXTERIOR</b>	WALL	TYPES
	IIAFF	IIIE

TYPE MARK	TYPE NAME	TYPE IMAGE	ASSEMBLY	FRR	STC	COMMENTS
W1A	BRICK MASONRY CLADDING ON METAL STUD FRAMING		<ul> <li>3 5/8" MASONRY FACE BRICK (C/W SS TIES AND FASTENERS, TYP.)</li> <li>1" AIR SPACE</li> <li>5" SEMI-RIGID MINERAL FIBRE INSULATION</li> <li>CONTINUOUS SELF ADHERED VAPOUR-PERMEABLE AIR/MOISTURE BARRIER</li> <li>5/8" EXT GWB SHEATHING</li> <li>3 5/8" STEEL STUD WITH CONTINUOUS BATT INSULATION</li> <li>CONTINUOUS 6MM POLY SHEET AIR/VAPOUR BARRIER (TYP.)</li> <li>5/8" GWB</li> </ul>	1HR	-	BCBC DESIGN S1B
W1B	BRICK MASONRY CLADDING ON METAL STUD FRAMING		<ul> <li>3 5/8" MASONRY FACE BRICK (C/W SS TIES AND FASTENERS, TYP.)</li> <li>1" AIR SPACE</li> <li>5" SEMI-RIGID MINERAL FIBRE INSULATION</li> <li>CONTINUOUS SELF ADHERED VAPOUR-PERMEABLE AIR/MOISTURE BARRIER</li> <li>5/8" EXT GWB SHEATHING</li> <li>6" STEEL STUD WITH CONTINUOUS BATT INSULATION</li> <li>CONTINUOUS 6MM POLY SHEET AIR/VAPOUR BARRIER (TYP.)</li> <li>5/8" GWB</li> </ul>	-	-	
W1C	TERRACOTTA ON METAL STUD FRAMING		<ul> <li>30mm (1 1/8") TERRACOTTA MASONRY UNIT</li> <li>1" AIR SPACE</li> <li>5" SEMI-RIGID MINERAL FIBRE INSULATION</li> <li>THERMALLY BROKEN GIRT SYSTEM</li> <li>CONTINUOUS SELF ADHERED VAPOUR-PERMEABLE AIR/MOISTURE BARRIER</li> <li>5/8" EXT GWB SHEATHING</li> <li>3 5/8" STEEL STUD WITH CONTINUOUS BATT INSULATION</li> <li>CONTINUOUS 6MM POLY SHEET AIR/VAPOUR BARRIER (TYP.)</li> <li>5/8" GWB</li> </ul>	-	-	
W1D	TERRACOTTA ON METAL STUD FRAMING		<ul> <li>30mm (1 1/8") TERRACOTTA MASONRY UNIT</li> <li>1" AIR SPACE</li> <li>5" SEMI-RIGID MINERAL FIBRE INSULATION</li> <li>THERMALLY BROKEN GIRT SYSTEM</li> <li>CONTINUOUS SELF ADHERED VAPOUR-PERMEABLE AIR/MOISTURE BARRIER</li> <li>5/8" EXT GWB SHEATHING</li> <li>6" STEEL STUD WITH CONTINUOUS BATT INSULATION</li> <li>CONTINUOUS 6MM POLY SHEET AIR/VAPOUR BARRIER (TYP.)</li> <li>5/8" GWB</li> </ul>	-	-	
W1E	METAL PANEL CLADDING ON METAL FRAMING		<ul> <li>PRE FINISHED ALUMINUM COMPOSITE PANEL (ACM) WITH RAINSCREEN</li> <li>1" AIR SPACE</li> <li>5" SEMI-RIGID MINERAL FIBRE INSULATION</li> <li>THERMALLY BROKEN GIRT SYSTEM</li> <li>CONTINUOUS SELF ADHERED VAPOUR-PERMEABLE AIR/MOISTURE BARRIER</li> <li>5/8" EXT GWB SHEATHING</li> <li>3 5/8" STEEL STUD WITH CONTINUOUS BATT INSULATION</li> <li>CONTINUOUS 6MM POLY SHEET AIR/VAPOUR BARRIER (TYP.)</li> <li>5/8' GWB</li> </ul>	-	-	INSET BALCONIES, SOUTH ELEVATION
W1F	METAL PANEL CLADDING ON METAL FRAMING		<ul> <li>PRE FINISHED ALUMINUM COMPOSITE PANEL (ACM) WITH RAINSCREEN</li> <li>1" AIR SPACE</li> <li>5" SEMI-RIGID MINERAL FIBRE INSULATION</li> <li>THERMALLY BROKEN GIRT SYSTEM</li> <li>CONTINUOUS SELF ADHERED VAPOUR-PERMEABLE AIR/MOISTURE BARRIER</li> <li>5/8" EXT GWB SHEATHING</li> <li>6" STEEL STUD WITH CONTINUOUS BATT INSULATION</li> <li>CONTINUOUS 6MM POLY SHEET AIR/VAPOUR BARRIER (TYP.)</li> <li>5/8" GWB</li> </ul>	-	-	INSET BALCONIES, SOUTH ELEVATION
W2	METAL PANEL CLADDING ON CONCRETE BASE		PRE FINISHED ALUMINUM COMPOSITE PANEL (ACM) WITH RAINSCREEN 1" AIR SPACE 5" SEMI-RIGID MINERAL FIBRE INSULATION THERMALLY BROKEN GIRT SYSTEM CONTINUOUS SELF-ADHERED VAPOUR-PERMEABLE AIR/MOISTURE BARRIER CONCRETE WALL	-	-	ROOFTOP ELEVATOR SHAFT EXTERIOR WALL
W3	BRICK MASONRY CLADDING ON METAL STUD FRAMING NO INSUL.		3 5/8" MASONRY FACE BRICK (C/W THERMALLY BROKEN TIES)     1" AIR SPACE     5/8" EXT GWB SHEATHING     3 5/8" STEEL STUD WITH CONTINUOUS BATT INSULATION     5/8" EXT GWB SHEATHING     VARIABLE AIR SPACE + METAL FRAMING     PRE FINISHED ALUMINUM COMPOSITE PANEL (ACM)	-	-	INSET BALCONY PIERS
W4	BRICK MASONRY CLADDING ON METAL STUD FRAMING		3 5/8" RECYCLED MASONRY FACE BRICK (C/W THERMALLY BROKEN TIES)     3" AIR SPACE     3" SEMI-RIGID MINERAL FIBRE INSULATION     CONTINUOUS SELF ADHERED VAPOUR-PERMEABLE AIR/MOISTURE BARRIER     5/8" EXT GWB SHEATHING     6" STEEL STUD WITH CONTINUOUS BATT INSULATION     CONTINUOUS 6MM POLY SHEET AIR/VAPOUR BARRIER (TYP.)     5/8" GWB	-	-	
W5	CAST IN PLACE ARCHITECTURAL CONCRETE	SEEARCH	CLEAR SEALED ROUGH BOARDFORM CONCRETE* (SEE STRUCTURAL) SMOOTH INTERIOR FINISH  *PROVIDE MOCKUP OF FINISH (SURFACE AND SEALER, NOT PART OF FINAL CONSTRUCTION)	-	-	6" STACK W/ RANDOM LENGTHS ROUGH SAWN CEDAR FORMWORK     ANTI-GRAFFITI COATING
W6	EXISTING MASONRY/STONE WALL		EXISTING STONE/MASONRY WALL (CLEAR MATTE SEALER)     REPOINTED INTERIOR AND EXTERIOR, AS REQ'D     STRUCTURAL STRONG-BACK SEISMIC SUPPORT SYSTEM (SEE STRUCTURAL)	2HR	-	BCBC D-2.1.1 (MIN. 128mm)
W7A	WINDOW WALL		SEE WINDOW ELEVATIONS AND SCHEDULES	-	-	
W7B	WINDOW WALL - INSUL. SPANDREL		SEE WINDOW ELEVATIONS AND SCHEDULES	-	-	
W8	CURTAIN WALL		CAPLESS VERTICAL MULLIONS     SEE WINDOW ELEVATIONS AND SCHEDULES	-	-	
W9	INTERIOR FRAMELESS GLAZING SYSTEM		SEE WINDOW ELEVATIONS AND SCHEDULES	0HR	-	0-HR AT LOBBY TO LOUNGE SEPERATION
W10	NORTH ELEVATION MURAL		SMOOTH FACE CONCRETE BLOCK VENEER (C/W FLUSH RAKED JOINTS)  3/4" AIR SPACE 2" SEMI-RIGID MINERAL FIBRE INSULATION CONTINUOUS SELF ADHERED VAPOUR-PERMEABLE AIR/MOISTURE BARRIER CONC. SHEAR WALL (SEE STRUCTURAL)	1HR	-	BCBC D-2.1.1 (MIN. 90mm)

- 2. CONSTRUCT ALL WALL ASSEMBLIES FROM FLOOR TO U/S OF STRUCTURE ABOVE FOR ALL WALLS ADJACENT
- 3. INSTALL DEFLECTION TOP TRACKS AT ALL PARTITIONS
- 4. USE CEMENTITIOUS BACKER BOARD INSTEAD OF GWB IN
- 5. USE GLASS MAT TILE BACKER BOARD INSTEAD OF GWB 6. FOR PARTITIONS WITH DOUBLE LAYER OF GWB ON ONE
- SIDE, LOCATE DOUBLE LAYER ON CORRIDOR SIDE.
- 9. PROVIDE ACOUSTIC SEALANT AT TOP AND BOTTOM
- 10. SEAL ALL GWB PENETRATIONS INCLUDING ABOVE T-BAR CEILING. 11. FOR PLUMBING PARTITIONS ENSURE THAT PLUMBING IS
- 12. REINFORCE STUD FRAMING (BLOCKING) AS REQUIRED TO SUPPORT MISCELLANEOUS EQUIPMENT (EG.
- 13. FOR PAVERS AND ROOF BALLAST LAYOUT, REFER TO LANDSCAPE DRAWINGS AND SPECIFICATIONS.
- OF STUDS (I.E. TYPE P1), STUDS TO BE MIN. 16" O.C., TYP. 15. FOR ALL ACOUSTIC (STC) RATED WALLS, ENSURE SIDES OF THE WALL ARE NOT LOCATED WITHIN THE
- 16. ALL GYPSUM BOARD TO BE TYPE X UNLESS OTHERWISE INDICATED BY ULC LISTING OR NOTED OTHERWISE 17. ALL STUDS AT 16" O.C. UNLESS OTHERWISE NOTED OR REQUIRED BY FIRE RESISTANT LISTING OR BY STEEL STUD ENGINEER DRAWINGS
- 18. ALL ACOUSTICALLY RATED PARTITIONS TO HAVE CONTINUOUS ACOUSTIC SEALANT BETWEEN FLOOR AND
- 19. FOR ALL ELECTRICAL AND DATA ROOMS PROVIDE INTUMESCENT PAINTED PLYWOOD TO 84"AFF ON ALL WALLS OR FIRE RETARDANT TREATED ULC MARK PLYWOOD AS INDICATED ON THE ELECTRICAL DRAWINGS.
- 20. PARTITION INSULATION TO FILL BUT NOT OVERFILL CAVITY - TYPICAL
- 21. AT EXTERIOR WALLS CONTAINING SPRAY FOAM INSULATION, PROTECT ELECTRICAL BOX OPENINGS WITH FIRESTOP PUTTY PACKS, TYP.
- 22. ALL ASSEMBLIES CONTAINING SPRAY FOAM INSULATION TO BE PROTECTED BY TESTED (ULC) THERMAL BARRIER SYSTEM AS REQ'D BY THE BUILDING CODE. SPRAY APPLIED, GWB OR EQUIV.
- 23. ALL MEMBRANES, COATINGS, VAPOUR/THERMAL BARRIERS AND SIMILAR ENVELOPE COMPONENTS TO BE CONTINUOUS UNLESS NOTED OTHERWISE.
- STUD BLOCKING PER DETAILS.
- 26. REFER TO ENERGY MODEL REPORT FOR ROOF AND WALL ASSEMBLIES R-VALUES

### FIRE RATED NOTES

- 1. ALL FIRE RATED PARTITIONS TO HAVE FIRE STOPPING BETWEEN TOP OF WALL TRACK AND UNDERSIDE OF
- 2. CONTRACTOR TO PROVIDE A LISTED ASSEMBLY SUBMITTAL FOR ALL FIRE RATED WALLS
- AND PARTIALLY RECESSED ITEMS IN FIRE RATED PARTITIONS. TYPE AND NUMBER OF LAYERS OF GWB TO MATCH PARTITION TYPE. ITEMS INCLUDE BUT ARE NOT LIMITED TO ELEMENTS SUCH AS FIRE EXTINGUISHER CABINETS, ELECTRICAL PANELS AND ALARMS. 4. ALL RATED SEPARATIONS TO BE CONTINUOUS.

### **GENERAL ASSEMBLY NOTES**

- 1. CONSTRUCT ALL WALL ASSEMBLIES FROM FLOOR TO U/S OF STRUCTURE ABOVE UNLESS NOTED OTHERWISE
- BATHTUBS OR SHOWER ENCLOSURES (NEXT TO RATED WALLS ONLY)
- ABUTTING STRUCTURE ABOVE.
- ALL WASHROOMS, BATHROOMS AND WASHER/DRYER CLOSETS.
- AT ALL WASHROOM AND KITCHEN TILE INSTALLATIONS.
- 7. USE CORNER BEADS AT ALL EXPOSED GWB CORNERS. 8. USE J-BEADS AT ALL EXPOSED GWB EDGES AND WHERE GWB BUTTS AGAINST DISSIMILAR MATERIAL.
- TRACK AT ALL SUITE-TO-SUITE AND SUITE-TO-CORRIDOR OR SERVICE SPACE PARTITIONS.
- NOT IN CONTACT WITH STUD FRAMING AND GWB.
- FIXTURES, MILLWORK ETC).
- 14. FOR ACOUSTIC (STC) RATED WALLS, WITH SINGLE ROW
- ELECTRICAL/COMMUNICATIONS OUTLETS ON OPPOSITE SAME STUD CAVITY, TYP.
- STRUCTURE AND GWB

- 24. ENSURE MIN. 2% SLOPE FOR ALL ROOF ASSEMBLIES 25. REINFORCE SUITE ENTRY DOOR JAMBS WITH WOOD

- 3. PROVIDE RATED GWB ENCLOSURES AROUND ALL FULLY





## ISSUED FOR

- A 2022-06-24 BUILDING PERMIT APPLICATION
- B 2022-09-29 BUILDING PERMIT APPLICATION **REVISION 1**
- C 2022-10-14 ISSUED FOR TENDER
- D 2022-11-10 IFT ADDENDUM 2 E 2023-02-21 POST-TENDER ADDENDUM
- F 2023-04-09 BUILDING PERMIT APPLICATION **REVISION 3**

IMPERIAL THIS DRAWING IS COPYRIGHTED AND MUST NOT BE USED, REPRODUCED, OR REVISED WITHOUT WRITTEN PERMISSION.

ALL DIMENSIONS ARE IN FEET AND INCHES UNLESS OTHERWISE VERIFY DIMENSIONS.

DO NOT SCALE THIS DRAWING. REPORT INCONSISTENCIES AND OMISSIONS TO THE CONSULTANT FOR CLARIFICATION BEFORE COMMENCING WITH THE WORK.

DEVIATIONS FROM THE CONTRACT DOCUMENTS WITHOUT WRITTEN APPROVAL FROM THE CONSULTANT ARE SUBJECT TO CORRECTION AT THE CONTRACTOR'S EXPENSE.

### ARCHITECT BONIFACE OLEKSIUK POLITANO ARCHITECTS 180-510 NICOLA STREET VANCOUVER BC, V6G 3J7

Tel: 236.521.6568 Email: info@bop.ca

This document has been digitally certified with digital certificate and encryption technology authorized by the Architectural Institute of BC and the Engineers and Geoscientists BC. The authoritative original has been transmitted to you in digital form. Any printed version can be relied upon as a true copy of the original when supplied by the architect, bearing images of the professional seal and digital certificate, or when printed from the digitally-certified electronic file provided by the architect.

SEAL



2023-04-09

## NORTHERN JUNK

1314 WHARF STREET

## ASSEMBLY SCHEDULE

CHECKED: SO/AP

DRAWN: LM PLOT DATE: 2023-04-07 7:59:50 PM

19004C

<b>CEILING TYPES</b>		

TYPE MARK	TYPE NAME	TYPE IMAGE	ASSEMBLY	FRR	STC	COMMENTS
CE1	INTERIOR UNFINISHED EXPOSED CEILING		STRUCTURAL CONCRETE SLAB (SEE STRUCTURAL)	-	-	HERITAGE PORTION
CE2	INTERIOR PAINTED CONCRETE		STRUCTURAL CONCRETE SLAB (SEE STRUCTURAL)     PAINT	-	-	
CE3	INTERIOR SMOOTH PAINTED CEILING		STRUCTURAL CONCRETE SLAB (SEE STRUCTURAL)     PLASTER SKIM (TBD)     CONTINUOUS SMOOTH PTD CEILING	-	-	
CE4	INTERIOR SUSPENDED GWB FRAMED CEILING	VARIES	STRUCTURAL CONCRETE SLAB (SEE STRUCTURAL) LIGHT GAUGE STEEL STUD FRAMING/CEILING SYSTEM AS REQ'D 5/8" GWB NOTE: CONTINUOUS ACOUSTIC INSULATION ABOVE BATHROOMS INCLUDING INSULATION OF W/C TRAPS FROM ABOVE.	-	-	
CE5	TEXTURED METAL SOFFIT/CEILING		STRUCTURAL CONCRETE SLAB (SEE STRUCTURAL) LIGHT GAUGE STEEL STUD FRAMING/CEILING SYSTEM AS REQ'D TEXTURED STAINLESS STEEL SOFFIT SYSTEM NOTE: 5" SPRAY FIBER INSULATION (OPEN CELL, TAMPED SMOOTH) AS REQ'D (REFER TO RCP'S) THERMALLY BROKEN GIRT SYSTEM USE VENTED SPLINE AT JOINTS	-	-	FOR EXTERIOR APPLICATIONS INC. INSULATION
CE6	CMP SOFFIT		STRUCTURAL CONCRETE SLAB (SEE STRUCTURAL) LIGHT GAUGE STEEL STUD FRAMING/CEILING SYSTEM AS REQ'D CMP SOFFIT SYSTEM THERMALLY BROKEN GIRT SYSTEM USE VENTED SPLINE AT JOINTS	-	-	
CE7	HORIZONTAL SHAFT WALL	SHAFT SIDE	<ul> <li>1" FIRE RATED GWB CORE-BOARD/LINER</li> <li>2 1/2" METAL SHAFTWALL STUD FRAMING C/W CONTINUOUS MINERAL FIBRE ACOUSTIC INSULATION</li> <li>2 X 5/8" FIRE RATED GWB</li> </ul>	2HR cUL W409	38 USG- 040917	FOR HORIZONTAL SHAFTWALL, REFER TO UL EVALUATION REPORT UL ER3660-04

			FLOOR TYPES			
TYPE MARK	TYPE NAME	TYPE IMAGE	ASSEMBLY	FRR	STC	COMMENTS
FL1	CONCRETE SLAB		FLOORING FINISH C/W ACOUSTIC UNDERLAYMENT AS REQ'D. (SEE INTERIOR DESIGN DRAWINGS) STRUCTURAL CONCRETE SLAB. (SEE STRUCTURAL)	1HR/2HR*	-	*1HR FRR LVLS 3-5 BCBC D-2.1.1 (MIN. 90mm) 2HR FRR LVLS 1-2 BCBC D-2.1.1 (MIN.130mm)
FL1A	CONCRETE SLAB		CONTINUOUS PEDESTRIAN TRAFFIC COAT MEMBRANE STRUCTURAL CONCRETE SLAB, SLOPED TO DRAIN (SEE STRUCTURAL) NOTE: ANY NEGATIVE SLOPE WILL NOT BE ACCEPTED SMOOTH PAINTED SOFFIT	1HR/2HR*	-	*1HR FRR LVLS 3-5 BCBC D-2.1.1 (MIN. 90mm) 2HR FRR LVLS 1-2 BCBC D-2.1.1 (MIN.130mm)
FL2	CONCRETE SLAB ON GRADE		<ul> <li>4" CONCRETE SLAB ON GRADE (SEE STRUCTURAL)</li> <li>3" RIGID XPS INSULATION - 3' INBOARD AT EXPOSED WESTERN PERIMETER ONLY</li> <li>CONTINUOUS 10mil. POLY VAPOUR BARRIER MEMBRANE. TAPED AND SEALED.</li> <li>COURSE GRANULAR FILL</li> </ul>	-	-	EXTEND INSULATION BELOW SLAB 3'-0 EXPOSED PERIMETER TYP.

### PARTITION TYPES

TYPE MARK	TYPE NAME	TYPE IMAGE	ASSEMBLY	FRR	STC	COMMENTS
P1	GWB PARTITION WALL		5/8" GWB     2-1/2" MTL STUD FRAMING C/W CONTINUOUS ACOUSTIC BATT INSULATION **     5/8" GWB	-	-	-
P2	GWB PARTITION WALL		• 5/8" GWB • 3-5/8" MTL STUD FRAMING 25 GAUGE C/W CONTINUOUS ACOUSTIC BATT INSULATION • 5/8" GWB	-	-	-
Р3	GWB PARTITION WALL		5/8" GWB     6" MTL STUD FRAMING C/W CONTINUOUS ACOUSTIC BATT INSULATION     5/8" GWB	-	-	-
P4	METAL MESH PARTITION WALL	=00-	PAINTED WIRE METAL MESH PARTITION AND FRAMING AS REQ'D     SEE SPECIFICATIONS FOR DELEGATED DESIGN REQUIREMENTS	-	-	-
P5	PARTITION WALL - CALL ROOM		RECLAIMED WOOD FINISH C/W 1/4" PLYWOOD BACKING AS REQ'D BY ID     3-5/8" MTL STUD FRAMING 25 GAUGE C/W CONTINUOUS ACOUSTIC BATT INSULATION     RECLAIMED WOOD FINISH C/W 1/4" PLYWOOD BACKING AS REQ'D BY ID	-	-	PART HEIGHT WALLS AROUND CALL ROOM. SEE I.D FOR PANELING SIZING
P6	GWB + PLY PARTITION WALL		RECLAIMED WOOD FINISH C/W 1/4" PLYWOOD BACKING AS REQ'D BY ID  5/8" GWB  3-5/8" MTL STUD FRAMING 25 GAUGE C/W CONTINUOUS ACOUSTIC BATT INSULATION  5/8" GWB  RECLAIMED WOOD FINISH C/W 1/4" PLYWOOD BACKING AS REQ'D BY ID.	0HR	-	E A A A A A A A A A A A A A A A A A A A
RP1	GWB DEMISING WALL		<ul> <li>2 X 5/8" FIRE RATED GWB</li> <li>2-1/2" MTL STUD FRAMING C/W CONTINUOUS MINERAL FIBRE ACOUSTIC INSUL.</li> <li>1" AIR GAP</li> <li>2-1/2" MTL STUD FRAMING C/W CONTINUOUS MINERAL FIBRE ACOUSTIC INSUL.</li> <li>5/8" FIRE RATED GWB</li> </ul>	1HR	61*	BXUV.U4666
RP2	GWB CORRIDOR WALL	CORRIDOR SIDE	2 x 5/8" FIRE RATED GWB     3 5/8" MTL STUD FRAMING 25 GAUGE C/W CONTINUOUS MINERAL FIBRE ACOUSTIC INSULATION     5/8" FIRE RATED GWB	1HR	53*	BCBC DESIGN S5A
RP3	GWB WALL		<ul> <li>2 x 5/8" FIRE RATED GWB</li> <li>3 5/8" MTL STUD FRAMING C/W CONTINUOUS MINERAL FIBRE ACOUSTIC INSUL.</li> <li>2 x 5/8" FIRE RATED GWB</li> </ul>	2HR	47*	BXUV.U411
SW1	2 HR. SHAFT WALL	SHAFT SIDE	1" FIRE RATED GWB SHAFT LINER OR CORE-BOARD     2 1/2" METAL SHAFTWALL STUD FRAMING C/W CONTINUOUS MINERAL FIBRE ACOUSTIC INSULATION     2 X 5/8" FIRE RATED GWB	2HR	38 USG- 040917	BXUV.U428
	1			1		1

\*SOUND TRANSMISSION THROUGH GYPSUM BOARD WALLS: SOUND TRANSMISSION RESULTS. NRC IRC-IR-693, 1995

\*\*ACOUSTIC BATT MAY BE OMITTED IN CLOSET PARTITIONS THAT DO NOT FORM A SEPARATION OF BEDROOM TO REMAINDER OF SUITE

### **FURRING TYPES**

TYPE MARK	TYPE NAME	TYPE IMAGE	ASSEMBLY	FRR	STC	COMMENTS
F1	GWB FURRING 1'-5/8" STUD		• 5/8" GWB • 1-5/8" STUD FURRING • 1" AIR GAP	-	-	-
F2	GWB FURRING 2-1/2" STUD		5/8" GWB     2-1/2" STUD FRAMING     1" AIR GAP	-	-	-
F2A	GWB FURRING 2-1/2" STUD		5/8" GWB C/W CONTINUOUS MINERAL FIBRE ACOUSTIC INSULATION     2-1/2" STUD FRAMING     1" AIR GAP	-	-	-
F3	GWB FURRING 3 5/8" STUD		• 5/8" GWB • 3 5/8"" STUD FRAMING • 1" AIR GAP	-	-	-
F4	GWB FURRING STUD W/6" CHASE	50	• 5/8" GWB • 3 5/8"" STUD FRAMING • AIR GAP TO ACHIEVE 6" CAVITY	-	-	-

### **GENERAL ASSEMBLY NOTES**

- OF STRUCTURE ABOVE FOR ALL WALLS ADJACENT BATHTUBS OR SHOWER ENCLOSURES (NEXT TO RATED
- ABUTTING STRUCTURE ABOVE.
- ALL WASHROOMS, BATHROOMS AND WASHER/DRYER CLOSETS.
- AT ALL WASHROOM AND KITCHEN TILE INSTALLATIONS.
- GWB BUTTS AGAINST DISSIMILAR MATERIAL. 9. PROVIDE ACOUSTIC SEALANT AT TOP AND BOTTOM
- OR SERVICE SPACE PARTITIONS. 10. SEAL ALL GWB PENETRATIONS INCLUDING ABOVE T-BAR
- CEILING.
- TO SUPPORT MISCELLANEOUS EQUIPMENT (EG. FIXTURES, MILLWORK ETC).
- LANDSCAPE DRAWINGS AND SPECIFICATIONS. 14. FOR ACOUSTIC (STC) RATED WALLS, WITH SINGLE ROW
- ELECTRICAL/COMMUNICATIONS OUTLETS ON OPPOSITE SIDES OF THE WALL ARE NOT LOCATED WITHIN THE SAME STUD CAVITY, TYP.
- INDICATED BY ULC LISTING OR NOTED OTHERWISE 17. ALL STUDS AT 16" O.C. UNLESS OTHERWISE NOTED OR REQUIRED BY FIRE RESISTANT LISTING OR BY STEEL STUD ENGINEER DRAWINGS
- 18. ALL ACOUSTICALLY RATED PARTITIONS TO HAVE CONTINUOUS ACOUSTIC SEALANT BETWEEN FLOOR AND
- WALLS OR FIRE RETARDANT TREATED ULC MARK PLYWOOD AS INDICATED ON THE ELECTRICAL
- 20. PARTITION INSULATION TO FILL BUT NOT OVERFILL CAVITY - TYPICAL
- INSULATION, PROTECT ELECTRICAL BOX OPENINGS WITH FIRESTOP PUTTY PACKS, TYP. 22. ALL ASSEMBLIES CONTAINING SPRAY FOAM INSULATION
- SYSTEM AS REQ'D BY THE BUILDING CODE. SPRAY APPLIED, GWB OR EQUIV.
- BARRIERS AND SIMILAR ENVELOPE COMPONENTS TO BE CONTINUOUS UNLESS NOTED OTHERWISE. 24. ENSURE MIN. 2% SLOPE FOR ALL ROOF ASSEMBLIES
- STUD BLOCKING PER DETAILS. 26. REFER TO ENERGY MODEL REPORT FOR ROOF AND WALL ASSEMBLIES R-VALUES
- 1. ALL FIRE RATED PARTITIONS TO HAVE FIRE STOPPING BETWEEN TOP OF WALL TRACK AND UNDERSIDE OF
- 2. CONTRACTOR TO PROVIDE A LISTED ASSEMBLY
- SUBMITTAL FOR ALL FIRE RATED WALLS CABINETS, ELECTRICAL PANELS AND ALARMS.

- 1. CONSTRUCT ALL WALL ASSEMBLIES FROM FLOOR TO U/S OF STRUCTURE ABOVE UNLESS NOTED OTHERWISE 2. CONSTRUCT ALL WALL ASSEMBLIES FROM FLOOR TO U/S
- WALLS ONLY) 3. INSTALL DEFLECTION TOP TRACKS AT ALL PARTITIONS
- 4. USE CEMENTITIOUS BACKER BOARD INSTEAD OF GWB IN
- 5. USE GLASS MAT TILE BACKER BOARD INSTEAD OF GWB 6. FOR PARTITIONS WITH DOUBLE LAYER OF GWB ON ONE
- SIDE, LOCATE DOUBLE LAYER ON CORRIDOR SIDE. 7. USE CORNER BEADS AT ALL EXPOSED GWB CORNERS. 8. USE J-BEADS AT ALL EXPOSED GWB EDGES AND WHERE
- TRACK AT ALL SUITE-TO-SUITE AND SUITE-TO-CORRIDOR
- 11. FOR PLUMBING PARTITIONS ENSURE THAT PLUMBING IS
- NOT IN CONTACT WITH STUD FRAMING AND GWB. 12. REINFORCE STUD FRAMING (BLOCKING) AS REQUIRED
- 13. FOR PAVERS AND ROOF BALLAST LAYOUT, REFER TO
- OF STUDS (I.E. TYPE P1), STUDS TO BE MIN. 16" O.C., TYP. 15. FOR ALL ACOUSTIC (STC) RATED WALLS, ENSURE
- 16. ALL GYPSUM BOARD TO BE TYPE X UNLESS OTHERWISE
- STRUCTURE AND GWB 19. FOR ALL ELECTRICAL AND DATA ROOMS PROVIDE INTUMESCENT PAINTED PLYWOOD TO 84"AFF ON ALL
- DRAWINGS.
- 21. AT EXTERIOR WALLS CONTAINING SPRAY FOAM
- TO BE PROTECTED BY TESTED (ULC) THERMAL BARRIER
- 23. ALL MEMBRANES, COATINGS, VAPOUR/THERMAL
- 25. REINFORCE SUITE ENTRY DOOR JAMBS WITH WOOD

## FIRE RATED NOTES

- STRUCTURE.
- 3. PROVIDE RATED GWB ENCLOSURES AROUND ALL FULLY AND PARTIALLY RECESSED ITEMS IN FIRE RATED PARTITIONS. TYPE AND NUMBER OF LAYERS OF GWB TO MATCH PARTITION TYPE. ITEMS INCLUDE BUT ARE NOT LIMITED TO ELEMENTS SUCH AS FIRE EXTINGUISHER
- 4. ALL RATED SEPARATIONS TO BE CONTINUOUS.





## ISSUED FOR

A 2022-06-24 BUILDING PERMIT APPLICATION

B 2022-09-29 BUILDING PERMIT APPLICATION **REVISION 1** 

C 2022-10-14 ISSUED FOR TENDER

D 2023-03-27 POST-TENDER ADDENDUM 02 E 2023-04-09 BUILDING PERMIT APPLICATION

**REVISION 3** 

### IMPERIAL

THIS DRAWING IS COPYRIGHTED AND MUST NOT BE USED, REPRODUCED, OR REVISED WITHOUT WRITTEN PERMISSION.

ALL DIMENSIONS ARE IN FEET AND INCHES UNLESS OTHERWISE VERIFY DIMENSIONS.

DO NOT SCALE THIS DRAWING. REPORT INCONSISTENCIES AND OMISSIONS TO THE CONSULTANT FOR CLARIFICATION BEFORE COMMENCING WITH THE WORK.

DEVIATIONS FROM THE CONTRACT DOCUMENTS WITHOUT WRITTEN APPROVAL FROM THE CONSULTANT ARE SUBJECT TO CORRECTION AT THE CONTRACTOR'S EXPENSE.

ARCHITECT BONIFACE OLEKSIUK POLITANO ARCHITECTS 180-510 NICOLA STREET VANCOUVER BC, V6G 3J7 Tel: 236.521.6568 Email: info@bop.ca

This document has been digitally certified with digital certificate and encryption technology authorized by the Architectural Institute of BC and the Engineers and Geoscientists BC. The authoritative original has been transmitted to you in digital form. Any printed version can be relied upon as a true copy of the original when supplied by the architect, bearing images of the professional seal and digital certificate, or when printed from the digitally-certified electronic file provided by the architect.

SEAL



## NORTHERN JUNK

1314 WHARF STREET

## ASSEMBLY SCHEDULE

CHECKED: SO/AP

DRAWN: LM PLOT DATE: 2023-04-07 7:59:51 PM

19004C

			FL	OOR	CEI	LING	EAST	WALL	NORT	H WALL	SOUT	TH WALL	WEST	WALL	
LEVEL	NUMBER	NAME	Floor Finish	Dogo Finish	Cailing Matarial	Cailing Finiah	Foot Well Motorial	Fact Wall Finish	North Wall	North Wall Finish	South Wall	South Wall Finish	West Well Meterial	West Well Finish	Remarks
EL 00	NUMBER	NAME	Floor Finish	Base Finish	Ceiling Material	Ceiling Finish	East Wall Material	East Wall Finish	Material	North Wall Finish	Material	South Wall Finish	West Wall Material	west wan rinish	Remarks
EL 00	001	CRU 01	CONC	_	CONC	_	MAS	_	MAS	-	MAS	_	MAS	_	
'EL 00	002	RESIDENTIAL BIKES		RB	CONC	PTD	MAS/CONC	_	CONC	-	MAS	_	CONC	_	
EL 00	003	COMMERCIAL GARBAGE		RB	CONC	PTD	MAS/CONC	HPC	MAS	HPC	MAS	-	CONC	HPC	HPC TO 4'0" AFF ON ALL NEW WALLS
'EL 00	004	EMR	CONC	-	CONC	PTD	MAS	-	MAS	-	CONC	-	CONC	-	
EL 00	005	COMMERCIAL BIKES	SEALED CONC	RB	CONC	PTD	CONC	PTD	MAS	-	MAS	-		CMP	
EL 00	006	MECH RM	SEALED CONC	-	CONC	-	CONC	-	MAS/CONC	-	CONC	-	CONC	-	
EL 00	007	RESIDENTIAL GARBAGE	SEALED CONC	-	CONC	PTD	CONC	PTD	MAS/CONC	-	MAS	-	MAS/CONC	PTD	
EL 00	008	MAIN ELEC RM	CONC	-	CONC	-	MAS/CONC	-	MAS	-	MAS	-	MAS	PTD	
EL 00	009	CORR.	SEALED CONC	RB	CONC	PTD	MAS/CONC	PTD	MAS	PTD	MAS	PTD	MAS/GWB	PTD	
EL 00	010	RES BIKES/LOCKERS	SEALED CONC	RB	CONC	PTD	CONC	PTD	MAS	PTD	CONC	PTD	CONC	PTD	
EL 00	011	CRU 02	CONC	-	CONC	-	MAS/CONC	-	MAS	-	CW	-	MAS/CW	-	
EL 00	012	STORAGE	SEALED CONC	RB	CONC	PTD	CONC		CONC		CONC		CONC		
EL-OL	~~~013~	JANITOR	SEALED CONG	*******	CONG	PTD	CONC	~~~~	MAS		CONC			~~~~~	
ÆL 00	014	GAS ROOM	SEALED CONC		CONC	PTD	MAS/CONC	PTD	MAS/CONC	PTD	CONC	PTD	CONC		
	ST-01	STAIR 1	SEALED CONC		CONC	PTD	CONC	PTD	GWB	PTD	CONC	PTD	CONC	PTD	
EL 01															
EL 01	101	CRU-01	CONC		CONC		MAS		MAS		MAS		MAS		
EL 01	101	CRU 02	CONC	-	CONC	-	MAS/CONC	_	MAS	-  -	CW	-  -	MAS/CW	-  -	
EL 01	103	VEST	REFER TO I.D.	REFER TO I.D.		REFER TO I.D.	CW	_	MAS	-  -	CW	<u> </u>	CW	-  -	
EL 01	103	LOBBY	REFER TO I.D.	REFER TO I.D.	MTL	SEE RCP	CW	_	CW	-  -	CW		CONC	PTD	
EL 01	110	CORR.	REFER TO I.D.	REFER TO I.D.	REFER TO I.D.	REFER TO I.D.		REFER TO I.D.	REFER TO I.D.	REFER TO I.D.	REFER TO I.D.	REFER TO I.D.		REFER TO I.D.	NORTH WALL IN PART IS EXISTING MASONARY, NO FINISHES
EL 01	ST-101	STAIR 1	SEALED CONC	_	CONC	PTD	CONC	PTD	GWB	PTD	CONC	PTD	CONC	PTD	INACOVART, NOT INICITES
EL 01	ST-101		SEALED CONC	_	CONC	PTD		PTD	MAS/CONC	PTD	CONC		GWB	PTD	
LL 01	31-102	STAIRE	SLALLD CONC	<u> </u>	CONC	1110	IVIAO	I ID	IVIAO/CONC	1 10	CONC	I I I	OWB	110	
EL 02															
/EL 02	213	ELEC/COMM	SEALED CONC	Ī_	CONC	T_	GWB	PTD	GWB	PTD	GWB	PTD	GWB	PTD	
EL 02	220	CORR.		REFER TO I.D.		REFER TO I.D.		REFER TO I.D.	REFER TO I.D.	REFER TO I.D.	REFER TO I.D.			REFER TO I.D.	
EL 02	ST-201	STAIR 1	SEALED CONC	-	CONC	PTD		PTD	GWB	PTD	CONC	PTD	CONC	PTD	
EL 02	ST-202		SEALED CONC	_		PTD		PTD	CONC	PTD	CONC			PTD	
	0.202	OTAMAZ	02/1225 00/10	1	00110		00110	1. 1.5	00.10	1. 15	100110		100110	1	
EL 03															
EL 03	313	ELEC/COMM	SEALED CONC	-	CONC	-	GWB	PTD	GWB	PTD	GWB	PTD	GWB	PTD	
EL 03	320	CORR.	REFER TO I.D.	REFER TO I.D.	REFER TO I.D.	REFER TO I.D.	REFER TO I.D.	REFER TO I.D.	REFER TO I.D.	REFER TO I.D.	REFER TO I.D.	REFER TO I.D.	REFER TO I.D.	REFER TO I.D.	
ÆL 03	ST-301	STAIR 1	SEALED CONC	-	CONC	PTD	CONC	PTD	GYP	PTD	CONC	PTD	CONC	PTD	
EL 03	ST-302	STAIR 2	SEALED CONC	-	CONC	PTD	CONC	PTD	CONC	PTD	CONC	PTD	CONC	PTD	
EL 04	·													•	
EL 04 EL 04	413	ELEC/COMMS	SEALED CONC	T_	CONC	I_	GWB	PTD	GWB	PTD	GWB	PTD	GWB	PTD	T
EL 04	420	CORR.		REFER TO I.D.		REFER TO I.D.		REFER TO I.D.	REFER TO I.D.	REFER TO I.D.	REFER TO I.D.			REFER TO I.D.	
EL 04	ST-401	STAIR 1	SEALED CONC	-		PTD		PTD	GWB	PTD	CONC			PTD	
EL 04	ST-401		SEALED CONC	-		PTD		PTD	CONC	PTD	CONC			PTD	
	01-402	OTANZ	OLALLD GOING	<u> </u>	JOONO	ן וט	JOUINO	טו ון	JOHO	עו זי	LOCINO	וון	JOHO	1 10	1
EL 05	F40	ELEC/COMMC	CEALED COMO		CONC		CWD	DTD	CWD	DTD	CWD	DTD	CWD	DTD	T
EL 05	513 520	ELEC/COMMS  CORR.	SEALED CONC REFER TO I.D.	REFER TO I.D.	CONC	PEEED TO LD		PTD DEEED TO LD	GWB	PTD PEEER TO LD	GWB	PTD PEEED TO LD	GWB	PTD TO LD	
I 05	5.70	LUKK	KEEEK IUII)	TREFER TO I.D.	REFER TO I.D.	REFER TO I.D.	REFER TO I.D.	REFER TO I.D.	REFER TO I.D.	REFER TO I.D.	REFER TO I.D.	REFER TO I.D.	REFER TO I.D.	REFER TO I.D.	
/EL 05 /EL 05	ST-501	STAIR 1	SEALED CONC			PTD		PTD	GWB	PTD	CONC	PTD	CONC	PTD	



Boniface Oleksiuk Politano Architects



PROPERTIES LTD.

### ISSUED FOR

- A 2022-09-29 BUILDING PERMIT APPLICATION REVISION 1
- B 2022-10-14 ISSUED FOR TENDER
- C 2023-03-27 POST-TENDER ADDENDUM 02
- D 2023-04-09 BUILDING PERMIT APPLICATION REVISION 3

### **IMPERIAL**

THIS DRAWING IS COPYRIGHTED AND MUST NOT BE USED, REPRODUCED, OR REVISED WITHOUT WRITTEN PERMISSION.

ALL DIMENSIONS ARE IN FEET AND INCHES UNLESS OTHERWISE NOTED.
VERIFY DIMENSIONS.
DO NOT SCALE THIS DRAWING.

REPORT INCONSISTENCIES AND OMISSIONS TO THE CONSULTANT FOR CLARIFICATION BEFORE COMMENCING WITH THE WORK.

DEVIATIONS FROM THE CONTRACT DOCUMENTS WITHOUT WRITTEN APPROVAL FROM THE CONSULTANT ARE SUBJECT TO CORRECTION AT THE CONTRACTOR'S EXPENSE.

# ARCHITECT BONIFACE OLEKSIUK POLITANO ARCHITECTS 180-510 NICOLA STREET VANCOUVER BC, V6G 3J7 Tel: 236.521.6568 Email: info@bop.ca

This document has been digitally certified with digital certificate and encryption technology authorized by the Architectural Institute of BC and the Engineers and Geoscientists BC. The authoritative original has been transmitted to you in digital form. Any printed version can be relied upon as a true copy of the original when supplied by the architect, bearing images of the professional seal and digital certificate, or when printed from the digitally-certified electronic file provided by the architect.

SEA



## NORTHERN JUNK

1314 WHARF STREET


## ROOM FINISH SCHEDULE


DRAWN: LM PLOT DATE: 2023-04-07 7:59:53 PM

CHECKED: SO/AP

A-005

19004C

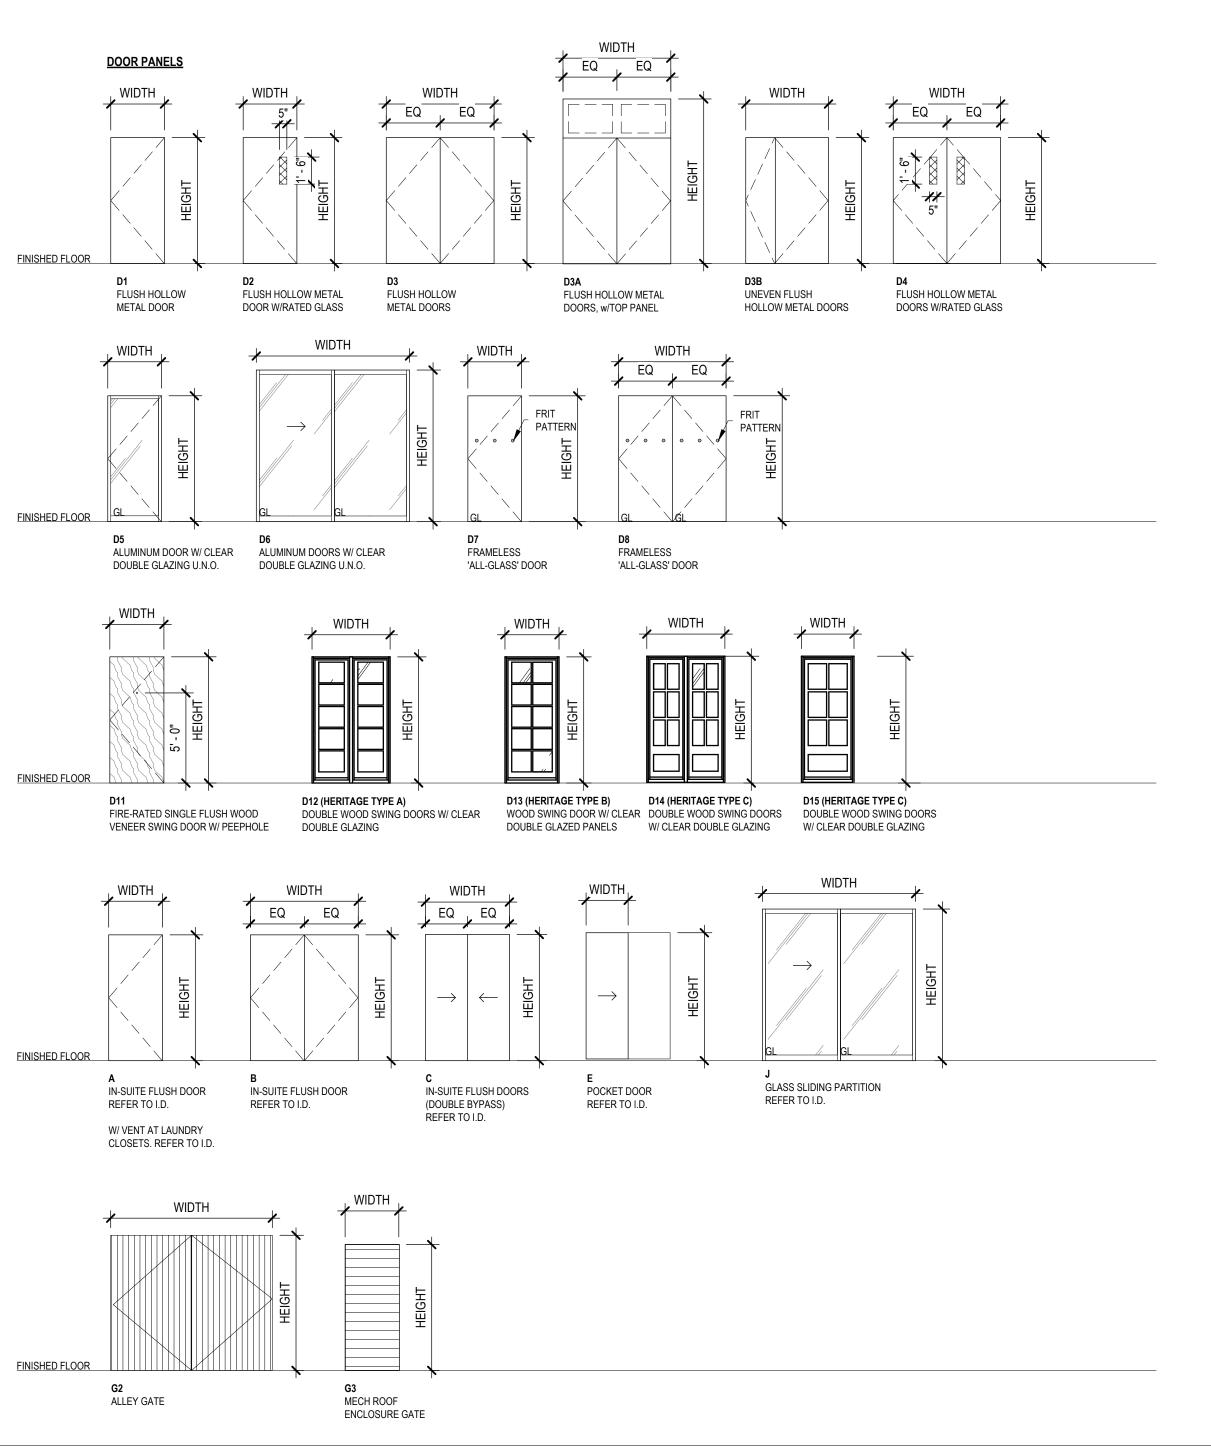

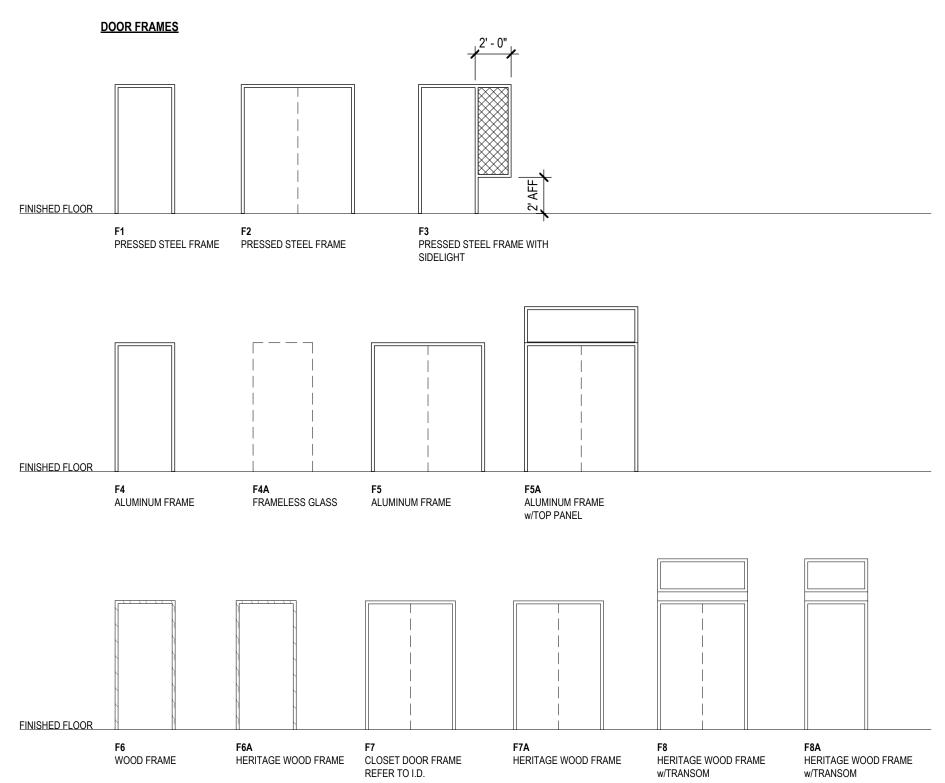

## **ABBREVIATIONS**

ALUM

ALUMINUM

ANOD ANODIZED **VISION GLASS CURTAIN WALL** CHAIN LINK FENCE EXPANDED METAL MESH **FIBERGLASS** FROSTED GLASS HOLLOW CORE WOOD **HOLLOW METAL MIRROR** MTL NOT IN CONTRACT OPAQUE GLASS PRESSED STEEL PAINTED SOLID CORE WOOD TEMPERED GLAZING UNIT **UNLESS NOTED OTHERWISE** WD WOOD WIRED GLASS WINDOW WALL / DOOR

### MATERIAL LEGEND





WIRED GLASS



**WOOD FRAMING** 



**EXPANDED WIRE MESH** 



PERFORATED METAL PANEL

## **GENERAL NOTES**

- 1. INSTALLATION OF ALL CLOSURES WILL COMPLY WITH NFPA 80. 2010 EDITION.
- 2. ALL FIRE RATED DOORS REQUIRE SELF-CLOSING DEVICES AND POSITIVE LATCHING MECHANISMS.
- 3. 20MIN FIRE-RATED DOORS ARE PERMITTED BETWEEN RESIDENTIAL SUITES AND THE ADJOINING PUBLIC CORRIDOR WILL HAVE A MAXIMUM 6MM CLEARANCE AT THE BOTTOM AND 3MM CLEARANCE AT THE SIDES AND TOP AS PER BCBC 2018.
- 4. FIRE RATING ALREADY ADJUSTED TO TABLE 3.1.8.4 "FIRE PROTECTION RATING OF CLOSURES" OF THE BCBC 2018.
- 5. ALL UNIT ENTRY DOORS NOT PROVIDING CLEARANCES OF 450MM (1' 6") ON PULL SIDE AND 300MM (1' 0") ON PUSH SIDE BESIDE LATCHING JAMBS ARE REQUIRED TO BE PREWIRED FOR FUTURE AUTOMATIC DOOR OPENER AS PER BCBC 2018.
- 6. DOORS EQUIPPED WITH HOLD-OPEN DEVICES WILL BE DESIGNED TO RELEASE UPON A SIGNAL FROM A SMOKE DETECTOR LOCATED AS DESCRIBED IN CAN/ULC-S524 "INSTALLATION OF FIRE ALARM SYSTEMS", AND FROM A SIGNAL FROM THE BUILDING FIRE ALARM SYSTEM.
- 7. WHERE A DOOR CONSISTS OF 2 LEAFS, BOTH LEAFS SHALL BE THE SAME DOOR TYPE AS DESIGNATED.
- 8. DOOR SIZE INDICATES MINIMUM SIZE OF DOOR LEAF, NOT ROUGH OPENING.
- 9. REFER TO MECHANICAL FOR DOORS REQUIRE UNDERCUTS OR GRILLES.
- 10. REFER TO SPECIFICATION FOR HARDWARE GROUP DETAILS. 11. UNLESS SPECIFIED OTHERWISE, GLASS DOORS SHALL BE
- DOUBLE-GLAZED. 12. ALL DOORS AT RESIDENTIAL SUITE ENTRY, TO BE SOLID CORE WOOD. OTHER DOORS WITHIN RESIDENTIAL SUITES TO BE
- 13. GLAZING IN ALL RATED DOORS TO BE WIRED GLASS, UNO.
- 14. FRIT PATTERN TO BE PROVIDED ON "ALL-GLASS" DOORS AND SIDELIGHTS.
- 15. COORDINATORS TO BE PROVIDED ON ALL FIRE-RATED DOUBLE DOORS.

HOLLOW CORE WOOD.

- 14. NUMBERS INDICATING THE STAIR DESIGNATION SHALL BE PROVIDED AT EVERY FLOOR LEVEL FOR EACH SCISSOR STAIR IN CONFORMANCE WITH THE FOLLOWING:
- SHALL BE PERMANENTLY MOUNTED ON BOTH SIDES OF THE DOOR.
- SHALL BE NOT LESS THAN 100 MM HIGH AND HAVE A 125 MM SQUARE VINYL BACKING SURFACE;
- BE LOCATED 1500 MM VERTICALLY FROM THE BOTTOM EDGE OF THE DOOR AS MEASURED TO THE CENTERLINE OF THE NUMBERS AND GENERALLY BE CENTERED HORIZONTALLY BETWEEN THE LOCK AND HINGE STILES;
- BE IN CONTRASTING COLOUR WITH THE SURFACE TO WHICH THEY ARE APPLIED.



**Boniface** 

Oleksiuk

Politano

### ISSUED FOR

A 2022-06-24 BUILDING PERMIT APPLICATION B 2022-09-29 BUILDING PERMIT APPLICATION

**REVISION 1** 

C 2022-10-14 ISSUED FOR TENDER

D 2023-03-27 POST-TENDER ADDENDUM 02

E 2023-04-09 BUILDING PERMIT APPLICATION **REVISION 3** 

### **IMPERIAL**

THIS DRAWING IS COPYRIGHTED AND MUST NOT BE USED, REPRODUCED, OR REVISED WITHOUT WRITTEN PERMISSION.

ALL DIMENSIONS ARE IN FEET AND INCHES UNLESS OTHERWISE VERIFY DIMENSIONS.

DO NOT SCALE THIS DRAWING. REPORT INCONSISTENCIES AND OMISSIONS TO THE CONSULTANT

FOR CLARIFICATION BEFORE COMMENCING WITH THE WORK.

DEVIATIONS FROM THE CONTRACT DOCUMENTS WITHOUT WRITTEN APPROVAL FROM THE CONSULTANT ARE SUBJECT TO CORRECTION AT THE CONTRACTOR'S EXPENSE.

ARCHITECT BONIFACE OLEKSIUK POLITANO ARCHITECTS 180-510 NICOLA STREET VANCOUVER BC, V6G 3J7

Tel: 236.521.6568 Email: info@bop.ca

This document has been digitally certified with digital certificate and encryption technology authorized by the Architectural Institute of BC and the Engineers and Geoscientists BC. The authoritative original has been transmitted to you in digital form. Any printed version can be relied upon as a true copy of the original when supplied by the architect, bearing images of the professional seal and digital certificate, or when printed from the digitally-certified electronic file provided by the architect.

SEAL



## NORTHERN JUNK


1314 WHARF STREET


DOOR, TYPES & **FRAMES** 

CHECKED: SO/AP PLOT DATE: 2023-04-07 7:59:55 PM


19004C

C:\Users\Louis Moore\Documents\Northern Junk Model\_louis84FE8.rvt

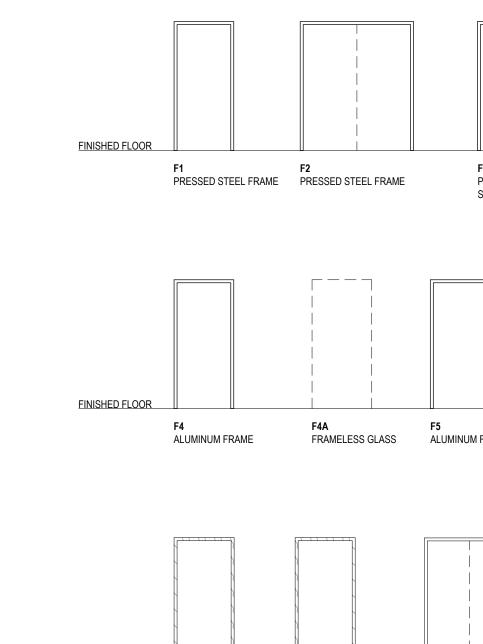

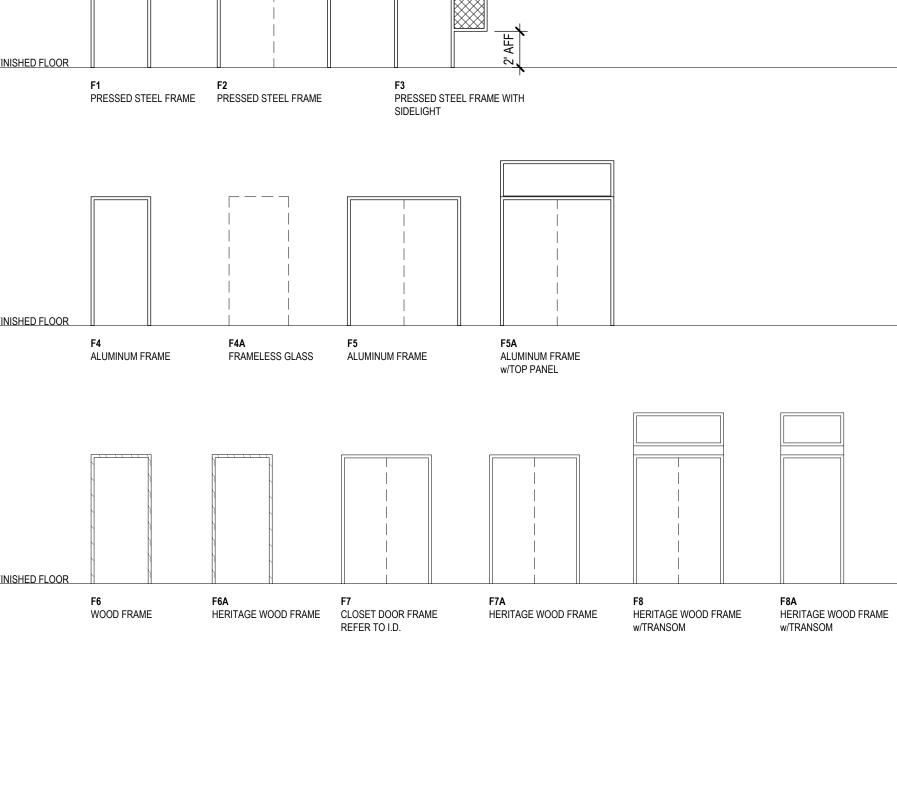

## **HERITAGE OPENINGS + DETAILS**

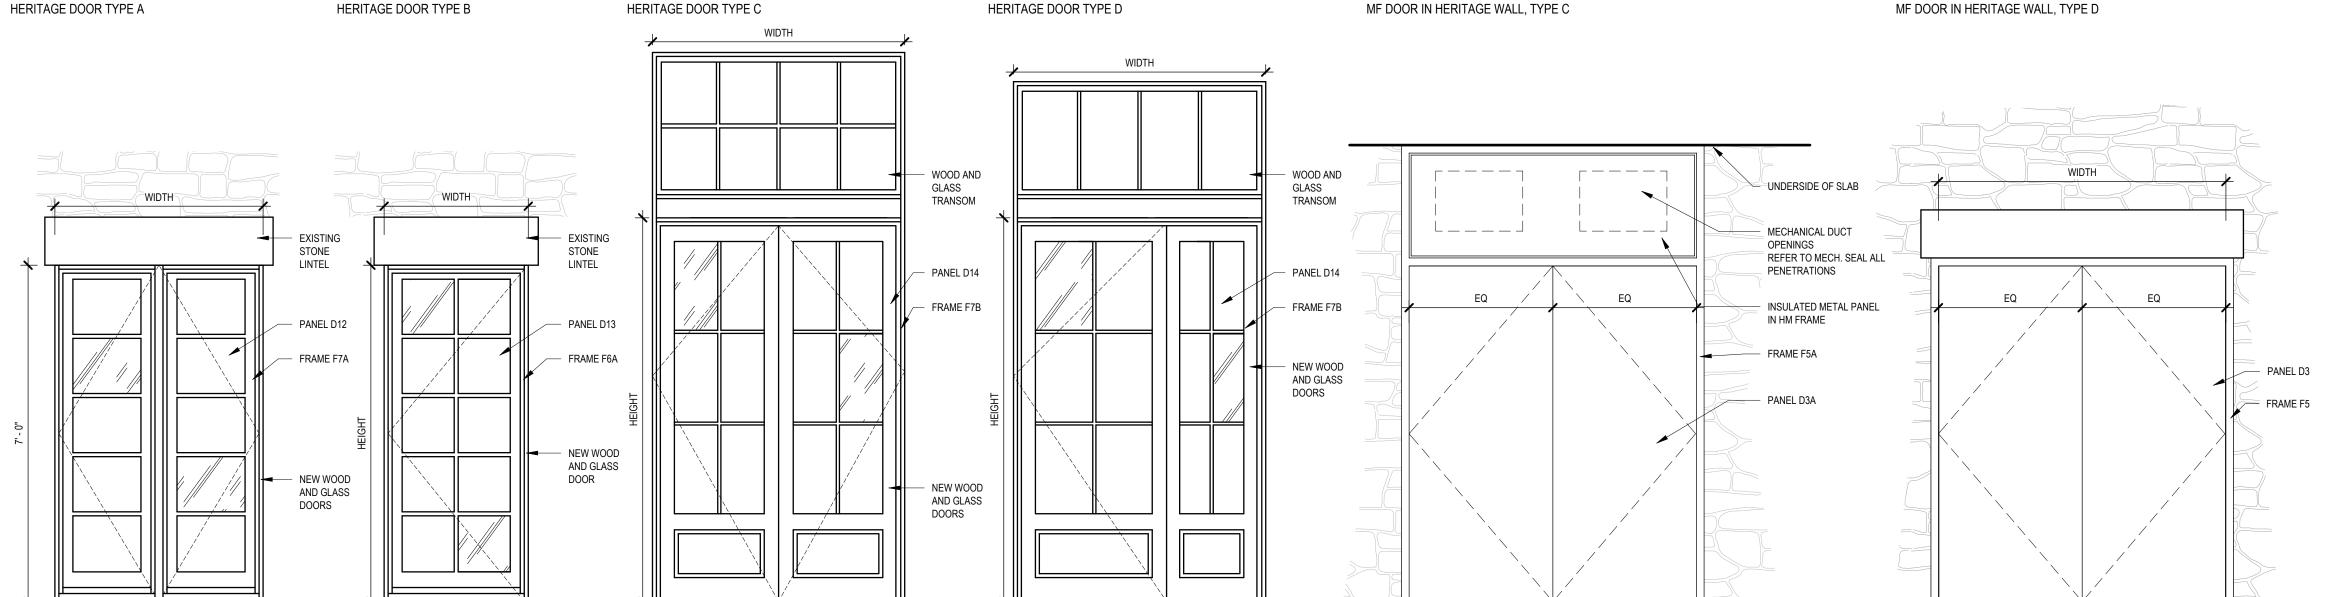

DOOR SCHEDULE -	LEVEL 00							E														
							~~~~	DOOR	~~~~	~~~~~	~~~~~~		FRAME	<u> </u>				HARDWARE				
LEVEL	DOOR NO	FUNCTION	LOCATION		DIMENSION	NS	PANEL	PANEL MATERIAL	PANEL	PANEL THERMAL	DANEL GLAZING	FRAME TYPE	FRAME MATERIAL	FRAME	FRAME THERMAL	GROUP	FOB	AUTOMATIC OPENER	CLOSER	PANIC	FRR	COMMENTS
				WIDTH	HEIGHT	THICKNESS	TYPE	PANEL WATERIAL	FINISH	PANEL INERWAL	PANEL GLAZING	) FRAMETIFE	FRANCE MATERIAL	FINISH	FRAIVIE I HERIVIAL		гов	AUTOMATIC OPENER	CLOSEK	PANIC		
LEVEL 00	0ST01	Interior	CORRIDOR TO ST01	3' - 0"	6' - 8"	1 3/4"	<b>C</b> D2	HM	PAINT	No	Υ	ζ F1	PS	PAINT	No	STR-001	No	No	Yes	No	45 mins	
LEVEL 0 LOWER	001	Exterior	CRU 1 NORTH WEST	6' - 0"	8' - 6"	1 3/8"	VVB42V	WDW.	~ PA'INT	wyesw	mym	F7A	WD	PAINT	No	CRU-001	No	No	Yes	No		FIT EXISTING OPENING. DOUBLE GLAZING, HERITAGE DOOR TYPE A
LEVEL 0 LOWER	001A	Exterior	CRU 1 NORTH WEST	6' - 0"	8' - 6"	1 3/8"	D12	WD	PAINT	Yes	Υ	F7A	WD	PAINT	No	CRU-001	No	No	Yes	No		FIT EXISTING OPENING. DOUBLE GLAZING, HERITAGE DOOR TYPE A
LEVEL 0 LOWER	001B	Exterior	CRU 1 SOUTH	3' - 0"	7' - 0"	1 3/8"	D13	WD	PAINT	Yes	Υ	F6A	WD	PAINT	No	CRU-002	No	No	Yes	No		FIT EXISTING OPENING. DOUBLE GLAZING, HERITAGE DOOR TYPE B
LEVEL 0 LOWER	001C	Exterior	CRU 1 SOUTH	3' - 0"	7' - 0"	1 3/8"	D13	WD	PAINT	Yes	Υ	F6A	WD	PAINT	No	CRU-002	No	No	Yes	No		HERITAGE DOOR TYPE B
LEVEL 0 LOWER	002	Exterior	RES. BIKES TO COMMERCIAL BIKES	3' - 0"	7' - 0"	1 3/4"	D2	НМ	PAINT	Yes	Y	F1	PS	PAINT	Yes	EAC-001	Yes	Yes	Yes	No	45 mins	
LEVEL 0 LOWER	003	Exterior	COMM BIKES TO COMM GARBAGE	6' - 0"	7' - 0"	1 3/4"	D3A	HM	PAINT	No	Υ	F5A	PS	PAINT	No	EAC-002A	No	Yes	Yes	No	45 mins	
LEVEL 0 LOWER	004	Interior	RES. BIKES TO EMR	3' - 0"	7' - 0"	1 3/4"	D1	HM	PAINT	No	-	F1	PS	PAINT	No	SER-002	No	No	Yes	No	45 mins	
LEVEL 0 LOWER	005	Exterior	PUBLIC WALKWAY TO COMMERCIAL BIKES	6' - 0"	7' - 0"	1 3/4"	D4	НМ	PAINT	No	Y	F2	PS	PAINT	No	EAC-002	Yes	Yes	Yes	No		
LEVEL 0 LOWER	006	Exterior	PUBLIC WALKWAY TO MECHANICAL	6' - 0"	7' - 0"	1 3/4"	D3A	НМ	PAINT	No	-	F5A	PS	PAINT	No	SER-003	No	No	Yes	No	45 mins	
LEVEL 0 LOWER	007	Interior	CORRIDOR TO RES GARBAGE	4' - 0"	7' - 0"	1 3/4"	D3B	HM	PAINT	Yes	-	F2	PS	PAINT	No	EAC-002	Yes	Yes	Yes	No	45 mins	
LEVEL 0 LOWER	008	Exterior	COMMERCIAL BIKES TO ELE	3' - 0"	7' - 0"	1 3/4"	D2	HM	PAINT	Yes	Υ	F1	PS	PAINT	Yes	SER-004	No	No	Yes	No	45 mins	
LEVEL 0 LOWER	009	Exterior	COMM BIKES TO CORRIDOR	4' - 0"	7' - 0"	1 3/4"	D3B	HM	PAINT	No	-	F2	PS	PAINT	No	EAC-002	Yes	Yes	Yes	No	45 mins	
LEVEL 0 LOWER	010	Interior	CORRIDOR TO RES BIKES / LOCKERS	3' - 0"	7' - 0"	1 3/4"	D1	НМ	PAINT	No	-	F1	PS	PAINT	No	EAC-003	Yes	Yes	Yes	No	45 mins	
LEVEL 00	011	Exterior	CRU 2 WEST ENTRY	3' - 0"	7' - 0"	1 3/4"	D5	ALUM		Yes	Y	F4	ALUM	-	Yes	EAC-004	No	Yes	Yes	No		
LEVEL 00	011A	Exterior	CRU 2 SW HERITAGE	3' - 11 1/4"	8' - 9"	1 3/8"	D12	WD	PAINT	Yes	Υ	F6A	WD	PAINT	Yes	CRU-001A	No	No	No	No		NO PUBLIC ACCESS, HERITAGE DOOR TYPE A
LEVEL 00	011B	Exterior	CRU 2 SW HERITAGE	3' - 11 1/4"	8' - 9"	1 3/8"	D12	WD	PAINT	Yes	Υ	F6A	WD	PAINT	Yes	CRU-001A	No	No	No	No		NO PUBLIC ACCESS, HERITAGE DOOR TYPE A
LEVEL 0 LOWER	011C	Exterior	CRU 2 NORTH ENTRY	3' - 0"	7' - 0"	1 3/8"	D13	WD	PAINT	Yes	Υ	F6A	WD	PAINT	No	CRU-002	No	No	Yes	No		HERITAGE DOOR TYPE B
ST01 ELEV01 THRESHOLD	012	Interior	CORRIDOR TO STORAGE	3' - 0"	6' - 8"	1 3/4"	D1	НМ	PAINT	No	-	F1	PS	PAINT	No	SER-002	No	No	Yes	No	45 mins	
LEVEL 0 LOWER	013	Interior	JANITOR	3' - 0"	7' - 0"	1 3/4"	D1	HM	PAINT	No	-	F1	PS	PAINT	No	SER-002	No	No	Yes	No	45 mins	
LEVEL 00	014	Interior	CORRIDOR TO RES BIKES / LOCKERS	3' - 0"	7' - 0"	1 3/4"	D1	НМ	PAINT	No	-	F1	PS	PAINT	No	EAC-003	Yes	Yes	Yes	No	45 mins	
LEVEL 00	G01	Exterior	PUBLIC WALKWAY GATE	7' - 0"	7' - 8"	2"	G2	MTL	PAINT	No	-	N/A	MTL	PAINT	No	GATE-001	Yes	Yes	No	No		HARDWARE BY GATE SUPPLIER

DOOR SCHEDULE	- LEVEL 01																					
								DOOR					FRA	ME				HARDWARE				
LEVEL	DOOR NO	FUNCTION	LOCATION		DIMENSIO		PANEL TYPE	PANEL MATERIAL	PANEL	PANEL THERMAL	PANEL GLAZING	FRAME TYPE	FRAME MATERIA	FRAME	FRAME THERMAL	GROUP	FOB	AUTOMATIC OPENER	CLOSER	PANIC	FRR	COMMENTS
				WIDTH	HEIGHT	THICKNESS	TYPE	I ANEL MATERIAL	FINISH	TARLE THERMAL	I AILL OLALINO	TIVAME TITE	TIVAME MATERIA	FINISH	TIVAME THERMAL	OKOOI	100	AUTOMATIO OF LINER	OLOGER	1 ANO		
LEVEL 01	1ST01	Interior	LOBBY CORRIDOR TO ST01	3' - 0"	6' - 8"	1 3/4"	D2	HM	PAINT	No	Υ	F1	PS	PAINT	No	EAC-008	Yes	No	Yes	No	45 mins	INCLUDE THRESHOLD TRANSITION FOR FLOORING
LEVEL 01	1ST02	Exterior	STAIR 2 EAST EXIT	3' - 0"	10' - 10"	1 3/8"	D15	WD	PAINT	Yes	Y	F8A	WD	PAINT	No	EAC-009	Yes	No	Yes	Yes		FIT EXISTING OPENING. DOUBLE GLAZING, FROSTED GLASS, HERITAGE DOOR TYPE B
LEVEL 01	101	Exterior	CRU 1 SOUTH ENTRY	3' - 0"	7' - 0"	1 3/8"	D13	WD	PAINT	Yes	Υ	F6A	WD	PAINT	No	EAC-007	No	Yes	Yes	No		FIT EXISTING OPENING. DOUBLE GLAZING, HERITAGE DOOR TYPE B
LEVEL 01	102	Exterior	CRU 2 NORTH ENTRY	3' - 0"	7' - 0"	1 3/8"	D13	WD	PAINT	Yes	Υ	F6A	WD	PAINT	No	EAC-007	No	Yes	Yes	No		FIT EXISTING OPENING. DOUBLE GLAZING, HERITAGE DOOR TYPE B
LEVEL 01	103	Exterior	RES LOBBY ENTRY	3' - 0"	8' - 10 3/4"	5/8"	D5	TPG	-	No	Υ	F4A	-	-	No	EAC-005	Yes	Yes	Yes	Yes		
LEVEL 01	103A	Interior	VESTIBULE TO LOBBY	3' - 0"	8' - 10 3/4"	5/8"	D7	TPG	-	No	Υ	F4A	-	-	No	EAC-006	No	Yes	Yes	Yes		
LEVELDI	104	Interior	LOBBY TO LOUNGE	3'-0"	8' - 10 3/4"	5/8"	DZ	TPG	~~~~	No	~~~~~~~~~~~~~~~~~~~~~~~~~~~~~~~~~~~~~~	F4A	~~~~~		No.	GLA-001	Yes	No	Yes	No		
LEVEL 01	104A	Interior	CALLROOM	2' - 10"	6' - 8"	1 3/4"	REFER TO I.D	HCWD	REFER TO I.D	No	Y	REFER TO I.D	WD	REFER TO I.D	No		No	No	No	No		DOORS TO CALLROOMS REFER TO I.D PACKAGE FOR FINISHES, DETAILING AND HARDWARE
LEVEL 01	104B	Interior	CALLROOM	2' - 10"	6' - 8"	1 3/4"	REFER TO I.D	HCWD	REFER TO I.D	No	Υ	REFER TO I.D	WD	REFER TO I.D	No		No	No	No	No		DOORS TO CALLROOMS REFER TO I.D PACKAGE FOR FINISHES, DETAILING AND HARDWARE
LEVEL 01	105	Exterior	CRU 1 NORTH ENTRY	3-0	10'-10"	13/8"	D14	WD	PAINT	Yes	· · · · · · · · · · · · · · · · · · ·	F7A F7A	WD	PAINT	No	CRU-004	N <sub>0</sub>	Nous	Yes	No	·····	HERITAGE DOOR TYPE D
LEVEL 01	106	Exterior	CRU 1 NORTH ENTRY	3' - 0"	10' - 10"	1 3/8"	D14	WD	PAINT	Yes	Υ	F7A	WD	PAINT	No	CRU-004	No	No	Yes	No		HERITAGE DOOR TYPE D
LEVEL 01	107	Exterior	CRU 2 ENTRY	6' - 2"	13' - 7 3/8"	1 3/8"	D14	WD	PAINT	Yes	Υ	F7A	WD	PAINT	No	CRU-004	No	No	Yes	No		HERITAGE DOOR TYPE C
LEVEL 01	G02	Exterior	PUBLIC WALKWAY GATE	7' - 0"	7' - 8"	2"	G2	MTL	PAINT	No	-	N/A	MTL	PAINT	No	GATE-001	Yes	Yes	Yes	No		HARDWARE BY GATE SUPPLIER

DOOR SCHEDULE	- LEVEL 02						/E\	~~~~	······	~~~~~~~~~~~~~~~~~~~~~~~~~~~~~~~~~~~~~~~											
							{	DOOR			3	FRAM	IE				HARDWARE				
LEVEL	DOOR NO	FUNCTION	LOCATION		DIMENSI	ONS	PANEL	PANEL MATERIAL	PANEL	PANEL THERMAL PANEL GLAZING	FRAME TYPE	FRAME MATERIAL	FRAME	FRAME THERMAL	GROUP	FOB	AUTOMATIC OPENER	CLOSER	PANIC	FRR	COMMENTS
				WIDTH	HEIGHT	THICKNESS	TYPE	PANEL WATERIAL	FINISH	PANEL THERMAL PANEL GLAZING	) FRAME TIPE	FRANCE WATERIAL	FINISH	FRAME INERMAL	GROUP	гов	AUTOMATIC OPENER	CLOSER	PANIC		
LEVEL 02	2ST01	Interior	CORRIDOR TO ST01	3' - 0"	6' - 8"	1 3/4"	D2	HM	PAINT	No Y	} F1	PS	PAINT	No	EAC-010	Yes	No	Yes	No	45 mins	INCLUDE THRESHOLD TRANSITION FOR FLOORING
LEVEL 02	2ST02	Interior	CORRIDOR TO ST02	3' - 0"	6' - 8"	1 3/4"	D2	WAM!	174111	Manney	F1	PS	PAINT	No	EAC-010	Yes	No	Yes	No	45 mins	INCLUDE THRESHOLD TRANSITION FOR FLOORING
LEVEL 02	201	Interior	RES. SUITE ENTRY	3' - 0"	6' - 8"	1 3/4"	D11	SCWD	REFER TO I.D.	No	F6	WD	REFER TO I.D.	No	SUITE-001	Yes	No	Yes	No	20 mins	
LEVEL 02	202	Interior	RES. SUITE ENTRY	3' - 0"	6' - 8"	1 3/4"	D11	SCWD	REFER TO I.D.	No	F6	WD	REFER TO I.D.	No	SUITE-001	Yes	No	Yes	No	20 mins	
LEVEL 02	203	Interior	RES. SUITE ENTRY	3' - 0"	6' - 8"	1 3/4"	D11	SCWD	REFER TO I.D.	No	F6	WD	REFER TO I.D.	No	SUITE-001	Yes	No	Yes	No	20 mins	
LEVEL 02	204	Interior	RES. SUITE ENTRY	3' - 0"	6' - 8"	1 3/4"	D11	SCWD	REFER TO I.D.	No	F6	WD	REFER TO I.D.	No	SUITE-001	Yes	No	Yes	No	20 mins	
LEVEL 02	205	Interior	RES. SUITE ENTRY	3' - 0"	6' - 8"	1 3/4"	D11	SCWD	REFER TO I.D.	No	F6	WD	REFER TO I.D.	No	SUITE-001	Yes	No	Yes	No	20 mins	
LEVEL 02	206	Interior	RES. SUITE ENTRY	3' - 0"	6' - 8"	1 3/4"	D11	SCWD	REFER TO I.D.	No	F6	WD	REFER TO I.D.	No	SUITE-001	Yes	No	Yes	No	20 mins	
LEVEL 02	207	Interior	RES. SUITE ENTRY	3' - 0"	6' - 8"	1 3/4"	D11	SCWD	REFER TO I.D.	No	F6	WD	REFER TO I.D.	No	SUITE-001	Yes	No	Yes	No	20 mins	
LEVEL 02	208	Interior	RES. SUITE ENTRY	3' - 0"	6' - 8"	1 3/4"	D11	SCWD	REFER TO I.D.	No	F6	WD	REFER TO I.D.	No	SUITE-001	Yes	No	Yes	No	20 mins	
LEVEL 02	209	Interior	RES. SUITE ENTRY	3' - 0"	6' - 8"	1 3/4"	D11	SCWD	REFER TO I.D.	No	F6	WD	REFER TO I.D.	No	SUITE-001	Yes	No	Yes	No	20 mins	
LEVEL 02	210	Interior	RES. SUITE ENTRY	3' - 0"	6' - 8"	1 3/4"	D11	SCWD	REFER TO I.D.	No	F6	WD	REFER TO I.D.	No	SUITE-001	Yes	No	Yes	No	20 mins	
LEVEL 02	211	Interior	RES. SUITE ENTRY	3' - 0"	6' - 8"	1 3/4"	D11	SCWD	REFER TO I.D.	No	F6	WD	REFER TO I.D.	No	SUITE-001	Yes	No	Yes	No	20 mins	
LEVEL 02	212	Interior	RES. SUITE ENTRY	3' - 0"	6' - 8"	1 3/4"	D11	SCWD	REFER TO I.D.	No	F6	WD	REFER TO I.D.	No	SUITE-001	Yes	No	Yes	No	20 mins	
LEVEL 02	213	Interior	CORRIDOR TO ELEC / COMM	6' - 0"	6' - 8"	1 3/4"	D3	НМ	PAINT	No -	F2	PS	PAINT	No	SER-001	No	No	Yes	No	45 mins	180DEG HINGE TO OPEN FLAT AGAINST WALL
									$\longrightarrow / \setminus$												

OOR SCHEDULE	E - LEVEL 03						~~~	· · · · · · · · · · · · · · · · · · ·	ZE \	~~~~~												
								DOOR				}	FRAM	ME				HARDWARE				
LEVEL	DOOR NO	FUNCTION	LOCATION	MIDTH	DIMENS		PANEL TYPE	PANEL MATERIAL	PANEL FINISH	PANEL THERMAL	PANEL GLAZING	FRAME TYPE	FRAME MATERIAL	FRAME FINISH	FRAME THERMAL	GROUP	FOB	AUTOMATIC OPENER	CLOSER	PANIC	FRR	COMMENTS
LEVEL 03	3ST01	Interior	CORRIDOR TO ST01	3' - 0"	<b>HEIGHT</b> 6' - 8"	THICKNESS 1 3/4"	D2	HM	PAINT	No	V	F1	PS	PAINT	No	EAC-010	Yes	No	Yes	No	45 mins	CROSS OVER FLOOR - FREE ACCESS REQ'D +INCLUDE THRESHOL
LEVEL 03	3ST02	Interior	CORRIDOR TO ST02	3' - 0"	6' - 8"	1 3/4"	Tuber	HM	PAINT	Nou	1 Y A	F1	PS	PAINT	No	EAC-010	Yes	No	Yes	No	45 mins	CROSS OVER FLOOR - FREE ACCESS REQ'D +INCLUDE THRESHOLI
LEVEL 03	301	Interior	RES. SUITE ENTRY	3' - 0"	6' - 8"	1 3/4"	D11	SCWD	REFER TO			F6	WD	REFER TO I.D.		SUITE-001	Yes	No	Yes	No	20 mins	CHOOCOVERTEOOR TREE HOSEOGREGO HEQD HINEOHOEL
LEVEL 03	302	Interior	RES. SUITE ENTRY	3' - 0"	6' - 8"	1 3/4"	D11	SCWD	REFER TO	No		F6	WD	REFER TO I.D.	No	SUITE-001	Yes	No	Yes	No	20 mins	
LEVEL 03	303	Interior	RES. SUITE ENTRY	3' - 0"	6' - 8"	1 3/4"	D11	SCWD	REFER TO	No		F6	WD	REFER TO I.D.	No	SUITE-001	Yes	No	Yes	No	20 mins	
LEVEL 03	304	Interior	RES. SUITE ENTRY	3' - 0"	6' - 8"	1 3/4"	D11	SCWD	REFER TO	No		F6	WD	REFER TO I.D.	No	SUITE-001	Yes	No	Yes	No	20 mins	
LEVEL 03	305	Interior	RES. SUITE ENTRY	3' - 0"	6' - 8"	1 3/4"	D11	SCWD	REFER TO	No		F6	WD	REFER TO I.D.	No	SUITE-001	Yes	No	Yes	No	20 mins	
LEVEL 03	306	Interior	RES. SUITE ENTRY	3' - 0"	6' - 8"	1 3/4"	D11	SCWD	REFER TO	No		F6	WD	REFER TO I.D.	No	SUITE-001	Yes	No	Yes	No	20 mins	
LEVEL 03	307	Interior	RES. SUITE ENTRY	3' - 0"	6' - 8"	1 3/4"	D11	SCWD	REFER TO	No		F6	WD	REFER TO I.D.	No	SUITE-001	Yes	No	Yes	No	20 mins	
LEVEL 03	308	Interior	RES. SUITE ENTRY	3' - 0"	6' - 8"	1 3/4"	D11	SCWD	REFER TO	No		F6	WD	REFER TO I.D.	No	SUITE-001	Yes	No	Yes	No	20 mins	
LEVEL 03	309	Interior	RES. SUITE ENTRY	3' - 0"	6' - 8"	1 3/4"	D11	SCWD	REFER TO	No		F6	WD	REFER TO I.D.	No	SUITE-001	Yes	No	Yes	No	20 mins	
LEVEL 03	310	Interior	RES. SUITE ENTRY	3' - 0"	6' - 8"	1 3/4"	D11	SCWD	REFER TO	No		F6	WD	REFER TO I.D.	No	SUITE-001	Yes	No	Yes	No	20 mins	
LEVEL 03	311	Interior	RES. SUITE ENTRY	3' - 0"	6' - 8"	1 3/4"	D11	SCWD	REFER TO	No		F6	WD	REFER TO I.D.	No	SUITE-001	Yes	No	Yes	No	20 mins	
LEVEL 03	312	Interior	RES. SUITE ENTRY	3' - 0"	6' - 8"	1 3/4"	D11	SCWD	REFER TO	No		F6	WD	REFER TO I.D.	No	SUITE-001	Yes	No	Yes	No	20 mins	
LEVEL 03	313	Interior	CORRIDOR TO ELEC / COMM	6' - 0"	6' - 8"	1 3/4"	D3	HM	PAINT	No	-	F2	PS	PAINT	No	SER-001	No	No	Yes	No	45 mins	180DEG HINGE TO OPEN FLAT AGAINST WALL



Boniface Oleksiuk Politano Architects



CROSSTOW PROPERTIES LTD.

### ISSUED FOR

A 2022-06-24 BUILDING PERMIT APPLICATION
B 2022-09-29 BUILDING PERMIT APPLICATION

)22-09-29 BUILDING PERMIT A REVISION 1

C 2022-10-14 ISSUED FOR TENDER

D 2023-03-27 POST-TENDER ADDENDUM 02 E 2023-04-09 BUILDING PERMIT APPLICATION

REVISION 3

### IMPERIAL

THIS DRAWING IS COPYRIGHTED AND MUST NOT BE USED, REPRODUCED, OR REVISED WITHOUT WRITTEN PERMISSION.

ALL DIMENSIONS ARE IN FEET AND INCHES UNLESS OTHERWISE NOTED.
VERIFY DIMENSIONS.
DO NOT SCALE THIS DRAWING.

REPORT INCONSISTENCIES AND OMISSIONS TO THE CONSULTANT FOR CLARIFICATION BEFORE COMMENCING WITH THE WORK.

DEVIATIONS FROM THE CONTRACT DOCUMENTS WITHOUT WRITTEN APPROVAL FROM THE CONSULTANT ARE SUBJECT TO CORRECTION AT THE CONTRACTOR'S EXPENSE.

ARCHITECT

BONIFACE OLEKSIUK POLITANO ARCHITECTS
180-510 NICOLA STREET
VANCOUVER BC, V6G 3J7
Tel: 236.521.6568 Email: info@bop.ca

This document has been digitally certified with digital certificate and encryption technology authorized by the Architectural Institute of BC and the Engineers and Geoscientists BC. The authoritative original has been transmitted to you in digital form. Any printed version can be relied upon as a true copy of the original when supplied by the architect, bearing images of the professional seal and digital certificate, or when printed from the digitally-certified electronic file provided by the architect.

SEA



## NORTHERN JUNK

1314 WHARF STREET

DOOR SCHEDULE, LEVEL 0-3

DRAWN: LM PLOT DATE: 2023-04-07 7:59:58 PM

CHECKED: SO/AP

A-007

/E -

**GENERAL NOTE** 

DOORS LOCATED IN WALLS WITH ACOUSTIC RATINGS (STC) TO PROVIDE ADEQUATE ACOUSTIC PERFORMANCE TO COMPLY WITH SECTION 5.8 OF THE BCBC ASTC REQUIREMENTS FOR PROTECTION FROM AIRBORNE NOISE.

19004C

DOOR SCHEDULE	- LEVEL 04								E	7												
							~~~~~	DOOR	~~~~	,,,,,,,,,,,,,,,,,,,,,,,,,,,,,,,,,,,,,,	~~~~~		FRAM	IE				HARDWARE				
LEVEL	DOOR NO	FUNCTION	LOCATION		DIMENSIO		PANEL	PANEL MATERIAL	PANEL	PANEL THERMAL		FRAME TYPE	FRAME MATERIAL	FRAME	FRAME THERMAL	GROUP	FOB	AUTOMATIC OPENER	CLOSER	PANIC	FRR	COMMENTS
				WIDTH	HEIGHT	THICKNESS	TYPE	I ANLE MATERIAL	FINISH	I ANLE IIILIMAL	I ANLL GLAZING	) INAME III E	TIVAME MATERIAL	FINISH	TIVAME THERMAL		105	ACTOMATIC OF EIGH	OLOOLK	TANO		
LEVEL 04	4ST401	Interior	CORRIDOR TO ST01	3' - 0"	6' - 8"	1 3/4"	D2	HM	PAINT	No	Υ	5 F1	PS	PAINT	No	EAC-010	Yes	No	Yes	No	45 mins	
LEVEL 04	4ST402	Interior	CORRIDOR TO ST02	3' - 0"	6' - 8"	1 3/4"	D2	HM	PAINT	No	Y	5 F1	PS	PAINT	No	EAC-010	Yes	No	Yes	No	45 mins	INCLUDE THRESHOLD TRANSITION FOR FLOORING
LEVEL 04	401	Interior	RES. SUITE ENTRY	3' - 0"	6' - 8"	1 3/4"	Mall	SCWD	REFER TO	Mo		F6	WD	REFER TO I.D.	No	SUITE-001	Yes	No	Yes	No	20 mins	
LEVEL 04	402	Interior	RES. SUITE ENTRY	3' - 0"	6' - 8"	1 3/4"	D11	SCWD	REFER TO I.D.	No		F6	WD	REFER TO I.D.	No	SUITE-001	Yes	No	Yes	No	20 mins	
LEVEL 04	403	Interior	RES. SUITE ENTRY	3' - 0"	6' - 8"	1 3/4"	D11	SCWD	REFER TO I.D.	No		F6	WD	REFER TO I.D.	No	SUITE-001	Yes	No	Yes	No	20 mins	
LEVEL 04	404	Interior	RES. SUITE ENTRY	3' - 0"	6' - 8"	1 3/4"	D11	SCWD	REFER TO I.D.	No		F6	WD	REFER TO I.D.	No	SUITE-001	Yes	No	Yes	No	20 mins	
LEVEL 04	405	Interior	RES. SUITE ENTRY	3' - 0"	6' - 8"	1 3/4"	D11	SCWD	REFER TO I.D.	No		F6	WD	REFER TO I.D.	No	SUITE-001	Yes	No	Yes	No	20 mins	
LEVEL 04	406	Interior	RES. SUITE ENTRY	3' - 0"	6' - 8"	1 3/4"	D11	SCWD	REFER TO I.D.	No		F6	WD	REFER TO I.D.	No	SUITE-001	Yes	No	Yes	No	20 mins	
LEVEL 04	407	Interior	RES. SUITE ENTRY	3' - 0"	6' - 8"	1 3/4"	D11	SCWD	REFER TO I.D.	No		F6	WD	REFER TO I.D.	No	SUITE-001	Yes	No	Yes	No	20 mins	
LEVEL 04	408	Interior	RES. SUITE ENTRY	3' - 0"	6' - 8"	1 3/4"	D11	SCWD	REFER TO I.D.	No		F6	WD	REFER TO I.D.	No	SUITE-001	Yes	No	Yes	No	20 mins	
LEVEL 04	409	Interior	RES. SUITE ENTRY	3' - 0"	6' - 8"	1 3/4"	D11	SCWD	REFER TO I.D.	No		F6	WD	REFER TO I.D.	No	SUITE-001	Yes	No	Yes	No	20 mins	
LEVEL 04	410	Interior	RES. SUITE ENTRY	3' - 0"	6' - 8"	1 3/4"	D11	SCWD	REFER TO I.D.	No		F6	WD	REFER TO I.D.	No	SUITE-001	Yes	No	Yes	No	20 mins	
LEVEL 04	411	Interior	RES. SUITE ENTRY	3' - 0"	6' - 8"	1 3/4"	D11	SCWD	REFER TO I.D.	No		F6	WD	REFER TO I.D.	No	SUITE-001	Yes	No	Yes	No	20 mins	
LEVEL 04	412	Interior	RES. SUITE ENTRY	3' - 0"	6' - 8"	1 3/4"	D11	SCWD	REFER TO I.D.	No		F6	WD	REFER TO I.D.	No	SUITE-001	Yes	No	Yes	No	20 mins	
LEVEL 04	413	Interior	CORRIDOR TO ELEC / COMM	6' - 0"	6' - 8"	1 3/4"	D3	НМ	PAINT	No	-	F2	PS	PAINT	No	SER-001	No	No	Yes	No	45 mins	180DEG HINGE TO OPEN FLAT AGAINST WALL

OOR SCHEDULI	E - LEVEL 05								E													
I EVE	DOOD NO	FUNCTION	LOGATION		DIMENSIO			DOOR		· · · · · · · · · · · · · · · · · · ·	~~~~~~~~~~~~~~~~~~~~~~~~~~~~~~~~~~~~~~		FRAM		I			HARDWARE		I		COMMENTO
LEVEL	DOOR NO	FUNCTION	LOCATION	WIDTH	DIMENSIC HEIGHT	THICKNESS	PANEL TYPE	PANEL MATERIAL	PANEL FINISH	PANEL THERMAL	PANEL GLAZING	FRAME TYPE	FRAME MATERIAL	FRAME FINISH	FRAME THERMAL	GROUP	FOB	AUTOMATIC OPENER	CLOSER	PANIC	FRR	COMMENTS
LEVEL 05	5ST01	Interior	CORRIDOR TO ST01	3' - 0"	6' - 8"	1 3/4"	D2	HM	PAINT	No	Υ	5 F1	PS	PAINT	No	EAC-010	Yes	No	Yes	No	45 mins	INCLUDE THRESHOLD TRANSITION FOR FLOORING
LEVEL 05	5ST02	Interior	CORRIDOR TO ST02	3' - 0"	6' - 8"	1 3/4"	D2	HM	PAINT	No	Υ	} F1	PS	PAINT	No	EAC-010	Yes	No	Yes	No	45 mins	
LEVEL 05	501	Interior	RES. SUITE ENTRY	3' - 0"	6' - 8"	1 3/4"	W BAH	SCWD	REFER TO	NO NO		F6	WD	REFER TO I.D.	No	SUITE-001	Yes	No	Yes	No	20 mins	
LEVEL 05	502	Interior	RES. SUITE ENTRY	3' - 0"	6' - 8"	1 3/4"	D11	SCWD	REFER TO I.D.	No		F6	WD	REFER TO I.D.	No	SUITE-001	Yes	No	Yes	No	20 mins	
LEVEL 05	503	Interior	RES. SUITE ENTRY	3' - 0"	6' - 8"	1 3/4"	D11	SCWD	REFER TO I.D.	No		F6	WD	REFER TO I.D.	No	SUITE-001	Yes	No	Yes	No	20 mins	
LEVEL 05	504	Interior	RES. SUITE ENTRY	3' - 0"	6' - 8"	1 3/4"	D11	SCWD	REFER TO I.D.	No		F6	WD	REFER TO I.D.	No	SUITE-001	Yes	No	Yes	No	20 mins	
LEVEL 05	505	Interior	RES. SUITE ENTRY	3' - 0"	6' - 8"	1 3/4"	D11	SCWD	REFER TO I.D.	No		F6	WD	REFER TO I.D.	No	SUITE-001	Yes	No	Yes	No	20 mins	
LEVEL 05	506	Interior	RES. SUITE ENTRY	3' - 0"	6' - 8"	1 3/4"	D11	SCWD	REFER TO I.D.	No		F6	WD	REFER TO I.D.	No	SUITE-001	Yes	No	Yes	No	20 mins	
LEVEL 05	507	Interior	RES. SUITE ENTRY	3' - 0"	6' - 8"	1 3/4"	D11	SCWD	REFER TO I.D.	No		F6	WD	REFER TO I.D.	No	SUITE-001	Yes	No	Yes	No	20 mins	
LEVEL 05	508	Interior	RES. SUITE ENTRY	3' - 0"	6' - 8"	1 3/4"	D11	SCWD	REFER TO I.D.	No		F6	WD	REFER TO I.D.	No	SUITE-001	Yes	No	Yes	No	20 mins	
LEVEL 05	509	Interior	RES. SUITE ENTRY	3' - 0"	6' - 8"	1 3/4"	D11	SCWD	REFER TO	No		F6	WD	REFER TO I.D.	No	SUITE-001	Yes	No	Yes	No	20 mins	
LEVEL 05	510	Interior	RES. SUITE ENTRY	3' - 0"	6' - 8"	1 3/4"	D11	SCWD	REFER TO I.D.	No		F6	WD	REFER TO I.D.	No	SUITE-001	Yes	No	Yes	No	20 mins	
LEVEL 05	511	Interior	RES. SUITE ENTRY	3' - 0"	6' - 8"	1 3/4"	D11	SCWD	REFER TO I.D.	No		F6	WD	REFER TO I.D.	No	SUITE-001	Yes	No	Yes	No	20 mins	
LEVEL 05	513	Interior	CORRIDOR TO ELEC / COMM	6' - 0"	6' - 8"	1 3/4"	D3	HM	PAINT	No	-	F2	WD	PAINT	No	SER-001	No	No	Yes	No	45 mins	

DOOR SCHEDULE	- ROOF LEVEL																					
								DOOR					FRAME					HARDWARE				
LEVEL	DOOR NO	FUNCTION	LOCATION		DIMENSIO	ONS	PANEL	DANIEL MATERIAL	PANEL	PANEL THERMAL	DANIEL CLAZINIC	FRAME TYPE	EDAME MATERIAL	FRAME	EDAME THEDMAI	GROUP	FOR	AUTOMATIC OPENER	CLOSED	DANIC	FRR	COMMENTS
				WIDTH	HEIGHT	THICKNESS	TYPE	PANEL MATERIAL	FINISH	PANEL INERWAL	PANEL GLAZING	FRAME ITPE	FRAME MATERIAL	FINISH	FRAME THERMAL	GROUP	FOB	AUTOWATIC OPENER	CLOSER	PANIC		
ROOF LEVEL	6ST01	Exterior	ROOF TO ST01	3' - 3"	7' - 0"	1 3/4"	D5	ALUM		No		F4	ALUM	-	No	EAC-011	Yes	No	Yes	No		
ROOF LEVEL	601	Exterior	MECH ENCLOSURE	3' - 0"	6' - 8"	1 3/4"	G3	MTL	PAINT	No	-	F4	ALUM	PAINT	No	EXT-001	No	No	No	No		

DOOR SCHEDUL	R SCHEDULE - SUITE DOORS																		
						DOOR					FRAME					HARDWARE			
DOOR NO	FUNCTION		DIMENSIO	DNS	PANEL	PANEL MATERIAL	DANIEL EINIGH	PANEL THERMAL	PANEL GLAZING	FRAME TYPE	FRAME MATERIAL	FRAME	FRAME THERMAL	GROUP	FOB	AUTOMATIC OPENER	CLOSER	PANIC	FRR COMMENTS
		WIDTH	HEIGHT	THICKNESS	TYPE	PANEL WATERIAL	PANEL FINISH	PANEL INERWAL	PANEL GLAZING	FRAME TIPE	FRAINE MATERIAL	FINISH	FRAME INERMAL	GROUP	ГОВ	AUTOWATIC OPENER	CLOSEK	PANIC	
A1	Interior	2' - 6"	6' - 8"	1 3/4"	Α	HCWD	SEE I.D.	No	-	F6	WD	SEE I.D.	No	<varies></varies>	No	No	No	No	
A2	Interior	2' - 10"	6' - 8"	1 3/4"	Α	HCWD	SEE I.D.	No	-	F6	WD	SEE I.D.	No	SUITE-003	No	No	No	No	
C1	Interior	3' - 6"	6' - 8"	1 3/8"	С	HCWD	SEE I.D.	No	-	<varies></varies>	WD	<varies></varies>	No	<varies></varies>	No	No	No	No	
C2	Interior	4' - 6"	6' - 8"	1 3/8"	С	HCWD	SEE I.D.	No	-	F7	WD	SEE I.D.	No	SUITE-005	No	No	No	No	
C3	Interior	5' - 0"	6' - 8"	1 3/8"	С	HCWD	SEE I.D.	No	-	F7	WD	SEE I.D.	No	SUITE-006	No	No	No	No	
E1	Interior	3' - 0"	6' - 8"	1 3/8"	Е	HCWD	SEE I.D.	No	-	F7	WD	SEE I.D.	No	SUITE-007	No	No	No	No	
E2	Interior	2' - 9"	6' - 8"	1 3/8"	Е	HCWD	SEE I.D.	No	-	F7	WD	SEE I.D.	No	SUITE-007	No	No	No	No	
J1	Interior	VARIES	VARIES	VARIES	D	GLASS	SEE I.D.	No	YES	SEE I.D.	ALUM	SEE I.D.	No		No	No	No	No	HARDWARE BY MANUFACTURER/SUPPLIER

## **GENERAL NOTE**

DOORS LOCATED IN WALLS WITH ACOUSTIC RATINGS (STC) TO PROVIDE ADEQUATE ACOUSTIC PERFORMANCE TO COMPLY WITH SECTION 5.8 OF THE BCBC ASTC REQUIREMENTS FOR PROTECTION FROM AIRBORNE NOISE.





Boniface Oleksiuk Politano Architects



PROPERTIES LTD.

### ISSUED FOR

A 2022-06-24 BUILDING PERMIT APPLICATION B 2022-09-29 BUILDING PERMIT APPLICATION **REVISION 1** 

C 2022-10-14 ISSUED FOR TENDER

D 2023-03-27 POST-TENDER ADDENDUM 02 E 2023-04-09 BUILDING PERMIT APPLICATION

**REVISION 3** 

### **IMPERIAL**

THIS DRAWING IS COPYRIGHTED AND MUST NOT BE USED, REPRODUCED, OR REVISED WITHOUT WRITTEN PERMISSION.

ALL DIMENSIONS ARE IN FEET AND INCHES UNLESS OTHERWISE VERIFY DIMENSIONS. DO NOT SCALE THIS DRAWING.

REPORT INCONSISTENCIES AND OMISSIONS TO THE CONSULTANT FOR CLARIFICATION BEFORE COMMENCING WITH THE WORK.

DEVIATIONS FROM THE CONTRACT DOCUMENTS WITHOUT WRITTEN APPROVAL FROM THE CONSULTANT ARE SUBJECT TO CORRECTION AT THE CONTRACTOR'S EXPENSE.

ARCHITECT BONIFACE OLEKSIUK POLITANO ARCHITECTS 180-510 NICOLA STREET VANCOUVER BC, V6G 3J7 Tel: 236.521.6568 Email: info@bop.ca

This document has been digitally certified with digital certificate and encryption technology authorized by the Architectural Institute of BC and the Engineers and Geoscientists BC. The authoritative original has been transmitted to you in digital form. Any printed version can be relied upon as a true copy of the original when supplied by the architect, bearing images of the professional seal and digital certificate, or when printed from the digitally-certified electronic file provided by the architect.



## NORTHERN JUNK

1314 WHARF STREET

DOOR SCHEDULE, LEVEL 04-ROOF

DRAWN: LM PLOT DATE: 2023-04-07 8:00:03 PM


CHECKED: SO/AP


19004C

		DII	MENSIONS	F	RAME	PAN	NEL		
Mark	Туре	Width	Height	Material	Finish	Material	Finish	Comments	
EVEL 00									
V001	А	4' - 1"	6' - 0"	Wood / Fir	Paint	Glazed	-	EXISTING OPENING - RESIZED	
V003	С	3' - 0"	5' - 6"	Wood / Fir	Paint	Glazed	-	NEW OPENING	
V004	A	3' - 4 1/8"	5' - 0"	Wood / Fir	Paint	Glazed	-	EXISTING OPENING	
V005	A	3' - 4 1/8"	5' - 0"	Wood / Fir	Paint	Glazed	-	EXISTING OPENING	
V006	A	3' - 4 1/8"	5' - 0"	Wood / Fir	Paint	Glazed	-	EXISTING OPENING	
V007	A	3' - 4 1/8"	5' - 0"	Wood / Fir	Paint	Glazed	-	EXISTING OPENING	
EVEL 01 V101	С	3' - 0"	6' - 0"	Wood / Fir	Paint	Glazed		NEW OPENING	
	_	3' - 0"	6' - 0"				-		
V102	С	3' - 0"	6' - 0"	Wood / Fir	Paint	Glazed	-	NEW OPENING	
V103	С			Wood / Fir	Paint	Glazed	-	NEW OPENING	
V106	D	3' - 8" 3' - 8"	9' - 5"	Wood / Fir	Paint	Glazed	-	EXISTING OPENING - RESIZED	
V107	D		9' - 5"	Wood / Fir	Paint	Glazed	-	EXISTING OPENING - RESIZED	
V108	D	3' - 11 7/8"	9' - 5"	Wood / Fir	Paint	Glazed	-	EXISTING OPENING - RESIZED C/W LOUVER	
V109	C	3' - 0"	5' - 6"	Wood / Fir	Paint	Glazed	-	NEW OPENING	
V110	C	3' - 0"	5' - 6"	Wood / Fir	Paint	Glazed	-	NEW OPENING	
V111	E	4' - 8 1/2"	12' - 2 3/8"	Wood / Fir	Paint	Glazed	-	NEW OPENING	
V112	E	4' - 8 1/2"	12' - 2 3/8"	Wood / Fir	Paint	Glazed	-	NEW OPENING	
V115	A	3' - 6 5/8"	7' - 9 3/4"	Wood / Fir	Paint	Glazed	-	EXISTING OPENING	
V116	A	3' - 6 5/8"	7' - 9 3/4"	Wood / Fir	Paint	Glazed	-	EXISTING OPENING	
V117	A	3' - 6 5/8"	7' - 9 3/4"	Wood / Fir	Paint	Glazed	-	EXISTING OPENING	
V118	C	3' - 0"	5' - 6"	Wood / Fir	Paint	Glazed	-	NEW OPENING	
V119	A	3' - 3"	8' - 5 1/2"	Wood / Fir	Paint	Glazed	-	EXISTING OPENING	
V120	A	4' - 3 1/8"	8' - 5 1/2"	Wood / Fir	Paint	Glazed	-	EXISTING OPENING	
V121	A	3' - 3"	8' - 5 1/2"	Wood / Fir	Paint	Glazed	-	EXISTING OPENING	
V122 V123	A	3' - 3"	8' - 5 1/2"	Wood / Fir	Paint	Glazed	-	EXISTING OPENING	
V I / S	A	4' - 3 1/8"	8' - 5 1/2"	Wood / Fir	Paint	Glazed	-	EXISTING OPENING	

NOTE: FIELD VERIFY ALL OPENINGS AND DIMENSIONS, TYPICAL

NOTE: WOODEN FRAME PROFILES TO MATCH SALVAGED FRAME ELEMENTS OR SIMILAR TO BE APPROVED BY CONSULTANT

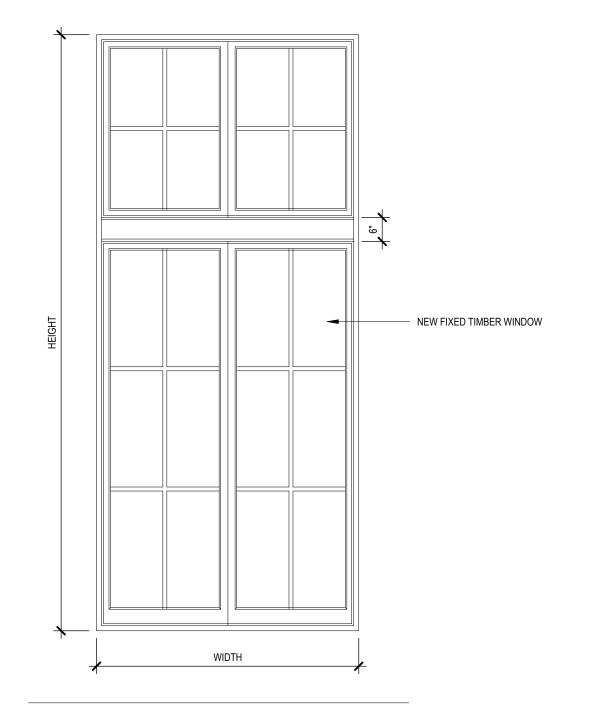

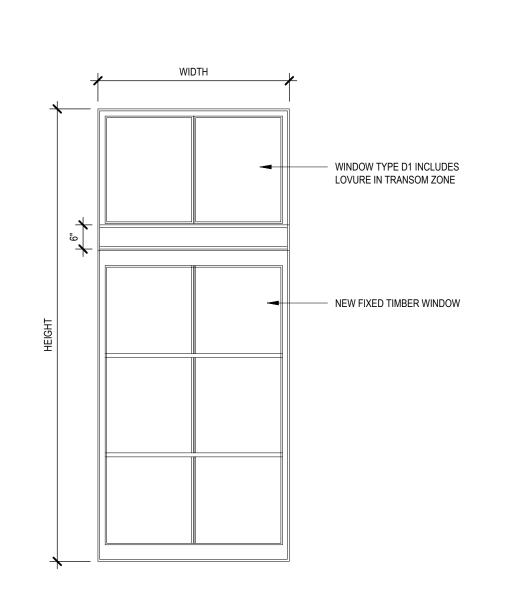


WINDOW TYPE D




WINDOW TYPE E

SCALE: 1/2" = 1'-0"

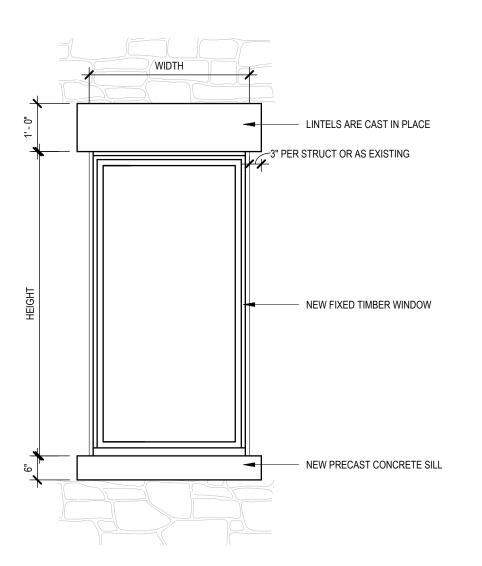



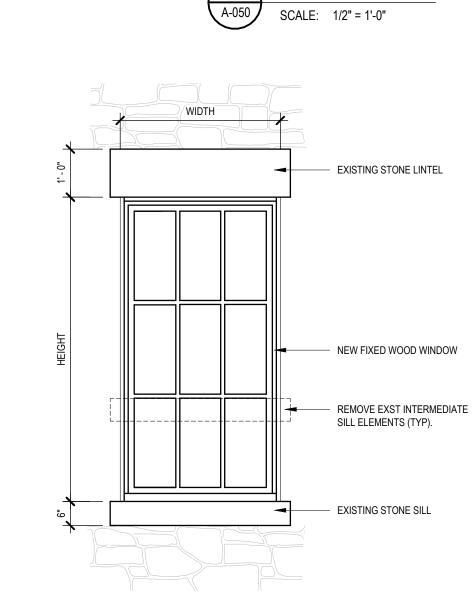







Boniface Oleksiuk Politano Architects

PROPERTIES LTD.

### ISSUED FOR

- A 2022-06-24 BUILDING PERMIT APPLICATION
  B 2022-09-29 BUILDING PERMIT APPLICATION
- REVISION 1 C 2022-10-14 ISSUED FOR TENDER
- D 2023-04-09 BUILDING PERMIT APPLICATION REVISION 3

### IMPERIAL

THIS DRAWING IS COPYRIGHTED AND MUST NOT BE USED, REPRODUCED, OR REVISED WITHOUT WRITTEN PERMISSION.

ALL DIMENSIONS ARE IN FEET AND INCHES UNLESS OTHERWISE NOTED.
VERIFY DIMENSIONS.

DO NOT SCALE THIS DRAWING.

REPORT INCONSISTENCIES AND OMISSIONS TO THE CONSULTANT

FOR CLARIFICATION BEFORE COMMENCING WITH THE WORK.

DEVIATIONS FROM THE CONTRACT DOCUMENTS WITHOUT

WRITTEN APPROVAL FROM THE CONSULTANT ARE SUBJECT TO CORRECTION AT THE CONTRACTOR'S EXPENSE.

ARCHITECT

BONIFACE OLEKSIUK POLITANO ARCHITECTS
180-510 NICOLA STREET
VANCOUVER BC, V6G 3J7
Tel: 236.521.6568 Email: info@bop.ca

This document has been digitally certified with digital certificate and encryption technology authorized by the Architectural Institute of BC and the Engineers and Geoscientists BC. The authoritative original has been transmitted to you in digital form. Any printed version can be relied upon as a true copy of the original when supplied by the architect, bearing images of the professional seal and digital certificate, or when printed from the digitally-certified electronic file provided by the architect.

SEAL



## NORTHERN JUNK

1314 WHARF STREET


WINDOW SCHEDULE, TYPES & FRAMES

DRAWN: LM CHECKED: SO/AP PLOT DATE: 2023-04-07 8:00:05 PM

A-050


19004C

C:\Users\Louis Moore\Documents\Northern Junk Model\_louis84FE8.rvt

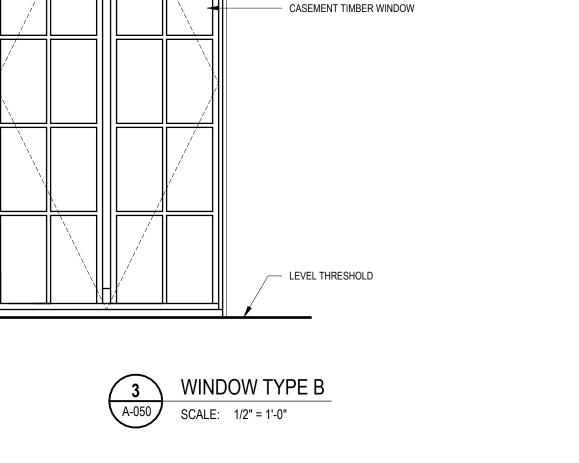

EXISTING STONE LINTEL

REPLACE EXISTING WOOD OR METAL LINTELS WITH NEW CUT SANDSTONE LINTELS TO MATCH PROPORTIONS OF ADJACENT SIMILAR STONE

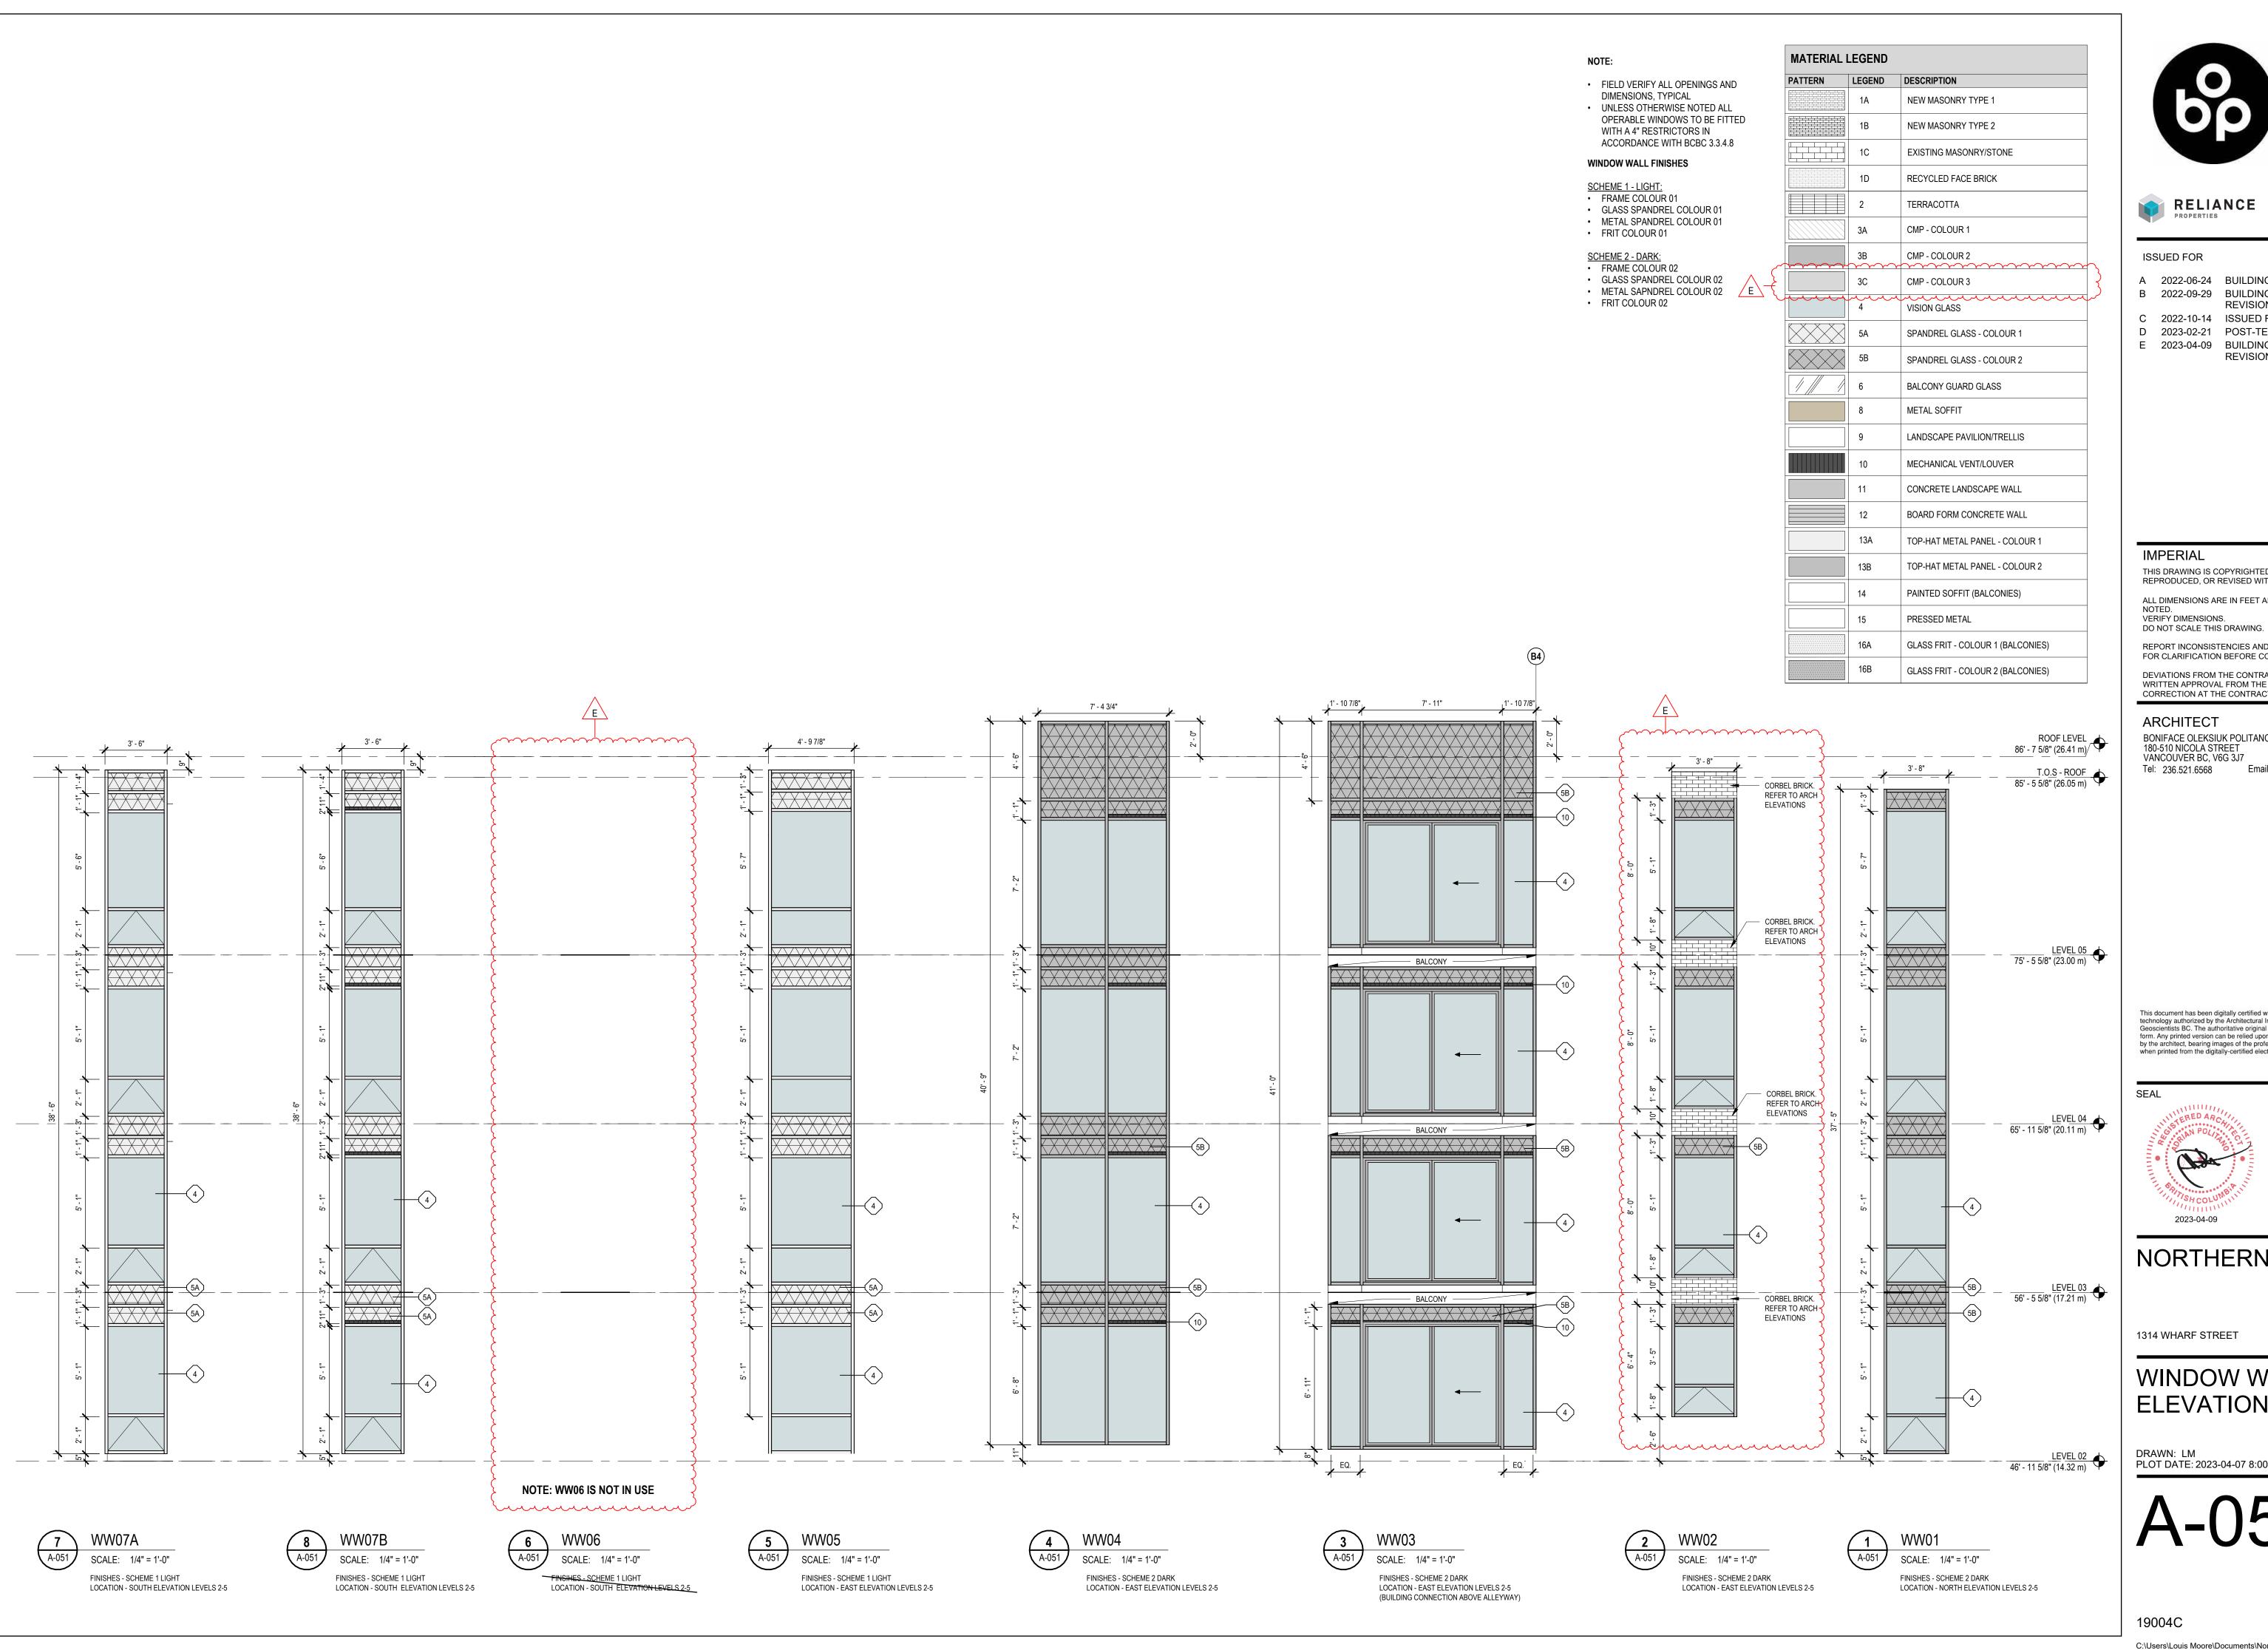





### ISSUED FOR

A 2022-06-24 BUILDING PERMIT APPLICATION B 2022-09-29 BUILDING PERMIT APPLICATION

PROPERTIES LTD.

**REVISION 1** 

C 2022-10-14 ISSUED FOR TENDER

D 2023-02-21 POST-TENDER ADDENDUM

E 2023-04-09 BUILDING PERMIT APPLICATION **REVISION 3** 

THIS DRAWING IS COPYRIGHTED AND MUST NOT BE USED, REPRODUCED, OR REVISED WITHOUT WRITTEN PERMISSION.

ALL DIMENSIONS ARE IN FEET AND INCHES UNLESS OTHERWISE VERIFY DIMENSIONS.

REPORT INCONSISTENCIES AND OMISSIONS TO THE CONSULTANT

FOR CLARIFICATION BEFORE COMMENCING WITH THE WORK. DEVIATIONS FROM THE CONTRACT DOCUMENTS WITHOUT

WRITTEN APPROVAL FROM THE CONSULTANT ARE SUBJECT TO CORRECTION AT THE CONTRACTOR'S EXPENSE.

## BONIFACE OLEKSIUK POLITANO ARCHITECTS

180-510 NICOLA STREET VANCOUVER BC, V6G 3J7 Tel: 236.521.6568 Email: info@bop.ca

This document has been digitally certified with digital certificate and encryption technology authorized by the Architectural Institute of BC and the Engineers and Geoscientists BC. The authoritative original has been transmitted to you in digital form. Any printed version can be relied upon as a true copy of the original when supplied by the architect, bearing images of the professional seal and digital certificate, or when printed from the digitally-certified electronic file provided by the architect.



## NORTHERN JUNK


1314 WHARF STREET

## WINDOW WALL, **ELEVATIONS 1**

PLOT DATE: 2023-04-07 8:00:19 PM

CHECKED: SO/AP

A-051

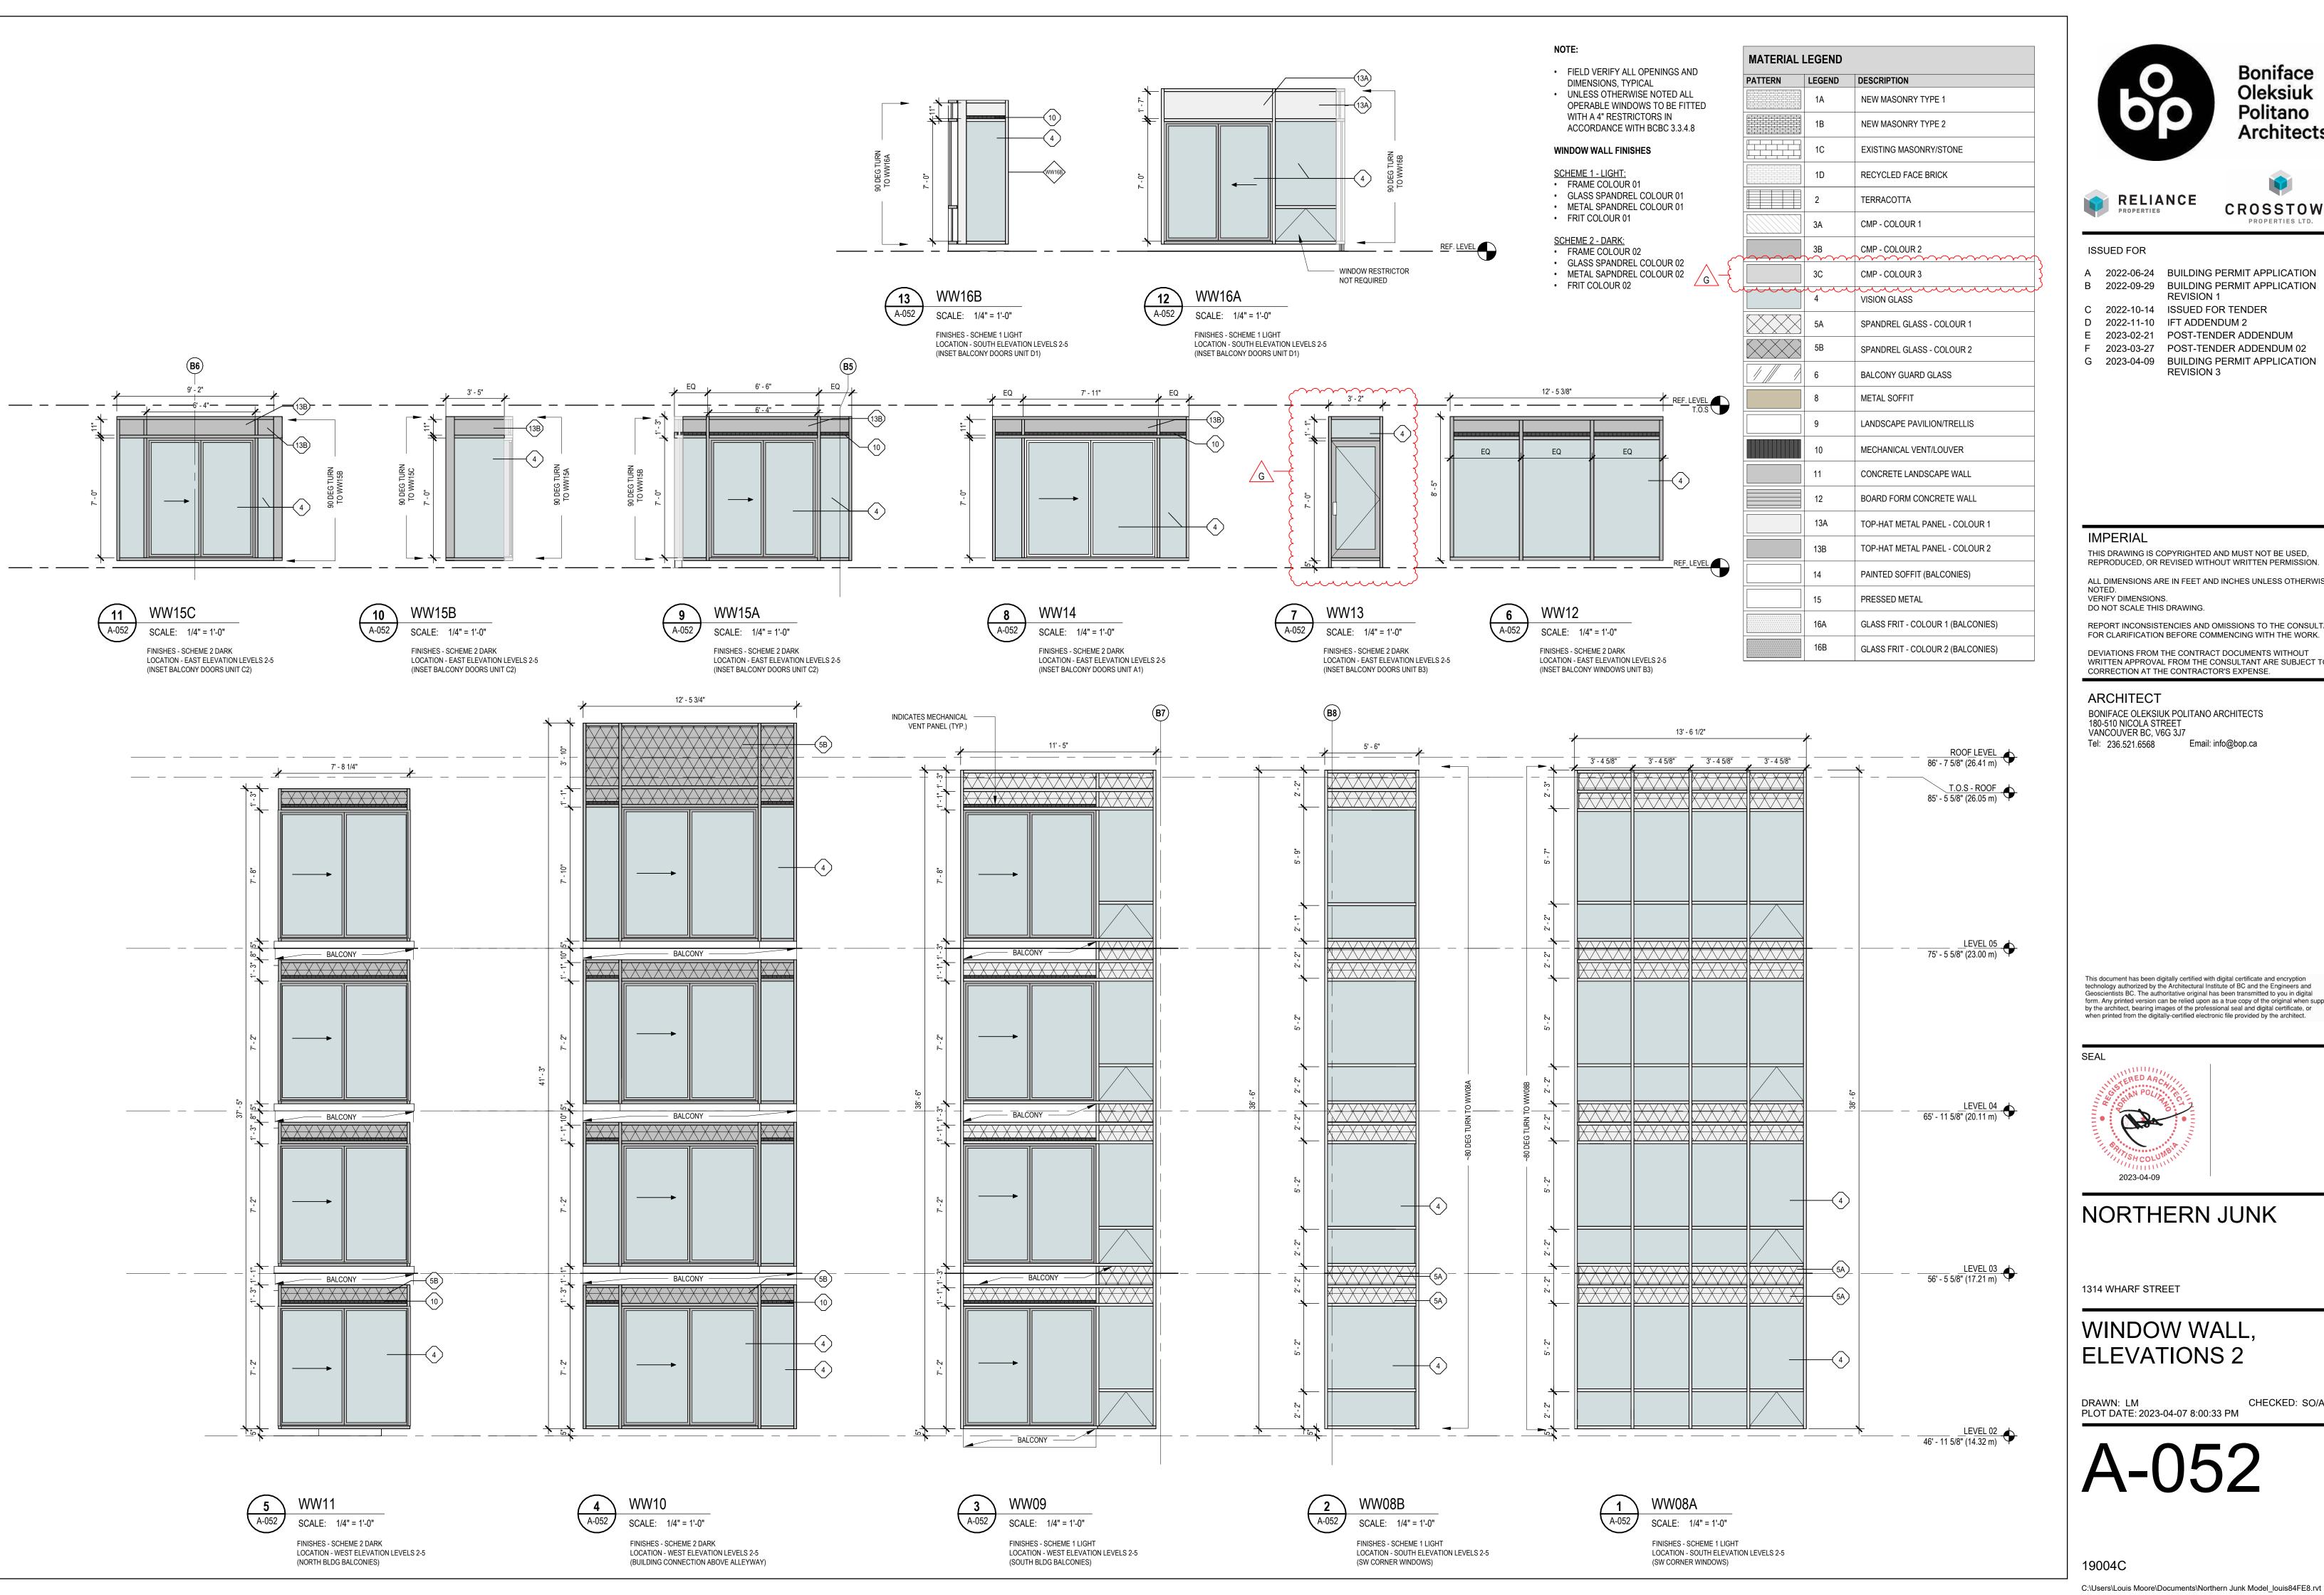



**Boniface** Oleksiuk Politano

PROPERTIES LTD



CROSSTOWN

### ISSUED FOR

- A 2022-06-24 BUILDING PERMIT APPLICATION B 2022-09-29 BUILDING PERMIT APPLICATION
  - **REVISION 1**
- C 2022-10-14 ISSUED FOR TENDER
- D 2022-11-10 IFT ADDENDUM 2
- E 2023-02-21 POST-TENDER ADDENDUM
- F 2023-03-27 POST-TENDER ADDENDUM 02
- G 2023-04-09 BUILDING PERMIT APPLICATION **REVISION 3**

### **IMPERIAL**

THIS DRAWING IS COPYRIGHTED AND MUST NOT BE USED, REPRODUCED, OR REVISED WITHOUT WRITTEN PERMISSION.

ALL DIMENSIONS ARE IN FEET AND INCHES UNLESS OTHERWISE VERIFY DIMENSIONS.

DO NOT SCALE THIS DRAWING. REPORT INCONSISTENCIES AND OMISSIONS TO THE CONSULTANT

DEVIATIONS FROM THE CONTRACT DOCUMENTS WITHOUT WRITTEN APPROVAL FROM THE CONSULTANT ARE SUBJECT TO

**ARCHITECT** 

BONIFACE OLEKSIUK POLITANO ARCHITECTS 180-510 NICOLA STREET VANCOUVER BC, V6G 3J7 Tel: 236.521.6568 Email: info@bop.ca

This document has been digitally certified with digital certificate and encryption technology authorized by the Architectural Institute of BC and the Engineers and Geoscientists BC. The authoritative original has been transmitted to you in digital form. Any printed version can be relied upon as a true copy of the original when supplied by the architect, bearing images of the professional seal and digital certificate, or when printed from the digitally-certified electronic file provided by the architect.



## **NORTHERN JUNK**


1314 WHARF STREET


WINDOW WALL, **ELEVATIONS 2** 


PLOT DATE: 2023-04-07 8:00:33 PM

CHECKED: SO/AP

19004C

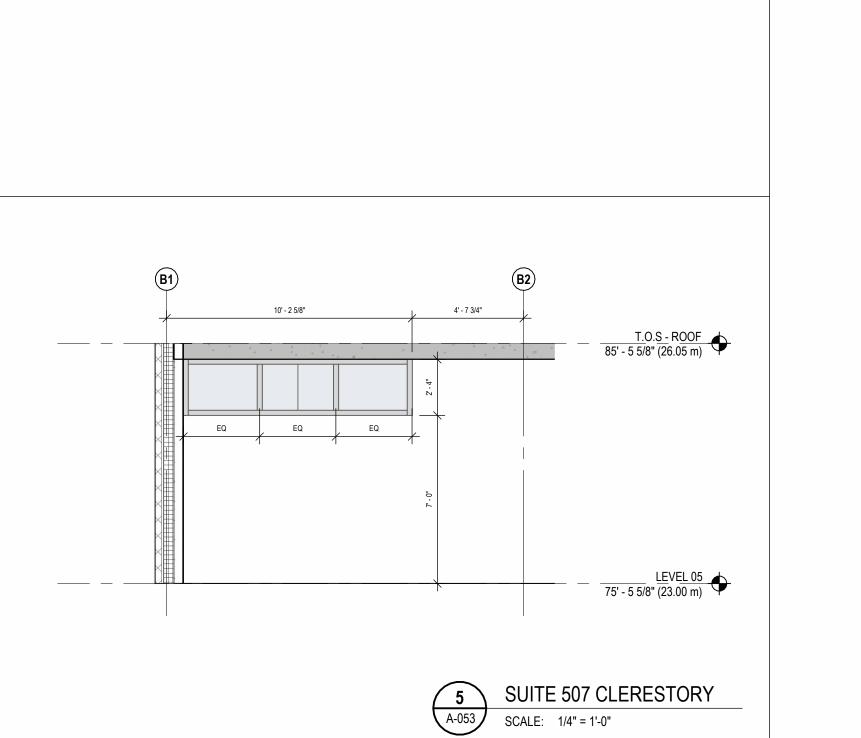

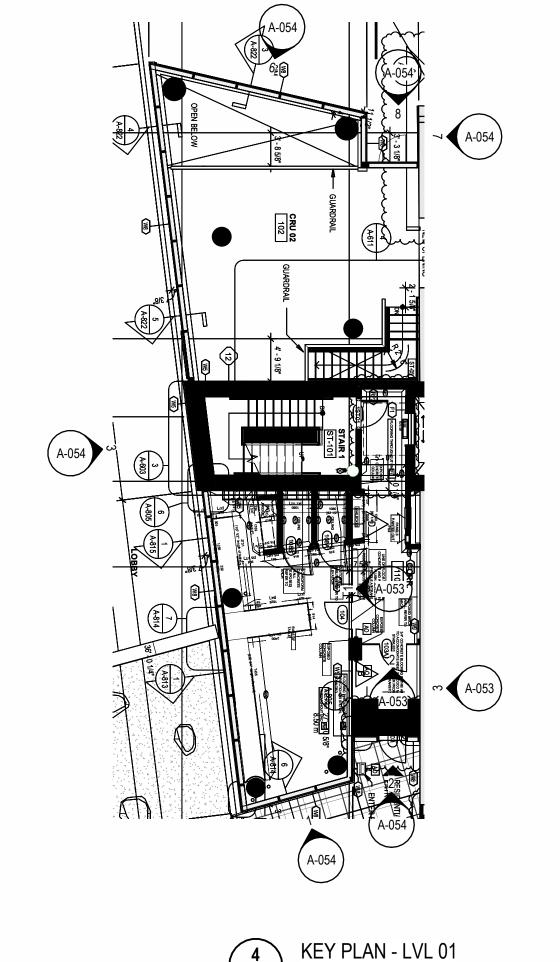

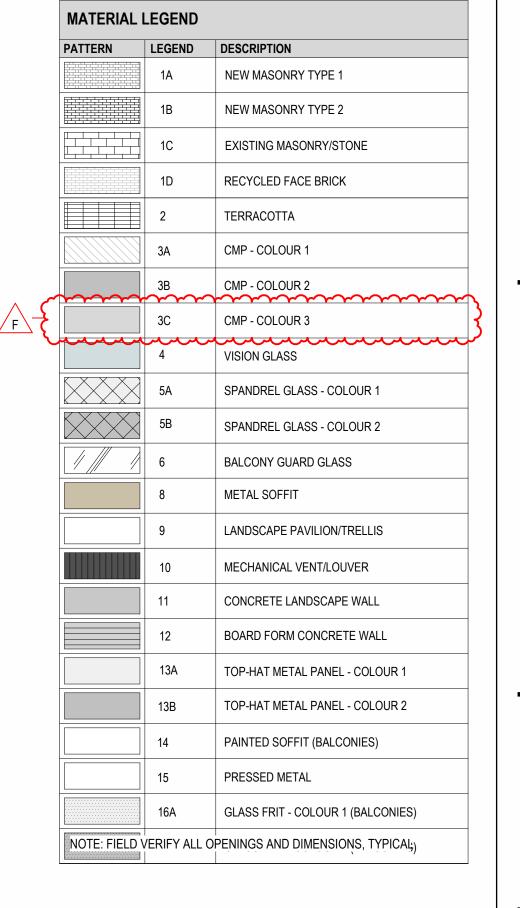





CROSSTOWN PROPERTIES LTD.

### ISSUED FOR

- A 2022-06-24 BUILDING PERMIT APPLICATION
- B 2022-09-29 BUILDING PERMIT APPLICATION **REVISION 1**
- C 2022-10-14 ISSUED FOR TENDER
- D 2022-11-10 IFT ADDENDUM 2
- E 2023-02-21 POST-TENDER ADDENDUM
- F 2023-04-09 BUILDING PERMIT APPLICATION **REVISION 3**

## **IMPERIAL**

THIS DRAWING IS COPYRIGHTED AND MUST NOT BE USED, REPRODUCED, OR REVISED WITHOUT WRITTEN PERMISSION.

ALL DIMENSIONS ARE IN FEET AND INCHES UNLESS OTHERWISE VERIFY DIMENSIONS.

DO NOT SCALE THIS DRAWING.


REPORT INCONSISTENCIES AND OMISSIONS TO THE CONSULTANT FOR CLARIFICATION BEFORE COMMENCING WITH THE WORK.


DEVIATIONS FROM THE CONTRACT DOCUMENTS WITHOUT WRITTEN APPROVAL FROM THE CONSULTANT ARE SUBJECT TO CORRECTION AT THE CONTRACTOR'S EXPENSE.

## **ARCHITECT**


BONIFACE OLEKSIUK POLITANO ARCHITECTS

180-510 NICOLA STREET VANCOUVER BC, V6G 3J7 Tel: 236.521.6568 Email: info@bop.ca

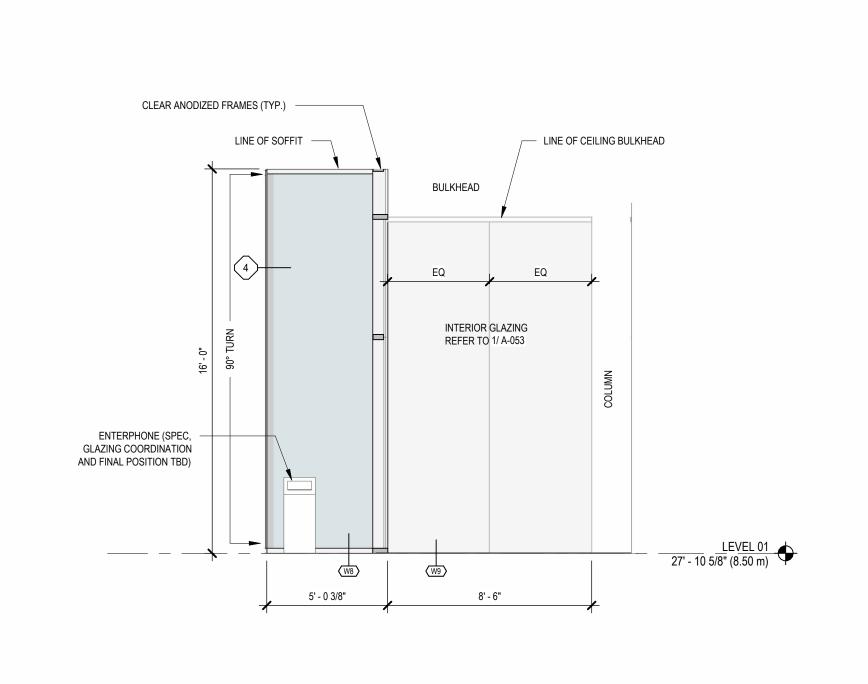

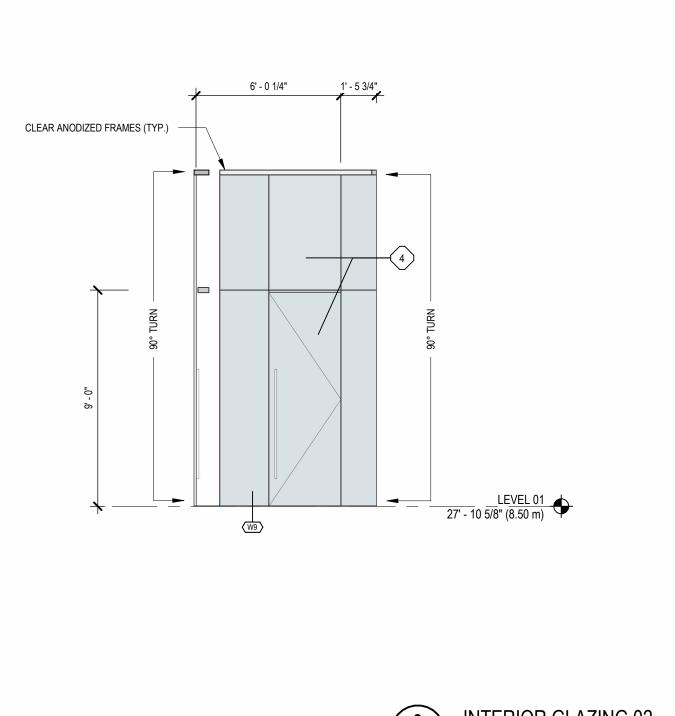



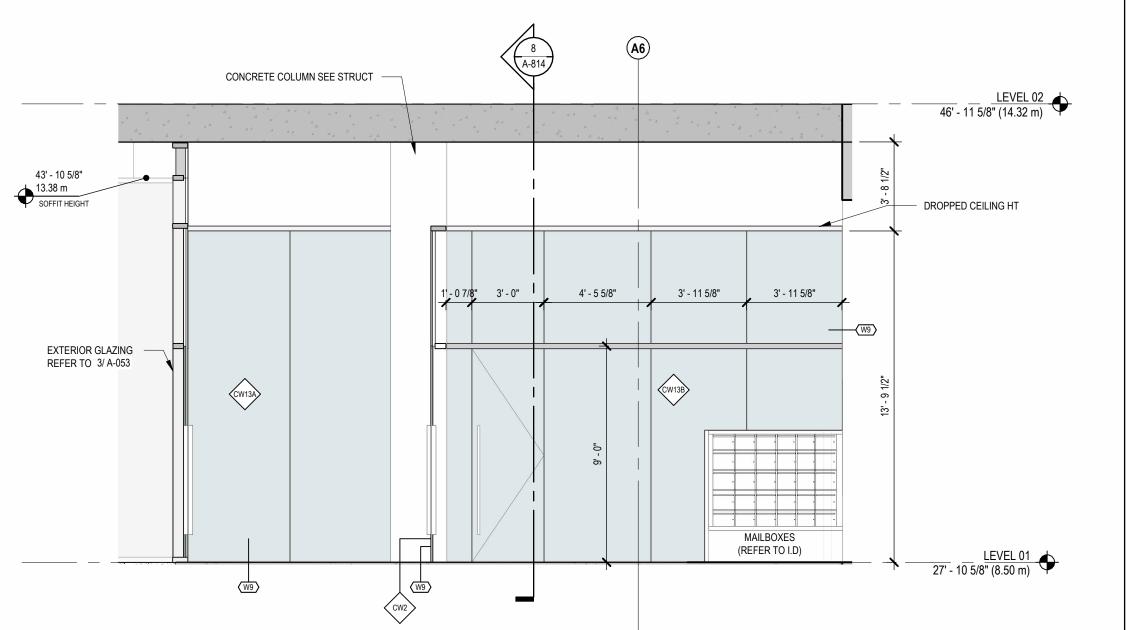

1 INTERIOR GLAZING 01

A-053 SCALE: 1/4" = 1'-0"

This document has been digitally certified with digital certificate and encryption technology authorized by the Architectural Institute of BC and the Engineers and Geoscientists BC. The authoritative original has been transmitted to you in digital form. Any printed version can be relied upon as a true copy of the original when supplied by the architect, bearing images of the professional seal and digital certificate, or when printed from the digitally-certified electronic file provided by the architect.

SEAL



NORTHERN JUNK


1314 WHARF STREET

INTERIOR GLAZING SCHEDULE

CHECKED: Checker DRAWN: Author PLOT DATE: 2023-04-07 8:00:50 PM

A-053

19004C

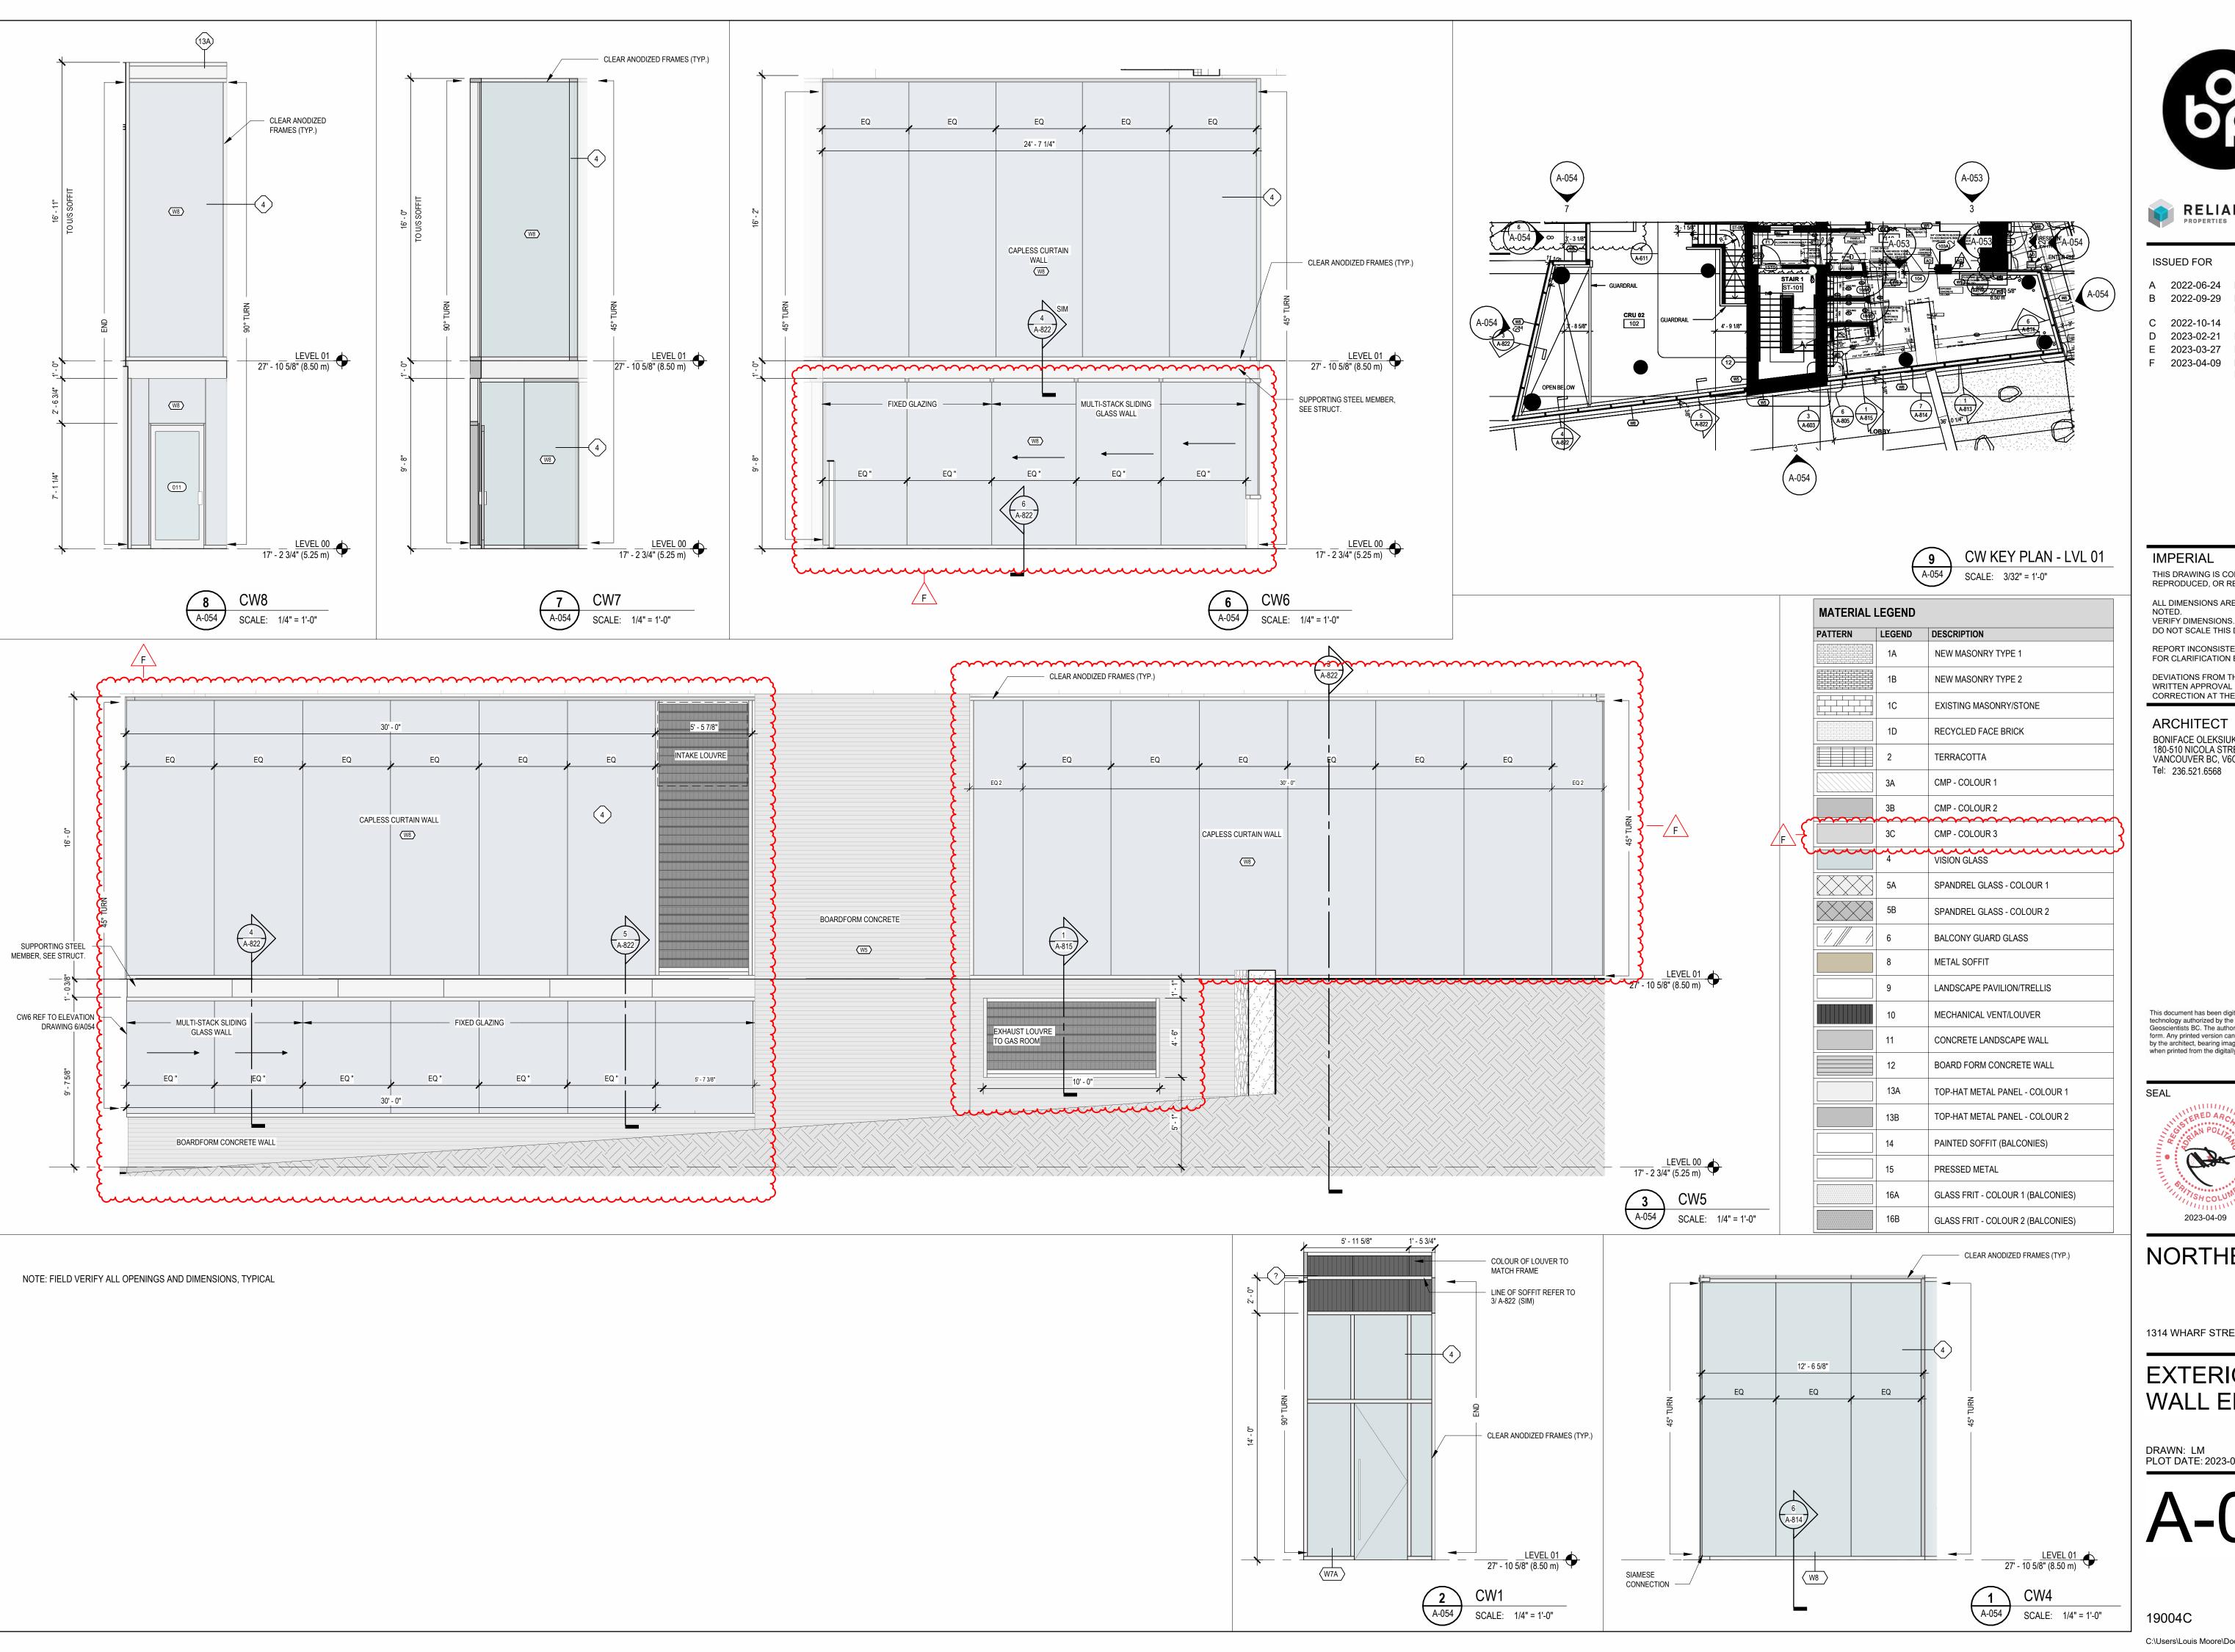

Boniface Oleksiuk Politano Architects

PROPERTIES LTD



CROSSTOWN

### ISSUED FOR

- A 2022-06-24 BUILDING PERMIT APPLICATION
- B 2022-09-29 BUILDING PERMIT APPLICATION **REVISION 1**
- C 2022-10-14 ISSUED FOR TENDER
- D 2023-02-21 POST-TENDER ADDENDUM
- E 2023-03-27 POST-TENDER ADDENDUM 02 F 2023-04-09 BUILDING PERMIT APPLICATION
  - **REVISION 3**

THIS DRAWING IS COPYRIGHTED AND MUST NOT BE USED, REPRODUCED, OR REVISED WITHOUT WRITTEN PERMISSION.

ALL DIMENSIONS ARE IN FEET AND INCHES UNLESS OTHERWISE

DO NOT SCALE THIS DRAWING.

REPORT INCONSISTENCIES AND OMISSIONS TO THE CONSULTANT FOR CLARIFICATION BEFORE COMMENCING WITH THE WORK.

DEVIATIONS FROM THE CONTRACT DOCUMENTS WITHOUT WRITTEN APPROVAL FROM THE CONSULTANT ARE SUBJECT TO CORRECTION AT THE CONTRACTOR'S EXPENSE.

ARCHITECT

BONIFACE OLEKSIUK POLITANO ARCHITECTS 180-510 NICOLA STREET VANCOUVER BC, V6G 3J7

Tel: 236.521.6568 Email: info@bop.ca

This document has been digitally certified with digital certificate and encryption technology authorized by the Architectural Institute of BC and the Engineers and Geoscientists BC. The authoritative original has been transmitted to you in digital form. Any printed version can be relied upon as a true copy of the original when supplied by the architect, bearing images of the professional seal and digital certificate, or when printed from the digitally-certified electronic file provided by the architect.




## NORTHERN JUNK

1314 WHARF STREET

EXTERIOR CURTAIN WALL ELEVATIONS 1

DRAWN: LM PLOT DATE: 2023-04-07 8:01:10 PM

CHECKED: SO/AP

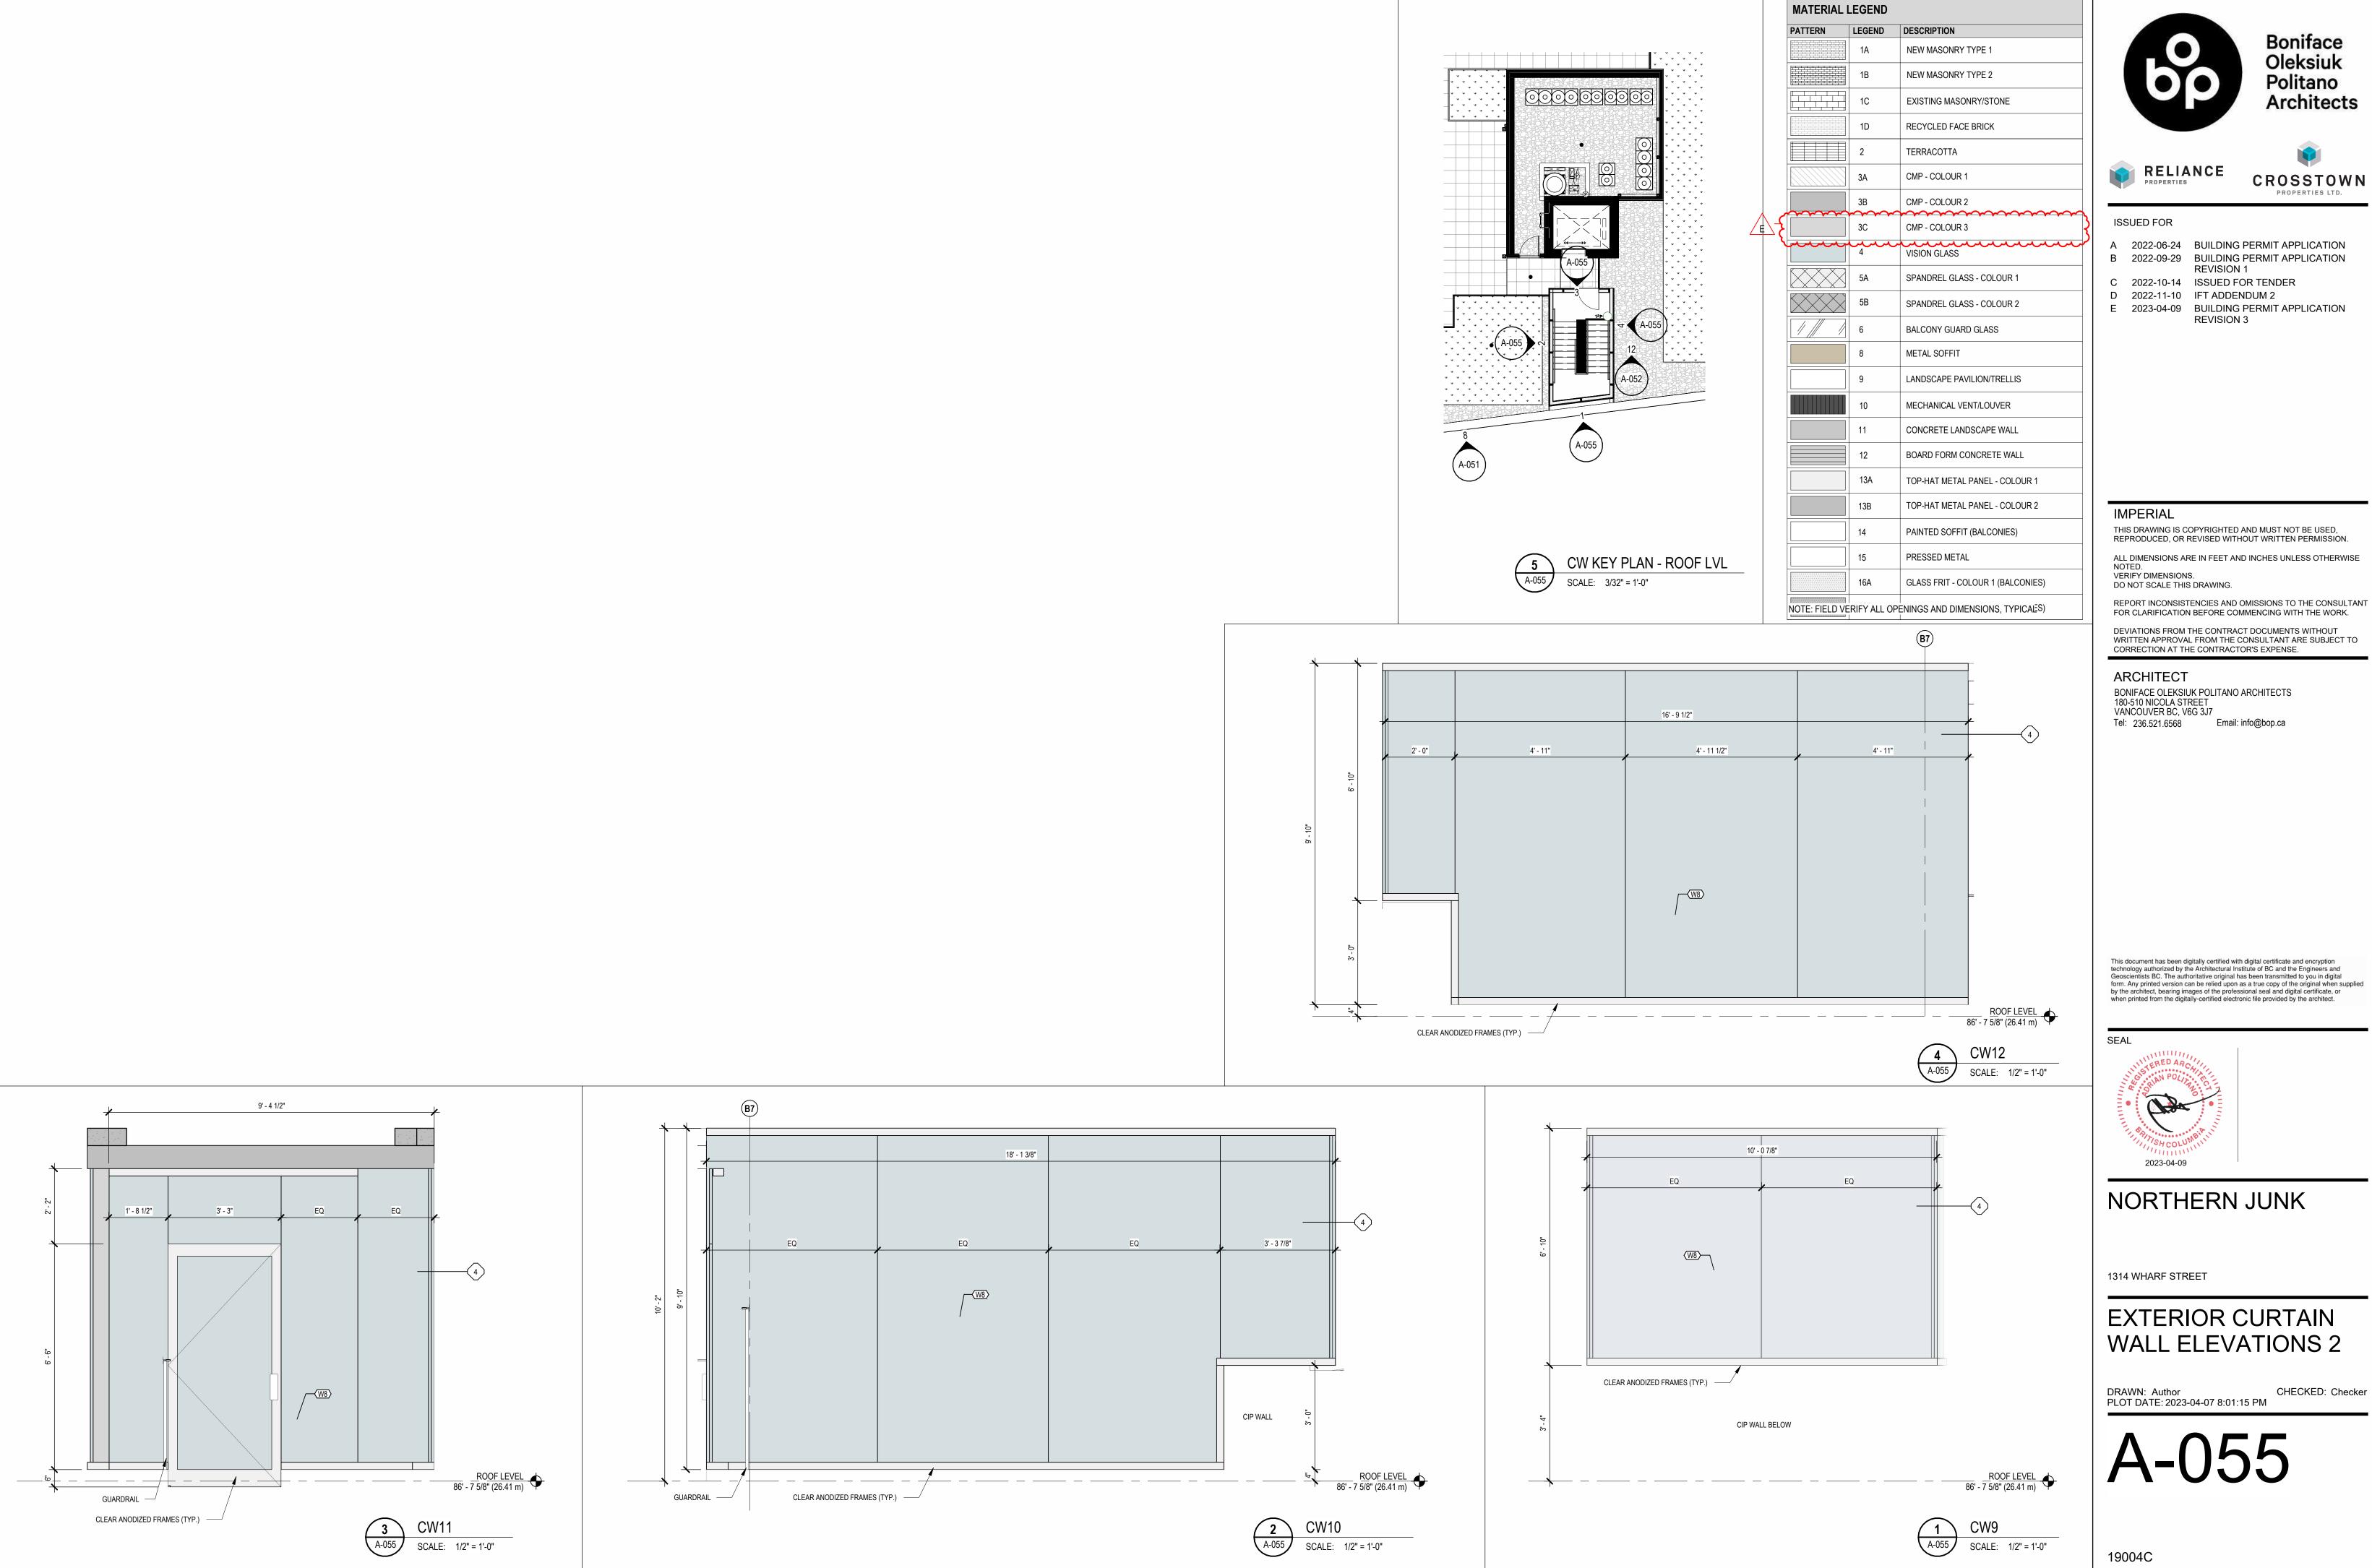

- A 2022-06-24 BUILDING PERMIT APPLICATION

THIS DRAWING IS COPYRIGHTED AND MUST NOT BE USED,


ALL DIMENSIONS ARE IN FEET AND INCHES UNLESS OTHERWISE

REPORT INCONSISTENCIES AND OMISSIONS TO THE CONSULTANT

DEVIATIONS FROM THE CONTRACT DOCUMENTS WITHOUT

WRITTEN APPROVAL FROM THE CONSULTANT ARE SUBJECT TO CORRECTION AT THE CONTRACTOR'S EXPENSE.

## EXTERIOR CURTAIN

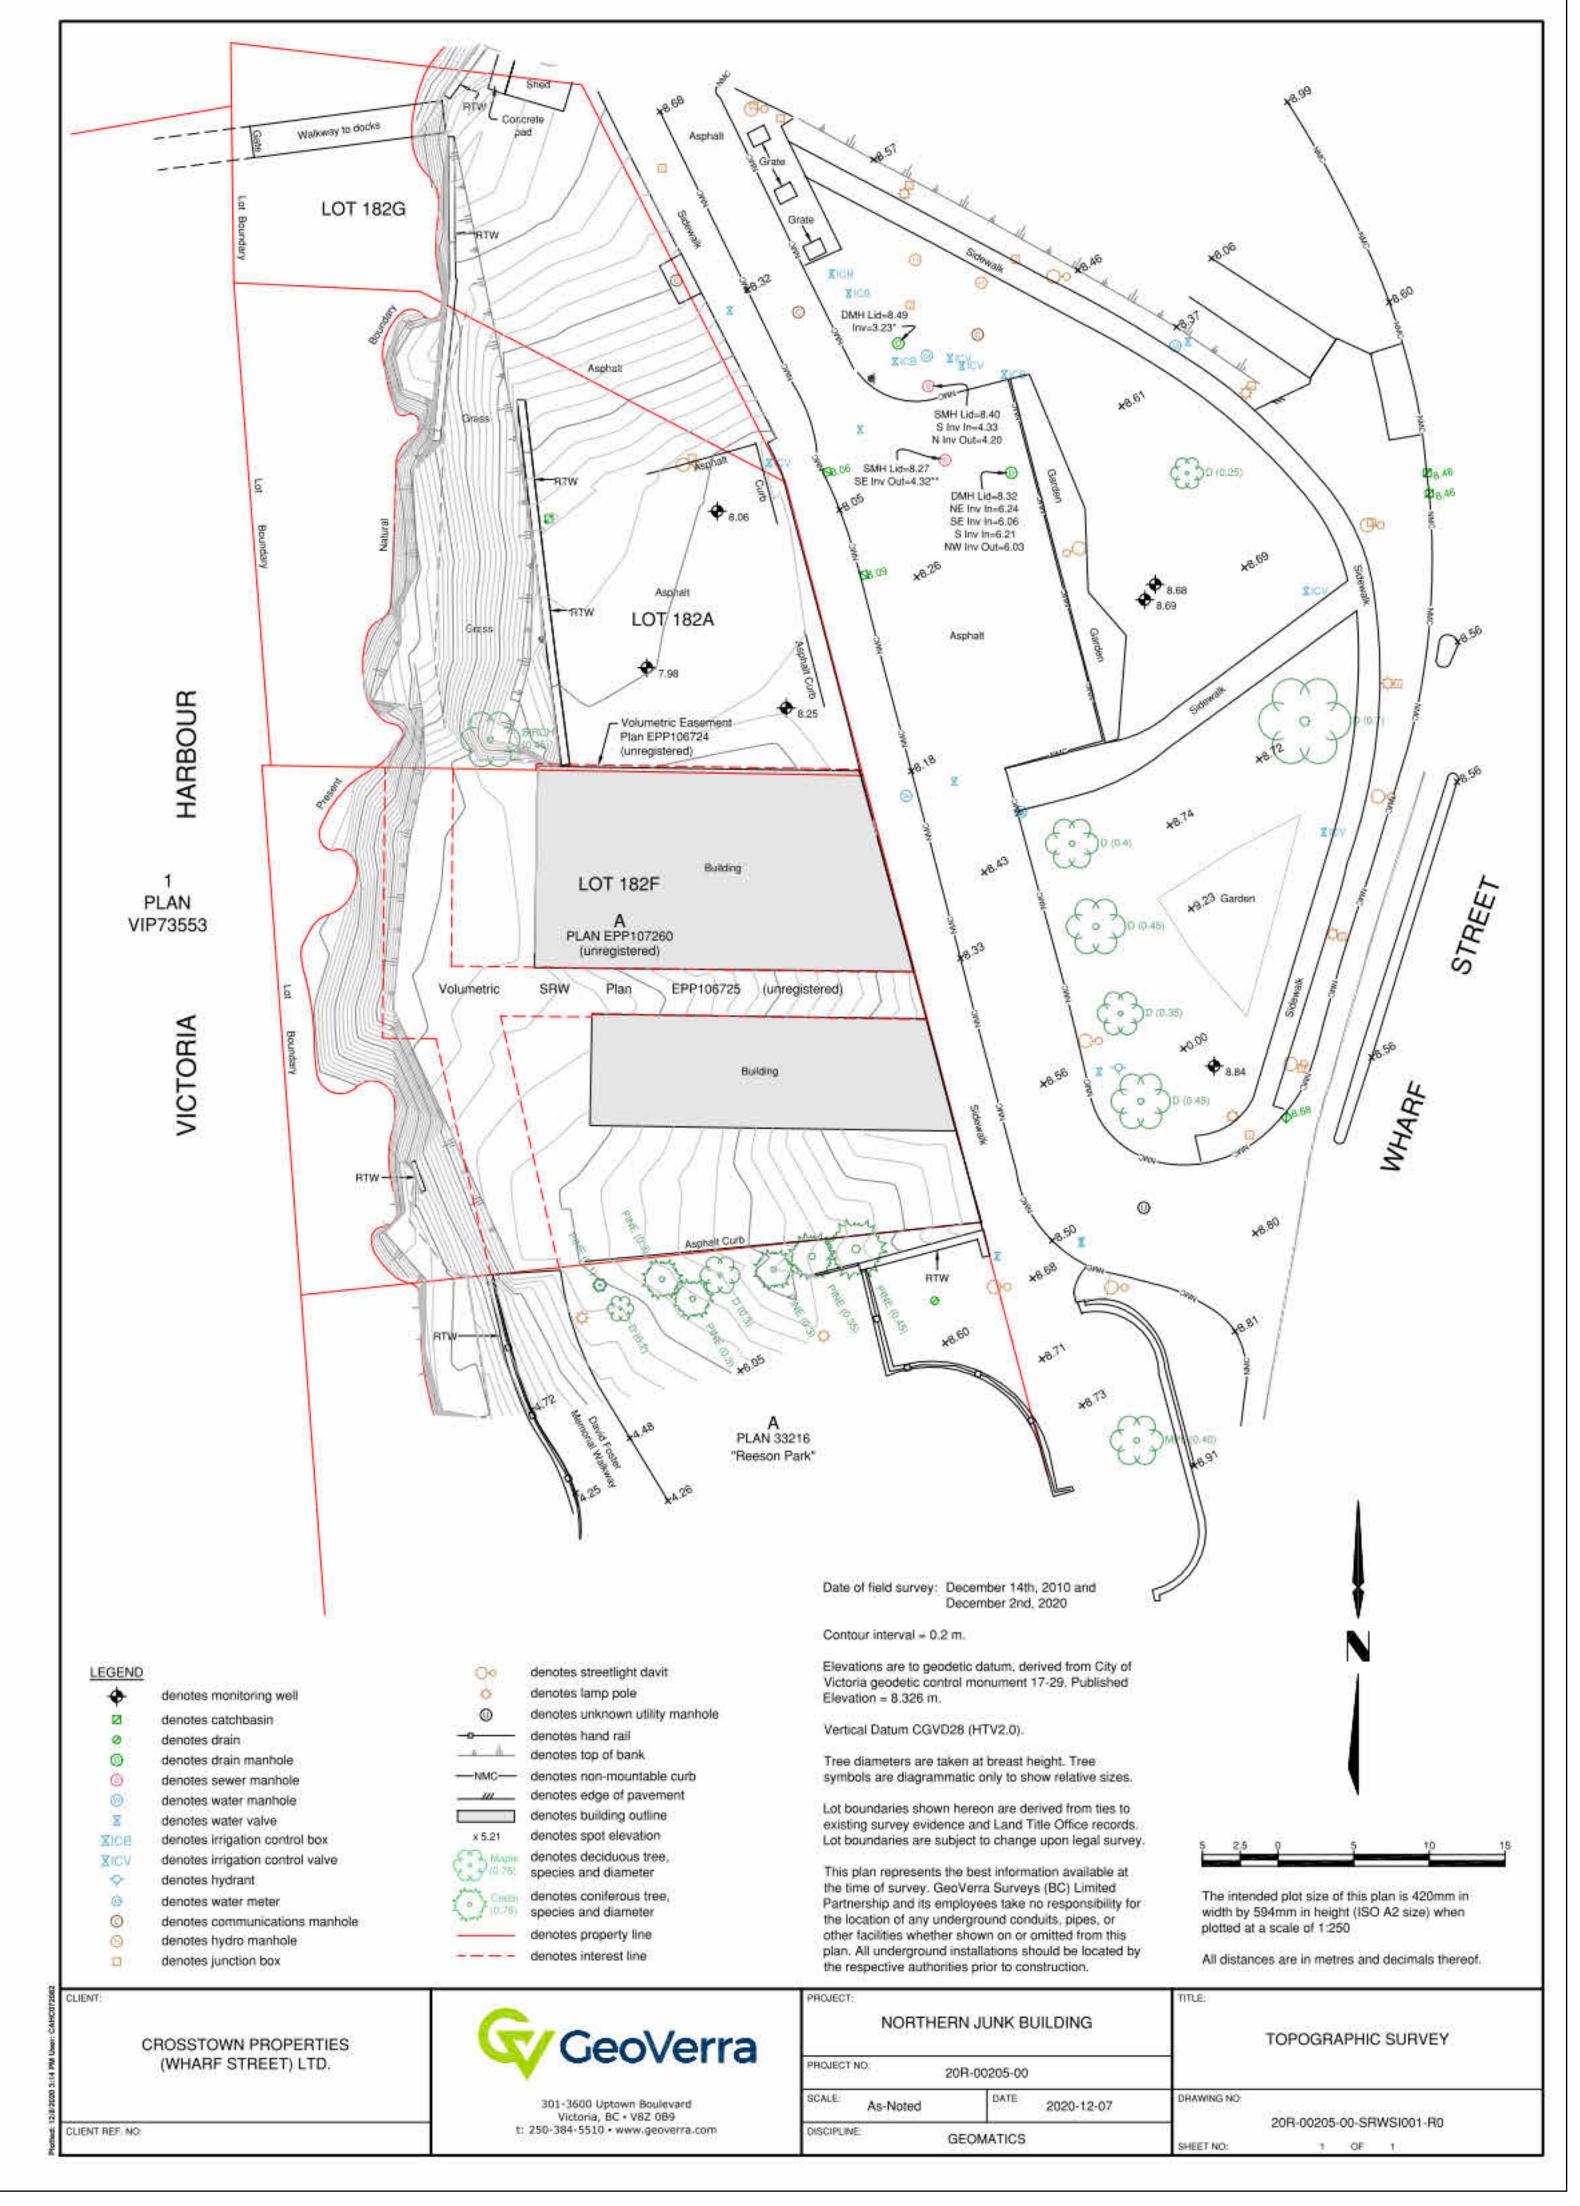

SURVEY INCLUDED FOR REFERENCE

ONLY.NTS\*







### ISSUED FOR

- A 2022-06-24 BUILDING PERMIT APPLICATION B 2022-09-29 BUILDING PERMIT APPLICATION
  - **REVISION 1**
- C 2022-10-14 ISSUED FOR TENDER D 2023-04-09 BUILDING PERMIT APPLICATION **REVISION 3**

### **IMPERIAL**

THIS DRAWING IS COPYRIGHTED AND MUST NOT BE USED, REPRODUCED, OR REVISED WITHOUT WRITTEN PERMISSION.

ALL DIMENSIONS ARE IN FEET AND INCHES UNLESS OTHERWISE VERIFY DIMENSIONS.

DO NOT SCALE THIS DRAWING. REPORT INCONSISTENCIES AND OMISSIONS TO THE CONSULTANT

FOR CLARIFICATION BEFORE COMMENCING WITH THE WORK.

DEVIATIONS FROM THE CONTRACT DOCUMENTS WITHOUT WRITTEN APPROVAL FROM THE CONSULTANT ARE SUBJECT TO CORRECTION AT THE CONTRACTOR'S EXPENSE.

## ARCHITECT

BONIFACE OLEKSIUK POLITANO ARCHITECTS 180-510 NICOLA STREET VANCOUVER BC, V6G 3J7 Tel: 236.521.6568 Email: info@bop.ca

This document has been digitally certified with digital certificate and encryption technology authorized by the Architectural Institute of BC and the Engineers and Geoscientists BC. The authoritative original has been transmitted to you in digital form. Any printed version can be relied upon as a true copy of the original when supplied by the architect, bearing images of the professional seal and digital certificate, or when printed from the digitally-certified electronic file provided by the architect.

SEAL



## NORTHERN JUNK

1314 WHARF STREET


SITE SURVEY

DRAWN: LM PLOT DATE: 2023-04-07 8:01:16 PM

CHECKED: SO/AP

A-101

19004C

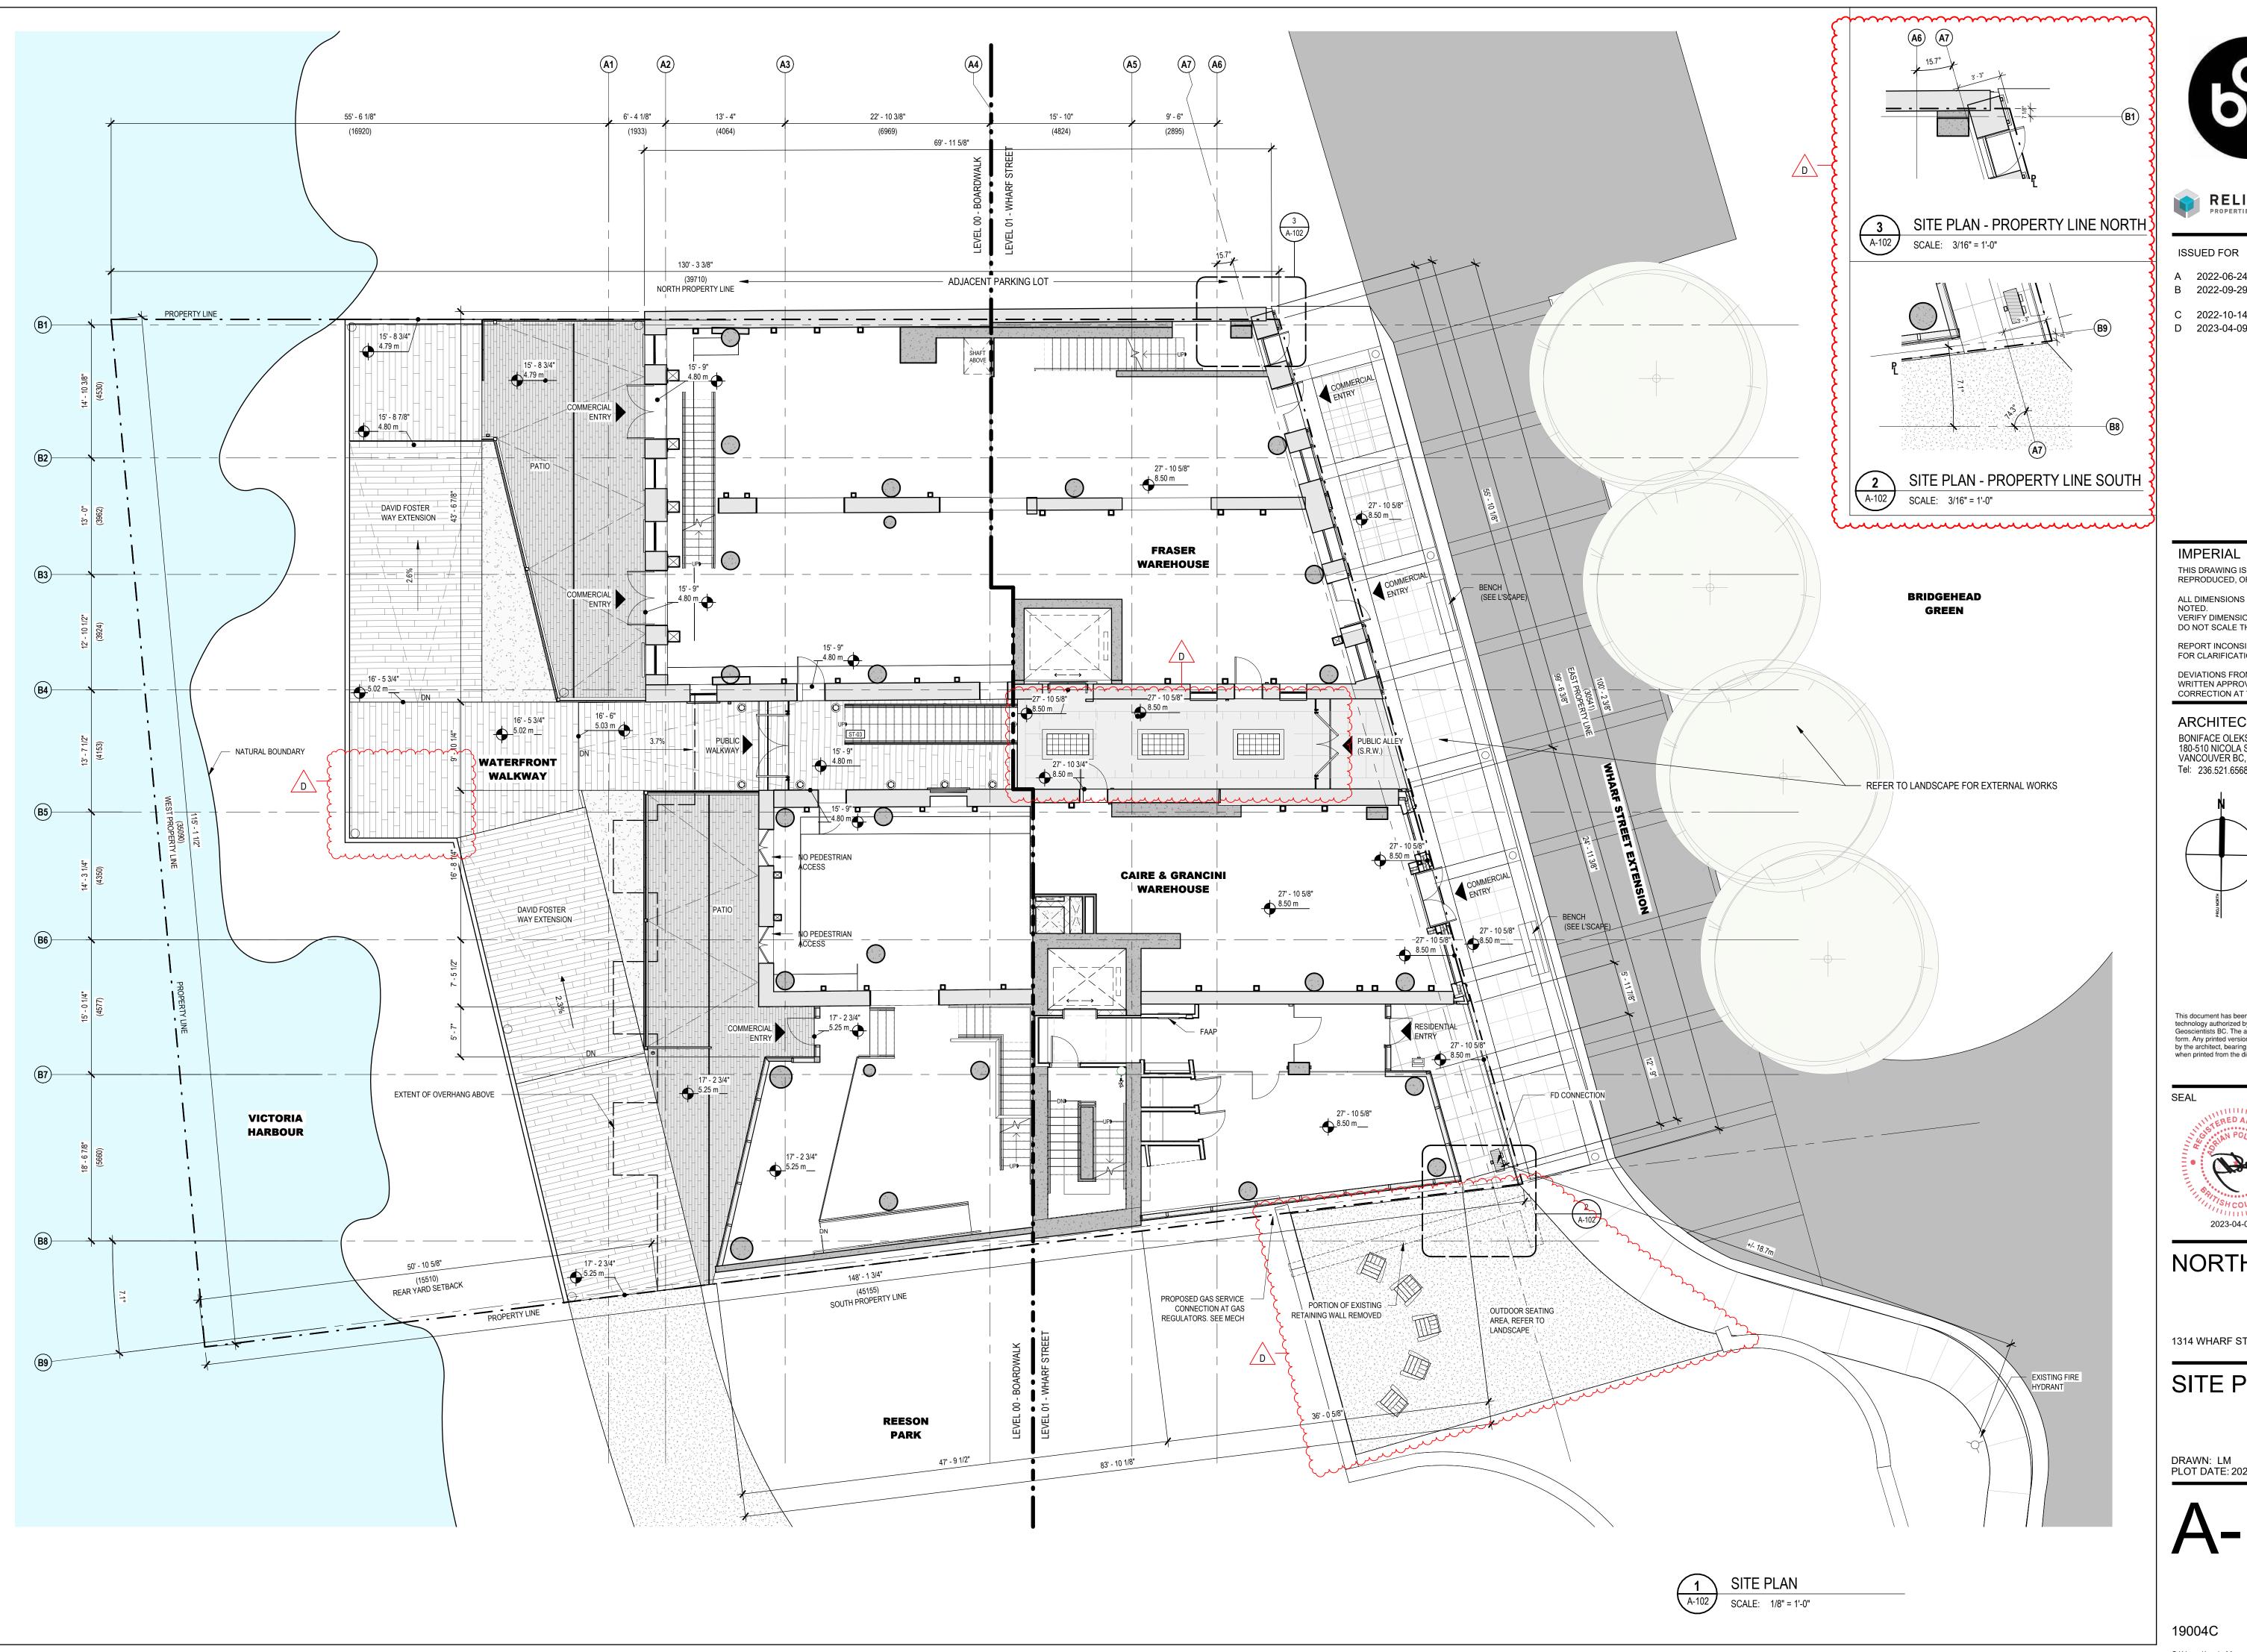





CROSSTOWN PROPERTIES LTD.

### ISSUED FOR

- A 2022-06-24 BUILDING PERMIT APPLICATION
- B 2022-09-29 BUILDING PERMIT APPLICATION **REVISION 1**
- C 2022-10-14 ISSUED FOR TENDER D 2023-04-09 BUILDING PERMIT APPLICATION **REVISION 3**

THIS DRAWING IS COPYRIGHTED AND MUST NOT BE USED, REPRODUCED, OR REVISED WITHOUT WRITTEN PERMISSION.

ALL DIMENSIONS ARE IN FEET AND INCHES UNLESS OTHERWISE VERIFY DIMENSIONS.

DO NOT SCALE THIS DRAWING. REPORT INCONSISTENCIES AND OMISSIONS TO THE CONSULTANT


FOR CLARIFICATION BEFORE COMMENCING WITH THE WORK. DEVIATIONS FROM THE CONTRACT DOCUMENTS WITHOUT

WRITTEN APPROVAL FROM THE CONSULTANT ARE SUBJECT TO CORRECTION AT THE CONTRACTOR'S EXPENSE.

## **ARCHITECT**

BONIFACE OLEKSIUK POLITANO ARCHITECTS 180-510 NICOLA STREET VANCOUVER BC, V6G 3J7

Email: info@bop.ca Tel: 236.521.6568

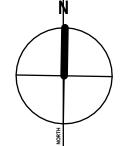

This document has been digitally certified with digital certificate and encryption technology authorized by the Architectural Institute of BC and the Engineers and Geoscientists BC. The authoritative original has been transmitted to you in digital form. Any printed version can be relied upon as a true copy of the original when supplied by the architect, bearing images of the professional seal and digital certificate, or when printed from the digitally-certified electronic file provided by the architect.




## NORTHERN JUNK

1314 WHARF STREET

SITE PLAN

CHECKED: SO/AP PLOT DATE: 2023-04-07 8:01:18 PM

A-102

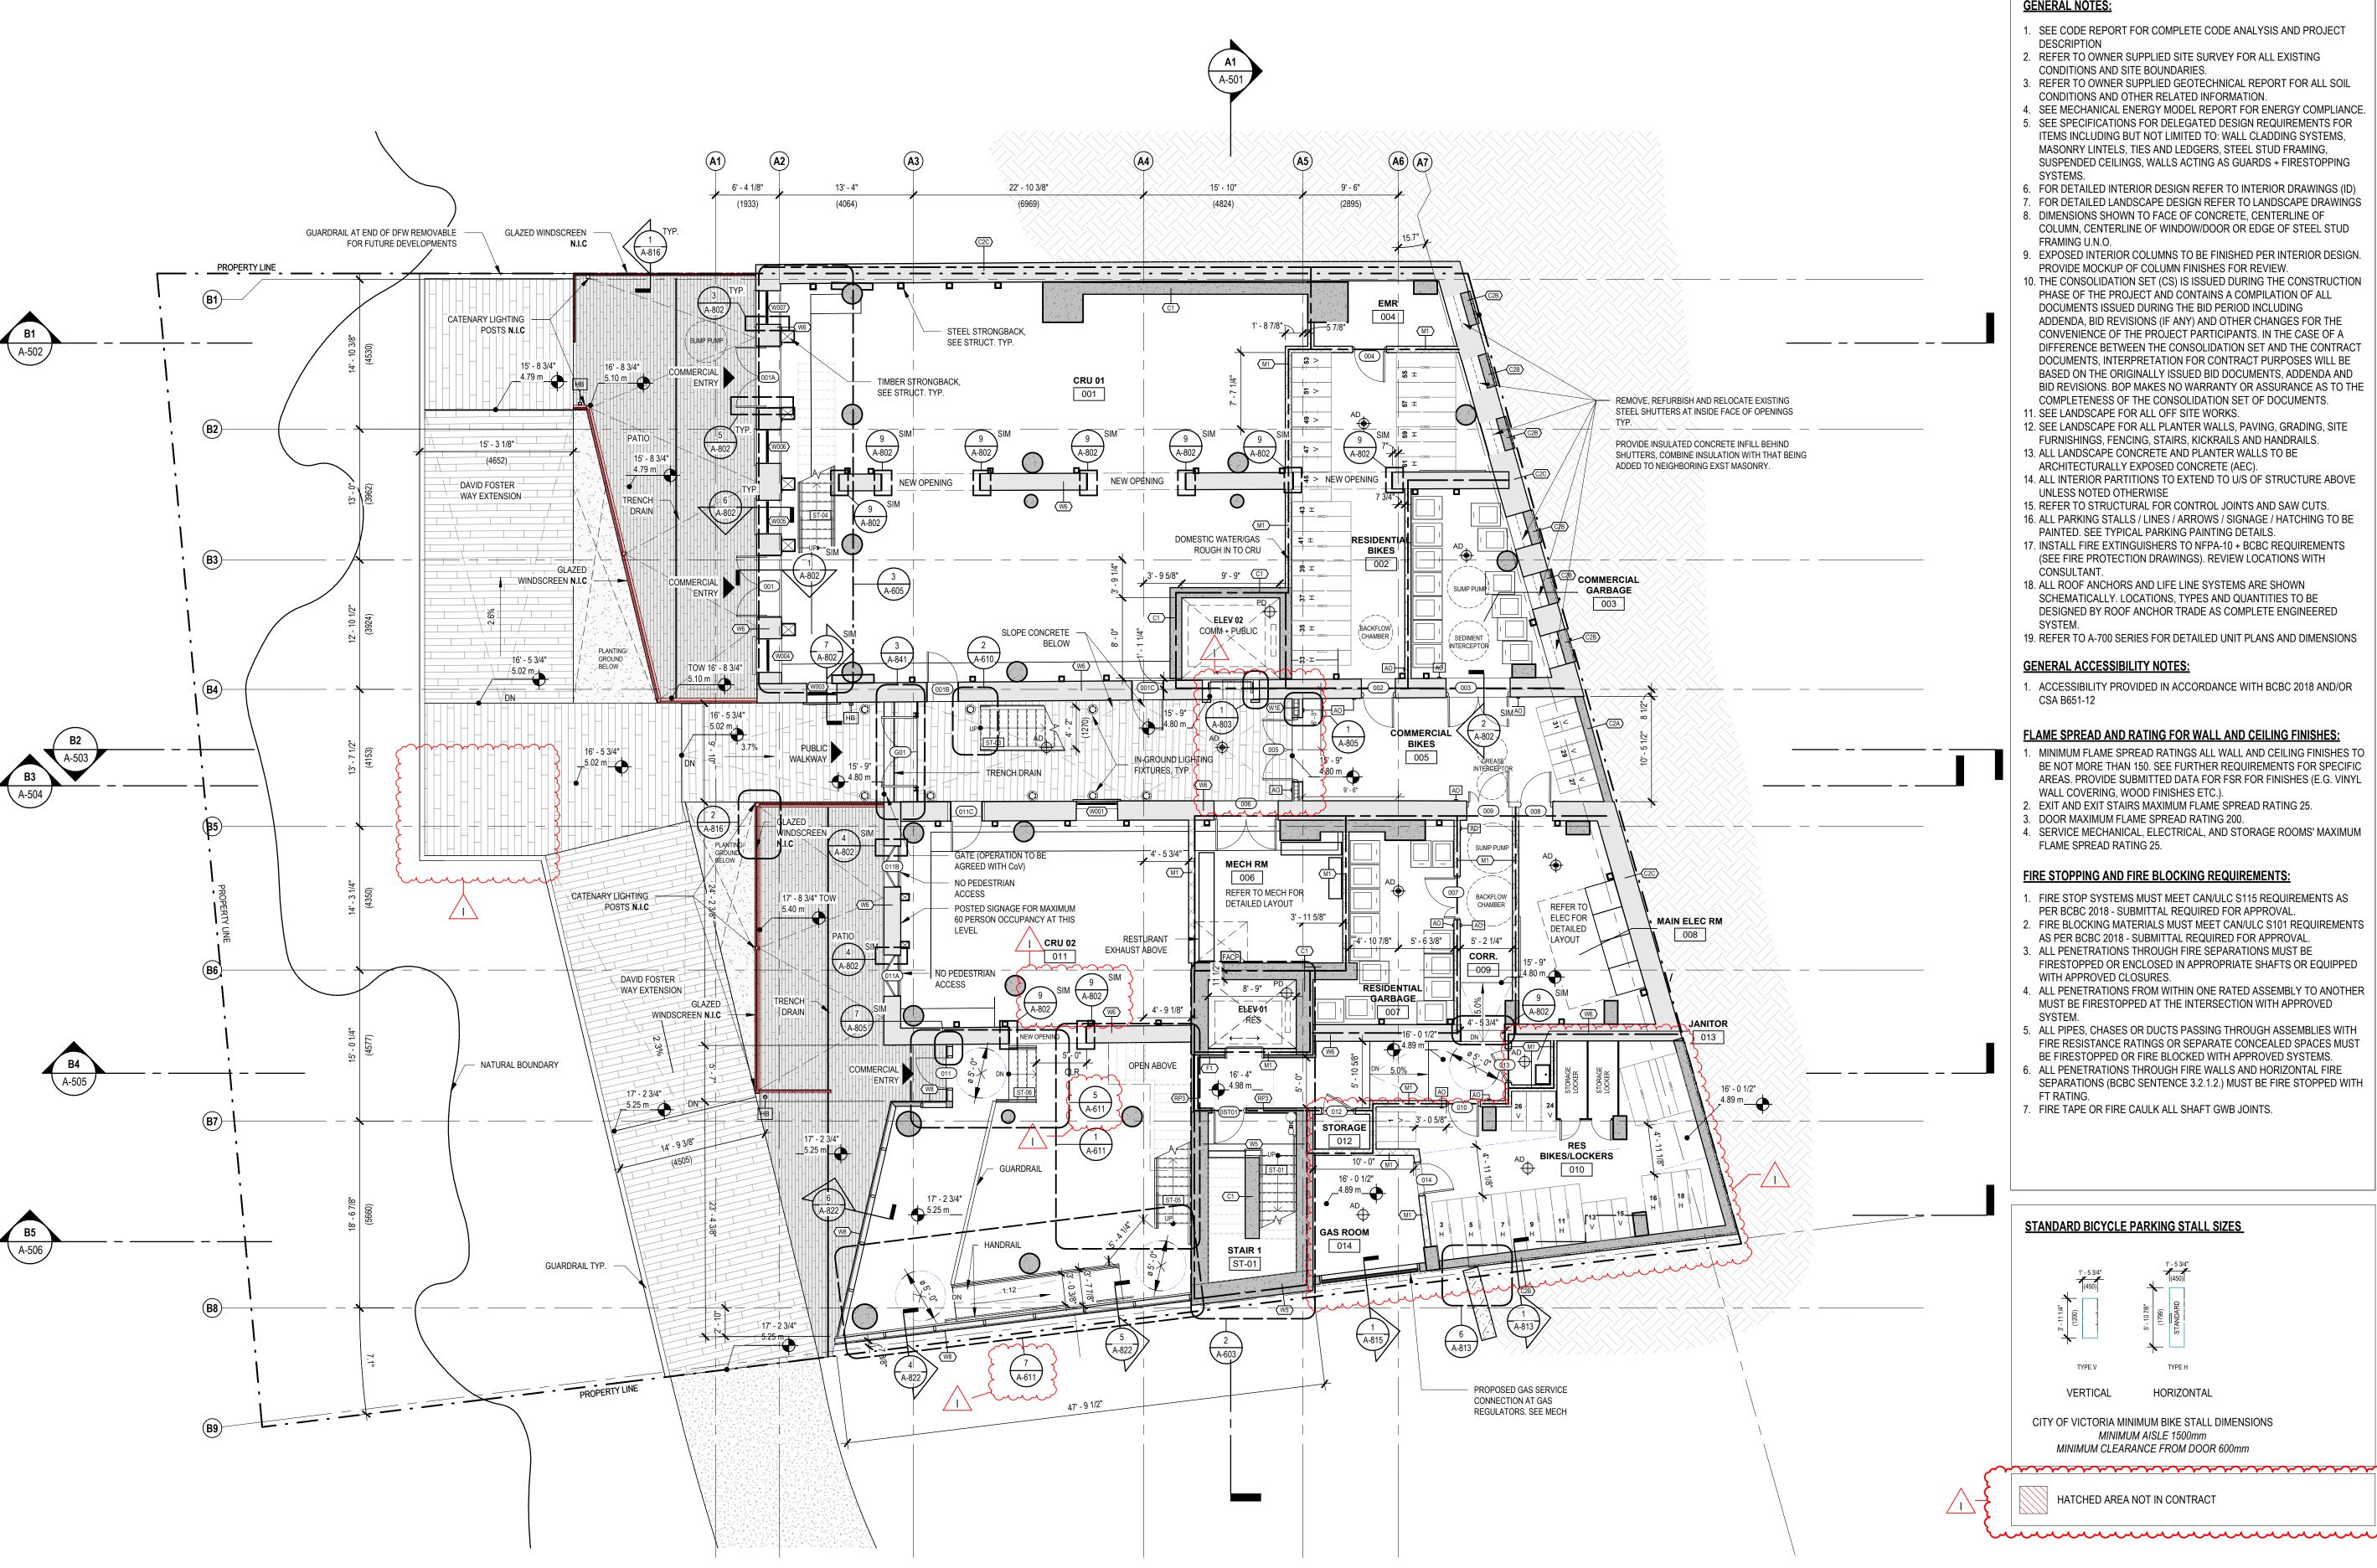

### **GENERAL NOTES:**

- 1. SEE CODE REPORT FOR COMPLETE CODE ANALYSIS AND PROJECT
- 2. REFER TO OWNER SUPPLIED SITE SURVEY FOR ALL EXISTING CONDITIONS AND SITE BOUNDARIES.
- 3. REFER TO OWNER SUPPLIED GEOTECHNICAL REPORT FOR ALL SOIL CONDITIONS AND OTHER RELATED INFORMATION.
- 4. SEE MECHANICAL ENERGY MODEL REPORT FOR ENERGY COMPLIANCE. 5. SEE SPECIFICATIONS FOR DELEGATED DESIGN REQUIREMENTS FOR ITEMS INCLUDING BUT NOT LIMITED TO: WALL CLADDING SYSTEMS, MASONRY LINTELS, TIES AND LEDGERS, STEEL STUD FRAMING, SUSPENDED CEILINGS, WALLS ACTING AS GUARDS + FIRESTOPPING
- FOR DETAILED INTERIOR DESIGN REFER TO INTERIOR DRAWINGS (ID) 7. FOR DETAILED LANDSCAPE DESIGN REFER TO LANDSCAPE DRAWINGS 8. DIMENSIONS SHOWN TO FACE OF CONCRETE, CENTERLINE OF COLUMN, CENTERLINE OF WINDOW/DOOR OR EDGE OF STEEL STUD
- FRAMING U.N.O. 9. EXPOSED INTERIOR COLUMNS TO BE FINISHED PER INTERIOR DESIGN.
- PROVIDE MOCKUP OF COLUMN FINISHES FOR REVIEW. 10. THE CONSOLIDATION SET (CS) IS ISSUED DURING THE CONSTRUCTION PHASE OF THE PROJECT AND CONTAINS A COMPILATION OF ALL
- DOCUMENTS ISSUED DURING THE BID PERIOD INCLUDING ADDENDA, BID REVISIONS (IF ANY) AND OTHER CHANGES FOR THE CONVENIENCE OF THE PROJECT PARTICIPANTS. IN THE CASE OF A DIFFERENCE BETWEEN THE CONSOLIDATION SET AND THE CONTRACT DOCUMENTS, INTERPRETATION FOR CONTRACT PURPOSES WILL BE BASED ON THE ORIGINALLY ISSUED BID DOCUMENTS, ADDENDA AND BID REVISIONS. BOP MAKES NO WARRANTY OR ASSURANCE AS TO THE COMPLETENESS OF THE CONSOLIDATION SET OF DOCUMENTS.
- 11. SEE LANDSCAPE FOR ALL OFF SITE WORKS. 12. SEE LANDSCAPE FOR ALL PLANTER WALLS, PAVING, GRADING, SITE
- FURNISHINGS, FENCING, STAIRS, KICKRAILS AND HANDRAILS. 13. ALL LANDSCAPE CONCRETE AND PLANTER WALLS TO BE
- ARCHITECTURALLY EXPOSED CONCRETE (AEC). 14. ALL INTERIOR PARTITIONS TO EXTEND TO U/S OF STRUCTURE ABOVE
- UNLESS NOTED OTHERWISE 15. REFER TO STRUCTURAL FOR CONTROL JOINTS AND SAW CUTS.
- 16. ALL PARKING STALLS / LINES / ARROWS / SIGNAGE / HATCHING TO BE PAINTED. SEE TYPICAL PARKING PAINTING DETAILS.
- 17. INSTALL FIRE EXTINGUISHERS TO NFPA-10 + BCBC REQUIREMENTS (SEE FIRE PROTECTION DRAWINGS). REVIEW LOCATIONS WITH CONSULTANT.
- 18. ALL ROOF ANCHORS AND LIFE LINE SYSTEMS ARE SHOWN SCHEMATICALLY. LOCATIONS, TYPES AND QUANTITIES TO BE DESIGNED BY ROOF ANCHOR TRADE AS COMPLETE ENGINEERED
- 19. REFER TO A-700 SERIES FOR DETAILED UNIT PLANS AND DIMENSIONS

### **GENERAL ACCESSIBILITY NOTES:**

1. ACCESSIBILITY PROVIDED IN ACCORDANCE WITH BCBC 2018 AND/OR CSA B651-12


### FLAME SPREAD AND RATING FOR WALL AND CEILING FINISHES:

- MINIMUM FLAME SPREAD RATINGS ALL WALL AND CEILING FINISHES TO BE NOT MORE THAN 150. SEE FURTHER REQUIREMENTS FOR SPECIFIC AREAS. PROVIDE SUBMITTED DATA FOR FSR FOR FINISHES (E.G. VINYL
- WALL COVERING, WOOD FINISHES ETC.). 2. EXIT AND EXIT STAIRS MAXIMUM FLAME SPREAD RATING 25.
- 3. DOOR MAXIMUM FLAME SPREAD RATING 200. 4. SERVICE MECHANICAL, ELECTRICAL, AND STORAGE ROOMS' MAXIMUM
- FLAME SPREAD RATING 25.

## FIRE STOPPING AND FIRE BLOCKING REQUIREMENTS

- 1. FIRE STOP SYSTEMS MUST MEET CAN/ULC S115 REQUIREMENTS AS
- PER BCBC 2018 SUBMITTAL REQUIRED FOR APPROVAL. 2. FIRE BLOCKING MATERIALS MUST MEET CAN/ULC S101 REQUIREMENTS AS PER BCBC 2018 - SUBMITTAL REQUIRED FOR APPROVAL.
- FIRESTOPPED OR ENCLOSED IN APPROPRIATE SHAFTS OR EQUIPPED WITH APPROVED CLOSURES. 4. ALL PENETRATIONS FROM WITHIN ONE RATED ASSEMBLY TO ANOTHER
- MUST BE FIRESTOPPED AT THE INTERSECTION WITH APPROVED
- ALL PIPES, CHASES OR DUCTS PASSING THROUGH ASSEMBLIES WITH FIRE RESISTANCE RATINGS OR SEPARATE CONCEALED SPACES MUST BE FIRESTOPPED OR FIRE BLOCKED WITH APPROVED SYSTEMS.
- ALL PENETRATIONS THROUGH FIRE WALLS AND HORIZONTAL FIRE SEPARATIONS (BCBC SENTENCE 3.2.1.2.) MUST BE FIRE STOPPED WITH
- 7. FIRE TAPE OR FIRE CAULK ALL SHAFT GWB JOINTS.

## STANDARD BICYCLE PARKING STALL SIZES

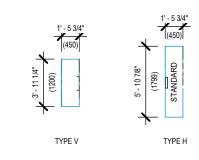

CITY OF VICTORIA MINIMUM BIKE STALL DIMENSIONS MINIMUM AISLE 1500mm MINIMUM CLEARANCE FROM DOOR 600mm

HORIZONTAL

HATCHED AREA NOT IN CONTRACT





Boniface Oleksiuk Politano Architects

A 2022-06-24 BUILDING PERMIT APPLICATION

B 2022-09-29 BUILDING PERMIT APPLICATION **REVISION 1** 

C 2022-10-14 ISSUED FOR TENDER

D 2022-11-10 IFT ADDENDUM 2

E 2022-11-17 IFT ADDENDUM 3

F 2022-12-01 BUILDING PERMIT APPLICATION

**REVISION 2** 

G 2023-02-21 POST-TENDER ADDENDUM

H 2023-03-27 POST-TENDER ADDENDUM 02

2023-04-09 BUILDING PERMIT APPLICATION **REVISION 3** 

THIS DRAWING IS COPYRIGHTED AND MUST NOT BE USED, REPRODUCED, OR REVISED WITHOUT WRITTEN PERMISSION.

ALL DIMENSIONS ARE IN FEET AND INCHES UNLESS OTHERWISE


**VERIFY DIMENSIONS** DO NOT SCALE THIS DRAWING.

REPORT INCONSISTENCIES AND OMISSIONS TO THE CONSULTANT FOR CLARIFICATION BEFORE COMMENCING WITH THE WORK.

DEVIATIONS FROM THE CONTRACT DOCUMENTS WITHOUT WRITTEN APPROVAL FROM THE CONSULTANT ARE SUBJECT TO CORRECTION AT THE CONTRACTOR'S EXPENSE.

## ARCHITECT

BONIFACE OLEKSIUK POLITANO ARCHITECTS 180-510 NICOLA STREET VANCOUVER BC, V6G 3J7 Tel: 236.521.6568 Email: info@bop.ca

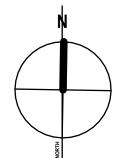

This document has been digitally certified with digital certificate and encryption technology authorized by the Architectural Institute of BC and the Engineers and eoscientists BC. The authoritative original has been transmitted to you in digital form. Any printed version can be relied upon as a true copy of the original when supplied by the architect, bearing images of the professional seal and digital certificate, or when printed from the digitally-certified electronic file provided by the architect.

SEAL




## NORTHERN JUNK

1314 WHARF STREET

PLAN - LEVEL 0

CHECKED: SO/AP PLOT DATE: 2023-04-07 8:01:21 PM

19004C

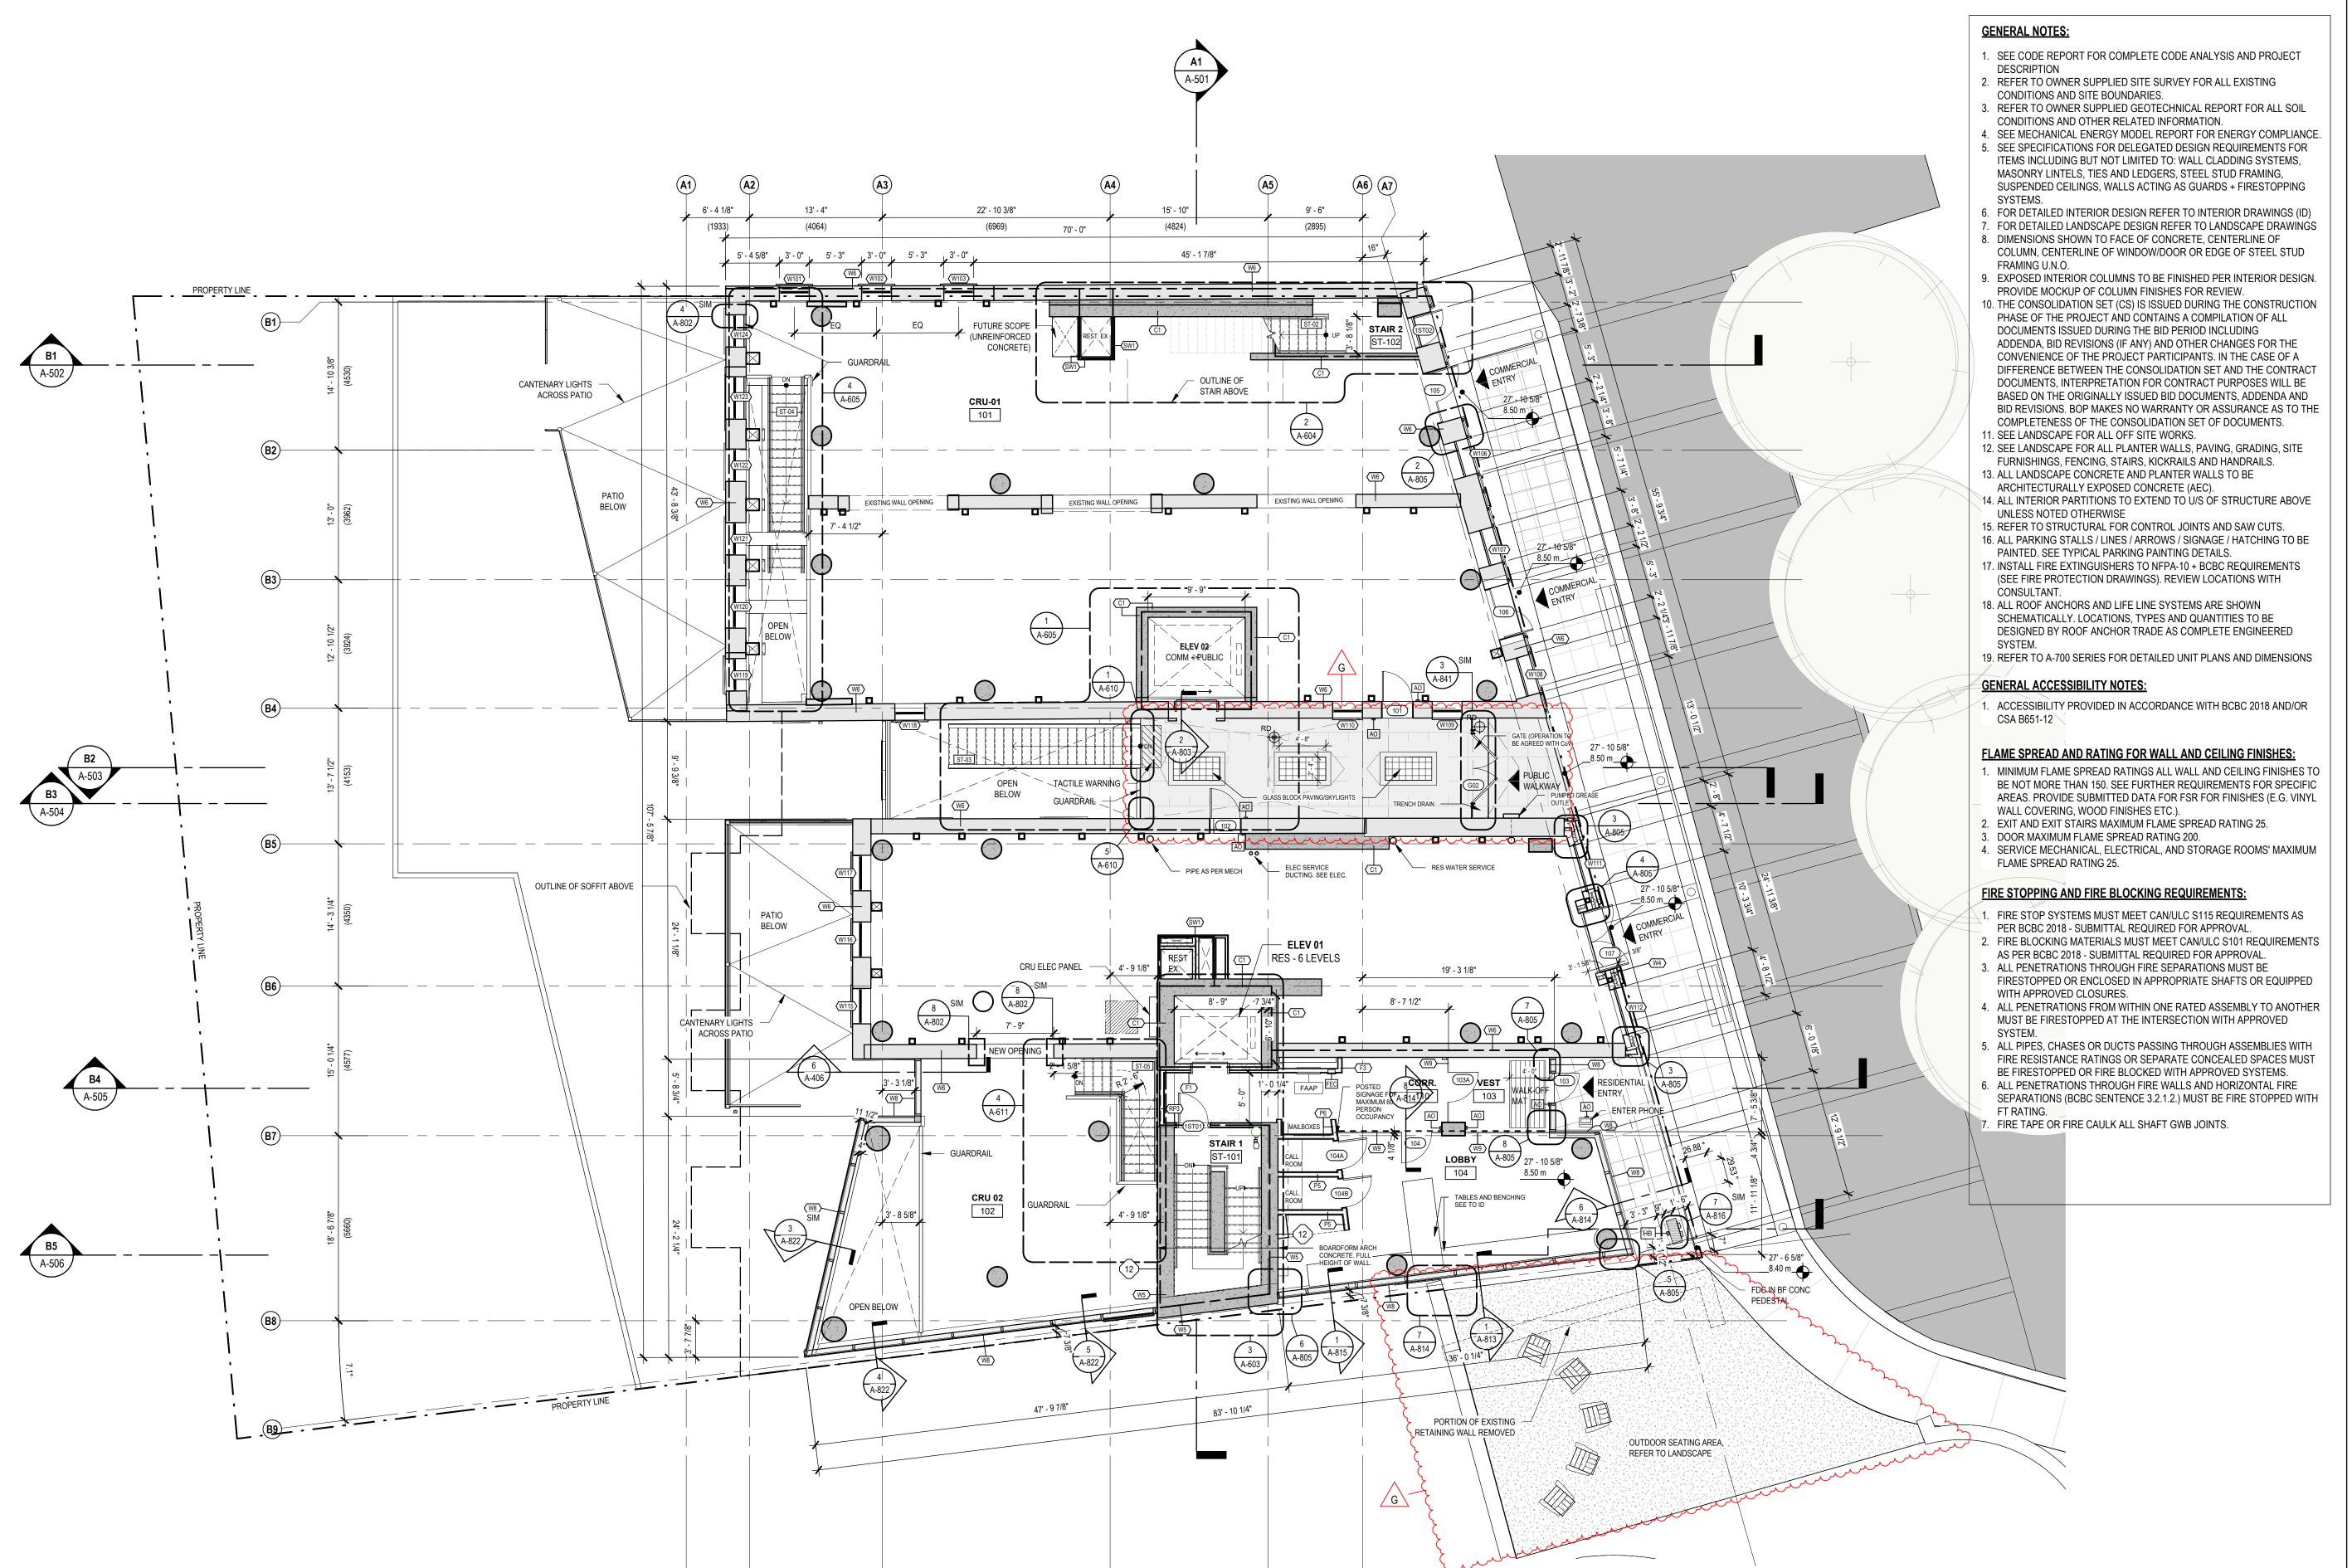







## RELIANCE

PROPERTIES LTD.

A 2022-06-24 BUILDING PERMIT APPLICATION B 2022-09-29 BUILDING PERMIT APPLICATION

**REVISION 1** 

C 2022-10-14 ISSUED FOR TENDER

D 2022-11-10 IFT ADDENDUM 2

E 2023-02-21 POST-TENDER ADDENDUM

F 2023-03-27 POST-TENDER ADDENDUM 02

G 2023-04-09 BUILDING PERMIT APPLICATION

**REVISION 3** 

THIS DRAWING IS COPYRIGHTED AND MUST NOT BE USED, REPRODUCED, OR REVISED WITHOUT WRITTEN PERMISSION.

ALL DIMENSIONS ARE IN FEET AND INCHES UNLESS OTHERWISE

VERIFY DIMENSIONS. DO NOT SCALE THIS DRAWING.


REPORT INCONSISTENCIES AND OMISSIONS TO THE CONSULTANT FOR CLARIFICATION BEFORE COMMENCING WITH THE WORK.

DEVIATIONS FROM THE CONTRACT DOCUMENTS WITHOUT WRITTEN APPROVAL FROM THE CONSULTANT ARE SUBJECT TO CORRECTION AT THE CONTRACTOR'S EXPENSE.

### ARCHITECT

BONIFACE OLEKSIUK POLITANO ARCHITECTS 180-510 NICOLA STREET VANCOUVER BC, V6G 3J7

Tel: 236.521.6568 Email: info@bop.ca

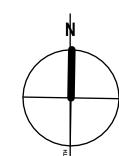

This document has been digitally certified with digital certificate and encryption technology authorized by the Architectural Institute of BC and the Engineers and Geoscientists BC. The authoritative original has been transmitted to you in digital form. Any printed version can be relied upon as a true copy of the original when supplied by the architect, bearing images of the professional seal and digital certificate, or when printed from the digitally-certified electronic file provided by the architect.

SEAL



## NORTHERN JUNK

1314 WHARF STREET


PLAN - LEVEL 1

PLOT DATE: 2023-04-07 8:01:22 PM

CHECKED: SO/AP

A-202

19004C

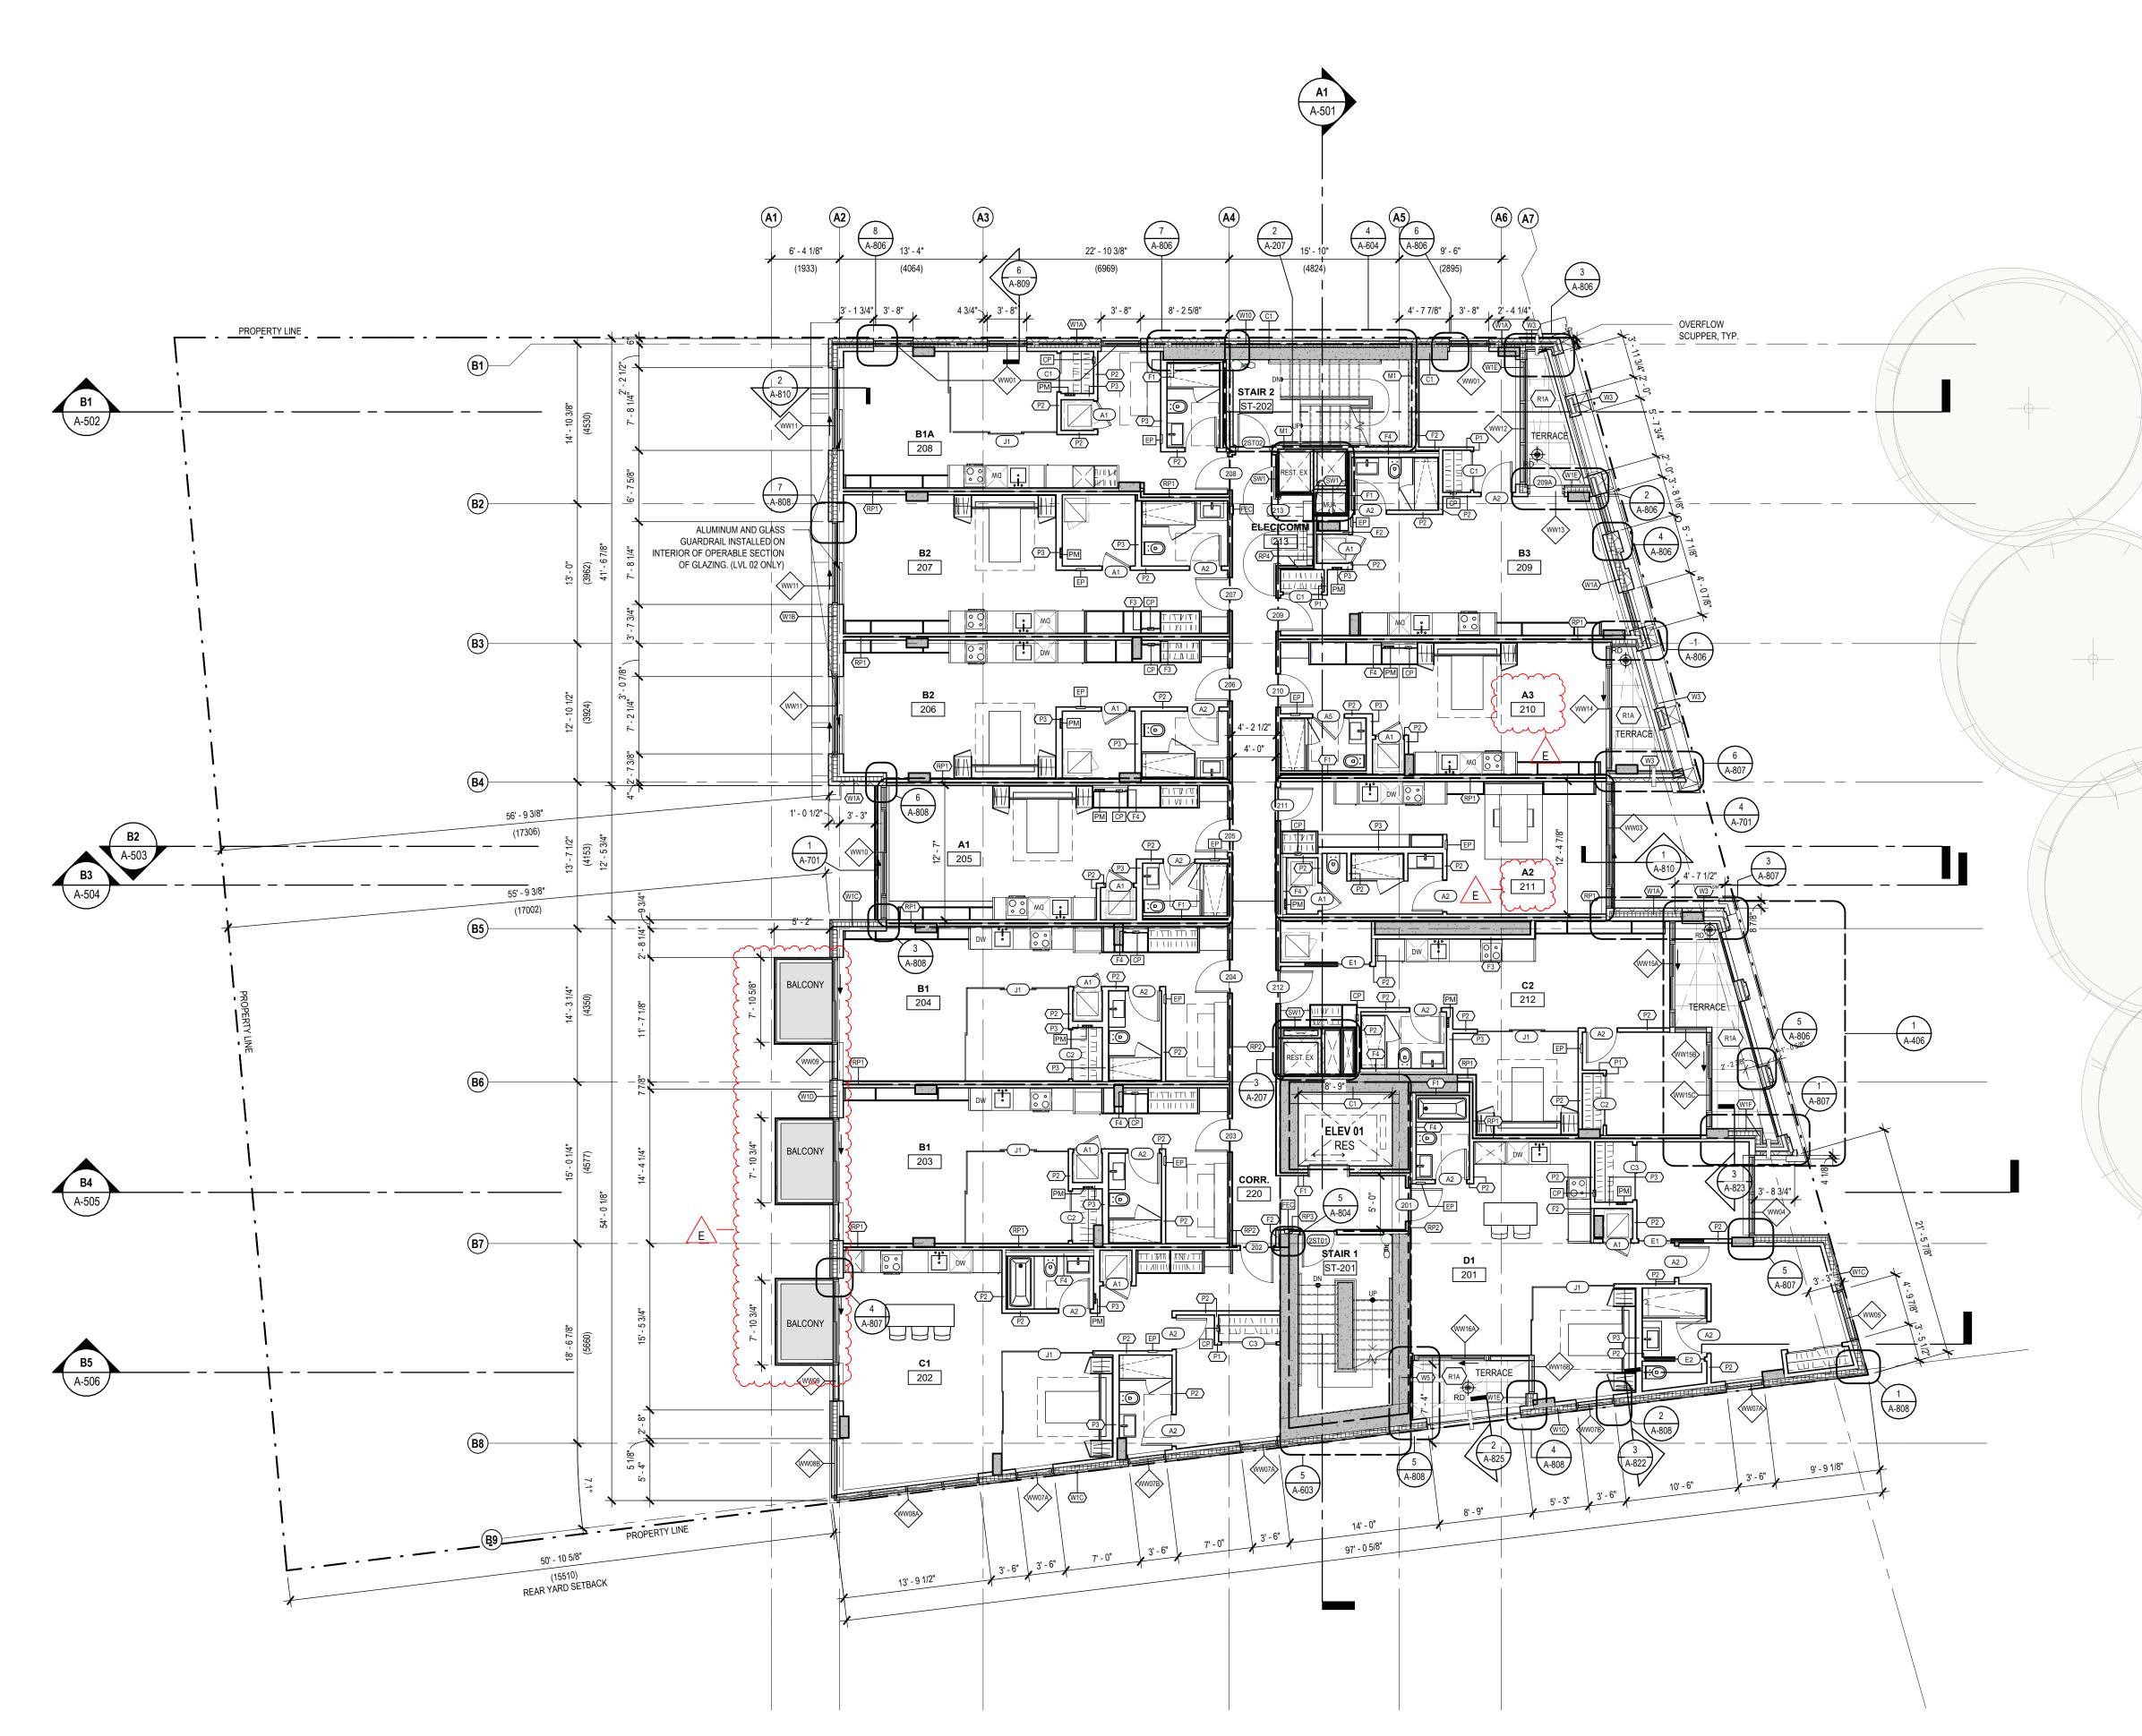



- SEE CODE REPORT FOR COMPLETE CODE ANALYSIS AND PROJECT DESCRIPTION
- 2. REFER TO OWNER SUPPLIED SITE SURVEY FOR ALL EXISTING
- CONDITIONS AND SITE BOUNDARIES.
- REFER TO OWNER SUPPLIED GEOTECHNICAL REPORT FOR ALL SOIL CONDITIONS AND OTHER RELATED INFORMATION.
   SEE MECHANICAL ENERGY MODEL REPORT FOR ENERGY COMPLIANCE.
- 5. SEE SPECIFICATIONS FOR DELEGATED DESIGN REQUIREMENTS FOR ITEMS INCLUDING BUT NOT LIMITED TO: WALL CLADDING SYSTEMS, MASONRY LINTELS, TIES AND LEDGERS, STEEL STUD FRAMING, SUSPENDED CEILINGS, WALLS ACTING AS GUARDS + FIRESTOPPING SYSTEMS
- FOR DETAILED INTERIOR DESIGN REFER TO INTERIOR DRAWINGS (ID)
   FOR DETAILED LANDSCAPE DESIGN REFER TO LANDSCAPE DRAWINGS
   DIMENSIONS SHOWN TO FACE OF CONCRETE, CENTERLINE OF COLUMN, CENTERLINE OF WINDOW/DOOR OR EDGE OF STEEL STUD
- FRAMING U.N.O.

  9. EXPOSED INTERIOR COLUMNS TO BE FINISHED PER INTERIOR DESIGN.

  PROVIDE MOCKLIP OF COLUMN FINISHES FOR REVIEW.
- PROVIDE MOCKUP OF COLUMN FINISHES FOR REVIEW.

  10. THE CONSOLIDATION SET (CS) IS ISSUED DURING THE CONSTRUCTION PHASE OF THE PROJECT AND CONTAINS A COMPILATION OF ALL
- DOCUMENTS ISSUED DURING THE BID PERIOD INCLUDING ADDENDA, BID REVISIONS (IF ANY) AND OTHER CHANGES FOR THE CONVENIENCE OF THE PROJECT PARTICIPANTS. IN THE CASE OF A DIFFERENCE BETWEEN THE CONSOLIDATION SET AND THE CONTRACT DOCUMENTS, INTERPRETATION FOR CONTRACT PURPOSES WILL BE BASED ON THE ORIGINALLY ISSUED BID DOCUMENTS, ADDENDA AND BID REVISIONS. BOP MAKES NO WARRANTY OR ASSURANCE AS TO THE COMPLETENESS OF THE CONSOLIDATION SET OF DOCUMENTS.
- 11. SEE LANDSCAPE FOR ALL OFF SITE WORKS.12. SEE LANDSCAPE FOR ALL PLANTER WALLS, PAVING, GRADING, SITE
- FURNISHINGS, FENCING, STAIRS, KICKRAILS AND HANDRAILS.

  13. ALL LANDSCAPE CONCRETE AND PLANTER WALLS TO BE
  ARCHITECTURALLY EXPOSED CONCRETE (AEC).
- 14. ALL INTERIOR PARTITIONS TO EXTEND TO U/S OF STRUCTURE ABOVE UNLESS NOTED OTHERWISE
- 15. REFER TO STRUCTURAL FOR CONTROL JOINTS AND SAW CUTS.
  16. ALL PARKING STALLS / LINES / ARROWS / SIGNAGE / HATCHING TO BE
- PAINTED. SEE TYPICAL PARKING PAINTING DETAILS.

  17. INSTALL FIRE EXTINGUISHERS TO NFPA-10 + BCBC REQUIREMENTS
  (SEE FIRE PROTECTION DRAWINGS). REVIEW LOCATIONS WITH
- CONSULTANT.

  18. ALL ROOF ANCHORS AND LIFE LINE SYSTEMS ARE SHOWN
  SCHEMATICALLY. LOCATIONS, TYPES AND QUANTITIES TO BE
  DESIGNED BY ROOF ANCHOR TRADE AS COMPLETE ENGINEERED
- 19. REFER TO A-700 SERIES FOR DETAILED UNIT PLANS AND DIMENSIONS

### **GENERAL ACCESSIBILITY NOTES:**

1. ACCESSIBILITY PROVIDED IN ACCORDANCE WITH BCBC 2018 AND/OR CSA B651-12

### FLAME SPREAD AND RATING FOR WALL AND CEILING FINISHES:

- 1. MINIMUM FLAME SPREAD RATINGS ALL WALL AND CEILING FINISHES TO BE NOT MORE THAN 150. SEE FURTHER REQUIREMENTS FOR SPECIFIC AREAS. PROVIDE SUBMITTED DATA FOR FSR FOR FINISHES (E.G. VINYL WALL COVERING, WOOD FINISHES ETC.).
- EXIT AND EXIT STAIRS MAXIMUM FLAME SPREAD RATING 25.
   DOOR MAXIMUM FLAME SPREAD RATING 200.
- 4. SERVICE MECHANICAL, ELECTRICAL, AND STORAGE ROOMS' MAXIMUM FLAME SPREAD RATING 25.

## FIRE STOPPING AND FIRE BLOCKING REQUIREMENTS:

- FIRE STOP SYSTEMS MUST MEET CAN/ULC S115 REQUIREMENTS AS PER BCBC 2018 - SUBMITTAL REQUIRED FOR APPROVAL.
   FIRE BLOCKING MATERIALS MUST MEET CAN/ULC S101 REQUIREMENTS
- AS PER BCBC 2018 SUBMITTAL REQUIRED FOR APPROVAL.

  3. ALL PENETRATIONS THROUGH FIRE SEPARATIONS MUST BE FIRESTOPPED OR ENCLOSED IN APPROPRIATE SHAFTS OR EQUIPPED WITH APPROVED CLOSURES.
- 4. ALL PENETRATIONS FROM WITHIN ONE RATED ASSEMBLY TO ANOTHER MUST BE FIRESTOPPED AT THE INTERSECTION WITH APPROVED
- 5. ALL PIPES, CHASES OR DUCTS PASSING THROUGH ASSEMBLIES WITH FIRE RESISTANCE RATINGS OR SEPARATE CONCEALED SPACES MUST BE FIRESTOPPED OR FIRE BLOCKED WITH APPROVED SYSTEMS
- BE FIRESTOPPED OR FIRE BLOCKED WITH APPROVED SYSTEMS.

  6. ALL PENETRATIONS THROUGH FIRE WALLS AND HORIZONTAL FIRE SEPARATIONS (BCBC SENTENCE 3.2.1.2.) MUST BE FIRE STOPPED WITH
- 7. FIRE TAPE OR FIRE CAULK ALL SHAFT GWB JOINTS.

SCALE: 1/8" = 1'-0"





Oleksiuk Politano Architects

PROPERTIES LTD.

ISSUED FOR

- A 2022-06-24 BUILDING PERMIT APPLICATION
- B 2022-09-29 BUILDING PERMIT APPLICATION REVISION 1
- C 2022-10-14 ISSUED FOR TENDER
- D 2023-03-27 POST-TENDER ADDENDUM 02
- E 2023-04-09 BUILDING PERMIT APPLICATION
  - 3-04-09 BUILDING PERMIT APPLICATION REVISION 3

### IMPERIAL

THIS DRAWING IS COPYRIGHTED AND MUST NOT BE USED, REPRODUCED, OR REVISED WITHOUT WRITTEN PERMISSION.

ALL DIMENSIONS ARE IN FEET AND INCHES UNLESS OTHERWISE NOTED. VERIFY DIMENSIONS.


DO NOT SCALE THIS DRAWING.

REPORT INCONSISTENCIES AND OMISSIONS TO THE CONSULTANT FOR CLARIFICATION BEFORE COMMENCING WITH THE WORK.

DEVIATIONS FROM THE CONTRACT DOCUMENTS WITHOUT WRITTEN APPROVAL FROM THE CONSULTANT ARE SUBJECT TO CORRECTION AT THE CONTRACTOR'S EXPENSE.

## ARCHITECT BONIFACE OLEKSIUM

BONIFACE OLEKSIUK POLITANO ARCHITECTS 180-510 NICOLA STREET VANCOUVER BC, V6G 3J7
Tel: 236.521.6568 Email: info@bop.ca

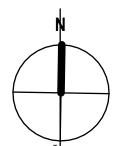

This document has been digitally certified with digital certificate and encryption technology authorized by the Architectural Institute of BC and the Engineers and Geoscientists BC. The authoritative original has been transmitted to you in digital form. Any printed version can be relied upon as a true copy of the original when supplied by the architect, bearing images of the professional seal and digital certificate, or when printed from the digitally-certified electronic file provided by the architect.

SEAL



## NORTHERN JUNK

1314 WHARF STREET

PLAN - LEVEL 2


DRAWN: LM PLOT DATE: 2023-04-07 8:01:26 PM

A-203

19004C

C:\Users\Louis Moore\Documents\Northern Junk Model\_louis84FE8.rvt

CHECKED: SO/AP

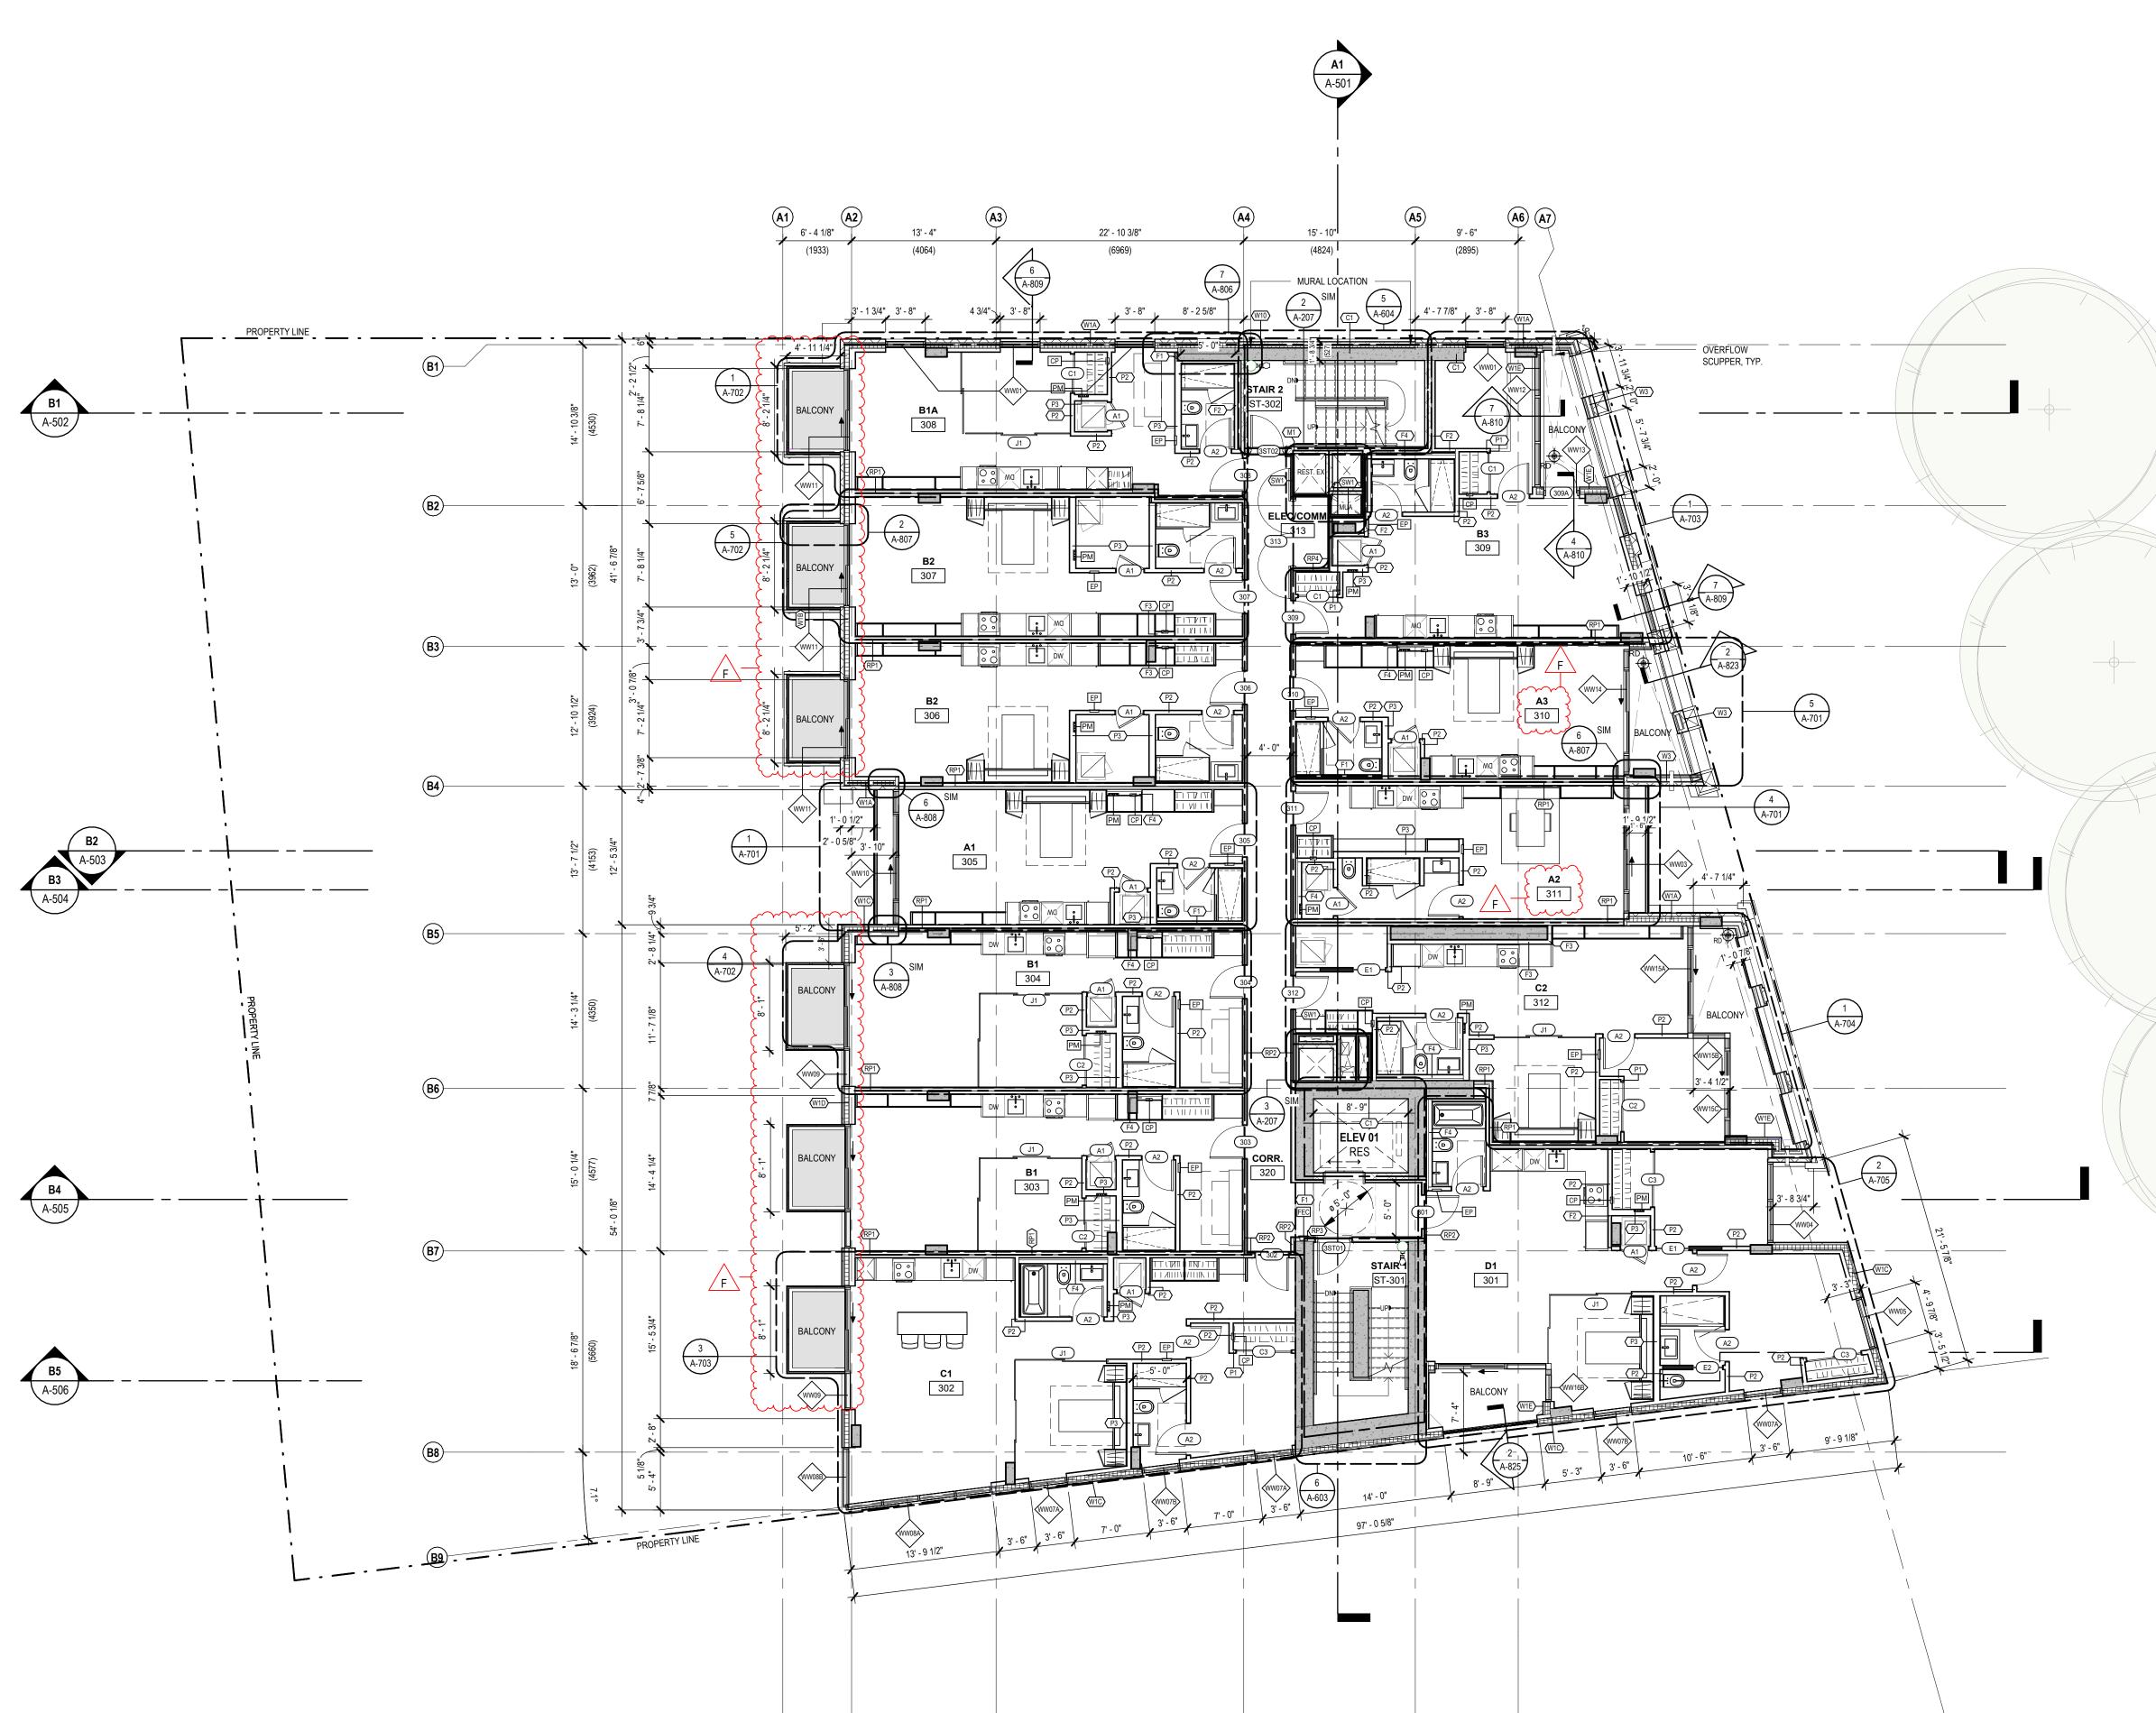



- 1. SEE CODE REPORT FOR COMPLETE CODE ANALYSIS AND PROJECT DESCRIPTION
- 2. REFER TO OWNER SUPPLIED SITE SURVEY FOR ALL EXISTING
- CONDITIONS AND SITE BOUNDARIES. 3. REFER TO OWNER SUPPLIED GEOTECHNICAL REPORT FOR ALL SOIL
- CONDITIONS AND OTHER RELATED INFORMATION. 4. SEE MECHANICAL ENERGY MODEL REPORT FOR ENERGY COMPLIANCE. 5. SEE SPECIFICATIONS FOR DELEGATED DESIGN REQUIREMENTS FOR
- ITEMS INCLUDING BUT NOT LIMITED TO: WALL CLADDING SYSTEMS, MASONRY LINTELS, TIES AND LEDGERS, STEEL STUD FRAMING, SUSPENDED CEILINGS, WALLS ACTING AS GUARDS + FIRESTOPPING
- 6. FOR DETAILED INTERIOR DESIGN REFER TO INTERIOR DRAWINGS (ID) 7. FOR DETAILED LANDSCAPE DESIGN REFER TO LANDSCAPE DRAWINGS 8. DIMENSIONS SHOWN TO FACE OF CONCRETE, CENTERLINE OF COLUMN, CENTERLINE OF WINDOW/DOOR OR EDGE OF STEEL STUD FRAMING U.N.O.
- 9. EXPOSED INTERIOR COLUMNS TO BE FINISHED PER INTERIOR DESIGN. PROVIDE MOCKUP OF COLUMN FINISHES FOR REVIEW.
- 10. THE CONSOLIDATION SET (CS) IS ISSUED DURING THE CONSTRUCTION PHASE OF THE PROJECT AND CONTAINS A COMPILATION OF ALL DOCUMENTS ISSUED DURING THE BID PERIOD INCLUDING ADDENDA, BID REVISIONS (IF ANY) AND OTHER CHANGES FOR THE CONVENIENCE OF THE PROJECT PARTICIPANTS. IN THE CASE OF A
- DIFFERENCE BETWEEN THE CONSOLIDATION SET AND THE CONTRACT DOCUMENTS, INTERPRETATION FOR CONTRACT PURPOSES WILL BE BASED ON THE ORIGINALLY ISSUED BID DOCUMENTS, ADDENDA AND BID REVISIONS. BOP MAKES NO WARRANTY OR ASSURANCE AS TO THE COMPLETENESS OF THE CONSOLIDATION SET OF DOCUMENTS. 11. SEE LANDSCAPE FOR ALL OFF SITE WORKS.
- 12. SEE LANDSCAPE FOR ALL PLANTER WALLS, PAVING, GRADING, SITE
- FURNISHINGS, FENCING, STAIRS, KICKRAILS AND HANDRAILS. 13. ALL LANDSCAPE CONCRETE AND PLANTER WALLS TO BE ARCHITECTURALLY EXPOSED CONCRETE (AEC).
- 14. ALL INTERIOR PARTITIONS TO EXTEND TO U/S OF STRUCTURE ABOVE UNLESS NOTED OTHERWISE
- 15. REFER TO STRUCTURAL FOR CONTROL JOINTS AND SAW CUTS. 16. ALL PARKING STALLS / LINES / ARROWS / SIGNAGE / HATCHING TO BE
- PAINTED. SEE TYPICAL PARKING PAINTING DETAILS. 17. INSTALL FIRE EXTINGUISHERS TO NFPA-10 + BCBC REQUIREMENTS (SEE FIRE PROTECTION DRAWINGS). REVIEW LOCATIONS WITH
- CONSULTANT. 18. ALL ROOF ANCHORS AND LIFE LINE SYSTEMS ARE SHOWN SCHEMATICALLY. LOCATIONS, TYPES AND QUANTITIES TO BE DESIGNED BY ROOF ANCHOR TRADE AS COMPLETE ENGINEERED
- 19. REFER TO A-700 SERIES FOR DETAILED UNIT PLANS AND DIMENSIONS

### GENERAL ACCESSIBILITY NOTES:

1. ACCESSIBILITY PROVIDED IN ACCORDANCE WITH BCBC 2018 AND/OR CSA B651-12

### FLAME SPREAD AND RATING FOR WALL AND CEILING FINISHES:

- 1. MINIMUM FLAME SPREAD RATINGS ALL WALL AND CEILING FINISHES TO BE NOT MORE THAN 150. SEE FURTHER REQUIREMENTS FOR SPECIFIC AREAS. PROVIDE SUBMITTED DATA FOR FSR FOR FINISHES (E.G. VINYL WALL COVERING, WOOD FINISHES ETC.).
- 2. EXIT AND EXIT STAIRS MAXIMUM FLAME SPREAD RATING 25. 3. DOOR MAXIMUM FLAME SPREAD RATING 200.
- 4. SERVICE MECHANICAL, ELECTRICAL, AND STORAGE ROOMS' MAXIMUM FLAME SPREAD RATING 25.

## FIRE STOPPING AND FIRE BLOCKING REQUIREMENTS:

- 1. FIRE STOP SYSTEMS MUST MEET CAN/ULC S115 REQUIREMENTS AS PER BCBC 2018 - SUBMITTAL REQUIRED FOR APPROVAL.
- 2. FIRE BLOCKING MATERIALS MUST MEET CAN/ULC \$101 REQUIREMENTS AS PER BCBC 2018 - SUBMITTAL REQUIRED FOR APPROVAL. 3. ALL PENETRATIONS THROUGH FIRE SEPARATIONS MUST BE FIRESTOPPED OR ENCLOSED IN APPROPRIATE SHAFTS OR EQUIPPED
- WITH APPROVED CLOSURES. 4. ALL PENETRATIONS FROM WITHIN ONE RATED ASSEMBLY TO ANOTHER MUST BE FIRESTOPPED AT THE INTERSECTION WITH APPROVED
- 5. ALL PIPES, CHASES OR DUCTS PASSING THROUGH ASSEMBLIES WITH
- FIRE RESISTANCE RATINGS OR SEPARATE CONCEALED SPACES MUST BE FIRESTOPPED OR FIRE BLOCKED WITH APPROVED SYSTEMS. 6. ALL PENETRATIONS THROUGH FIRE WALLS AND HORIZONTAL FIRE SEPARATIONS (BCBC SENTENCE 3.2.1.2.) MUST BE FIRE STOPPED WITH
- 7. FIRE TAPE OR FIRE CAULK ALL SHAFT GWB JOINTS.

LEVEL 03-04

SCALE: 1/8" = 1'-0"





Oleksiuk Politano Architects

PROPERTIES LTD.



ISSUED FOR

A 2022-06-24 BUILDING PERMIT APPLICATION

B 2022-09-29 BUILDING PERMIT APPLICATION **REVISION 1** 

C 2022-10-14 ISSUED FOR TENDER

D 2022-11-10 IFT ADDENDUM 2

E 2023-03-27 POST-TENDER ADDENDUM 02

F 2023-04-09 BUILDING PERMIT APPLICATION **REVISION 3** 

THIS DRAWING IS COPYRIGHTED AND MUST NOT BE USED, REPRODUCED, OR REVISED WITHOUT WRITTEN PERMISSION.

ALL DIMENSIONS ARE IN FEET AND INCHES UNLESS OTHERWISE


VERIFY DIMENSIONS. DO NOT SCALE THIS DRAWING.

REPORT INCONSISTENCIES AND OMISSIONS TO THE CONSULTANT FOR CLARIFICATION BEFORE COMMENCING WITH THE WORK.

DEVIATIONS FROM THE CONTRACT DOCUMENTS WITHOUT WRITTEN APPROVAL FROM THE CONSULTANT ARE SUBJECT TO CORRECTION AT THE CONTRACTOR'S EXPENSE.

## ARCHITECT

BONIFACE OLEKSIUK POLITANO ARCHITECTS 180-510 NICOLA STREET VANCOUVER BC, V6G 3J7 Tel: 236.521.6568 Email: info@bop.ca

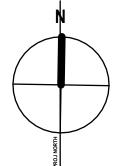

This document has been digitally certified with digital certificate and encryption technology authorized by the Architectural Institute of BC and the Engineers and Geoscientists BC. The authoritative original has been transmitted to you in digital form. Any printed version can be relied upon as a true copy of the original when supplied by the architect, bearing images of the professional seal and digital certificate, or when printed from the digitally-certified electronic file provided by the architect.

SEAL



NORTHERN JUNK

1314 WHARF STREET


PLAN - LEVEL 3-4

PLOT DATE: 2023-04-07 8:01:29 PM

CHECKED: SO/AP

A-204

19004C

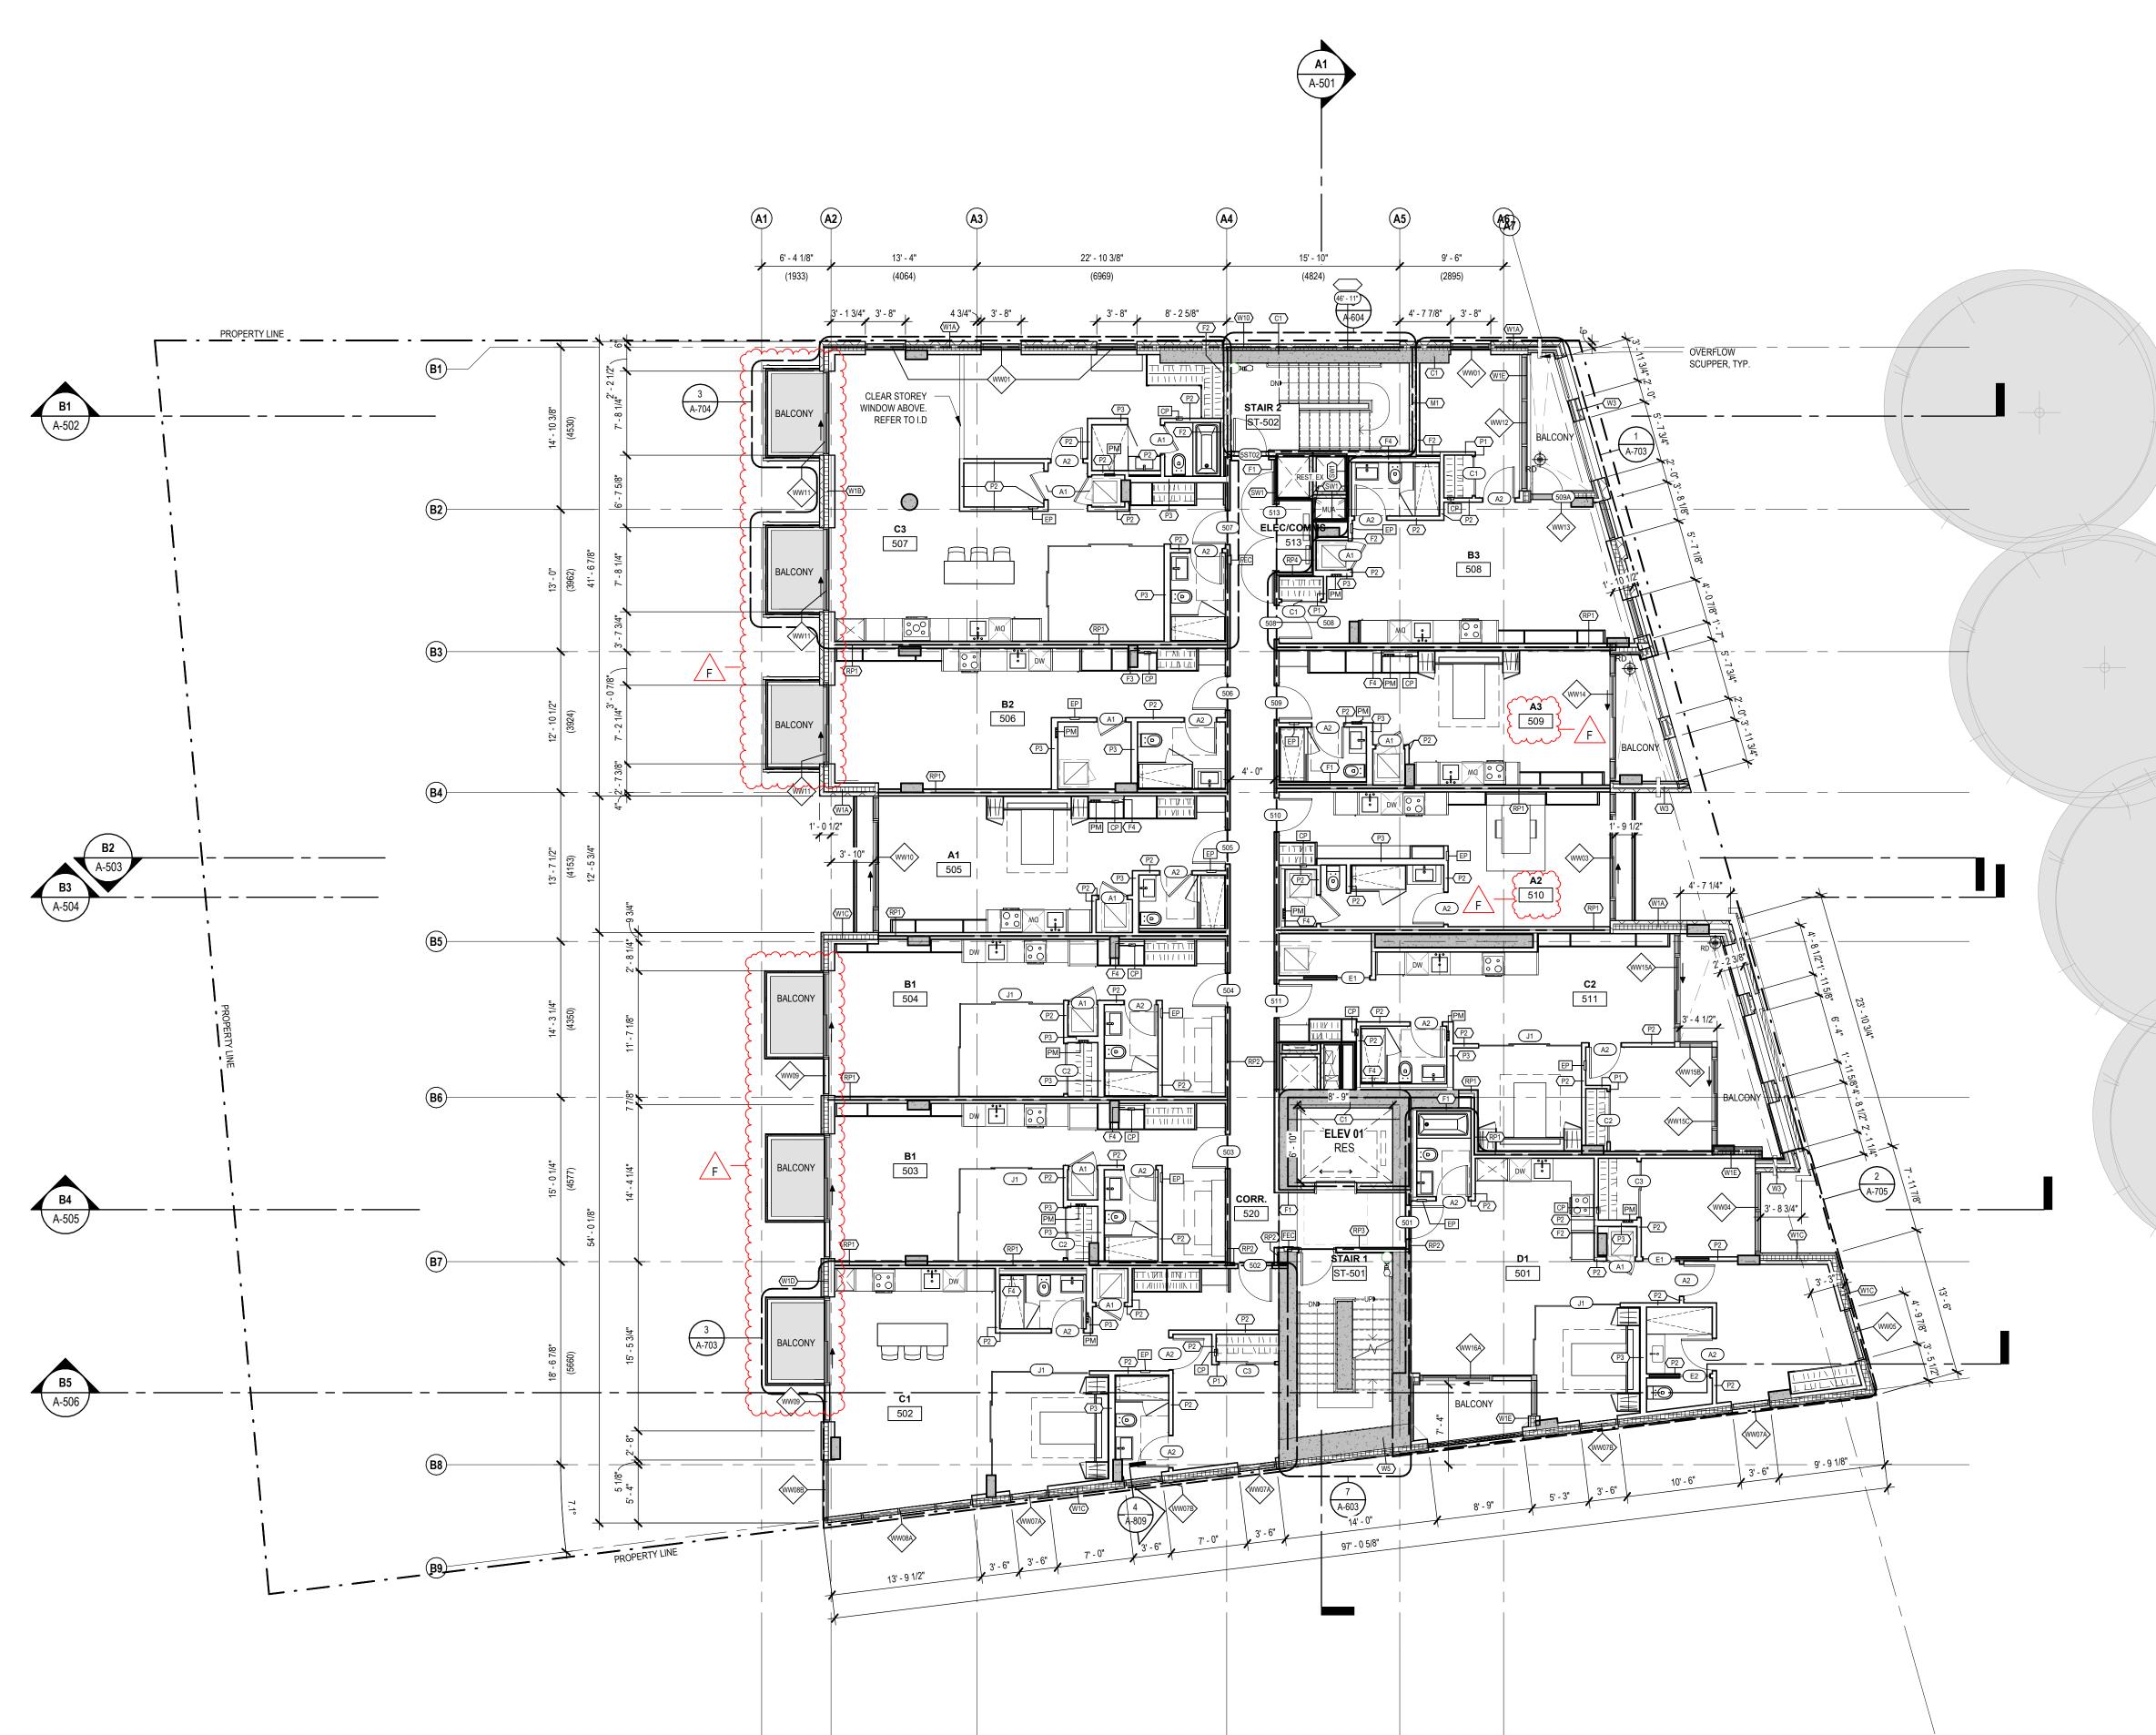



- 1. SEE CODE REPORT FOR COMPLETE CODE ANALYSIS AND PROJECT DESCRIPTION
- 2. REFER TO OWNER SUPPLIED SITE SURVEY FOR ALL EXISTING
- CONDITIONS AND SITE BOUNDARIES. 3. REFER TO OWNER SUPPLIED GEOTECHNICAL REPORT FOR ALL SOIL
- CONDITIONS AND OTHER RELATED INFORMATION. 4. SEE MECHANICAL ENERGY MODEL REPORT FOR ENERGY COMPLIANCE.
- 5. SEE SPECIFICATIONS FOR DELEGATED DESIGN REQUIREMENTS FOR ITEMS INCLUDING BUT NOT LIMITED TO: WALL CLADDING SYSTEMS, MASONRY LINTELS, TIES AND LEDGERS, STEEL STUD FRAMING, SUSPENDED CEILINGS, WALLS ACTING AS GUARDS + FIRESTOPPING
- 6. FOR DETAILED INTERIOR DESIGN REFER TO INTERIOR DRAWINGS (ID) 7. FOR DETAILED LANDSCAPE DESIGN REFER TO LANDSCAPE DRAWINGS 8. DIMENSIONS SHOWN TO FACE OF CONCRETE, CENTERLINE OF COLUMN, CENTERLINE OF WINDOW/DOOR OR EDGE OF STEEL STUD FRAMING U.N.O.
- 9. EXPOSED INTERIOR COLUMNS TO BE FINISHED PER INTERIOR DESIGN. PROVIDE MOCKUP OF COLUMN FINISHES FOR REVIEW.
- 10. THE CONSOLIDATION SET (CS) IS ISSUED DURING THE CONSTRUCTION PHASE OF THE PROJECT AND CONTAINS A COMPILATION OF ALL DOCUMENTS ISSUED DURING THE BID PERIOD INCLUDING ADDENDA, BID REVISIONS (IF ANY) AND OTHER CHANGES FOR THE
- CONVENIENCE OF THE PROJECT PARTICIPANTS. IN THE CASE OF A DIFFERENCE BETWEEN THE CONSOLIDATION SET AND THE CONTRACT DOCUMENTS, INTERPRETATION FOR CONTRACT PURPOSES WILL BE BASED ON THE ORIGINALLY ISSUED BID DOCUMENTS, ADDENDA AND BID REVISIONS. BOP MAKES NO WARRANTY OR ASSURANCE AS TO THE COMPLETENESS OF THE CONSOLIDATION SET OF DOCUMENTS.
- 11. SEE LANDSCAPE FOR ALL OFF SITE WORKS. 12. SEE LANDSCAPE FOR ALL PLANTER WALLS, PAVING, GRADING, SITE
- FURNISHINGS, FENCING, STAIRS, KICKRAILS AND HANDRAILS. 13. ALL LANDSCAPE CONCRETE AND PLANTER WALLS TO BE ARCHITECTURALLY EXPOSED CONCRETE (AEC).
- 14. ALL INTERIOR PARTITIONS TO EXTEND TO U/S OF STRUCTURE ABOVE UNLESS NOTED OTHERWISE
- 15. REFER TO STRUCTURAL FOR CONTROL JOINTS AND SAW CUTS. 16. ALL PARKING STALLS / LINES / ARROWS / SIGNAGE / HATCHING TO BE PAINTED. SEE TYPICAL PARKING PAINTING DETAILS.
- 17. INSTALL FIRE EXTINGUISHERS TO NFPA-10 + BCBC REQUIREMENTS (SEE FIRE PROTECTION DRAWINGS). REVIEW LOCATIONS WITH CONSULTANT.
- 18. ALL ROOF ANCHORS AND LIFE LINE SYSTEMS ARE SHOWN SCHEMATICALLY. LOCATIONS, TYPES AND QUANTITIES TO BE DESIGNED BY ROOF ANCHOR TRADE AS COMPLETE ENGINEERED
- 19. REFER TO A-700 SERIES FOR DETAILED UNIT PLANS AND DIMENSIONS

### **GENERAL ACCESSIBILITY NOTES:**

1. ACCESSIBILITY PROVIDED IN ACCORDANCE WITH BCBC 2018 AND/OR CSA B651-12

### FLAME SPREAD AND RATING FOR WALL AND CEILING FINISHES:

- MINIMUM FLAME SPREAD RATINGS ALL WALL AND CEILING FINISHES TO BE NOT MORE THAN 150. SEE FURTHER REQUIREMENTS FOR SPECIFIC AREAS. PROVIDE SUBMITTED DATA FOR FSR FOR FINISHES (E.G. VINYL WALL COVERING, WOOD FINISHES ETC.).
- 2. EXIT AND EXIT STAIRS MAXIMUM FLAME SPREAD RATING 25. 3. DOOR MAXIMUM FLAME SPREAD RATING 200.
- 4. SERVICE MECHANICAL, ELECTRICAL, AND STORAGE ROOMS' MAXIMUM FLAME SPREAD RATING 25.

## FIRE STOPPING AND FIRE BLOCKING REQUIREMENTS:

- 1. FIRE STOP SYSTEMS MUST MEET CAN/ULC S115 REQUIREMENTS AS PER BCBC 2018 - SUBMITTAL REQUIRED FOR APPROVAL. 2. FIRE BLOCKING MATERIALS MUST MEET CAN/ULC S101 REQUIREMENTS AS PER BCBC 2018 - SUBMITTAL REQUIRED FOR APPROVAL. 3. ALL PENETRATIONS THROUGH FIRE SEPARATIONS MUST BE
- FIRESTOPPED OR ENCLOSED IN APPROPRIATE SHAFTS OR EQUIPPED WITH APPROVED CLOSURES. 4. ALL PENETRATIONS FROM WITHIN ONE RATED ASSEMBLY TO ANOTHER
- MUST BE FIRESTOPPED AT THE INTERSECTION WITH APPROVED
- 5. ALL PIPES, CHASES OR DUCTS PASSING THROUGH ASSEMBLIES WITH FIRE RESISTANCE RATINGS OR SEPARATE CONCEALED SPACES MUST BE FIRESTOPPED OR FIRE BLOCKED WITH APPROVED SYSTEMS. 6. ALL PENETRATIONS THROUGH FIRE WALLS AND HORIZONTAL FIRE SEPARATIONS (BCBC SENTENCE 3.2.1.2.) MUST BE FIRE STOPPED WITH FT RATING.
- 7. FIRE TAPE OR FIRE CAULK ALL SHAFT GWB JOINTS.

SCALE: 1/8" = 1'-0"



Oleksiuk Politano Architects

PROPERTIES LTD.



CROSSTOWN

A 2022-06-24 BUILDING PERMIT APPLICATION

B 2022-09-29 BUILDING PERMIT APPLICATION **REVISION 1** 

C 2022-10-14 ISSUED FOR TENDER

D 2022-11-10 IFT ADDENDUM 2

E 2023-03-27 POST-TENDER ADDENDUM 02

F 2023-04-09 BUILDING PERMIT APPLICATION **REVISION 3** 

THIS DRAWING IS COPYRIGHTED AND MUST NOT BE USED, REPRODUCED, OR REVISED WITHOUT WRITTEN PERMISSION.

ALL DIMENSIONS ARE IN FEET AND INCHES UNLESS OTHERWISE VERIFY DIMENSIONS.

DO NOT SCALE THIS DRAWING.


REPORT INCONSISTENCIES AND OMISSIONS TO THE CONSULTANT FOR CLARIFICATION BEFORE COMMENCING WITH THE WORK.

WRITTEN APPROVAL FROM THE CONSULTANT ARE SUBJECT TO CORRECTION AT THE CONTRACTOR'S EXPENSE.

DEVIATIONS FROM THE CONTRACT DOCUMENTS WITHOUT

## ARCHITECT

BONIFACE OLEKSIUK POLITANO ARCHITECTS 180-510 NICOLA STREET VANCOUVER BC, V6G 3J7 Tel: 236.521.6568 Email: info@bop.ca

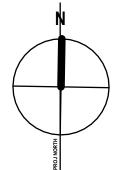

This document has been digitally certified with digital certificate and encryption technology authorized by the Architectural Institute of BC and the Engineers and Geoscientists BC. The authoritative original has been transmitted to you in digital form. Any printed version can be relied upon as a true copy of the original when supplied by the architect, bearing images of the professional seal and digital certificate, or when printed from the digitally-certified electronic file provided by the architect.

SEAL



## NORTHERN JUNK

1314 WHARF STREET


PLAN - LEVEL 5

PLOT DATE: 2023-04-07 8:01:33 PM

A-205

CHECKED: SO/AP

19004C

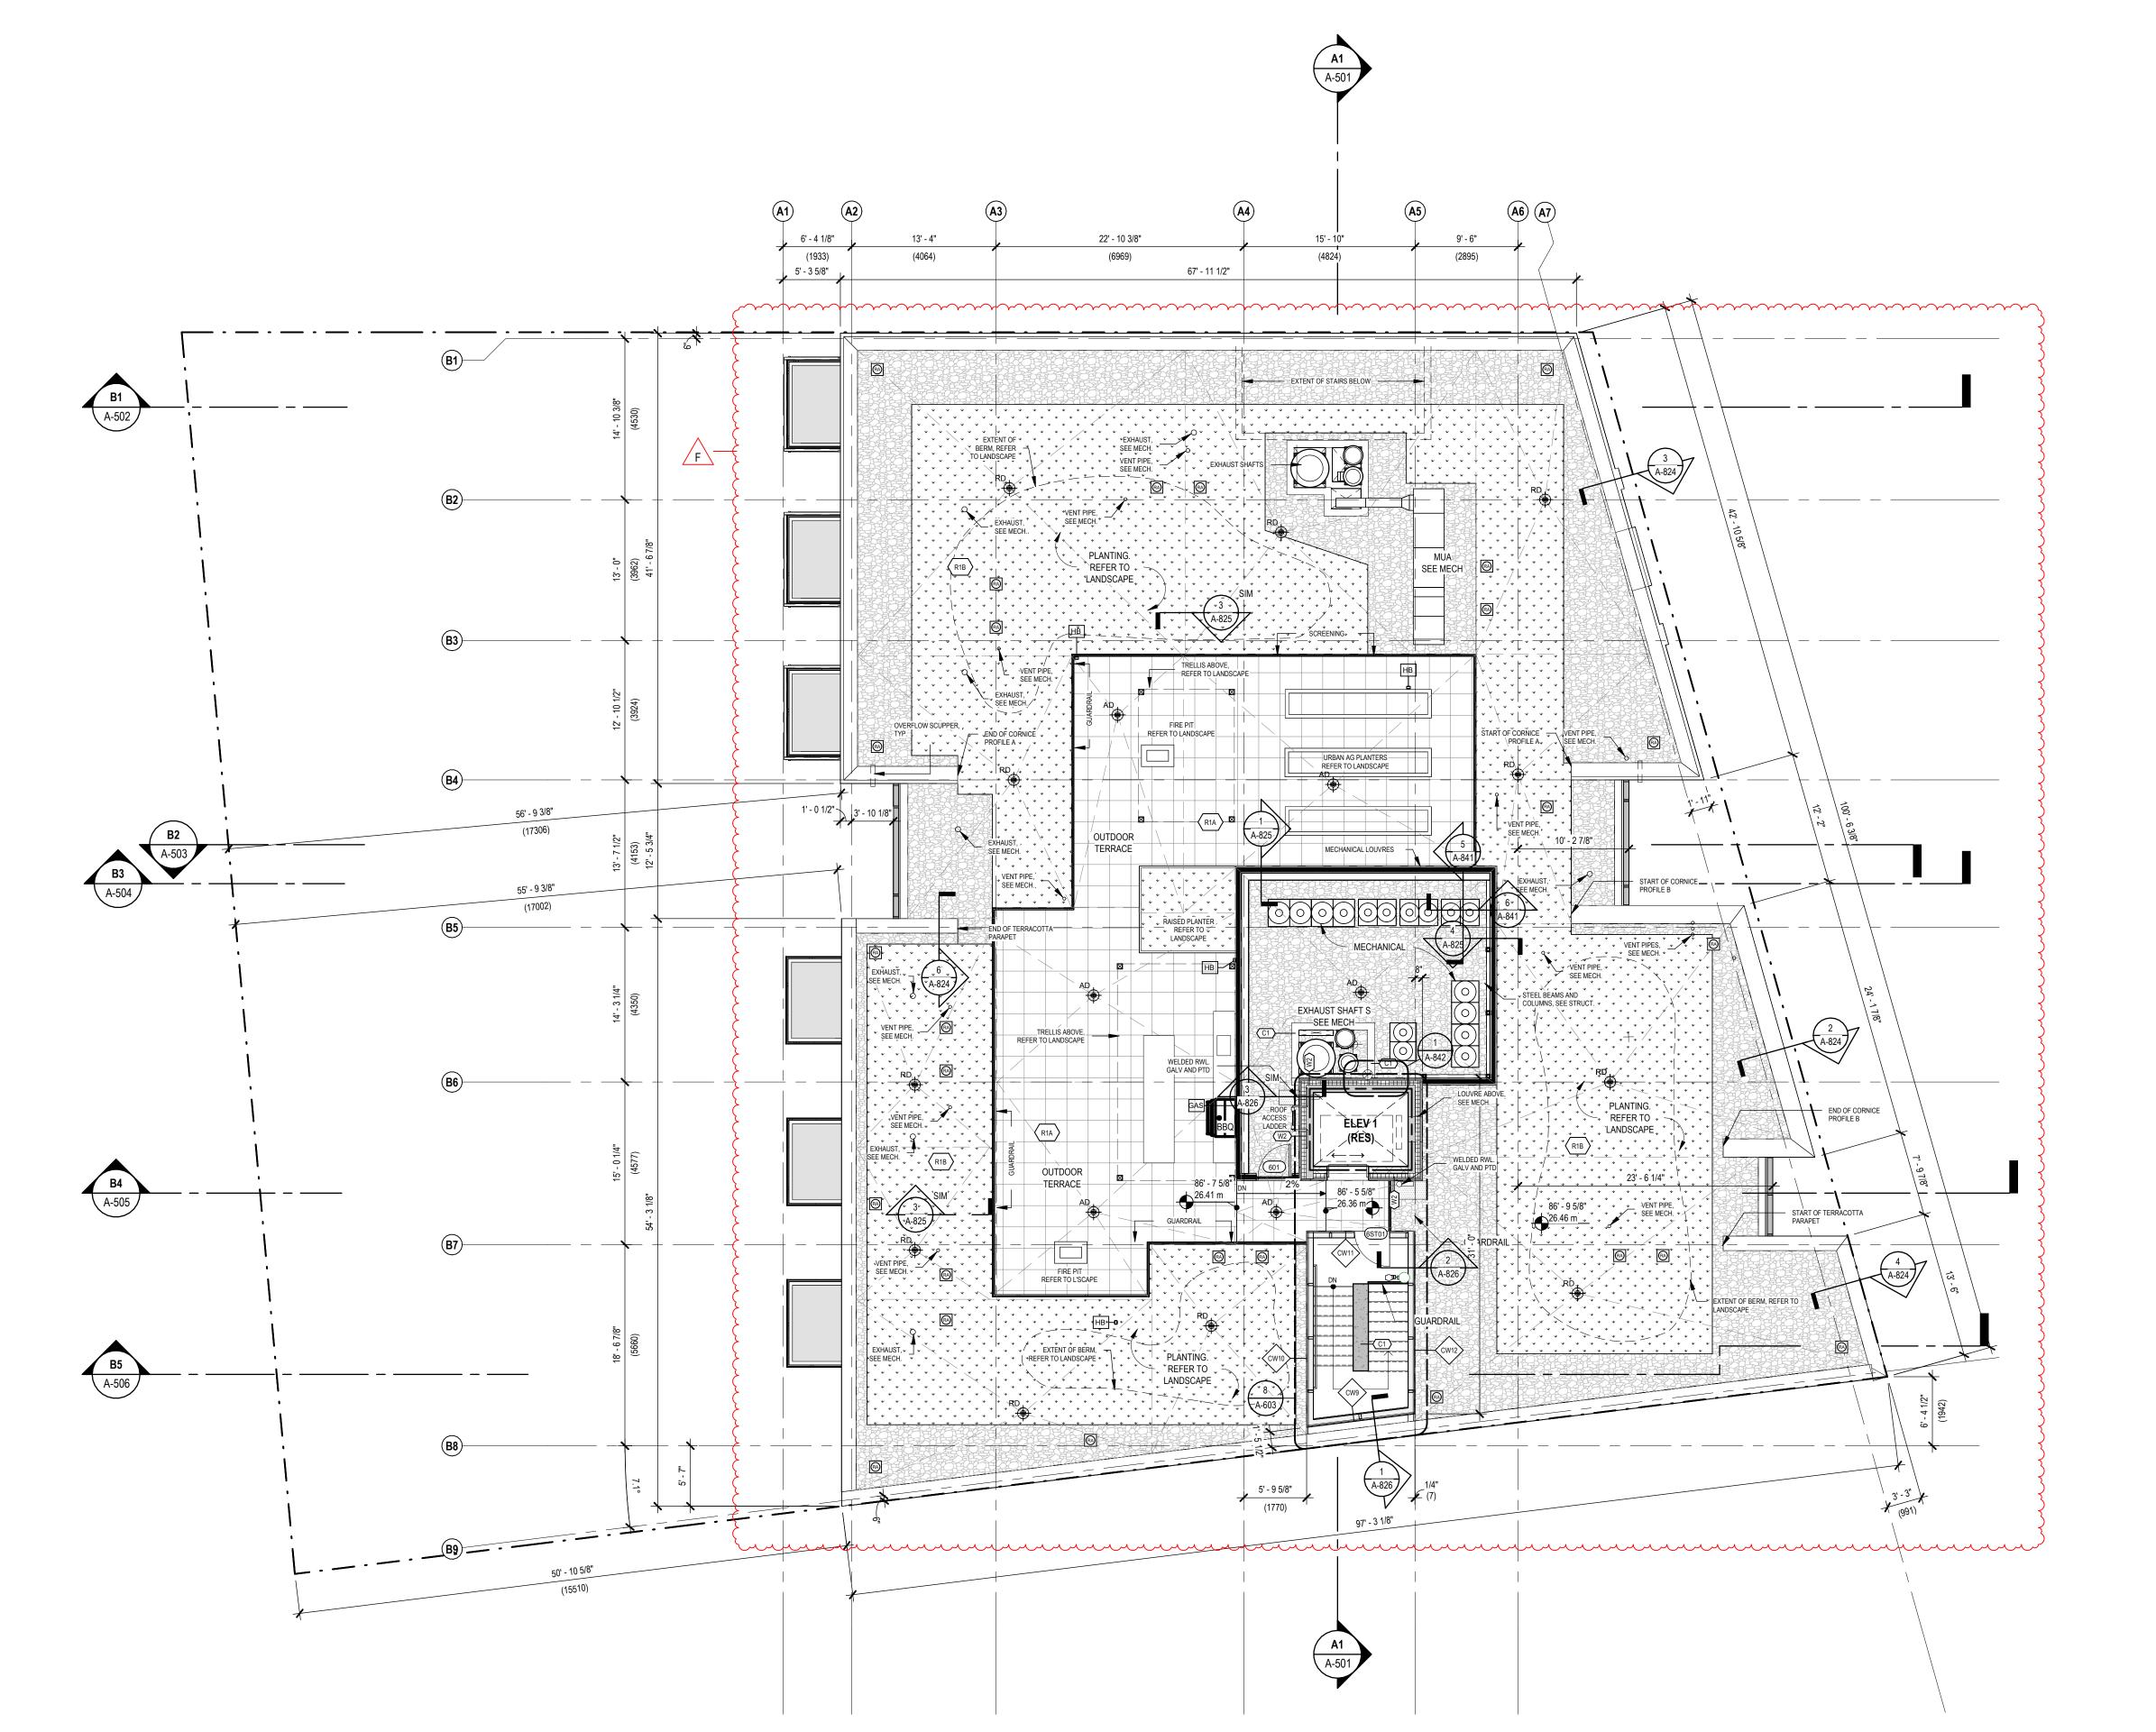

### **GENERAL NOTES:**

- 1. SEE CODE REPORT FOR COMPLETE CODE ANALYSIS AND PROJECT DESCRIPTION
- 2. REFER TO OWNER SUPPLIED SITE SURVEY FOR ALL EXISTING
- CONDITIONS AND SITE BOUNDARIES. 3. REFER TO OWNER SUPPLIED GEOTECHNICAL REPORT FOR ALL SOIL CONDITIONS AND OTHER RELATED INFORMATION.
- 4. SEE MECHANICAL ENERGY MODEL REPORT FOR ENERGY COMPLIANCE. 5. SEE SPECIFICATIONS FOR DELEGATED DESIGN REQUIREMENTS FOR ITEMS INCLUDING BUT NOT LIMITED TO: WALL CLADDING SYSTEMS, MASONRY LINTELS, TIES AND LEDGERS, STEEL STUD FRAMING, SUSPENDED CEILINGS, WALLS ACTING AS GUARDS + FIRESTOPPING
- FOR DETAILED INTERIOR DESIGN REFER TO INTERIOR DRAWINGS (ID) 7. FOR DETAILED LANDSCAPE DESIGN REFER TO LANDSCAPE DRAWINGS 8. DIMENSIONS SHOWN TO FACE OF CONCRETE, CENTERLINE OF COLUMN, CENTERLINE OF WINDOW/DOOR OR EDGE OF STEEL STUD
- FRAMING U.N.O. 9. EXPOSED INTERIOR COLUMNS TO BE FINISHED PER INTERIOR DESIGN.
- PROVIDE MOCKUP OF COLUMN FINISHES FOR REVIEW. 10. THE CONSOLIDATION SET (CS) IS ISSUED DURING THE CONSTRUCTION PHASE OF THE PROJECT AND CONTAINS A COMPILATION OF ALL DOCUMENTS ISSUED DURING THE BID PERIOD INCLUDING
- ADDENDA, BID REVISIONS (IF ANY) AND OTHER CHANGES FOR THE CONVENIENCE OF THE PROJECT PARTICIPANTS. IN THE CASE OF A DIFFERENCE BETWEEN THE CONSOLIDATION SET AND THE CONTRACT DOCUMENTS, INTERPRETATION FOR CONTRACT PURPOSES WILL BE BASED ON THE ORIGINALLY ISSUED BID DOCUMENTS, ADDENDA AND BID REVISIONS. BOP MAKES NO WARRANTY OR ASSURANCE AS TO THE COMPLETENESS OF THE CONSOLIDATION SET OF DOCUMENTS. 11. SEE LANDSCAPE FOR ALL OFF SITE WORKS.
- 12. SEE LANDSCAPE FOR ALL PLANTER WALLS, PAVING, GRADING, SITE
- FURNISHINGS, FENCING, STAIRS, KICKRAILS AND HANDRAILS. 13. ALL LANDSCAPE CONCRETE AND PLANTER WALLS TO BE ARCHITECTURALLY EXPOSED CONCRETE (AEC).
- 14. ALL INTERIOR PARTITIONS TO EXTEND TO U/S OF STRUCTURE ABOVE UNLESS NOTED OTHERWISE
- 15. REFER TO STRUCTURAL FOR CONTROL JOINTS AND SAW CUTS. 16. ALL PARKING STALLS / LINES / ARROWS / SIGNAGE / HATCHING TO BE PAINTED. SEE TYPICAL PARKING PAINTING DETAILS.
- 17. INSTALL FIRE EXTINGUISHERS TO NFPA-10 + BCBC REQUIREMENTS (SEE FIRE PROTECTION DRAWINGS). REVIEW LOCATIONS WITH CONSULTANT.
- 18. ALL ROOF ANCHORS AND LIFE LINE SYSTEMS ARE SHOWN SCHEMATICALLY. LOCATIONS, TYPES AND QUANTITIES TO BE DESIGNED BY ROOF ANCHOR TRADE AS COMPLETE ENGINEERED
- 19. REFER TO A-700 SERIES FOR DETAILED UNIT PLANS AND DIMENSIONS

### **GENERAL ACCESSIBILITY NOTES:**

1. ACCESSIBILITY PROVIDED IN ACCORDANCE WITH BCBC 2018 AND/OR CSA B651-12

### FLAME SPREAD AND RATING FOR WALL AND CEILING FINISHES:

- 1. MINIMUM FLAME SPREAD RATINGS ALL WALL AND CEILING FINISHES TO BE NOT MORE THAN 150. SEE FURTHER REQUIREMENTS FOR SPECIFIC AREAS. PROVIDE SUBMITTED DATA FOR FSR FOR FINISHES (E.G. VINYL
- WALL COVERING, WOOD FINISHES ETC.). 2. EXIT AND EXIT STAIRS MAXIMUM FLAME SPREAD RATING 25. 3. DOOR MAXIMUM FLAME SPREAD RATING 200.
- 4. SERVICE MECHANICAL, ELECTRICAL, AND STORAGE ROOMS' MAXIMUM
- FLAME SPREAD RATING 25.

## FIRE STOPPING AND FIRE BLOCKING REQUIREMENTS:

- 1. FIRE STOP SYSTEMS MUST MEET CAN/ULC S115 REQUIREMENTS AS PER BCBC 2018 - SUBMITTAL REQUIRED FOR APPROVAL.
- 2. FIRE BLOCKING MATERIALS MUST MEET CAN/ULC \$101 REQUIREMENTS AS PER BCBC 2018 - SUBMITTAL REQUIRED FOR APPROVAL. 3. ALL PENETRATIONS THROUGH FIRE SEPARATIONS MUST BE FIRESTOPPED OR ENCLOSED IN APPROPRIATE SHAFTS OR EQUIPPED
- WITH APPROVED CLOSURES. 4. ALL PENETRATIONS FROM WITHIN ONE RATED ASSEMBLY TO ANOTHER MUST BE FIRESTOPPED AT THE INTERSECTION WITH APPROVED
- 5. ALL PIPES, CHASES OR DUCTS PASSING THROUGH ASSEMBLIES WITH FIRE RESISTANCE RATINGS OR SEPARATE CONCEALED SPACES MUST
- BE FIRESTOPPED OR FIRE BLOCKED WITH APPROVED SYSTEMS. 6. ALL PENETRATIONS THROUGH FIRE WALLS AND HORIZONTAL FIRE SEPARATIONS (BCBC SENTENCE 3.2.1.2.) MUST BE FIRE STOPPED WITH
- FT RATING. 7. FIRE TAPE OR FIRE CAULK ALL SHAFT GWB JOINTS.

Boniface Oleksiuk Politano Architects



CROSSTOWN PROPERTIES LTD.

## ISSUED FOR

- A 2022-06-24 BUILDING PERMIT APPLICATION
- B 2022-09-29 BUILDING PERMIT APPLICATION **REVISION 1**
- C 2022-10-14 ISSUED FOR TENDER
- D 2022-11-17 IFT ADDENDUM 3
- E 2023-02-21 POST-TENDER ADDENDUM F 2023-04-09 BUILDING PERMIT APPLICATION
- **REVISION 3**

THIS DRAWING IS COPYRIGHTED AND MUST NOT BE USED, REPRODUCED, OR REVISED WITHOUT WRITTEN PERMISSION.

ALL DIMENSIONS ARE IN FEET AND INCHES UNLESS OTHERWISE


VERIFY DIMENSIONS. DO NOT SCALE THIS DRAWING.

REPORT INCONSISTENCIES AND OMISSIONS TO THE CONSULTANT FOR CLARIFICATION BEFORE COMMENCING WITH THE WORK.

DEVIATIONS FROM THE CONTRACT DOCUMENTS WITHOUT WRITTEN APPROVAL FROM THE CONSULTANT ARE SUBJECT TO CORRECTION AT THE CONTRACTOR'S EXPENSE.

## ARCHITECT

BONIFACE OLEKSIUK POLITANO ARCHITECTS 180-510 NICOLA STREET VANCOUVER BC, V6G 3J7 Tel: 236.521.6568 Email: info@bop.ca

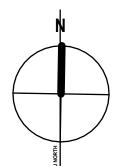

This document has been digitally certified with digital certificate and encryption technology authorized by the Architectural Institute of BC and the Engineers and Geoscientists BC. The authoritative original has been transmitted to you in digital form. Any printed version can be relied upon as a true copy of the original when supplied by the architect, bearing images of the professional seal and digital certificate, or when printed from the digitally-certified electronic file provided by the architect.

SEAL



## NORTHERN JUNK

1314 WHARF STREET

PLAN - ROOF

PLOT DATE: 2023-04-07 8:01:37 PM

A-206

19004C

C:\Users\Louis Moore\Documents\Northern Junk Model\_louis84FE8.rvt

CHECKED: SO/AP







## PROPERTIES LTD.

### ISSUED FOR

- A 2022-06-24 BUILDING PERMIT APPLICATION B 2022-09-29 BUILDING PERMIT APPLICATION
- **REVISION 1** C 2022-10-14 ISSUED FOR TENDER
- D 2023-04-09 BUILDING PERMIT APPLICATION **REVISION 3**

### IMPERIAL

THIS DRAWING IS COPYRIGHTED AND MUST NOT BE USED, REPRODUCED, OR REVISED WITHOUT WRITTEN PERMISSION.

ALL DIMENSIONS ARE IN FEET AND INCHES UNLESS OTHERWISE VERIFY DIMENSIONS. DO NOT SCALE THIS DRAWING.

REPORT INCONSISTENCIES AND OMISSIONS TO THE CONSULTANT

DEVIATIONS FROM THE CONTRACT DOCUMENTS WITHOUT WRITTEN APPROVAL FROM THE CONSULTANT ARE SUBJECT TO CORRECTION AT THE CONTRACTOR'S EXPENSE.

FOR CLARIFICATION BEFORE COMMENCING WITH THE WORK.

### ARCHITECT BONIFACE OLEKSIUK POLITANO ARCHITECTS

180-510 NICOLA STREET VANCOUVER BC, V6G 3J7

Tel: 236.521.6568 Email: info@bop.ca

This document has been digitally certified with digital certificate and encryption technology authorized by the Architectural Institute of BC and the Engineers and Geoscientists BC. The authoritative original has been transmitted to you in digital form. Any printed version can be relied upon as a true copy of the original when supplied by the architect, bearing images of the professional seal and digital certificate, or when printed from the digitally-certified electronic file provided by the architect.

SEAL




## NORTHERN JUNK


1314 WHARF STREET


PARTIAL PLANS


DRAWN: LM PLOT DATE: 2023-04-07 8:01:39 PM CHECKED: SO/AP


A-207

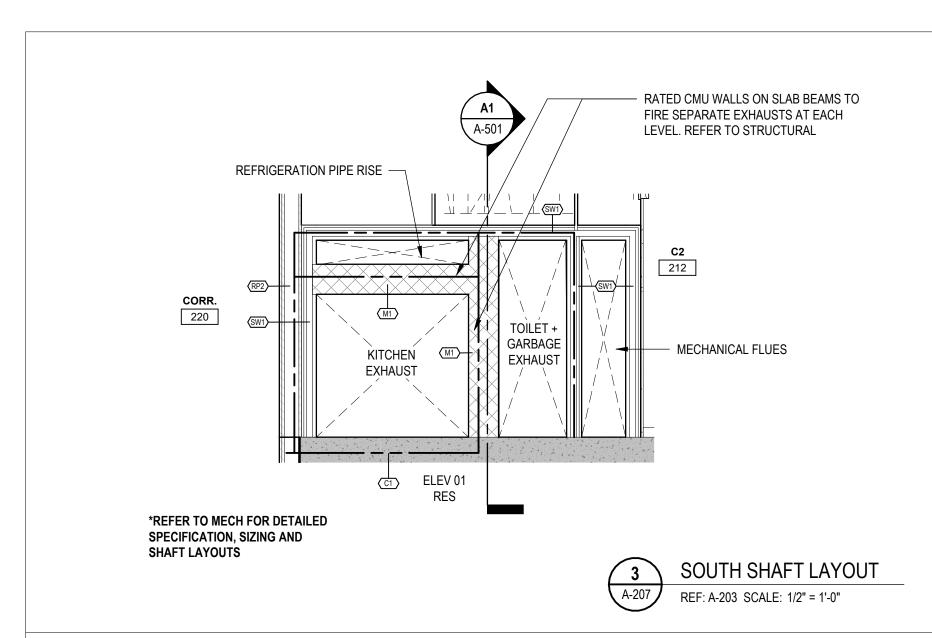

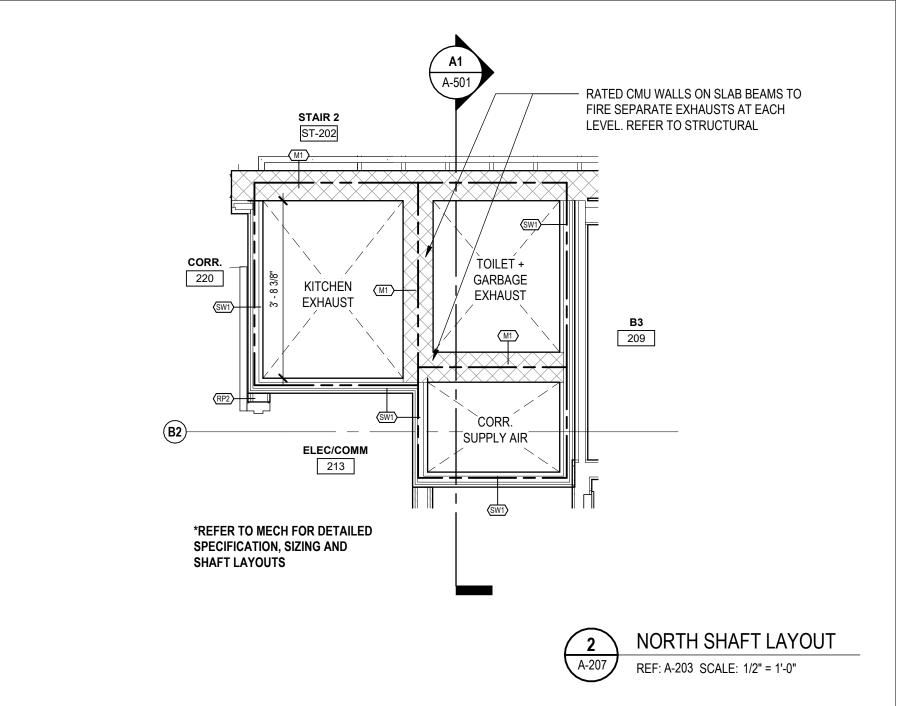

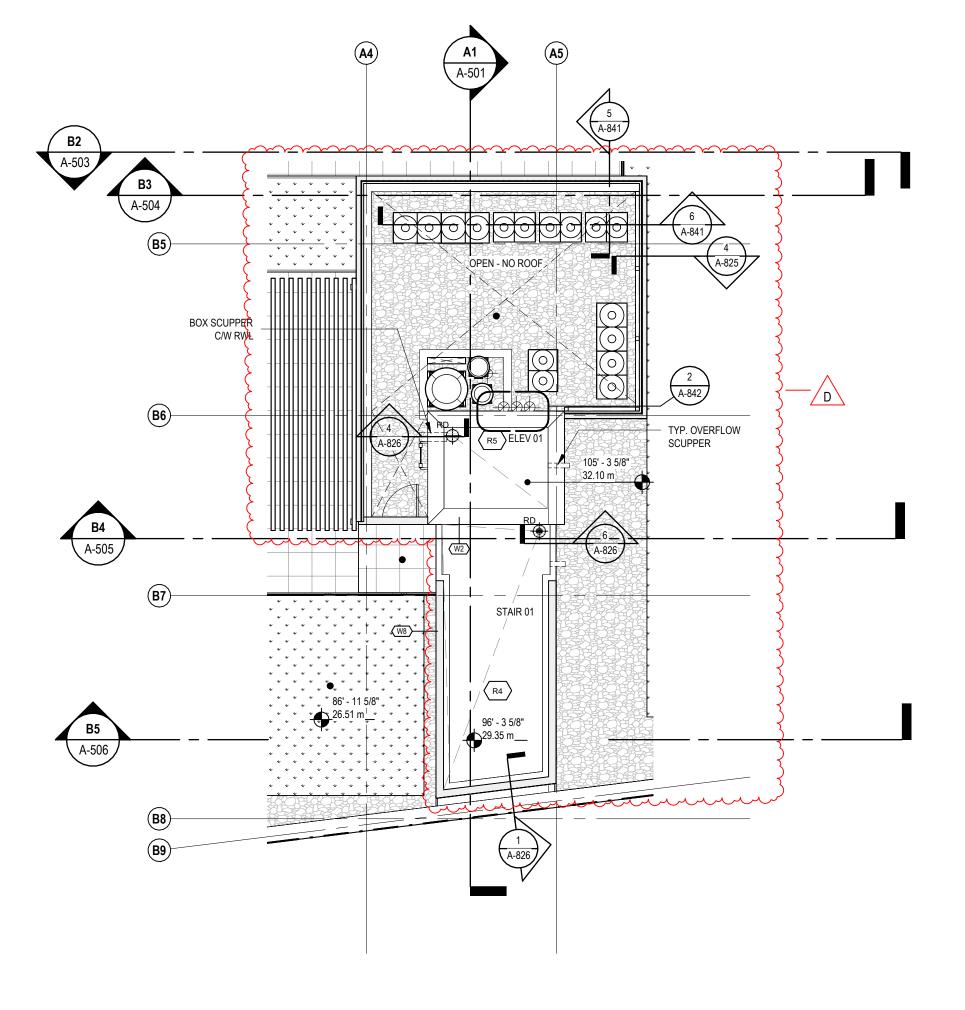

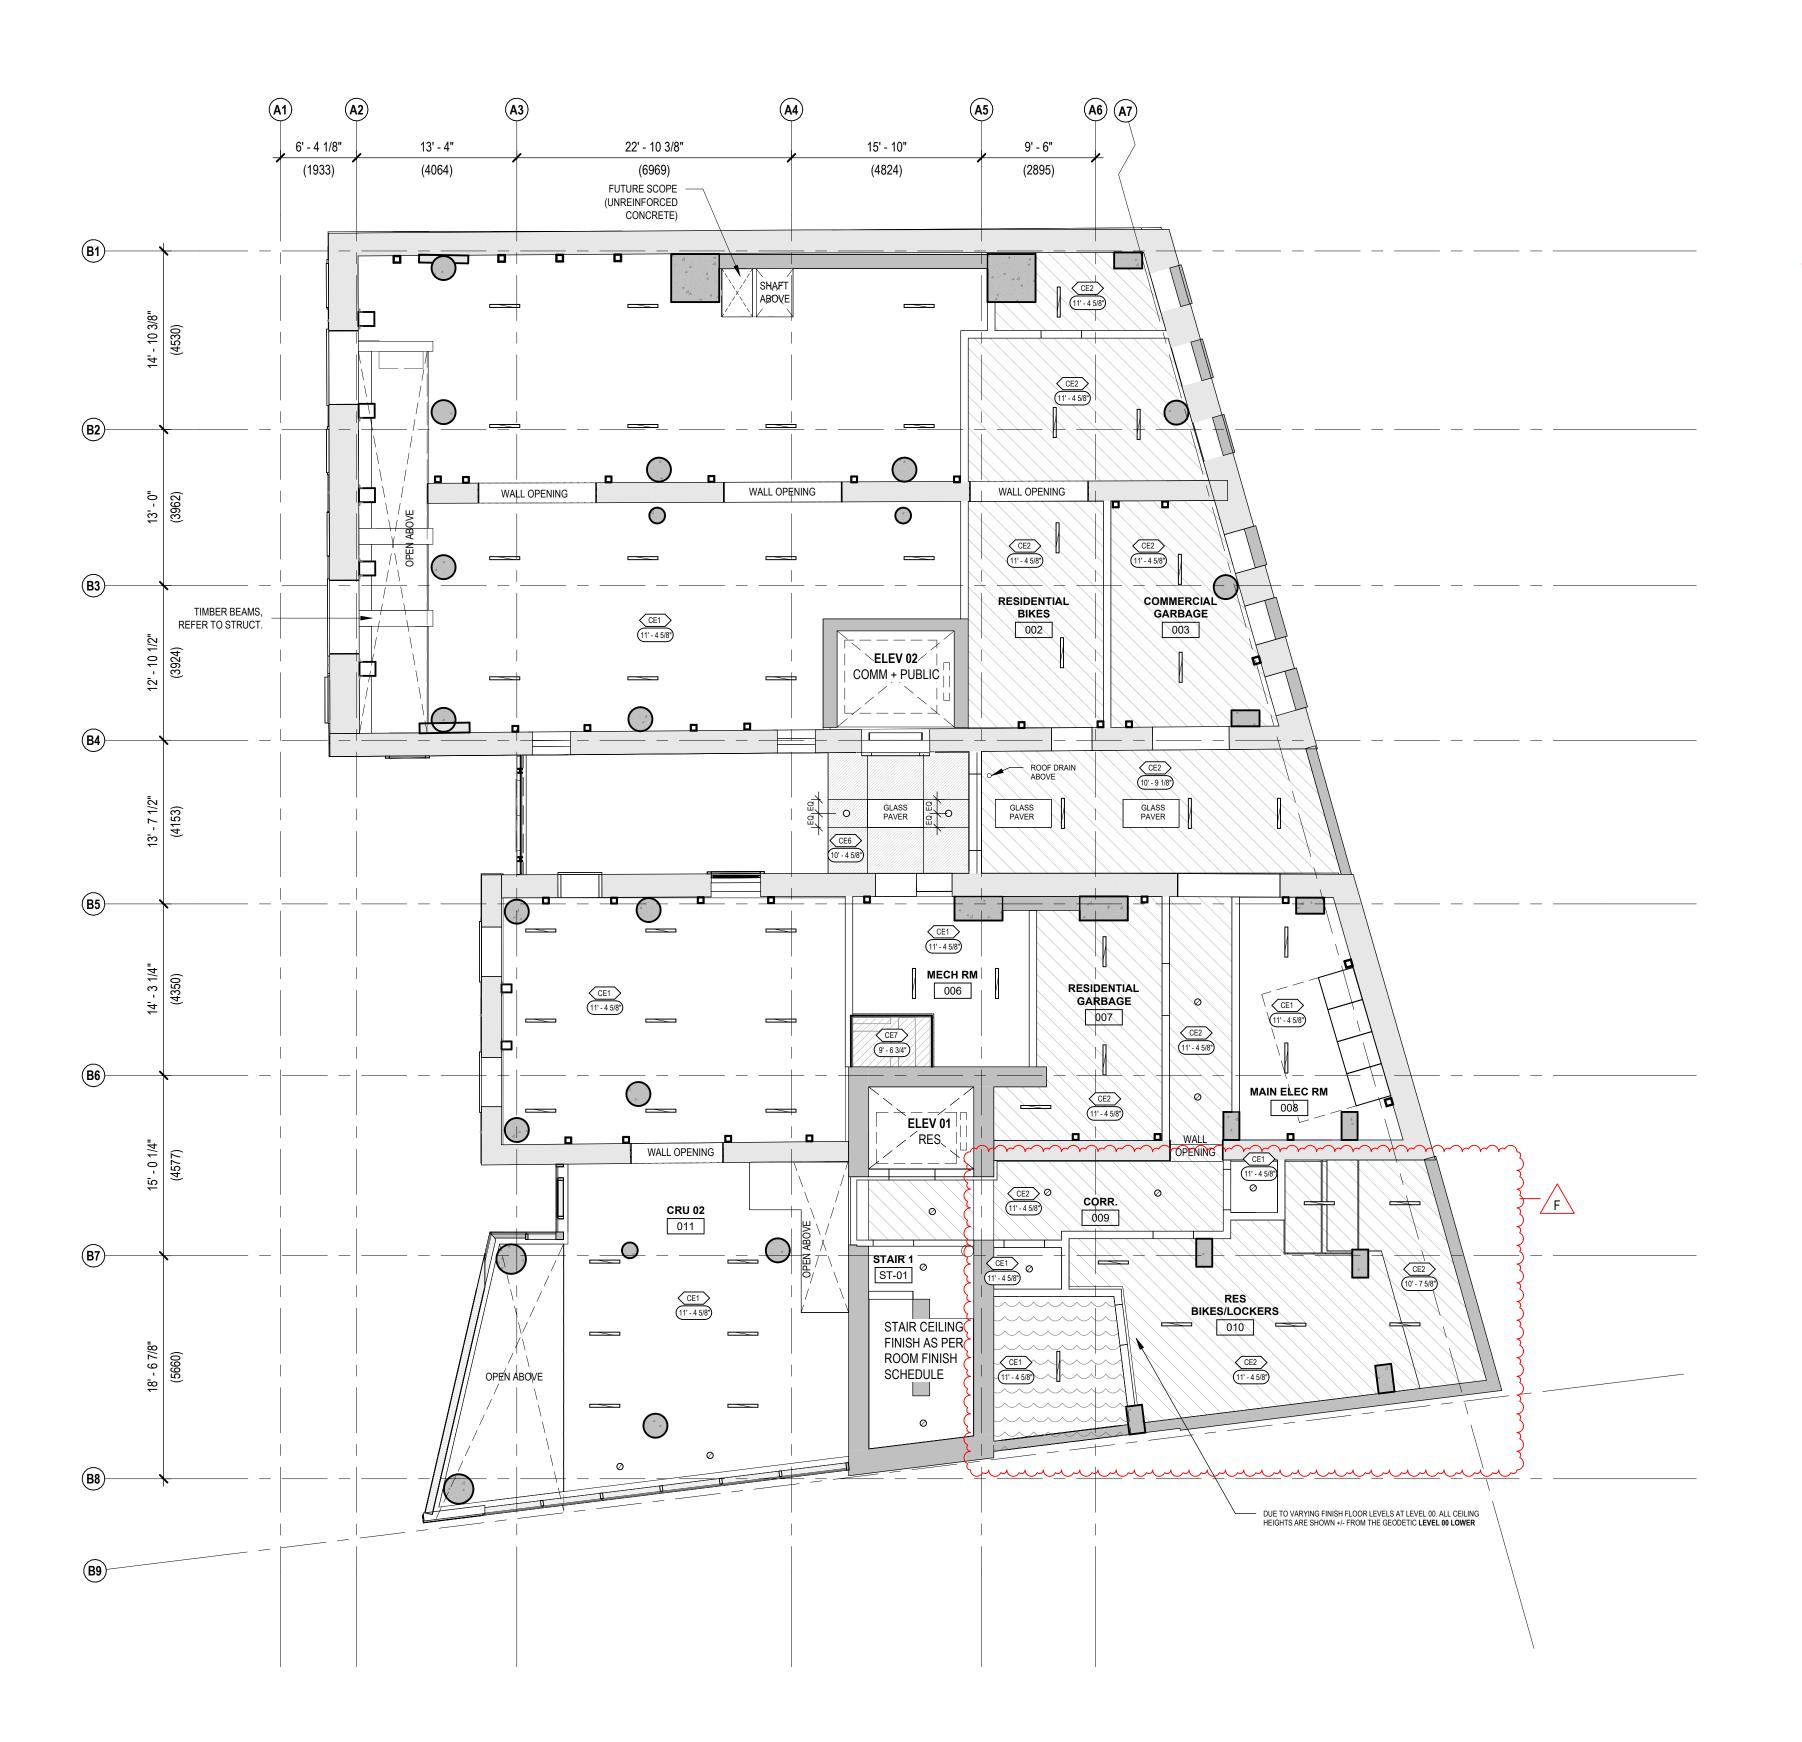

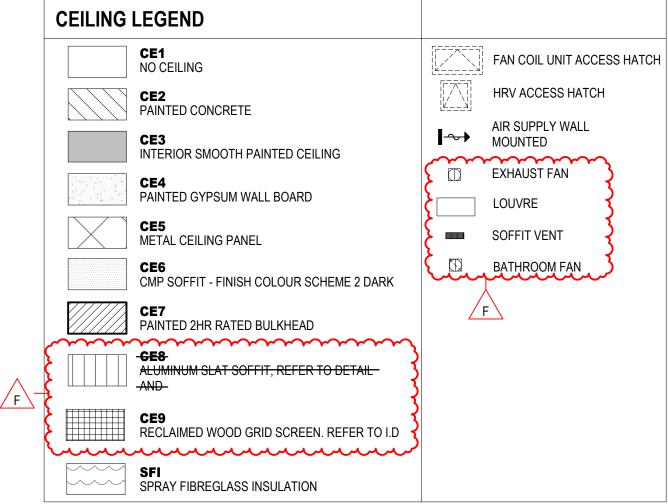



- LOCATIONS OF LIGHTING FIXTURES AND MECHANICAL GRILLE ARE DIMENSIONED FROM THE CENTRE LINES OF FIXTURE & GRILL TO FACE OF STUD OR FACE OF STRUCTURE UNLESS NOTED OTHERWISE.
- 2. REFER TO MECHANICAL AND ELECTRICAL FOR DETAIL AND SCHEDULES.
- 3. REFER TO FINISH SCHEDULE FOR FINISH DETAILS.
- ALL SUSPENDED GWB CEILINGS TO BE LATERALLY BRACED TO THE STRUCTURE.
- SPRAY FOAM INSULATION TO EXTEND 3' 4" BEYOND HEATED SPACE ABOVE, TYP.
- 6. CORRIDOR CEILING HEIGHT ON LEVEL 2 AS NOTED, CORRIDOR CEILING HEIGHT ON LEVEL 3 AND 4 7'9".
- 7. REFER TO A-700 SERIES FOR DETAILED UNIT PLANS AND DIMENSIONS
- 8. SPRINKLER HEADS/COVERS TO MATCH SOFFIT COLOUR AND MATERIAL, TYP.
- 9. PAINT SPRINKLER PIPING TO MATCH PAINTED CEILINGS AND WALLS WHERE EXPOSED TO VIEW, TYP.

## LEGEND



CEILING MATERIALS / FINISHES

SEE ALSO ROOM FINISH SCHEDULE

CEILING ASSEMBLY TAG

CLEAR FINISH HEIGHT

## CEILING LIGHT LEGEND

— — LED COVE STRIP LIGHT

PENDANT LIGHT

RECESSED DOWNLIGHT

SURFACE DOWNLIGHT

WALL MOUNTED LIGHT

SEE ELECTRICAL FOR LIGHT FIXTURE TYPE

SURFACE LINEAR STRIP LIGHT

RECESSED LINEAR STRIP LIGHT

SURFACE TRACK LIGHT





**Boniface** 

Oleksiuk Politano

CROSSTOWN

PROPERTIES LTD.

PROPERTIES

## ISSUED FOR

- A 2022-06-24 BUILDING PERMIT APPLICATION
- B 2022-09-29 BUILDING PERMIT APPLICATION REVISION 1
- C 2022-10-14 ISSUED FOR TENDER
- D 2022-11-10 IFT ADDENDUM 2
- E 2023-02-21 POST-TENDER ADDENDUM
- F 2023-04-09 BUILDING PERMIT APPLICATION REVISION 3

### **IMPERIAL**

THIS DRAWING IS COPYRIGHTED AND MUST NOT BE USED, REPRODUCED, OR REVISED WITHOUT WRITTEN PERMISSION.

ALL DIMENSIONS ARE IN FEET AND INCHES UNLESS OTHERWISE NOTED.
VERIFY DIMENSIONS.

DO NOT SCALE THIS DRAWING.

REPORT INCONSISTENCIES AND OMISSIONS TO THE CONSULTANT

FOR CLARIFICATION BEFORE COMMENCING WITH THE WORK.

DEVIATIONS FROM THE CONTRACT DOCUMENTS WITHOUT WRITTEN APPROVAL FROM THE CONSULTANT ARE SUBJECT TO

## ARCHITECT

BONIFACE OLEKSIUK POLITANO ARCHITECTS 180-510 NICOLA STREET VANCOUVER BC, V6G 3J7
Tel: 236.521.6568 Email: info@bop.ca

This document has been digitally certified with digital certificate and encryption technology authorized by the Architectural Institute of BC and the Engineers and Geoscientists BC. The authoritative original has been transmitted to you in digital form. Any printed version can be relied upon as a true copy of the original when supplied by the architect, bearing images of the professional seal and digital certificate, or when printed from the digitally-certified electronic file provided by the architect.

SEAL



## NORTHERN JUNK

1314 WHARF STREET


CEILING PLAN - LEVEL


CHECKED: SO/AP


DRAWN: LM PLOT DATE: 2023-04-07 8:01:41 PM


4-301

19004C

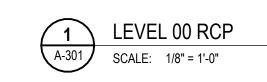

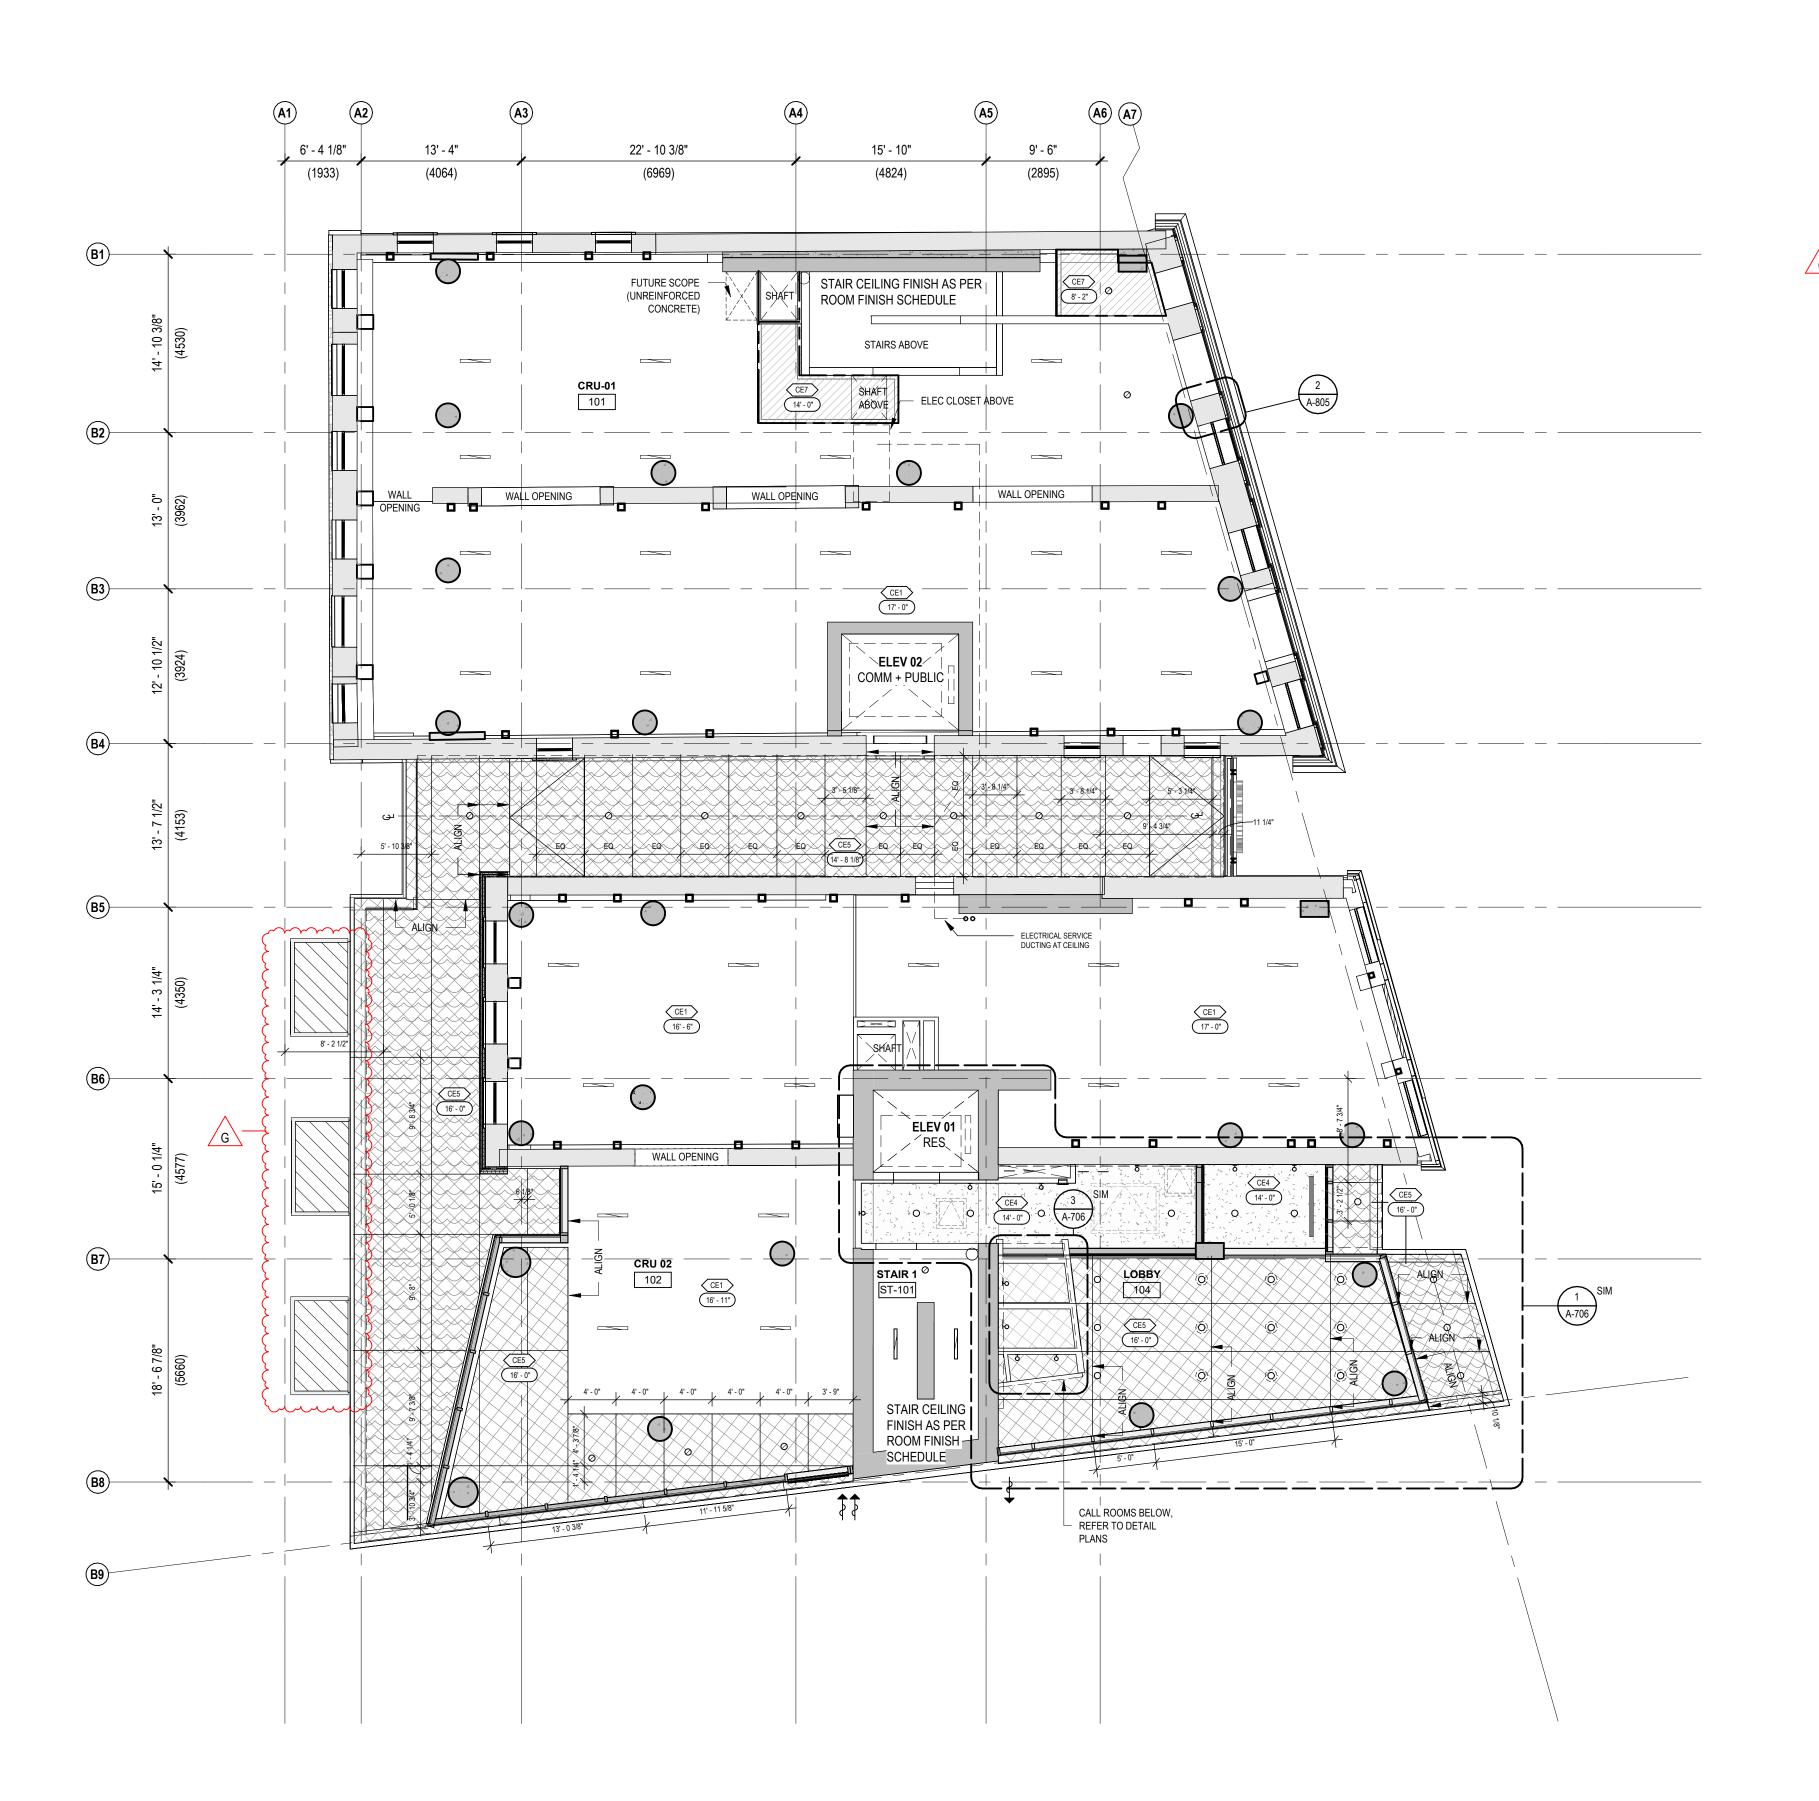

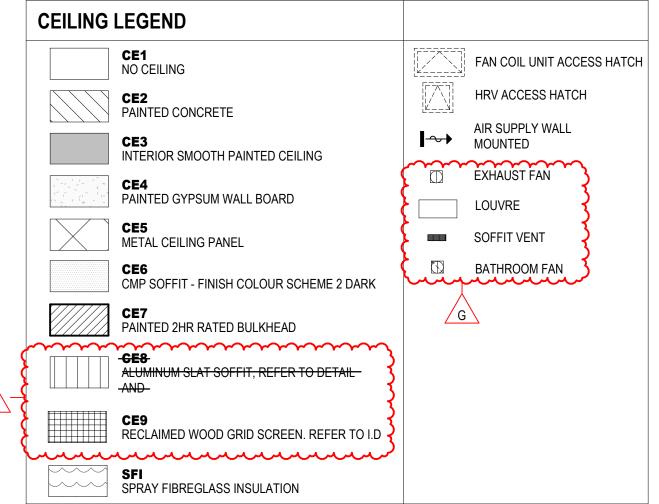

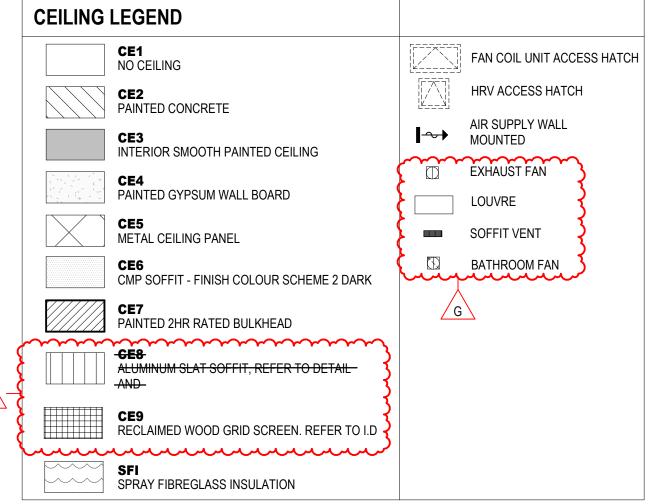

### **GENERAL NOTES - CEILING PLANS**

- 1. LOCATIONS OF LIGHTING FIXTURES AND MECHANICAL GRILLE ARE DIMENSIONED FROM THE CENTRE LINES OF FIXTURE & GRILL TO FACE OF STUD OR FACE OF STRUCTURE UNLESS NOTED OTHERWISE.
- 2. REFER TO MECHANICAL AND ELECTRICAL FOR DETAIL AND
- 3. REFER TO FINISH SCHEDULE FOR FINISH DETAILS.
- 4. ALL SUSPENDED GWB CEILINGS TO BE LATERALLY BRACED TO THE STRUCTURE.
- 5. SPRAY FOAM INSULATION TO EXTEND 3' 4" BEYOND HEATED SPACE
- 6. CORRIDOR CEILING HEIGHT ON LEVEL 2 AS NOTED, CORRIDOR CEILING
- HEIGHT ON LEVEL 3 AND 4 7'9".
- 7. REFER TO A-700 SERIES FOR DETAILED UNIT PLANS AND DIMENSIONS 8. SPRINKLER HEADS/COVERS TO MATCH SOFFIT COLOUR AND MATERIAL,
- 9. PAINT SPRINKLER PIPING TO MATCH PAINTED CEILINGS AND WALLS
- WHERE EXPOSED TO VIEW, TYP.

### **LEGEND**

CEILING MATERIALS / FINISHES

CEILING MATERIAL / FINISHES **CEILING ASSEMBLY TAG** 

CLEAR FINISH HEIGHT

SEE ALSO ROOM FINISH SCHEDULE

## **CEILING LIGHT LEGEND**

PENDANT LIGHT

SURFACE DOWNLIGHT

SURFACE LINEAR STRIP LIGHT

RECESSED DOWNLIGHT

SEE ELECTRICAL FOR LIGHT FIXTURE TYPE WALL MOUNTED LIGHT

RECESSED LINEAR STRIP LIGHT SURFACE TRACK LIGHT

— — LED COVE STRIP LIGHT



Oleksiuk Politano

PROPERTIES LTD.



ISSUED FOR

- A 2022-06-24 BUILDING PERMIT APPLICATION
- B 2022-09-29 BUILDING PERMIT APPLICATION **REVISION 1**
- C 2022-10-14 ISSUED FOR TENDER
- D 2022-11-10 IFT ADDENDUM 2
- E 2023-02-21 POST-TENDER ADDENDUM
- F 2023-03-27 POST-TENDER ADDENDUM 02
- G 2023-04-09 BUILDING PERMIT APPLICATION **REVISION 3**

### **IMPERIAL**

THIS DRAWING IS COPYRIGHTED AND MUST NOT BE USED, REPRODUCED, OR REVISED WITHOUT WRITTEN PERMISSION.

ALL DIMENSIONS ARE IN FEET AND INCHES UNLESS OTHERWISE VERIFY DIMENSIONS.

REPORT INCONSISTENCIES AND OMISSIONS TO THE CONSULTANT FOR CLARIFICATION BEFORE COMMENCING WITH THE WORK.

DEVIATIONS FROM THE CONTRACT DOCUMENTS WITHOUT WRITTEN APPROVAL FROM THE CONSULTANT ARE SUBJECT TO CORRECTION AT THE CONTRACTOR'S EXPENSE.

## **ARCHITECT**

DO NOT SCALE THIS DRAWING.

BONIFACE OLEKSIUK POLITANO ARCHITECTS 180-510 NICOLA STREET VANCOUVER BC, V6G 3J7

Tel: 236.521.6568 Email: info@bop.ca

This document has been digitally certified with digital certificate and encryption technology authorized by the Architectural Institute of BC and the Engineers and Geoscientists BC. The authoritative original has been transmitted to you in digital form. Any printed version can be relied upon as a true copy of the original when supplied by the architect, bearing images of the professional seal and digital certificate, or when printed from the digitally-certified electronic file provided by the architect.

SEAL



## NORTHERN JUNK

1314 WHARF STREET

CEILING PLAN - LEVEL


DRAWN: LM PLOT DATE: 2023-04-07 8:04:59 PM


CHECKED: SO/AP

A-302

19004C



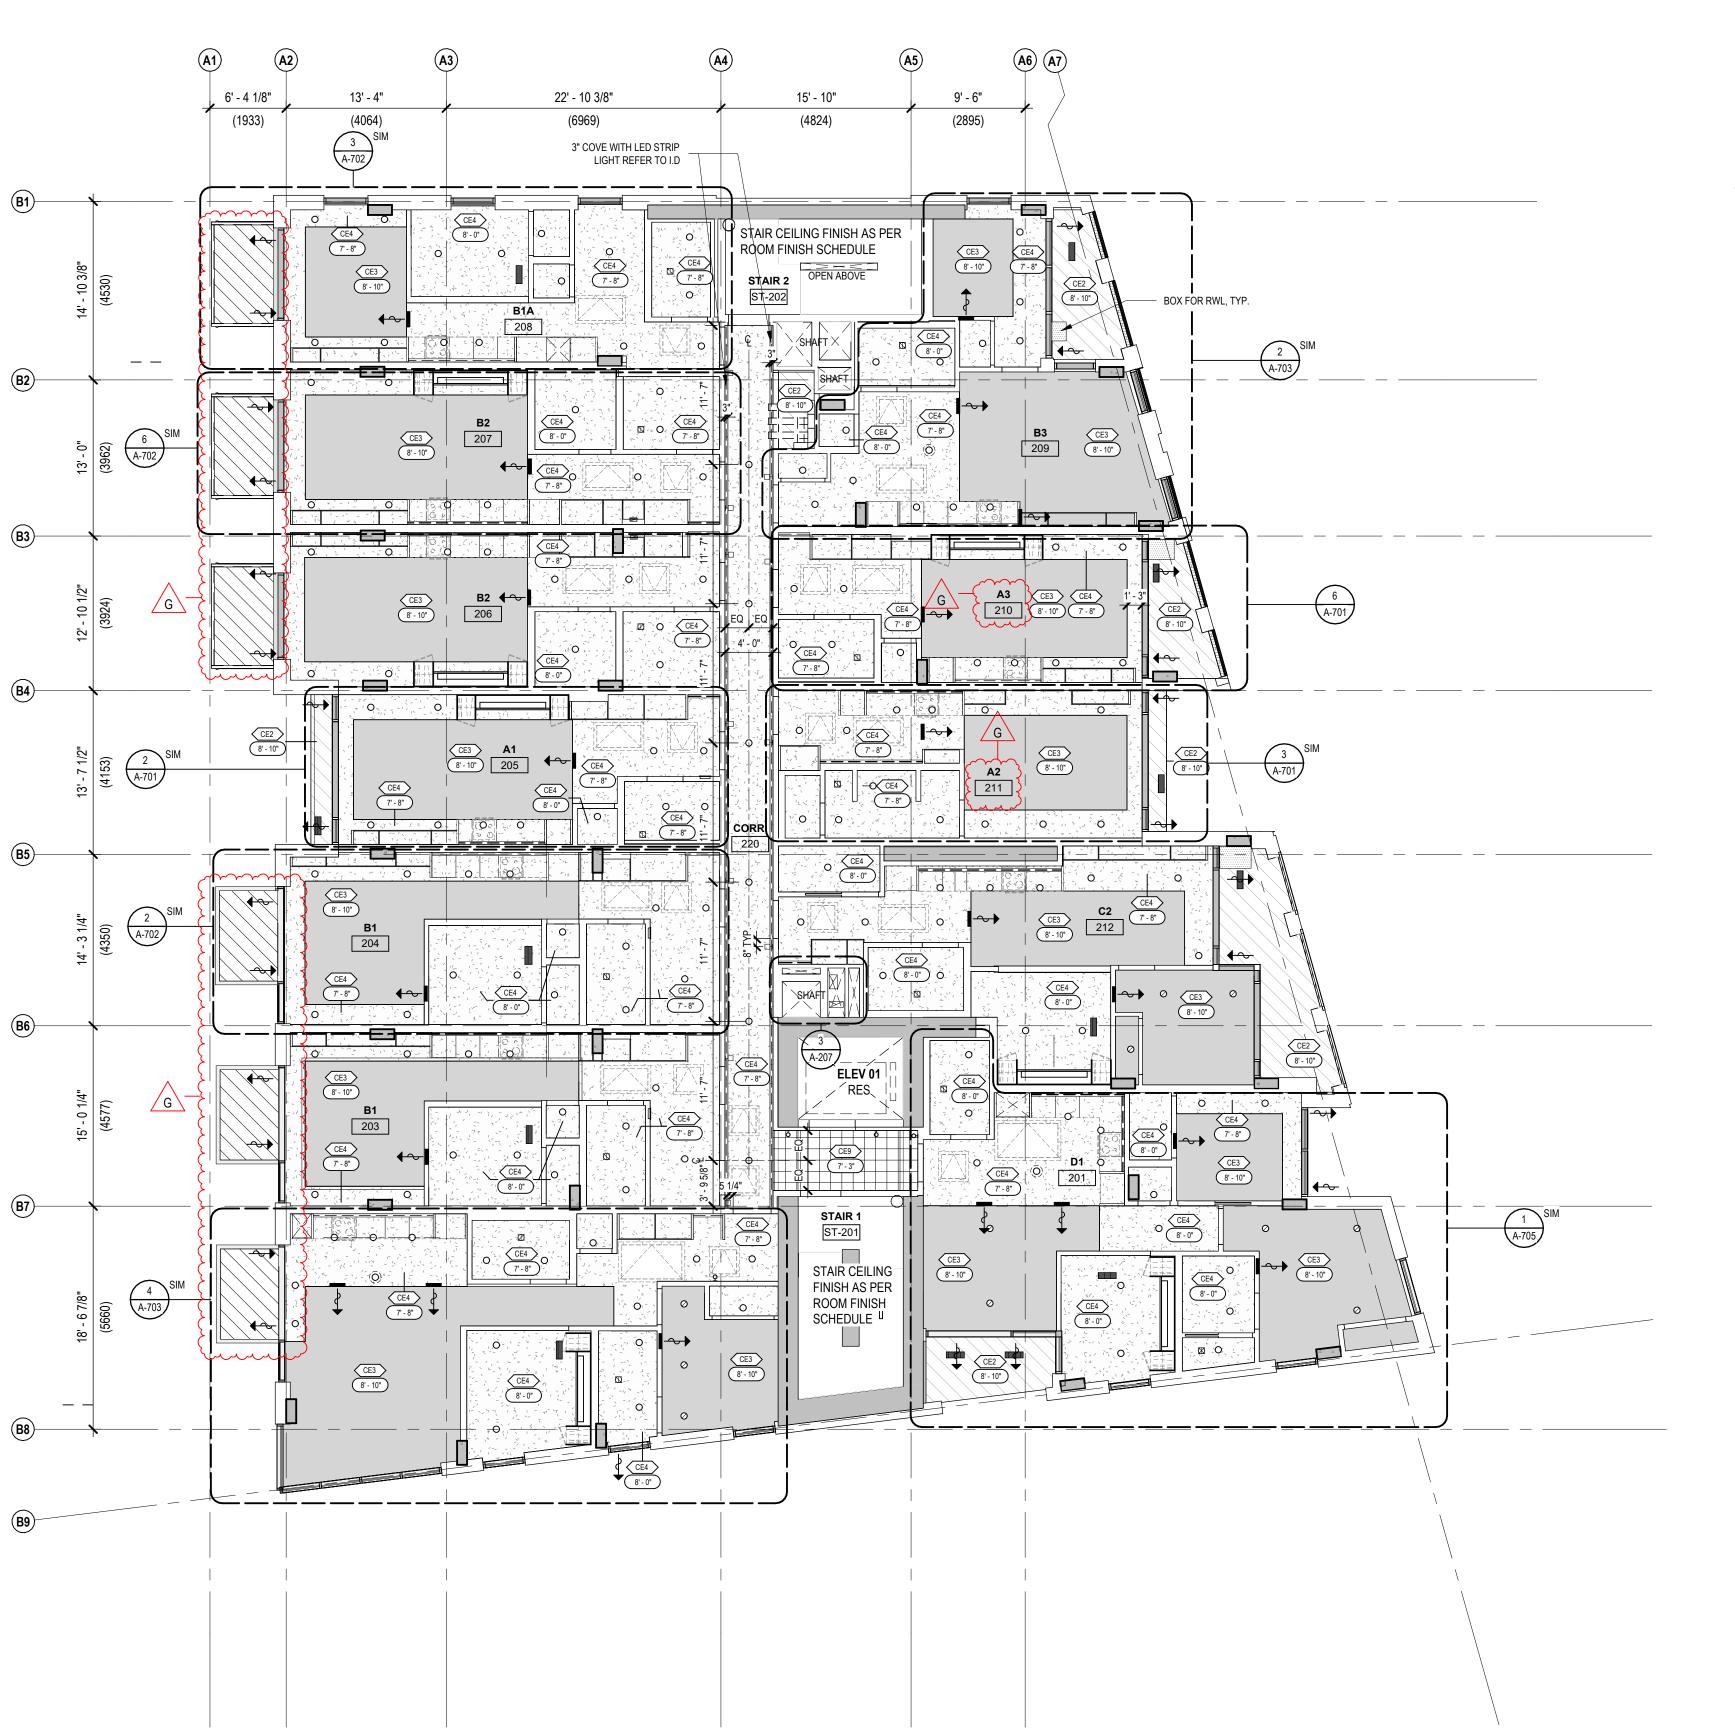

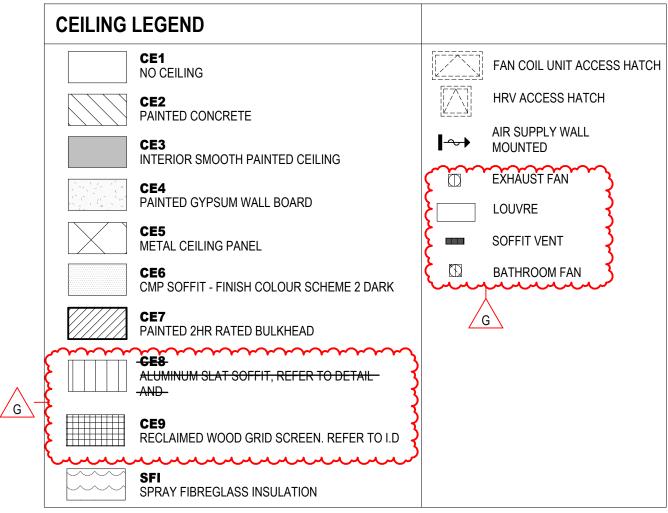





## ISSUED FOR

A 2022-06-24 BUILDING PERMIT APPLICATION

B 2022-09-29 BUILDING PERMIT APPLICATION **REVISION 1** 

C 2022-10-14 ISSUED FOR TENDER

D 2022-11-10 IFT ADDENDUM 2

E 2023-02-21 POST-TENDER ADDENDUM

F 2023-03-27 POST-TENDER ADDENDUM 02

G 2023-04-09 BUILDING PERMIT APPLICATION **REVISION 3** 

### 1. LOCATIONS OF LIGHTING FIXTURES AND MECHANICAL GRILLE ARE

DIMENSIONED FROM THE CENTRE LINES OF FIXTURE & GRILL TO FACE OF STUD OR FACE OF STRUCTURE UNLESS NOTED OTHERWISE.

2. REFER TO MECHANICAL AND ELECTRICAL FOR DETAIL AND

**GENERAL NOTES - CEILING PLANS** 

3. REFER TO FINISH SCHEDULE FOR FINISH DETAILS.

4. ALL SUSPENDED GWB CEILINGS TO BE LATERALLY BRACED TO THE STRUCTURE.

5. SPRAY FOAM INSULATION TO EXTEND 3' - 4" BEYOND HEATED SPACE

6. CORRIDOR CEILING HEIGHT ON LEVEL 2 AS NOTED, CORRIDOR CEILING

HEIGHT ON LEVEL 3 AND 4 7'9".

7. REFER TO A-700 SERIES FOR DETAILED UNIT PLANS AND DIMENSIONS 8. SPRINKLER HEADS/COVERS TO MATCH SOFFIT COLOUR AND MATERIAL,

9. PAINT SPRINKLER PIPING TO MATCH PAINTED CEILINGS AND WALLS

## **LEGEND**

CEILING MATERIALS / FINISHES

WHERE EXPOSED TO VIEW, TYP.

CEILING MATERIAL / FINISHES **CEILING ASSEMBLY TAG** CLEAR FINISH HEIGHT


SEE ALSO ROOM FINISH SCHEDULE


## **CEILING LIGHT LEGEND**

PENDANT LIGHT

— — LED COVE STRIP LIGHT

## TYPICAL LIGHTING CONFIGURATIONS

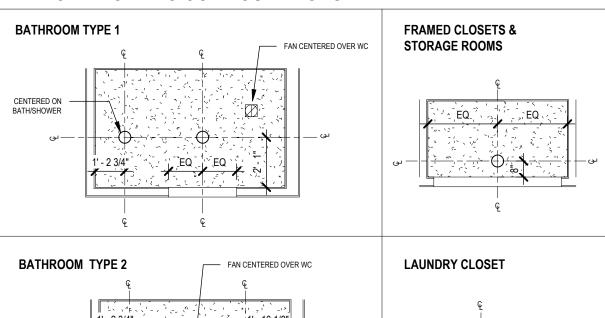

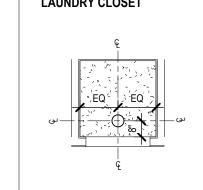

**IMPERIAL** 

THIS DRAWING IS COPYRIGHTED AND MUST NOT BE USED, REPRODUCED, OR REVISED WITHOUT WRITTEN PERMISSION.

ALL DIMENSIONS ARE IN FEET AND INCHES UNLESS OTHERWISE VERIFY DIMENSIONS. DO NOT SCALE THIS DRAWING.

REPORT INCONSISTENCIES AND OMISSIONS TO THE CONSULTANT

FOR CLARIFICATION BEFORE COMMENCING WITH THE WORK. DEVIATIONS FROM THE CONTRACT DOCUMENTS WITHOUT WRITTEN APPROVAL FROM THE CONSULTANT ARE SUBJECT TO CORRECTION AT THE CONTRACTOR'S EXPENSE.

**ARCHITECT** 

BONIFACE OLEKSIUK POLITANO ARCHITECTS 180-510 NICOLA STREET VANCOUVER BC, V6G 3J7 Tel: 236.521.6568 Email: info@bop.ca

RECESSED DOWNLIGHT SURFACE DOWNLIGHT SEE ELECTRICAL FOR LIGHT FIXTURE TYPE WALL MOUNTED LIGHT

SURFACE LINEAR STRIP LIGHT RECESSED LINEAR STRIP LIGHT SURFACE TRACK LIGHT

SEAL

## NORTHERN JUNK

1314 WHARF STREET


CEILING PLAN - LEVEL 2-4


DRAWN: LM CHECKED: SO/AP PLOT DATE: 2023-04-07 8:05:03 PM

A-303

LEVEL 02 RCP SCALE: 1/8" = 1'-0"



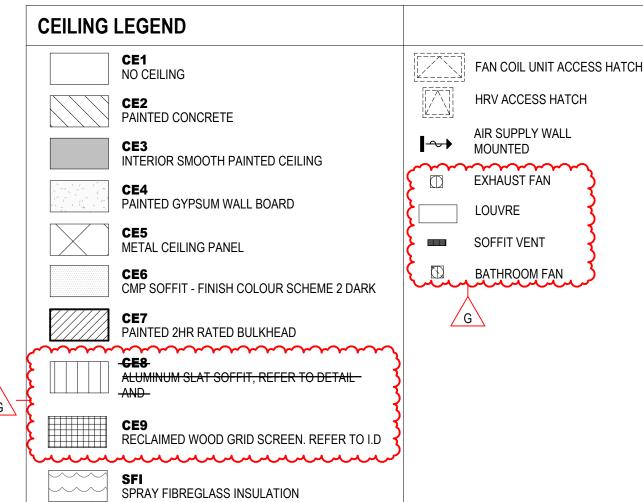

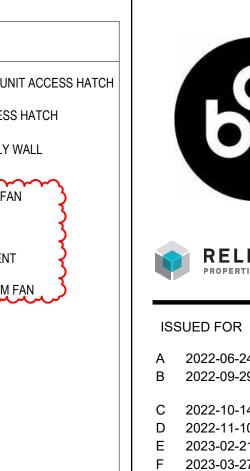

### **GENERAL NOTES - CEILING PLANS**

1. LOCATIONS OF LIGHTING FIXTURES AND MECHANICAL GRILLE ARE DIMENSIONED FROM THE CENTRE LINES OF FIXTURE & GRILL TO FACE OF STUD OR FACE OF STRUCTURE UNLESS NOTED OTHERWISE. 2. REFER TO MECHANICAL AND ELECTRICAL FOR DETAIL AND

3. REFER TO FINISH SCHEDULE FOR FINISH DETAILS.

4. ALL SUSPENDED GWB CEILINGS TO BE LATERALLY BRACED TO THE STRUCTURE.

5. SPRAY FOAM INSULATION TO EXTEND 3' - 4" BEYOND HEATED SPACE

6. CORRIDOR CEILING HEIGHT ON LEVEL 2 AS NOTED, CORRIDOR CEILING HEIGHT ON LEVEL 3 AND 4 7'9".

7. REFER TO A-700 SERIES FOR DETAILED UNIT PLANS AND DIMENSIONS 8. SPRINKLER HEADS/COVERS TO MATCH SOFFIT COLOUR AND MATERIAL,

9. PAINT SPRINKLER PIPING TO MATCH PAINTED CEILINGS AND WALLS WHERE EXPOSED TO VIEW, TYP.

### LEGEND

CEILING MATERIALS / FINISHES CEILING MATERIAL / FINISHES **CEILING ASSEMBLY TAG** 

CLEAR FINISH HEIGHT

SEE ALSO ROOM FINISH SCHEDULE

## **CEILING LIGHT LEGEND**


— — LED COVE STRIP LIGHT

PENDANT LIGHT RECESSED DOWNLIGHT SURFACE DOWNLIGHT WALL MOUNTED LIGHT SURFACE LINEAR STRIP LIGHT RECESSED LINEAR STRIP LIGHT SURFACE TRACK LIGHT

SEE ELECTRICAL FOR LIGHT FIXTURE TYPE

## TYPICAL LIGHTING CONFIGURATIONS

LEVEL 5 RCP SCALE: 1/8" = 1'-0"

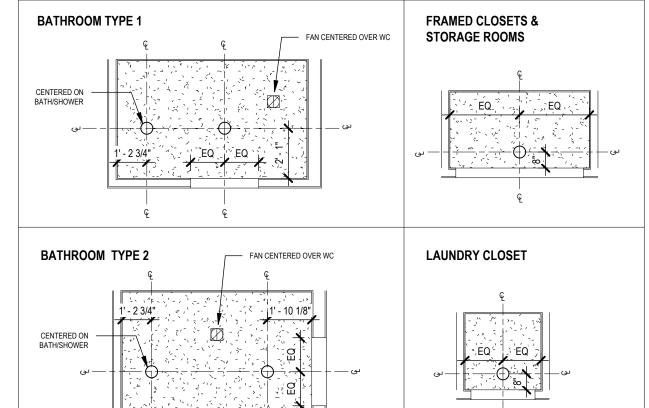





**Boniface** 

Oleksiuk Politano

**Architects** 

PROPERTIES LTD.

A 2022-06-24 BUILDING PERMIT APPLICATION

B 2022-09-29 BUILDING PERMIT APPLICATION **REVISION 1** 

C 2022-10-14 ISSUED FOR TENDER D 2022-11-10 IFT ADDENDUM 2

E 2023-02-21 POST-TENDER ADDENDUM

F 2023-03-27 POST-TENDER ADDENDUM 02

G 2023-04-09 BUILDING PERMIT APPLICATION **REVISION 3** 

### **IMPERIAL**

THIS DRAWING IS COPYRIGHTED AND MUST NOT BE USED, REPRODUCED, OR REVISED WITHOUT WRITTEN PERMISSION.

ALL DIMENSIONS ARE IN FEET AND INCHES UNLESS OTHERWISE VERIFY DIMENSIONS.

DO NOT SCALE THIS DRAWING.

REPORT INCONSISTENCIES AND OMISSIONS TO THE CONSULTANT FOR CLARIFICATION BEFORE COMMENCING WITH THE WORK.

DEVIATIONS FROM THE CONTRACT DOCUMENTS WITHOUT WRITTEN APPROVAL FROM THE CONSULTANT ARE SUBJECT TO CORRECTION AT THE CONTRACTOR'S EXPENSE.

## **ARCHITECT**

BONIFACE OLEKSIUK POLITANO ARCHITECTS 180-510 NICOLA STREET VANCOUVER BC, V6G 3J7 Tel: 236.521.6568 Email: info@bop.ca

This document has been digitally certified with digital certificate and encryption technology authorized by the Architectural Institute of BC and the Engineers and Geoscientists BC. The authoritative original has been transmitted to you in digital form. Any printed version can be relied upon as a true copy of the original when supplied by the architect, bearing images of the professional seal and digital certificate, or when printed from the digitally-certified electronic file provided by the architect.

SEAL




## NORTHERN JUNK


1314 WHARF STREET

CEILING PLAN - LEVEL

CHECKED: SO/AP DRAWN: LM PLOT DATE: 2023-04-07 8:05:05 PM

19004C

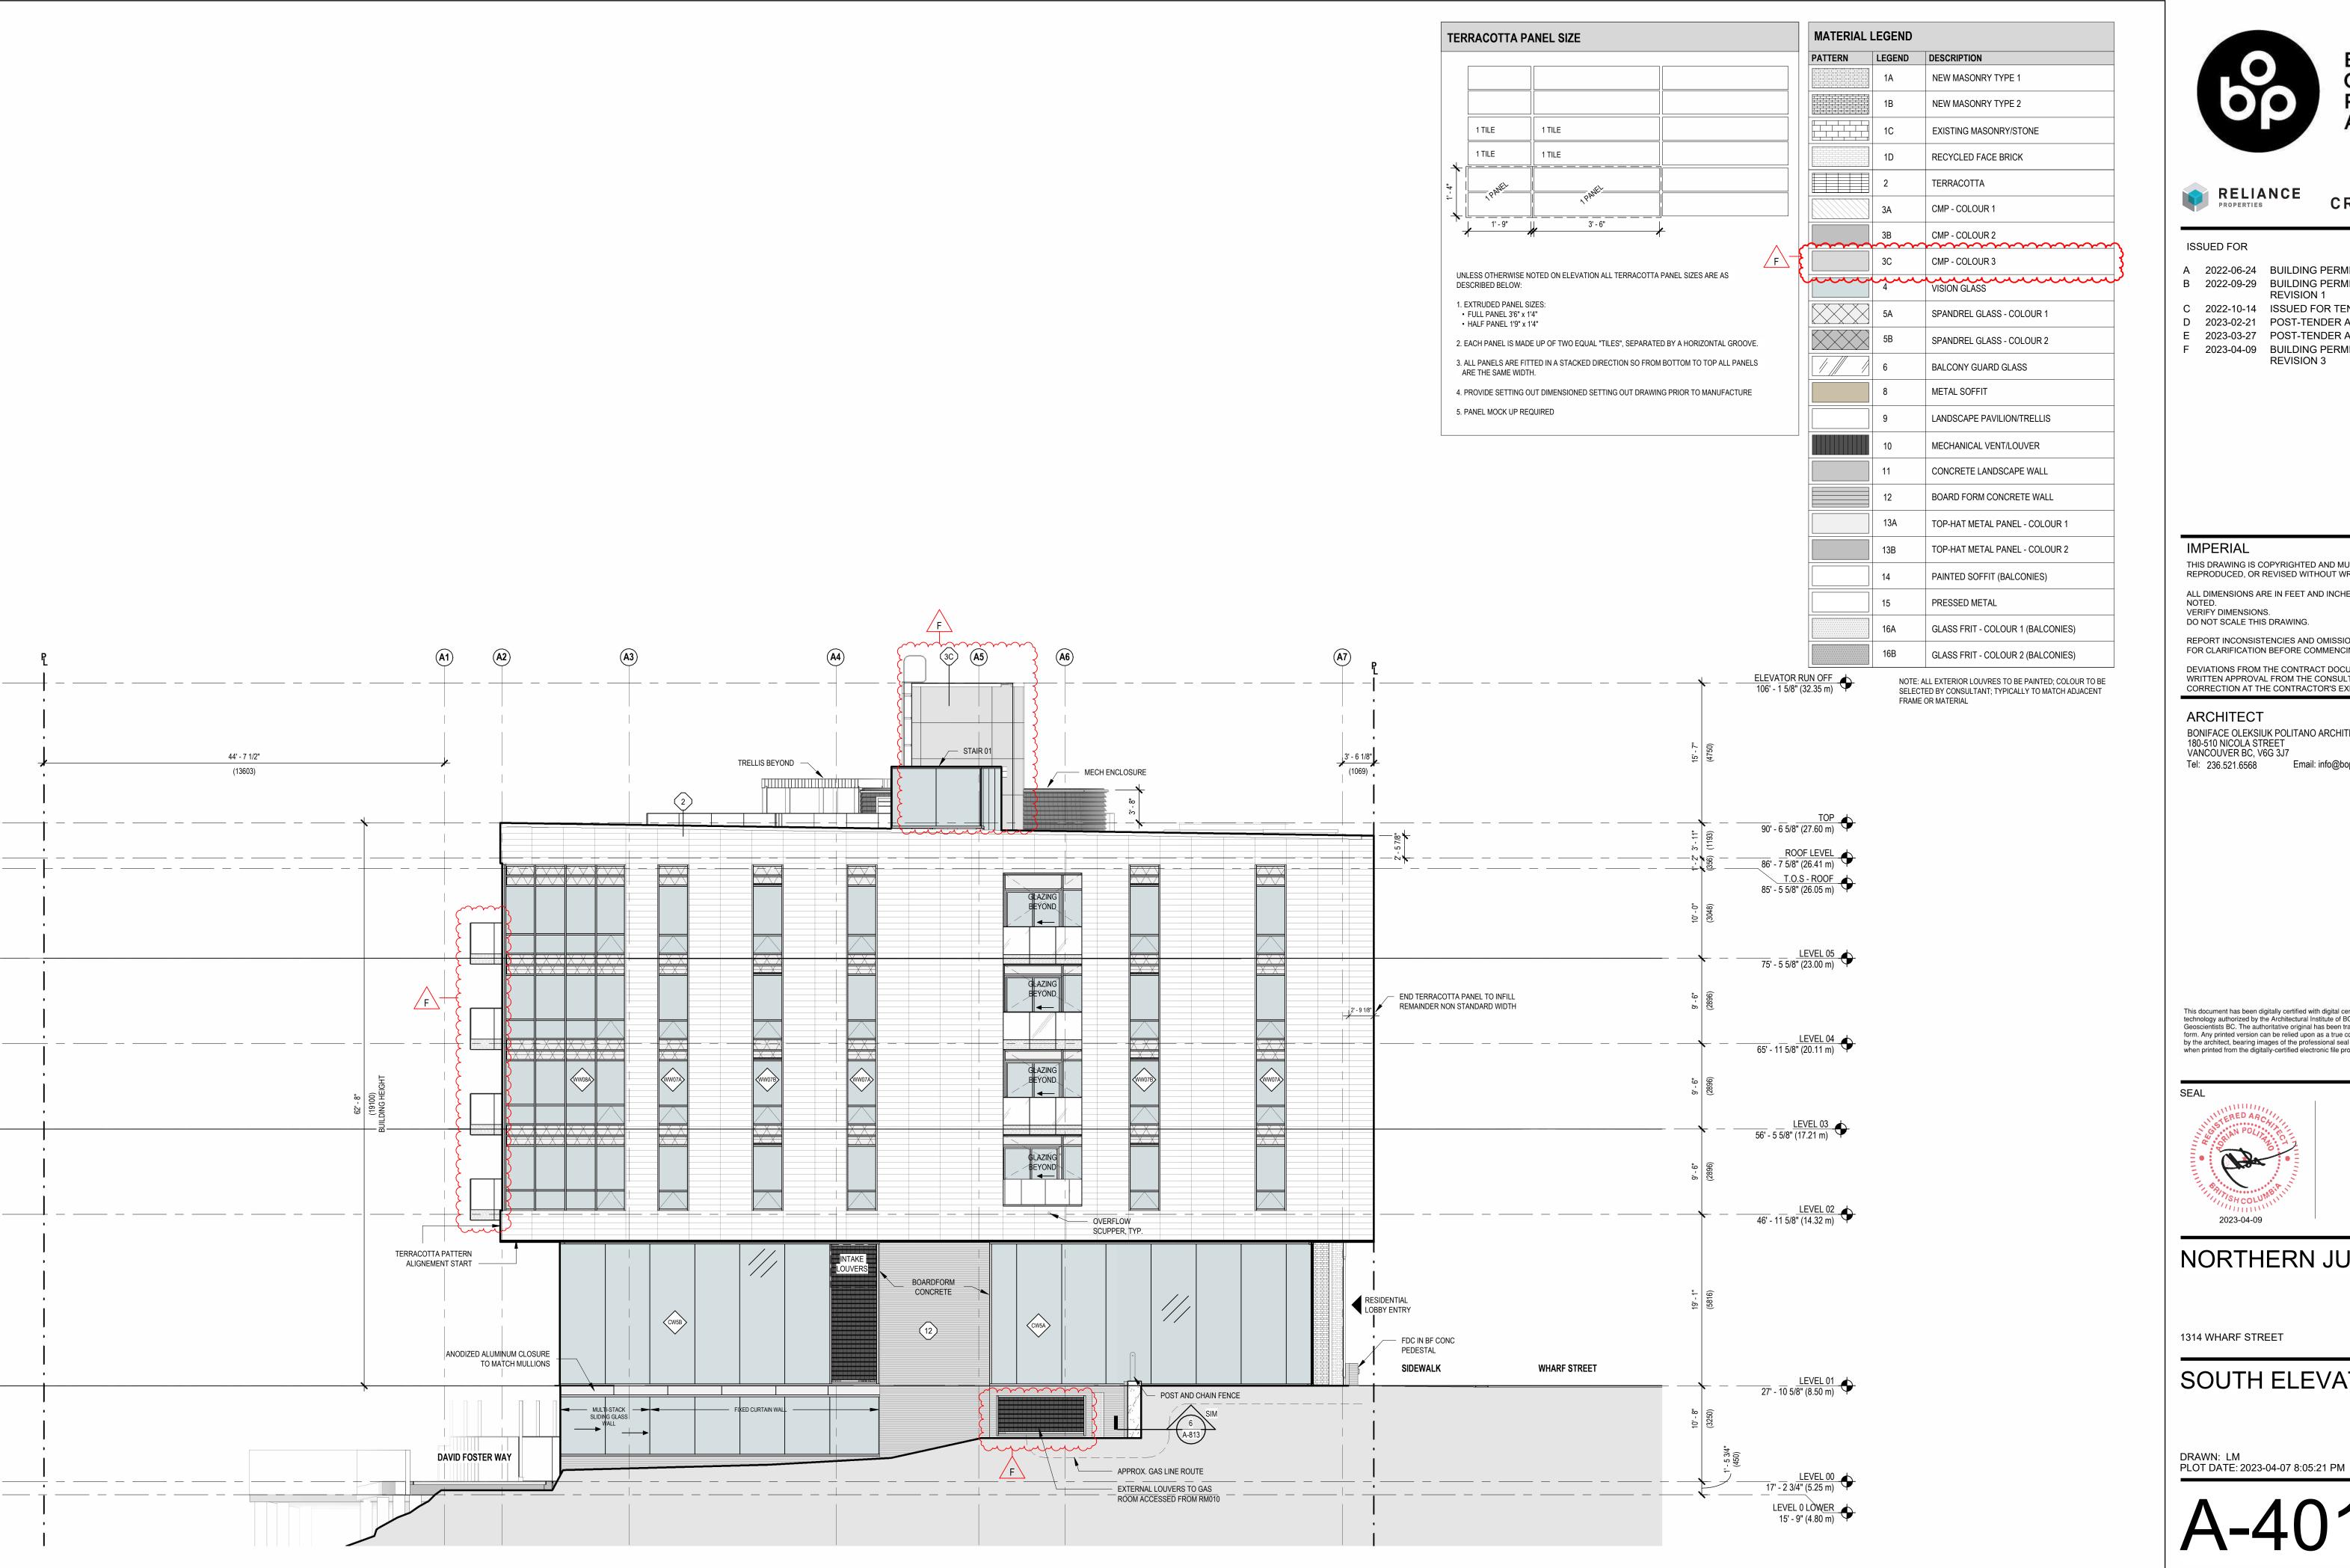

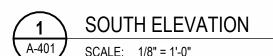





### ISSUED FOR

A 2022-06-24 BUILDING PERMIT APPLICATION B 2022-09-29 BUILDING PERMIT APPLICATION

PROPERTIES LTD.

- **REVISION 1**
- C 2022-10-14 ISSUED FOR TENDER
- D 2023-02-21 POST-TENDER ADDENDUM
- E 2023-03-27 POST-TENDER ADDENDUM 02
- F 2023-04-09 BUILDING PERMIT APPLICATION

## **REVISION 3**

### **IMPERIAL**

THIS DRAWING IS COPYRIGHTED AND MUST NOT BE USED, REPRODUCED, OR REVISED WITHOUT WRITTEN PERMISSION.

ALL DIMENSIONS ARE IN FEET AND INCHES UNLESS OTHERWISE VERIFY DIMENSIONS.

DO NOT SCALE THIS DRAWING. REPORT INCONSISTENCIES AND OMISSIONS TO THE CONSULTANT FOR CLARIFICATION BEFORE COMMENCING WITH THE WORK.

DEVIATIONS FROM THE CONTRACT DOCUMENTS WITHOUT WRITTEN APPROVAL FROM THE CONSULTANT ARE SUBJECT TO CORRECTION AT THE CONTRACTOR'S EXPENSE.

### ARCHITECT BONIFACE OLEKSIUK POLITANO ARCHITECTS 180-510 NICOLA STREET

VANCOUVER BC, V6G 3J7 Tel: 236.521.6568 Email: info@bop.ca

This document has been digitally certified with digital certificate and encryption technology authorized by the Architectural Institute of BC and the Engineers and Geoscientists BC. The authoritative original has been transmitted to you in digital form. Any printed version can be relied upon as a true copy of the original when supplied by the architect, bearing images of the professional seal and digital certificate, or when printed from the digitally-certified electronic file provided by the architect.

SEAL




## **NORTHERN JUNK**

1314 WHARF STREET

## SOUTH ELEVATION

CHECKED: SO/AP DRAWN: LM

19004C

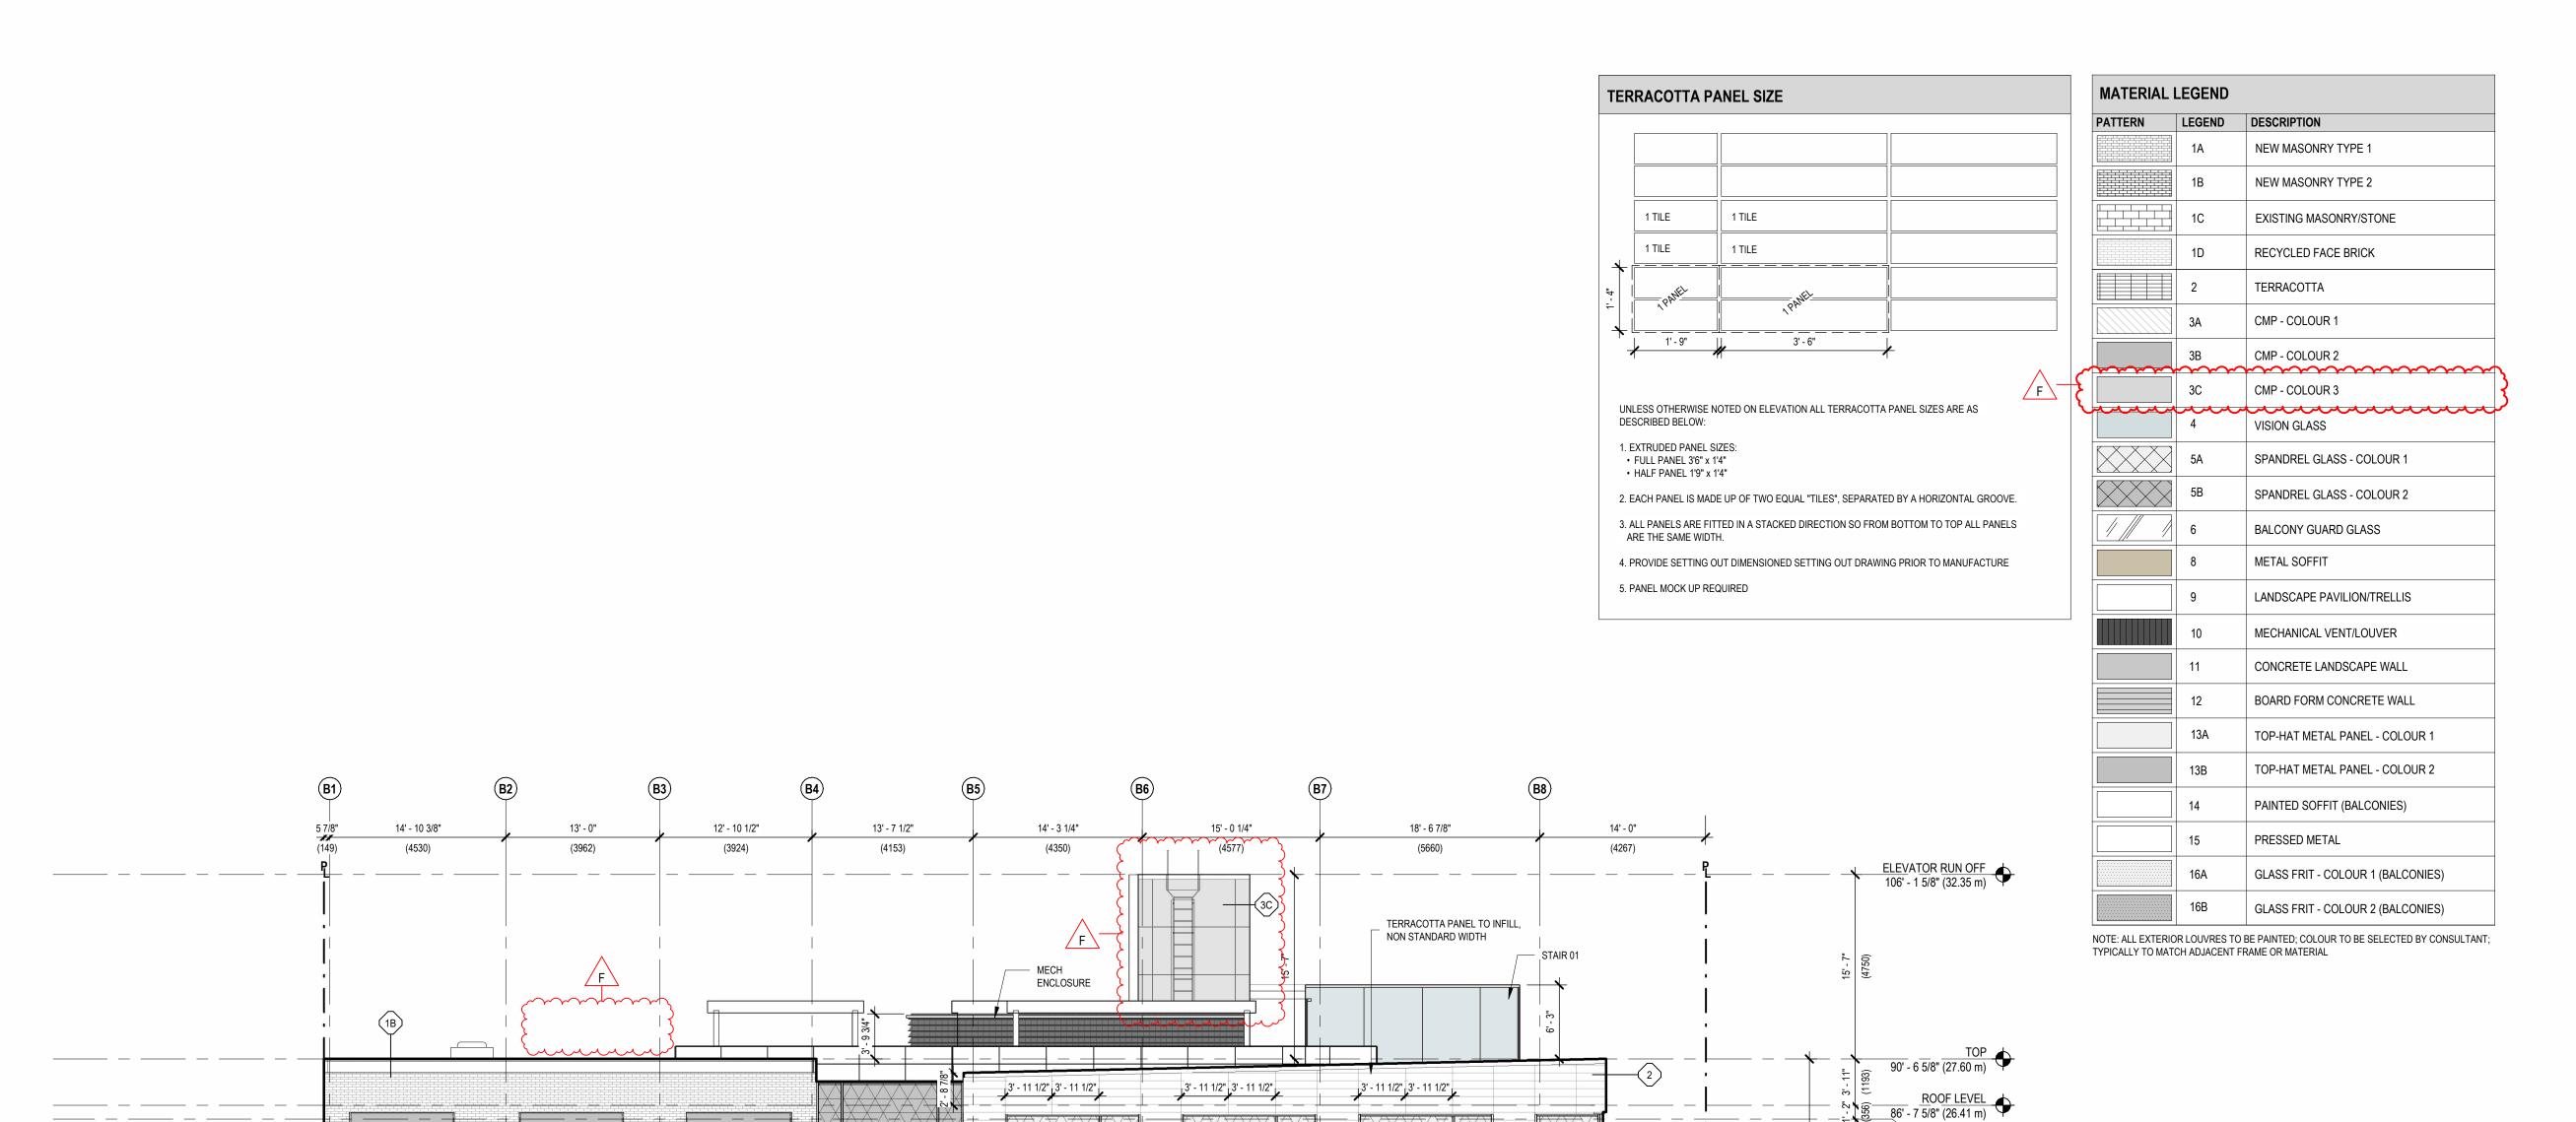

BALCONY METAL COMPONENTS AND SOFFIT TO MATCH ADJACENT WINDOW WALL COLOUR SCHEME 2 (DARK)

TYPICAL FOR WW11 ON WEST ELEVATION

METAL TO MATCH WINDOW WALL FINISH -ABOVE. COLOUR SCHEME 2 DARK

EXISTING PARKING LOT

GLAZED WINDSCREEN (TYP).

CRU ENTRANCE

CATENARY LIGHTING WALL BRACKET

001

CRU ENTRANCE

FRASER WAREHOUSE

(W004)

CATENARY LIGHTING

A-841

WALL BRACKET

CAIRE & GRANCINI WAREHOUSE ———





### ISSUED FOR

A 2022-06-24 BUILDING PERMIT APPLICATION

PROPERTIES LTD.

- B 2022-09-29 BUILDING PERMIT APPLICATION **REVISION 1**
- C 2022-10-14 ISSUED FOR TENDER
- D 2022-11-10 IFT ADDENDUM 2
- E 2023-02-21 POST-TENDER ADDENDUM
- F 2023-04-09 BUILDING PERMIT APPLICATION **REVISION 3**

**IMPERIAL** 

THIS DRAWING IS COPYRIGHTED AND MUST NOT BE USED, REPRODUCED, OR REVISED WITHOUT WRITTEN PERMISSION.

ALL DIMENSIONS ARE IN FEET AND INCHES UNLESS OTHERWISE VERIFY DIMENSIONS.

DO NOT SCALE THIS DRAWING. REPORT INCONSISTENCIES AND OMISSIONS TO THE CONSULTANT

FOR CLARIFICATION BEFORE COMMENCING WITH THE WORK.

DEVIATIONS FROM THE CONTRACT DOCUMENTS WITHOUT WRITTEN APPROVAL FROM THE CONSULTANT ARE SUBJECT TO CORRECTION AT THE CONTRACTOR'S EXPENSE.

### ARCHITECT BONIFACE OLEKSIUK POLITANO ARCHITECTS 180-510 NICOLA STREET VANCOUVER BC, V6G 3J7

Tel: 236.521.6568 Email: info@bop.ca

This document has been digitally certified with digital certificate and encryption technology authorized by the Architectural Institute of BC and the Engineers and Geoscientists BC. The authoritative original has been transmitted to you in digital form. Any printed version can be relied upon as a true copy of the original when supplied by the architect, bearing images of the professional seal and digital certificate, or when printed from the digitally-certified electronic file provided by the architect.

SEAL

T.O.S - ROOF 85' - 5 5/8" (26.05 m)

75' - 5 5/8" (23.00 m)

65' - 11 5/8" (20.11 m)

56' - 5 5/8" (17.21 m)

46' - 11 5/8" (14.32 m)

27' - 10 5/8" (8.50 m)

17' - 2 3/4" (5.25 m)

LEVEL 0 LOWER 15' - 9" (4.80 m)

WEST ELEVATION

A-402 SCALE: 1/8" = 1'-0"

BALCONY METAL COMPONENTS AND SOFFIT TO MATCH ADJACENT WINDOW WALL COLOUR SCHEME 1 (LIGHT) TYPICAL FOR WW09 ON WEST ELEVATION

> TERRACOTTA PATTERN ALIGNEMENT START

ANODIZED ALUMINUM CLOSURE TO MATCH MULLIONS

──── MULTI STACK SLIDING

GLASS WALL

CURTAIN

CRU ENTRANCE




## NORTHERN JUNK


1314 WHARF STREET

## WEST ELEVATION

DRAWN: LM CHECKED: SO/AP PLOT DATE: 2023-04-07 8:05:32 PM

19004C

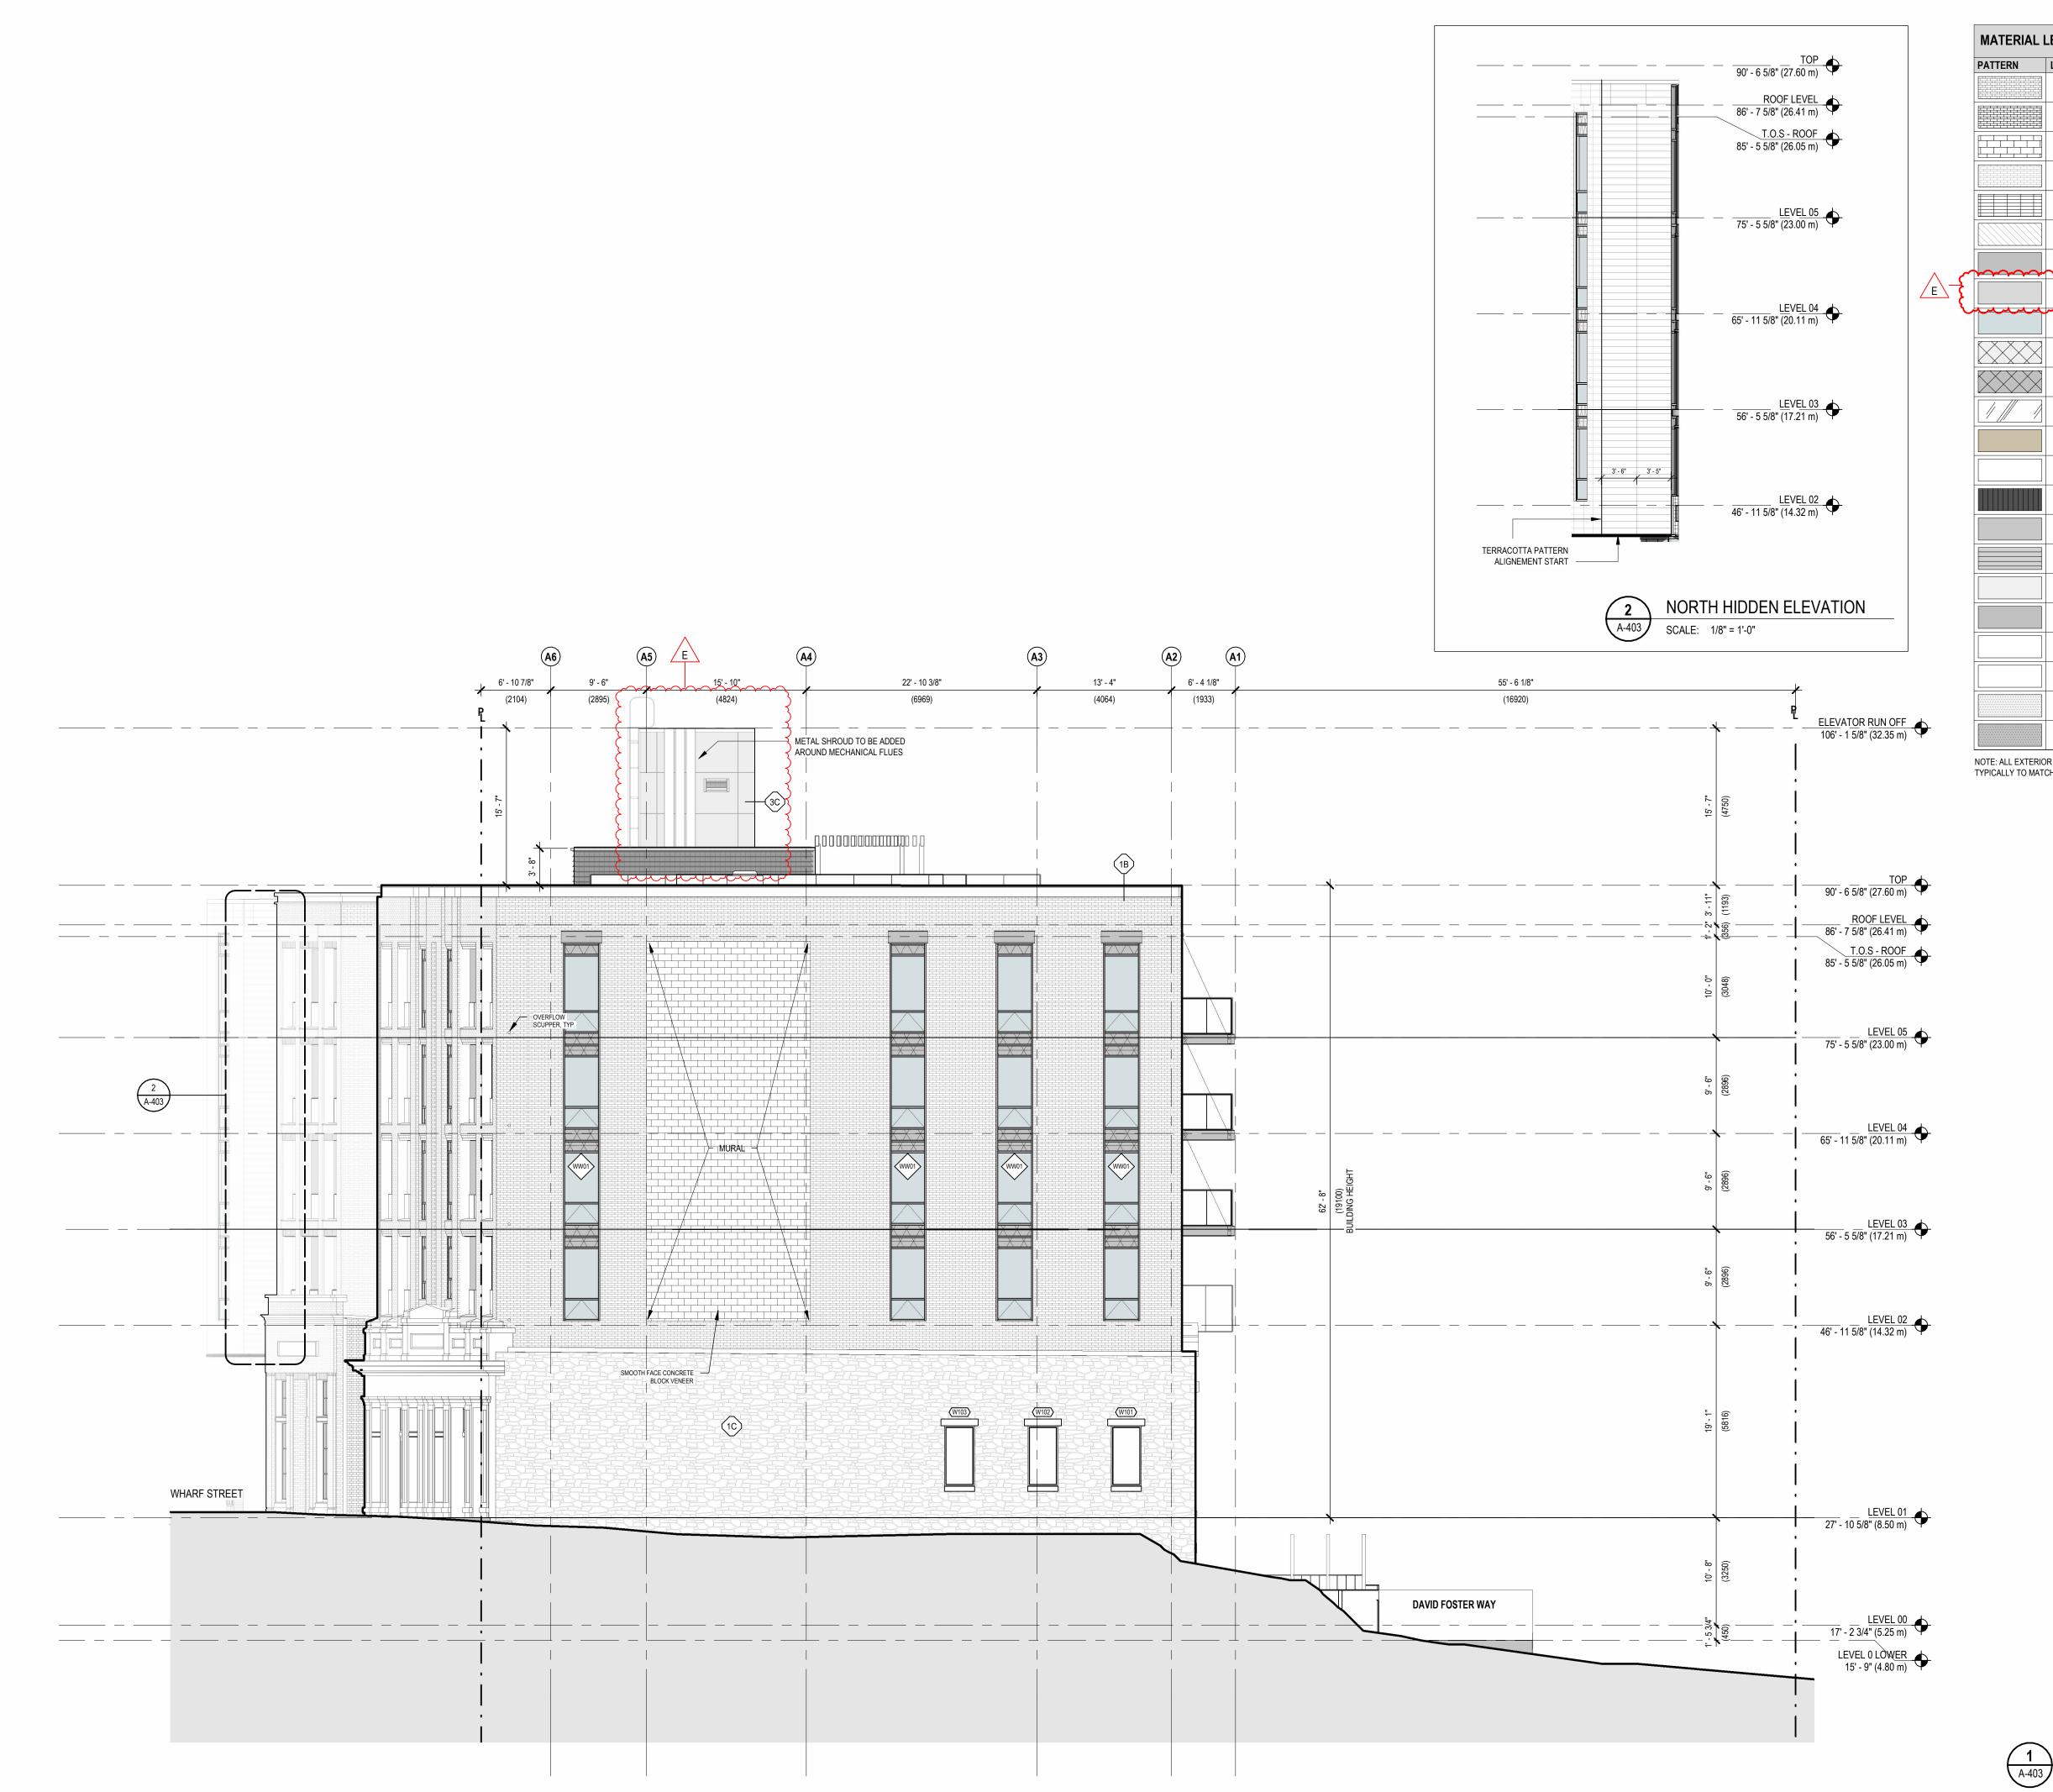

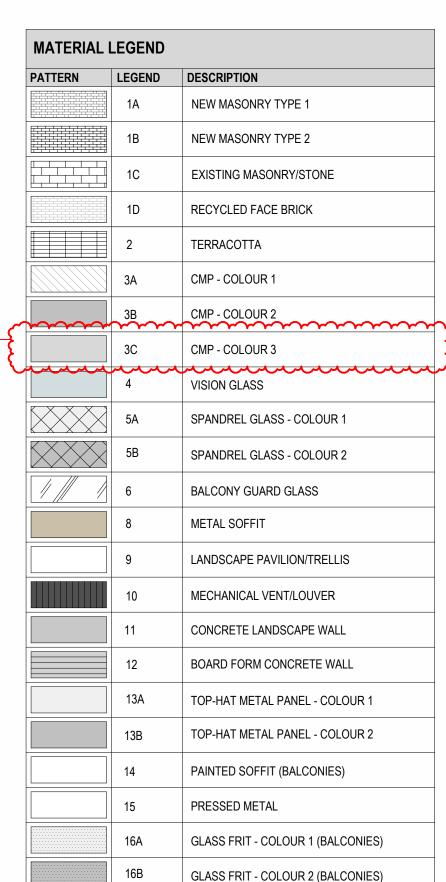

NOTE: ALL EXTERIOR LOUVRES TO BE PAINTED; COLOUR TO BE SELECTED BY CONSULTANT; TYPICALLY TO MATCH ADJACENT FRAME OR MATERIAL

NORTH ELEVATION



Boniface Oleksiuk Politano Architects

CROSSTOWN

PROPERTIES LTD.



## PROPERTIES

22-06-24 BUILDING PERMIT APPLICATION

## ISSUED FOR

- A 2022-06-24 BUILDING PERMIT APPLICATION
  B 2022-09-29 BUILDING PERMIT APPLICATION
  - 22-09-29 BUILDING PERMIT *F* REVISION 1
- C 2022-10-14 ISSUED FOR TENDER
- D 2023-02-21 POST-TENDER ADDENDUM

E 2023-04-09 BUILDING PERMIT APPLICATION REVISION 3

### **IMPERIAL**

THIS DRAWING IS COPYRIGHTED AND MUST NOT BE USED, REPRODUCED, OR REVISED WITHOUT WRITTEN PERMISSION.

ALL DIMENSIONS ARE IN FEET AND INCHES UNLESS OTHERWISE NOTED.
VERIFY DIMENSIONS.

REPORT INCONSISTENCIES AND OMISSIONS TO THE CONSULTANT FOR CLARIFICATION BEFORE COMMENCING WITH THE WORK.

DEVIATIONS FROM THE CONTRACT DOCUMENTS WITHOUT WRITTEN APPROVAL FROM THE CONSULTANT ARE SUBJECT TO CORRECTION AT THE CONTRACTOR'S EXPENSE.

## ARCHITECT BONIFACE OLEKSIUK POLITANO ARCHITECTS 180-510 NICOLA STREET

DO NOT SCALE THIS DRAWING.

180-510 NICOLA STREET VANCOUVER BC, V6G 3J7 Tel: 236.521.6568 Email: info@bop.ca

This document has been digitally certified with digital certificate and encryption technology authorized by the Architectural Institute of BC and the Engineers and Geoscientists BC. The authoritative original has been transmitted to you in digital form. Any printed version can be relied upon as a true copy of the original when supplied by the architect, bearing images of the professional seal and digital certificate, or when printed from the digitally-certified electronic file provided by the architect.

SEAL



## NORTHERN JUNK


1314 WHARF STREET

## NORTH ELEVATION

DRAWN: LM CHECKED: SO/AP PLOT DATE: 2023-04-07 8:05:44 PM

A-403

19004C

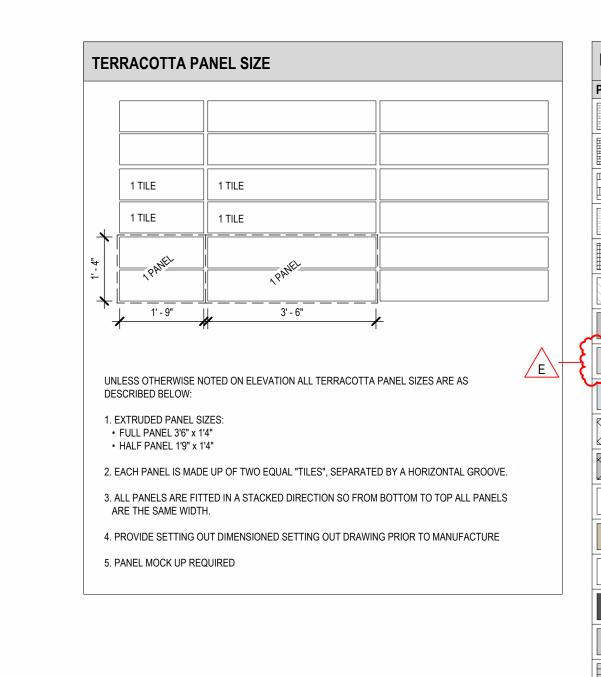

REFER TO NORTH ELEVATION REF.1/A-403

105

CRU ENTRANCE EMERGENCY EXIT

W106

A-405

FRASER WAREHOUSE

106

CRU ENTRANCE

(W107)

\_\_\_\_\_ STAIR 01

RES LOBBY ENTRANCE

NON STANDARD TERACOTTA PANEL SIZE

TERRACOTTA PATTERN ALIGNEMENT START

> FDC IN BF CONC • PEDESTAL -

> > 6 A-816

MECH ENCLOSURE

ALLEY ENTRANCE

2 A-405

CAIRE & GRANCINI WAREHOUSE -

ELEVATOR RUN OFF 106' - 1 5/8" (32.35 m)

90' - 6 5/8" (27.60 m)

ROOF LEVEL 86' - 7 5/8" (26.41 m)

T.O.S - ROOF 85' - 5 5/8" (26.05 m)

\_\_\_\_\_\_<u>LEVEL 05</u> 75' - 5 5/8" (23.00 m)


LEVEL 04 65' - 11 5/8" (20.11 m)

\_\_\_\_\_\_LEVEL 02 46' - 11 5/8" (14.32 m)

27' - 10 5/8" (8.50 m)

17' - 2 3/4" (5.25 m)

LEVEL 0 LOWER 15' - 9" (4.80 m)

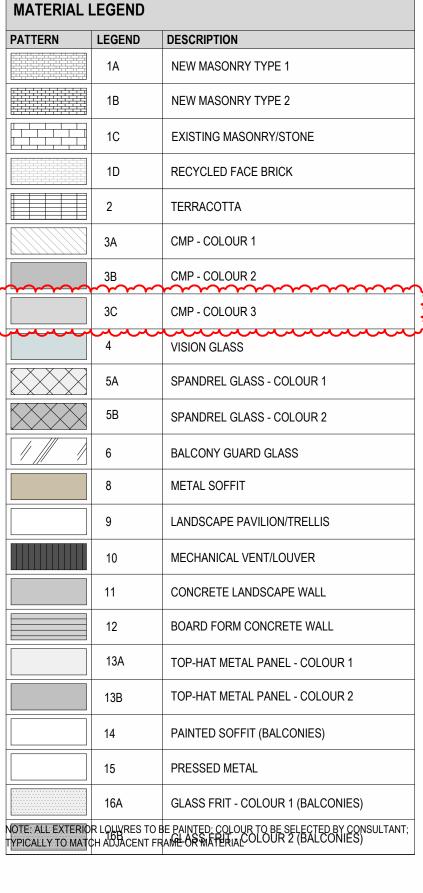







## ISSUED FOR

A 2022-06-24 BUILDING PERMIT APPLICATION B 2022-09-29 BUILDING PERMIT APPLICATION

PROPERTIES LTD.

**REVISION 1** 

C 2022-10-14 ISSUED FOR TENDER

D 2023-02-21 POST-TENDER ADDENDUM E 2023-04-09 BUILDING PERMIT APPLICATION **REVISION 3** 

### **IMPERIAL**

THIS DRAWING IS COPYRIGHTED AND MUST NOT BE USED, REPRODUCED, OR REVISED WITHOUT WRITTEN PERMISSION.

ALL DIMENSIONS ARE IN FEET AND INCHES UNLESS OTHERWISE VERIFY DIMENSIONS. DO NOT SCALE THIS DRAWING.

REPORT INCONSISTENCIES AND OMISSIONS TO THE CONSULTANT FOR CLARIFICATION BEFORE COMMENCING WITH THE WORK.

DEVIATIONS FROM THE CONTRACT DOCUMENTS WITHOUT WRITTEN APPROVAL FROM THE CONSULTANT ARE SUBJECT TO CORRECTION AT THE CONTRACTOR'S EXPENSE.

### **ARCHITECT** BONIFACE OLEKSIUK POLITANO ARCHITECTS 180-510 NICOLA STREET

VANCOUVER BC, V6G 3J7 Tel: 236.521.6568 Email: info@bop.ca

This document has been digitally certified with digital certificate and encryption technology authorized by the Architectural Institute of BC and the Engineers and Geoscientists BC. The authoritative original has been transmitted to you in digital form. Any printed version can be relied upon as a true copy of the original when supplied by the architect, bearing images of the professional seal and digital certificate, or when printed from the digitally-certified electronic file provided by the architect.

SEAL



## NORTHERN JUNK


1314 WHARF STREET

## EAST ELEVATION

CHECKED: SO/AP DRAWN: LM PLOT DATE: 2023-04-07 8:05:55 PM





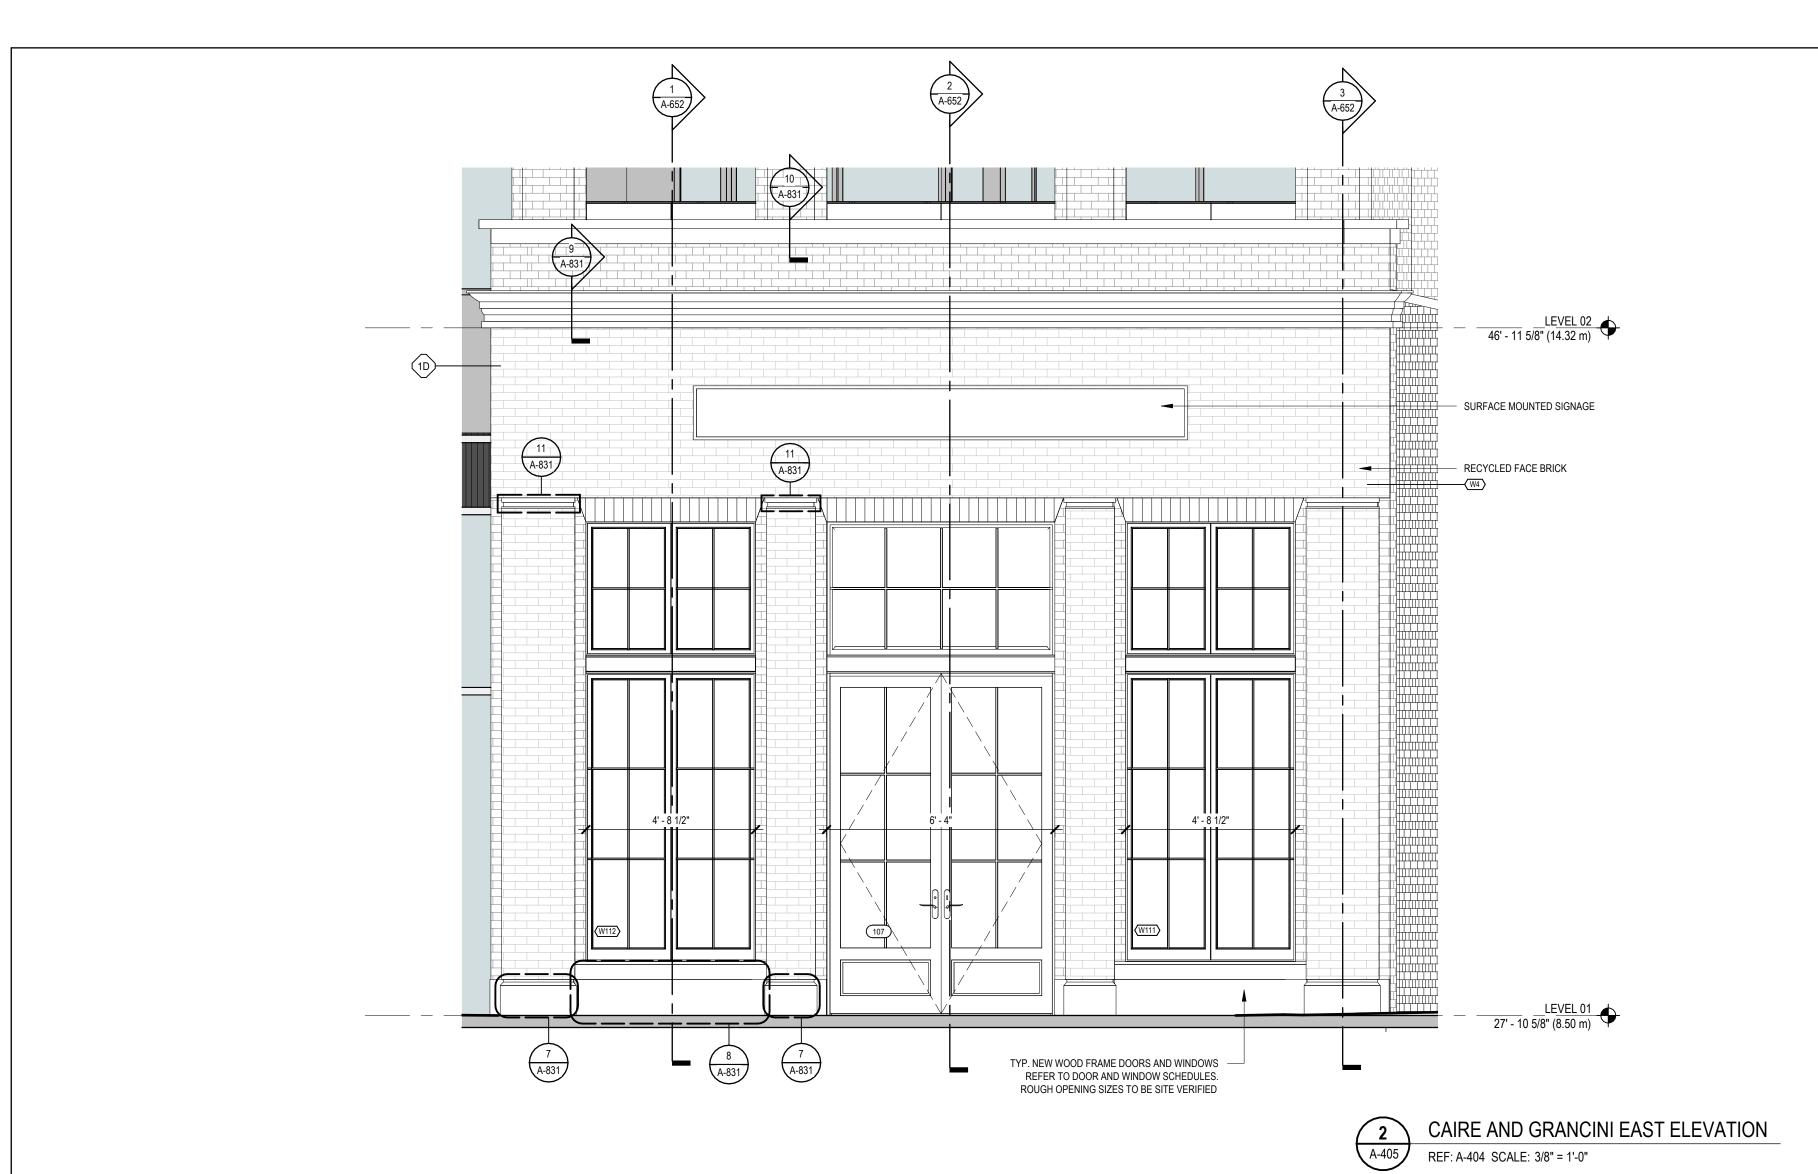

TYP. NEW WOOD FRAME DOORS AND WINDOWS REFER TO DOOR AND WINDOW SCHEDULES. ROUGH OPENING SIZES TO BE SITE VERIFIED

KEY VALUE	DESCRIPTOR								
H-01	RETAIN AND REAPIR CONCRETE STEPPED PARAPET AND CENTRAL TRIANGULAR TERMINATION.								
H-02	RETAIN AND REPAIR ALL FOUR STONE PILASTERS ALONG THE UPPER PARAPET USING AN APPROVED JAHN PRODUCT.								
H-03	REINSTATE BOTH PILASTERS WITH NEW SANDSTONE OR AN APPROVED JAHN PRODUCT TO REPLICATE THE OTHER FOUR PILASTERS IN THE UPPER PARAPET.								
H-04	RETAIN AND REPAIR MOULDED STONE PANELS AND BASE. WATER REPELLENT COATING COULD BE USED, FURTHER RESEARCH REQ'D.								
H-05	RETAIN AND REPAIR MOULDED STONE PANELS AND BASE, WHILE PROTECTING CARVED LETTERS. WATER REPELLENT COATING COULD BE USED, FURTHER RESEARCH REQ'D.								
H-06	RETAIN AND REPAIR MOULDED STONE PANELS AND BASE, WHILE PROTECTING CARVED LETTERS. WATER REPELLENT COATING COULD BE USED, FURTHER RESEARCH REQ'D								
H-07	RETAIN AND REPAIR ALL MOULDED STONE PILASTERS AND RAISED BASES.								
H-08	REINSTATE MOULDED SANDSTONE PILASTERS BY USING EXISTING STONE PILASTERS AS PHYSICAL EVIDENCE TO DUPLICATE IN ITS ENTIERTY.								
H-09	REINSTATE MOULDED SANDSTONE PILASTERS BY USING EXISTING STONE PILASTERS AS PHYSICAL EVIDENCE TO DUPLICATE IN ITS ENTIERTY.								
H-10	RETAIN AND PROTECT WITH A WATERPROOF AND BREATHABLE COATING. PRIOR TO BEING COVERED WITH NEW BUILT-UP CORNICE.								
H-11	RETAIN AND REAPIR EXISTING SANDSTONE FRIEZE.								
H-12	RETAIN AND REPAIR THE SANDSTONE MOULDINGS AND REINSTATE THE CAPITALS THAT TERMINATE EACH PILASTER. USE A JAHN PRODUCT TO REINSTATE PROFILE AND APPEARANCE TO REPLICATE PHYSICAL EVIDENCE.								
H-13	REINSTATE THE MOULDED CAPITALS THAT REPLICATE THE PHYSICAL EVIDENCE OF THE EXISTING SANDSTONE MOULDINGS USING A JAHN PRODUCT TO DUPLICATE IN ITS ENTIERTY.								

PATTERN	LEGEND	DESCRIPTION
	1A	NEW MASONRY TYPE 1
	1B	NEW MASONRY TYPE 2
	1C	EXISTING MASONRY/STONE
	1D	RECYCLED FACE BRICK
	2	TERRACOTTA
	3A	CMP - COLOUR 1
	3B	CMP - COLOUR 2
	3C	CMP - COLOUR 3
	4	VISION GLASS
	5A	SPANDREL GLASS - COLOUR 1
	5B	SPANDREL GLASS - COLOUR 2
1//////////////////////////////////////	6	BALCONY GUARD GLASS
	8	METAL SOFFIT
	9	LANDSCAPE PAVILION/TRELLIS
	10	MECHANICAL VENT/LOUVER
	11	CONCRETE LANDSCAPE WALL
	12	BOARD FORM CONCRETE WALL
	13A	TOP-HAT METAL PANEL - COLOUR 1
	13B	TOP-HAT METAL PANEL - COLOUR 2
	14	PAINTED SOFFIT (BALCONIES)
	15	PRESSED METAL
	16A	GLASS FRIT - COLOUR 1 (BALCONIES)





## CROSSTOWN

## ISSUED FOR

A 2022-09-29 BUILDING PERMIT APPLICATION **REVISION 1** 

PROPERTIES LTD.

- B 2022-10-14 ISSUED FOR TENDER
- C 2022-11-10 IFT ADDENDUM 2
- D 2023-04-09 BUILDING PERMIT APPLICATION **REVISION 3**

### **IMPERIAL**

THIS DRAWING IS COPYRIGHTED AND MUST NOT BE USED, REPRODUCED, OR REVISED WITHOUT WRITTEN PERMISSION.

ALL DIMENSIONS ARE IN FEET AND INCHES UNLESS OTHERWISE VERIFY DIMENSIONS. DO NOT SCALE THIS DRAWING.

REPORT INCONSISTENCIES AND OMISSIONS TO THE CONSULTANT FOR CLARIFICATION BEFORE COMMENCING WITH THE WORK.

DEVIATIONS FROM THE CONTRACT DOCUMENTS WITHOUT WRITTEN APPROVAL FROM THE CONSULTANT ARE SUBJECT TO CORRECTION AT THE CONTRACTOR'S EXPENSE.

ARCHITECT BONIFACE OLEKSIUK POLITANO ARCHITECTS 180-510 NICOLA STREET VANCOUVER BC, V6G 3J7

Tel: 236.521.6568 Email: info@bop.ca

TYP. REPAIR AS REQ'D AND RELAY EXISTING ——— CONCRETE CAPPINGS, WITH NEW FLASHING UNDERNEATH AS PER ARCHITECTURAL DETAILS
AND HERITAGE PROTOCOLS LEVEL 02 46' - 11 5/8" (14.32 m) NEW TUSCAN PROFILE CORNICE AS PER HERITAGE PROTOCOL 2 A-831 4 A-831 LOUVER PANEL FOR MECHANICAL DUCTING — LOUVER PANEL FOR MECHANICAL DUCTING 106 (W108) (W106) 27' - 10 5/8" (8.50 m) H-07

This document has been digitally certified with digital certificate and encryption technology authorized by the Architectural Institute of BC and the Engineers and Geoscientists BC. The authoritative original has been transmitted to you in digital form. Any printed version can be relied upon as a true copy of the original when supplied by the architect, bearing images of the professional seal and digital certificate, or when printed from the digitally-certified electronic file provided by the architect.

SEAL



## NORTHERN JUNK

1314 WHARF STREET

## **ENLARGED ELEVATIONS**

DRAWN: LM PLOT DATE: 2023-04-07 8:06:01 PM


CHECKED: SO/AP


A-405

19004C

FRASER WAREHOUSE EAST ELEVATION

REF: A-404 SCALE: 3/8" = 1'-0"

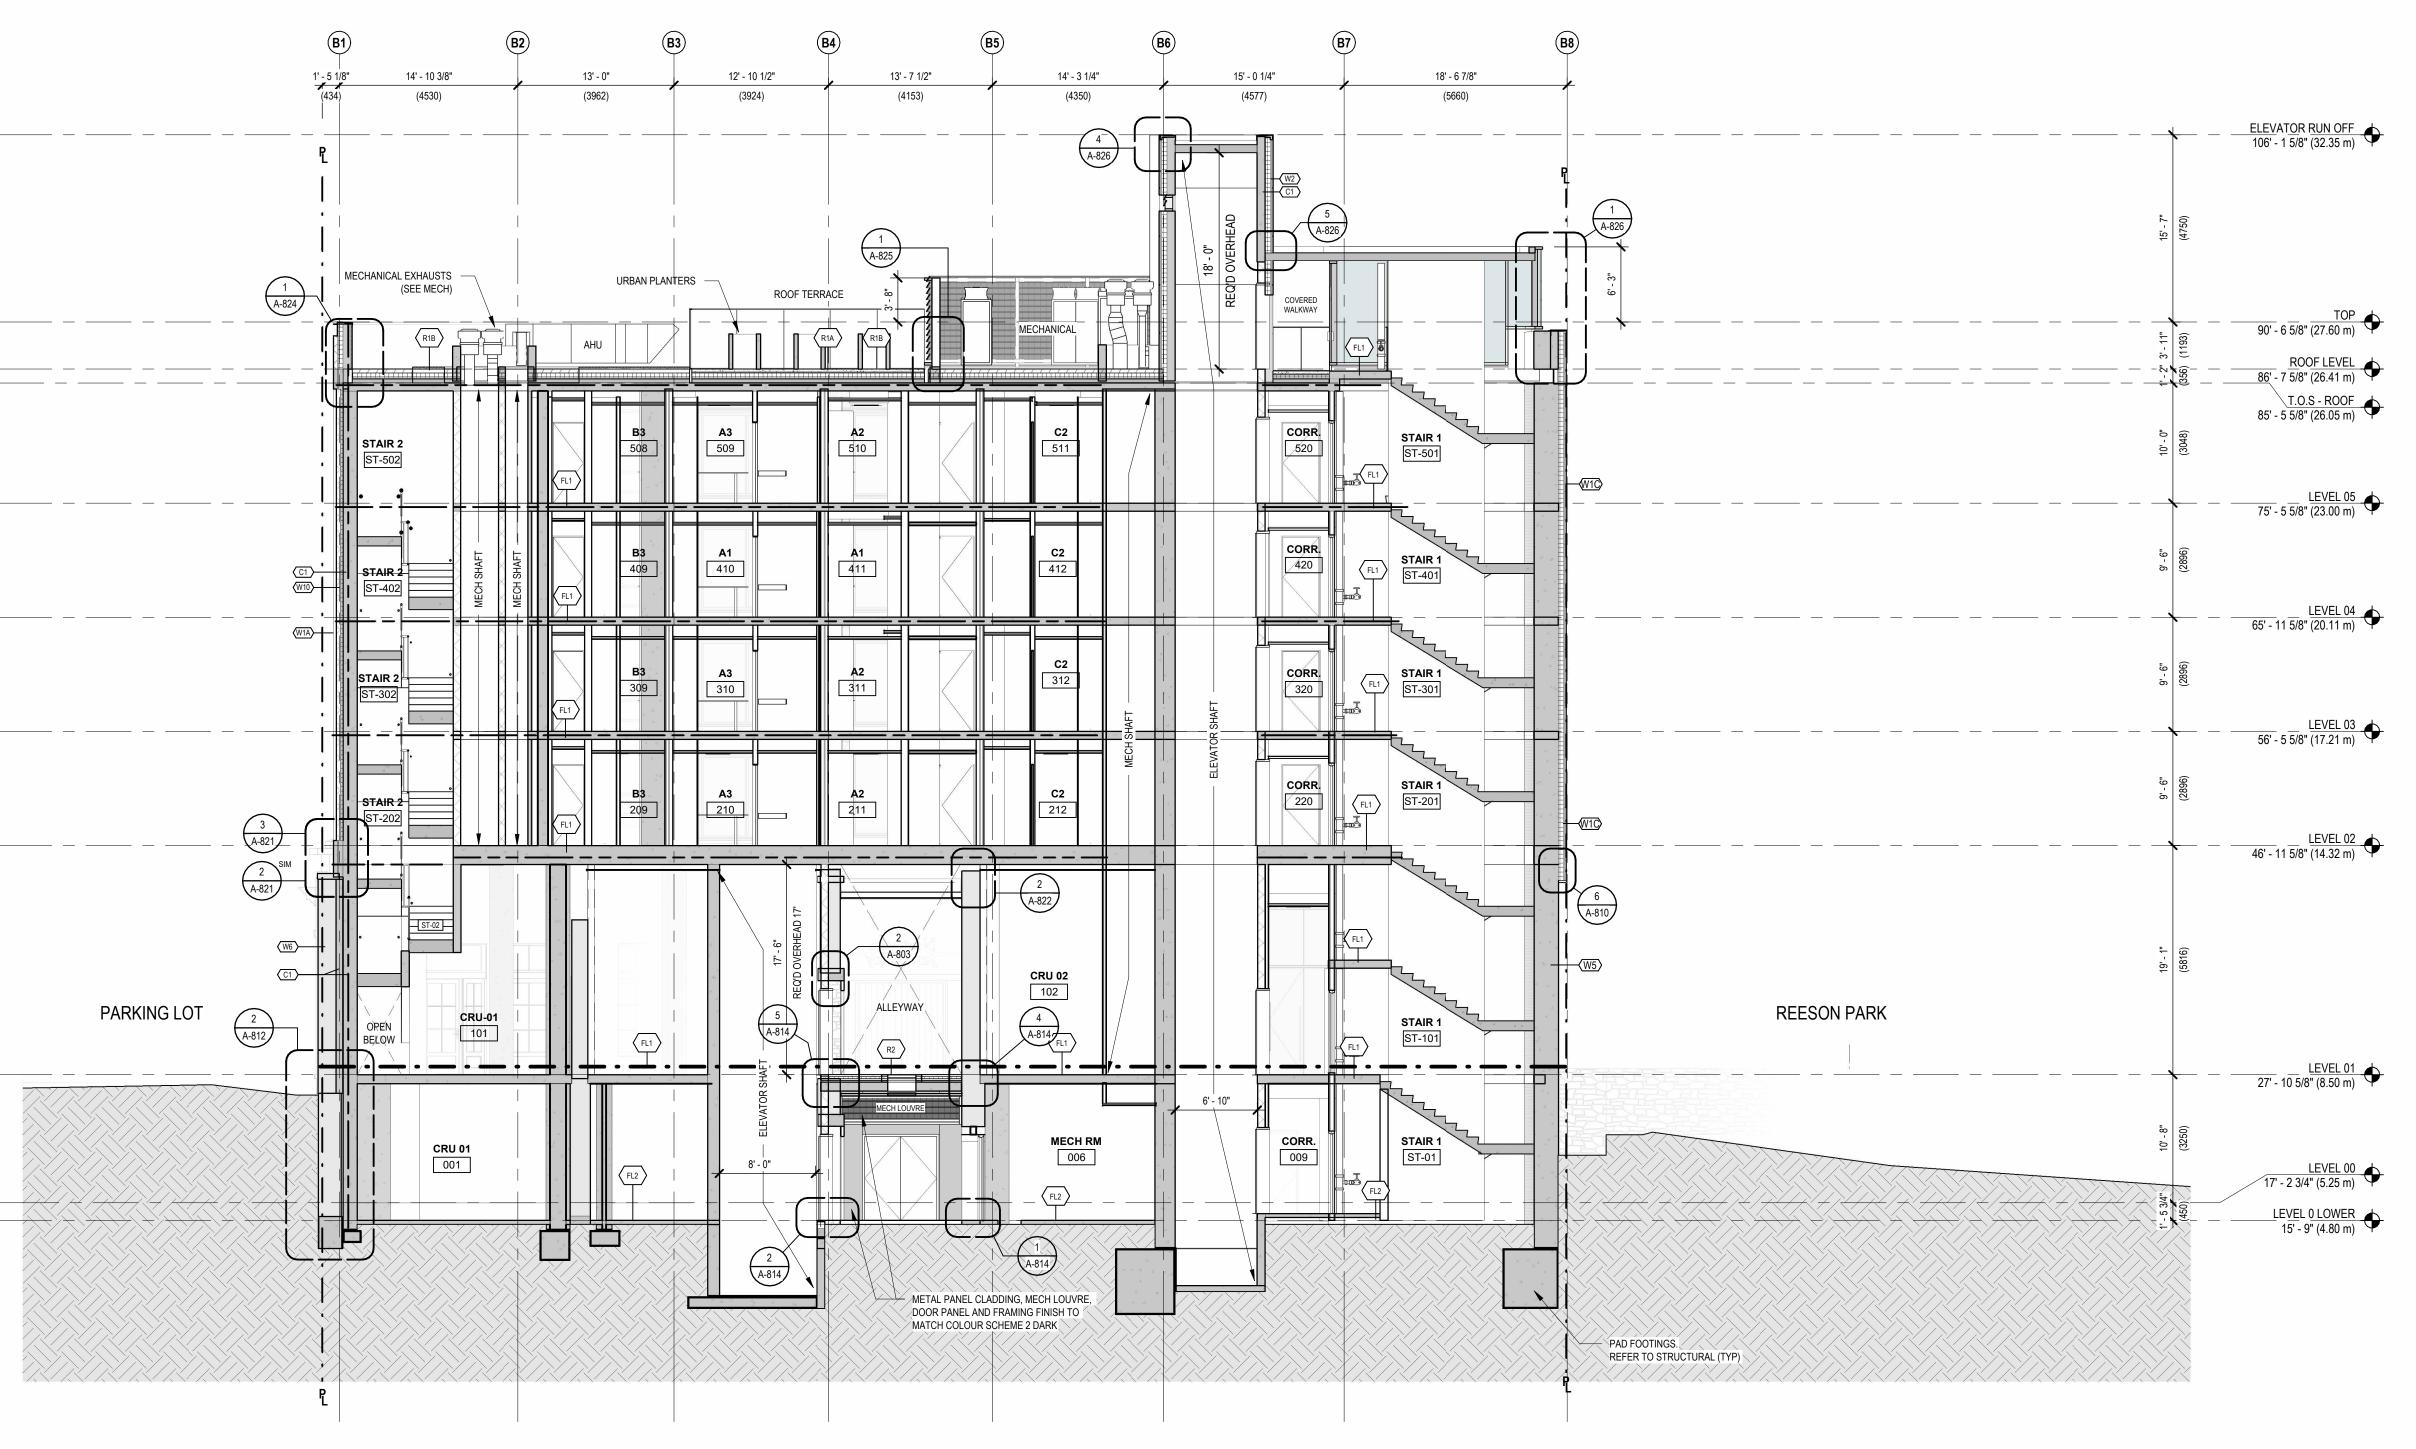

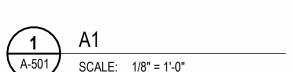







### ISSUED FOR

- A 2022-06-24 BUILDING PERMIT APPLICATION
  B 2022-09-29 BUILDING PERMIT APPLICATION
  REVISION 1
- C 2022-10-14 ISSUED FOR TENDER
- D 2022-11-10 IFT ADDENDUM 2
- E 2023-04-09 BUILDING PERMIT APPLICATION REVISION 3

### **IMPERIAL**

THIS DRAWING IS COPYRIGHTED AND MUST NOT BE USED, REPRODUCED, OR REVISED WITHOUT WRITTEN PERMISSION.

ALL DIMENSIONS ARE IN FEET AND INCHES UNLESS OTHERWISE NOTED.
VERIFY DIMENSIONS.

DO NOT SCALE THIS DRAWING.

REPORT INCONSISTENCIES AND OMISSIONS TO THE CONSULTANT FOR CLARIFICATION BEFORE COMMENCING WITH THE WORK.

DEVIATIONS FROM THE CONTRACT DOCUMENTS WITHOUT WRITTEN APPROVAL FROM THE CONSULTANT ARE SUBJECT TO CORRECTION AT THE CONTRACTOR'S EXPENSE.

ARCHITECT

BONIFACE OLEKSIUK POLITANO ARCHITECTS
180-510 NICOLA STREET
VANCOUVER BC, V6G 3J7
Tel: 236.521.6568 Email: info@bop.ca

This document has been digitally certified with digital certificate and encryption technology authorized by the Architectural Institute of BC and the Engineers and Geoscientists BC. The authoritative original has been transmitted to you in digital form. Any printed version can be relied upon as a true copy of the original when supplied by the architect, bearing images of the professional seal and digital certificate, or when printed from the digitally-certified electronic file provided by the architect.

SEAL



## NORTHERN JUNK


1314 WHARF STREET


## SECTION - A1

DRAWN: LM CHECKED: SO/AP PLOT DATE: 2023-04-07 8:06:07 PM

A-501

19004C

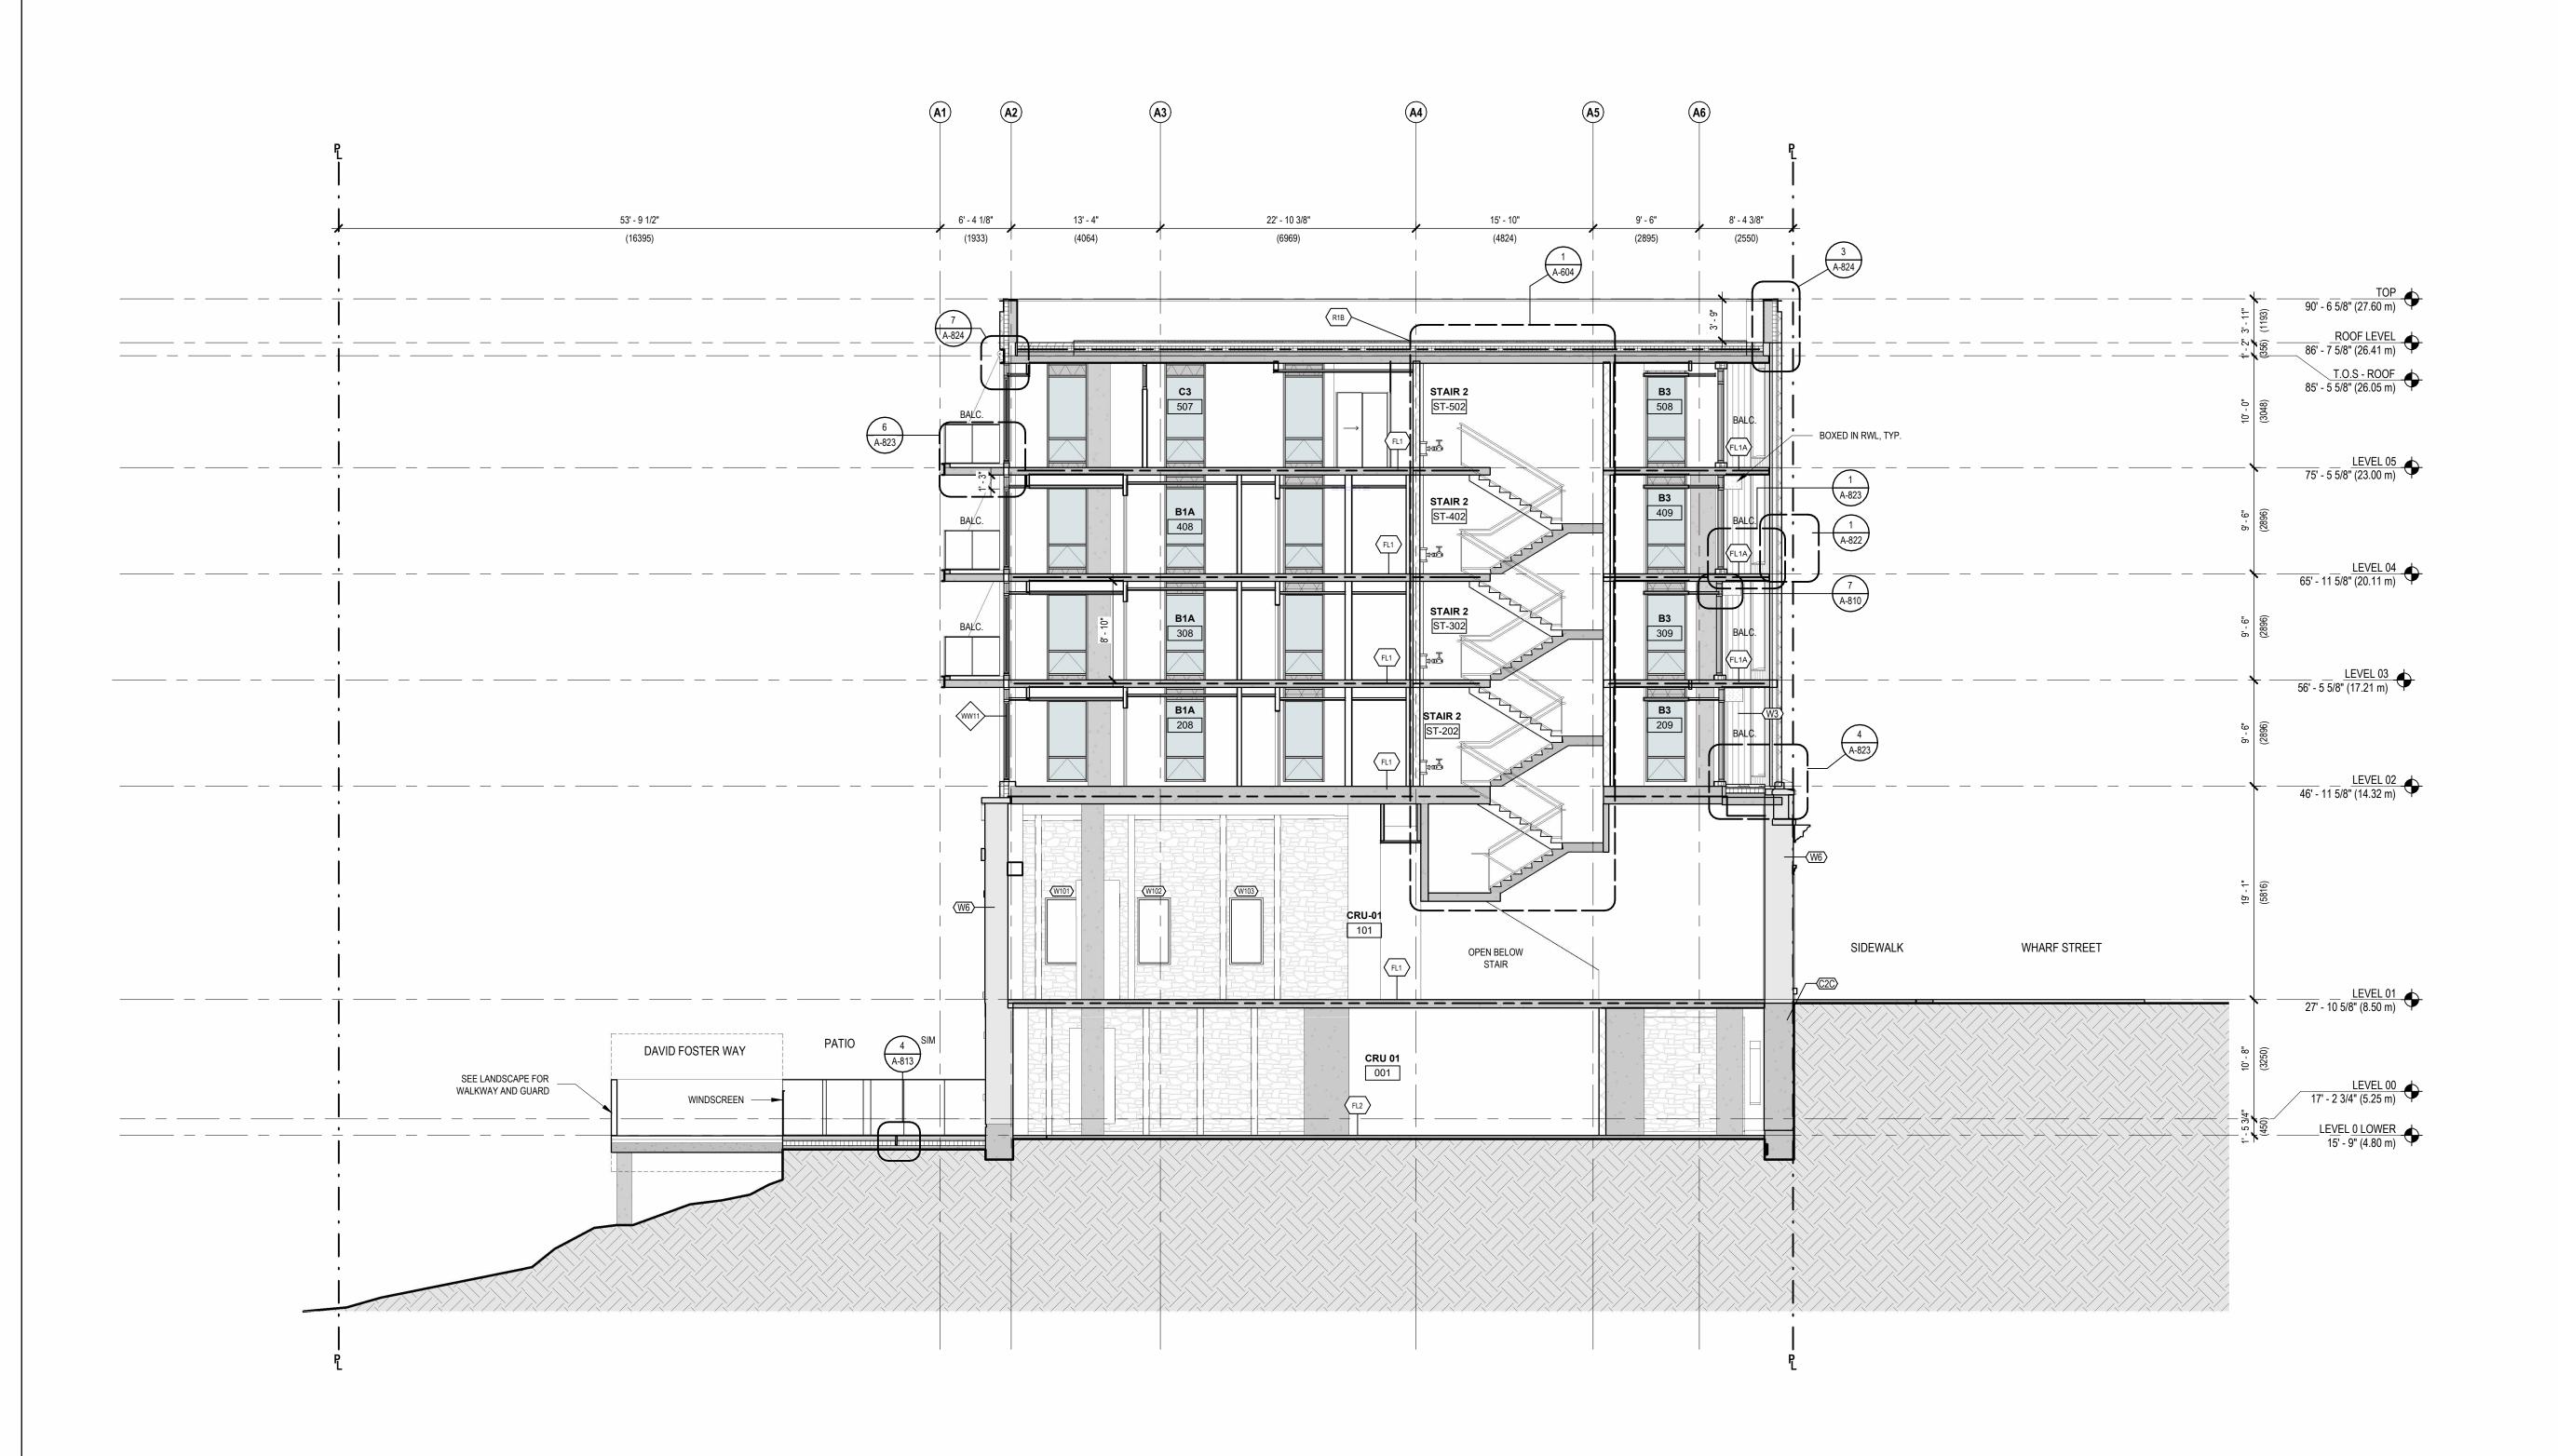

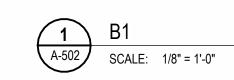





### ISSUED FOR

- A 2022-06-24 BUILDING PERMIT APPLICATION B 2022-09-29 BUILDING PERMIT APPLICATION
  - **REVISION 1**
- C 2022-10-14 ISSUED FOR TENDER
- D 2023-04-09 BUILDING PERMIT APPLICATION **REVISION 3**

### IMPERIAL

THIS DRAWING IS COPYRIGHTED AND MUST NOT BE USED, REPRODUCED, OR REVISED WITHOUT WRITTEN PERMISSION.

ALL DIMENSIONS ARE IN FEET AND INCHES UNLESS OTHERWISE VERIFY DIMENSIONS. DO NOT SCALE THIS DRAWING.

REPORT INCONSISTENCIES AND OMISSIONS TO THE CONSULTANT FOR CLARIFICATION BEFORE COMMENCING WITH THE WORK.

DEVIATIONS FROM THE CONTRACT DOCUMENTS WITHOUT WRITTEN APPROVAL FROM THE CONSULTANT ARE SUBJECT TO CORRECTION AT THE CONTRACTOR'S EXPENSE.

## ARCHITECT BONIFACE OLEKSIUK POLITANO ARCHITECTS 180-510 NICOLA STREET VANCOUVER BC, V6G 3J7 Tel: 236.521.6568 Email: info@bop.ca

This document has been digitally certified with digital certificate and encryption technology authorized by the Architectural Institute of BC and the Engineers and Geoscientists BC. The authoritative original has been transmitted to you in digital form. Any printed version can be relied upon as a true copy of the original when supplied by the architect, bearing images of the professional seal and digital certificate, or when printed from the digitally-certified electronic file provided by the architect.

SEAL



## NORTHERN JUNK


1314 WHARF STREET


SECTION - B1

DRAWN: LM PLOT DATE: 2023-04-07 8:06:12 PM CHECKED: SO/AP

A-502

19004C

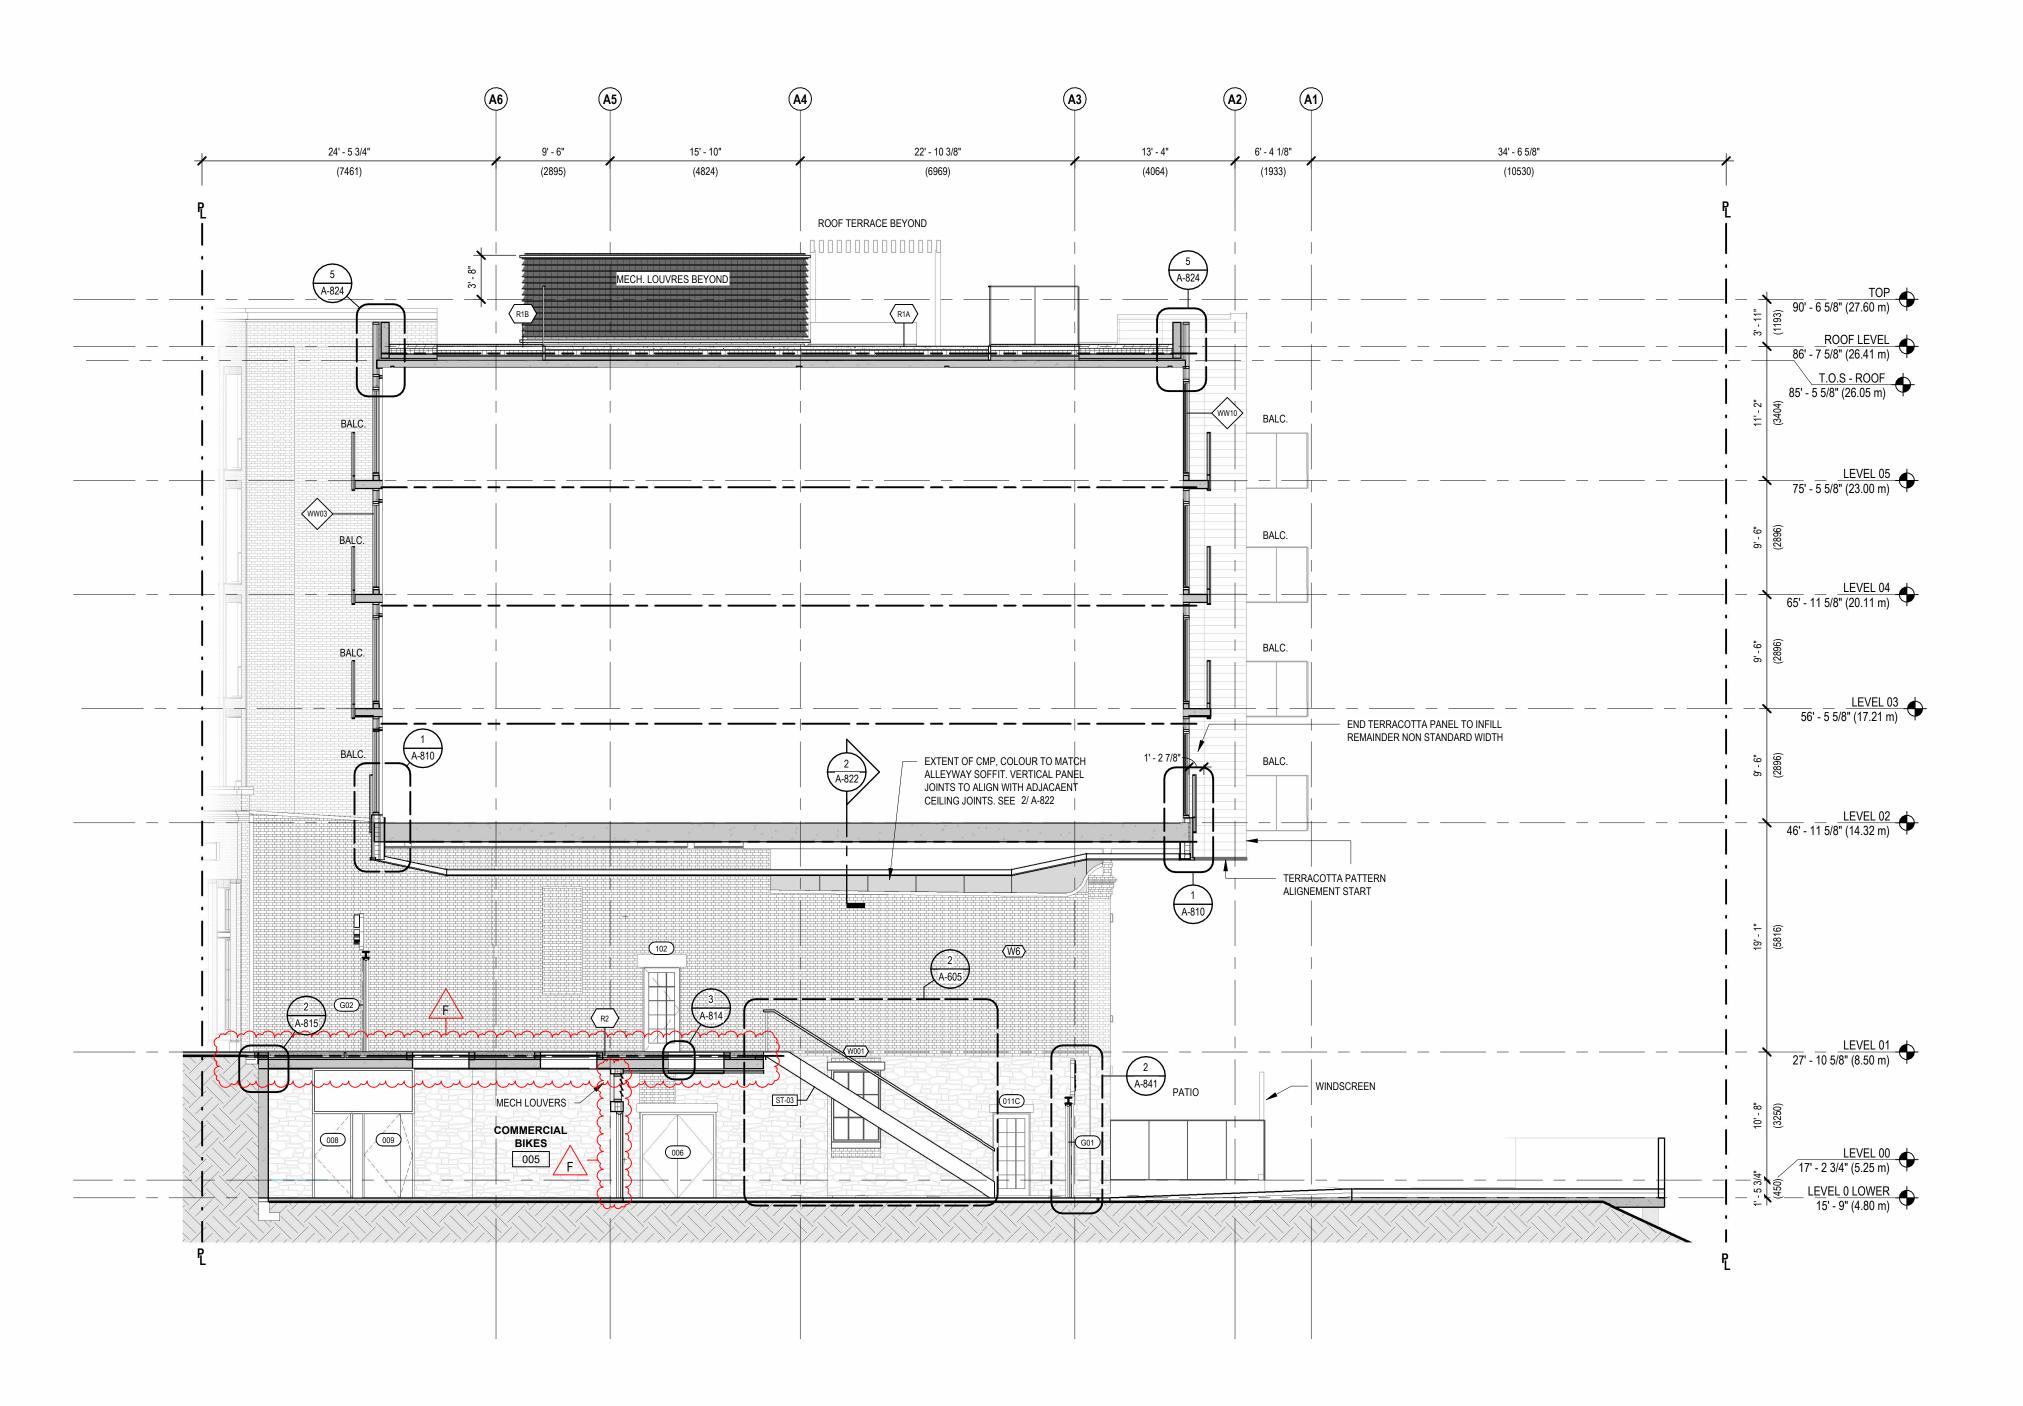

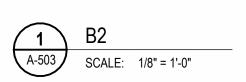





## PROPERTIES

ISSUED FOR

- A 2022-06-24 BUILDING PERMIT APPLICATION
- B 2022-09-29 BUILDING PERMIT APPLICATION REVISION 1
- C 2022-10-14 ISSUED FOR TENDER
- D 2022-11-10 IFT ADDENDUM 2
- E 2023-02-21 POST-TENDER ADDENDUM
- F 2023-04-09 BUILDING PERMIT APPLICATION REVISION 3

### IMPERIAL

THIS DRAWING IS COPYRIGHTED AND MUST NOT BE USED, REPRODUCED, OR REVISED WITHOUT WRITTEN PERMISSION.

ALL DIMENSIONS ARE IN FEET AND INCHES UNLESS OTHERWISE NOTED.
VERIFY DIMENSIONS.

DO NOT SCALE THIS DRAWING.

REPORT INCONSISTENCIES AND OMISSIONS TO THE CONSULTANT

FOR CLARIFICATION BEFORE COMMENCING WITH THE WORK.

DEVIATIONS FROM THE CONTRACT DOCUMENTS WITHOUT WRITTEN APPROVAL FROM THE CONSULTANT ARE SUBJECT TO CORRECTION AT THE CONTRACTOR'S EXPENSE.

# ARCHITECT BONIFACE OLEKSIUK POLITANO ARCHITECTS 180-510 NICOLA STREET VANCOUVER BC, V6G 3J7

Tel: 236.521.6568 Email: info@bop.ca

This document has been digitally certified with digital certificate and encryption technology authorized by the Architectural Institute of BC and the Engineers and Geoscientists BC. The authoritative original has been transmitted to you in digital form. Any printed version can be relied upon as a true copy of the original when supplied by the architect, bearing images of the professional seal and digital certificate, or when printed from the digitally-certified electronic file provided by the architect.

SI



## NORTHERN JUNK


1314 WHARF STREET


## SECTION - B2

DRAWN: LM CHECKED: SO/AP PLOT DATE: 2023-04-07 8:06:17 PM

A-503

19004C

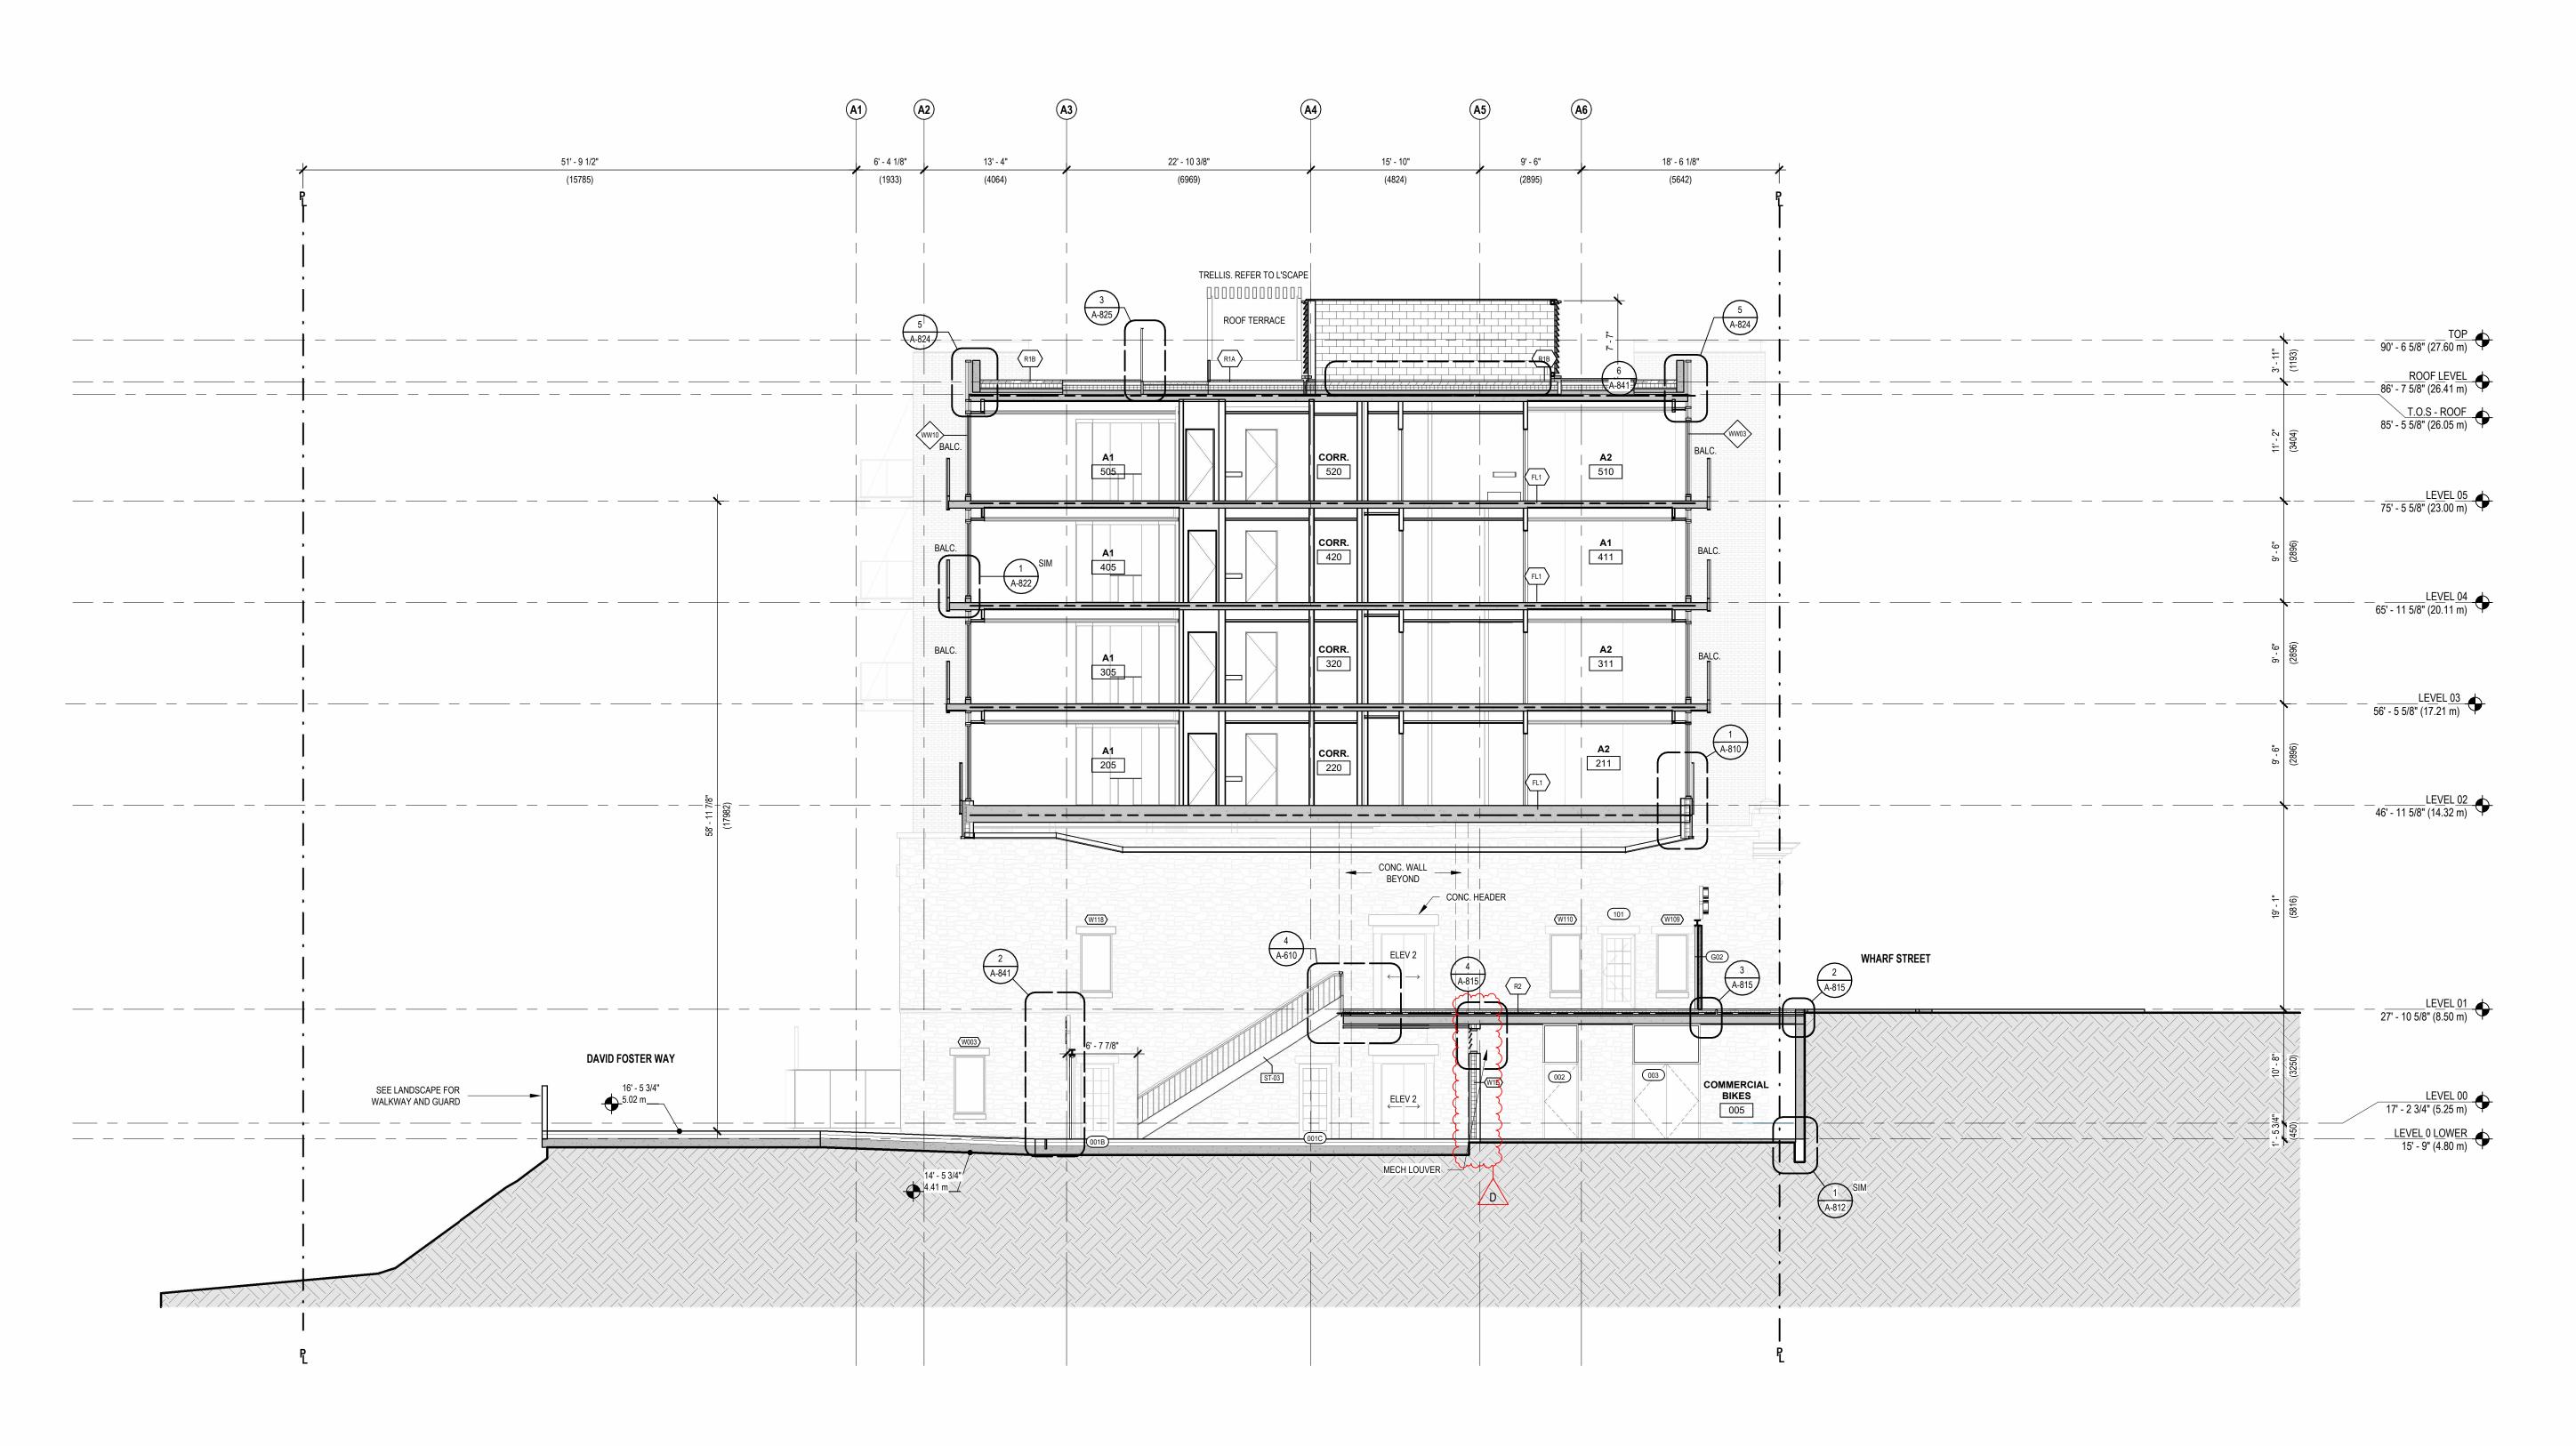

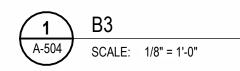





### ISSUED FOR

- A 2022-06-24 BUILDING PERMIT APPLICATION B 2022-09-29 BUILDING PERMIT APPLICATION
  - **REVISION 1**
- C 2022-10-14 ISSUED FOR TENDER
- D 2023-04-09 BUILDING PERMIT APPLICATION REVISION 3

### IMPERIAL

THIS DRAWING IS COPYRIGHTED AND MUST NOT BE USED, REPRODUCED, OR REVISED WITHOUT WRITTEN PERMISSION.

ALL DIMENSIONS ARE IN FEET AND INCHES UNLESS OTHERWISE VERIFY DIMENSIONS. DO NOT SCALE THIS DRAWING.

REPORT INCONSISTENCIES AND OMISSIONS TO THE CONSULTANT FOR CLARIFICATION BEFORE COMMENCING WITH THE WORK.

DEVIATIONS FROM THE CONTRACT DOCUMENTS WITHOUT WRITTEN APPROVAL FROM THE CONSULTANT ARE SUBJECT TO CORRECTION AT THE CONTRACTOR'S EXPENSE.

ARCHITECT BONIFACE OLEKSIUK POLITANO ARCHITECTS 180-510 NICOLA STREET VANCOUVER BC, V6G 3J7

Tel: 236.521.6568 Email: info@bop.ca

This document has been digitally certified with digital certificate and encryption technology authorized by the Architectural Institute of BC and the Engineers and Geoscientists BC. The authoritative original has been transmitted to you in digital form. Any printed version can be relied upon as a true copy of the original when supplied by the architect, bearing images of the professional seal and digital certificate, or when printed from the digitally-certified electronic file provided by the architect.

SEAL




## NORTHERN JUNK

1314 WHARF STREET

SECTION - B3

DRAWN: LM PLOT DATE: 2023-04-07 8:06:23 PM CHECKED: SO/AP

19004C

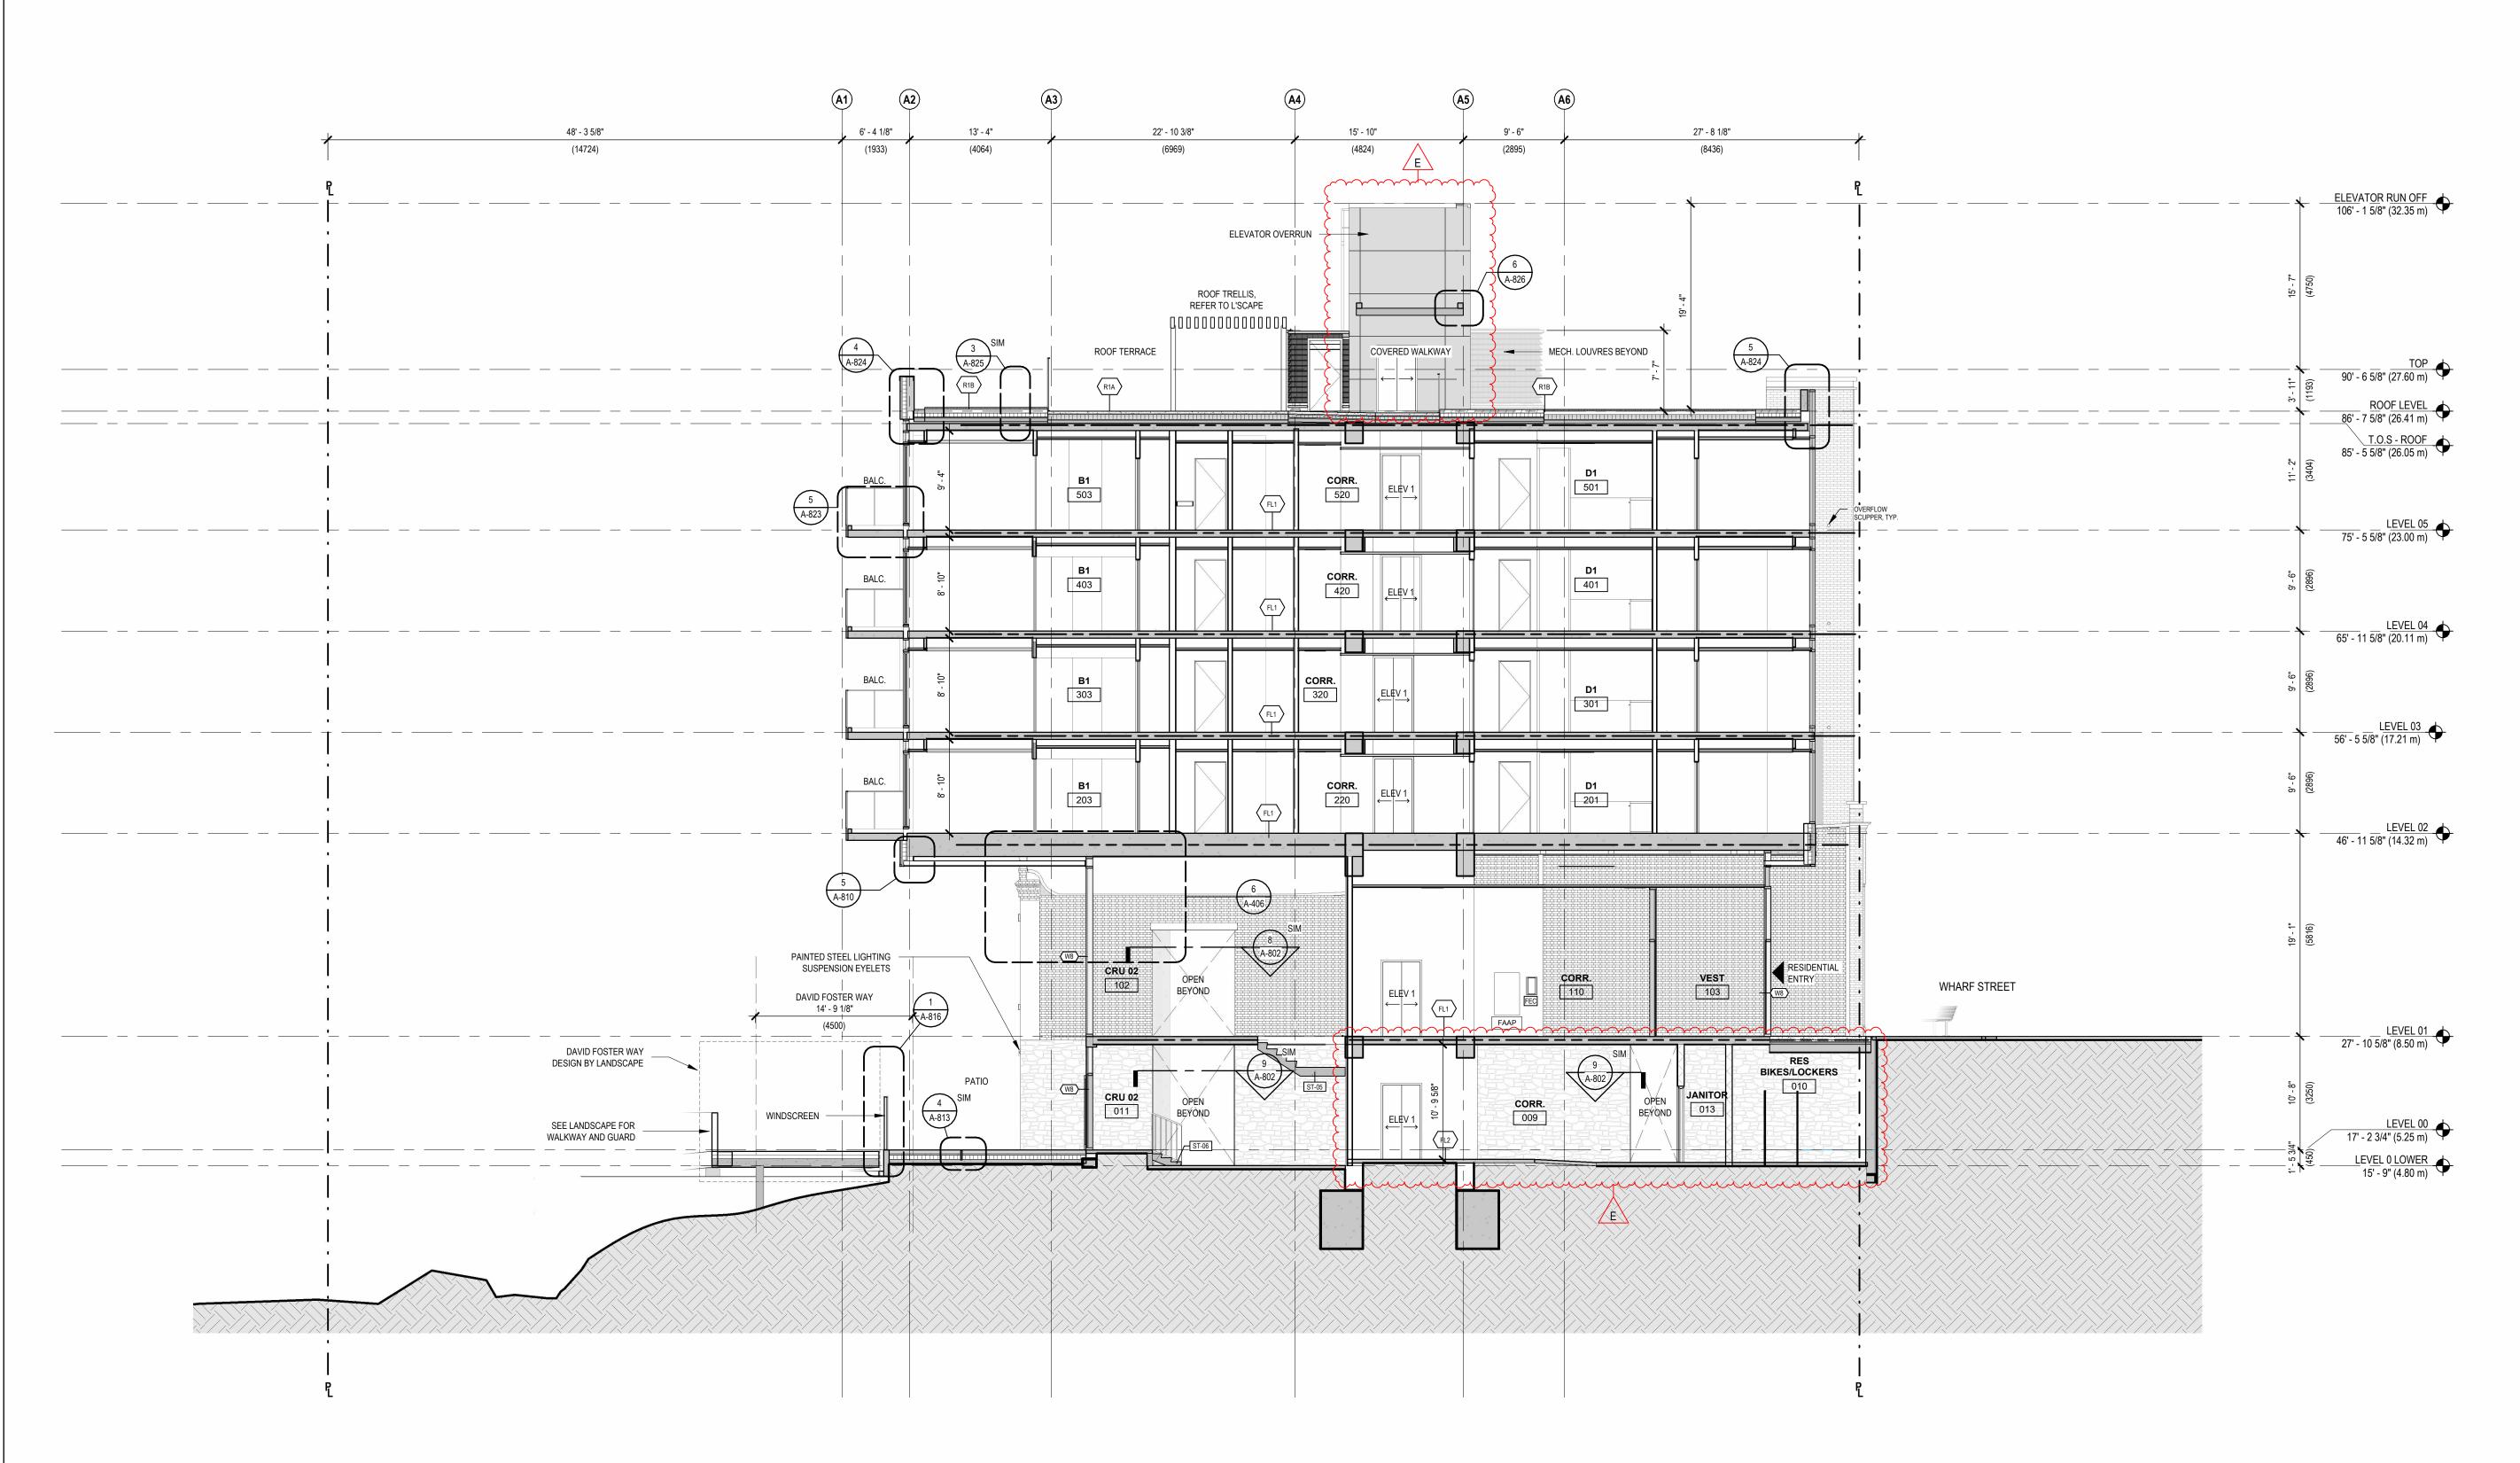







CROSSTOW

### ISSUED FOR

- A 2022-06-24 BUILDING PERMIT APPLICATION
  B 2022-09-29 BUILDING PERMIT APPLICATION
- REVISION 1
  C 2022-10-14 ISSUED FOR TENDER
- D 2023-02-21 POST-TENDER ADDENDUM
- E 2023-04-09 BUILDING PERMIT APPLICATION REVISION 3

### **IMPERIAL**

THIS DRAWING IS COPYRIGHTED AND MUST NOT BE USED, REPRODUCED, OR REVISED WITHOUT WRITTEN PERMISSION.

ALL DIMENSIONS ARE IN FEET AND INCHES UNLESS OTHERWISE NOTED.
VERIFY DIMENSIONS.
DO NOT SCALE THIS DRAWING.

REPORT INCONSISTENCIES AND OMISSIONS TO THE CONSULTANT

FOR CLARIFICATION BEFORE COMMENCING WITH THE WORK.

DEVIATIONS FROM THE CONTRACT DOCUMENTS WITHOUT WRITTEN APPROVAL FROM THE CONSULTANT ARE SUBJECT TO CORRECTION AT THE CONTRACTOR'S EXPENSE.

ARCHITECT

BONIFACE OLEKSIUK POLITANO ARCHITECTS
180-510 NICOLA STREET
VANCOUVER BC, V6G 3J7

Tel: 236.521.6568 Email: info@bop.ca

This document has been digitally certified with digital certificate and encryption technology authorized by the Architectural Institute of BC and the Engineers and Geoscientists BC. The authoritative original has been transmitted to you in digital form. Any printed version can be relied upon as a true copy of the original when supplied by the architect, bearing images of the professional seal and digital certificate, or when printed from the digitally-certified electronic file provided by the architect.

SEAL



## NORTHERN JUNK


1314 WHARF STREET

SECTION - B4

DRAWN: LM CHECKED: SO/AP PLOT DATE: 2023-04-07 8:06:29 PM

A-505

19004C

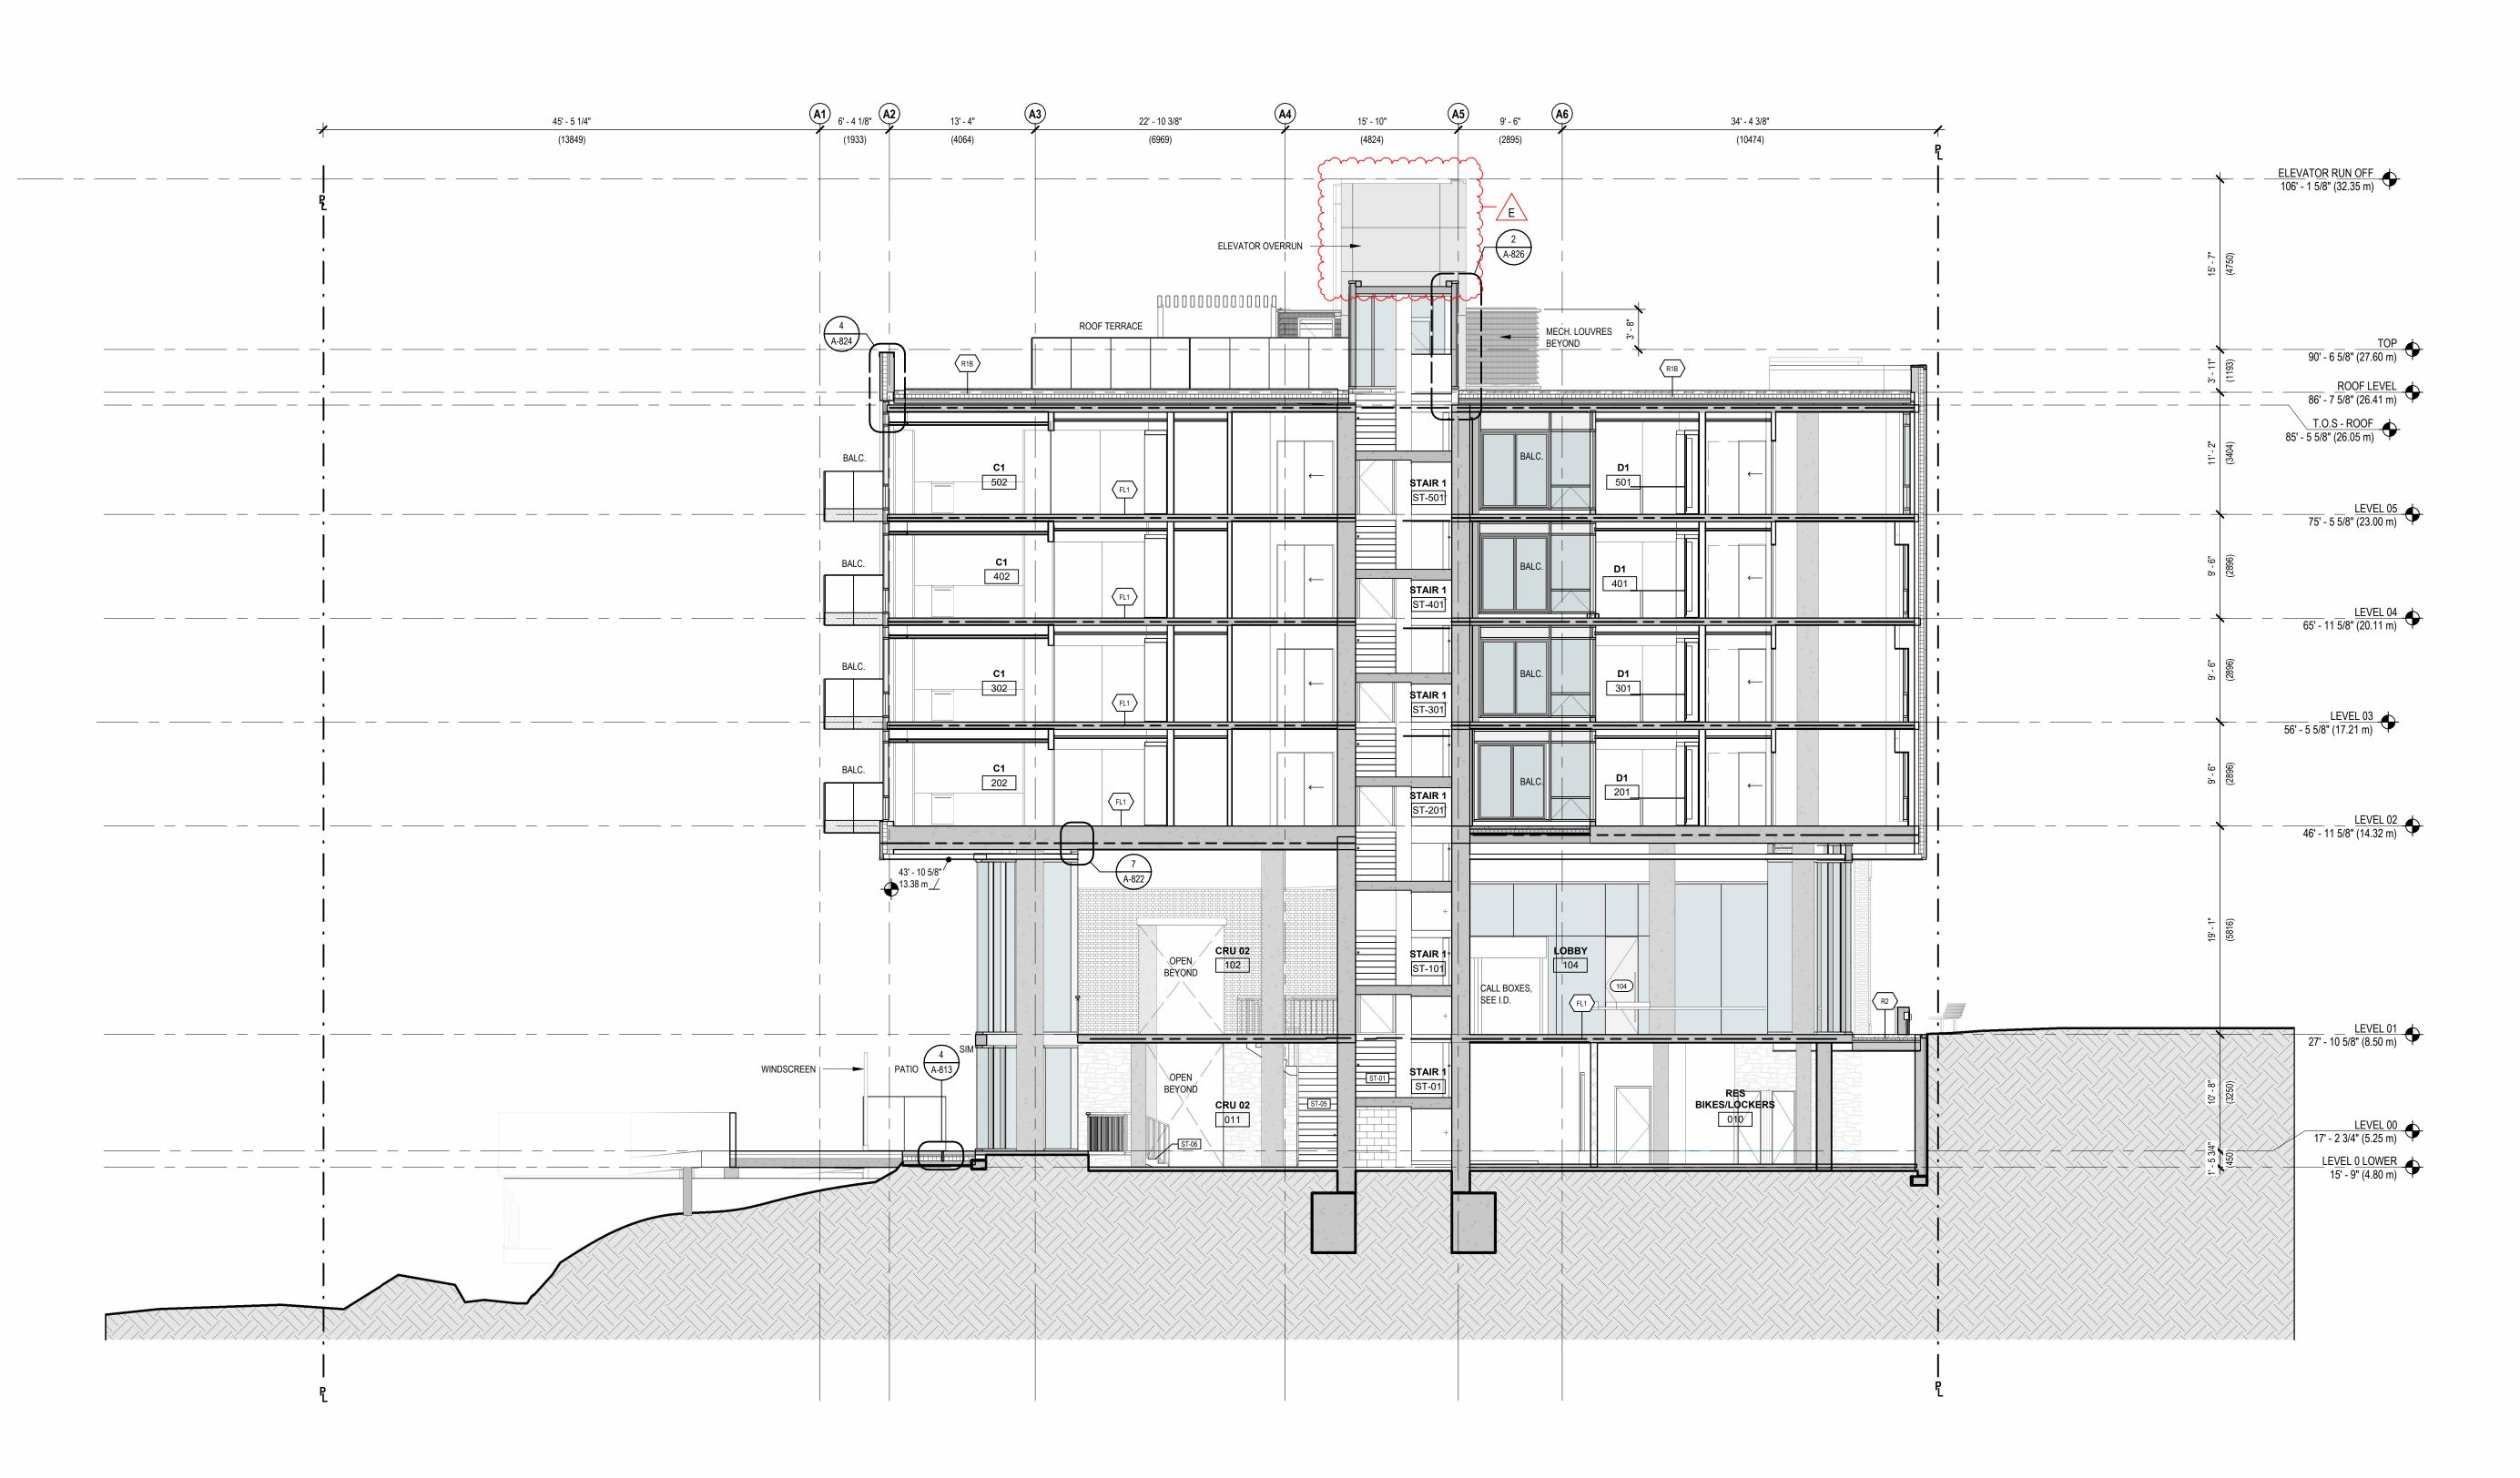









### ISSUED FOR

- A 2022-06-24 BUILDING PERMIT APPLICATION
  B 2022-09-29 BUILDING PERMIT APPLICATION
  REVISION 1
- C 2022-10-14 ISSUED FOR TENDER
- D 2023-02-21 POST-TENDER ADDENDUM E 2023-04-09 BUILDING PERMIT APPLICATION

### 23-04-09 BUILDING PERMIT APPLICAT REVISION 3

### **IMPERIAL**

THIS DRAWING IS COPYRIGHTED AND MUST NOT BE USED, REPRODUCED, OR REVISED WITHOUT WRITTEN PERMISSION.

ALL DIMENSIONS ARE IN FEET AND INCHES UNLESS OTHERWISE NOTED.
VERIFY DIMENSIONS.
DO NOT SCALE THIS DRAWING.

REPORT INCONSISTENCIES AND OMISSIONS TO THE CONSULTANT FOR CLARIFICATION BEFORE COMMENCING WITH THE WORK.

DEVIATIONS FROM THE CONTRACT DOCUMENTS WITHOUT WRITTEN APPROVAL FROM THE CONSULTANT ARE SUBJECT TO CORRECTION AT THE CONTRACTOR'S EXPENSE.

# ARCHITECT BONIFACE OLEKSIUK POLITANO ARCHITECTS 180-510 NICOLA STREET VANCOUVER BC, V6G 3J7 Tel: 236.521.6568 Email: info@bop.ca

This document has been digitally certified with digital certificate and encryption technology authorized by the Architectural Institute of BC and the Engineers and Geoscientists BC. The authoritative original has been transmitted to you in digital form. Any printed version can be relied upon as a true copy of the original when supplied by the architect, bearing images of the professional seal and digital certificate, or when printed from the digitally-certified electronic file provided by the architect.





## NORTHERN JUNK

1314 WHARF STREET

## SECTION - B5

DRAWN: LM CHECKED: SO/AP PLOT DATE: 2023-04-07 8:06:36 PM

A-506

19004C