Attachment H

HERITAGE TAX INCENTIVE PROGRAM

NON-RESIDENTIAL USES


1314 + 1318 WHARF STREET, VICTORIA BC JUNE 13, 2023





Boniface Oleksiuk Politano Architects



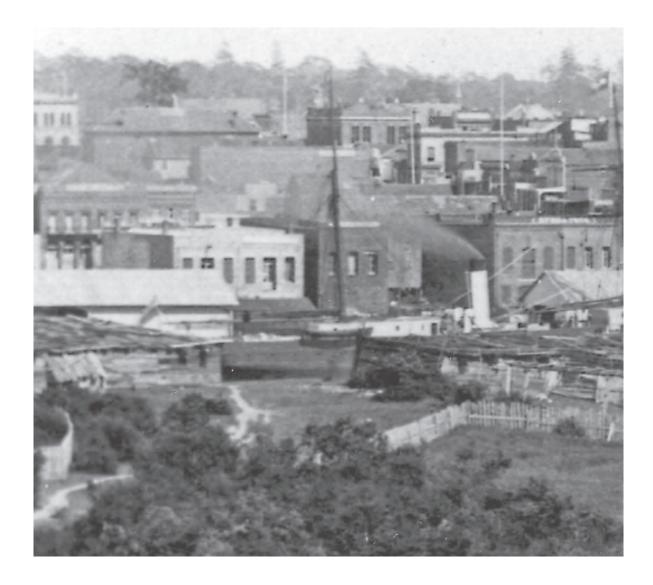

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HERITAGE TAX INCENTIVE PROGRAM

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PROJECT TEAM

OWNER

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ROPERTIES

1314+1318 WHARF STREET REDEVELOPMENT

HERITAGE CONSERVATION RATIONALE

The conservation of the Heritage Designated 1860 Caire & Grancini Warehouse and the 1864 Fraser Warehouse, known as Northern Junk, has been a 12 year effort to deliver a significant benefit with the future animation of these rehabilitated and restored heritage buildings. Not only is conserving these resources integral to their cultural and economic viability, and a vital component of urban revitalization efforts and the continuity of the David Foster Way, but their conservation avoids negative environmental impacts, reduces construction and demolition waste, and promotes adaptive re-use for reintegration into a vibrant urban environment. However, such conservation and redevelopment carries a great deal of unknown factors that lead to considerable uncertainty. Although the details of this project have been planned in minute detail, the ability to have certain financial incentives to help offset some of the actual costs of the heritage restoration work is paramount in such undertakings.

The City of Victoria's Heritage Tax Incentive Program is one of such tools that makes it feasible to convert underused or vacant structures, such as the Northern Junk warehouses, into fully functional properties and to ensure the protection and usefulness of priority heritage properties. The original use of both warehouses was industrial with no residential components. Although the new addition provides residential accommodation, it is understood that new additions are not factored in the tax exemption equation as the exemption is only applicable to the heritage portion that will be substantially rehabilitated for a new commercial use and not for living accommodation. It is important to note that the City's Zoning Bylaws exclude service areas and basements from "Residential Floor Area," and the CA-3C Zone - Old Town District restricts residential to the second and higher storeys of a building if the entire first storey is used for purposes other than residential. Thus, the "Non-Residential Uses" stream would logically apply to the Northern Junk warehouses.

The ability of the Tax Incentive Program under the "Non-Residential Uses" stream to offset construction costs for the purpose of "rehabilitation for uses other than residential" is vital to the success of Northern Junk's seismic upgrade, facade improvements and heritage restoration, building code improvements such as fire exits, and all work related to the envelope and interior rehabilitation of the buildings. The Land Lift analysis clearly outlines the imminent need of such incentives for project viability.

To date, the only activity on site has focused on extensive investigation work along with cleaning the buildings to evaluate their surfaces under what has been hidden under graffiti, stain, organic growth, and stucco for many years. To ensure complete transparency, a comprehensive package detailing results of the overall investigation of the heritage facades, mandatory pre-construction work to temporarily provide shoring and restraint to avoid further collapse and ensure safe access, a full seismic upgrade strategy, and numerous protocols and photographic records of all preliminary investigations were shared with Senior Heritage Planner Kristal Stevenot and the Victoria Civic Heritage Trust in October 2022.

Documentation shared included:

- Conservation Plans + Protocols
- Preliminary Site Work Photo Record
- Seismic Assessment Report
- Original Building Plans, Sections + Elevations

The overall heritage conservation intent is to ensure the project follows Donald Luxton and Associates Inc. conservation plans for both buildings, as well as the recommendations and guidelines provided in the Standards and Guidelines for the Conservation of Historic Places in Canada (S&Gs). Luxton's conservation plans clearly articulate the historical context, the buildings' significance and characterdefining elements, as well as conservation recommendations that were submitted as part of the Heritage Alteration Permit Application approved by Council on August 5, 2021. The conservation plans and the S&Gs have been the basis of all protocol documents to date.

Due to the nature of the addition approved by Council, the Fraser Warehouse gabled roofs and the Caire & Grancini flat deck roof will be dismantled, but will not alter the street-facing facades and will only require the rear parapet of the Caire & Grancini to be dismantled and then reassembled to match its existing appearance at a slightly lower level as detailed in the heritage consultant's protocol. In addition, and as noted by the then Senior Heritage Planner John O'Reilly during his presentation to CoTW, the north side floor of the Fraser Warehouse had collapsed and needed to be removed. Due to the overall structural integrity concerns of the floor systems, it was determined that the floors in both warehouses would be reconstructed, and the internal wood timbers reused within the interior, in part for seismic upgrading and other internal uses. Restoring the original appearance of the Fraser Warehouse street facing east facade and rehabilitating the Caire & Grancini east facade requires removal of the inappropriate stucco, brick infill, wood framing and panels, and windows and doors, all not original to the heritage buildings.

Following very extensive exploratory work to determine details barely visible in the only archival photograph available of the warehouses' east facades', the investigation successfully determined the original features of the Fraser Warehouse east facade. Unfortunately, nothing remains of the original Caire & Grancini east facade. The Senior Heritage Planner, John O'Reilly at the time, confirmed that a Delegated Heritage Alteration Permit application is to be submitted to alter the August 5, 2021, approved HAP to reflect the original physical appearance of the Fraser Warehouse east façade as it existed in 1864. This is truly an exciting find and one that has and will require additional financial investment not previously accounted for to realize its full restoration.



Oleksiuk Politano




- Current Architectural Drawings
- Current Structural Drawings
- Construction Schedule
- Existing Building Retention Plan

Further to what is detailed in the Fraser Warehouse Conservation Plan, and in addition to the approved August 5, 2021, HAP application, Council requested the inclusion of the random rubble stone masonry demising wall that equally divides the north and south portions of the warehouse on both levels in the Heritage Designation Bylaw. An application with a revised Statement of Significance (SoS) and a seismic upgrade strategy is ready to move forward once eligibility for the Heritage Tax Incentive – Non-Residential Uses is confirmed.

It is our position that the Northern Junk project meets the qualification requirements as detailed in the application and it has been our impression from previous conversations with City staff that this project would be eligible to apply. The warehouses are protected by a Heritage Designation Bylaw; the proposed work results in substantial rehabilitation or new use for a vacant or an underutilized space, or a new economic use of the building; and the warehouses are privately owned. Only pre-construction activities have been undertaken to help protect, maintain, and stabilize the existing form, material and integrity of the buildings, as well as strip-out and shoring of the interiors to ensure safe access. A Heritage Alteration Permit was approved on August 5, 2021, and conversations and correspondence with the Senior Heritage Planner, Kristal Stevenot, and the VCHT have been ongoing. We have made every effort to be transparent and forthcoming with all information requested to date.

We understand the decision for the TIP eligibility is not a simple one, but we firmly believe diagnoses are not always black-and-white and deserve further consideration of the gray area between these two extremes. In fact, the Tax Incentive Program Description on the City website clearly states that, **"Specifics will be subject to negotiation and approval by the Victoria City Council.";** In the same way the application information package outlines, **"City Council is the final authority in granting eligibility to the program".** It is in this light that we respectfully ask members of Council to consider the circumstances of Northern Junk's eligibility to apply for the Heritage Tax Incentive – Non-Residential Uses, work together and enable the efforts of this project to proceed to ensure these two historic buildings do not fall to their demise from an unfortunate lack of support.

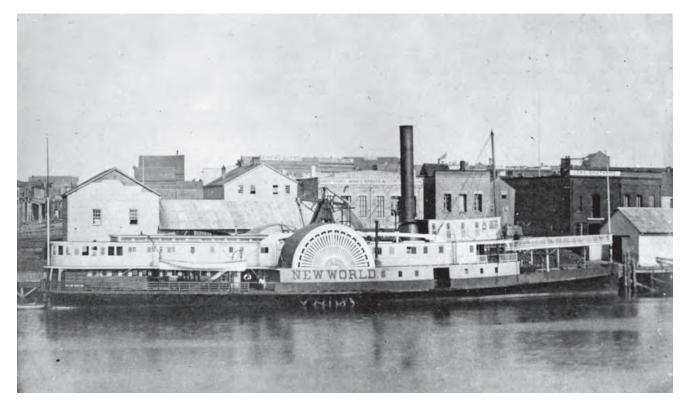





PROPOSED DEVELOPMENT

DESIGN RATIONALE

The Northern Junk site at the head of the Johnson Street Bridge presents unique set of opportunities and challenges. The site is in a prominent position in the City between Old-Town and Inner-harbour. Currently isolated between Reeson Park to the south and the as-yet undefined Bridgehead Green park to the North, the site offers the potential to complete a key piece of the public realm and neighbourhood revitalization through its design and development.

The proposed development responds to a number of planning and urban design objectives set forth in the OCP and Core Area Plans. In particular, it will provide housing diversity in the form of new rental apartments, an upgrade of two heritage buildings, improve public access to the waterfront and support economic and social vitality in the area, all within a built-form that is in keeping with the goals of area design guidelines.

The project consists of a multi-unit residential apartment building set atop the existing Northern Junk warehouse buildings (Caire & Grancini Warehouse and Fraser Warehouse) that are to be rehabilitated and incorporated into a mixed-use development. The project brings together active ground level uses, new housing options, and an integrated public access and extension of the public waterfront walkway.

HERITAGE RESPONSE

The existing architecture of the two Northern Junk warehouse buildings is to be rehabilitated by carefully revealing original facade elements obscured by previous alterations and additions and rehabilitating the exterior masonry facade. Alterations, including new openings, will be undertaken to improve the functionality of the buildings. The key goal is to maintain as many elements of the existing buildings as possible while giving them a new life as active commercial spaces accessible to the public. The new elements of the project have been devised to maximize visibility and retention of the existing buildings and bring new value to them for present and future generations. The new structure and spaces embrace the heritage elements allowing users to come in contact with and be able to appreciate the heritage elements in new ways. All principal facades, interior masonry walls and openings are retained in the proposed design.

Whereas, a typical addition to a heritage building might be smaller in scale, the context of the buildings within the generally 5-storey Old-town fabric suggests that a one or two-storey addition would seem out of scale with the surroundings. The increased height of the additions delivers an integrated streetscape using the heritage buildings as its foundation. The resulting tripartite composition of each facade reinforces the classical pattern of base (heritage buildings), middle (new residential building), and top (contemporary cornice elements).

The patterns of glazing and masonry piers of the new elements above the two heritage buildings are guided by the existing proportions and details of their facades, rendered in a simpler more contemporary articulation so as to not compete with the existing facades, but be sympathetic and complementary.





EXTERIOR FACADES TO BE RETAINED





EXISTING CONDITION

SITE PHOTOGRAPHS



EXISTING INTERIOR CONDITION



EXISTING INTERIOR CONDITION



FRASER WAREHOUSE EAST FACADE



EXISTING CAIRE & GRANCINI WEST FACADE



EXISTING ALLEYWAY BETWEEN BUILDINGS



EXISTING EAST FACADES










EXISTING WINDOW CONDITION TYP.



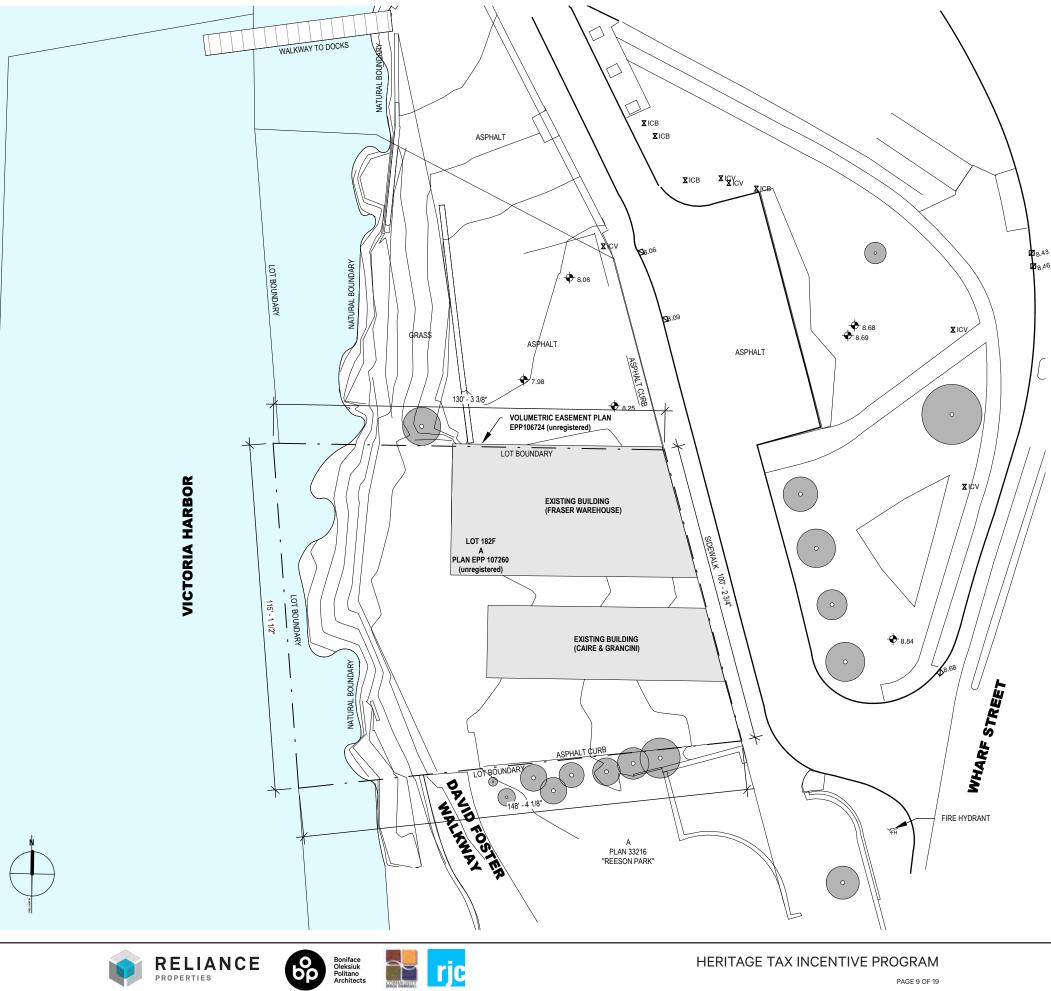

1314 + 1318 WHARF STREET JUNE 13, 2023



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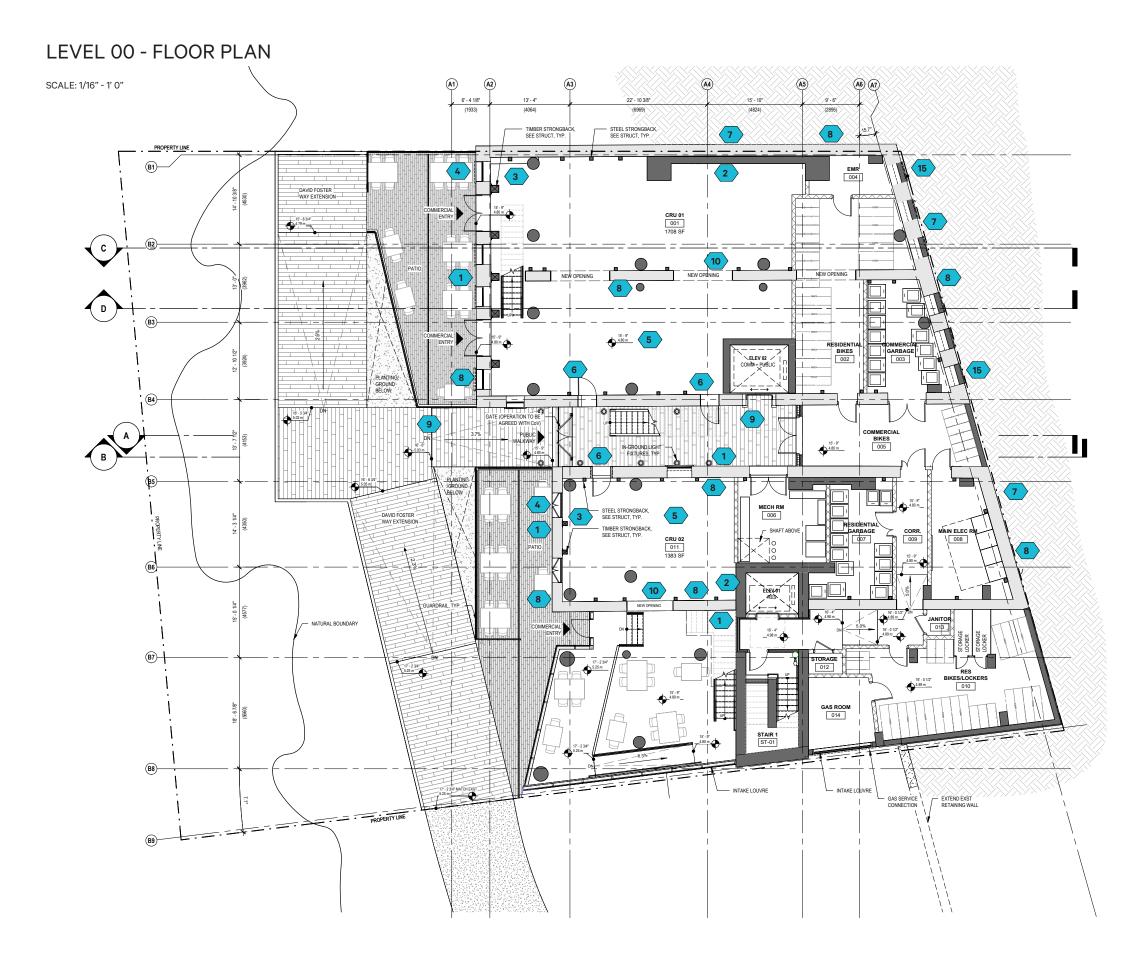
ARCHITECTURAL DRAWINGS

3D VISUAL















GENERAL DEVELOPMENT ITEMS:

- 1. Masonry restorations and re-pointing where required
- Seismic upgrade strategy Shear Wall (Refer to Structural drawings Page 18)
- Seismic upgrade strategy Reclaimed timber and steel strongbacks (Refer to Structural drawings Page 18)
- 4. Replacement of existing windows and doors with wood replicas
- 5. Floor grade lowered to provide level access and improved head height at Level 00
- 6. New openings created to improve access, life safety and quality of interior environment
- 7. Additional insulation and waterproofing to exterior face of existing below grade walls
- 8. Structural underpinning of all existing masonry walls to improve structural stability
- 9. Sloped/Level access and new public elevator to make accessible route from Wharf street to David Foster Way
- 10. New openings in Existing walls to connect CRU Spaces
- 11. New openings to provide adequate access exits
- 12. Restoration of Fraser Warehouse east facade, removing stucco and reinstating original building features. Repairs to existing parapets and cornices
- Rebuilding of Caire & Grancini east facade to reinstate facade to original, using recycled brick salvaged from other areas of the building
- 14. Caire & Grancini existing parapet removed and reinstated at a lower elevation to enable level floors in new portion of building whilst retaining an original feature
- Retention and treatment of old coal gates along East basement facade
- 16. Removal of brick infill to expose existing arched openings
- 17. Restoration and recreation of existing parapets and cornices.

DRAWING LEGEND:




EXISTING WALLS





LEVEL 01 - FLOOR PLAN

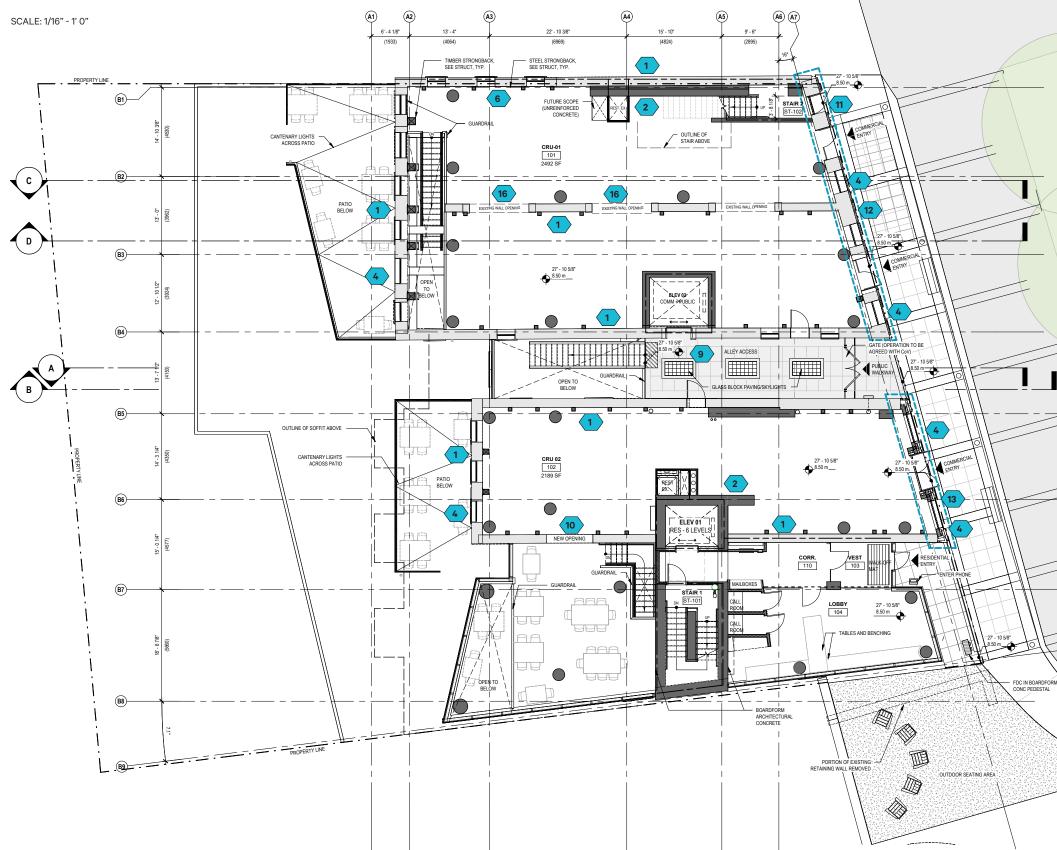







GENERAL DEVELOPMENT ITEMS:


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- 14. Caire & Grancini existing parapet removed and reinstated at a lower elevation to enable level floors in new portion of building whilst retaining an original feature
- 15. Retention and treatment of old coal gates along East basement facade
- Removal of brick infill to expose existing arched 16 openings
- 17. Restoration and recreation of existing parapets and cornices.

DRAWING LEGEND:

EXISTING WALLS



LEVEL 02 - FLOOR PLAN

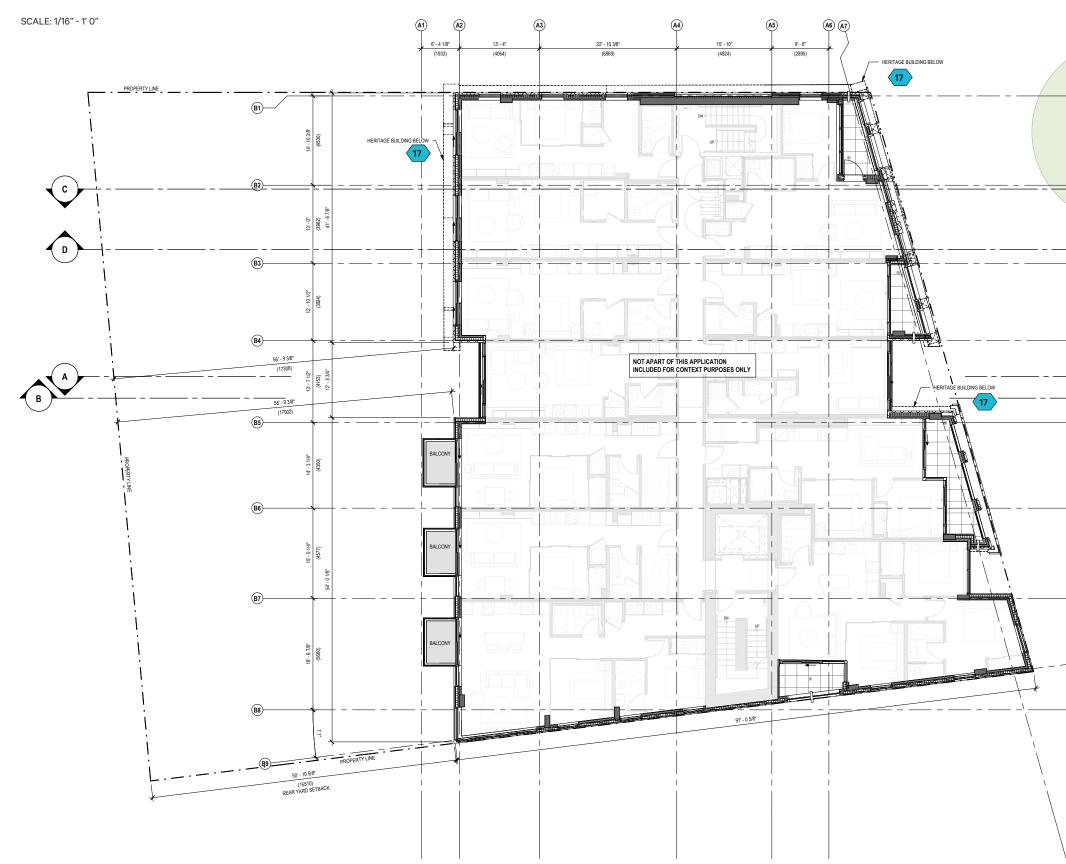





GENERAL DEVELOPMENT ITEMS:

- Masonry restorations and re-pointing where required
- Seismic upgrade strategy Shear Wall (Refer to Structural drawings Page 18)
- Seismic upgrade strategy Reclaimed timber and steel strongbacks (Refer to Structural drawings Page 18)
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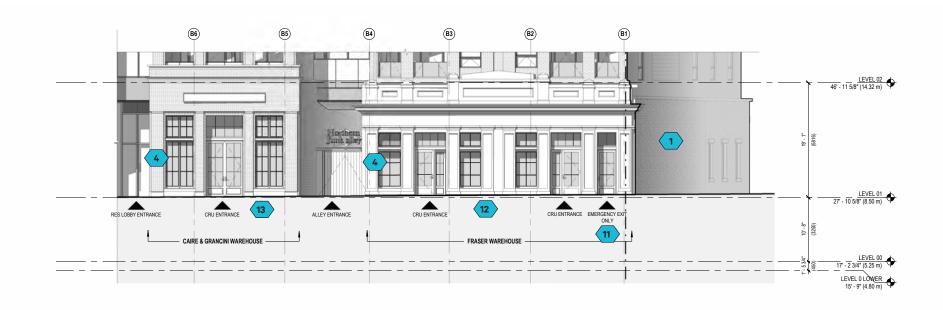


EXISTING WALLS




EAST ELEVATION

SCALE: 1/16" - 1' 0"



WEST ELEVATION

SCALE: 1/16" - 1' 0"

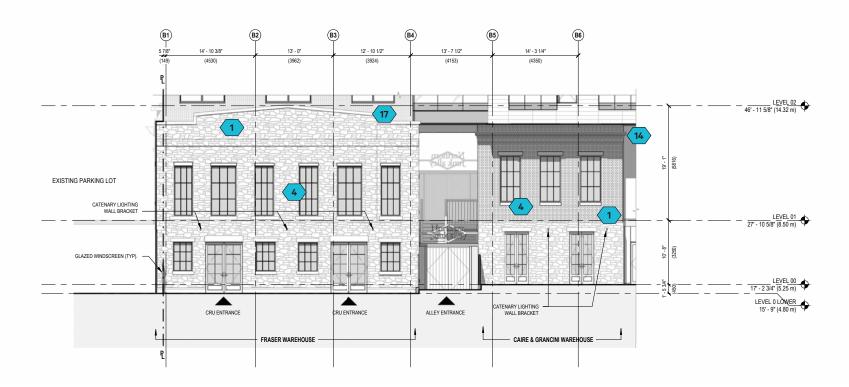



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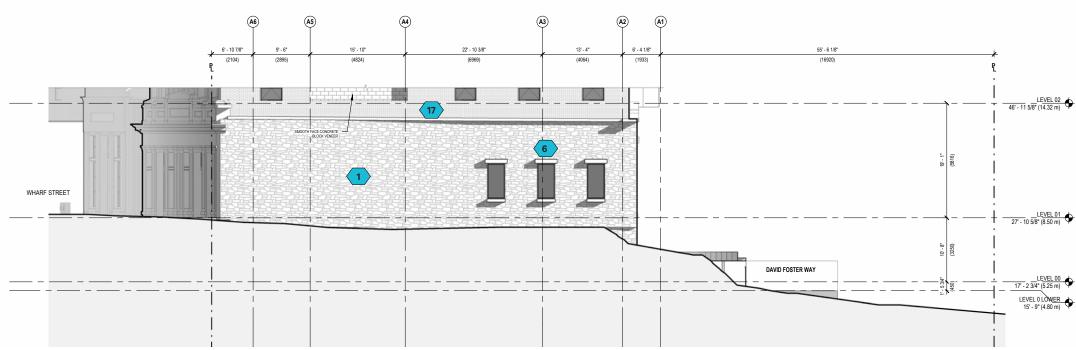
DRAWING LEGEND:



EXISTING WALLS

NORTH ELEVATION

SCALE: 1/16" - 1' 0"









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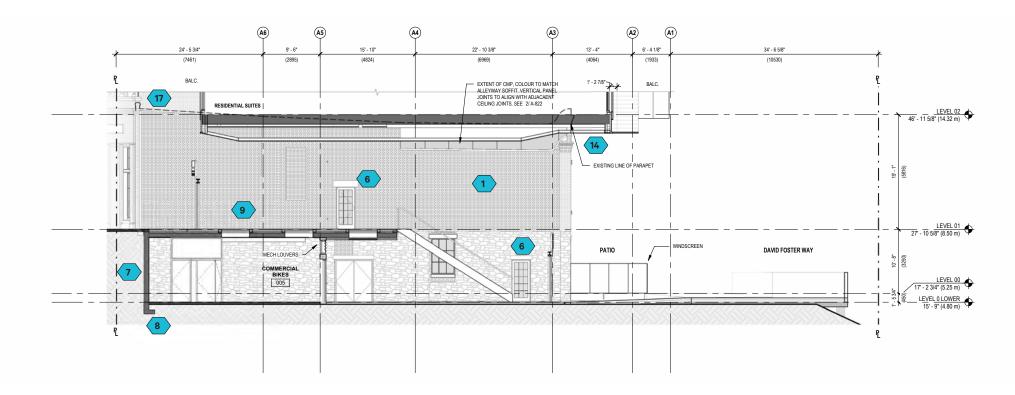
DRAWING LEGEND:



EXISTING WALLS


BUILDING SECTION A

SCALE: 1/16" - 1' 0"



BUILDING SECTION B

SCALE: 1/16" - 1' 0"

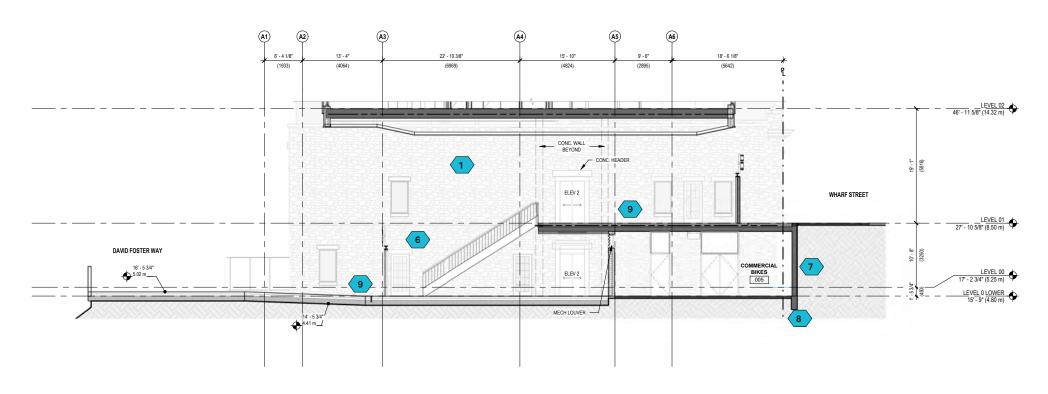





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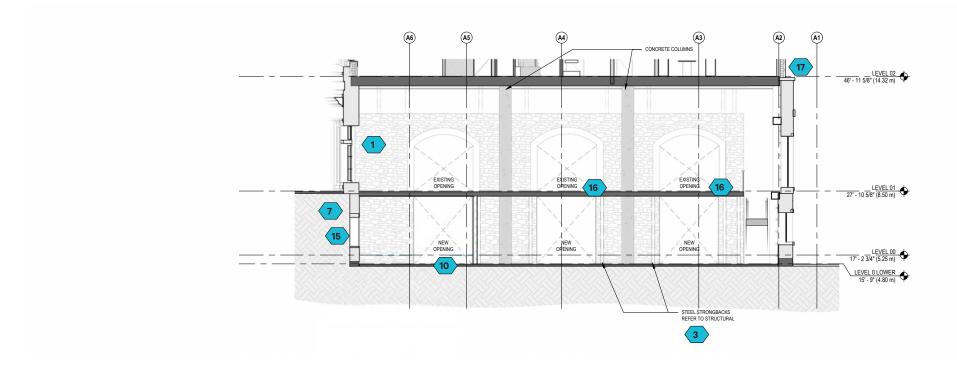
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EXISTING WALLS


BUILDING SECTION C

SCALE: 1/16" - 1' 0"



BUILDING SECTION D

SCALE: 1/16" - 1' 0"

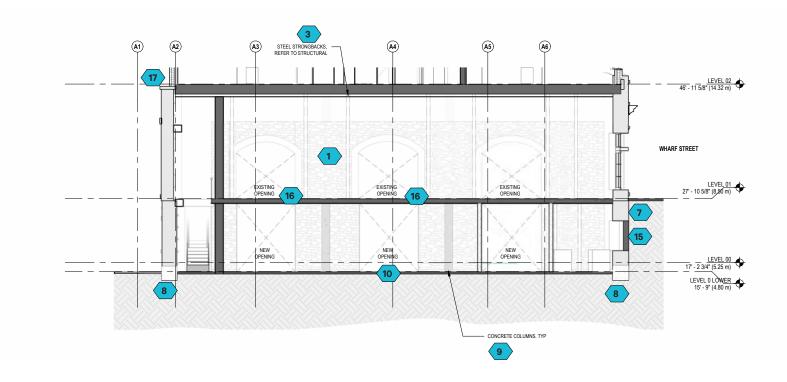





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DRAWING LEGEND:



EXISTING WALLS

STRUCTURAL DRAWINGS

SEISMIC REINFORCEMENT OF EXISTING BUILDINGS












HERITAGE TAX INCENTIVE PROGRAM

PAGE 18 OF 19

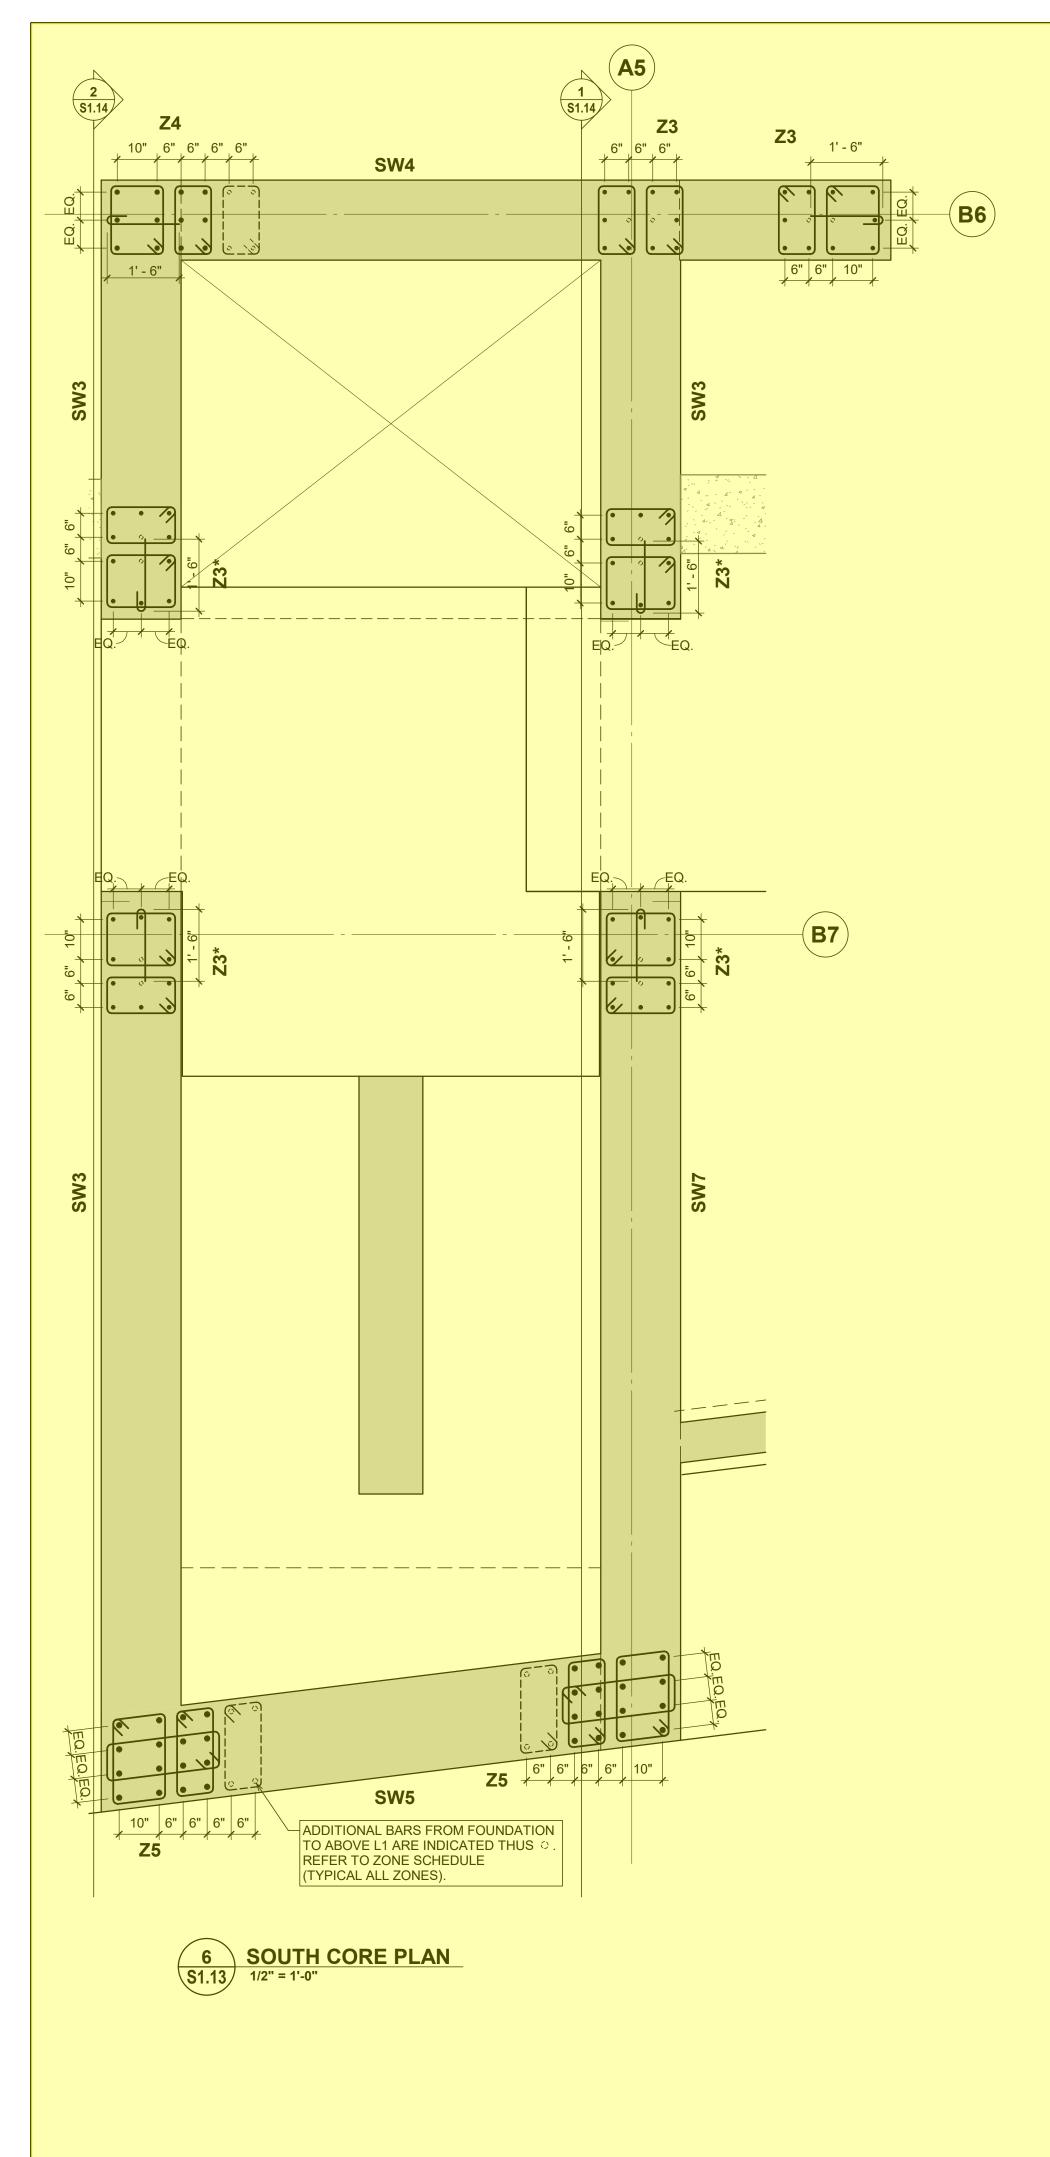

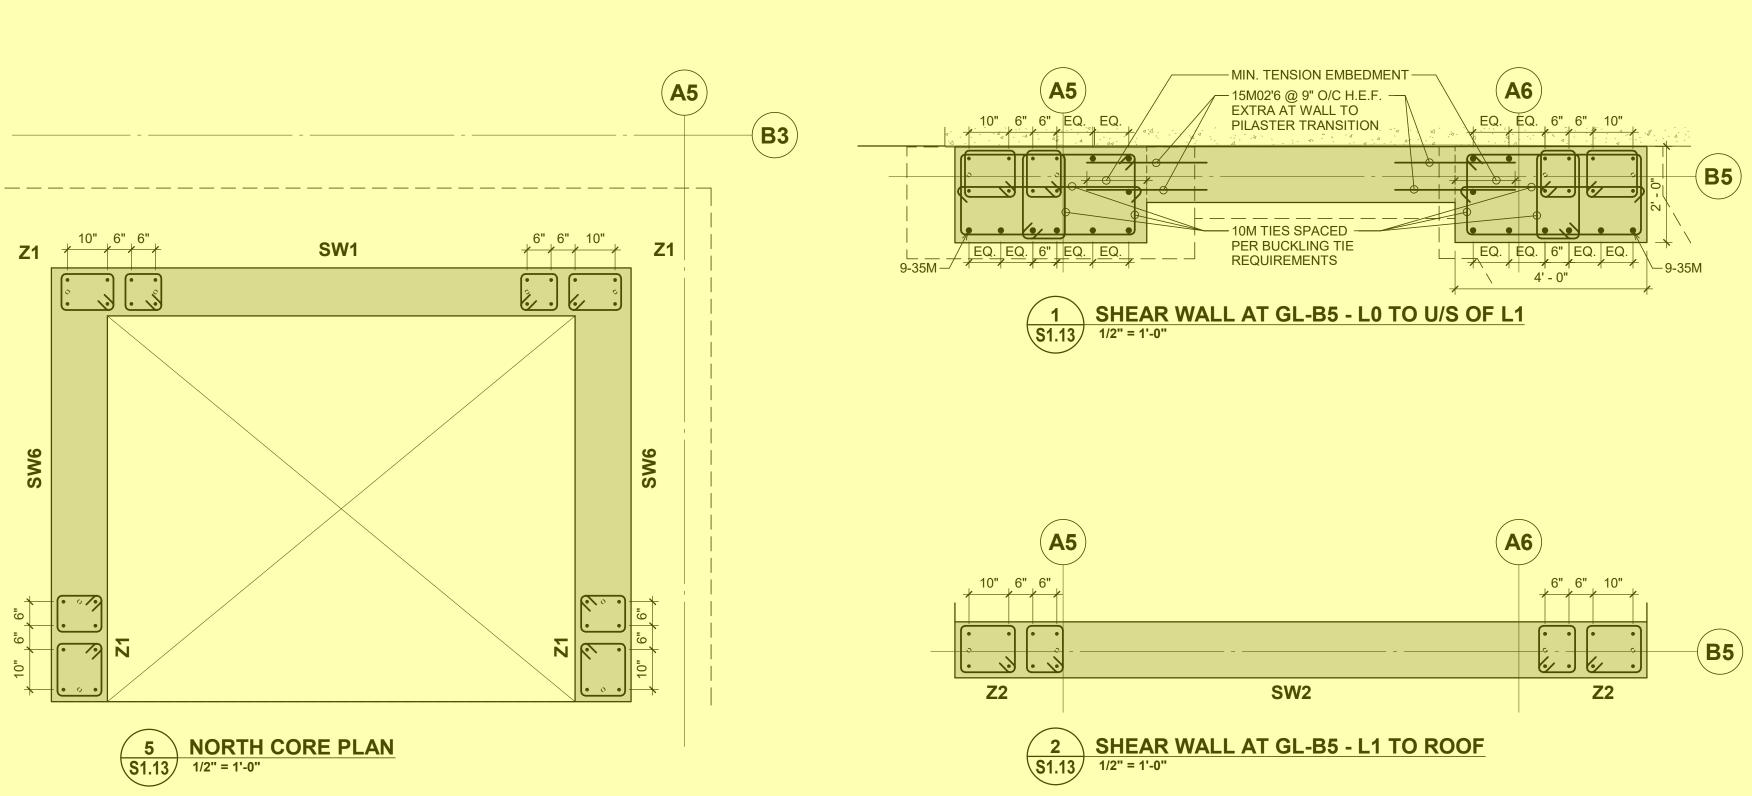

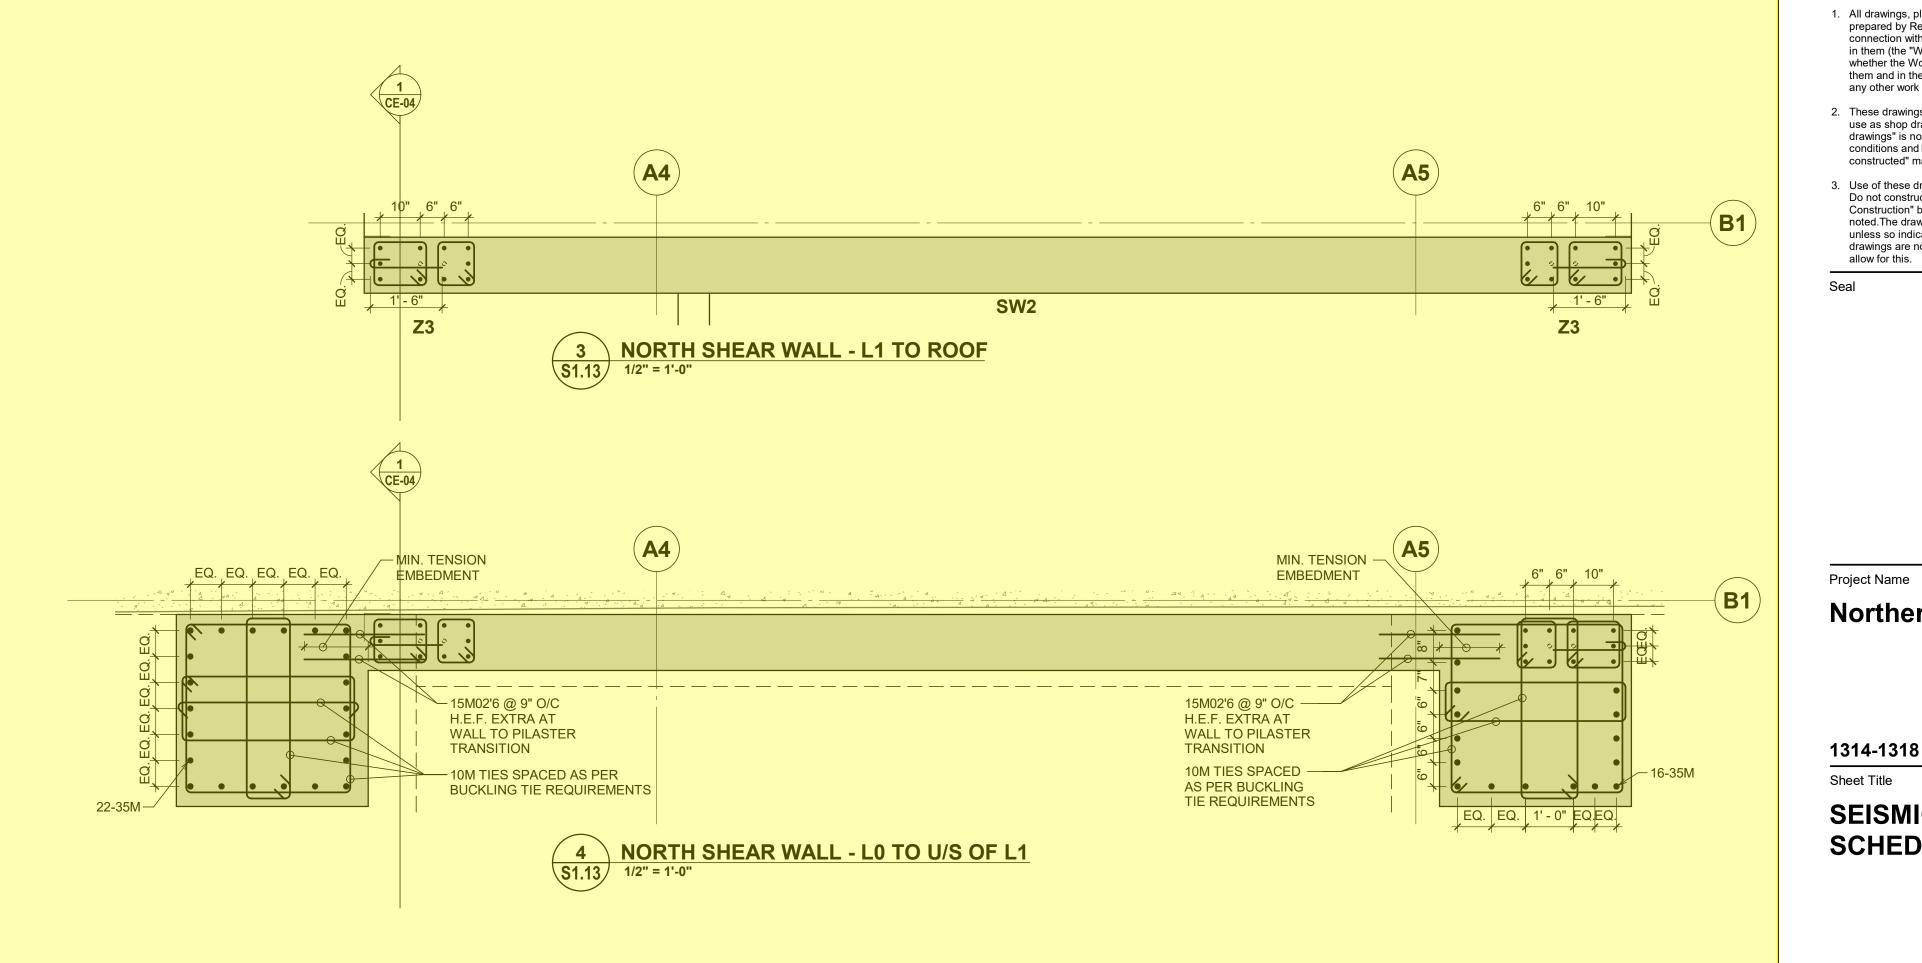



Read Jones Christoffersen Ltd. Engineers rjc.ca

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ITEMS HIGHLIGHTED IN YELLOW ARE REQUIRED FOR SEISMIC RESTRAINT OF THE HERITAGE BUILDINGS AND SUPPORT OF THE ADDITIONAL

MATERIAL COST OF THE HIGHLIGHTED ITEMS ARE FOR SUPPORT OF THE HISTORIC ELEMENTS

FOR COSTING PURPOSES 14.6% OF THE

FLOORS ABOVE.

SEISMIC KEY PLAN NOTES

*- INDICATES THAT BUCKLING PREVENTION TIES SHALL BE USED THE FULL HEIGHT OF ZONE.

5	Issued for Tender	2022-09-30	AP
4	Issued for Building Permit	2022-06-24	AP
3	90% Progress Set	2022-06-02	PM
2	Issued for 60% Review	2022-03-31	PM
1	Issued for 60% Review	2022-01-13	CP
No.	Revision	Date	Ву

Drawing Notes

 All drawings, plans, models, designs, specifications and other documents prepared by Read Jones Christoffersen Ltd. ("RJC") and used in connection with this project are instruments of service for the work shown in them (the "Work") and as such are and remain the property of RJC whether the Work is executed or not, and RJC reserves the copyright in them and in the Work executed from them, and they shall not be used for any other work or project.

2. These drawings are "design drawings" only. They may not be suitable for use as shop drawings. Use of these drawings as base drawings for "shop drawings" is not permitted unless written permission containing certain conditions and limitations is obtained from RJC. The work "as constructed" may vary from what is shown on these drawings.

3. Use of these drawings is limited to that identified in the Revision column. Do not construct from these drawings unless marked "Issued for Construction" by RJC in the Revision column, and then only for the parts noted. The drawings shall not be used for "pricing", "costing", or "tender" unless so indicated in the Revision column. "Pricing" or "Costing" drawings are not complete and any prices based on such drawings must allow for this.

Seal

Northern Junk


1314-1318 Wharf Street, Victoria B.C.


SEISMIC KEY PLANS AND SCHEDULES

		Casla	Ac indicated
Drawn By	MC	Scale	As indicated
Designed By	РМ	Date	30/09/2022
RJC Project N	lumber	VIC.	100479.0006
Sheet Numbe	r		Revision
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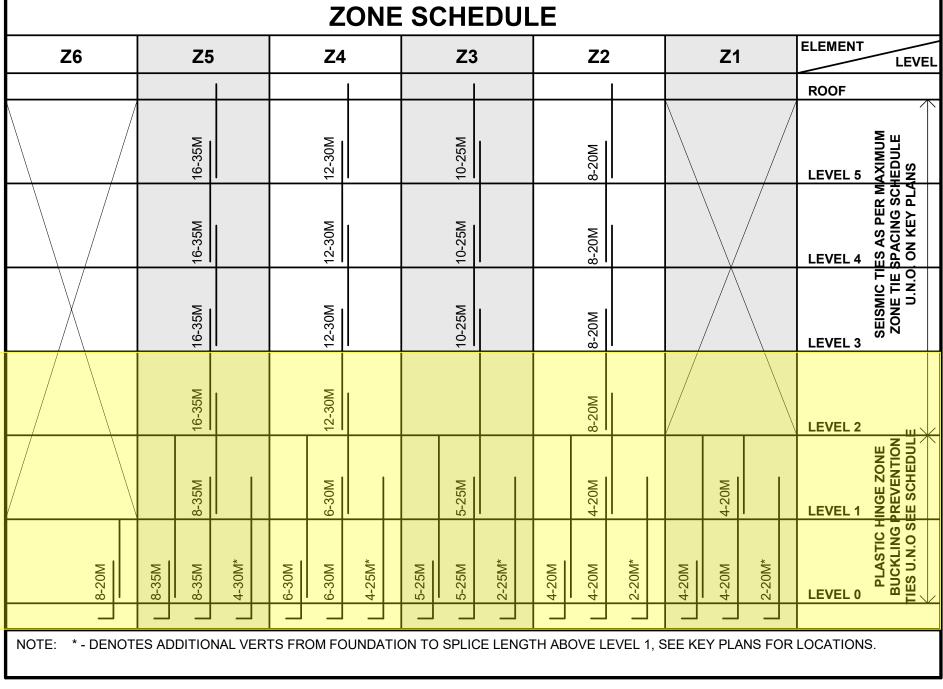
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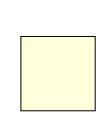


ONCRETE SHEAR WALL SCHEDULE								
	SW4	SW3	SW2	SW1	CONCRETE STRENGTH	ELEMENT		Z6
						ROOF		
						LEVEL 5		
						LEVEL 4		
				6 12" O/C		LEVEL 3		
- .E.F. E.F	20" WALL 15M @ 12" V.E.F. 15M @ 10" H.E.F.		14" WALL 10M @ 8" V.E.F. 15M @ 12" H.E.F. ↓	- ADD 15M036 DOWELS @ 12	U.N.O.	LEVEL 2		
DOWELS @ 10" O/C					45 MPa U.N.O.	EVEL 1		
- E.F. RIZ. 3)	20" WALL 15M @ 12" V.E.F. 20M @ 7" H.E.F.	20" WALL 15M @ 12" V.E.F. 15M @ 8" H.E.F.	14" WALL 10M @ 8" V.E.F. 15M @ 7" H.E.F.	12" WALL 10M @ 12" V.E.F. 20M @ 8" H.E.F.		PLASTIC HI		MOC-8
								-
								NOTE: * - DE



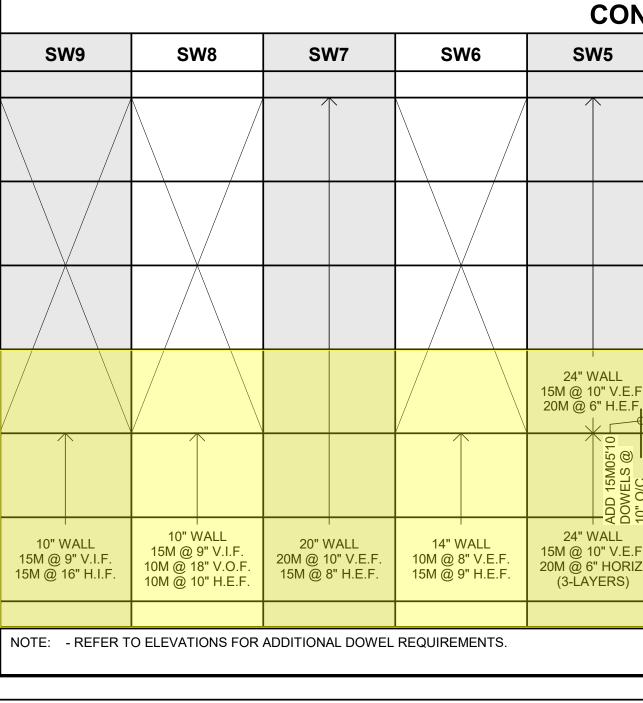

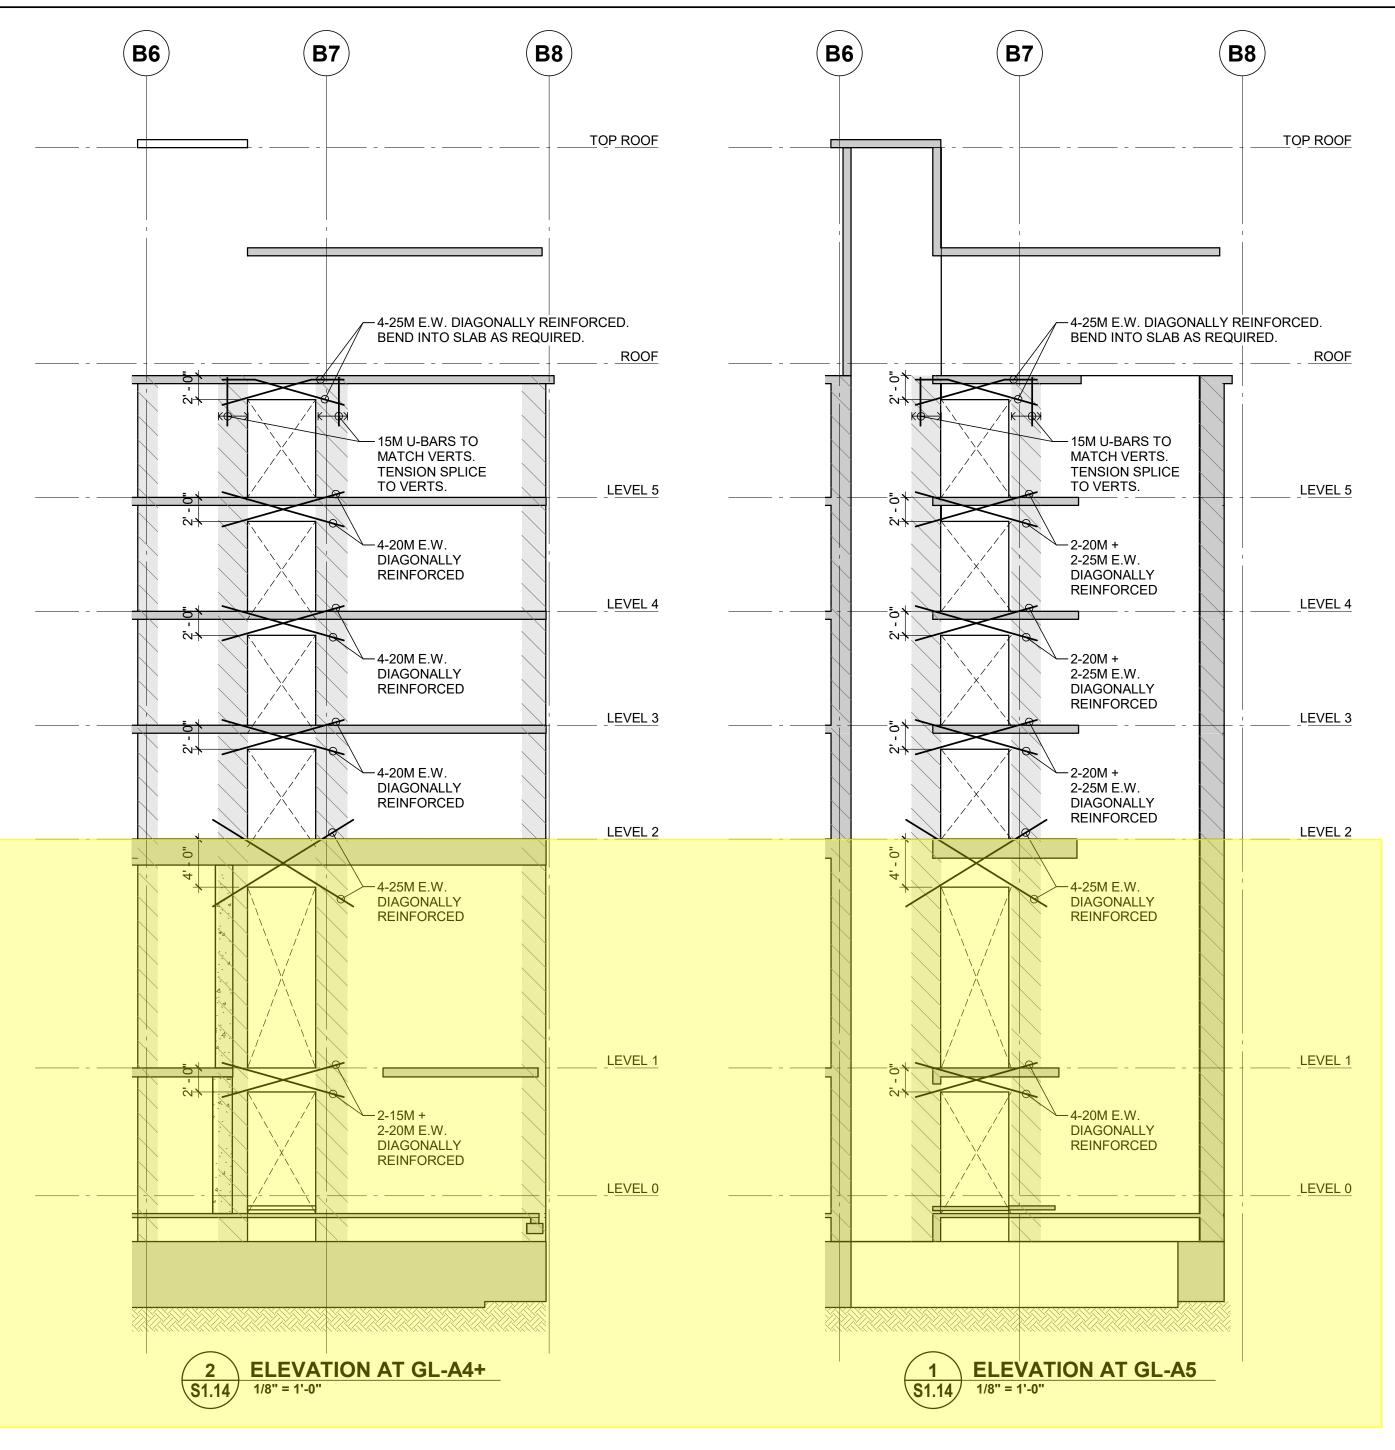Read Jones Christoffersen Ltd. Engineers rjc.ca 645 Tyee Road, Suite 220 Victoria, BC V9A 6X5 Canada tel 250-386-7794 fax 250-381-7900



ITEMS HIGHLIGHTED IN YELLOW ARE REQUIRED FOR SEISMIC RESTRAINT OF THE HERITAGE BUILDINGS AND SUPPORT OF THE ADDITIONAL FLOORS ABOVE.

FOR COSTING PURPOSES 14.6% OF THE MATERIAL COST OF THE HIGHLIGHTED ITEMS ARE FOR SUPPORT OF THE HISTORIC ELEMENTS

3	Issued for Tender	2022-09-30	AP
2	Issued for Building Permit	2022-06-24	AP
1	90% Progress Set	2022-06-02	PM
No.	Revision	Date	Ву

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Seal

Northern Junk

Project Name


Sheet Title

1314-1318 Wharf Street, Victoria B.C.

SHEAR WALL ELEVATIONS

S1.14			3
Sheet Number			Revision
RJC Project N	umber	VIC.	100479.0006
Designed By	РМ	Date	30/09/2022
Drawn By	МС	Scale	As indicated

J

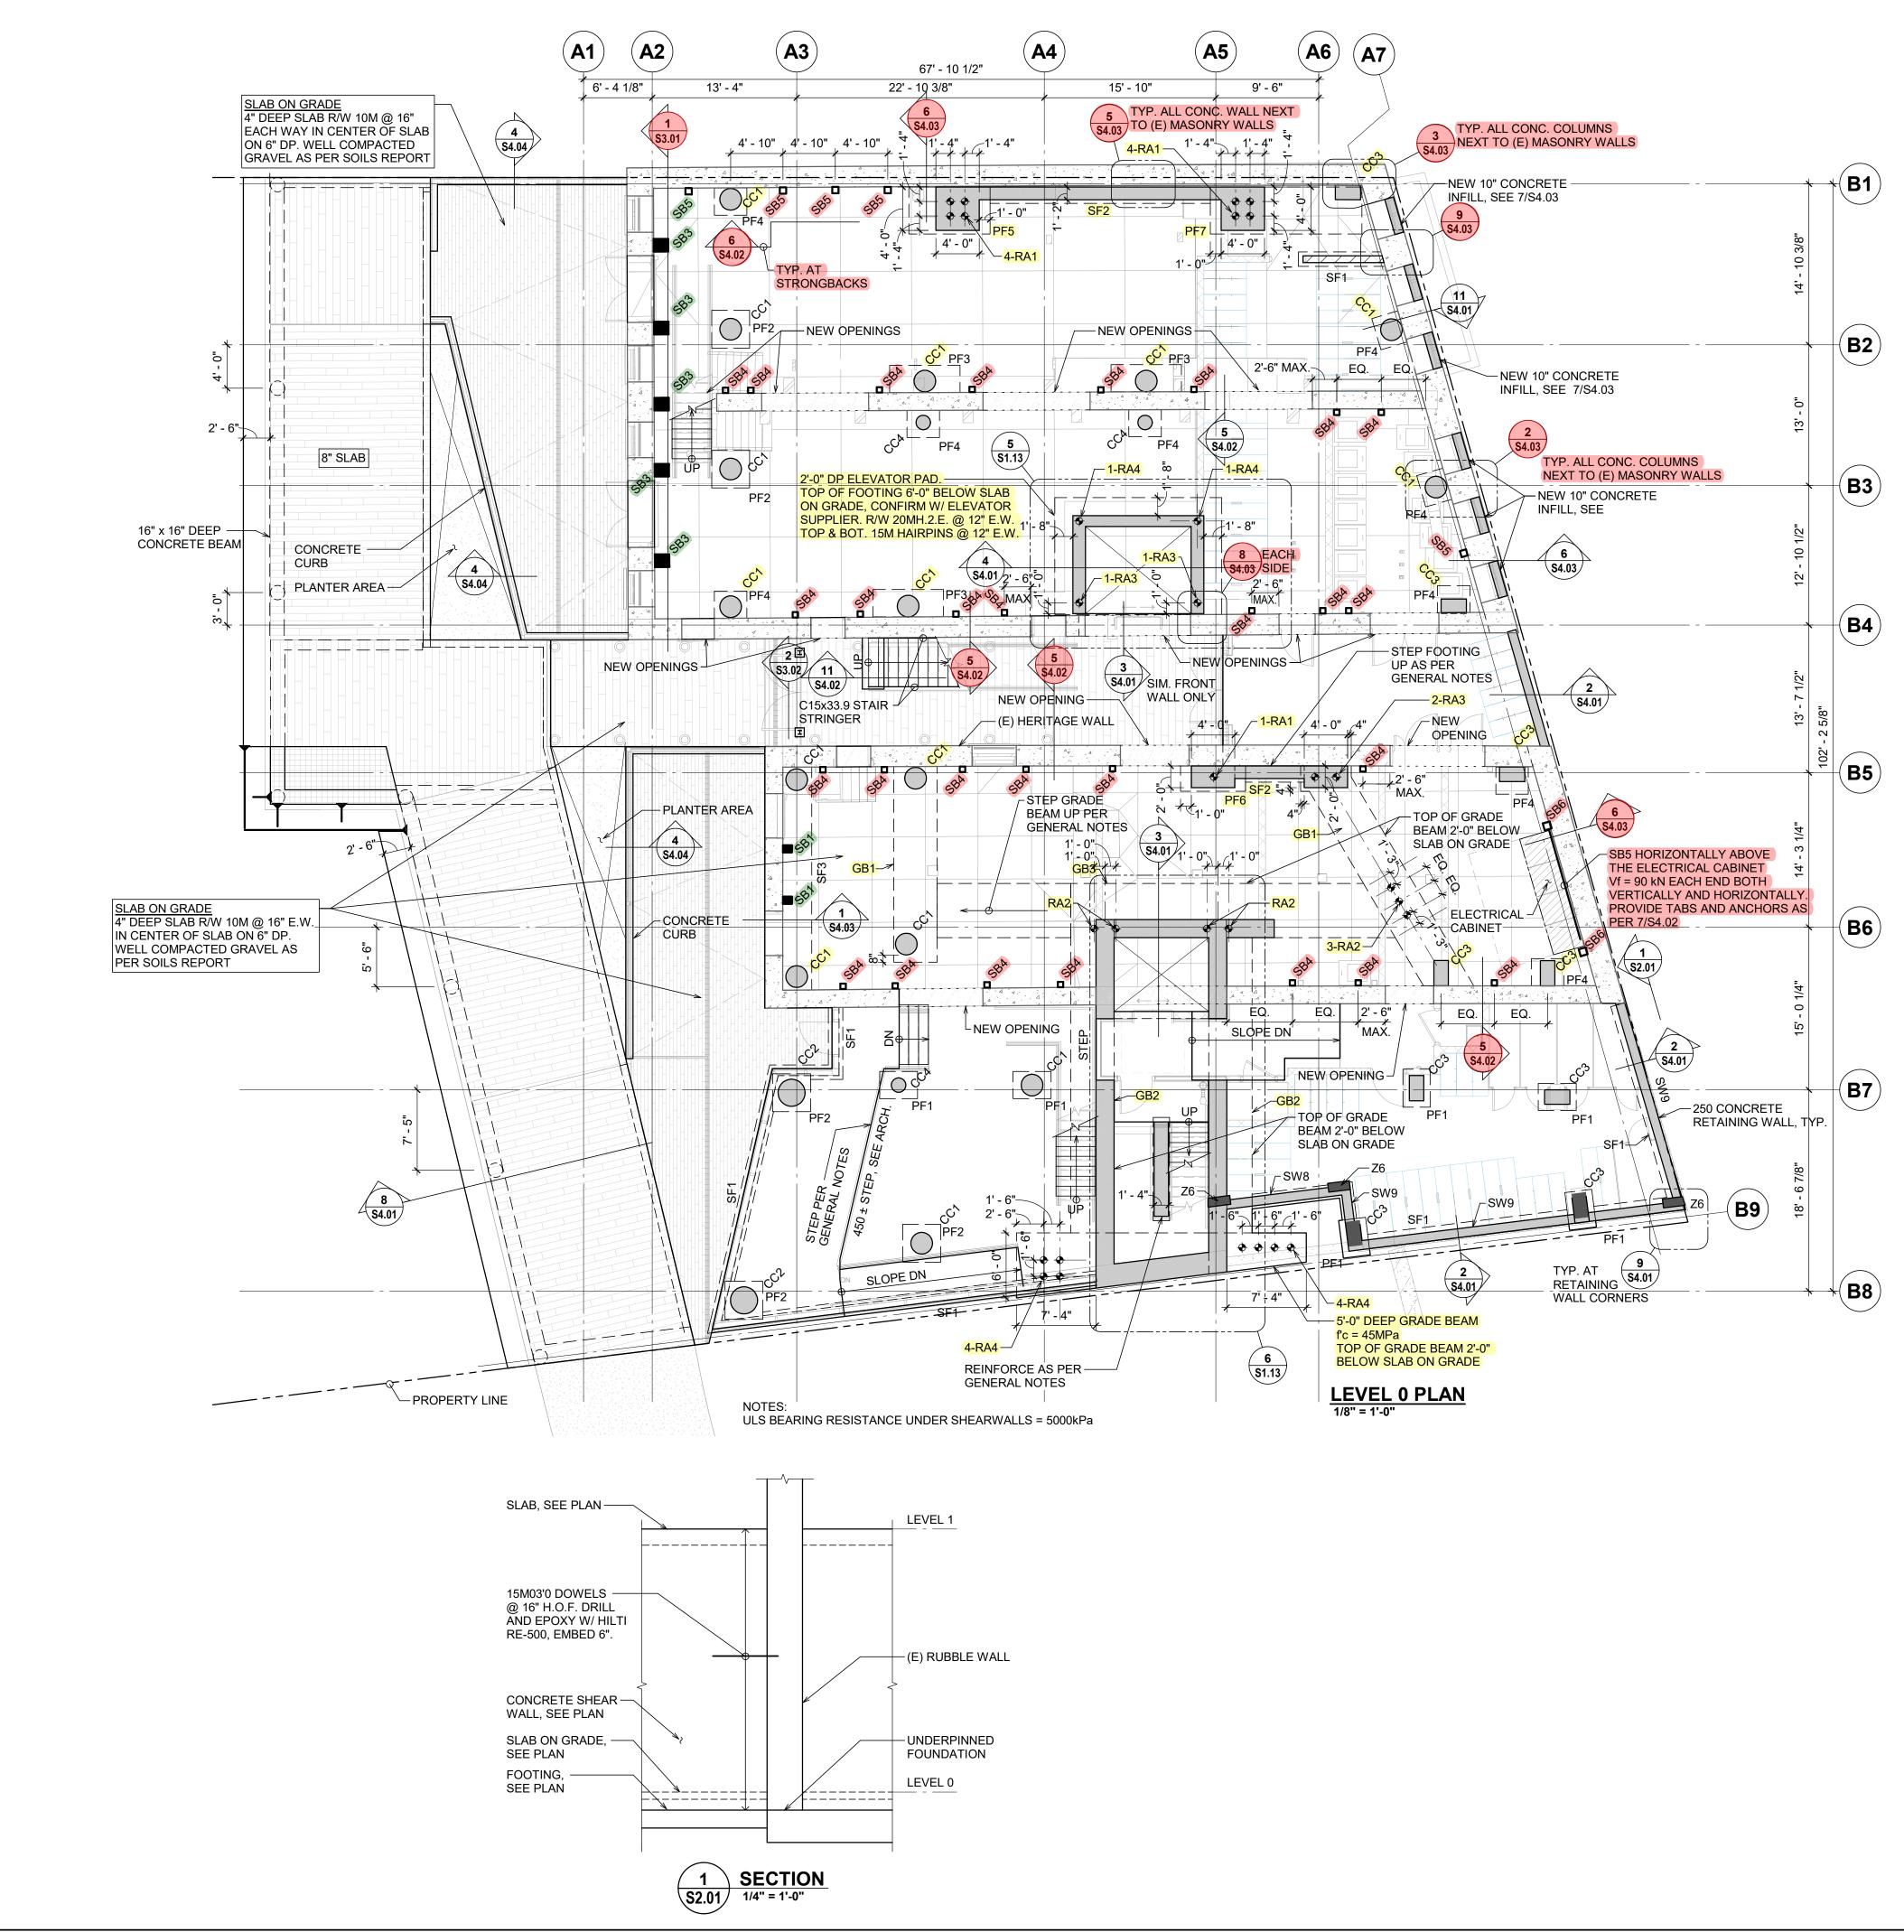

MARK PF1 2'-PF2 3'-PF3 2'-PF4 2'-PF5 4'-PF6 2'-4 PF7 4'-MARK SF1 1-SF2 1-

SF3 2-

MARK

SB1

SB2

SB3 16

SB4 HS

SB5 H SB6 HS

NOTE:

NOTE:



Creative Thinking Practical Results

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BUILDINGS
ITEMS HIGHLIGHTED IN YELLOW ARE REQUIRED FOR SEISMIC RESTRAINT OF THE HERITAGE BUILDINGS AND SUPPORT OF THE ADDITIONAL FLOORS ABOVE.
FOR COSTING PURPOSES 14.6% OF THE MATERIAL COST OF THE HIGHLIGHTED ITEMS ARE FOR SUPPORT OF THE HISTORIC ELEMENTS
ITEMS HIGHLIGHTED IN GREEN ARE REPURPOSED WOOD ELEMENTS FROM THE EXISTING FLOOR AND ROOF STRUCTURE

ITEMS HIGHLIGHTED IN RED ARE REQUIRED FOR SEISMIC RESTRAINT OF THE HERITAG

THESE ITEMS ARE REQUIRED FOR ESTRAINT OF THE HERITAGE BUILDING

STRONG BACK	SCHEDULE

SIZE	COMMENTS
0" x 8" D.FIR No.1	RE-USE (E) TIMBER, IF AVAILABLE
2" x 10" D.FIR No.1	RE-USE (E) TIMBER, IF AVAILABLE
6" x 14" D.FIR No.1	RE-USE (E) TIMBER
SS 6" x 6" x 0.250	
SS 7" x 7" x 0.5	
SS 8" x 8" x 0.5	

1. REUSED TIMBER SHALL BE GRADED PRIOR TO INSTALLATION. 2. SEE DETAILS 6/S4.02 AND 7/S4.02 FOR ADDITIONAL DETAILS.

ROCK ANCHOR SCHEDULE				
MARK	SIZE	COMMENTS		
RA1	#18 DYWIDAG ROCK ANCHOR	HOT-ROLLED THREAD BAR		
RA2	#20 DYWIDAG ROCK ANCHOR	HOT-ROLLED THREAD BAR		
RA3	#24 DYWIDAG ROCK ANCHOR	COLD-ROLLED THREAD BAR		
RA4	#28 DYWIDAG ROCK ANCHOR	COLD-ROLLED THREAD BAR		

1. fy = 550 MPa PER CSA G30.18 2. SEE GENERAL NOTES FOR ADDITIONAL REQUIREMENTS

GRADE BEAM SCHEDULE			
MARK	SIZE	REINFORCING	
GB1	4'-0" x 5'-0" DEEP	12-30M H.2.E. TOP; 10-25M H.2.E. BOT. 15M (8-LEGS) STIRRUPS @ 16"	
GB2	4'-0" x 5'-6" DEEP	10-25M H.2.E. TOP; 12-35M H.2.E. BOT. 10M (8-LEGS) STIRRUPS @ 16"	
GB3	5'-0" x 5'-6" DEEP	14-35M TOP; 20-35M BOT. 15M (10-LEGS) STIRRUPS @ 8"	
NOTE:	ťc = 45MPa U.N.O.		

CONCRETE COLUMN SCHEDULE				
MARK	SIZE REINFORCING			
CC1	24" Ø	8-25M VERT.	10M @ 6" TIES	
CC2	30" Ø	12-25M VERT.	10M @ 6" TIES	
CC3	16" x 28"	12-20M VERT.	10M @ 4 1/2" TIES	
CC4	16" Ø	6-20M VERT.	10M @ 4 1/2" TIES	
CC5	10" x 24"	10-25M VERT.	10M @ 5" TIES	
<u>NOTE:</u>	1. (TR) DENOTES TRANSFER COLUMN	I		

PAD FOOTING SCHEDULE				
SIZE	REINFORCING			
'-6" x 3'-6" x 16" DEEP	4-20M H.2.E. L.W BOT. 7-20M H.2.E. S.W. BOT.			
'-6" x 3'-6" x 16" DEEP	5-20M H.2.E. E.W BOT.			
'-6" x 6'-6" x 30" DEEP	6-25M H.2.E. L.W BOT. 10-20M H.2.E. S.W. BOT.			
'-6" x 3'-0" x 16" DEEP	4-20M H.2.E. E.W. BOT.			
'-4" x 8'-5" x 32" DEEP	10-35M H.2.E. L.W BOT. 12-20M H.2.E. S.W. BOT.			
'-4" x 6'-0" x 36" DEEP	5-20M H.2.E. L.W BOT. 6-20M H.2.E. S.W. BOT.			
'-4" x 14'-0" x 48" DEEP	20-35M H.2.E. (2 LAYERS) L.W. BOT. 10-20M H.2.E. L.W. TOP 16-20M H.2.E. S.W. TOP AND BOT.			
STRIP FOOTING	SCHEDULE			
SIZE	REINFORCING			
-4" x 10" DEEP x CONT.	2-15M CONT. BOT.			
-6" x 12" DEEP x CONT.	2-15M CONT. BOT.			
-8" x 1'-8" DEEP x CONT.	4-25M H.2.E. TOP AND BOT, 10M (4 LEG) STIRRUPS @ 8" O.C.			

5	Issued for Tender	2022-09-30	AP
4	Issued for Building Permit	2022-06-24	AP
3	90% Progress Set	2022-06-02	PM
2	Issued for 60% Review	2022-03-31	PM
1	Issued for 60% Review	2022-01-13	CP
No.	Revision	Date	Ву

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Seal

Northern Junk


Project Name

1314-1318 Wharf Street, Victoria B.C.

Sheet Title LEVEL 0 CONCRETE **OUTLINE PLAN**

Drawn By	MC	Scale	As indicated
Designed By	РМ	Date	30/09/2022
RJC Project Number		VIC.	100479.0006
Sheet Number	-		Revision


S2.01

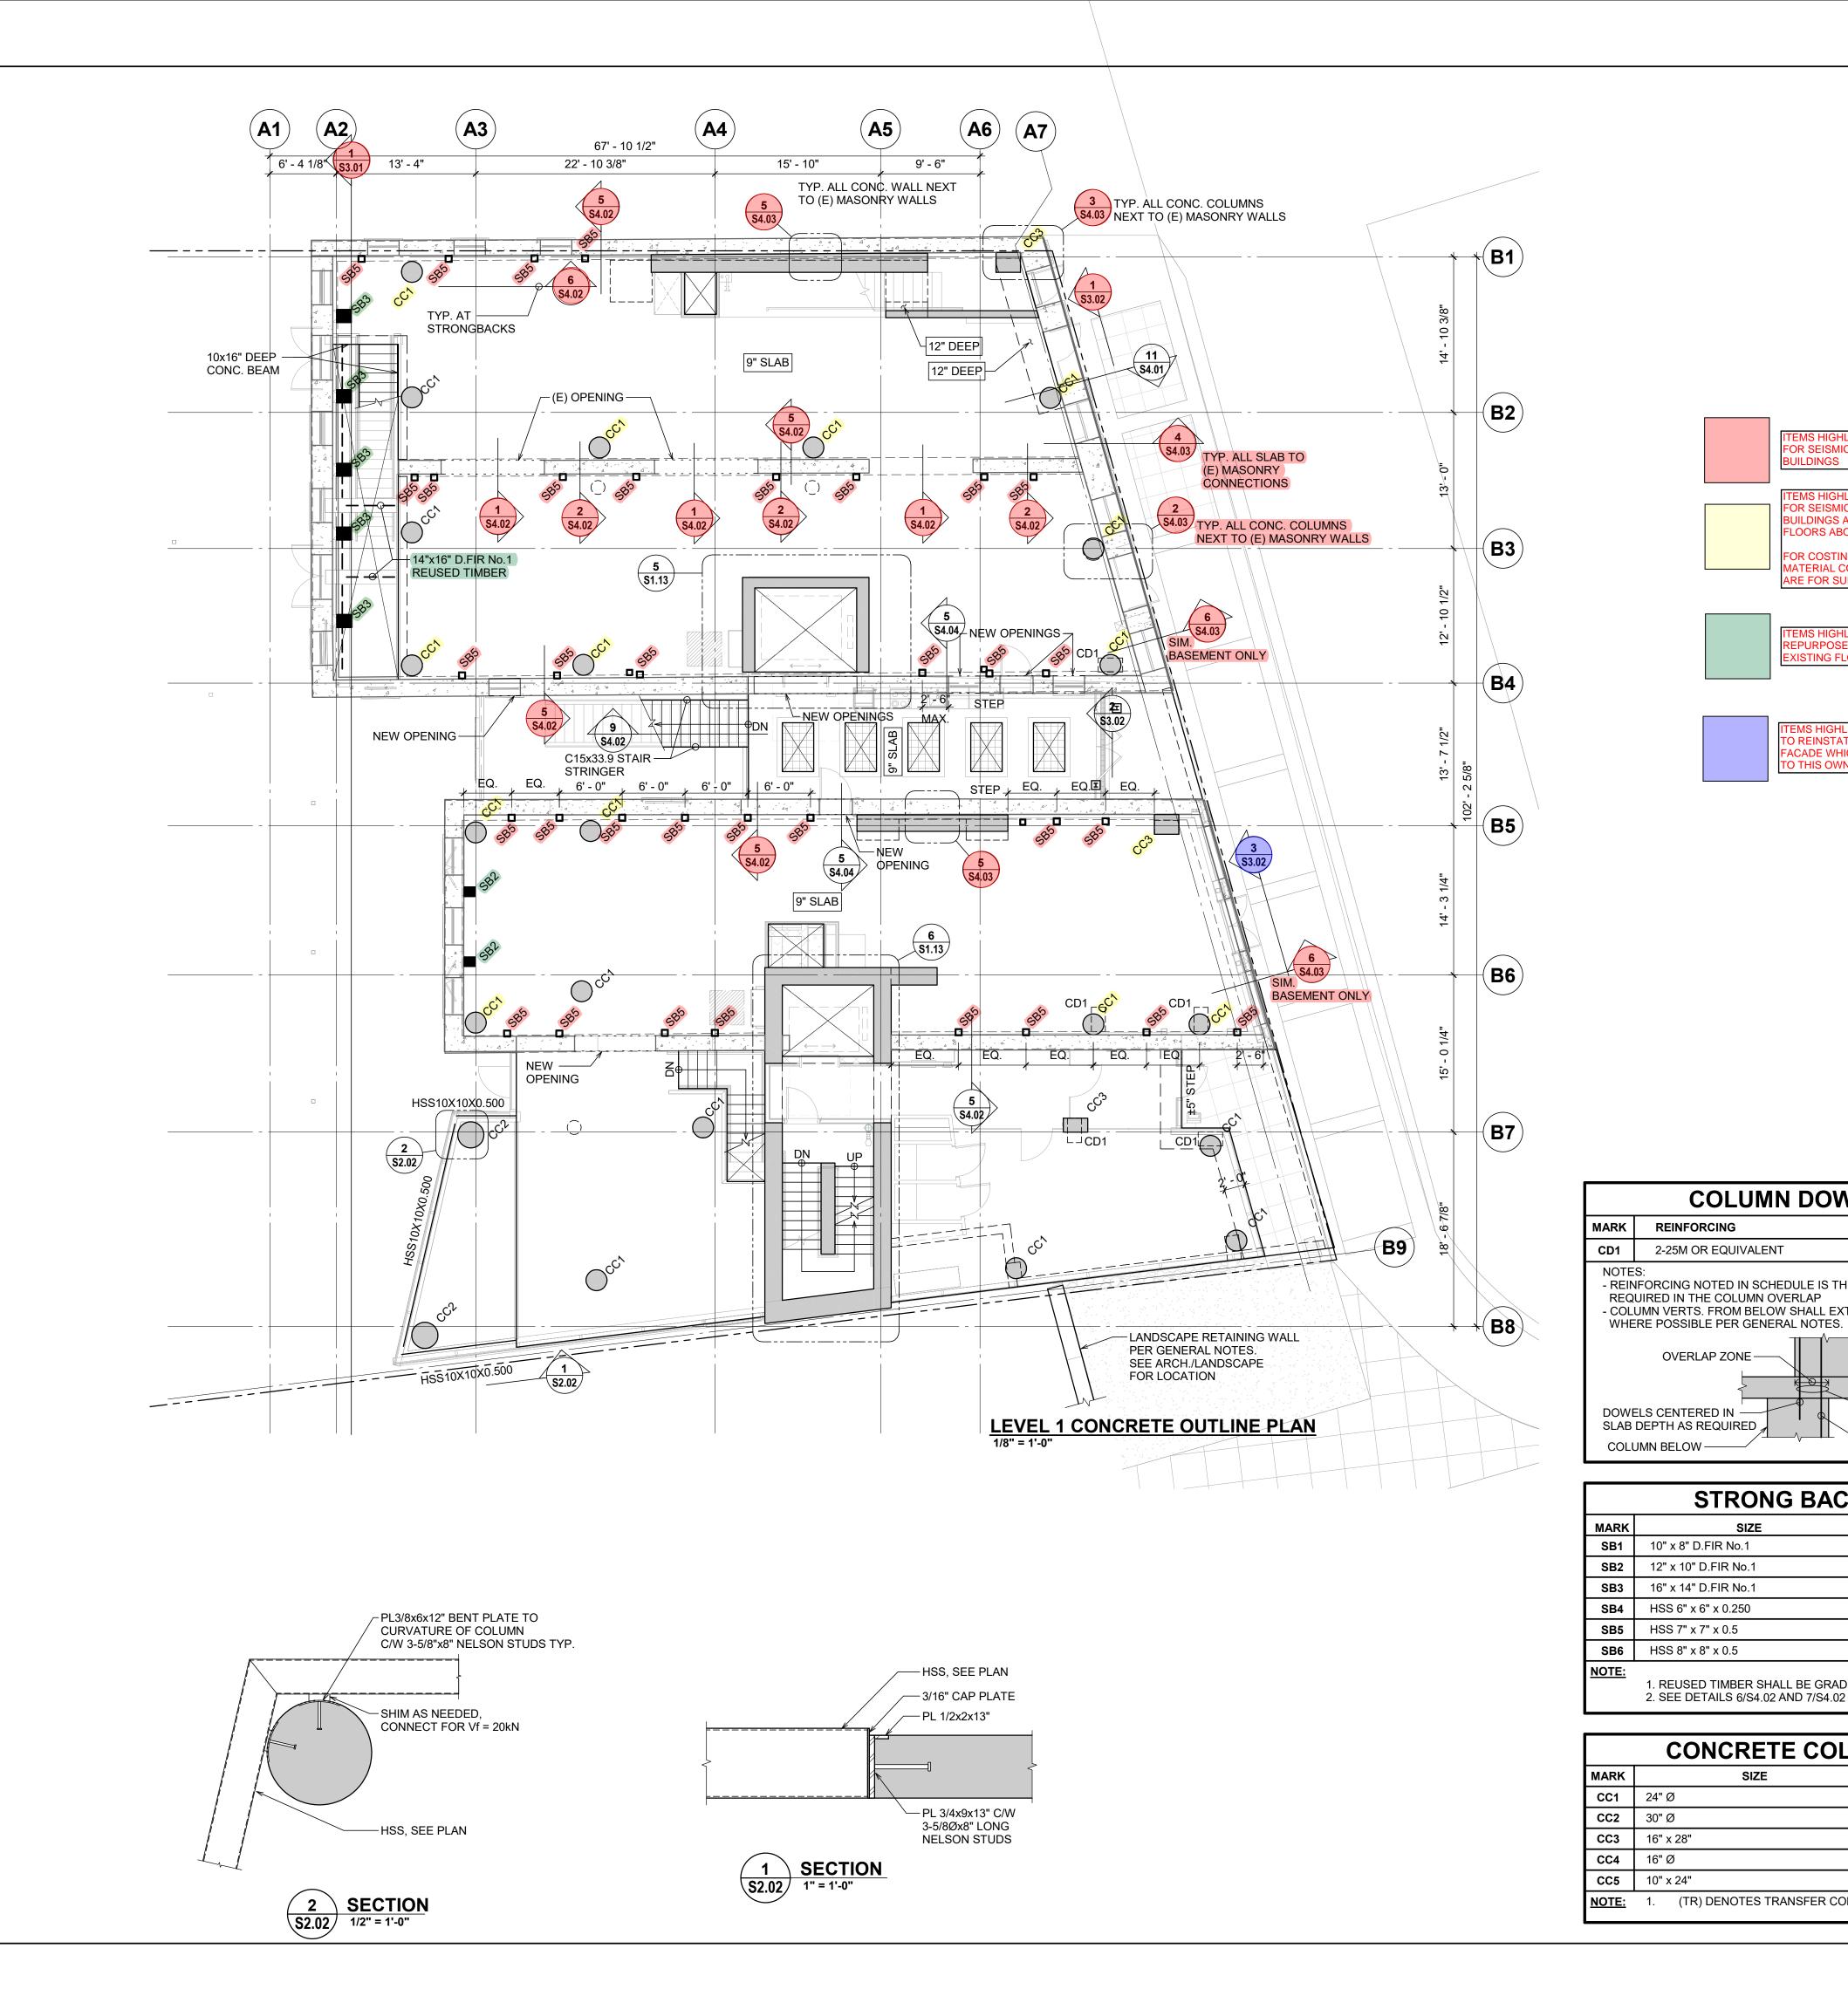



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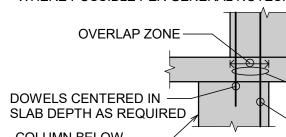
ITEMS HIGHLIGHTED IN GREEN ARE REPURPOSED WOOD ELEMENTS FROM THE ISTING FLOOR AND ROOF STRUCTURE

MS HIGHLIGHTED IN BLUE ARE EFFORT TO REINSTATE THE ORIGINAL HERITAGE FACADE WHICH WAS DEMOLISHED PRIOR O THIS OWNER

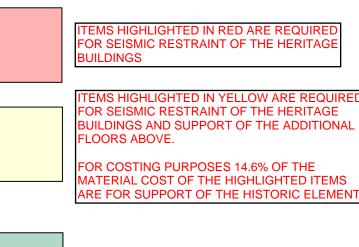COLUMN DOWEL SCHEDULE

REINFORCING

- REINFORCING NOTED IN SCHEDULE IS THE MINIMUM AMOUNT OF REINFORCEMENT REQUIRED IN THE COLUMN OVERLAP - COLUMN VERTS. FROM BELOW SHALL EXTEND THROUGH THE OVERLAP ZONE



COLUMN ABOVE -TIES NOT SHOWN FOR CLARITY, SEE SCHEDULE - EQUIVALENT AREA OF STEEL SHALL BE AT LEAST THE AMOUNT NOTED

— EXTEND VERTS WHERE POSSIBLE

STRONG BACK SCHEDULE

SIZE	COMMENTS
0" x 8" D.FIR No.1	RE-USE (E) TIMBER, IF AVAILABLE
2" x 10" D.FIR No.1	RE-USE (E) TIMBER, IF AVAILABLE
6" x 14" D.FIR No.1	RE-USE (E) TIMBER
ISS 6" x 6" x 0.250	
ISS 7" x 7" x 0.5	
ISS 8" x 8" x 0.5	

1. REUSED TIMBER SHALL BE GRADED PRIOR TO INSTALLATION. 2. SEE DETAILS 6/S4.02 AND 7/S4.02 FOR ADDITIONAL DETAILS.

CONCRETE COLUMN SCHEDULE

SIZE	REINFORCING				
4" Ø	8-25M VERT.	10M @ 6" TIES			
)" Ø	12-25M VERT.	10M @ 6" TIES			
6" x 28"	12-20M VERT.	10M @ 4 1/2" TIES			
6" Ø	6-20M VERT.	10M @ 4 1/2" TIES			
)" x 24"	10-25M VERT.	10M @ 5" TIES			
(TR) DENOTES TRANSFER COLUMN	l				

Ę	5	Issued for Tender	2022-09-30	AP
	4	Issued for Building Permit	2022-06-24	AP
3	3	90% Progress Set	2022-06-02	PM
2	2	Issued for 60% Review	2022-03-31	PM
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N	lo.	Revision	Date	Ву

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Seal

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Project Name

Sheet Title


1314-1318 Wharf Street, Victoria B.C.

LEVEL 1 CONCRETE **OUTLINE PLAN**


VIC.1	00479.0006
Date	30/09/2022
Scale	As indicated
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S2.02

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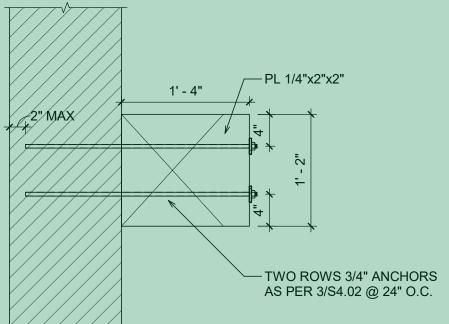




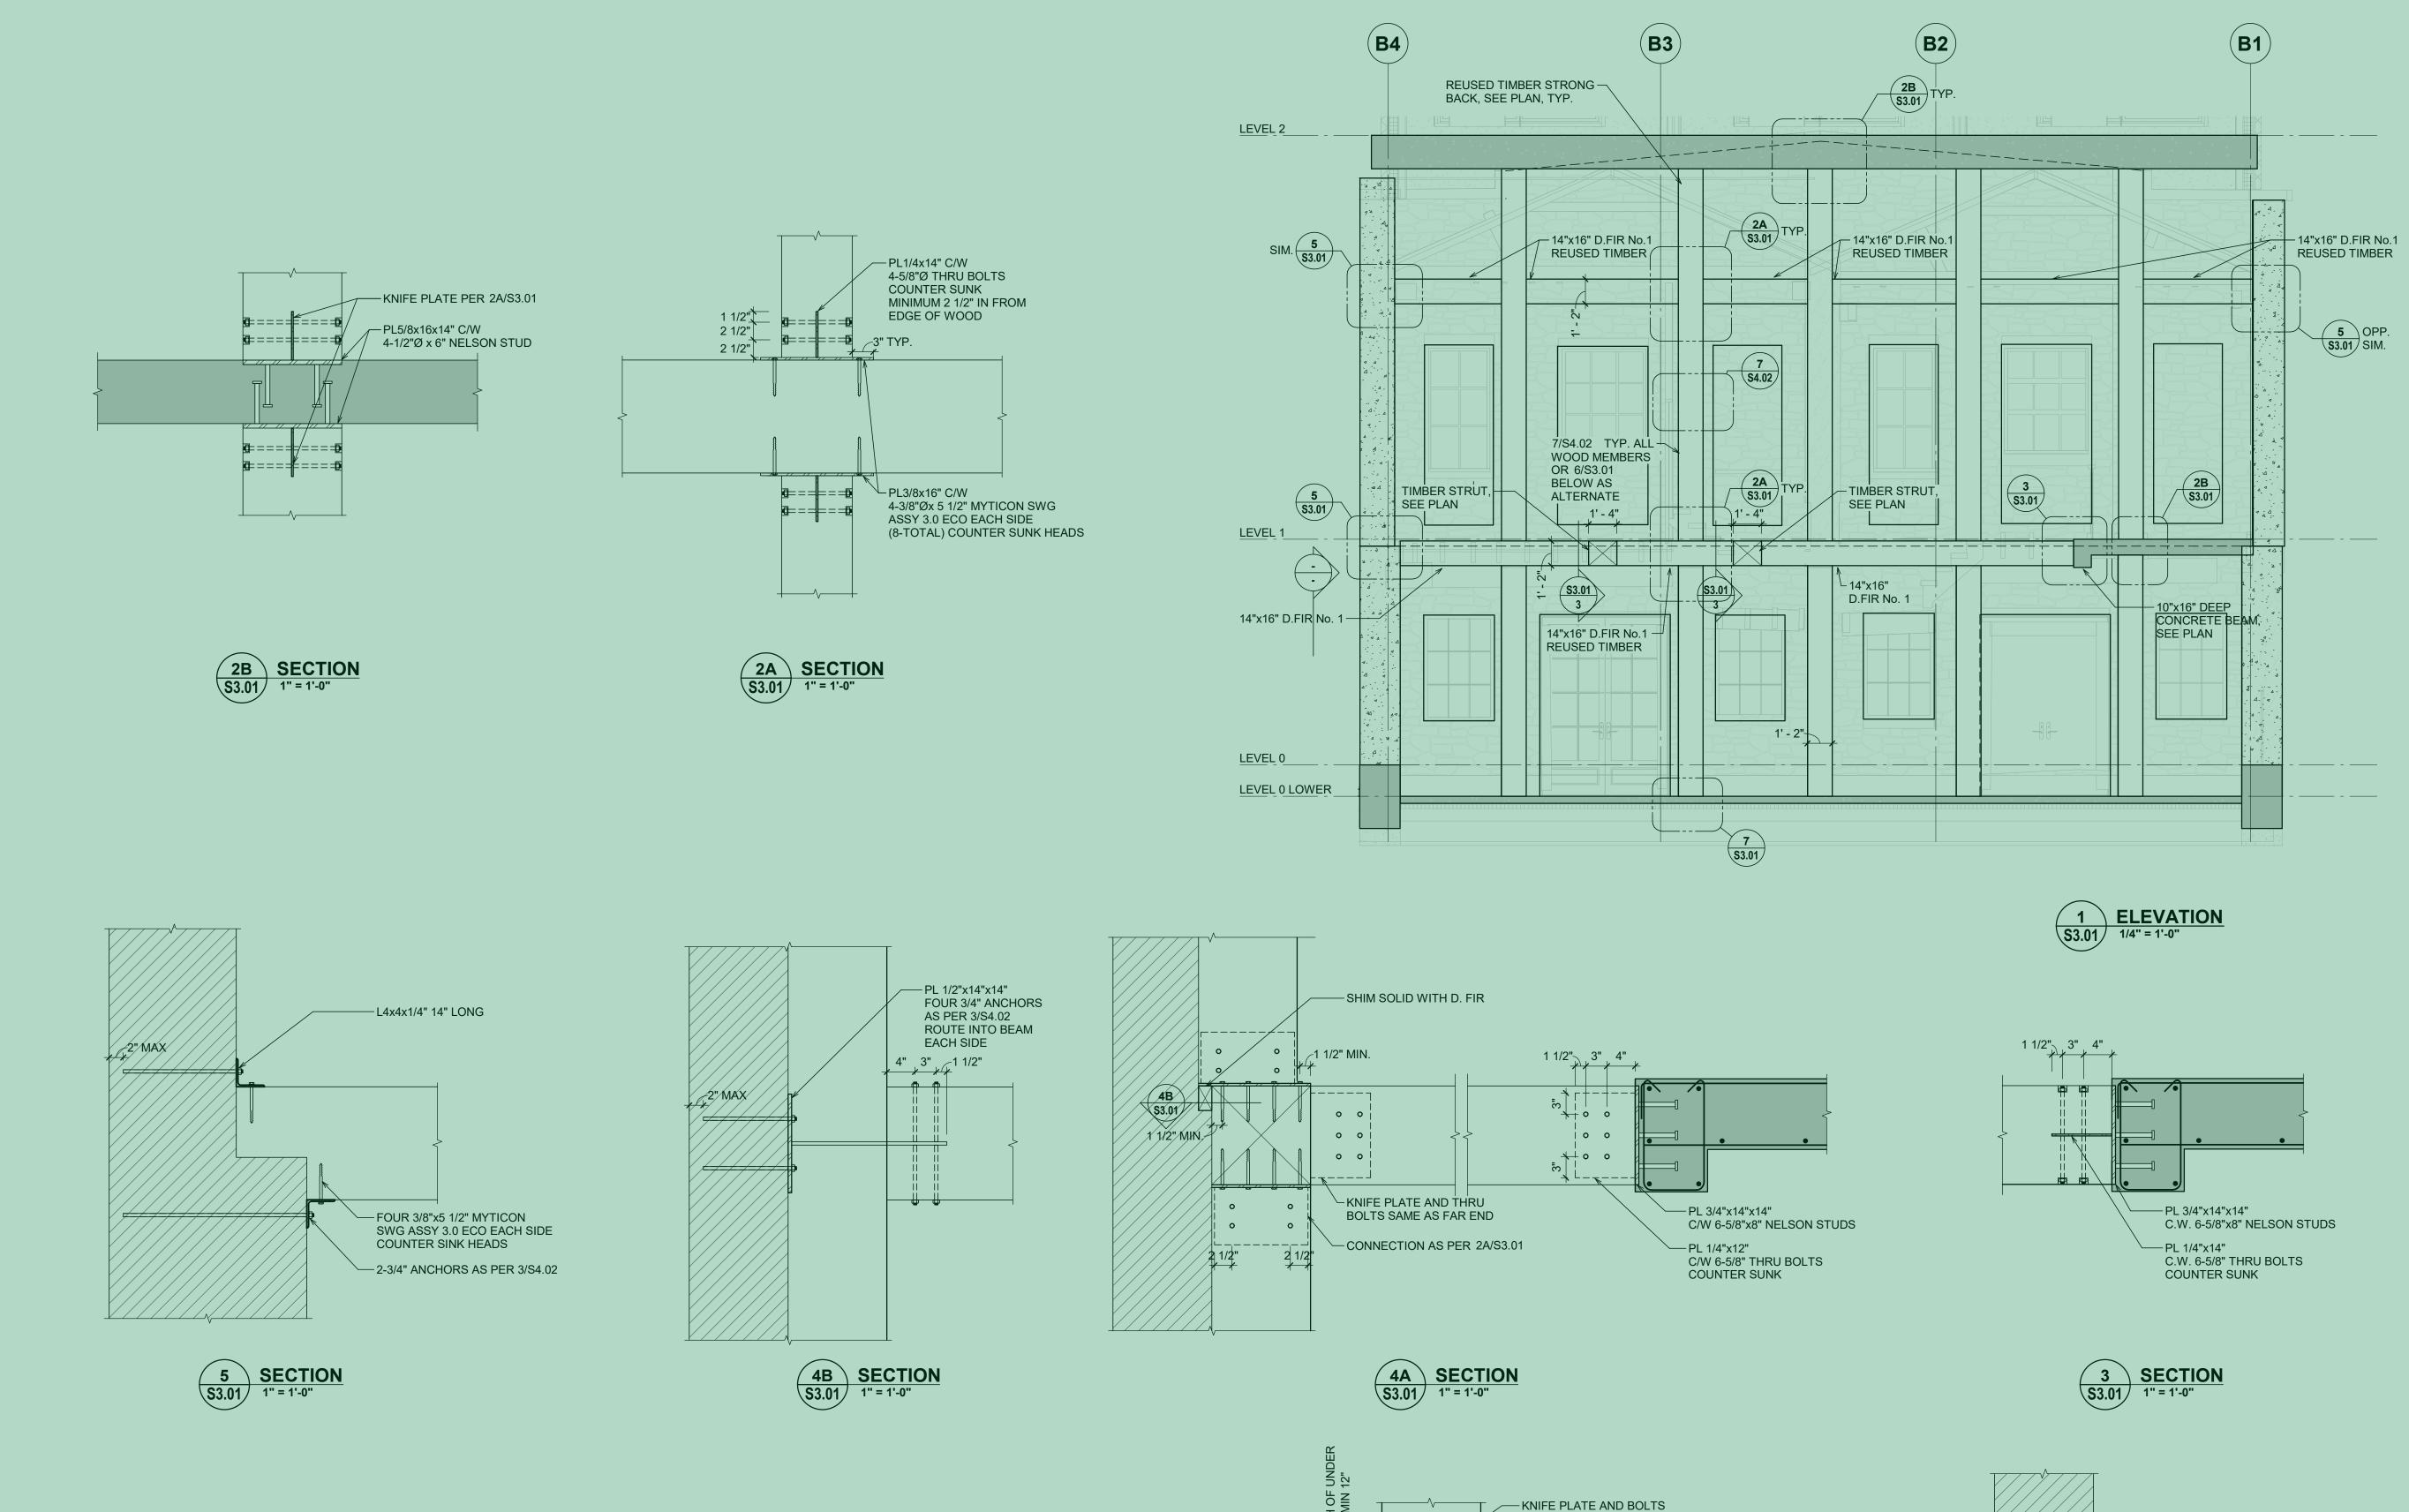

 7
 SECTION

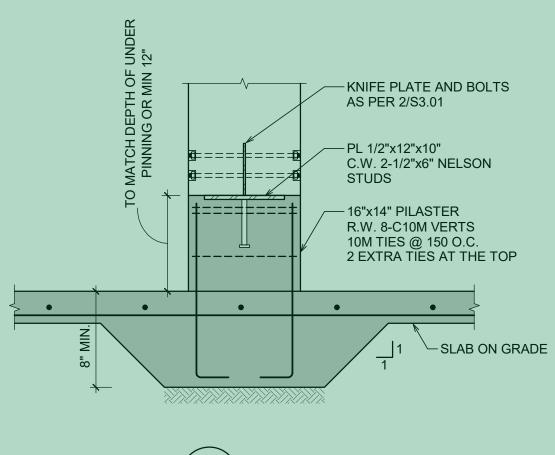 \$3.01
 1" = 1'-0"








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Engineers	
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EMS HIGHLIGHTED IN GREEN ARE EPURPOSED WOOD ELEMENTS FROM THE XISTING FLOOR AND ROOF STRUCTURE THESE ITEMS ARE REQUIRED FOR RESTRAINT OF THE HERITAGE BUILDING

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Sheet Title


1314-1318 Wharf Street, Victoria B.C.

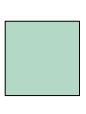
ELEVATIONS


Sheet Number			Revision
RJC Project N	umber	VIC.	100479.0006
Designed By	РМ	Date	30/09/2022
Drawn By	МС	Scale	As indicated


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Read Jones Engineers rjc.ca	Christoffersen	Ltd.
-	-	a
ITEMS HIGHLIGHTED FOR SEISMIC REST BUILDINGS		
ITEMS HIGHLIGHTED FOR SEISMIC REST BUILDINGS AND SUF FLOORS ABOVE. FOR COSTING PURF MATERIAL COST OF ARE FOR SUPPORT	PORT OF THE HERI PORT OF THE ADD OSES 14.6% OF TH THE HIGHLIGHTED	DITIONAL IE DITEMS
ITEMS HIGHLIGHTED TO REINSTATE THE FACADE WHICH WAS TO THIS OWNER	ORIGINAL HERITAG	θE
		45
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Seal

Project Name

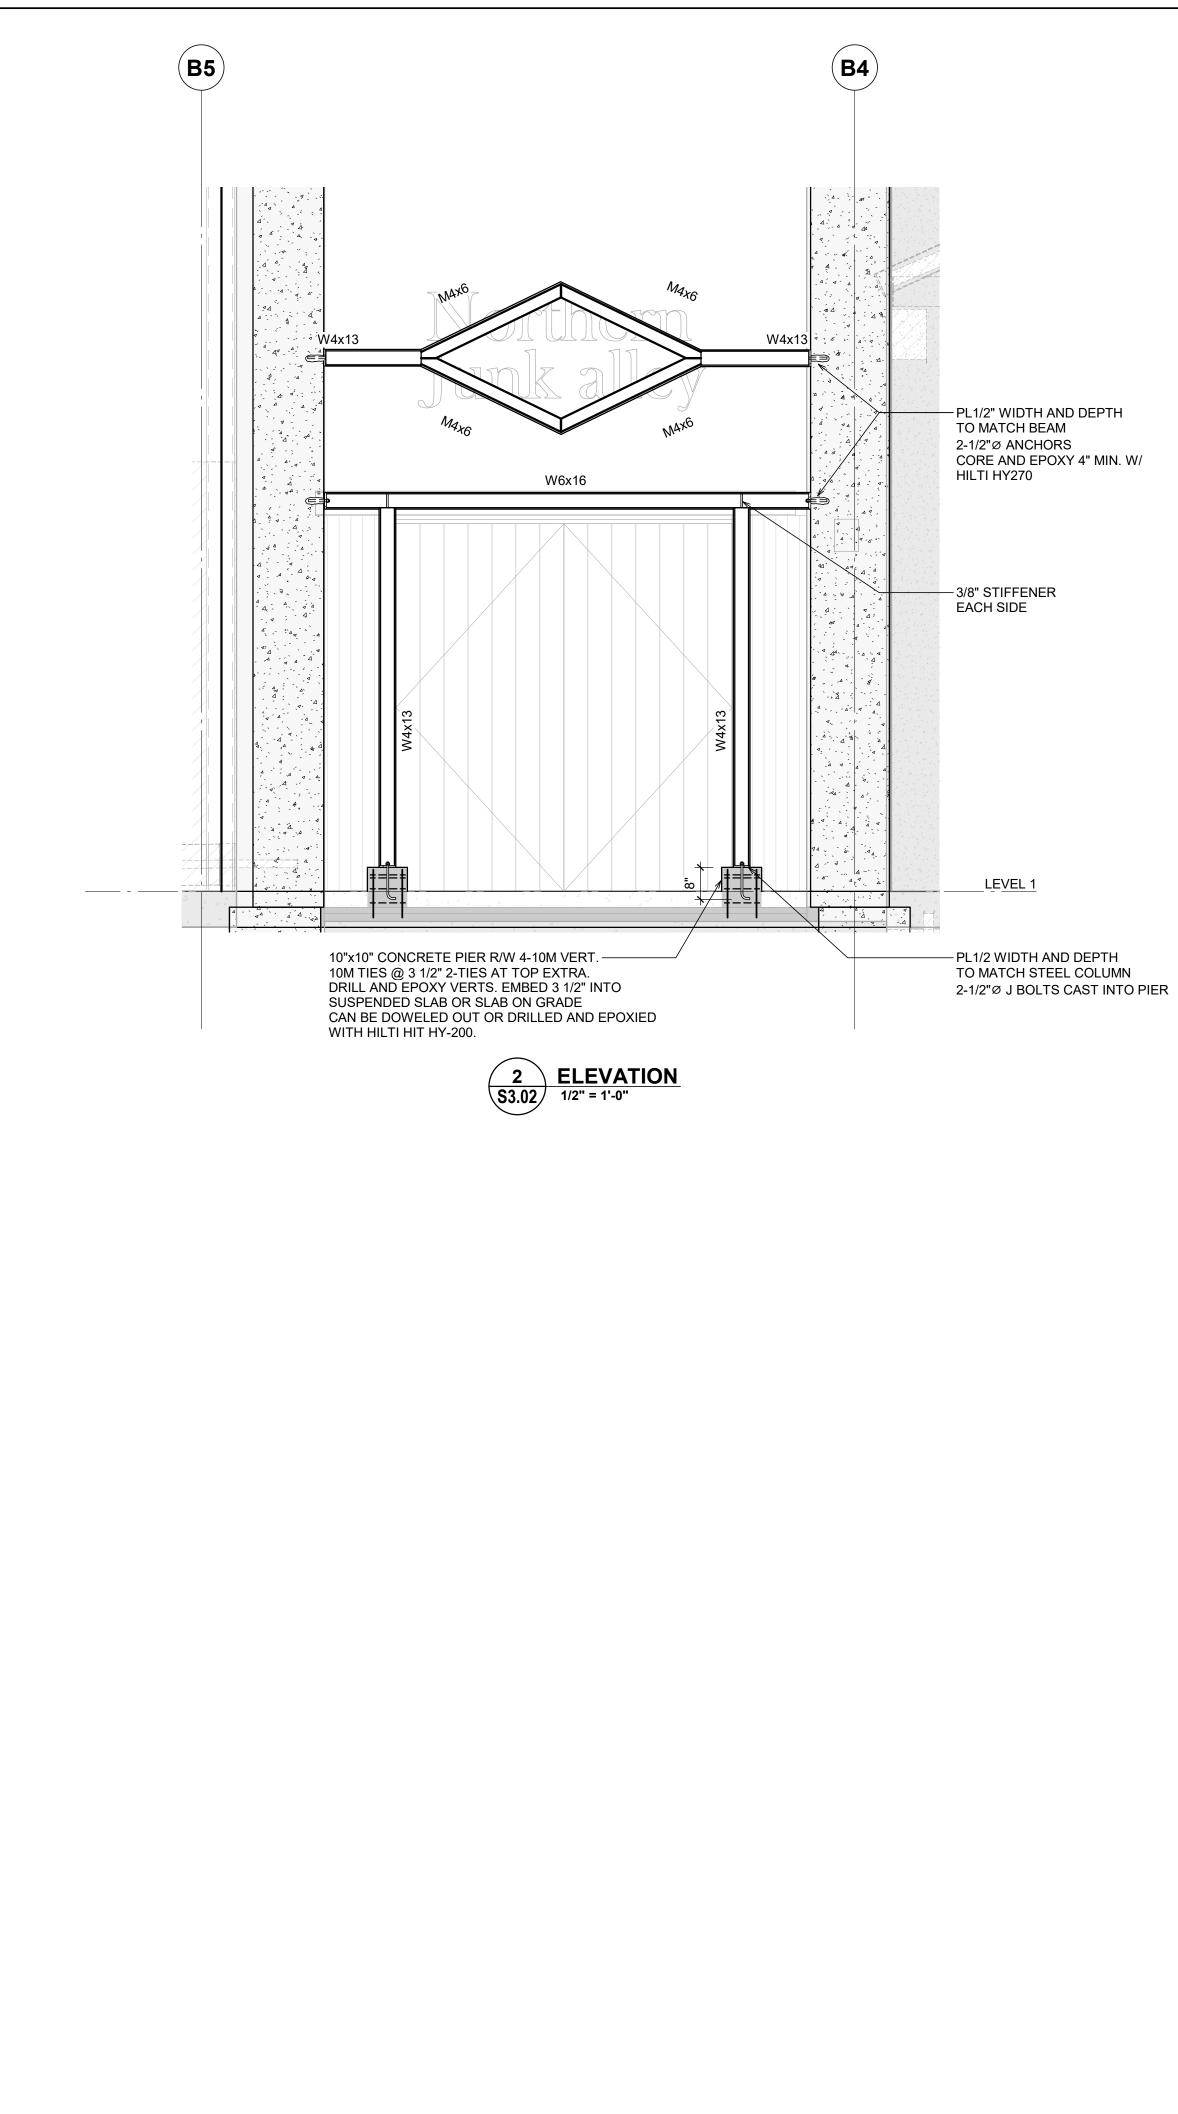Sheet Title

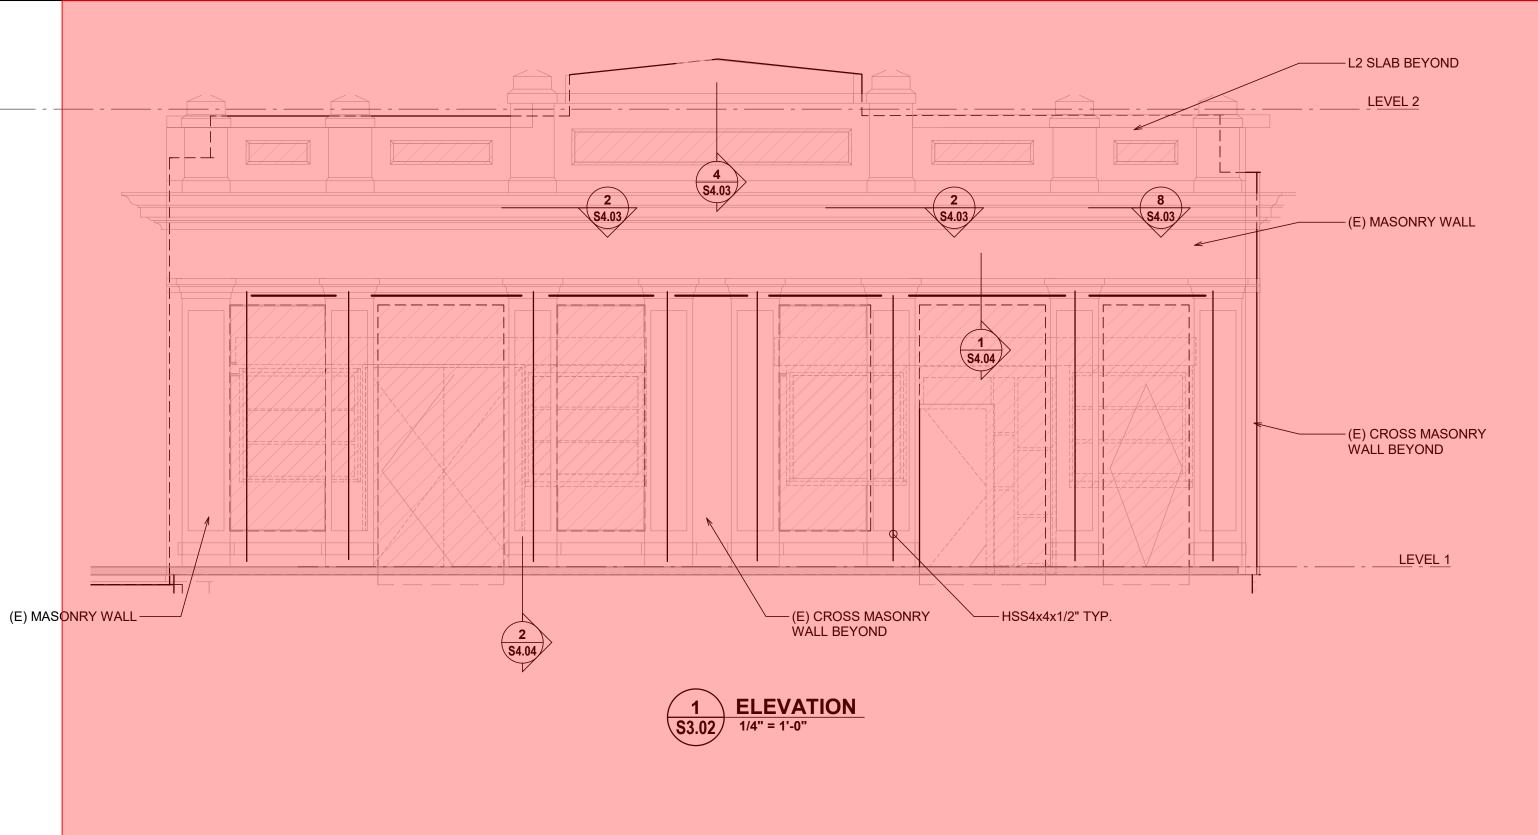Northern Junk

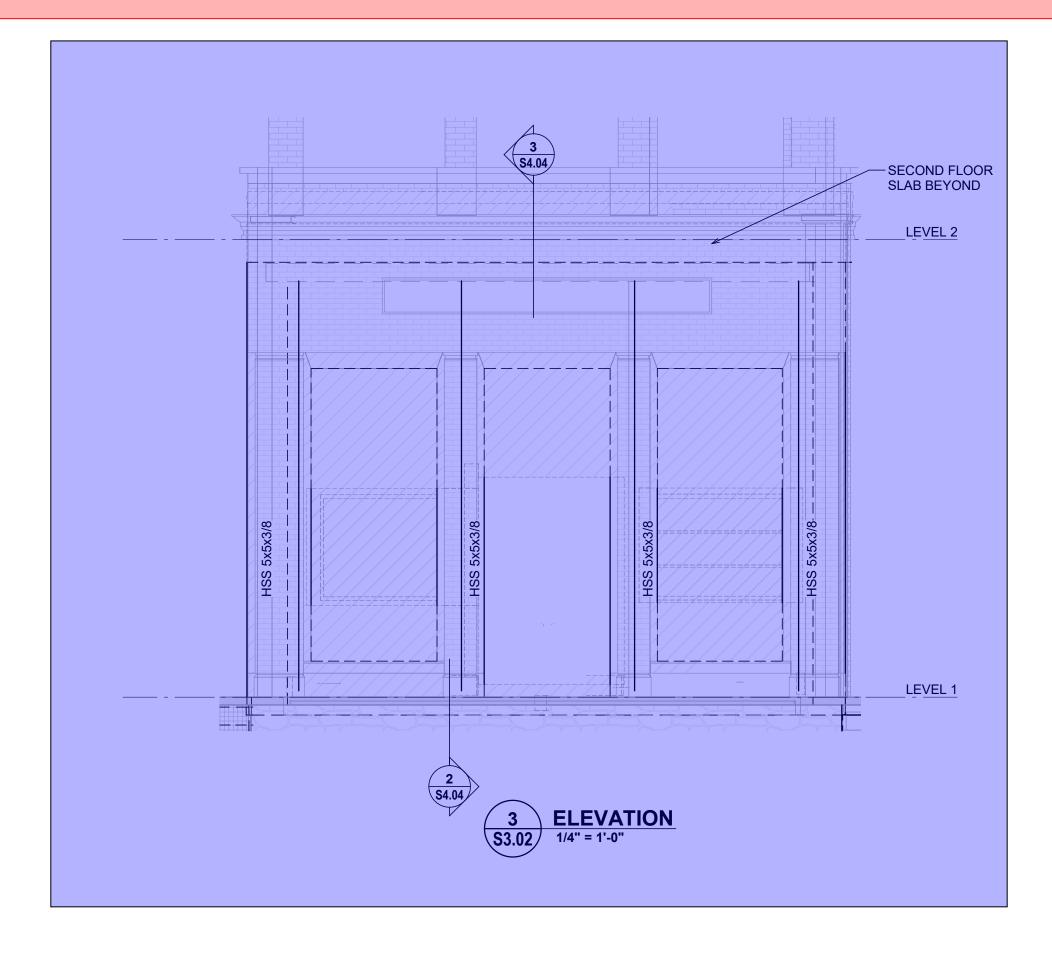
1314-1318 Wharf Street, Victoria B.C.

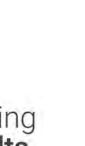ELEVATIONS

006

Sheet Number **S3.02** Revision

5

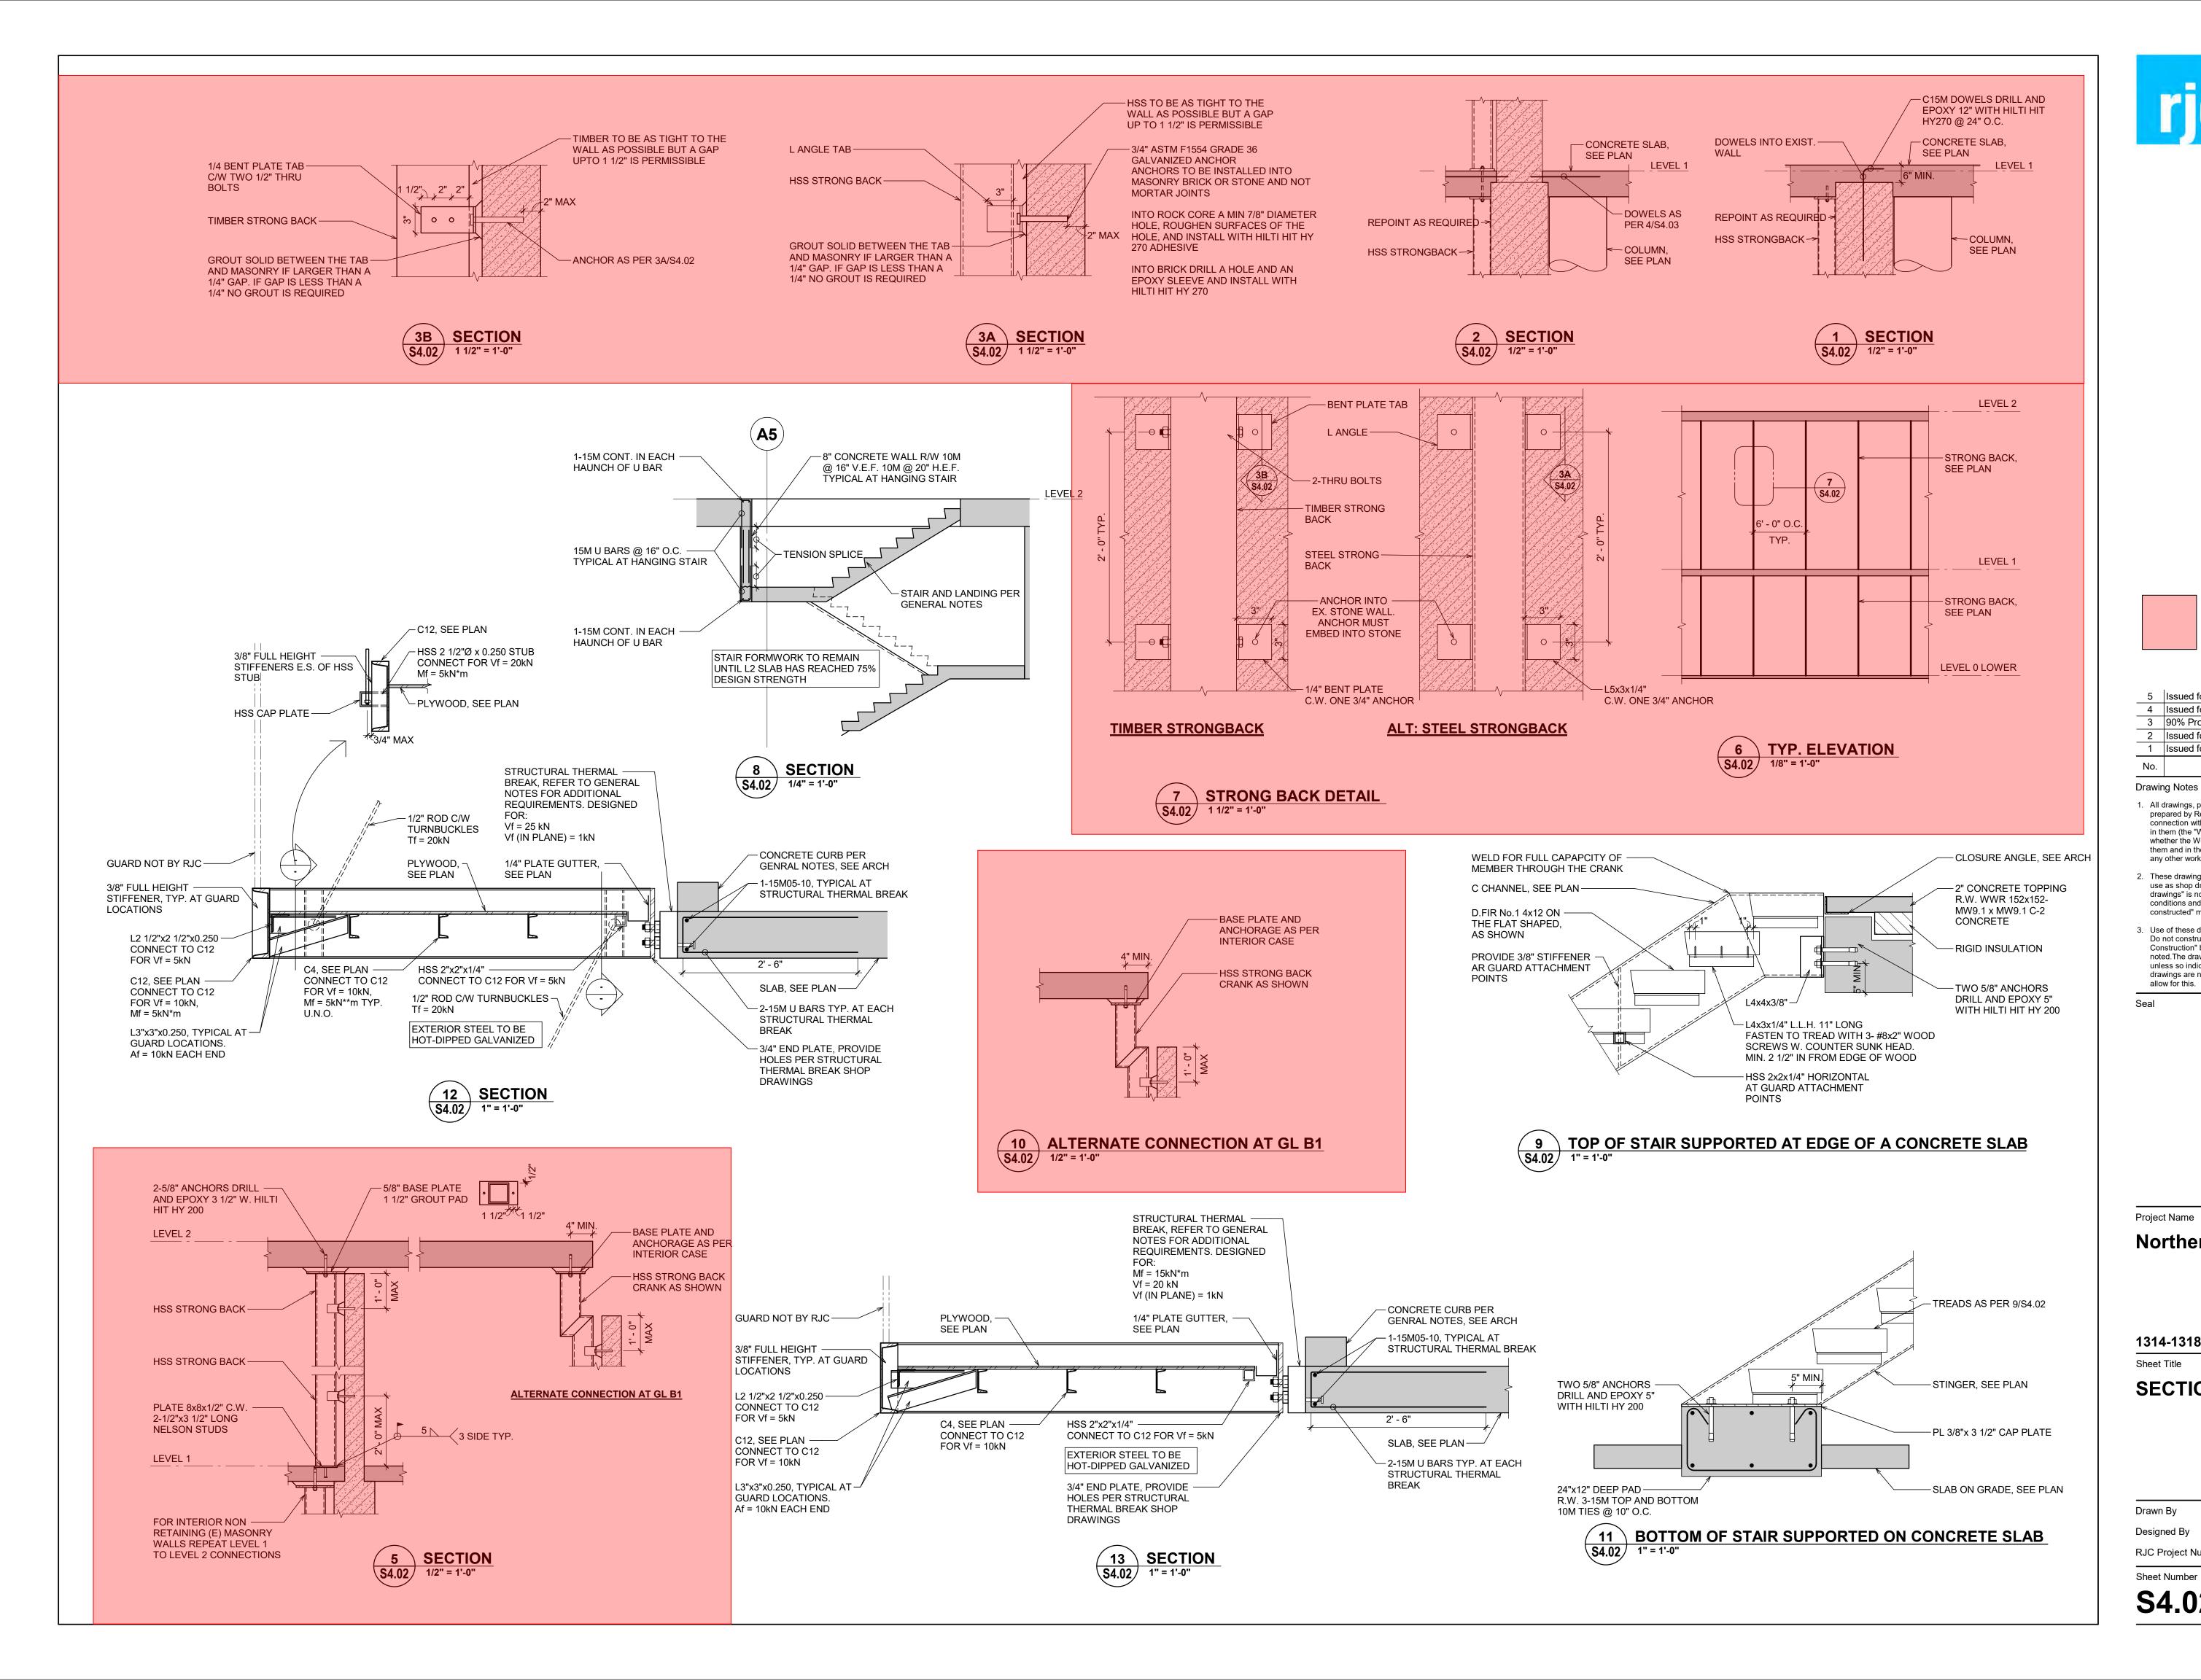



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ITEMS HIGHLIGHTED IN RED ARE REQUIRED FOR SEISMIC RESTRAINT OF THE HERITAGE LDINGS

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No.	Revision	Date	Ву

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Seal

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1314-1318 Wharf Street, Victoria B.C.

SECTIONS AND DETAILS


Drawn By	МС	Scale	As indicated
Designed By	РМ	Date	30/09/2022
RJC Project N	umber	VIC.	100479.0006
Sheet Number	-		Revis


S4.02


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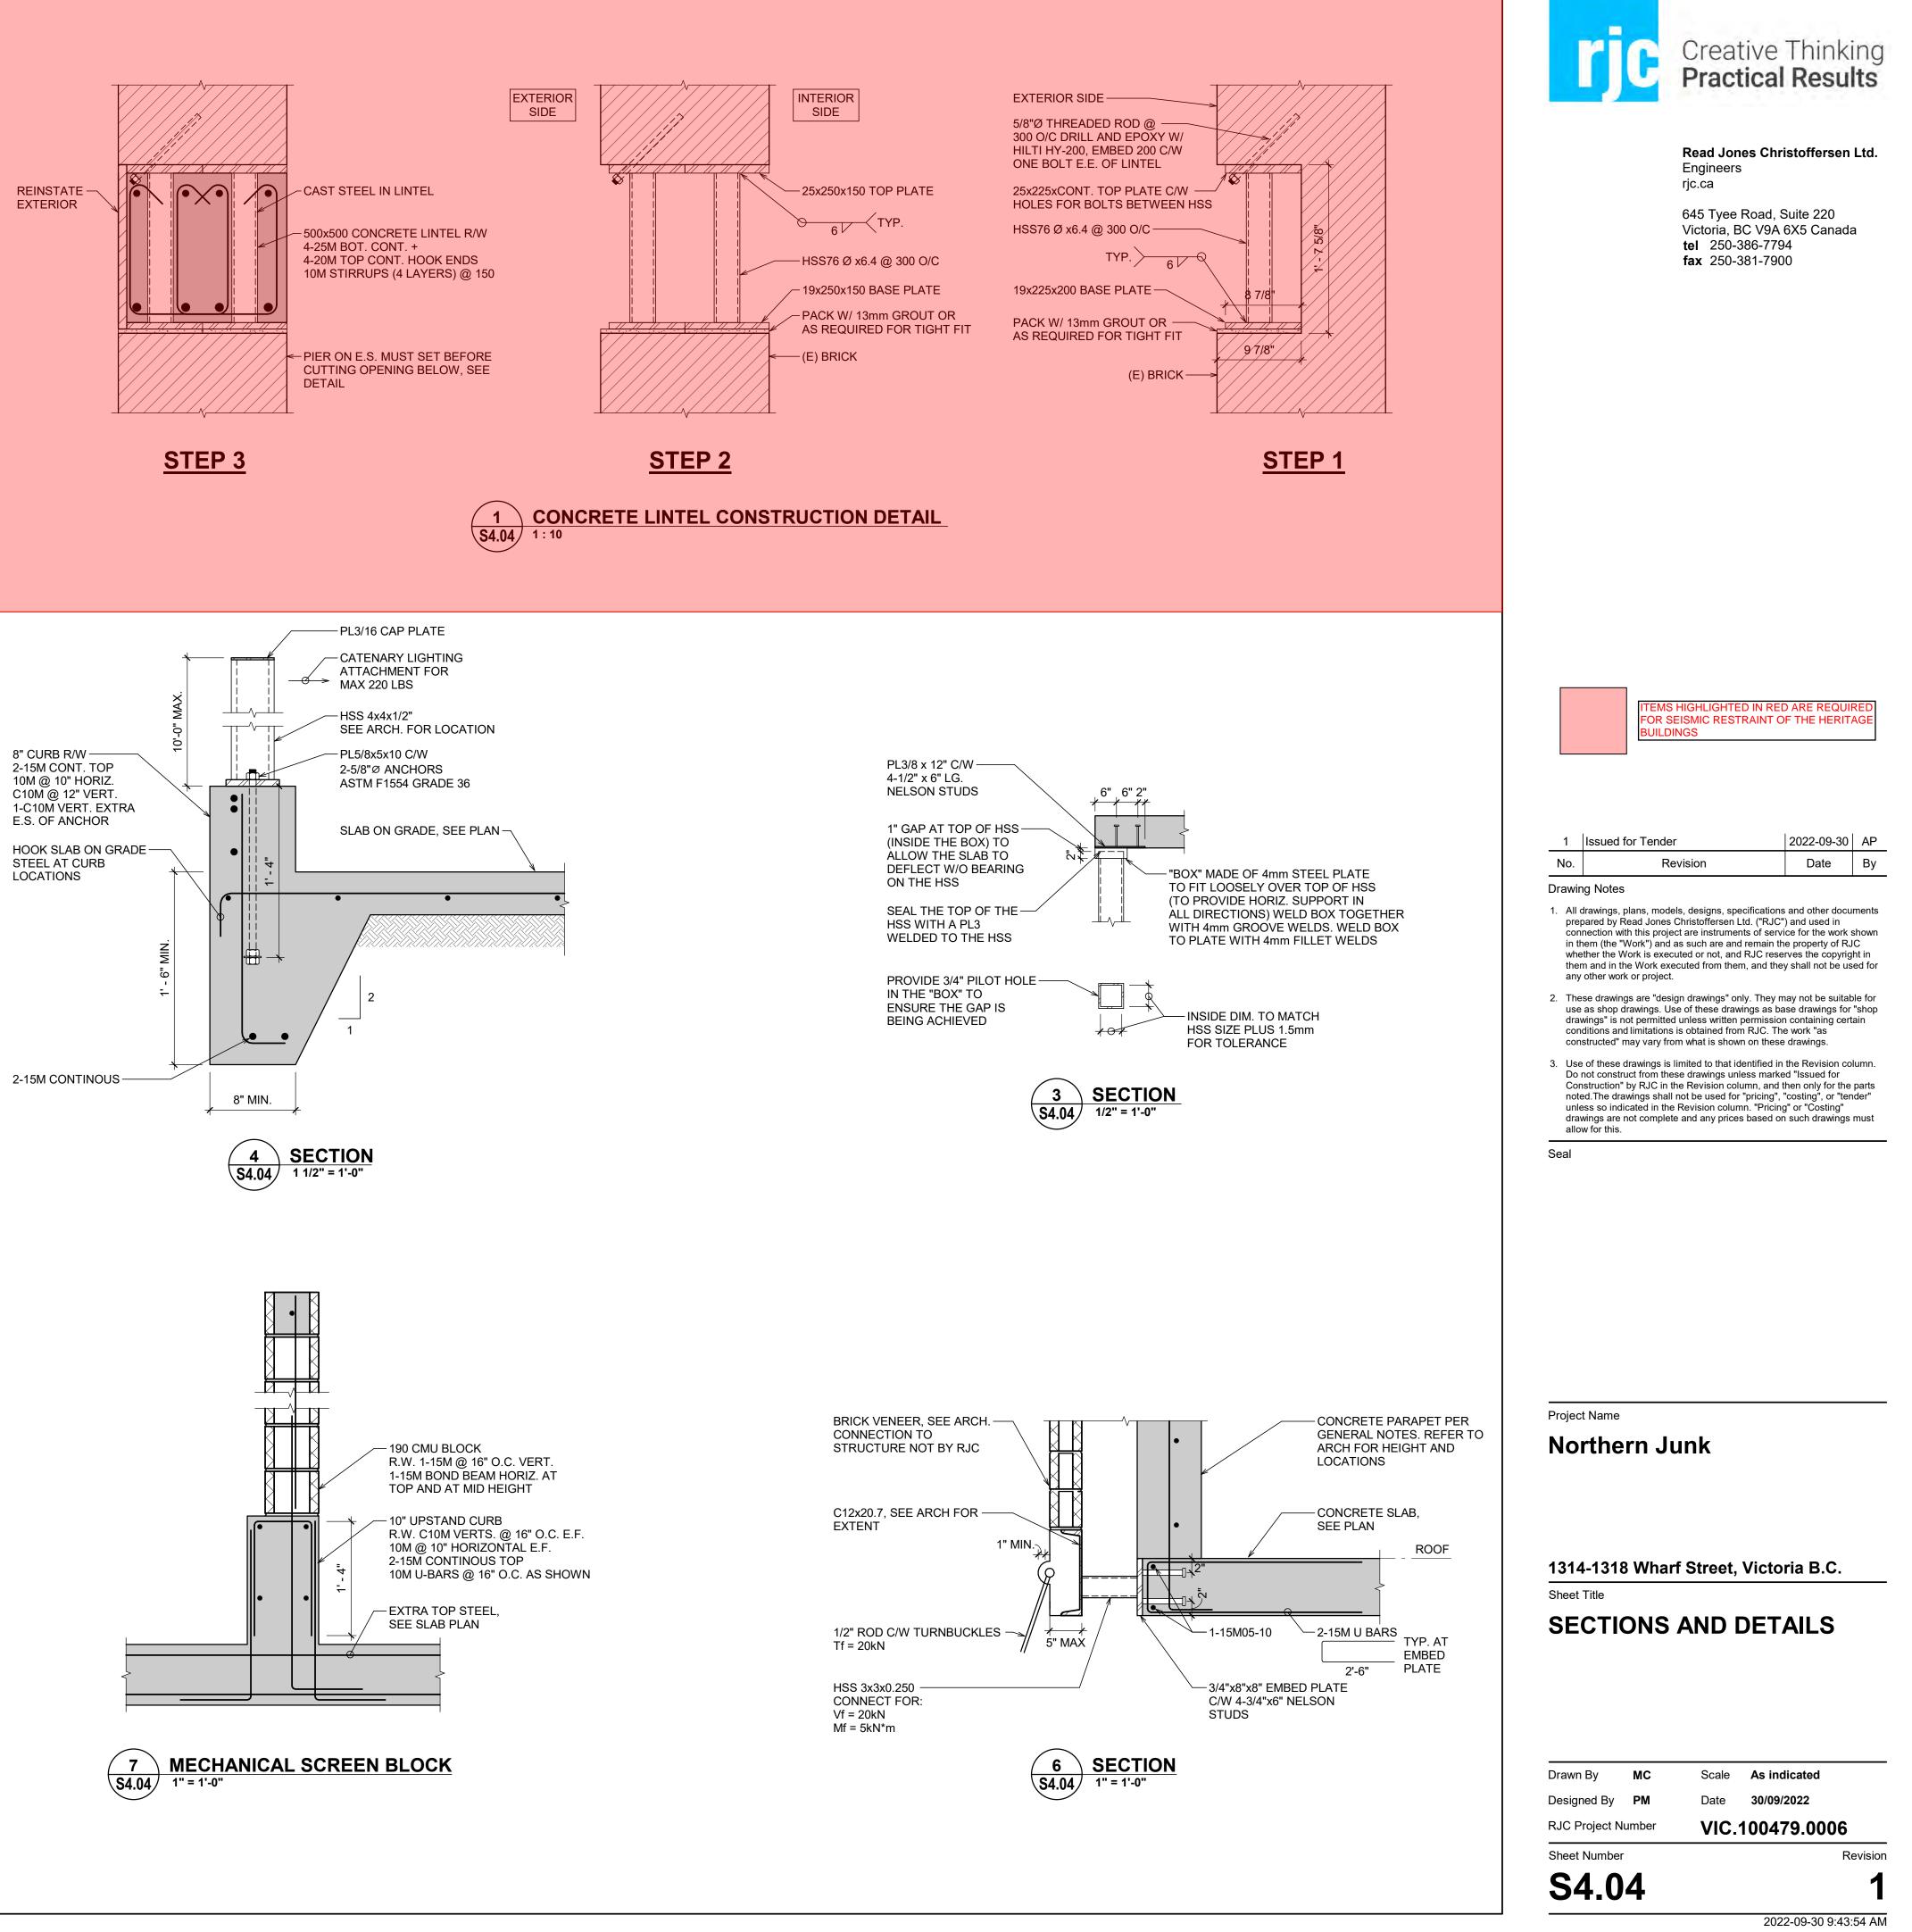
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Revision





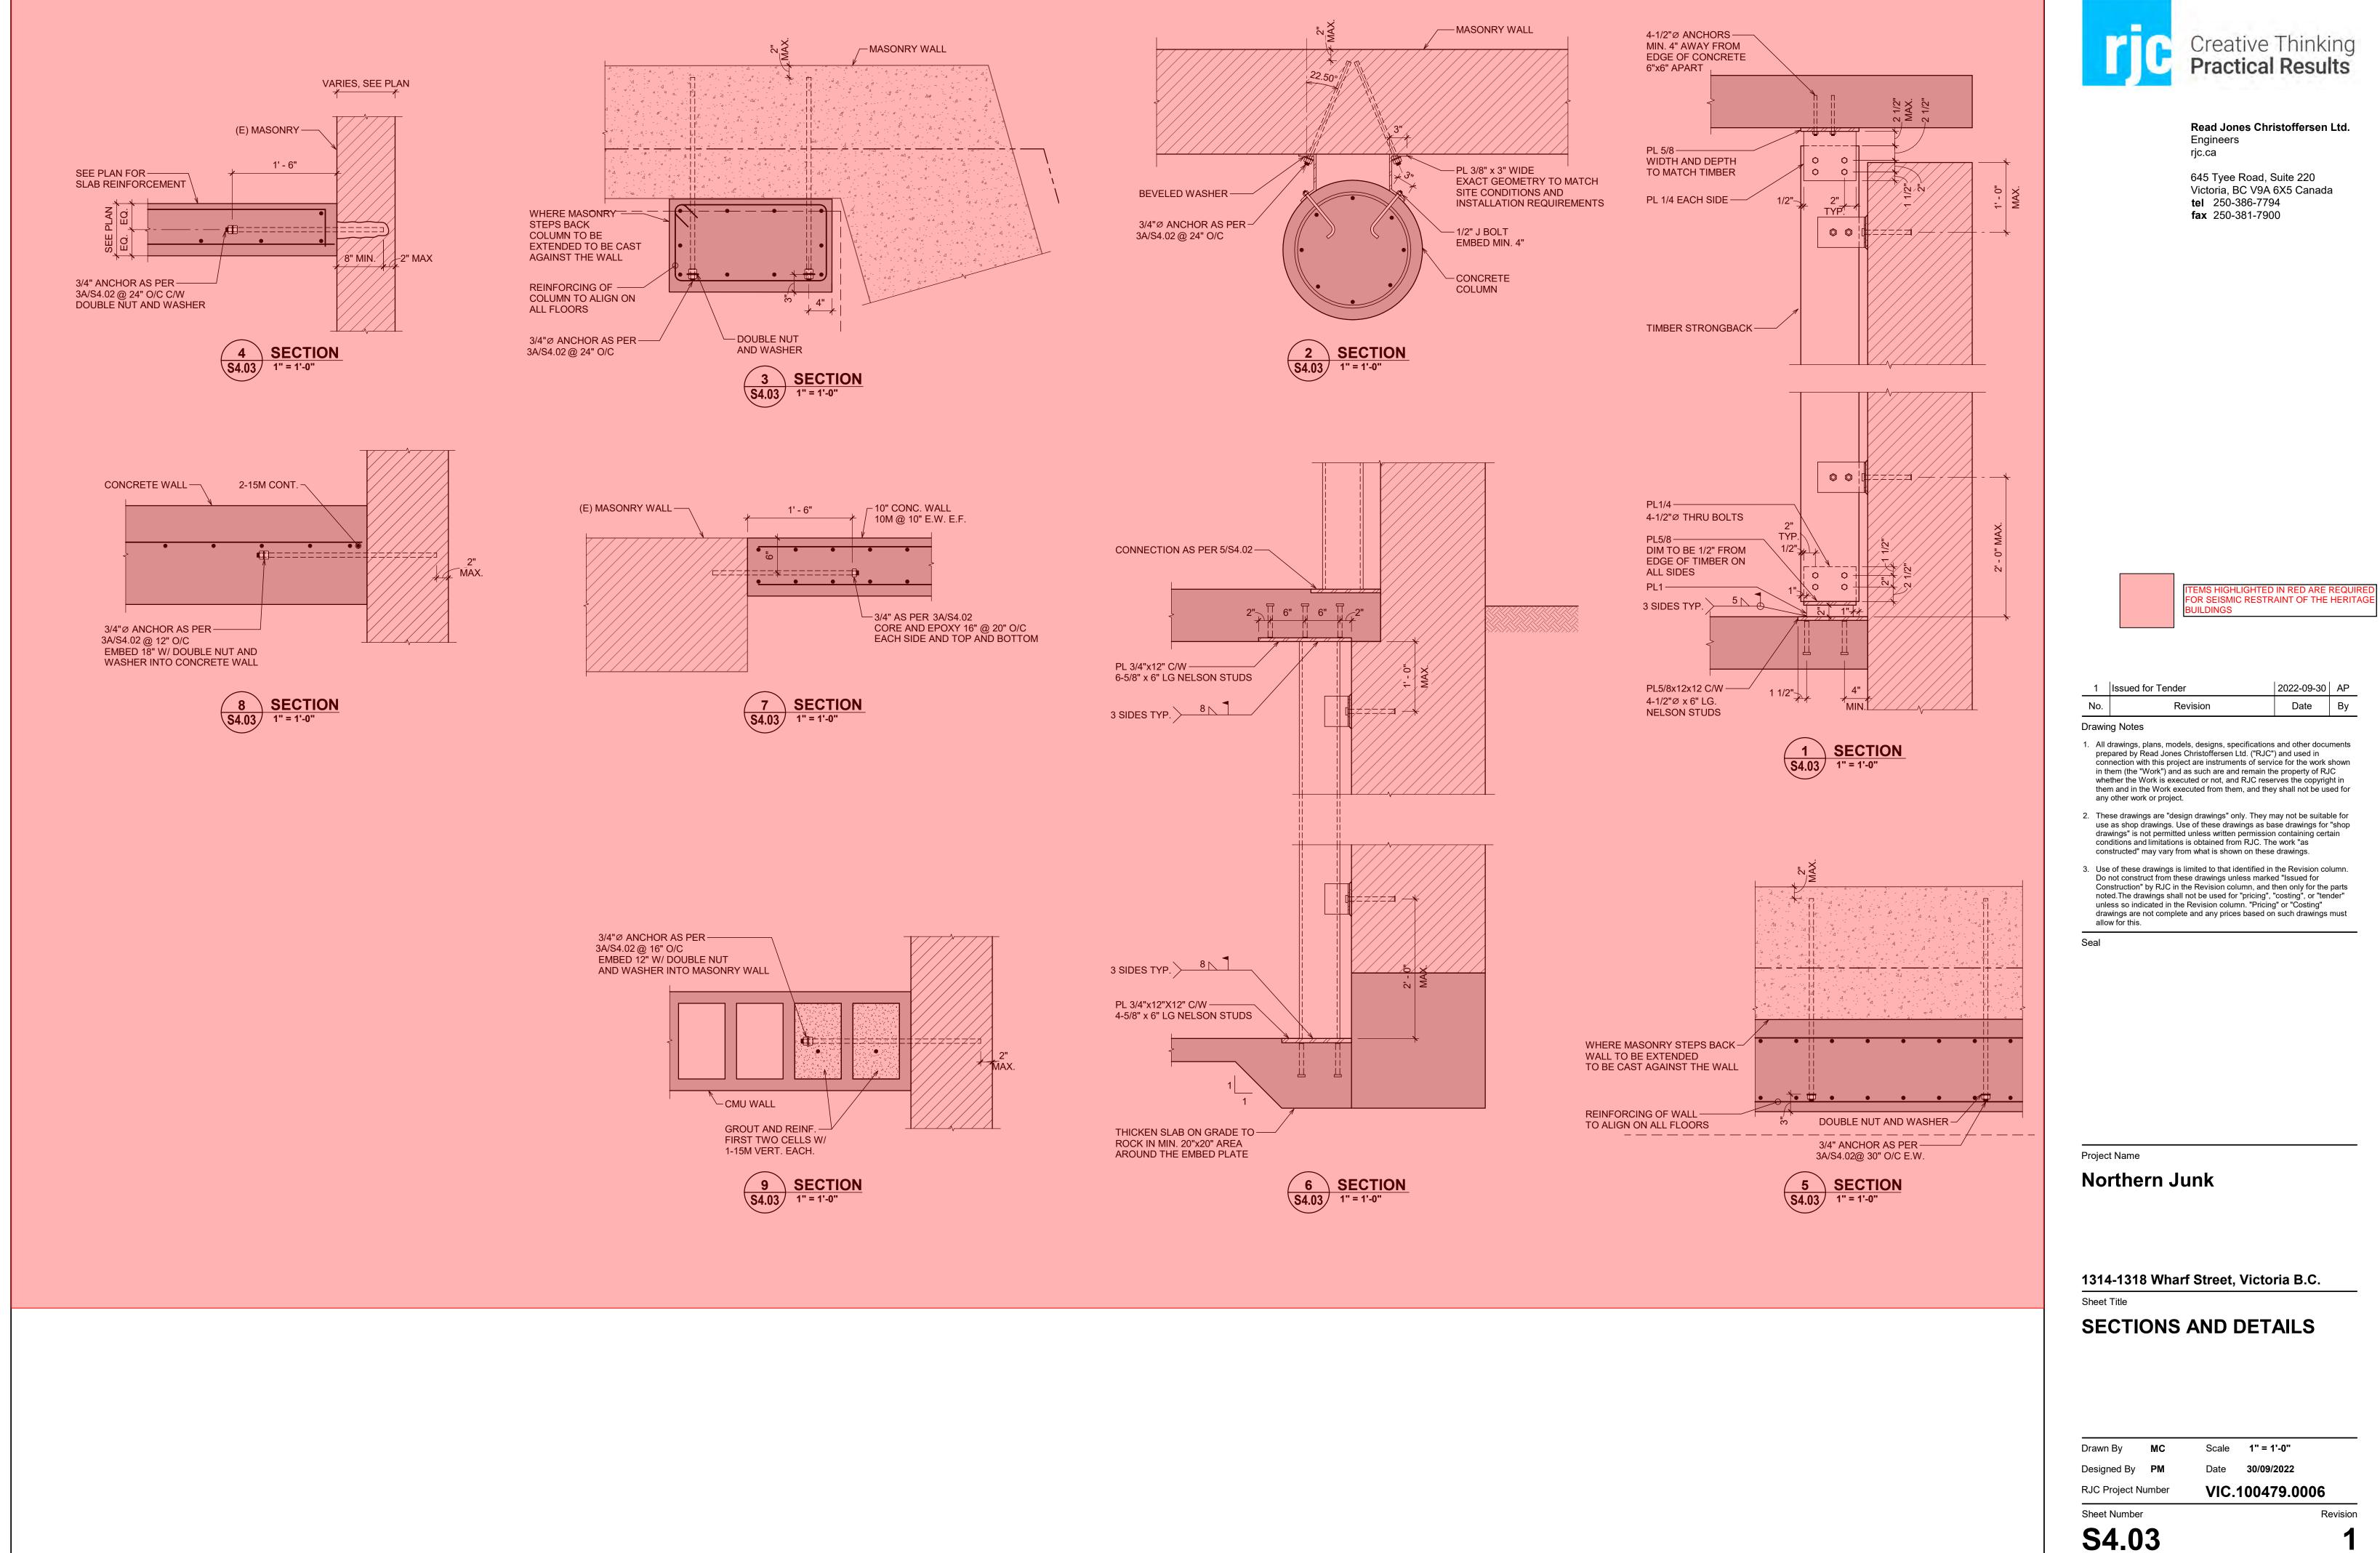

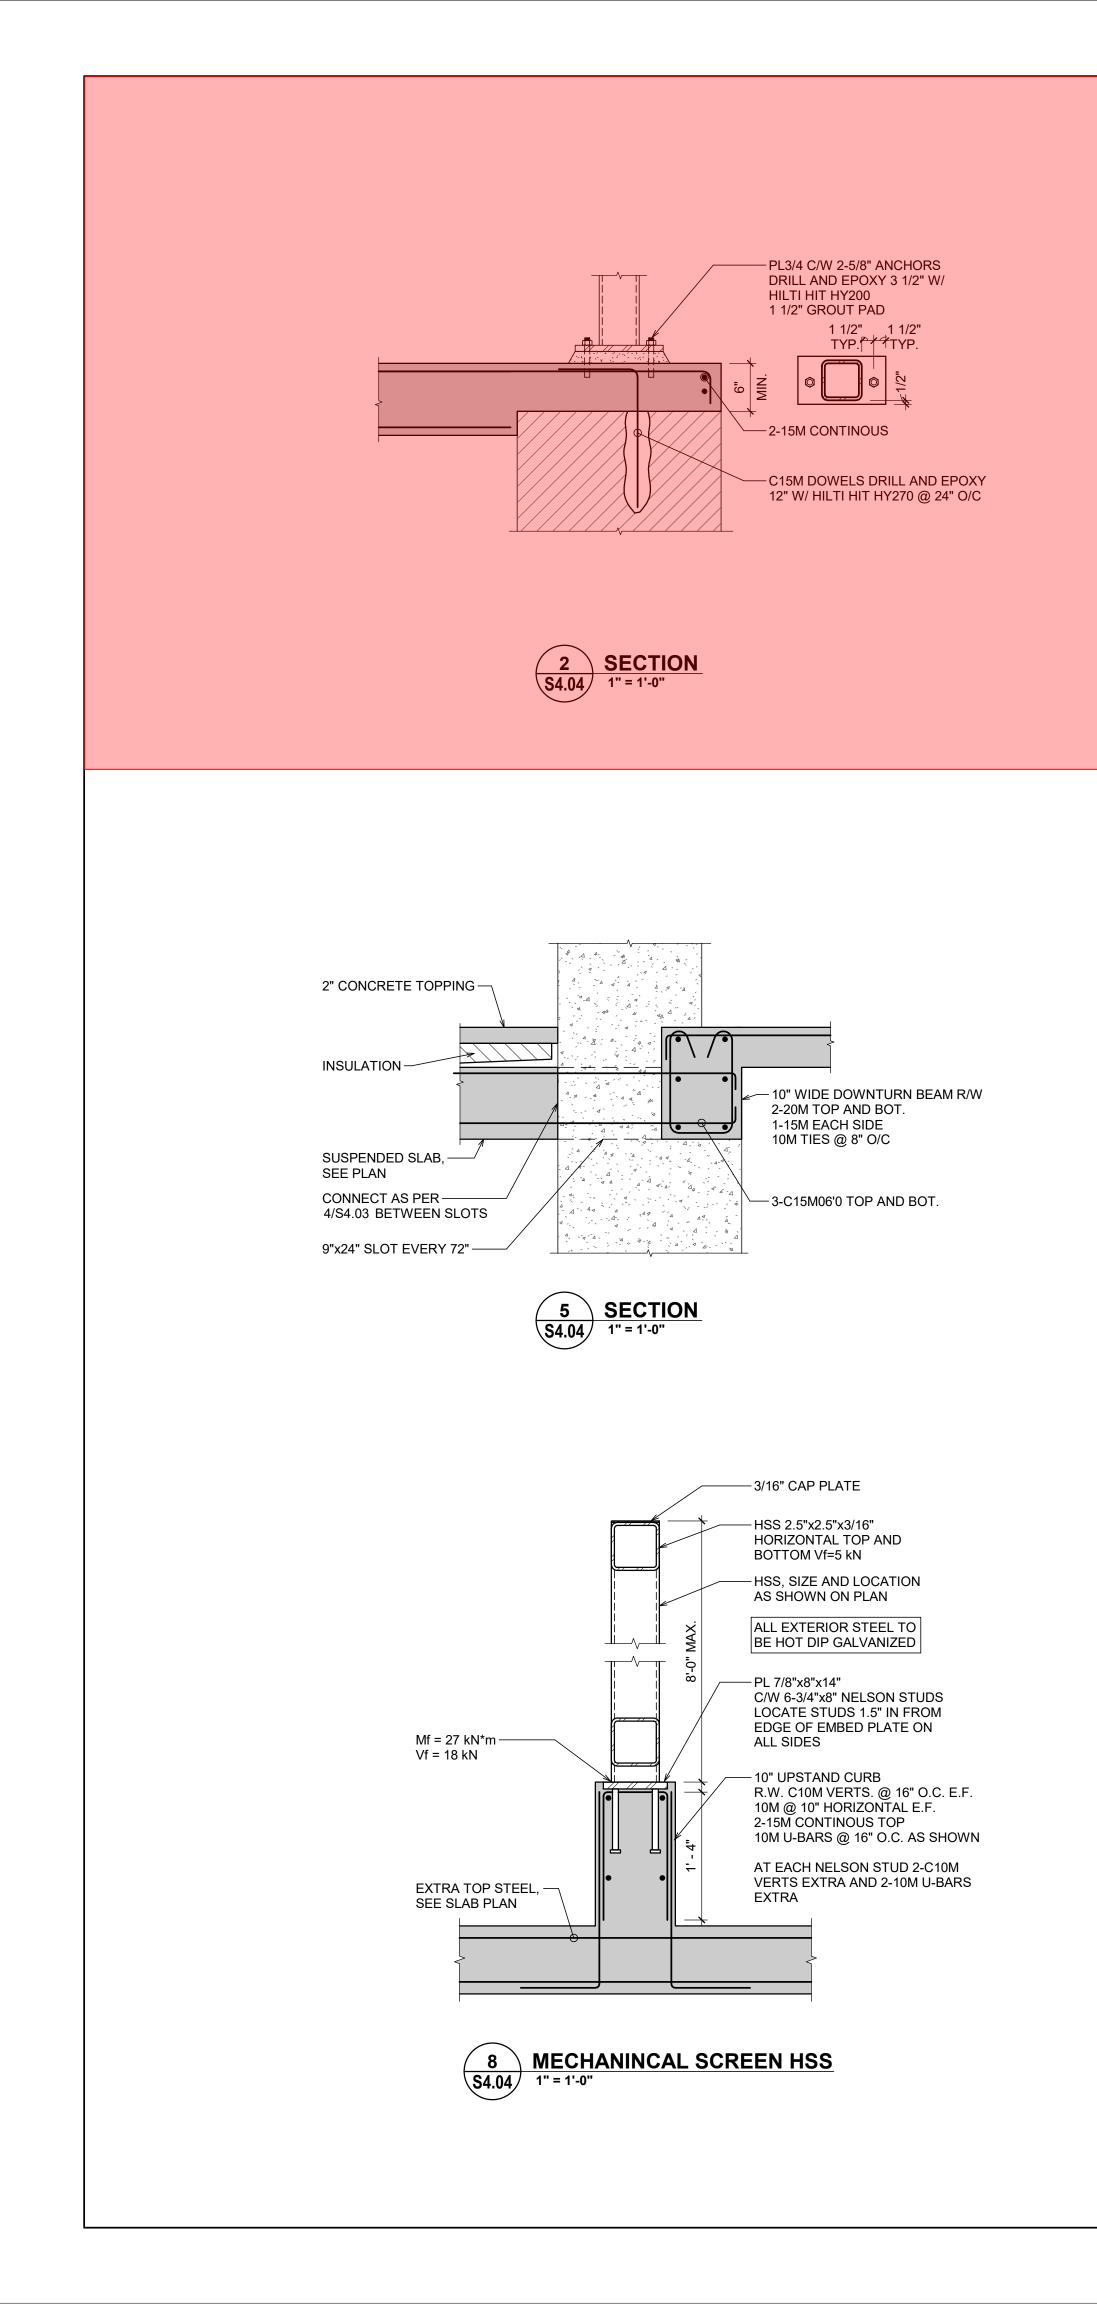

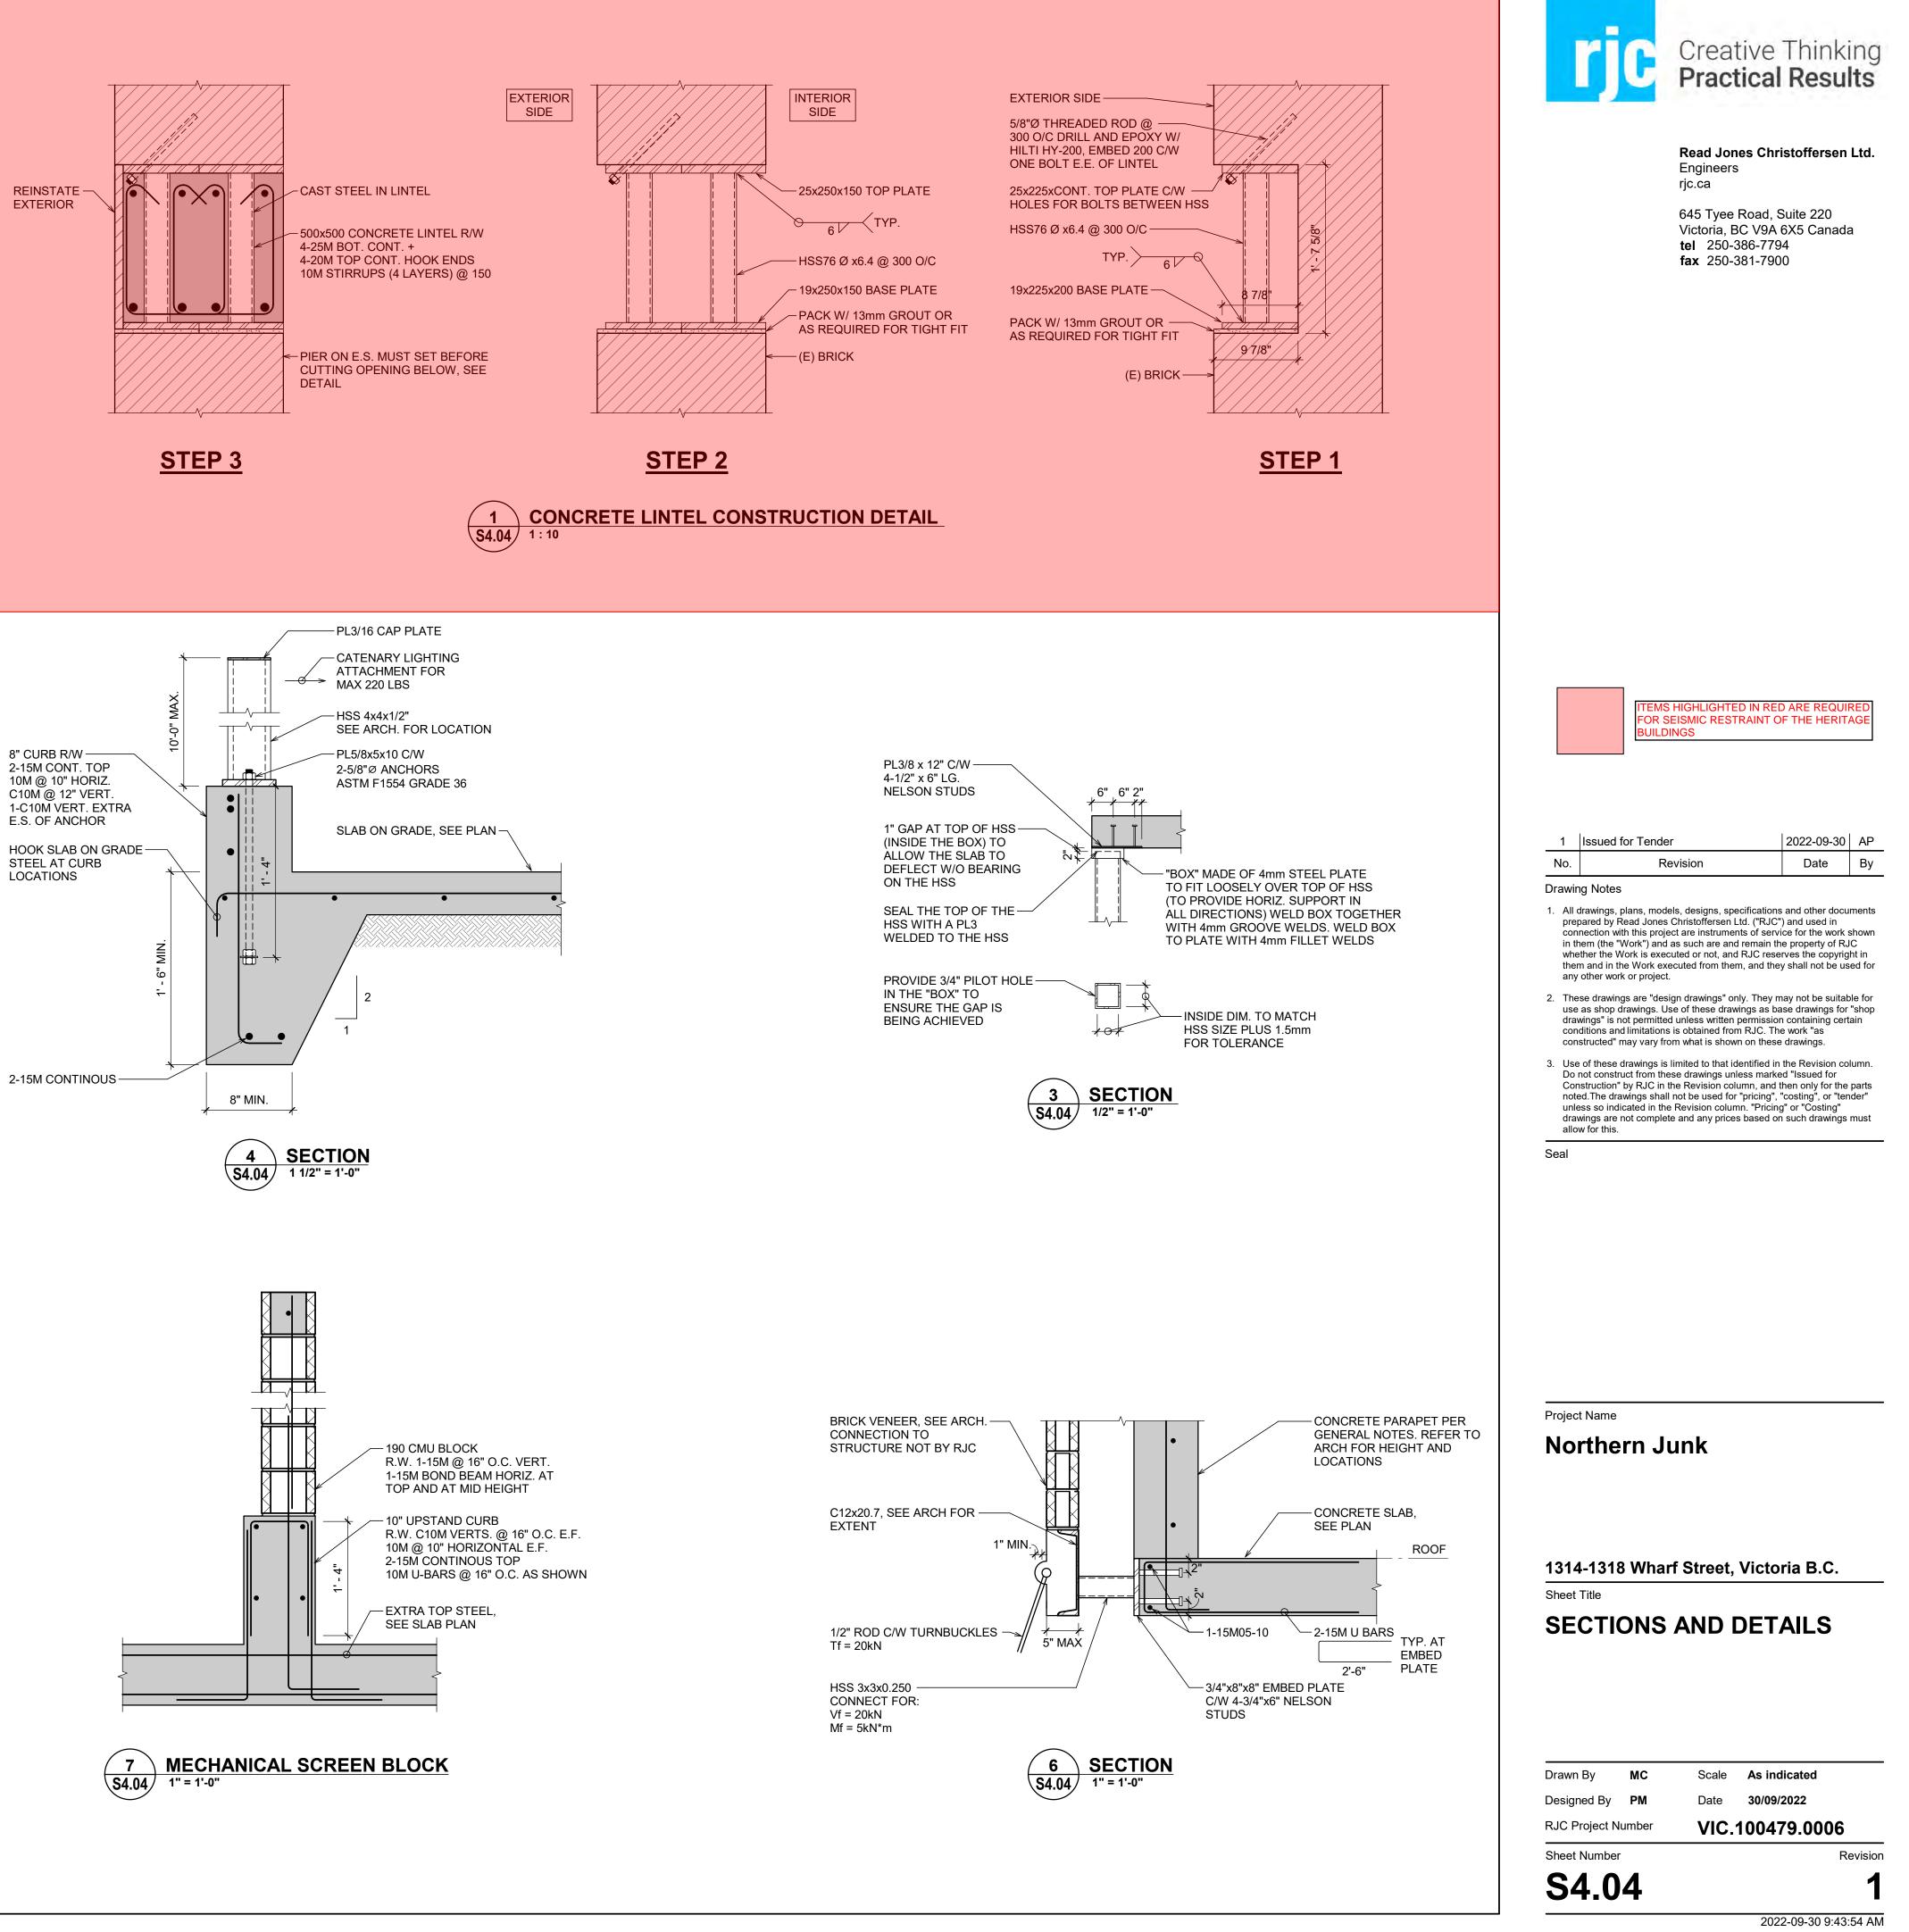UNDERPINNING AND SHORING DETAILS




JUNE 13, 2023





HERITAGE TAX INCENTIVE PROGRAM

PAGE 19 OF 19

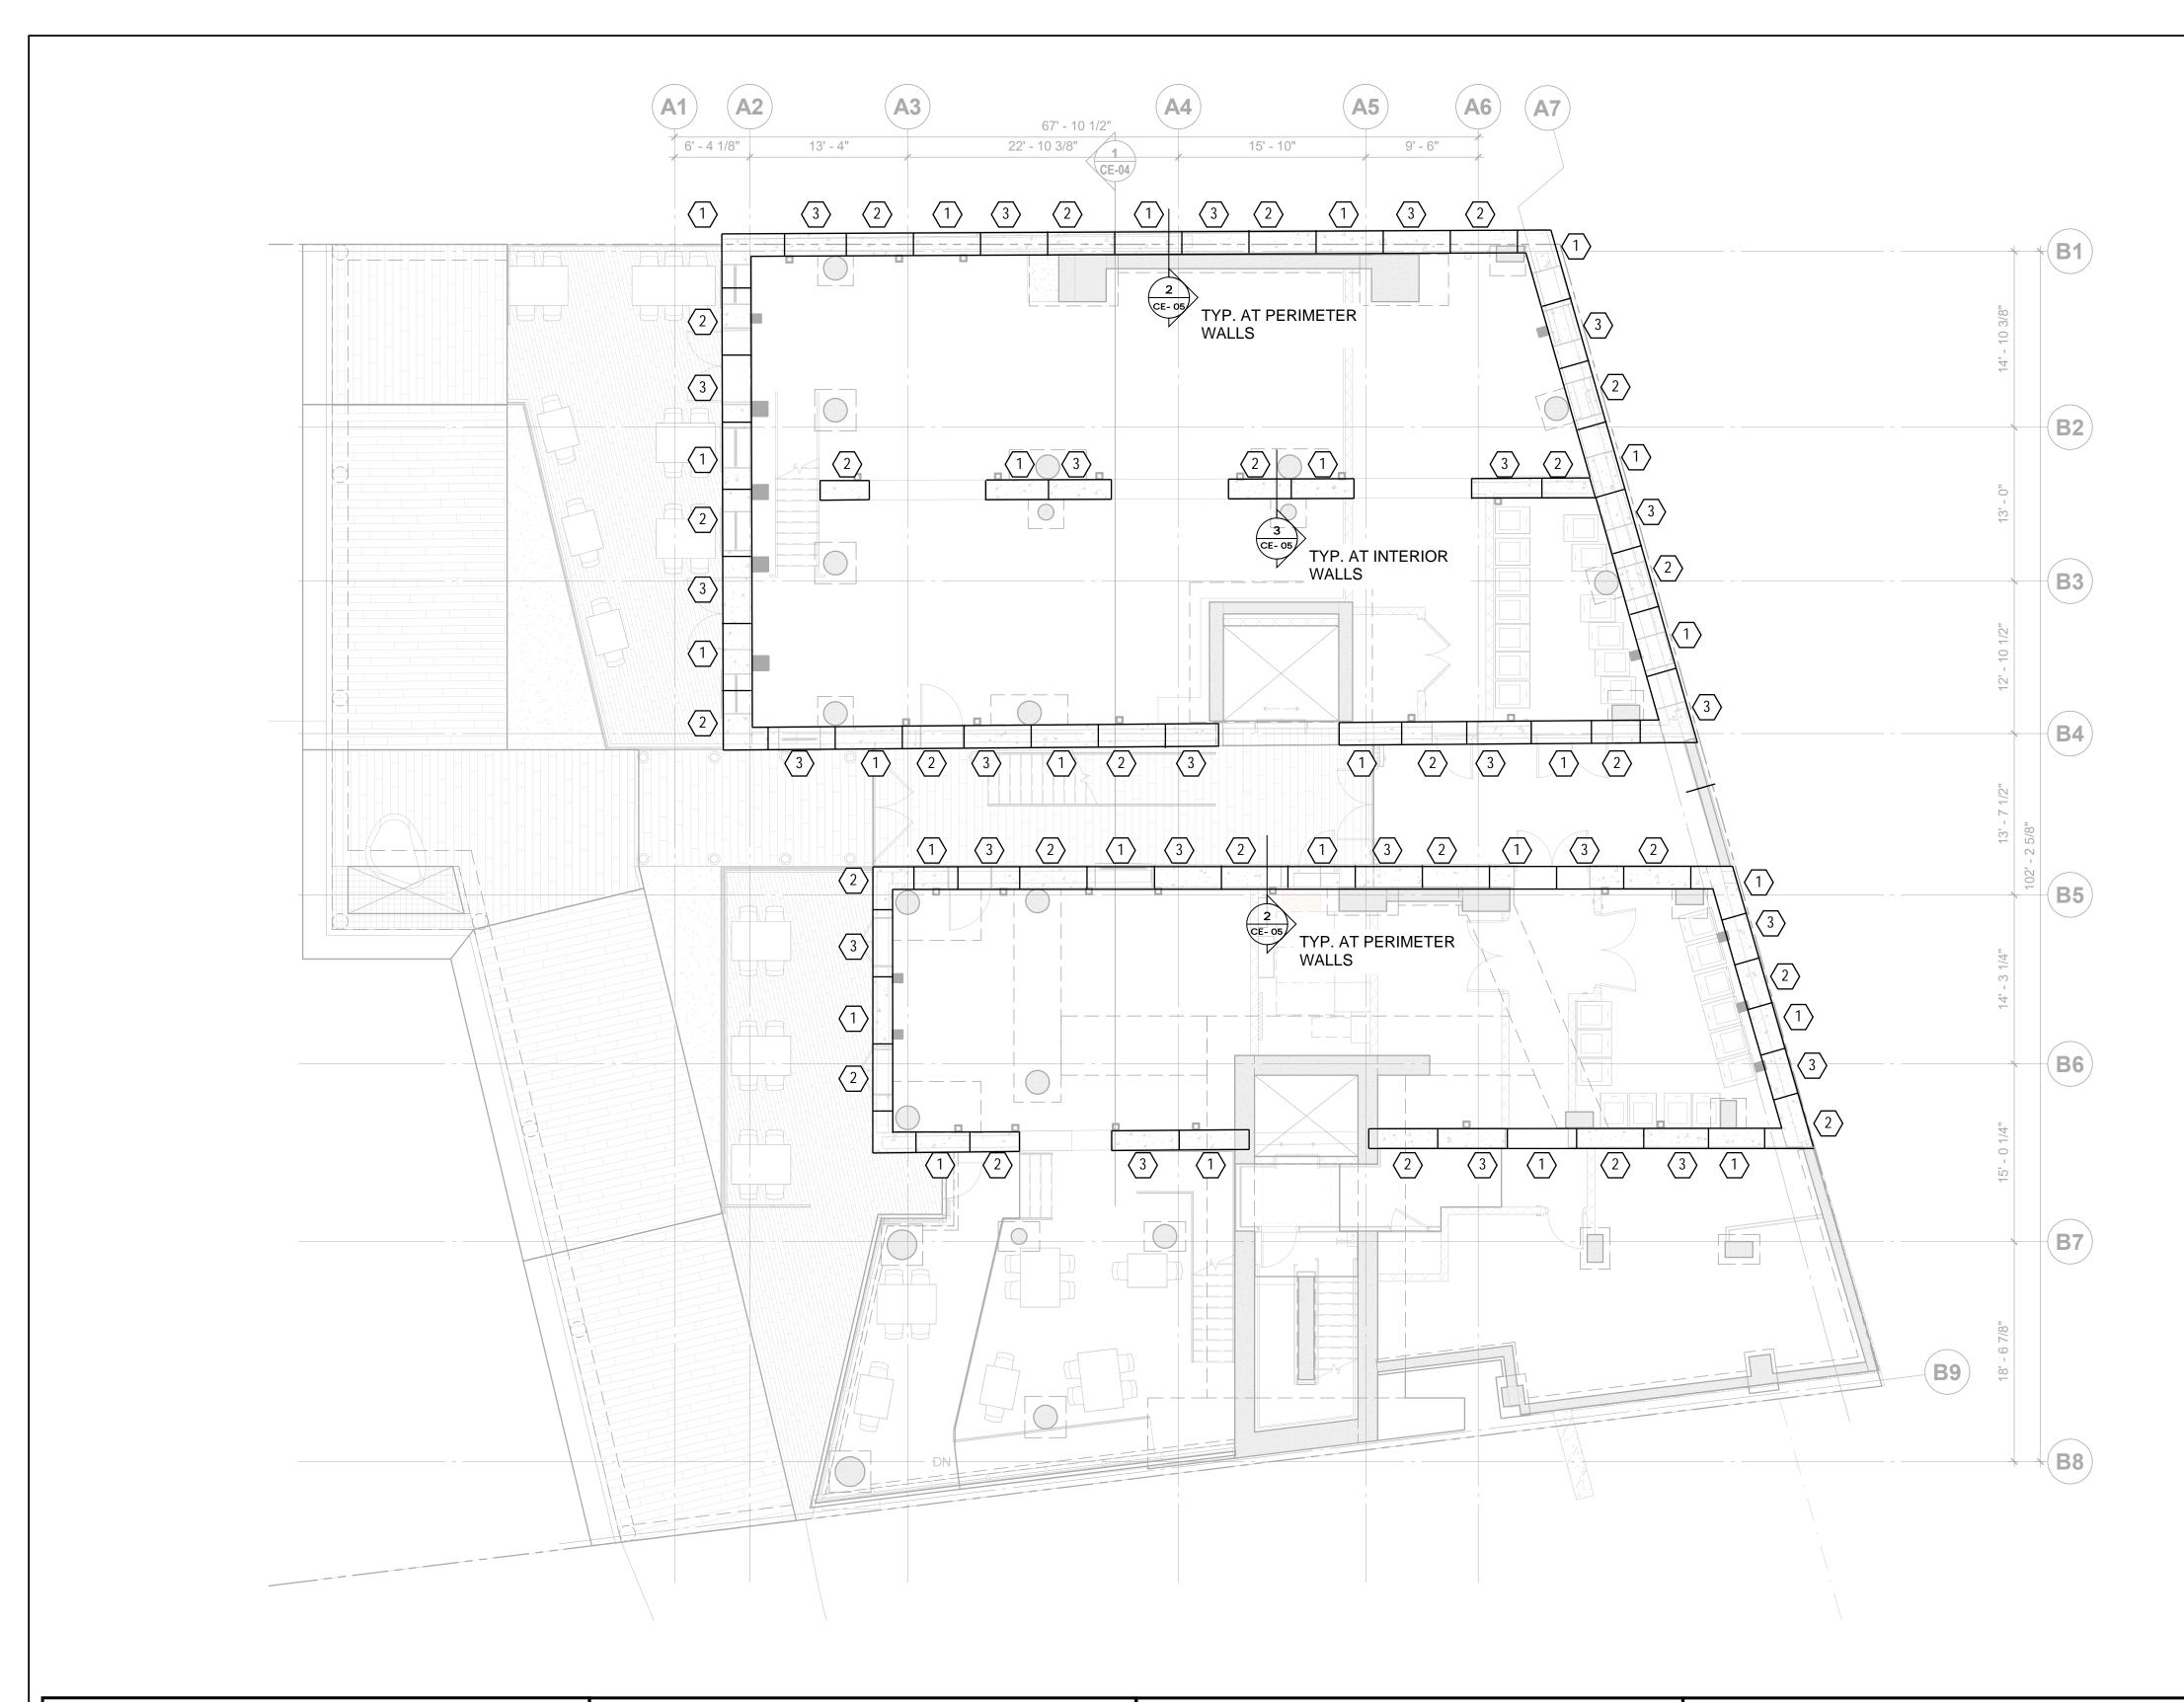

FIELD REVIEW

- 1. READ JONES CHRISTOFFERSEN PROVIDES FIELD REVIEW ONLY FOR THE WORK SHOWN ON THESE STRUCTURAL DRAWINGS. THIS REVIEW IS NOT A "FULL TIME" REVIEW BUT IS CONDUCTED WITH SUCH FREQUENCY AS RJC DEEMS APPROPRIATE TO OBSERVE VARIOUS STAGES OF THE WORK AND TO ASCERTAIN THAT THE WORK IS IN GENERAL CONFORMANCE WITH THE PLANS AND SUPPORTING DOCUMENTS PREPARED BY READ JONES CHRISTOFFERSEN. FIELD REVIEW BY READ JONES CHRISTOFFERSEN IS NOT CARRIED OUT FOR THE CONTRACTOR'S BENEFIT, NOR DOES IT MAKE READ JONES CHRISTOFFERSEN GUARANTORS OF THE CONTRACTOR'S WORK. IT REMAINS THE CONTRACTOR'S RESPONSIBILITY TO BUILD THE WORK IN CONFORMANCE WITH THE CONTRACT DOCUMENTS. RJC SHALL NOT BE RESPONSIBLE FOR THE ACTS OR OMISSIONS OF THE CONTRACTOR. SUB—CONTRACTOR, OR ANY OTHER PERSONS PERFORMING ANY OF THE WORK OR FOR THE FAILURE OF ANY OF THEM TO CARRY OUT THE WORK IN ACCORDANCE WITH THE CONTRACT DOCUMENTS.
- RJC WILL REVIEW SHOP DRAWINGS PERTAINING TO WORK SHOWN ON RJC'S DRAWINGS. THE EXTENT OF THIS REVIEW IS AT THE SOLE DISCRETION OF RJC'S ENGINEER AND IS FOR THE SOLE PURPOSE OF ASCERTAINING GENERAL CONFORMANCE WITH THE STRUCTURAL DESIGN CONCEPT. THE REVIEW IS NOT AN APPROVAL OF THE DESIGN, DETAILS, AND DIMENSIONS INHERENT IN THE SHOP DRAWINGS, RESPONSIBILITY FOR WHICH SHALL REMAIN WITH THE CONTRACTOR OR SUBCONTRACTOR SUBMITTING THEM. SUCH REVIEW SHALL NOT RELIEVE THE CONTRACTOR OR SUBCONTRACTOR OF HIS OR HER RESPONSIBILITY FOR ERRORS AND OMISSIONS IN THE SHOP DRAWINGS OR FOR MEETING ALL REQUIREMENTS OF THE CONTRACT DOCUMENTS.
- PROVIDE 24 HOURS ADVANCE NOTICE OF EACH REQUIRED FIELD REVIEW. FIELD REVIEWS SHALL BE SCHEDULED TO BE CARRIED OUT DURING NORMAL BUSINESS HOURS UNLESS SPECIAL ARRANGEMENTS ARE MADE WITH RJC.
 THE WORK TO BE REVIEWED SHALL BE GENERALLY COMPLETE.

CONCRETE REINFORCEMENT

- REINFORCEMENT SHALL CONFORM TO THE FOLLOWING STANDARDS:
 A. CAN/CSA-G30.18R GRADE 400 MPa 10M AND LARGER (U.N.O.) (NOTE: G30.18W MAY BE SUBSTITUTED FOR G30.18R)
- UNLESS OTHERWISE NOTED CONCRETE COVER TO REINFORCEMENT SHALL BE:
 A. CONCRETE CAST AGAINST EARTH OR GROUND --- 75 mm
 B. FORMED FINISHED CONCRETE EXPOSED TO WEATHER, EXPOSURE CLASS F1 F2, S1, S2 OR EARTH --- 40 mm OR 1.5d (WHICHEVER IS GREATER)
 NOTES:

LARGEST COVER REQUIRED GOVERNS.

- 3. DO NOT SUBSTITUTE DEFORMED WIRE FOR REINFORCING BARS WITHOUT PRIOR APPROVAL OF THE RJC.
- I. SUPPORT REINFORCING WITH CHAIRS, ACCESSORIES, OR REINFORCING BARS AS REQUIRED. BARS USED AS SUPPORT BARS SHALL BE CONSIDERED AS ACCESSORIES.
- PROVIDE SUFFICIENT SUPPORTS TO MAINTAIN CONCRETE COVER AS SPECIFIED. ALL SUPPORTS AND BARS MUST BE TIED TOGETHER TO MAINTAIN REINFORCING STEEL SECURELY IN PLACE DURING CONCRETE PLACEMENT.

FOUNDATIONS	DESIGN LOADS
 FOOTINGS HAVE BEEN DESIGNED FOR THE FOLLOWING BEARING RESISTANCE IN ACCORDANCE WITH THE SOILS REPORT. PREPARED BY: RYZUK GEOTECHNICAL DATED: MAY 10, 2022 ROCK BEARING A. STRIP FOOTINGS: ULS: 3000 kPa B. SPREAD FOOTINGS: ULS: 3600 kPa 	 BRACING OF THE EXISTING WALLS HAS BEEN DESIGNED FOR THE FOLLOWING LOADS: <u>WIND DESIGN:</u> HOURLY WIND PRESSURE, (1/10) = 9.2 PSF Iw = 1.0 ULS, 0.75 SLS.
2. BEARING SURFACES MUST BE APPROVED BY THE SOILS ENGINEER IMMEDIATELY BEFORE FOOTING CONCRETE IS PLACED. RJC IS NOT RESPONSIBLE FOR	DRAWINGS
 CONFIRMING BEARING CAPACITIES OF SOILS REFER TO SOILS REPORT FOR OTHER SPECIFIC DESIGN REQUIREMENTS FOR FOOTINGS, SOIL SLOPES, FROST PROTECTION, MINIMUM COVER, ETC. FOR GROUND ELEVATIONS AND DRAINAGE SLOPES, SEE ARCHITECT'S DRAWINGS. FOOTING ELEVATIONS, IF SHOWN, ARE FOR BIDDING PURPOSES ONLY, ARE NOT FINAL, AND MAY VARY ACCORDING TO SITE CONDITIONS OR AS REQUIRED BY SERVICES. ALL FOOTINGS MUST BE TAKEN TO A BEARING LAYER APPROVED BY THE SOILS ENGINEER. 	 THIS SET OF DRAWINGS SHOWS THE STRIP-OUT WORK OF THE PROJECT. THE DRAWINGS DO NOT SHOW COMPONENTS THAT MAY BE NECESSARY FOR CONSTRUCTION SAFETY. THE GENERAL CONTRACTOR IS RESPONSIBLE FOR SAFETY IN AND ABOUT THE JOB SITE DURING CONSTRUCTION, AND THE DESIGN AND ERECTION OF ALL TEMPORARY STRUCTURES. FORMWORK, FALSE WORK, SHORING, ETC. REQUIRED TO COMPLETE THE WORK. THE USE OF THESE DRAWINGS IS LIMITED TO THAT IDENTIFIED IN THE REVISIONS COLUMN. DO NOT CONSTRUCT FROM THESE DRAWINGS UNLESS MARKED "ISSUED FOR CONSTRUCTION" IN THE REVISIONS COLUMN, BY READ JONES CHRISTOFFERSEN LTD. THE DRAWINGS SHALL NOT BE USED FOR PRICING, COSTING, OR TENDER UNLESS SO INDICATED IN THE REVISION COLUMN. PRICING OR COSTING DRAWINGS ARE NOT COMPLETE AND ANY PRICES BASED ON PRICING OR COSTING DRAWINGS MUST INCLUDE ALLOWANCES FOR THIS. THE INFORMATION ON THESE DRAWINGS SHALL NOT BE USED FOR ANY OTHER PROJECT OR WORKS. THE INFORMATION ON THESE DRAWINGS APPLIES SOLELY TO THIS PROJECT.
	 FOOTINGS HAVE BEEN DESIGNED FOR THE FOLLOWING BEARING RESISTANCE IN ACCORDANCE WITH THE SOILS REPORT. PREPARED BY: RYZUK GEOTECHNICAL DATED: MAY 10, 2022 ROCK BEARING A. STRIP FOOTINGS: ULS: 3000 kPa B. SPREAD FOOTINGS: ULS: 3600 kPa BEARING SURFACES MUST BE APPROVED BY THE SOILS ENGINEER IMMEDIATELY BEFORE FOOTING CONCRETE IS PLACED. RJC IS NOT RESPONSIBLE FOR CONFIRMING BEARING CAPACITIES OF SOILS REFER TO SOILS REPORT FOR OTHER SPECIFIC DESIGN REQUIREMENTS FOR FOOTINGS, SOIL SLOPES, FROST PROTECTION, MINIMUM COVER, ETC. FOR GROUND ELEVATIONS AND DRAINAGE SLOPES, SEE ARCHITECT'S DRAWINGS. FOOTING ELEVATIONS, IF SHOWN, ARE FOR BIDDING PURPOSES ONLY, ARE NOT FINAL, AND MAY VARY ACCORDING TO SITE CONDITIONS OR AS REQUIRED BY SERVICES. ALL FOOTINGS MUST BE TAKEN TO A BEARING LAYER APPROVED BY

NOTES:

- 1. DENOTES SLOT CUT SEQUENCE.
- 2. GEOTECH TO REVIEW BEARING SURFACES BEFORE UNDERPINNING CONCRETE IS PLACED.

DESIGN CODE

1. THE STRIP-OUT WORK OF THE STRUCTURE SHOWN ON THE STRUCTURAL DRAWINGS HAS BEEN DESIGNED IN SUBSTANTIAL ACCORDANCE WITH THE BRITISH COLUMBIA BUILDING CODE 2018 WHICH IS BASED ON THE NATIONAL BUILDING CODE OF CANADA 2015.

CONCRETE

- **CONCRETE PLACEMENT**
- 1. UNLESS NOTED OTHERWISE, ALL CONCRETE IS TO BE CAST-IN-PLACE.

CONCRETE PROPERTIES

- 2. CONCRETE IS SPECIFIED AS PER THE "PERFORMANCE" ALTERNATE AS OUTLINED IN CSA A23.1.
- 3. THE GENERAL CONTRACTOR IS RESPONSIBLE FOR WORKING WITH THE CONCRETE SUPPLIER TO ENSURE THAT THE PLASTIC AND HARDENED MIX PROPERTIES MEET SITE REQUIREMENTS FOR PLACING, FINISHING, AND THE OWNERS' SPECIFIED PERFORMANCE REQUIREMENTS. THE GENERAL CONTRACTOR SHALL MEET THE DOCUMENTATION AND QUALITY CONTROL REQUIREMENTS OUTLINED UNDER THE "PERFORMANCE" ALTERNATE OF CSA A23.1.
- 4. THE SUPPLIER SHALL MEET ALL CERTIFICATION AND DOCUMENTATION REQUIREMENTS AS OUTLINED UNDER THE "PERFORMANCE" ALTERNATE OF CSA A23.1.
- 5. CONCRETE PROPERTIES:

	GENERAL		
ELEMENT	COMPRESSIVE STRENGTH (MPa) 28 DAYS U.N.O.	EXPOSURE CLASS	COMMENT S
SLAB ON GRADE	25	Ν	
FOOTINGS	25	N	
LINTELS	25	N	

- 6. PORTLAND CEMENT SHALL BE TYPE GU UNLESS NOTED OTHERWISE
- 7. THE CONCRETE PROPERTIES USED IN DESIGN ARE BASED ON A MAXIMUM COARSE AGGREGATE SIZE OF NOT LESS THAN 3/4", UNLESS NOTED OTHERWISE. ALL LOCATIONS PROPOSED BY THE CONTRACTOR FOR USE OF CONCRETE MIX DESIGNS WITH A MAXIMUM COARSE AGGREGATE SIZE SMALLER THAN 3/4" SHALL BE SUBMITTED TO THE STRUCTURAL ENGINEER FOR REVIEW AND APPROVAL. ANY INCREASE IN REQUIRED CONCRETE STRENGTH OR INCREASE IN QUANTITY OF REINFORCEMENT DUE TO PROPOSED USE OF CONCRETE MIX WITH MAXIMUM COARSE AGGREGATE SIZE SMALLER THAN 3/4" TO BE PAID FOR BY THE CONTRACTOR.
- 8. SLUMP AND AGGREGATE SIZE TO BE DETERMINED BY THE GENERAL CONTRACTOR AND SUPPLIER TO MEET PLACEMENT, AND FINISHING REQUIREMENTS WITHOUT SEGREGATION WHILE MEETING ALL OWNER SPECIFICATIONS.
- MAXIMUM WATER/CEMENT RATIO AND AIR CONTENT TO MEET THE REQUIREMENTS FOR THE EXPOSURE CLASS AS OUTLINED IN CSA A23.1.
- 10. CURING OF CONCRETE TO MEET THE REQUIREMENTS FOR THE EXPOSURE CLASS AS OUTLINED IN CSA A23.1.
- 11. CURING AND PROTECTION OF CONCRETE FOR HOT, COLD OR DRY WEATHER IS TO BE AS PER CSA A23.1.

RENOVATIONS

- 1. THE CONTRACT DOCUMENTS ARE BASED ON ASSUMED AS-BUILT DIMENSIONS FOR THE EXISTING BUILDING STRUCTURE AND ASSUMPTIONS IN ACCORDANCE WITH DETAILING AND PLACING PRACTICE. THESE ASSUMPTIONS MAY VARY FROM THE ACTUAL ON-SITE CONDITIONS. THE CONTRACTOR SHALL IMMEDIATELY INFORM THE CONSULTANT OF ANY ACTUAL VARIATIONS FROM THE ASSUMED CONDITIONS.
- 2. MINOR MODIFICATIONS WILL BE REQUIRED TO THE WORK INDICATED ON THESE DRAWINGS TO REFLECT ACTUAL SITE CONDITIONS. THE CONTRACTOR WILL COOPERATE WITH THE CONSULTANT AND RJC IN THIS REGARD. MINOR MODIFICATIONS WILL BECOME THE RESPONSIBILITY OF THE CONTRACTOR AND WILL NOT RESULT IN A CHANGE IN THE CONTRACT PRICE.
- 3. ENSURE THAT ALL NECESSARY JOB DIMENSIONS ARE TAKEN AND ALL TRADES ARE COORDINATED FOR THE PROPER EXECUTION OF THE WORK. THE CONTRACTOR SHALL ASSUME COMPLETE RESPONSIBILITY FOR THE ACCURACY AND COMPLETENESS OF SUCH DIMENSIONS, AND FOR COORDINATION.
- 4. PRIOR TO FABRICATION OF ANY STRUCTURAL MEMBERS, THE CONTRACTOR SHALL COMPLETE THIS SITE REVIEW OF CRITICAL "TIE-IN" DIMENSIONS AND CONFIRM ALL DIMENSIONS TO ENSURE PROPER FIT OF NEW WORK TO EXISTING. REPORT ANY DISCREPANCIES TO RJC PRIOR TO STARTING WORK.
- 5. COMMENCEMENT OF CONSTRUCTION OR ANY PART THEREOF CONSTITUTES ACCEPTANCE OF EXISTING CONDITIONS AND MEANS DIMENSIONS AND ELEVATIONS HAVE BEEN CONSIDERED, VERIFIED AND ARE ACCEPTABLE.
- ANY OPENINGS THAT ARE NOT SHOWN OR INDICATED ON THE STRUCTURAL DRAWINGS SHALL BE REPORTED TO RJC FOR REVIEW. THESE OPENINGS MAY NOT BE ALLOWED, MAY HAVE TO BE MOVED, OR MAY REQUIRE ADDITIONAL STRUCTURAL WORK AND DETAILING. DO NOT PROCEED WITH THESE OPENINGS WITHOUT WRITTEN PERMISSION FROM RJC.
- 7. NEW OPENINGS TO BE CUT THROUGH EXISTING WALLS SHALL BE CLEARLY MARKED OUT BY THE CONTRACTOR. THE CONTRACTOR SHALL NOTIFY RJC ONCE THE MARKING OUT HAS BEEN COMPLETED SO THAT RJC CAN REVIEW THE PROPOSED LOCATIONS OF ALL NEW OPENINGS. DO NOT PROCEED WITH CUTTING OF NEW OPENINGS WITHOUT THE APPROVAL OF RJC.
- UNLESS NOTED OTHERWISE AT ALL LOCATIONS WHERE NEW CONCRETE WILL BE IN CONTACT WITH EXISTING CONCRETE OR RUBBLE WALL SURFACES, THE EXISTING SURFACE IS TO BE COMPLETELY CLEANED AND ROUGHENED BY HYDRODEMOLITION, BUSH HAMMERING, (OR APPROVED EQUAL) TO AN AMPLITUDE OF 6 mm.
- CONTRACTOR TO ENSURE THAT UNDERGROUND OR IN-SLAB SERVICES ARE NOT DAMAGED THROUGH DEMOLITION, SAWCUTTING, HOLE AUGURING, OR OTHER CONSTRUCTION ACTIVITIES. SEE SPECIFICATION FOR TESTING/LOCATING REQUIREMENTS.
- THE CONTRACTOR IS RESPONSIBLE FOR SAFETY IN AND ABOUT THE JOB SITE DURING CONSTRUCTION, AND THE DESIGN AND ERECTION OF ALL TEMPORARY STRUCTURES, FORMWORK, FALSEWORK, SHORING, BRACING, ETC., REQUIRED TO COMPLETE THE WORK (SUBMIT SHORING DRAWINGS SEALED BY A SPECIALTY STRUCTURAL ENGINEER).
- 11. DRILL AND SITE MEASURE BOLT HOLES IN EXISTING STRUCTURE PRIOR TO FABRICATING STEEL CONNECTION PLATES. BOLT HOLES MAY HAVE TO BE MOVED FROM WHAT IS SHOWN ON THE DRAWINGS TO AVOID CUTTING EXISTING REINFORCING OR TO AVOID OTHER SITE CONDITIONS. SITE MODIFICATION OF STEEL CONNECTION PLATES WILL NOT BE ACCEPTED WITHOUT THE PRIOR APPROVAL OF RJC.



Creative Thinking Practical Results

Read Jones Christoffersen Ltd. Engineers rjc.ca

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1	ISSUE FOR CONSTRUCTION	30/09/2022	DW
No.	Revision	Date	Ву
Drawin	g Notes		

- 1. All drawings, plans, models, designs, specifications and other documents prepared by Read Jones Christoffersen Ltd. ("RJC") and used in connection with this project are instruments of service for the work shown in them (the "Work") and as such are and remain the property of RJC whether the Work is executed or not, and RJC reserves the copyright in them and in the Work executed from them, and they shall not be used for any other work or project.
- 2. These drawings are "design drawings" only. They may not be suitable for use as shop drawings. Use of these drawings as base drawings for "shop drawings" is not permitted unless written permission containing certain conditions and limitations is obtained from RJC. The work "as constructed" may vary from what is shown on these drawings.
- 3. Use of these drawings is limited to that identified in the Revision column. Do not construct from these drawings unless marked "Issued for Construction" by RJC in the Revision column, and then only for the parts noted. The drawings shall not be used for "pricing", "costing", or "tender" unless so indicated in the Revision column. "Pricing" or "Costing" drawings are not complete and any prices based on such drawings must allow for this.

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Project Name


Sheet Title

Northern Junk CONSTRUCTION ENGINEERING

1314-1318 Wharf Street, Victoria B.C.

LEVEL 0 UNDERPINNING PLAN

Drawn By	DRM	Scale	1/8" = 1'-0"	
Designed By	DRM	Date	15/07/2022	
RJC Project N	umber	VIC.	100479.0006	5
Sheet Number				Revision
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Project Name

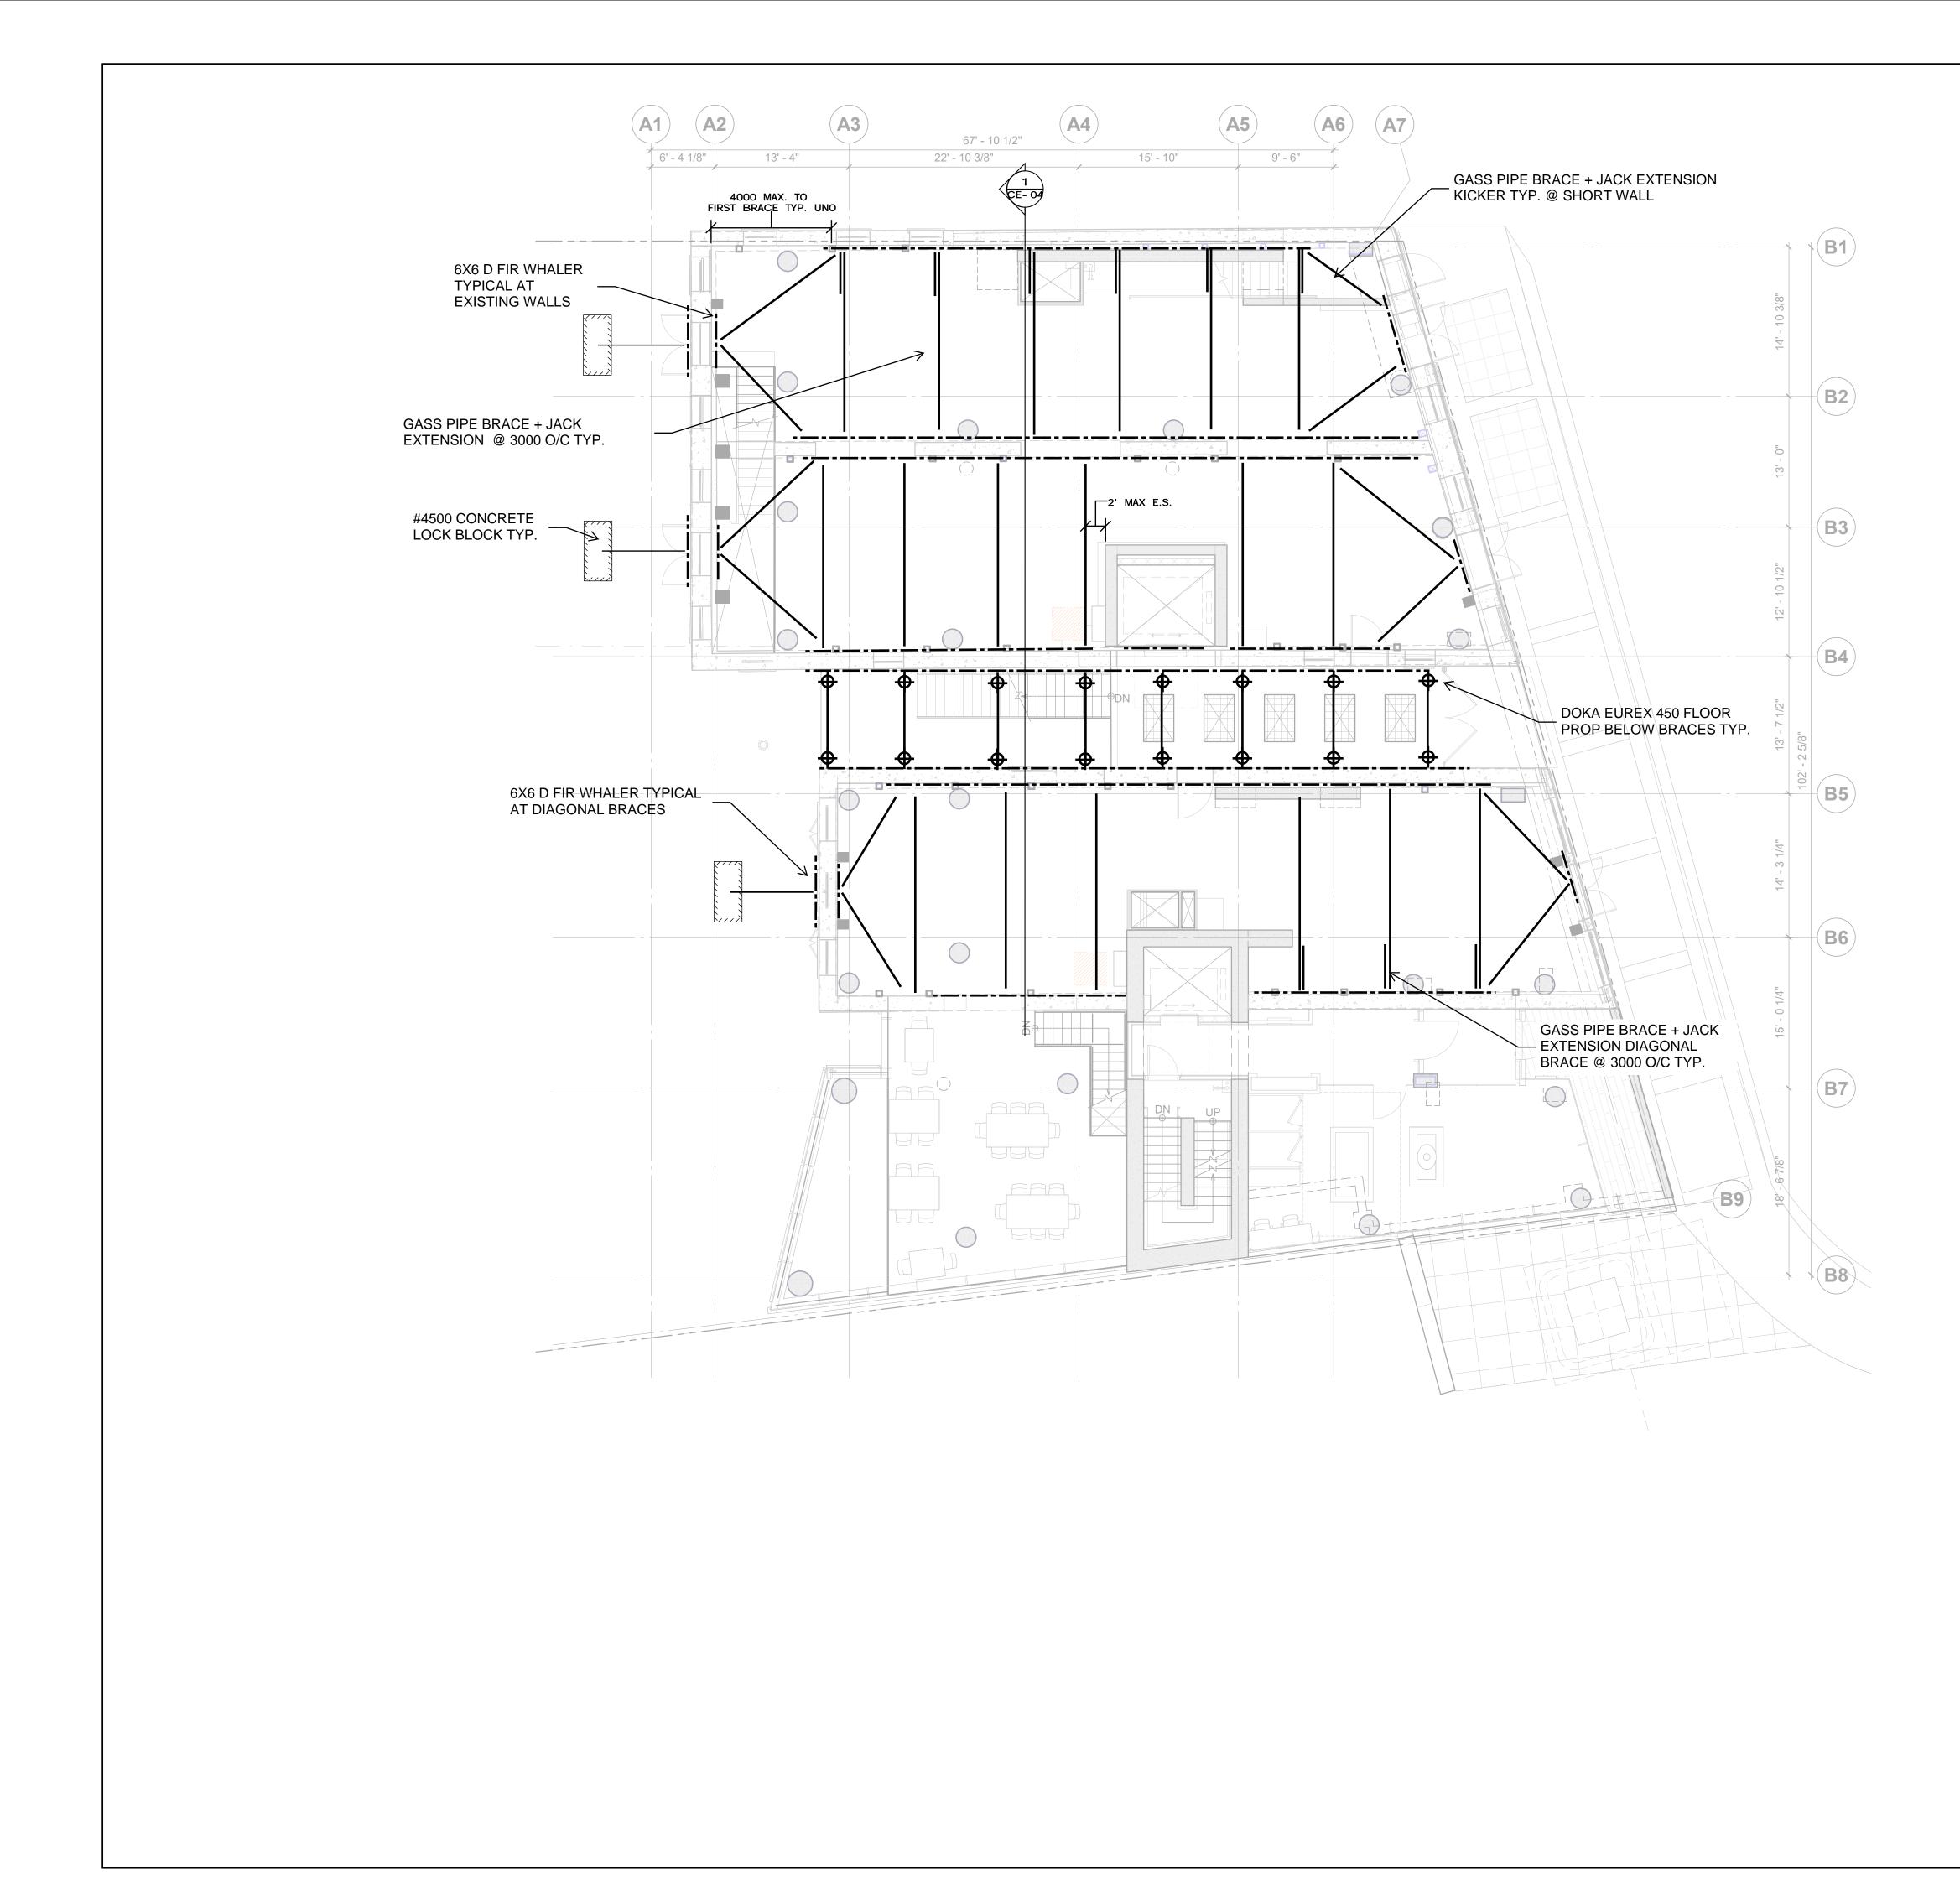
Northern Junk construction engineering

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Sheet Title
LEVEL 1 BRACING PLAN

Designed By	DRM	Date	15/07/2022	
RJC Project Number		VIC.	100479.000)6
Sheet Number				Revisio

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1	ISSUE FOR CONSTRUCTION	30/09/2022	DW
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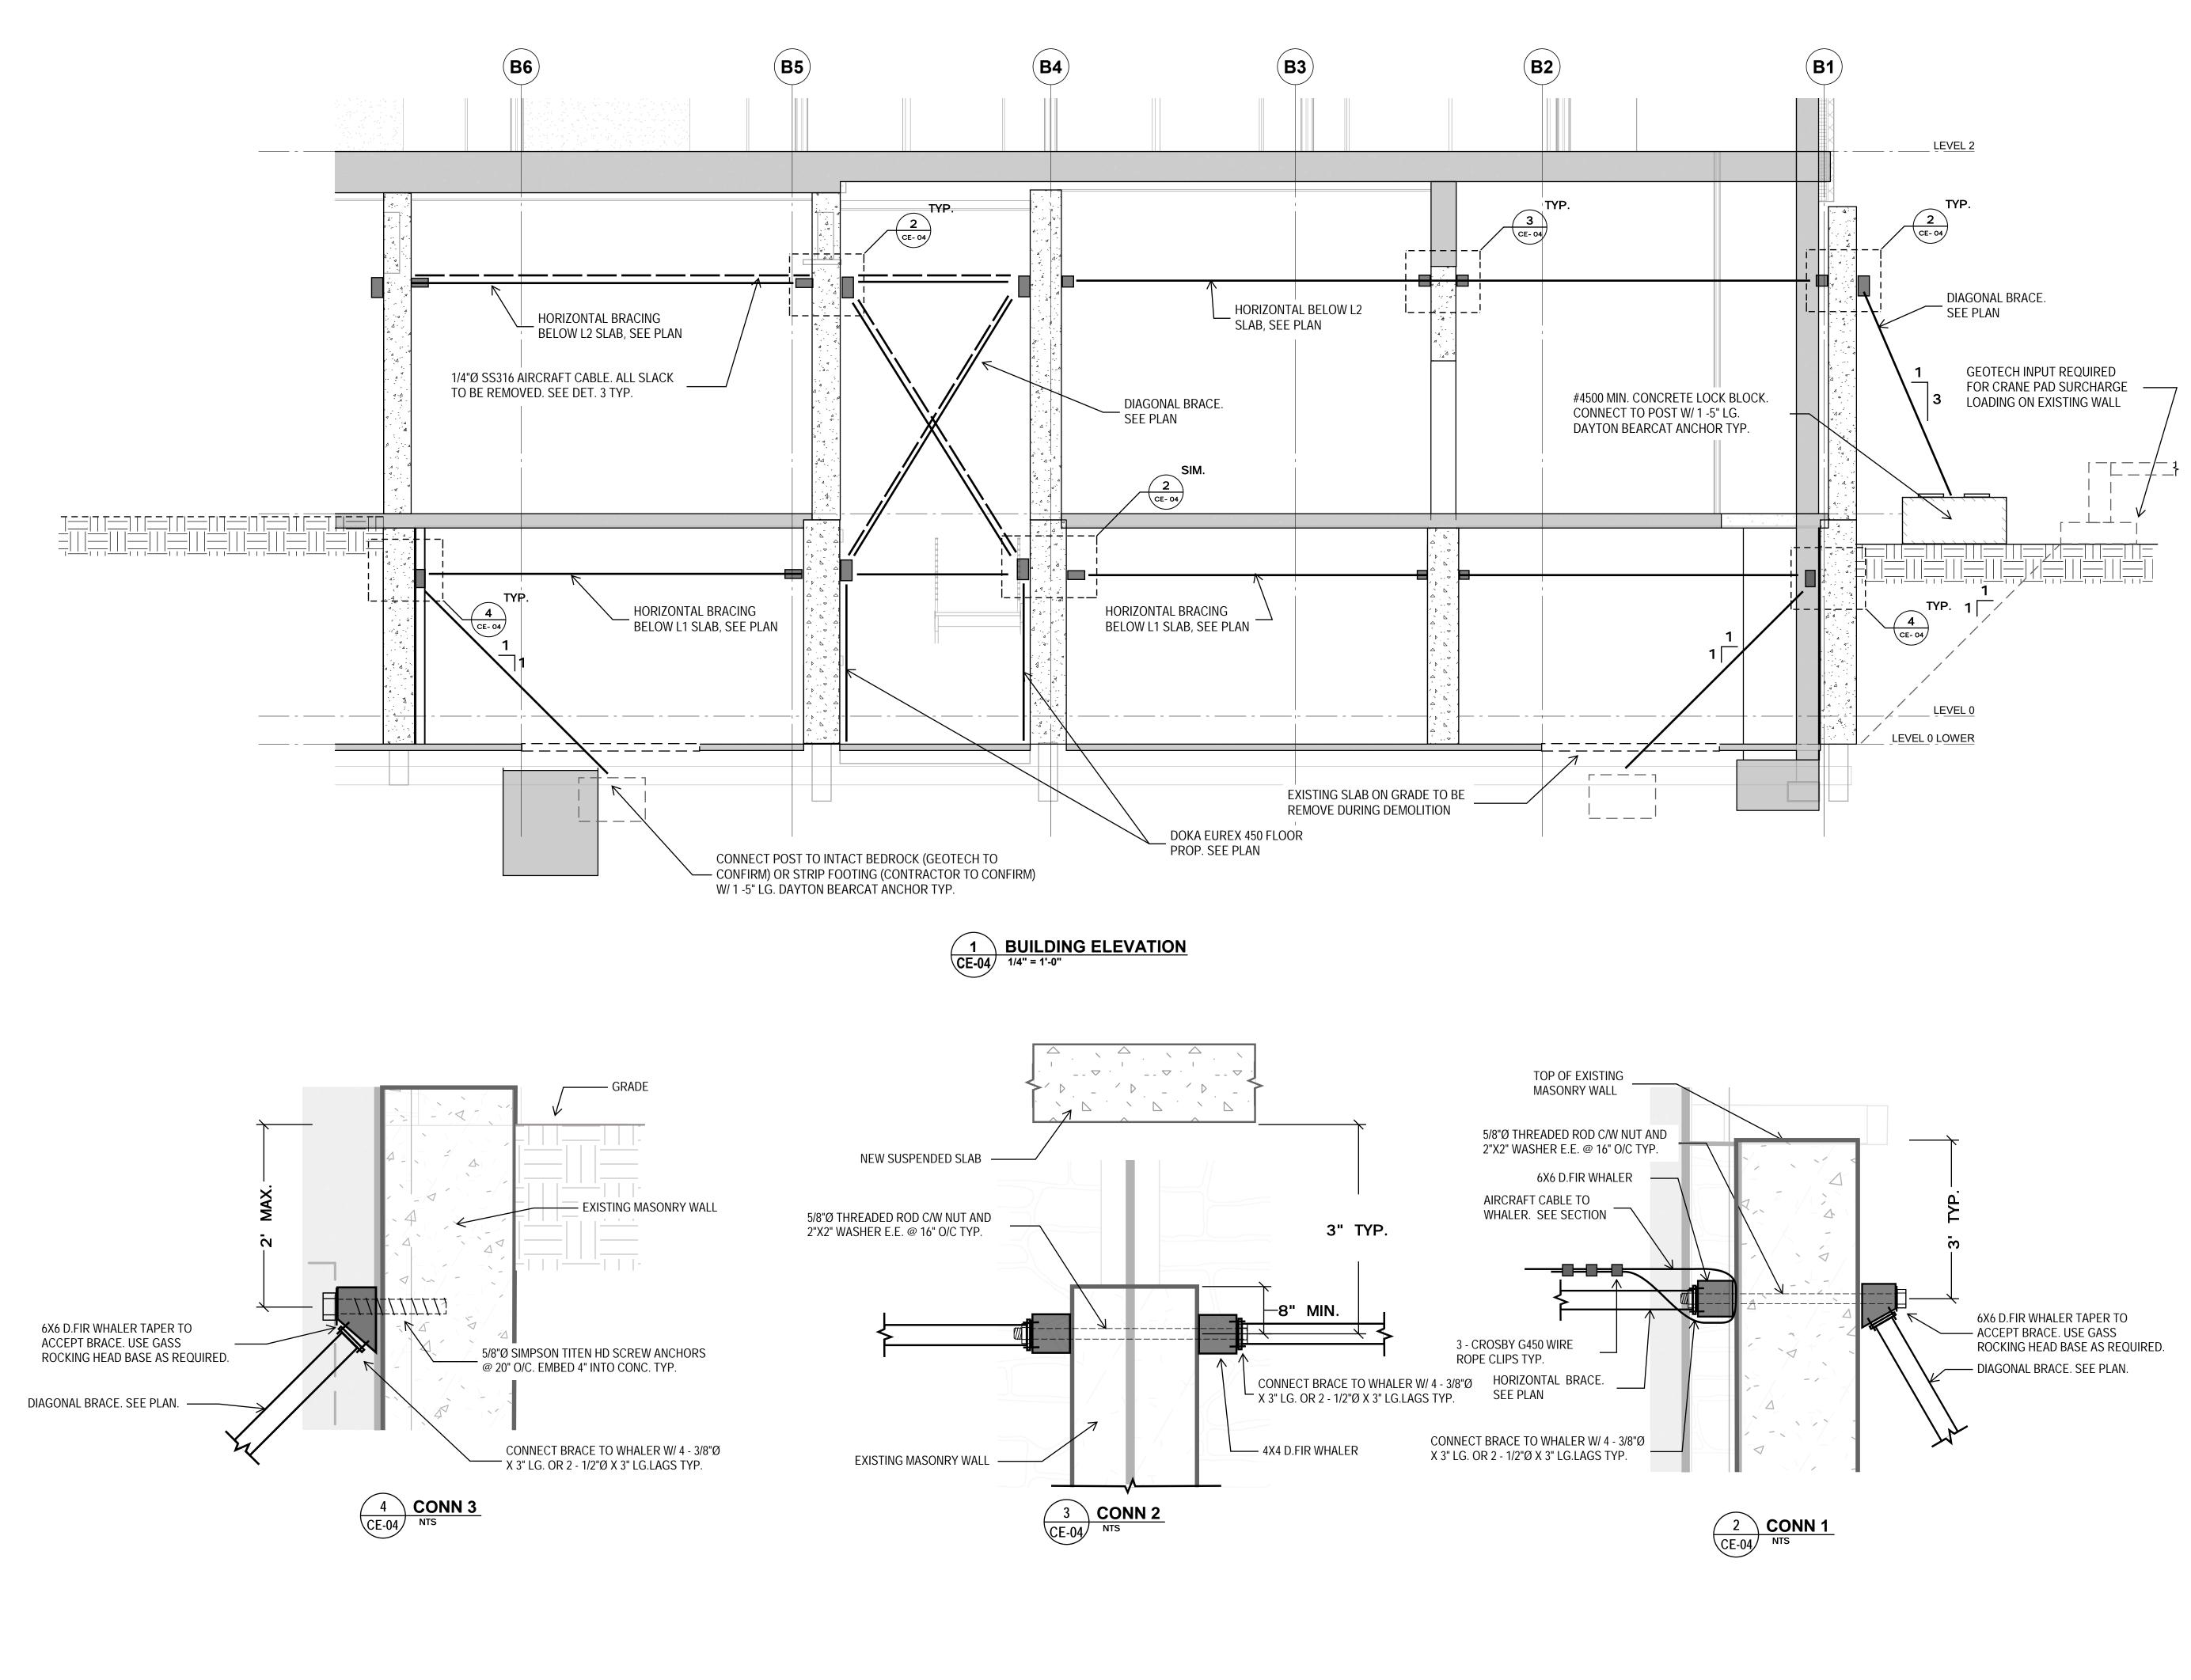
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Sheet Title LEVEL 2 BRACING PLAN

Drawn By	DRM	Scale	1/8" = 1'-0"	
Designed By	DRM	Date	15/07/2022	
RJC Project Number		VIC.	100479.00	06
Sheet Number				Revision
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No.	No. Revision		Ву	
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Project Name

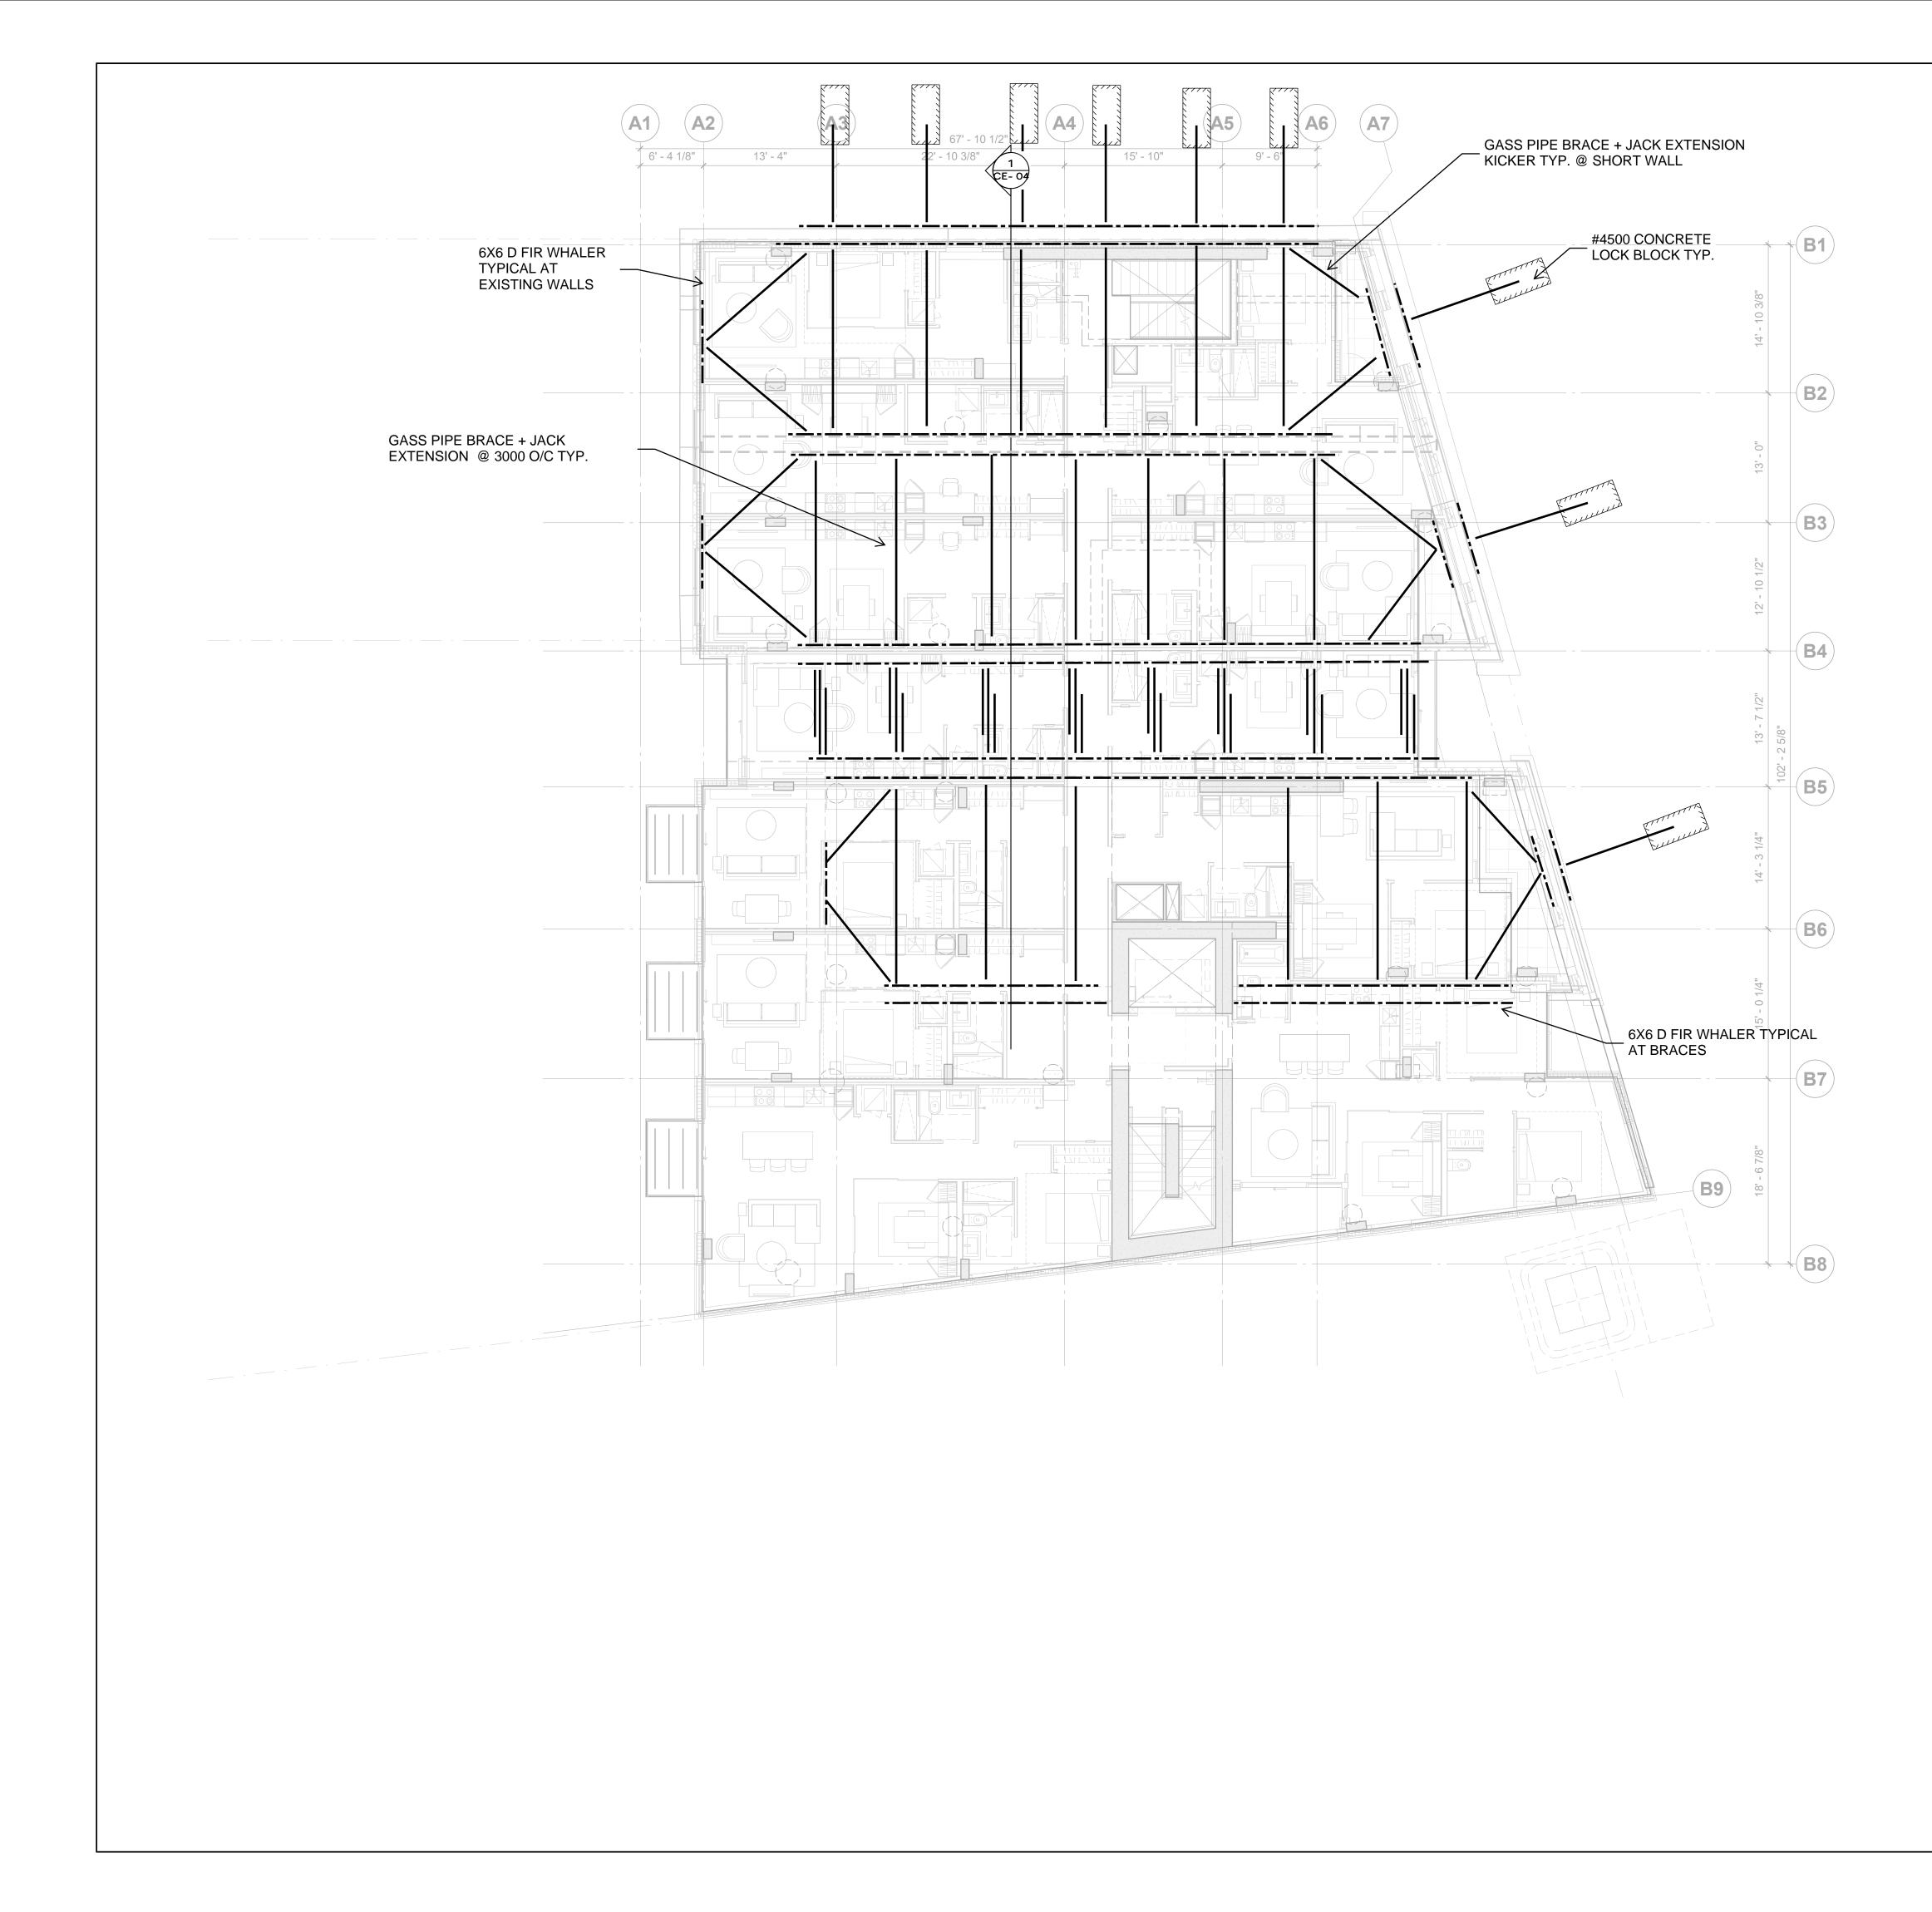Sheet Title


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ELEVATIONS AND DETAILS

Sheet Number			Revisio
RJC Project Number		VIC.	100479.0006
Designed By	DRM	Date	15/07/2022
Drawn By	DRM	Scale	1/4" = 1'-0"





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Project Name

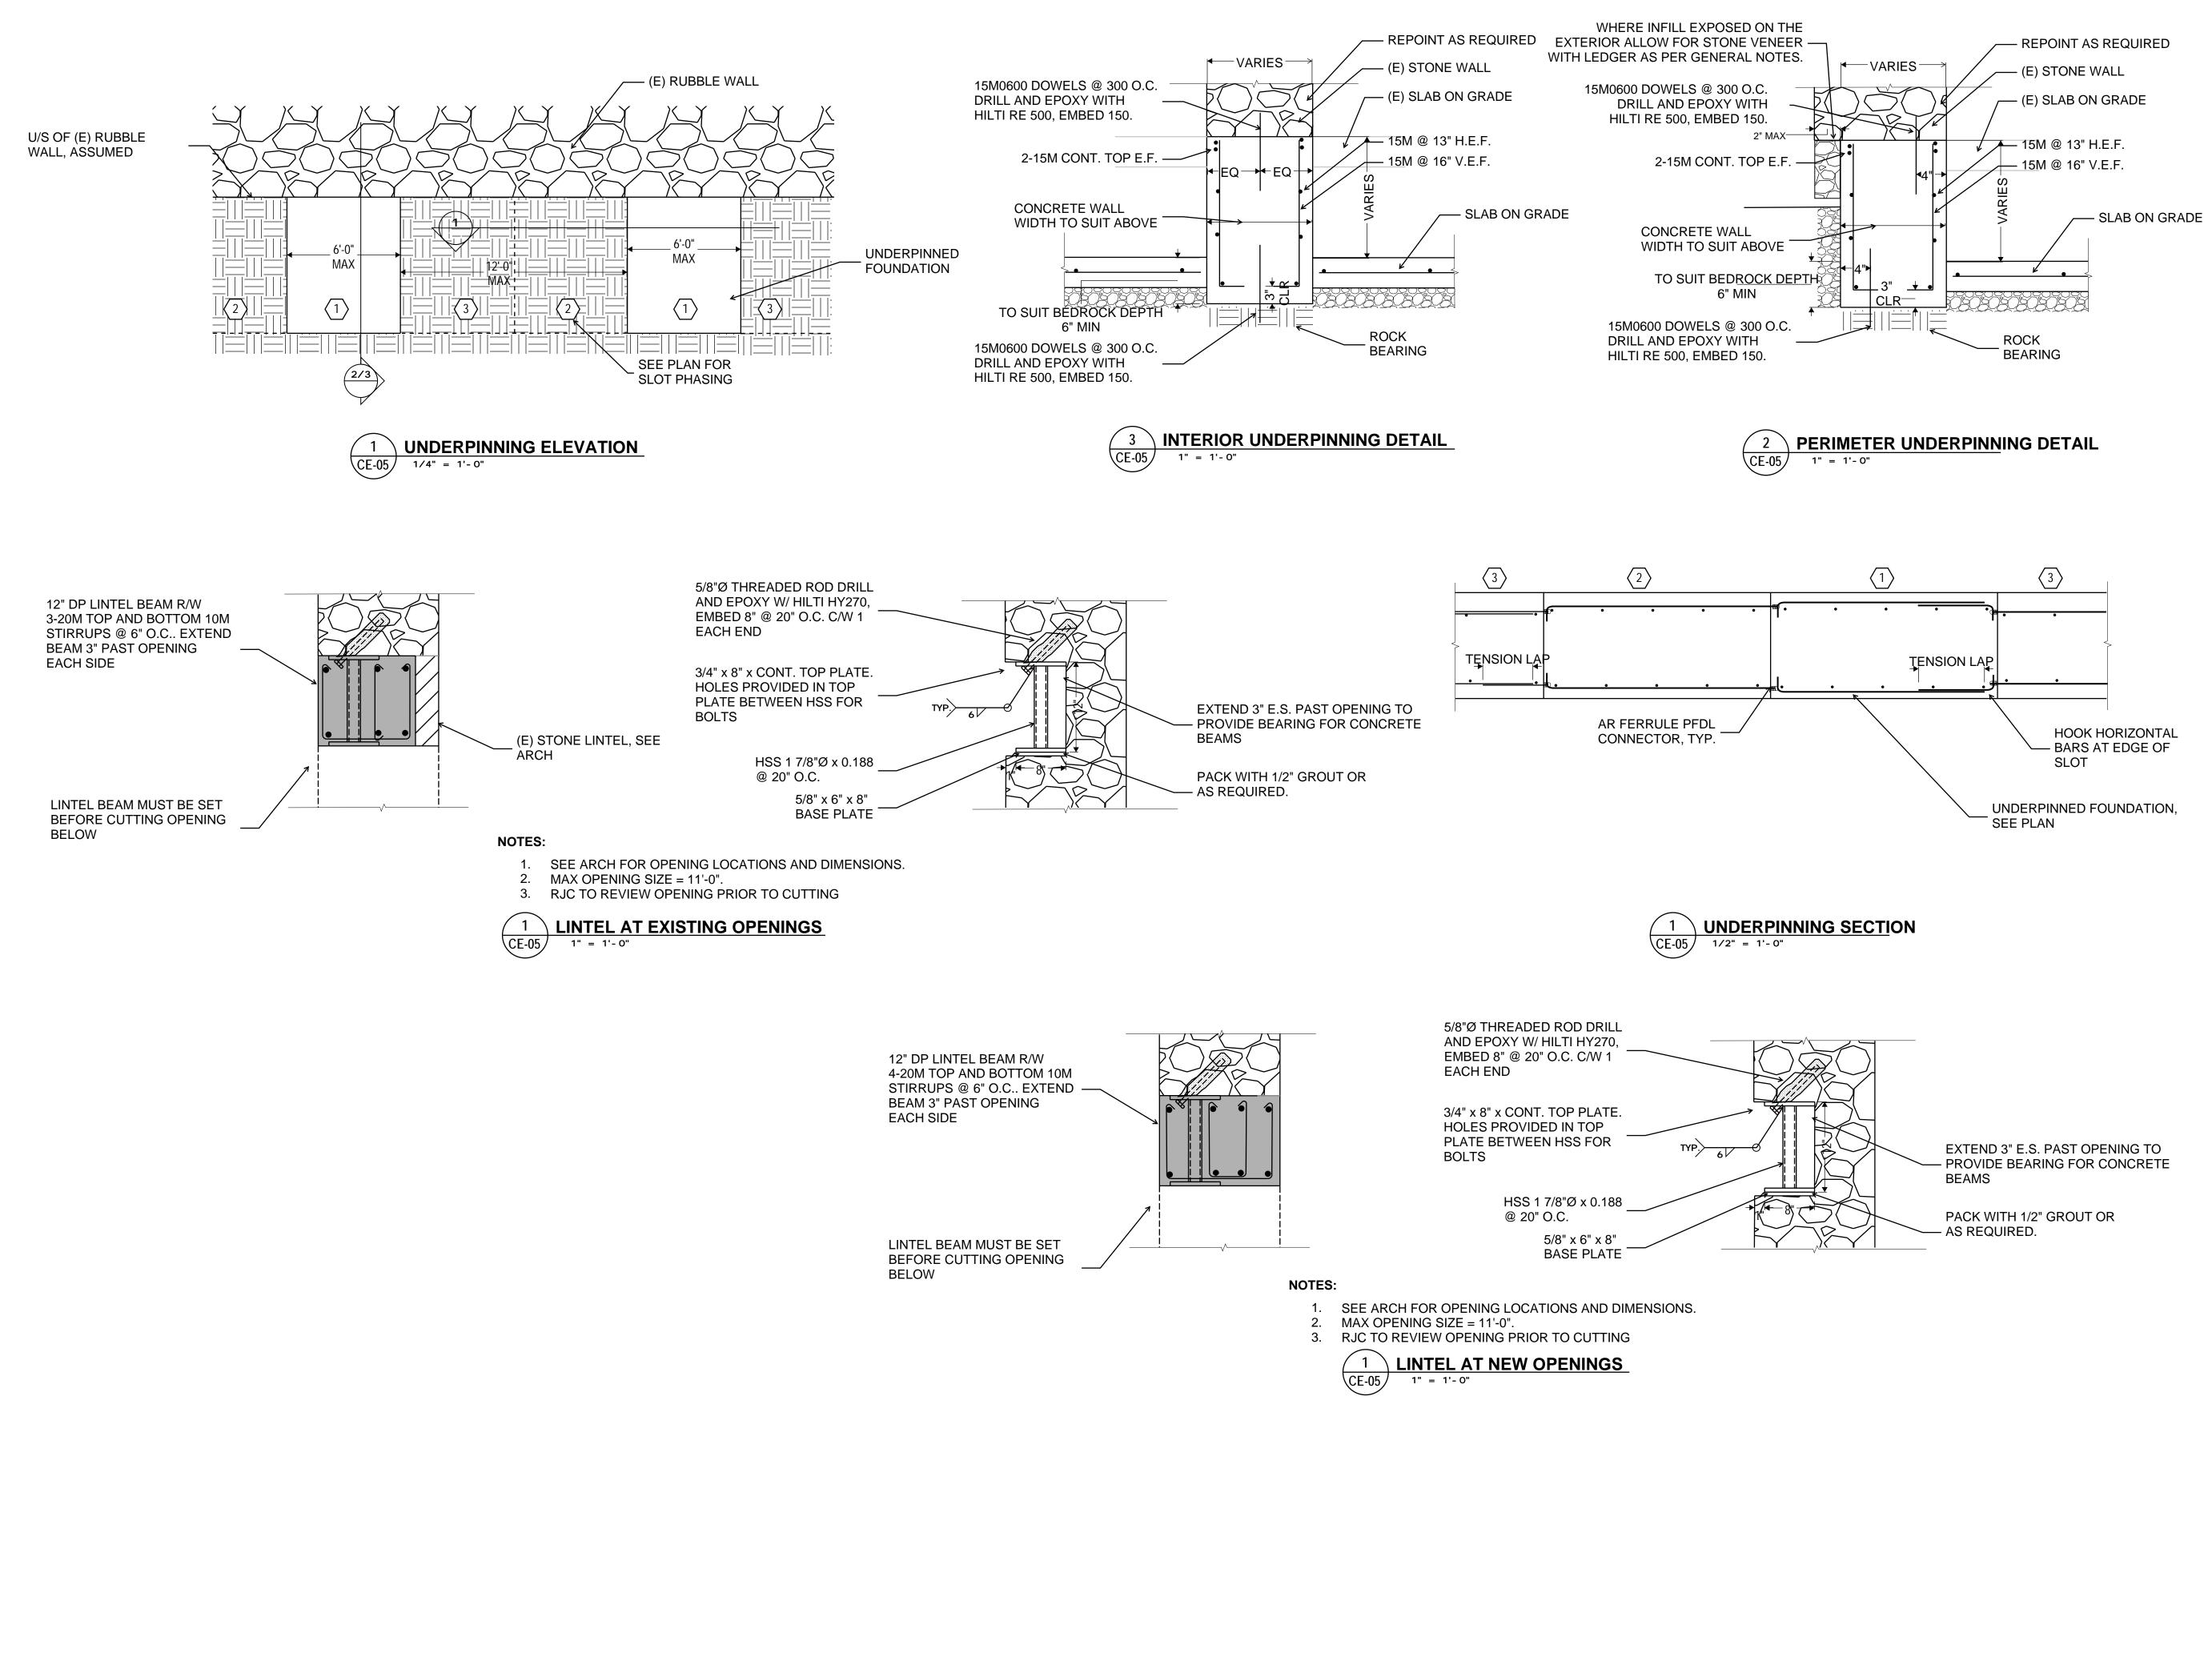Sheet Title

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UNDERPINNING DETAILS

Sheet Number			Revision
RJC Project Number		VIC.	100479.0006
Designed By	DRM	Date	15/07/2022
Drawn By	DRM	Scale	AS NOTED



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