

1733-37 Fairfield Rd.

We acknowledge with respect the Ləkwəŋən and WSÁNEĆ peoples on whose traditional territory the property stands and the Songhees and Esquimalt Nations whose historical relationships with the land continue to this day.



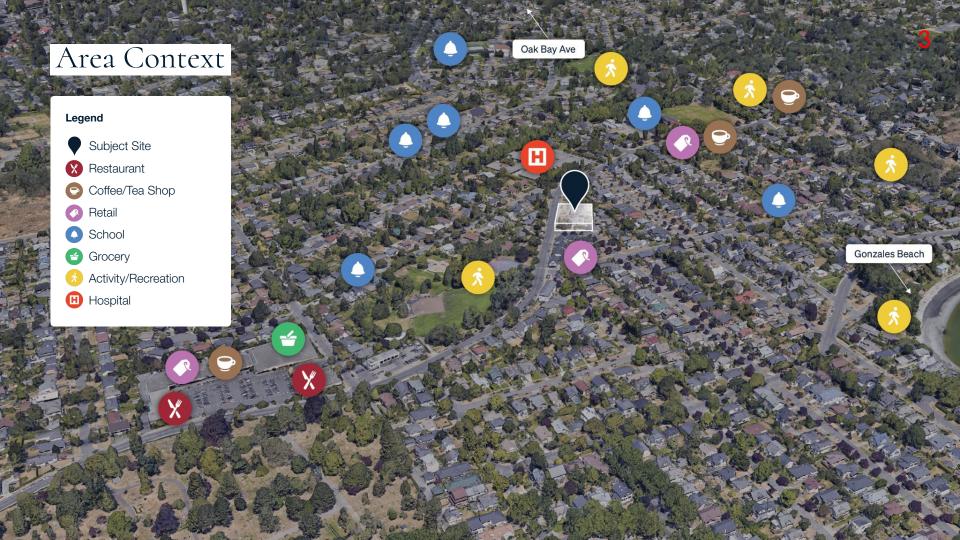

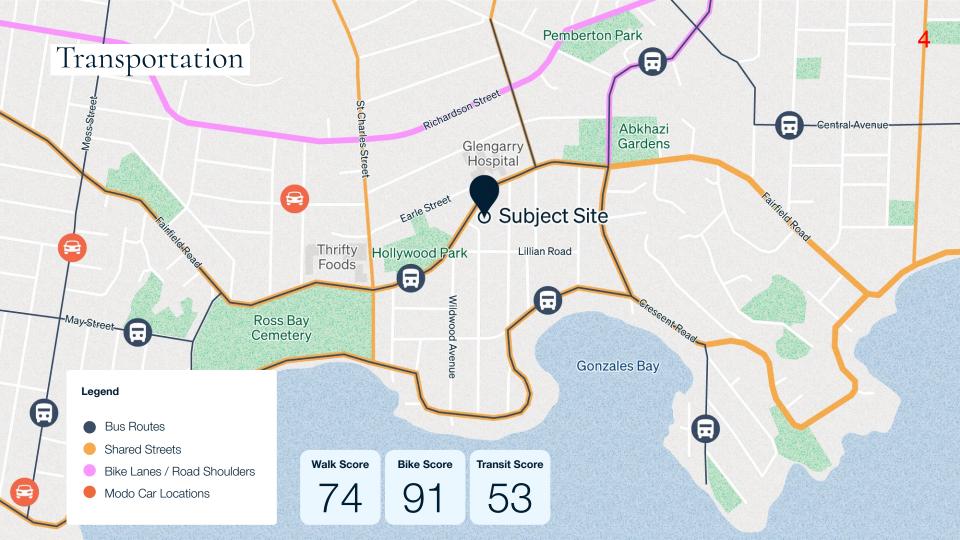

Project Pillars





Thoughtful Design

Consideration of the neighbouring context, while balancing new, modern design and architecture.





Housing Diversity

Range of housing choice—welcoming families to the neighbourhood and right-sizers to stay in their community.





Preserving Greenspace

Downzoning and heritage designation of Abkhazi Garden through a density transfer.






Building Performance

Surpassing current energy requirements with a zero-carbon approach and a commitment to BC Step Code 4 (Net-Zero Ready).




Building Placement

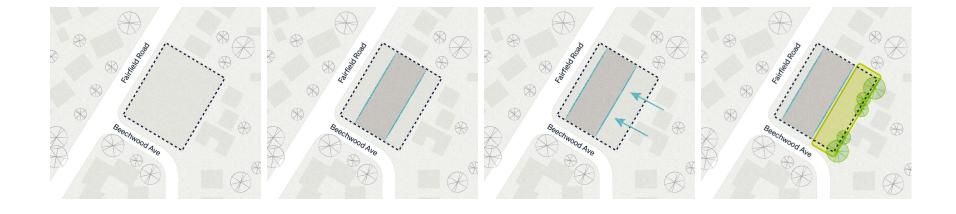


Design Moves


Simplify the Roof

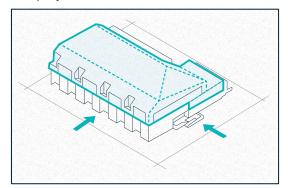

Articulate the Base

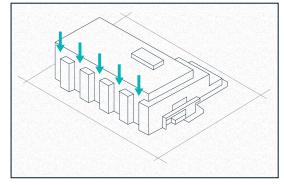

The Results

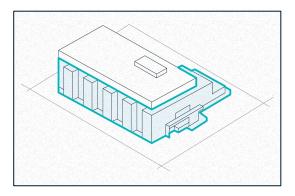

Building Section



Shadow Studies

Original

Equinox 9:00 am



Proposed

Equinox 9:00 am



Equinox 12:00 pm



Equinox 12:00 pm



Equinox 4:00 pm



Equinox 4:00 pm



View from Fairfield



View from Fairfield











Pedestrian View from Fairfield



Pedestrian View from Fairfield



View from Beechwood




Montague Courts




View from Fairfield & Beechwood



Community Engagement

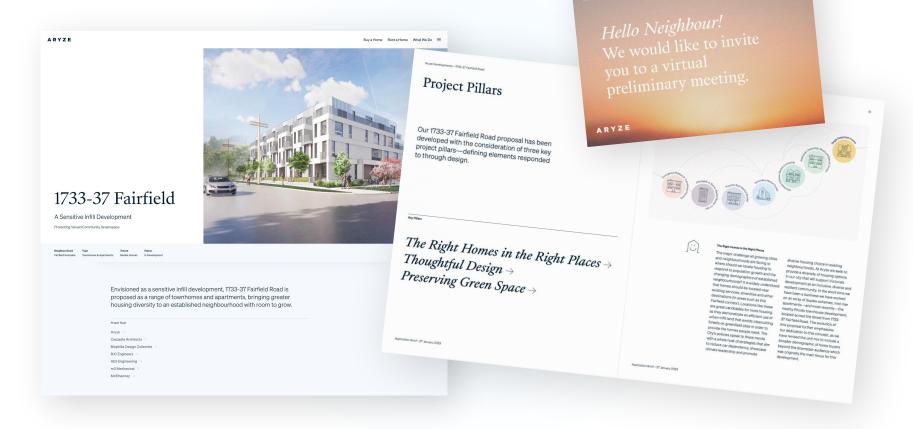

Submission Timeline

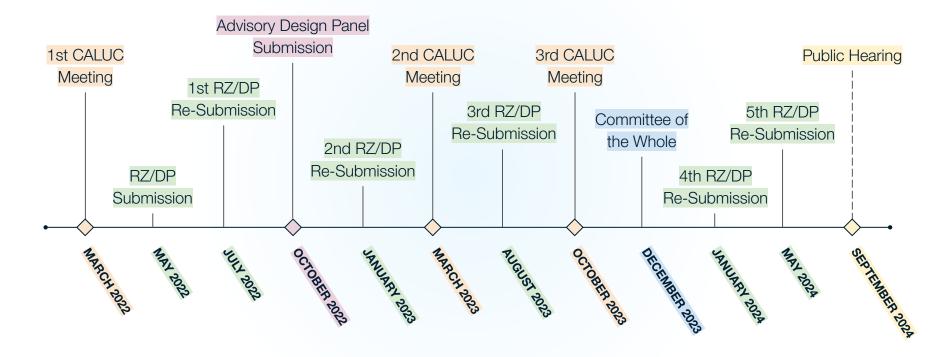

Design Changes



Design & Unit Mix

- ✓ Simplified roof form and material change
- Redesign of North-Eastern facade to improve neighbourliness
- ✓ Increased # of larger home sizes
- Larger outdoor patios at ground level to improve amenity and activate street



Parking & Transportation

- Curb bulge and increased public safety on Beechwood crossing
- New MODO offsite carshare for wider community use
- ✓ Additional accessible parking stall
- Increased number of oversized parking stalls for cargo bikes



Building Performance

- Commitment to Step Code 4 building performance
- ✓ Full electrification in the building—no gas
- Design is solar-ready to support renewable energy
- Greater permeable surfaces in parking area to improve stormwater management



Contact


Aryze Developments 1839 Fairfield Road Victoria, BC V8S 1G9


info@aryze.ca





Abkhazi Garden 1964 Fairfield Road & 507 Foul Bay Road Rezoning Application No. 00845



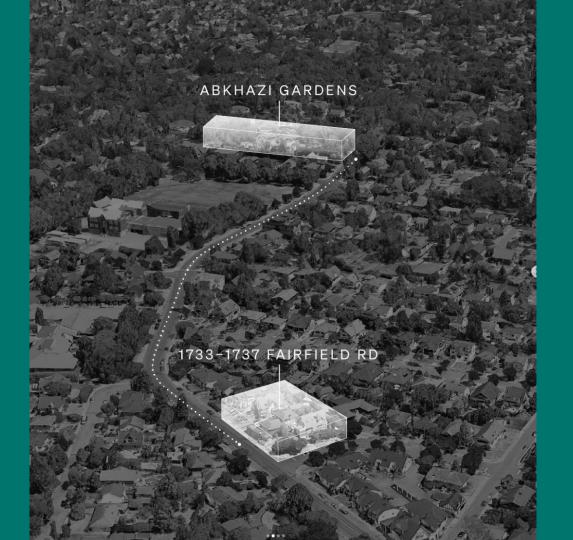

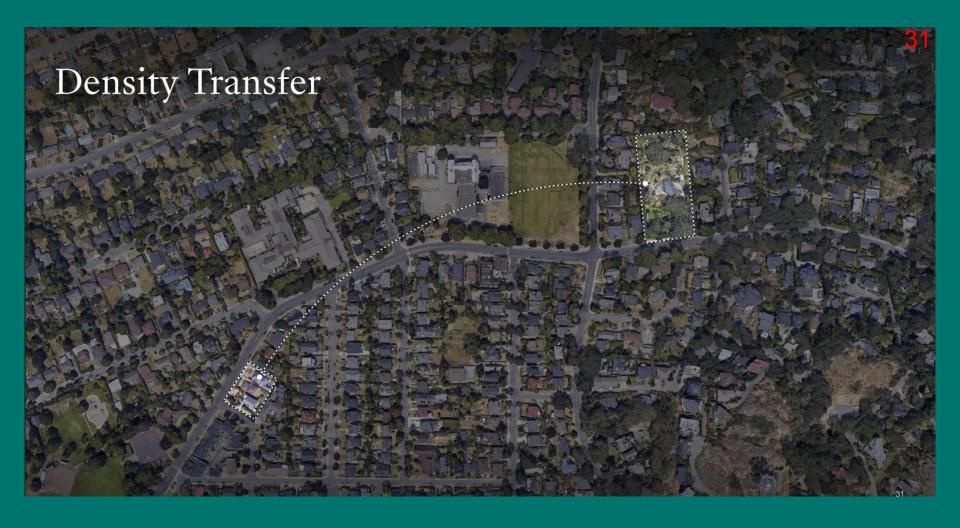

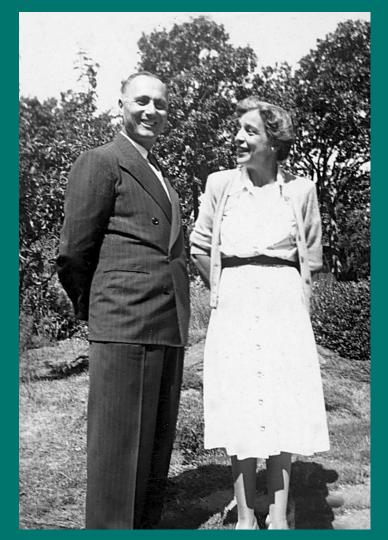

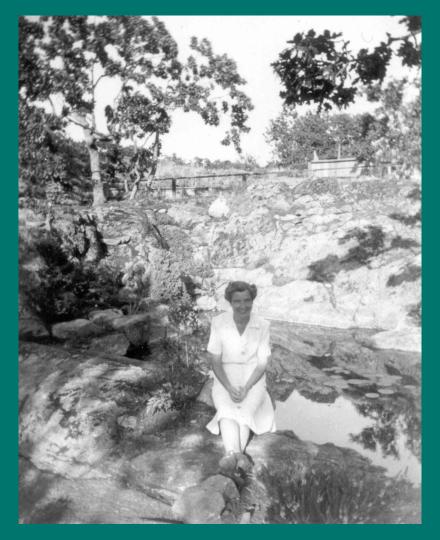


















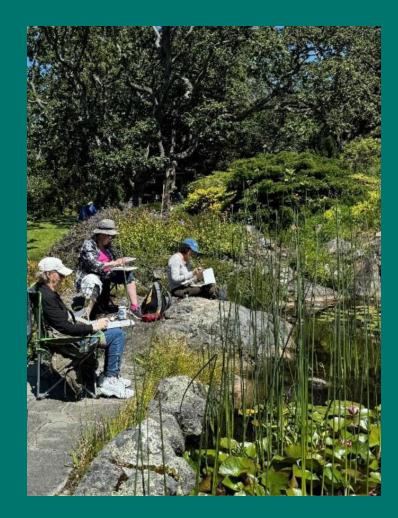

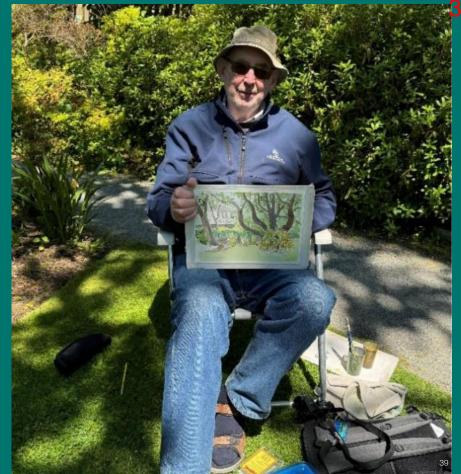





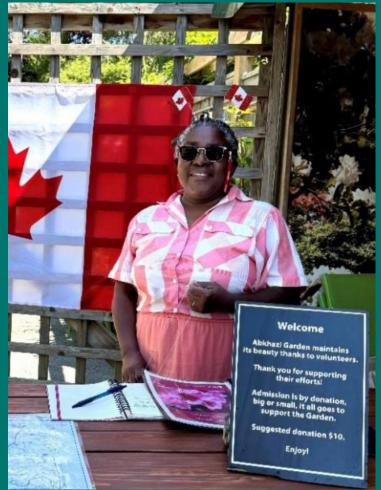

















Appendix

Additional Perspectives



Additional Perspectives



Project at a Glance











Height 4 Storeys

N. Setback 2.33m

E. Setback

Homes 29

23 Stalls

Parking

Site Area

18,751 sqft 2.62m **Townhomes**

6 Townhomes

Short term Bike

6 stalls

Floor Area

33,506 sqft

S. Setback

4.78-11.9m

1 Bedroom

10 Homes

Long term Bike

51 stalls

Site Coverage

65%

W. Setback

2.73m

2 Bedroom (+ Den)

13 Homes


Unique Features

Oversized storage lockers

Zero-carbon/100% Electric HVAC and hot water delivery systems

BC Energy Step Code Step Code 4


Massing Relative to Missing Middle Housing

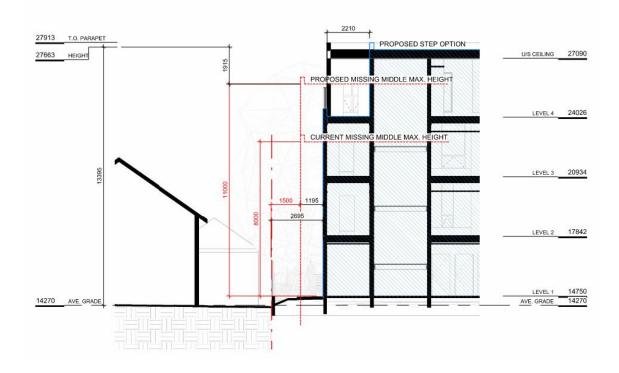

On-Street Parking Analysis



Tree Diagram

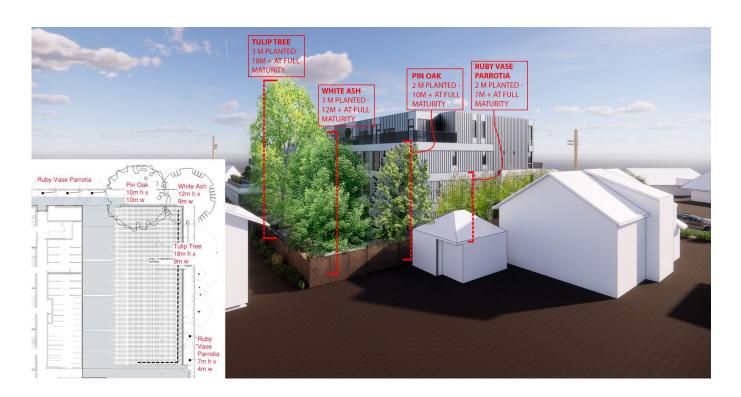

Window Revision



Abkhazi Garden Site Improvements



Abkhazi Garden Site Improvements







CONTACTS

OWNER Aryze Developments Inc. 1839 Fairfield Road Victoria, BC V85 1G9

Mike Wagar mwagar@aryze.ca 250.940.3568 ext. 375

ARCHITECT

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LANDSCAPE DESIGNER

Biophilia 1608 Camosun Street Victoria, BC V8T 3E6

Bianca Bodley bianca@biophiliacollective.ca 250.590.1156

CIVIL ENGINEER

Nathan Dunlop

McElhanney 500 - 3960 Quadra Street Victoria, BC V8X 4A3 ndunlop@mcelhanney.com 778.746.7417

LIST OF DRAWINGS

ARCHITECTURAL

A-000	COVER
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PERSPECTIVES

PERSPECTIVE & WINDOW OVERLAY CONTEXT ELEVATIONS & PERSPECTIVES

A-012 SHADOW STUDIES

SITE PLAN & PROJECT DATA

ZONING CALCULATIONS

CODE REVIEW

SPATIAL SEPARATION

A-101 LEVEL 1 PROPOSED PLAN LEVEL 2 PROPOSED PLAN

LEVEL 3 PROPOSED PLAN

LEVEL 4 PROPOSED PLAN

EXTERIOR ELEVATIONS EXTERIOR ELEVATIONS

BUILDING SECTIONS

CIVIL

PRELIMINARY CIVIL PLAN

LANDSCAPE


LANDSCAPE SITE PLAN PAVEMENT SPECIFICATIONS UPPER LEVEL LANDSCAPE PLAN

TREE REMOVAL PLAN

TREE PLANTING PLAN SOIL VOLUME ANALYSIS

GROUND FLOOR PLANTING PLAN UPPER LEVELS PLANTING PLAN

DETAILS

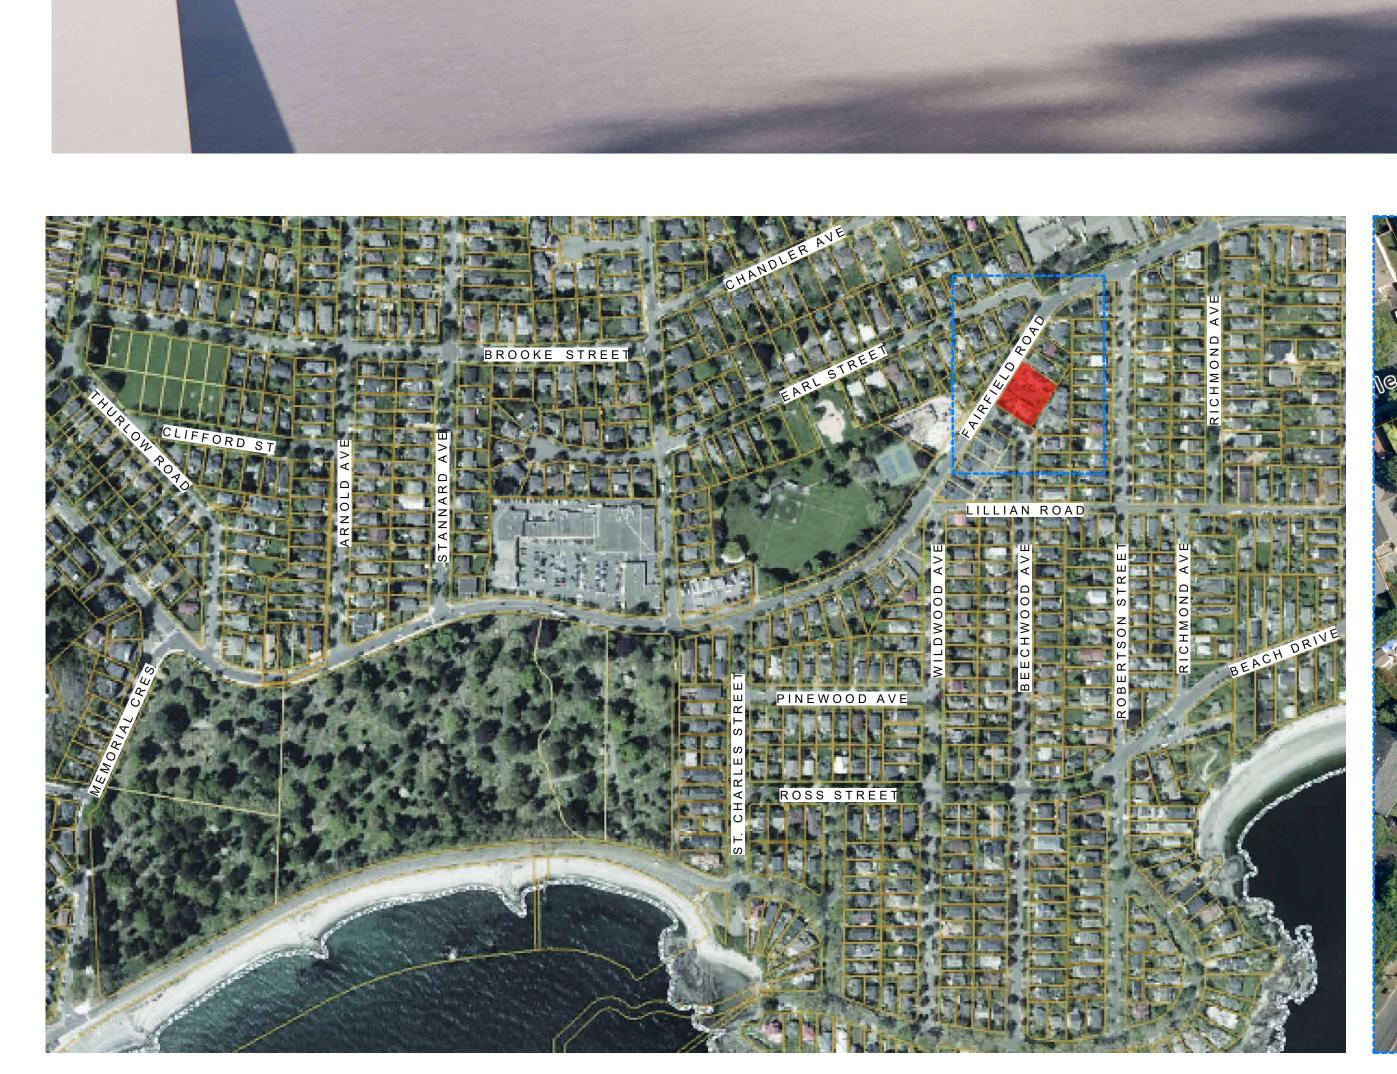



PROJECT SITE (NTS)



1 BEECHWOOD ELEVATION PERSPECTIVE
SCALE = 1:100





NO.	DESCRIPTION	DATE
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4	DP/RZ Rev2	Jan 26, 2023
13	DP/RZ Rev4	Jan 18, 2024
17	DP/RZ Rev5	Feb 21, 2024



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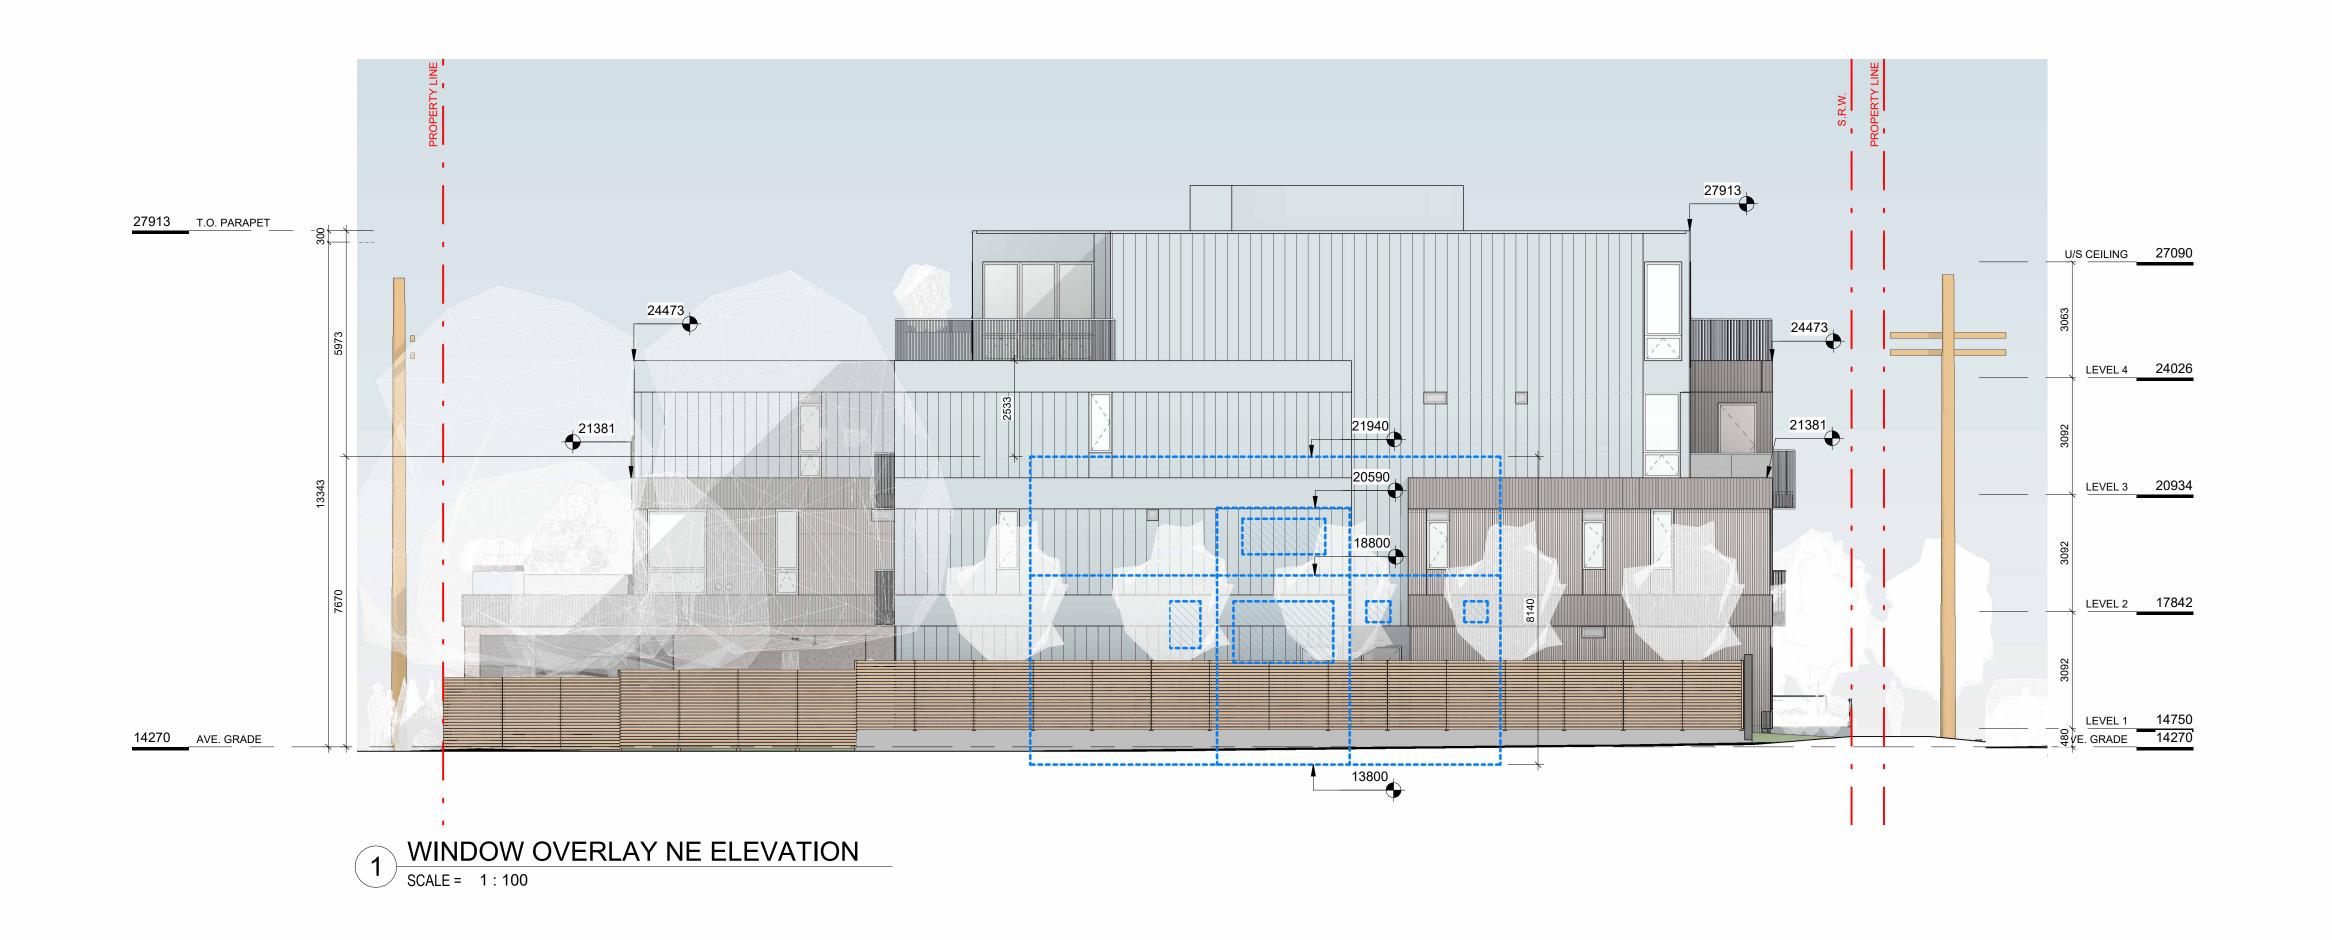
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1733-1737 Fairfield Rd

JUNE 25, 2024


PERSPECTIVES

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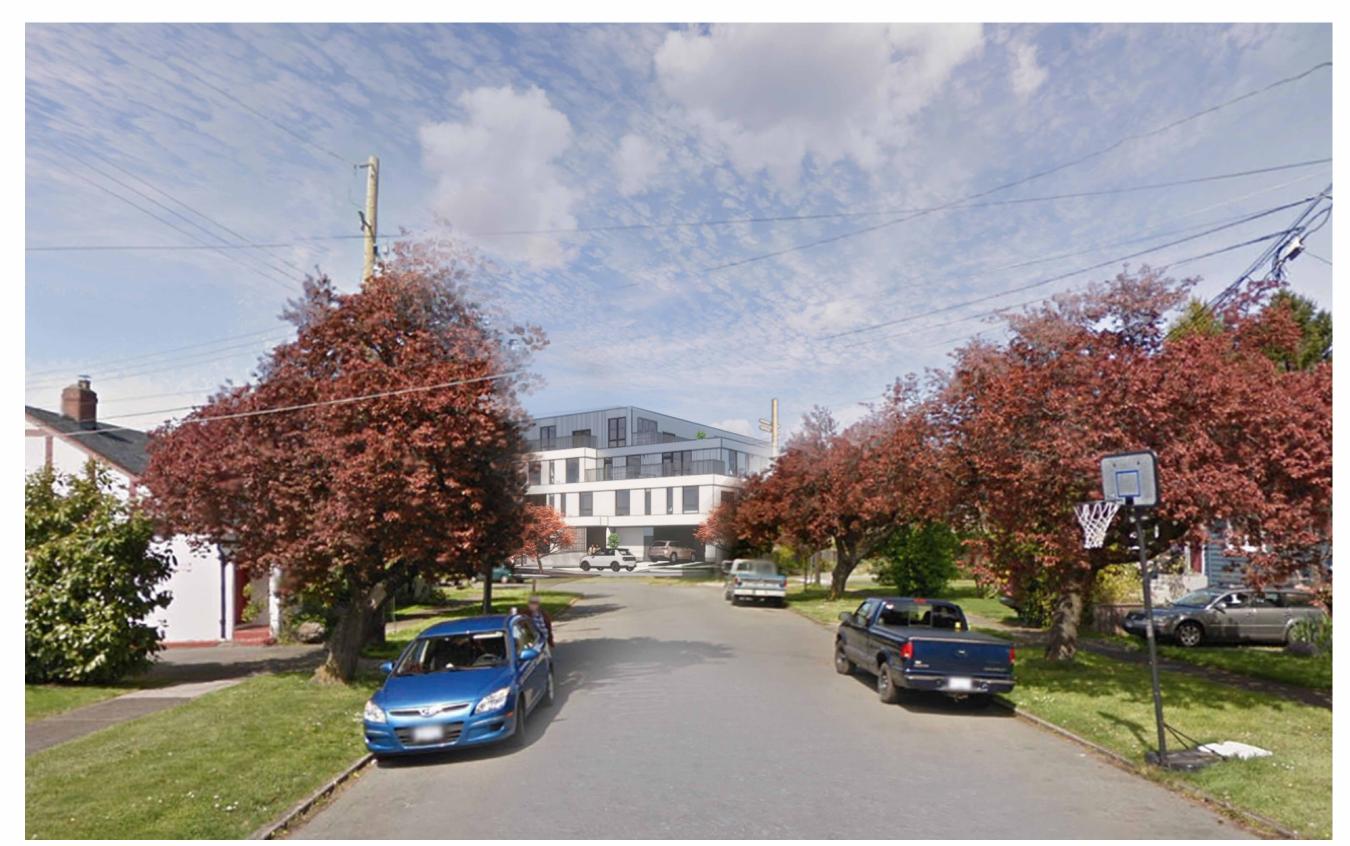




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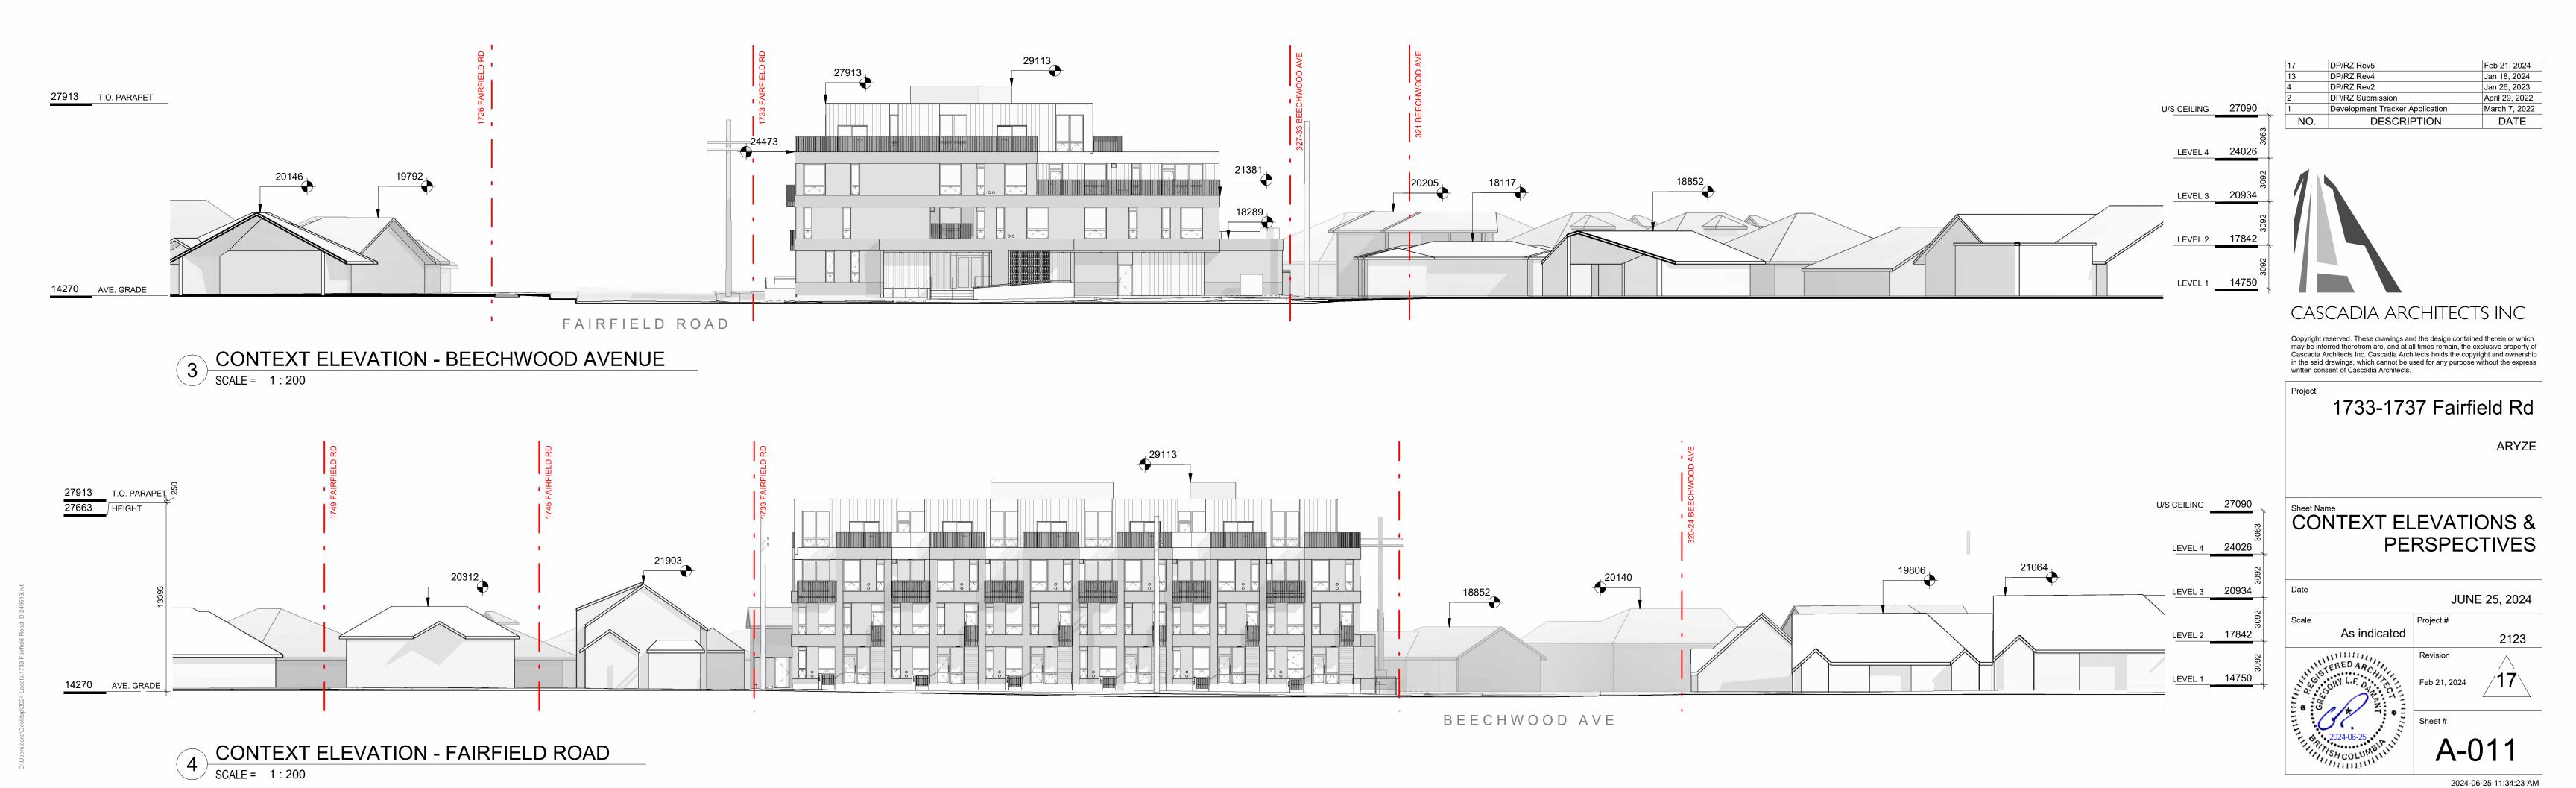
Feb 21, 2024
Jan 18, 2024
Jan 26, 2023
July 20, 2022
DATE



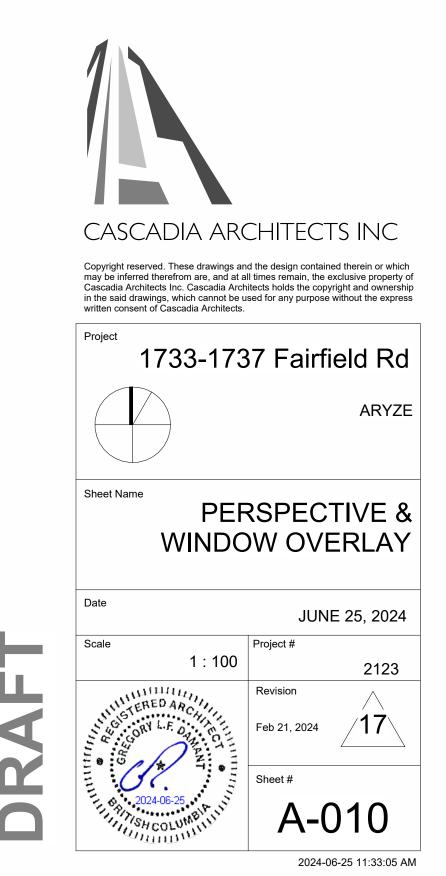


1 CONTEXT PERSPECTIVE FAIRFIELD ROAD
SCALE = 1:100

2 CONTEXT PERSPECTIVE BEECHWOOD AVE SCALE = 1:100




WINTER SOLSTICE 4:00 PM

EQUINOX 4:00 PM

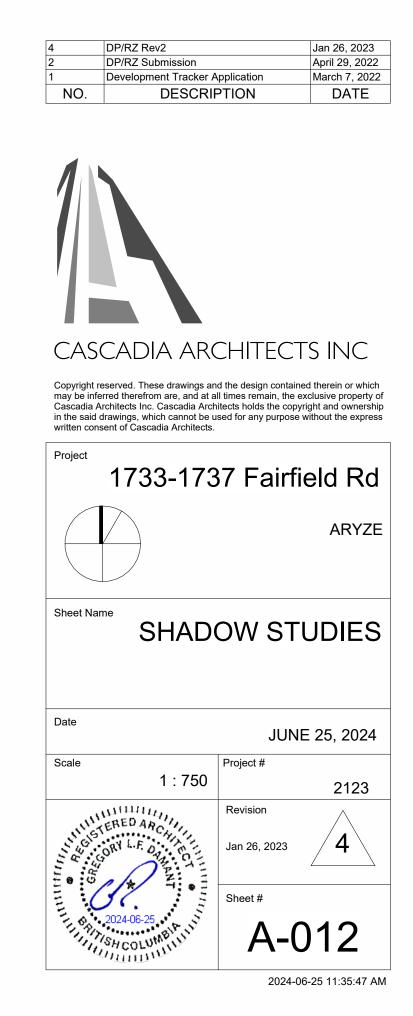

SUMMER SOLSTICE 4:00 PM

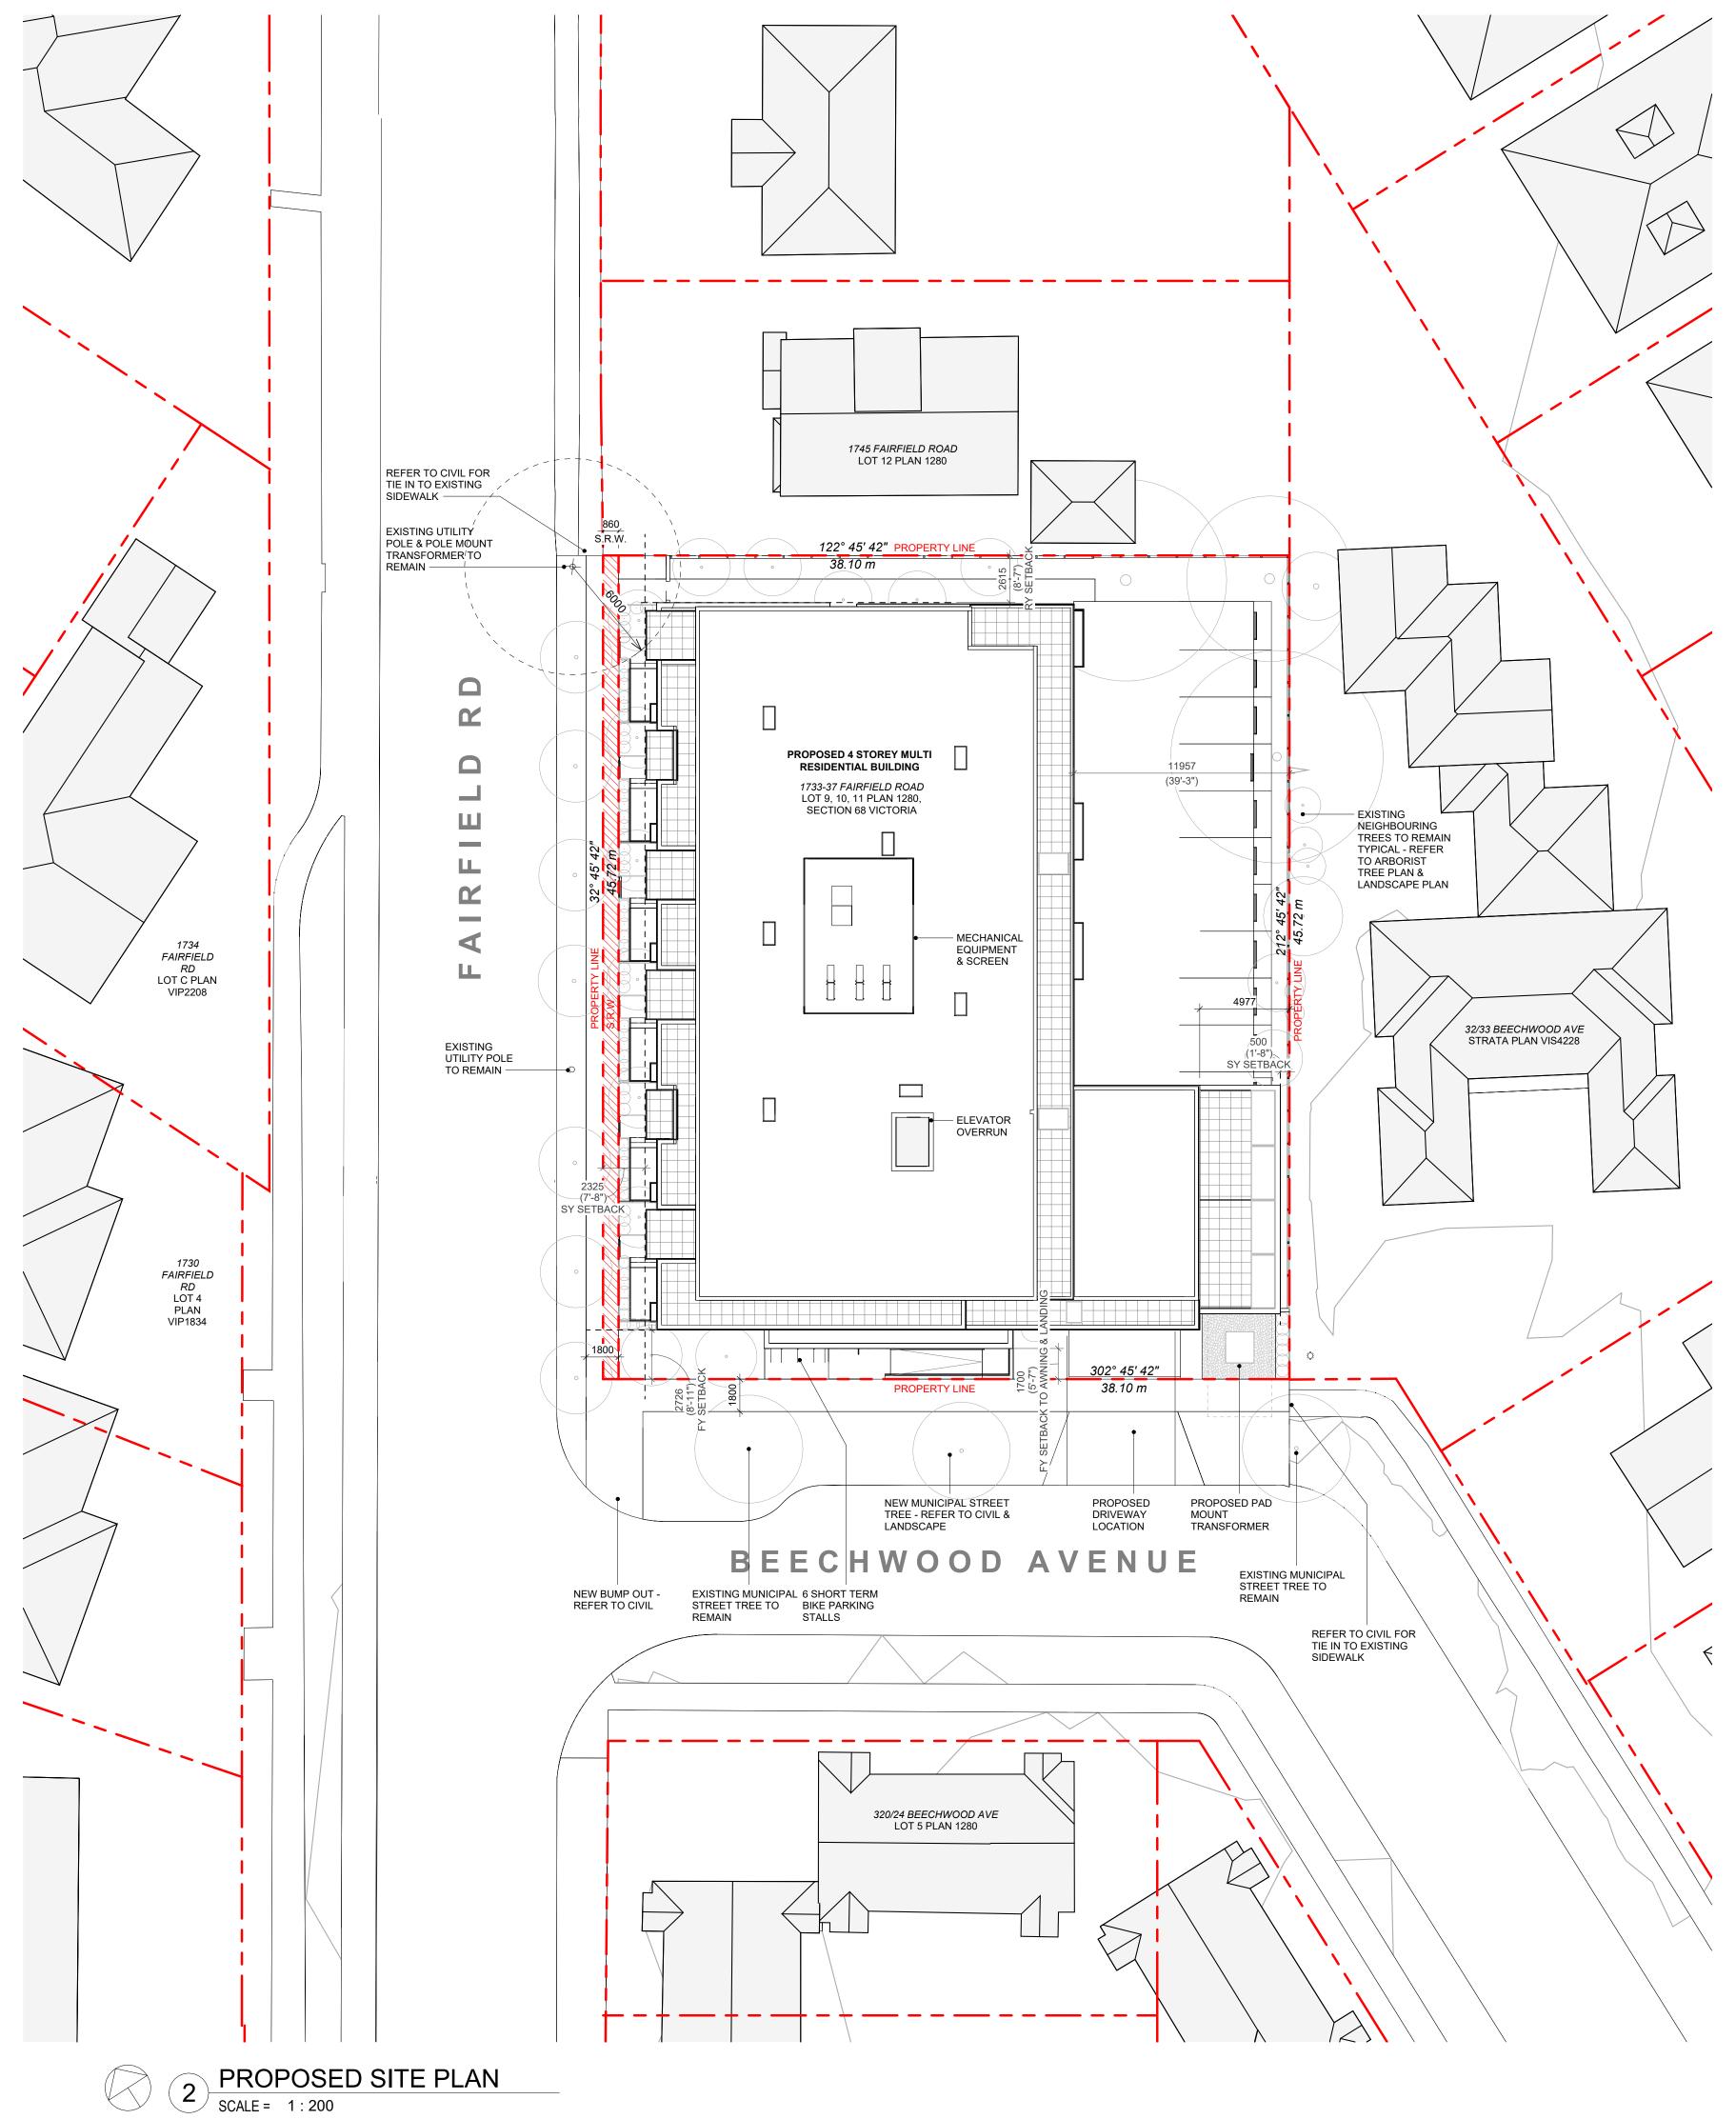

DATA

MUNICIPALITY	CITY OF VICTORIA
MUNICIPAL ADDRESS	1733-37 FAIRFIELD ROAD, VICTORIA BC
LEGAL DESCRIPTION	LOT 9, 10, 11, PLAN 1280, SECTION 68 VICTORIA
PROJECT DESCRIPTION	4 STOREY MULTI UNIT RESIDENTIAL BUILDING

PROJECT INFORMATION

ZONE (EXISTING)	R1-G	
PROPOSED ZONE	UNKNOWN	
SITE AREA (m²)	1,741.93m²	
TOTAL FLOOR AREA (m²)	3113.67m ²	
COMMERCIAL FLOOR AREA (m²)	0	
FLOOR SPACE RATIO	1.79:1	
SITE COVERAGE (%)	65%	
OPEN SITE SPACE (%)	23%	
HEIGHT (m)	13.39m	
NUMBER OF STOREYS	4	
	REQUIRED	PROVIDED
PARKING STALLS (#) TOTAL ON SITE		23 (+1sml)
PARKING STALLS - VISITOR (#) ON SITE	3	2
BICYCLE PARKING (#) SHORT TERM	6	6
BICYCLE PARKING (#) LONG TERM	37	51

BUILDING SETBACKS (m)

PROPOSED 2.73m
2.73m
1.70m
0.50m
4.78m
2.33m
2.62m
2.83m

RESIDENTIAL USE DETAILS

TOTAL NUMBER OF UNITS	29
UNIT TYPE	TOWNHOMES (6), 1 BEDS (10), 2 BEDS (13),
GROUND-ORIENTATED UNITS	6
MINIMUM UNIT FLOOR AREA (m²)	51m²

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5	DP/RZ Rev3	Aug 10, 2023
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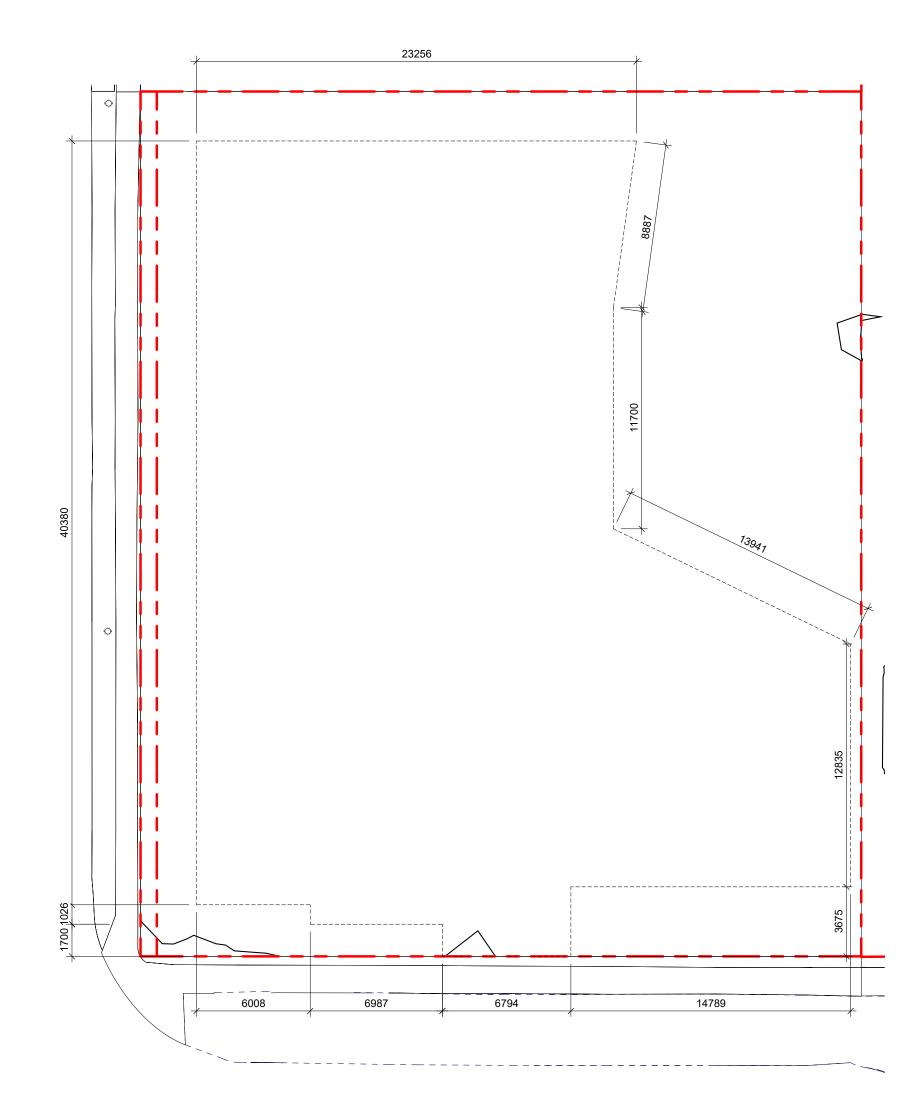
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1733-1737 Fairfield Rd

SITE PLAN & PROJECT DATA

JUNE 25, 2024 As indicated

Feb 21, 2024



1 DISTANCE BTWN POINTS KEY PLAN
SCALE = 1:200


POINT NAME	NATURAL	PROPOSED	DISTANCE BE	TWEEN POINTS	AVE. OF POINTS
Α	14.209	14.42	Point A & B	6.008	85.20
В	14.332	14.15	Point B & C	1.026	14.50
С	14.208	14.12	Point C & D	7.381	103.92
D	14.04	14.11	Point D & E	1.7	23.83
Е	13.997	14.10	Point E & F	6.4	89.96
F	14.75	14.11	Point F & G	3.63	51.72
G	14.38	14.44	Point G & H	13.35	191.33
Н	14.346	14.28	Point H & I	12.88	183.90
I	14.273	14.41	Point I & J	12.663	181.52
J	14.397	14.69	Point J & K	11.7	167.72
K	14.273	14.64	Point K & L	8.887	126.40
L	14.172	14.62	Point L & M	23.256	332.30
M	14.406	14.64	Point M & N	40.38	577.74

2130.03 **Total** 149.26 **Average Grade** 14.27 *NOTE: Lowest grade point governs per Schedule A definition


> <u>--</u> 543.81 m² - 5853.56 ft² __<u>L1 AREA 2</u> — 21.29 m² 229.19 ft² 6 L1 FLOOR AREA SCALE = 1:500

M 14406 L 14172 K 14273 I 14272 H 14245


2 NATURAL GRADE KEY PLAN
SCALE = 1:200

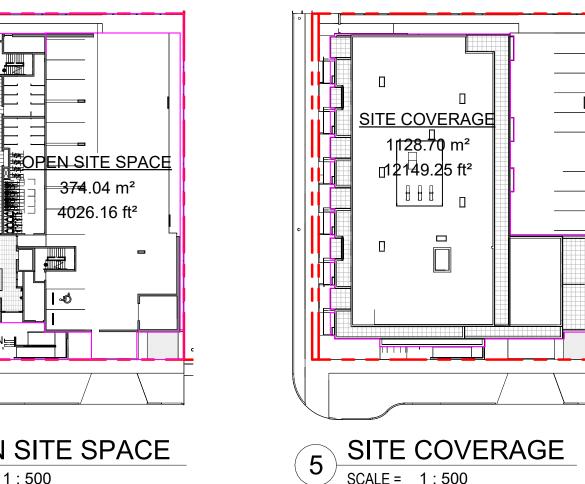


OPEN SITE SPACE SCALE = 1:500

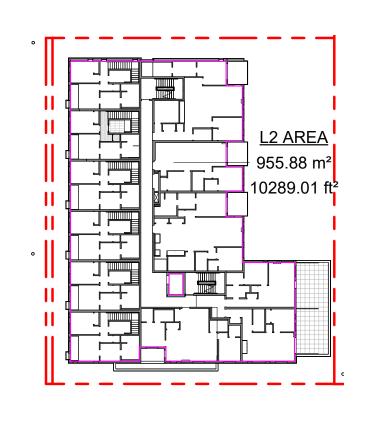

7 L2 FLOOR AREA SCALE = 1:500

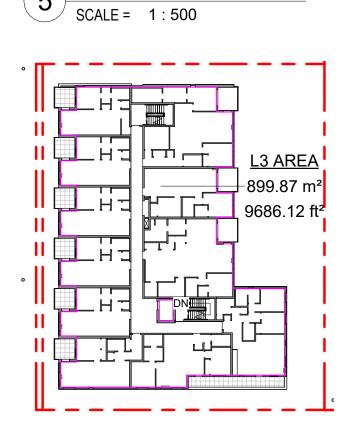

8 L3 FLOOR AREA
SCALE = 1:500

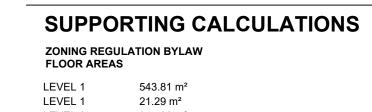

PROPOSED GRADE KEY PLAN

SCALE = 1:200


M 14511

LEVEL 2 955.88 m² LEVEL 3 899.87 m² LEVEL 4 692.82 m² Grand total: 5 FLOOR SPACE RATIO $3113.67m^2 / 1741.93m^2 = 1.787$ FSR - 1.79:1

SITE COVERAGE 1128.70m² / 1741.93m² = 0.65 (65%) **OPEN SITE SPACE** $395.01m^2 / 1741.93m^2 = 0.23 (23\%)$ HEIGHT OF PATIOS, STAIRS, & RAMP TO EXISTING & PROPOSED GRADE REFER TO GRADE KEY PLANS

1TH PATIO (WORST CASE GRADING ALONG FAIRFIELD RD - THEREFORE ALL <600mm) 14750 - 14200*(PROPOSED)* = 550mm 14750 - 14171*(EXISTING)* = 579mm

LDG (LANDING AT PRIMARY ENTRANCE) 14750 - 14114*(PROPOSED)* = 636mm 14750 - 14040 *(EXISTING)* = 710mm RMP (INTERMEDIARY RAMP LANDING) 14507 - 14114*(PROPOSED)* = 393mm 14507 - 14280 *(EXISTING)* = 227mm

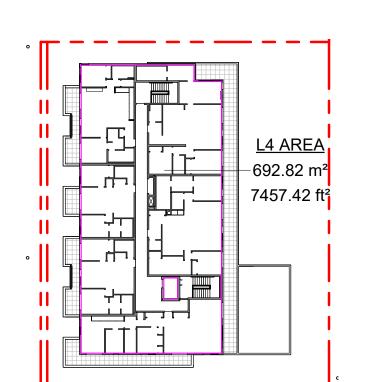

9 L4 FLOOR AREA

NO.	DESCRIPTION	DATE
1	Development Tracker Application	March 7, 2022
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ZONING CALCULATIONS

JUNE 25, 2024 As indicated



Feb 21, 2024

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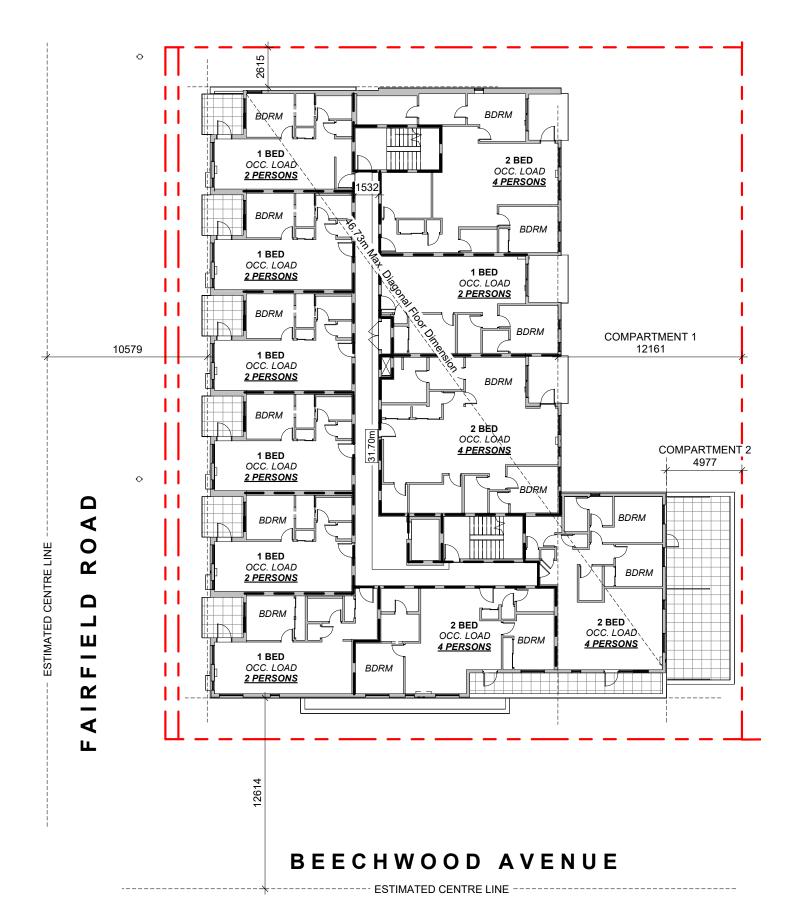
OCCUPANT LOAD: Occupancy: Group C
12 Bedrooms x 2 persons/bedroom

= 24 persons

MINIMUM EXIT WIDTH:

Ramps, Corridors, Passageways
the greater of 6.1mm x 24 = 146.4mm
or 1100mm (minimum 1500mm for or 1100mm accessible path of travel)


1 L1 CODE REVIEW KEY PLAN
SCALE = 1:250



OCCUPANT LOAD: MINIMUM EXIT WIDTH: Occupancy: Group C 15 Bedrooms x 2 persons/bedroom = 30 persons

Ramps, Corridors, Passageways
the greater of 6.1mm x 30 = 183mm
the greater of 8mm x 30 = 240mm or 1100mm (minimum 1500mm for or 1100mm accessible path of travel)

3 L3 CODE REVIEW KEY PLAN
SCALE = 1:250

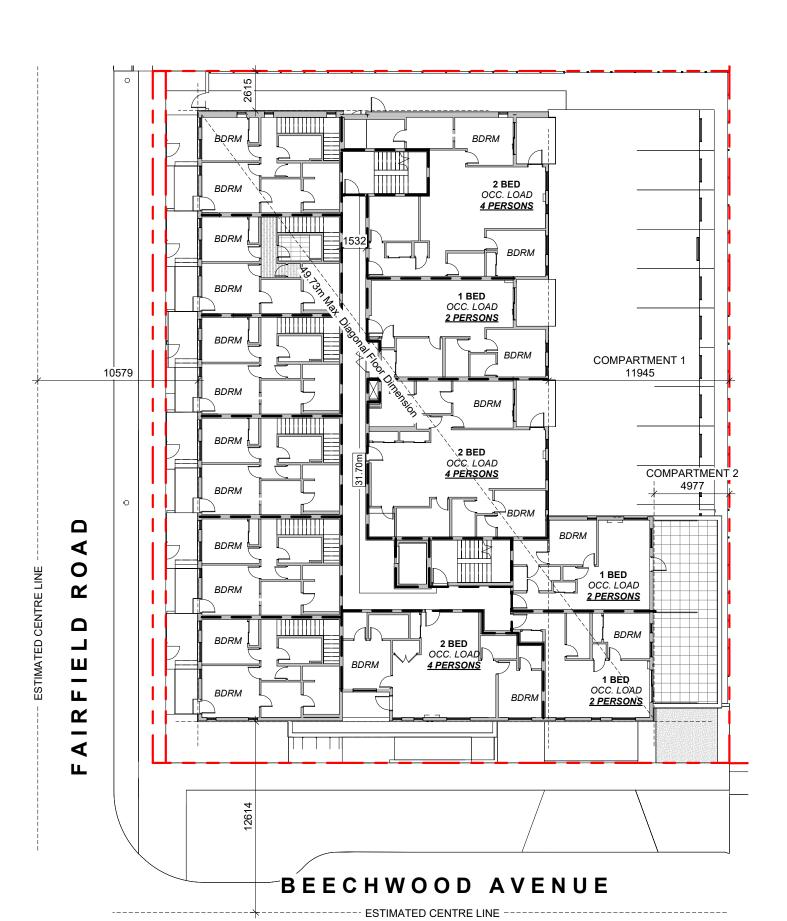


OCCUPANT LOAD: Occupancy: Group C 9 Bedrooms x 2 persons/bedroom = 18 persons

MINIMUM EXIT WIDTH:

accessible path of travel)

Ramps, Corridors, Passageways
the greater of 6.1mm x 18 = 109.8mm
the greater of 8mm x 18 = 144.0mm or 1100mm (minimum 1500mm for or 1100mm

L2 CODE REVIEW KEY PLAN

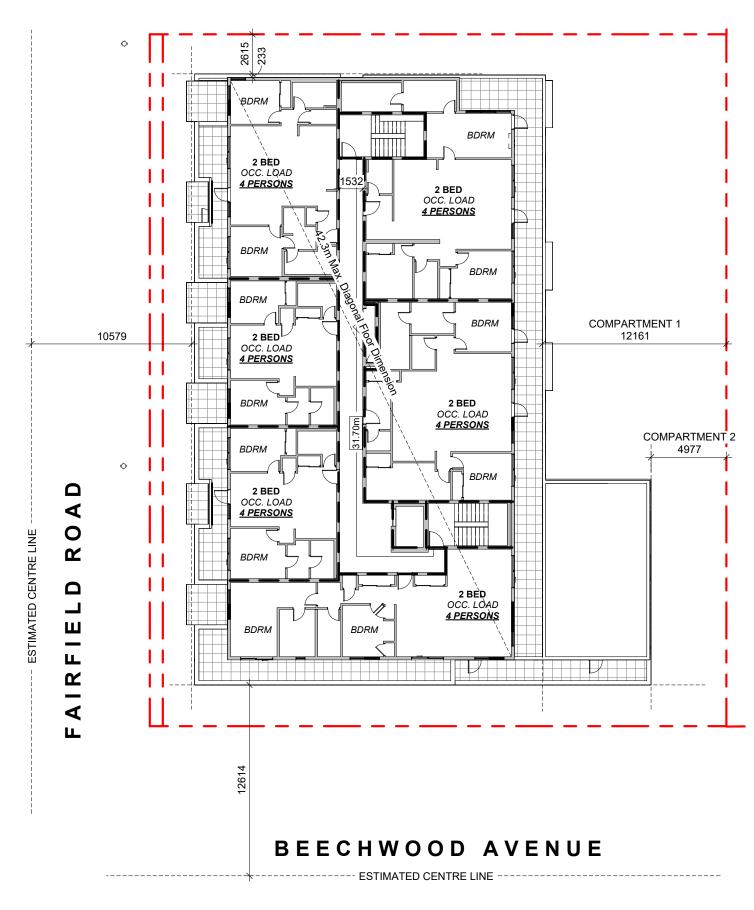

OCCUPANT LOAD: MINIMUM EXIT WIDTH: Occupancy: Group C 12 Bedrooms x 2 persons/bedroom

Ramps, Corridors, Passageways
the greater of 6.1mm x 24 = 146.4mm
the greater of 8mm x 24 = 184mm or 1100mm (minimum 1500mm for accessible path of travel)

L4 CODE REVIEW KEY PLAN SCALE = 1:250

BUILDING CODE ANALYSIS

PROJECT TYPE	NEW CONSTRUCTION RENOVATION ADDITIO	N
GOVERNING BUILDING CODE	2018 BC BUILDING CODE	
MAJOR OCCUPANCY	A1 A2 A3 A4 B1 B2 B3 C D E F1 F2 F3	3.1.2.1
BUILDING AREA	1,004 m² (approx)	1.4.1.2
GRADE	18.75 m geodetic	1.4.1.2
BUILDING HEIGHT (STOREYS)	4 STOREYS ABOVE GRADE 0 STOREYS BELOW GRADE	1.4.1.2

BUILDING FIRE SAFETY & CONSTRUCTION CLASSIFICATION

CLASSIFICATION	GROUP C, UP TO 4 STOREYS, SPRINKLERED	3.2.2.51
MAXIMUM BUILDING AREA	1800 m ²	3.2.2.51
No. OF STREETS FACING	1 (BEECHWOOD AVE UNDER 9M MINIMUM STREET WIDTH)	3.2.2.10
CONSTRUCTION TYPES PERMITTED	✓ COMBUSTIBLE NON-COMBUSTIBLE	3.2.2.51
FIRE ALARM SYSTEM	YES NO	3.2.4.1
STANDPIPE SYSTEM	YES NO	3.2.5.8
HIGH BUILDING	YES NO	3.2.6.1
INTERCONNECTED FLOOR SPACE	YES NO EXCEPT WITHIN AT GRADE RESIDENTIAL UNITS	3.2.8


FIRE RESISTANCE RATINGS

HORIZONTAL SEPARATIONS	1 hr FLOORS 1 hr MEZZANINE Unrated ROOF	3.2.2.51
LOADBEARING WALLS, COLUMNS & ARCHES	1 hr (NOT LESS THAN THAT REQUIRED FOR SUPPORTED STRUCTURE)	3.2.2.51
EXITS	1 hr	3.4.4.1

EXITS FROM FLOOR AREAS

NUMBER OF EXITS REQUIRED	2	3.4.2.1
SEPARATION OF EXITS (MIN.)	1/2 MAX. DIAGONAL FLOOR AREA, BUT NEED NOT BE > 9 m	3.4.2.3
MAX. TRAVEL DISTANCE ALLOWED	m, GROUP C	3.4.2.5
MEZZANINE	YES NO	3.2.8

FIRE RESISTANCE RATING - KEY - - - - - - UNRATED FIRE SEPARATIONS 1.5 HOUR _.... 2 HOUR

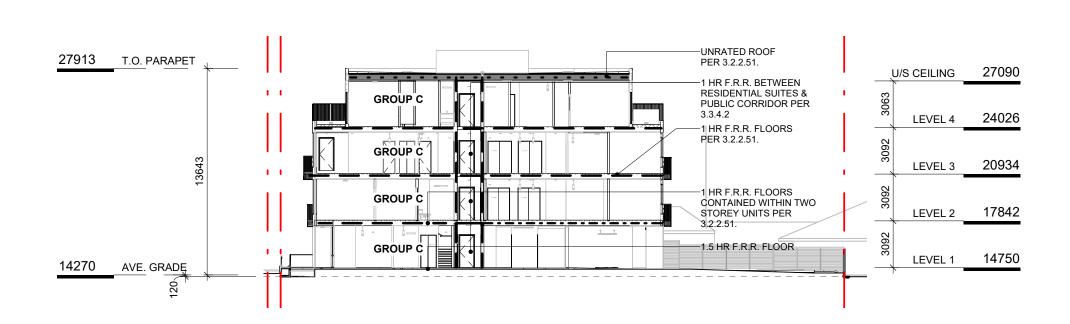

5 CODE REVIEW KEY SECTION

SCALE = 1:250

Jan 26, 2023 April 29, 2022 DP/RZ Rev2 DP/RZ Submission NO. DESCRIPTION DATE



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CODE REVIEW

As indicated




Jan 26, 2023

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JUNE 25, 2024

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1 NW ELEVATION - LD KEY SCALE = 1:200



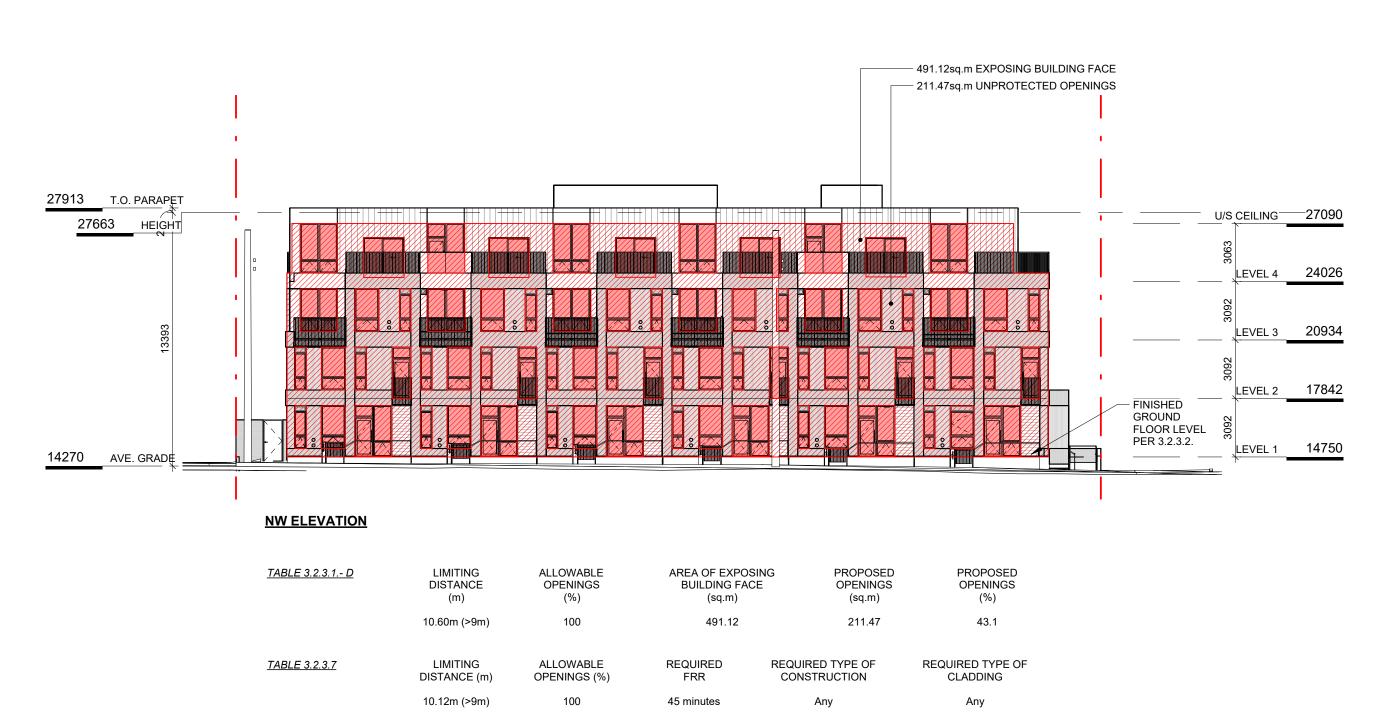


TABLE 3.2.3.1 D COMPARTMENT 1	LIMITING DISTANCE (m) 11.95m (>9m)	ALLOWABLE OPENINGS (%) 100	AREA OF EXPOSING BUILDING FACE (sq.m) 407.75	G PROPOSED OPENINGS (sq.m) 117.42	PROPOSED OPENINGS (%) 28.8
TABLE 3.2.3.7 COMPARTMENT 1	OCCUPANCY CLASSIFICATION GROUP C	ALLOWABLE OPENINGS (%) 50 - 100	REQUIRED FRR 45 minutes	REQUIRED TYPE OF CONSTRUCTION Any	REQUIRED TYPE OF CLADDING Any
TABLE 3.2.3.1 D COMPARTMENT 2	LIMITING DISTANCE (m) 4.98m (>4m)	ALLOWABLE OPENINGS (%) 56	AREA OF EXPOSING BUILDING FACE (sq.m) 85.00	G PROPOSED OPENINGS (sq.m) 23.27	PROPOSED OPENINGS (%) 27.4
TABLE 3.2.3.7 COMPARTMENT 2	OCCUPANCY CLASSIFICATION GROUP C	ALLOWABLE OPENINGS (%) 50 - 100	REQUIRED FRR 45 minutes	REQUIRED TYPE OF CONSTRUCTION Any	REQUIRED TYPE OF CLADDING Any

SE ELEVATION - LD KEY SCALE = 1:200



2 NE ELEVATION - LD KEY SCALE = 1:200

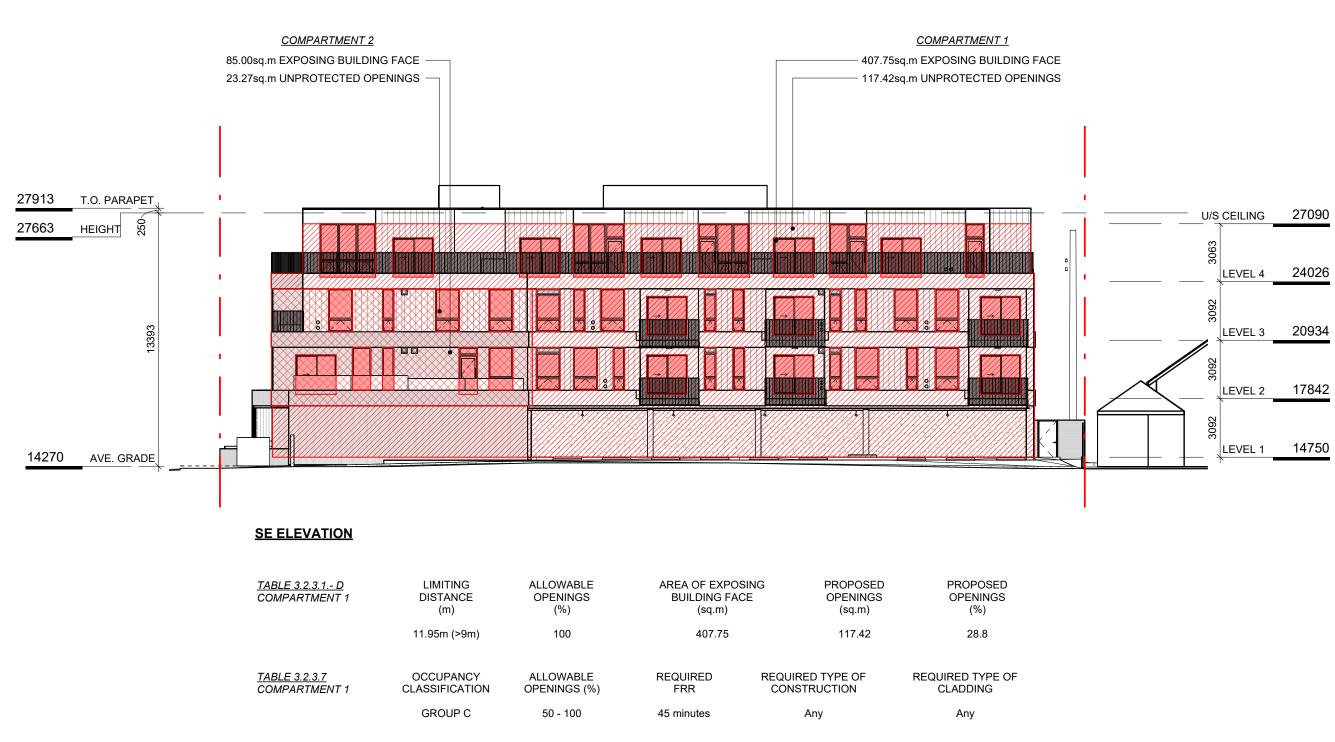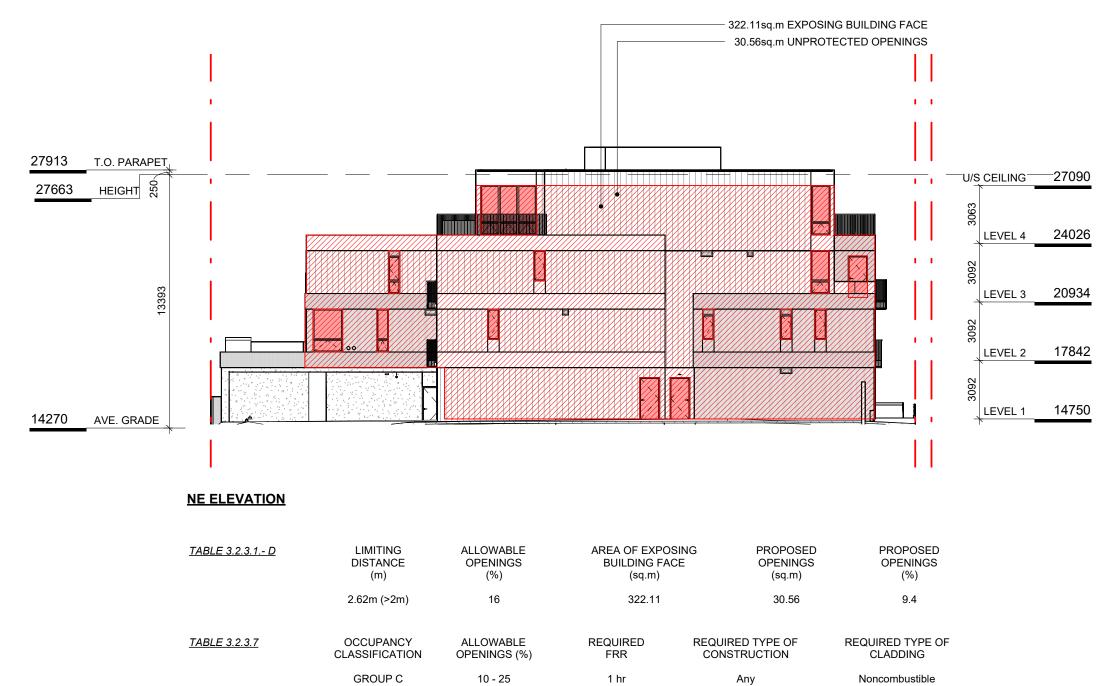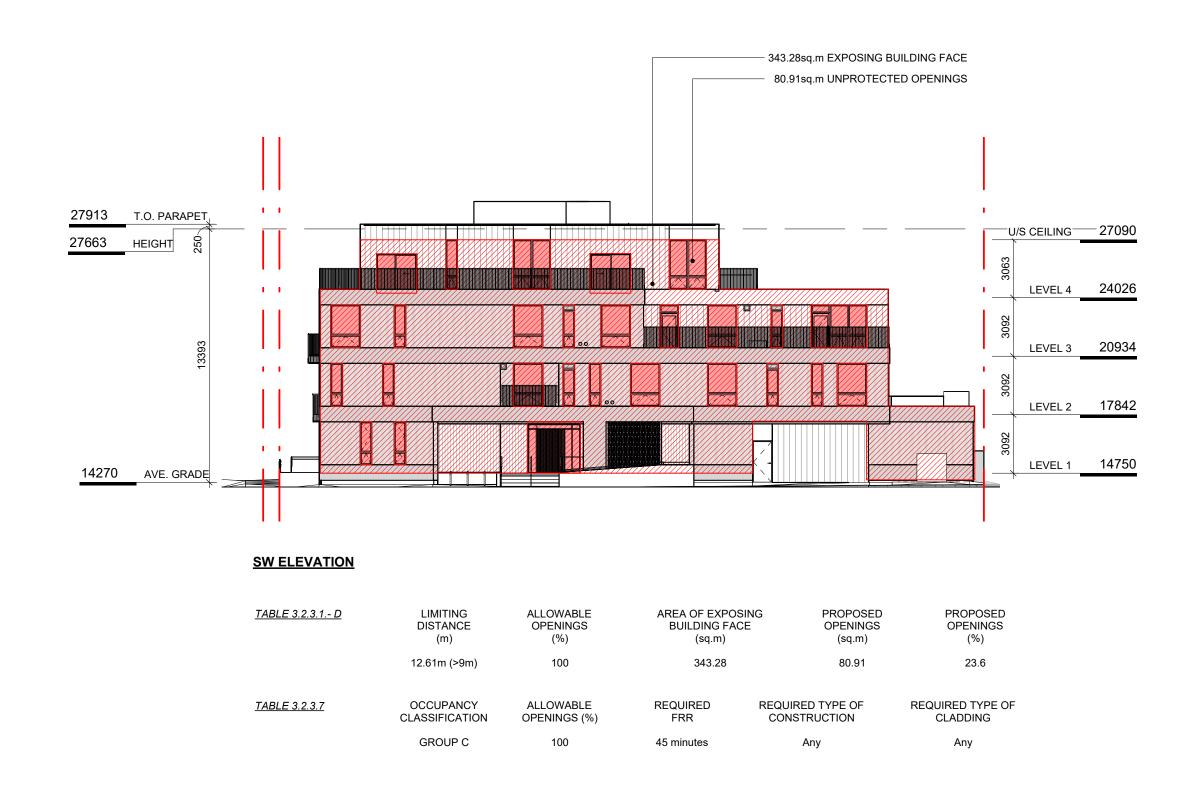


3 SCALE = 1:200



DP/RZ Rev2 DP/RZ Rev1

DP/RZ Submission



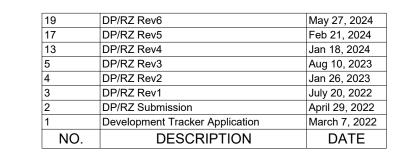



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1733-1737 Fairfield Rd

LEVEL 1 PROPOSED

PLAN

JUNE 25, 2024

1:100



Revision

May 27, 2024


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DP/RZ Rev6 DP/RZ Rev4

DP/RZ Rev3



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1733-1737 Fairfield Rd

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JUNE 25, 2024
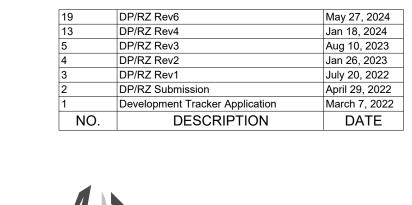
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LEVEL 2 PROPOSED PLAN

1:100


2123 May 27, 2024 A-102

1 L2 PROPOSED PLAN
SCALE = 1:100







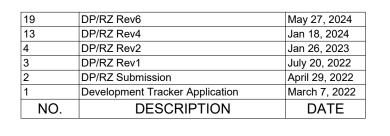



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LEVEL 3 PROPOSED PLAN

JUNE 25, 2024

1:100 Pr




May 27, 2024 /19


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2123

LEVEL 4 PROPOSED PLAN

JUNE 25, 2024

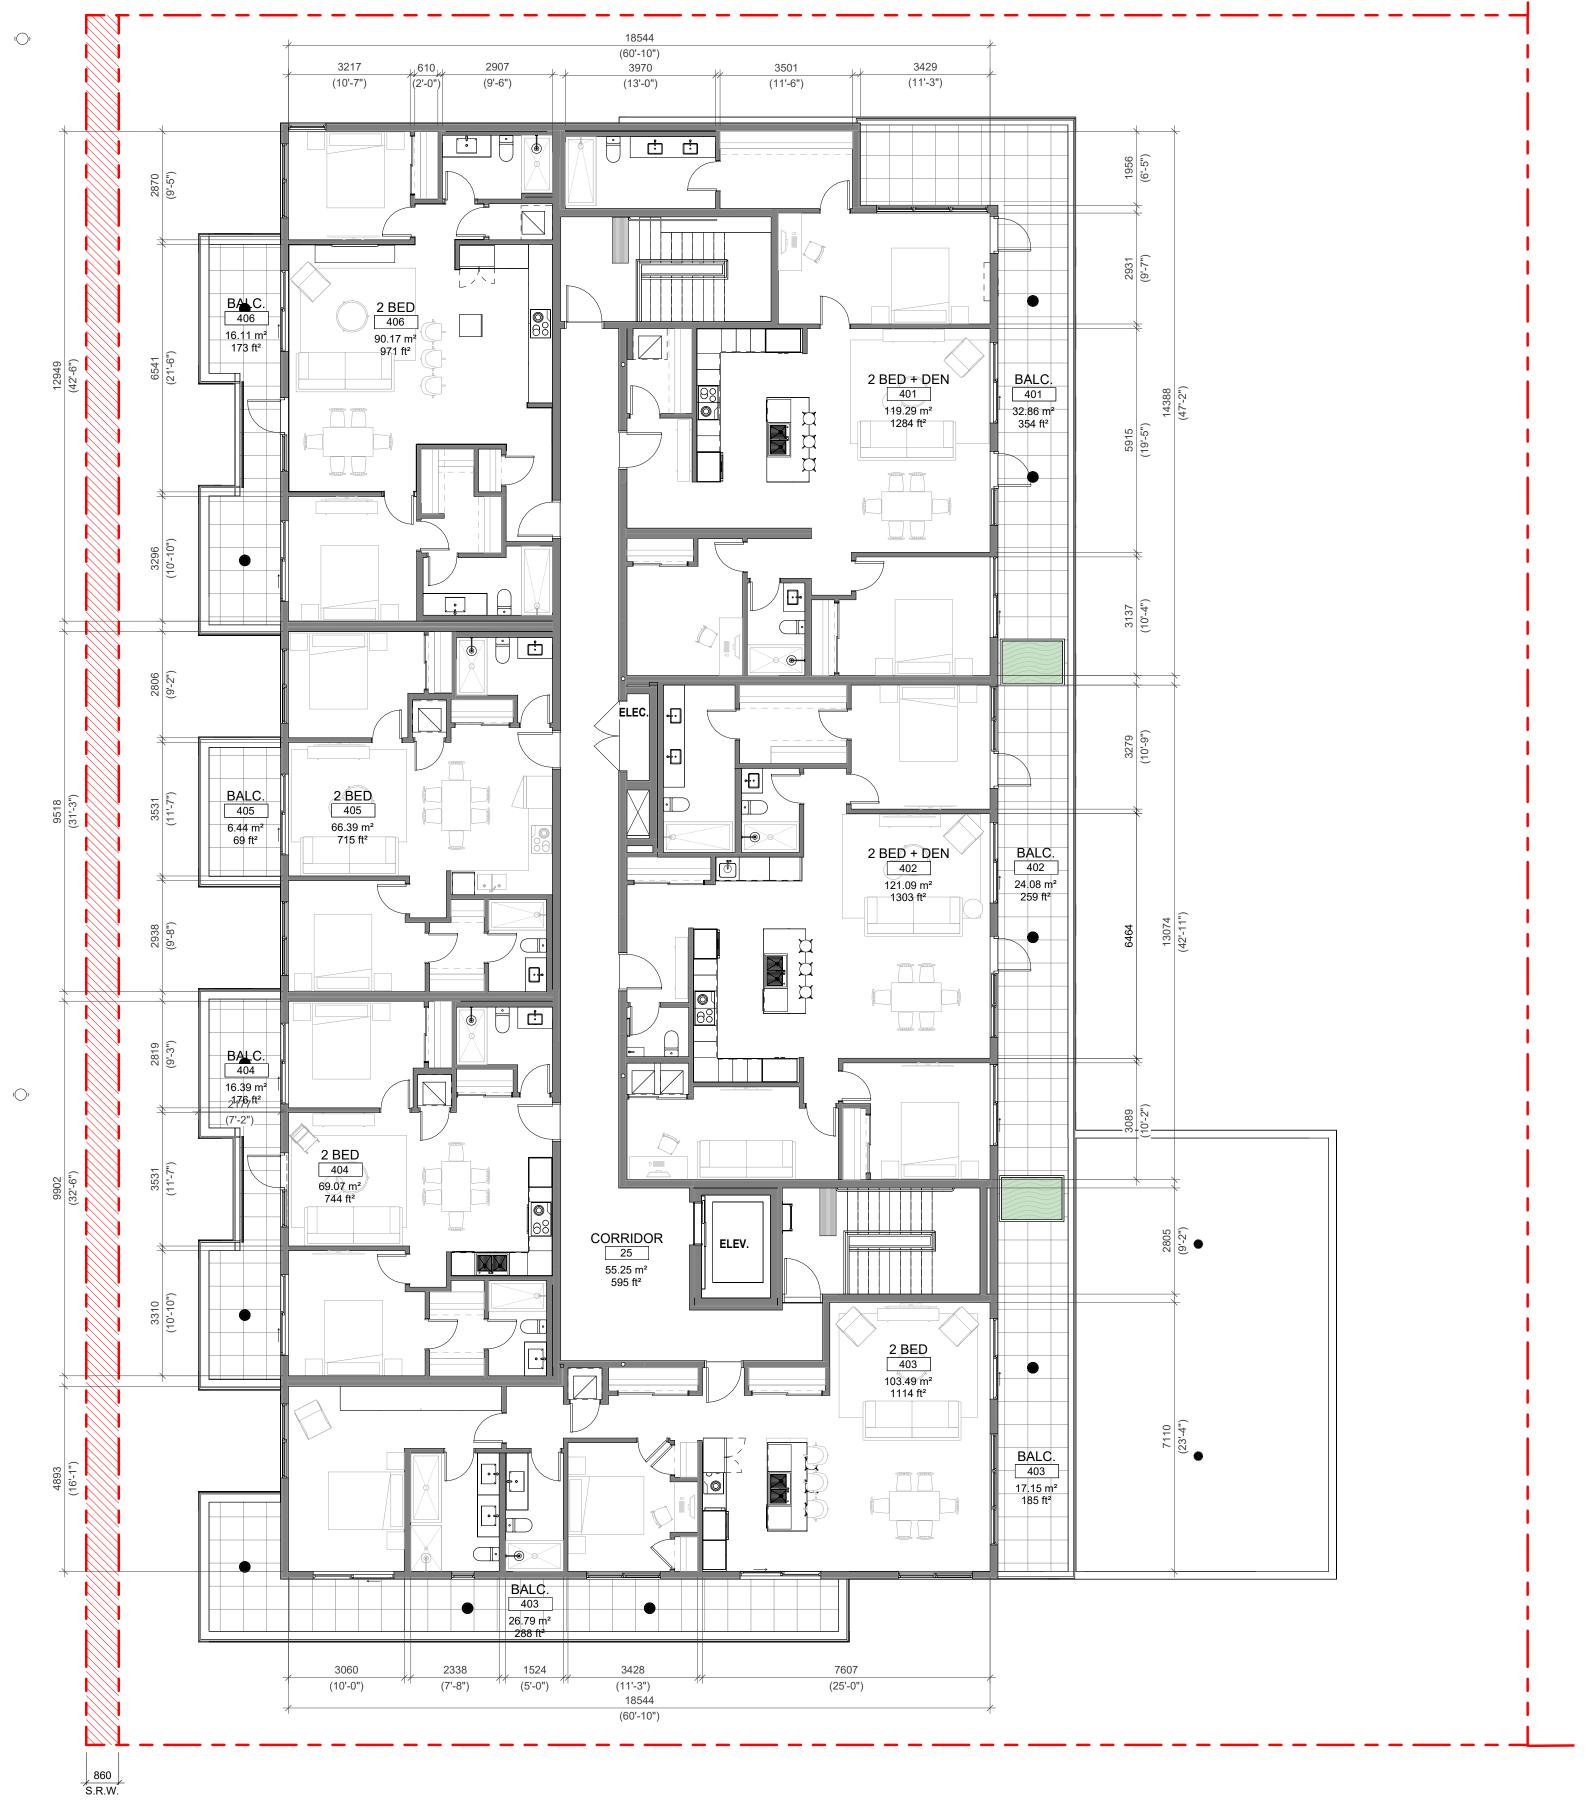1 : 100

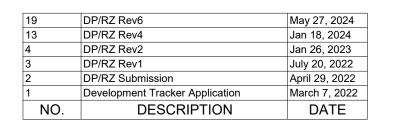

May 27, 2024 /19

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NW ELEVATION SCALE = 1:100



SW ELEVATION

SCALE = 1:100

19	DD/D7 D /C	May 07 0004
19	DP/RZ Rev6	May 27, 2024
17	DP/RZ Rev5	Feb 21, 2024
13	DP/RZ Rev4	Jan 18, 2024
5	DP/RZ Rev3	Aug 10, 2023
4	DP/RZ Rev2	Jan 26, 2023
3	DP/RZ Rev1	July 20, 2022
2	DP/RZ Submission	April 29, 2022
1	Development Tracker Application	March 7, 2022
NO.	DESCRIPTION	DATE

FINISH SCHEDULE

01. 'CERACLAD' CLADDING

LIGHT FINISH

02. PREFINISHED METAL

03. PREFINISHED METAL STANDING SEAM

04. METAL PICKET GUARD

06. WOOD GRAIN FINISH

07. HORIZONTAL WOOD FENCE

05. GLAZING

FLAT PANEL



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1733-1737 Fairfield Rd

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EXTERIOR ELEVATIONS

As indicated

May 27, 2024


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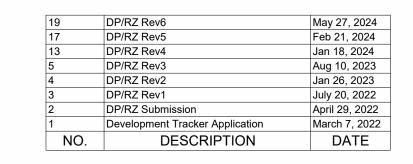
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1733-1737 Fairfield Rd

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EXTERIOR ELEVATIONS


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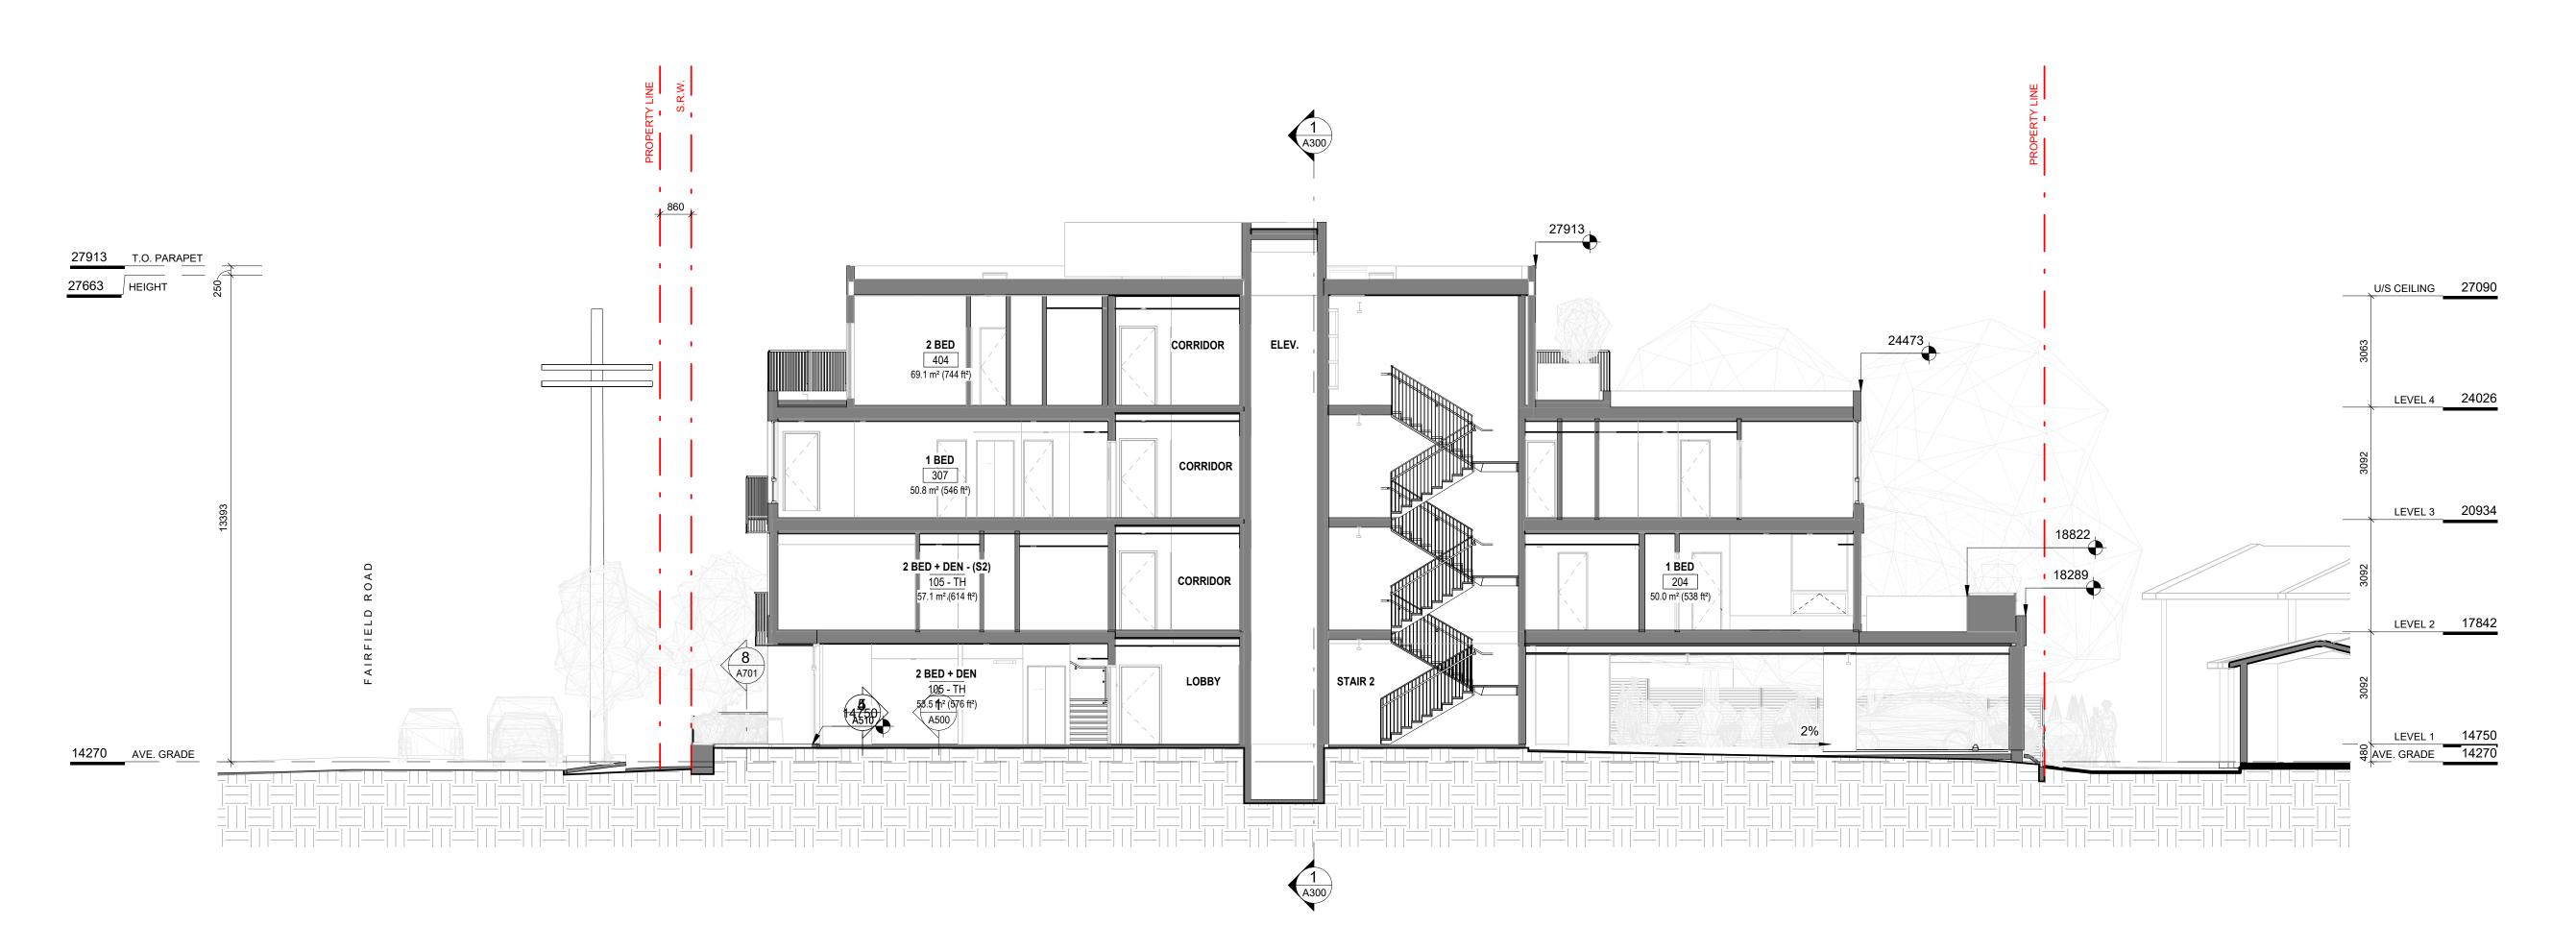
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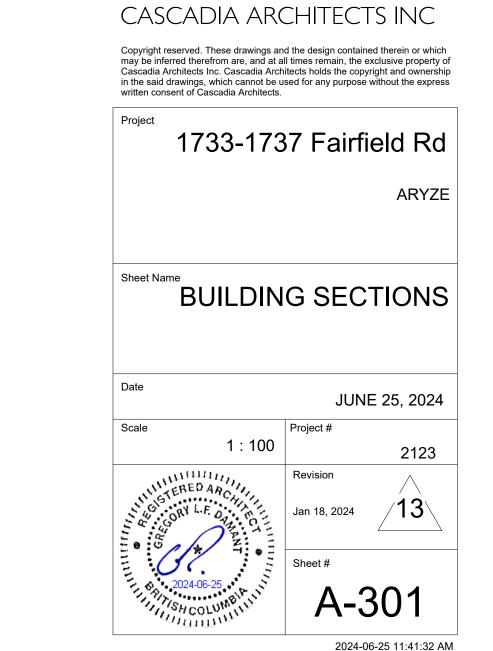
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JUNE 25, 2024

Jan 18, 2024 Jan 26, 2023 July 20, 2022 April 29, 2022 March 7, 2022 DATE



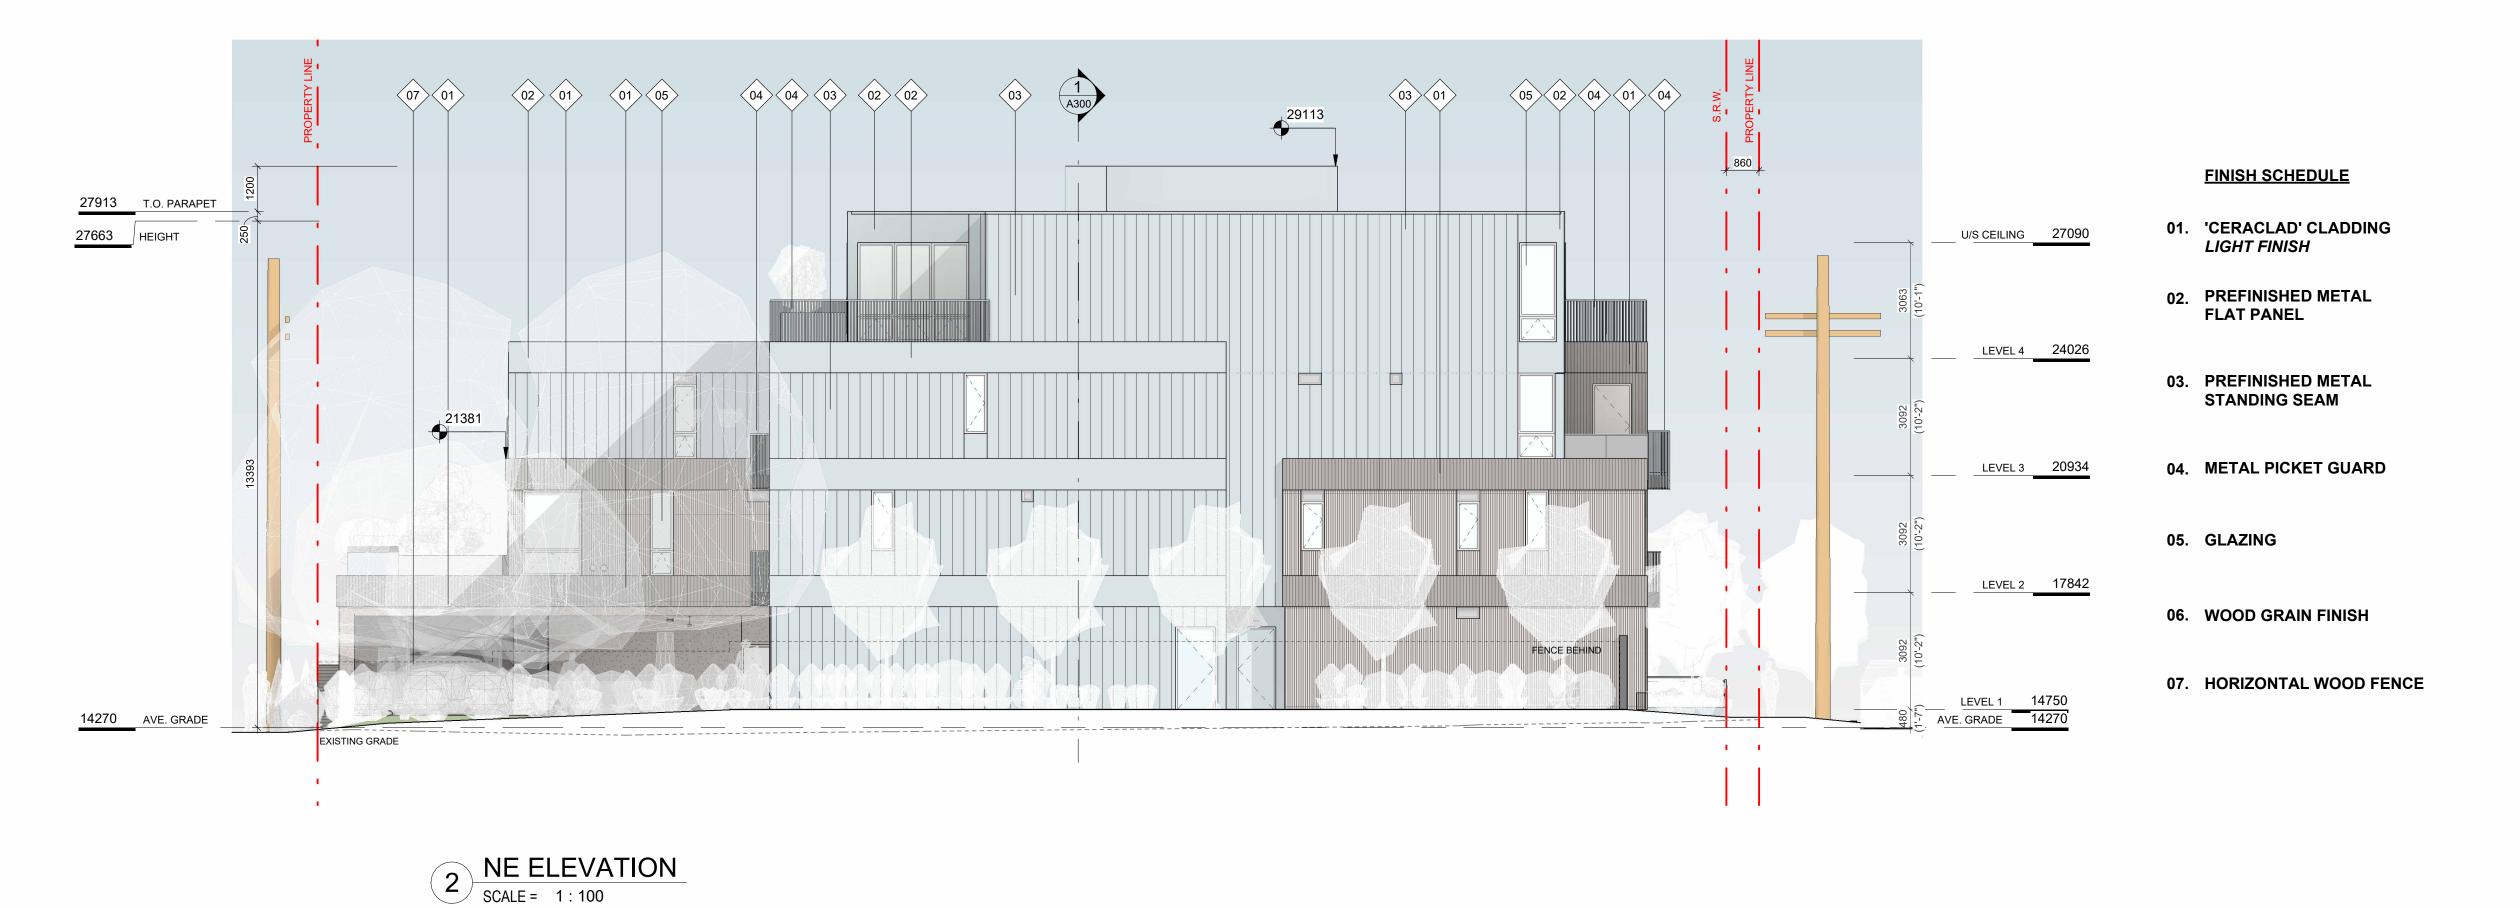

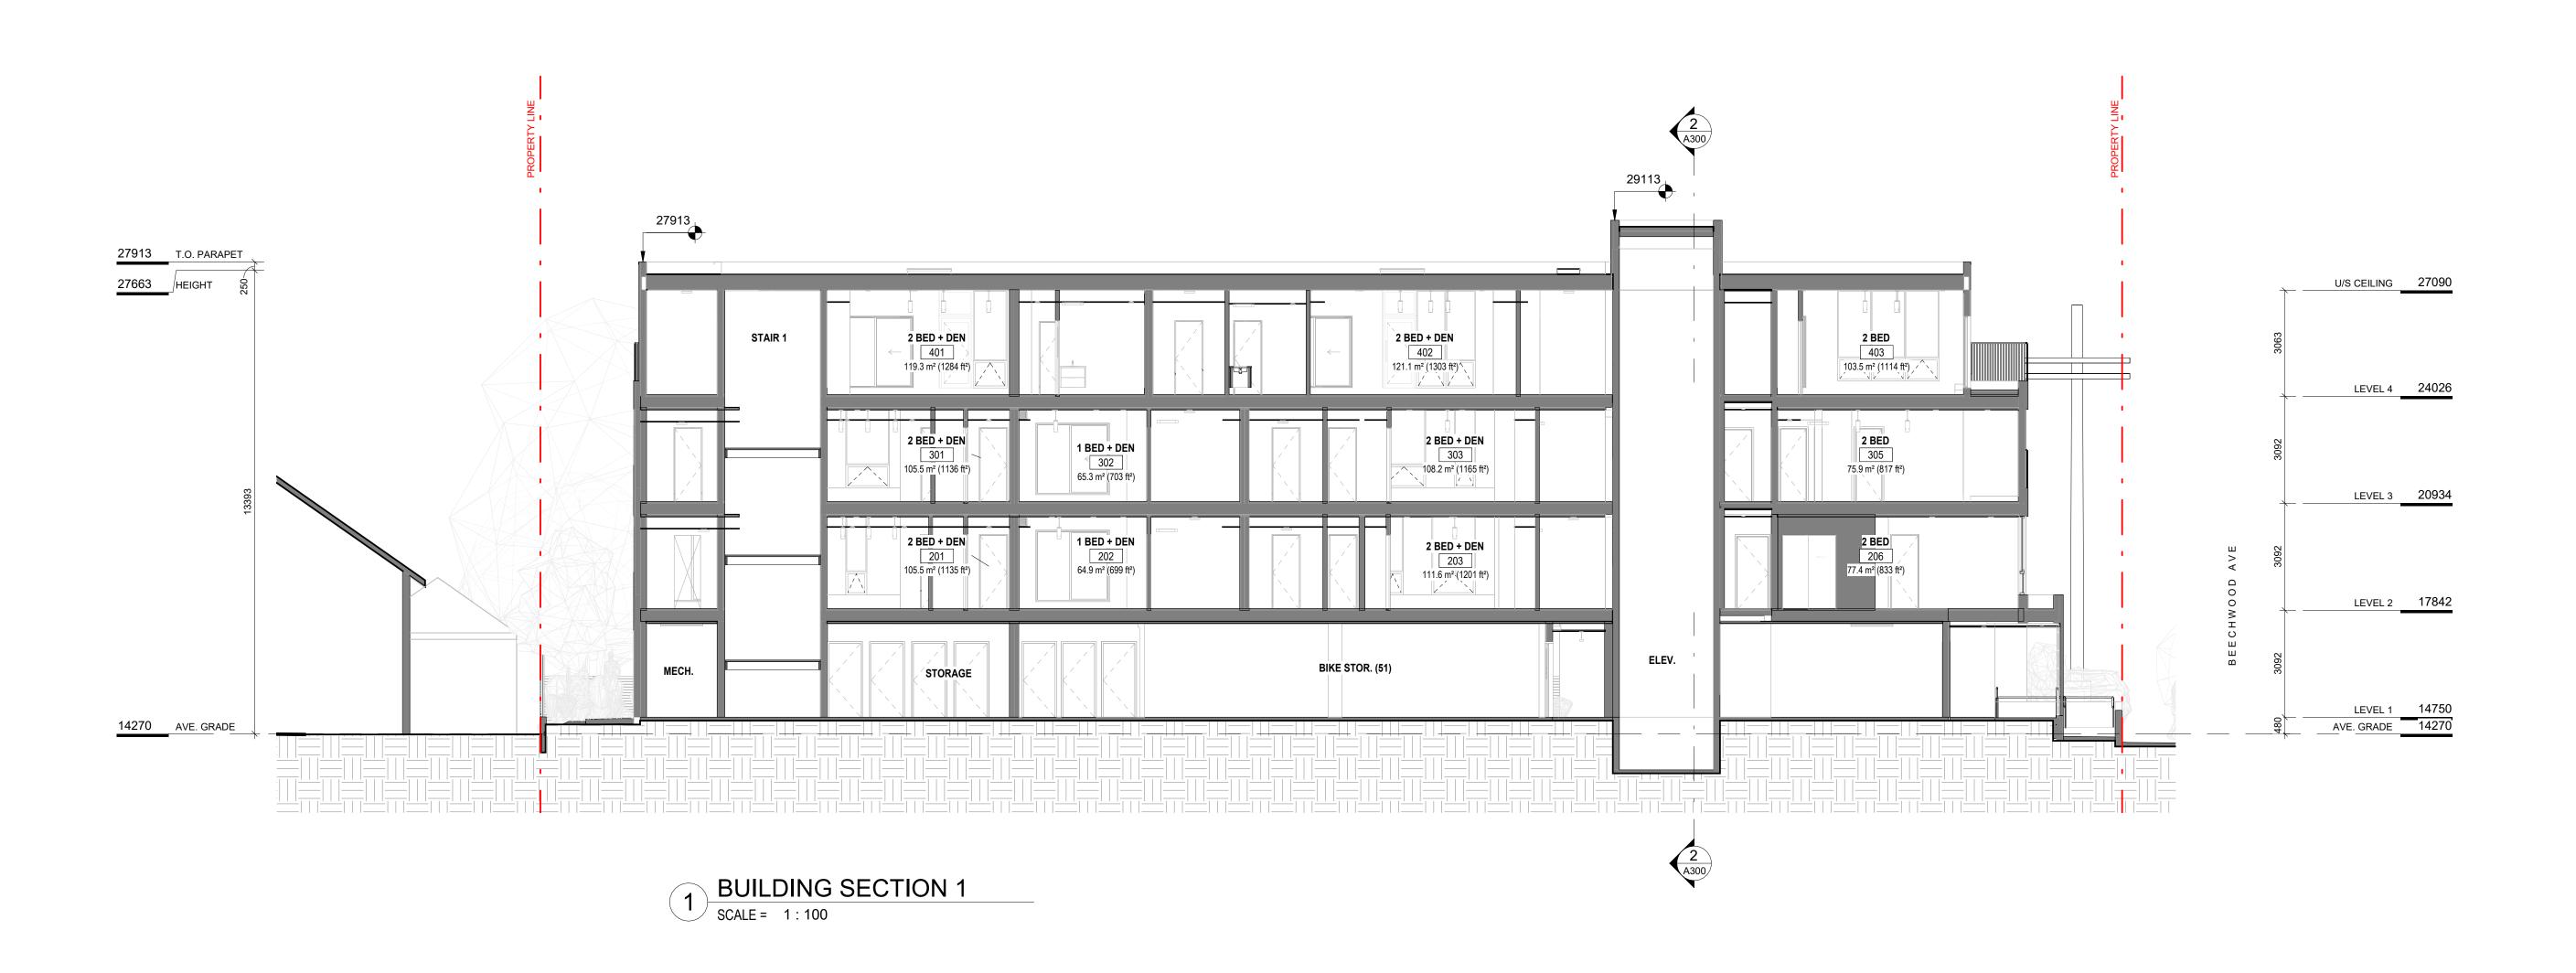


DP/RZ Rev2 DP/RZ Rev1 DP/RZ Submission

NO.

Development Tracker Application

DESCRIPTION

2 BUILDING SECTION 2
SCALE = 1:100

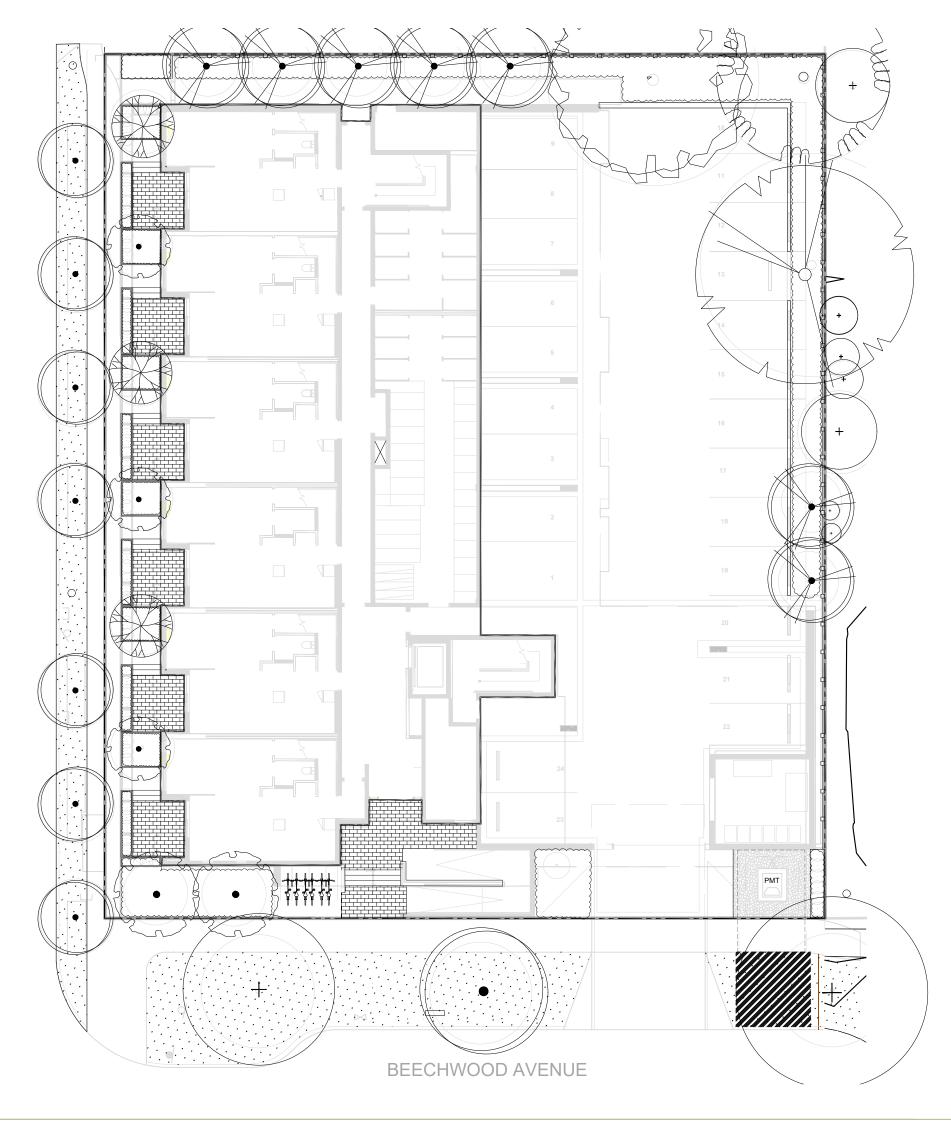

MATERIAL SPECIFICATIONS

- GROWING MEDIUM TESTING. MIXING. HANDLING AND PLACEMENT TO CLS SECTION 6.
- 2. ON SITE GROWING MEDIUM TYPE TO BE: AS PER DRAWING LEGEND. 3. PLANTER GROWING MEDIUM TO BE:
 - 50% BY VOLUME 1H HIGH TRAFFIC LAWN GROWING MEDIUM 50% BY VOLUME Pro-Mix HP Mychorrizae OR APPROVED EQUAL

- OFF-SITE GROWING MEDIUM: BOULEVARD GROWING MEDIUM TO BE:
 - MMCD Planting Areas Growing Medium to City of Victoria Supplementary Specifications Schedule 'B', Table 2. AS PER MUNICIPAL STANDARD.
 - IF NO MUNICIPAL STANDARD, GROWING MEDIUM TO CLS SECTION 6 2L LOW TRAFFIC LAWN AREAS.

MULCH: 1. MULCH IN ALL OTHER AREAS TO BE: Mitchell Excavating Ltd. Fine Bark Mulch - fir/hemlock OR APPROVED EQUAL. 2. HANDLING AND PLACEMENT TO CLS Section 10 - Mulching/Mulch

- 1. MUNICIPAL SOD TO BE: No. 1 Premium Grade Nursery Turfgrass.
- 2. HANDLING AND PLACEMENT TO BCLS Section 8 Turfgrass Sod. 3. SHALL BE SUITED TO THE LOCALITY, SITE CONDITIONS AND INTENDED FUNCTION OF THE PROJECT AREA.

1. ROOT BARRIER TO BE: Deeproot 18" Universal Guide OR APPROVED EQUAL.

1. FILTER FABRIC TO BE: Soprema Soprafiltre non-woven geotextile OR APPROVED EQUAL. 2. INSTALL AS PER MANUFACTURER'S SPECIFICATIONS AND LANDSCAPE DETAILS.

AGGREGATE:

- 1. PLANTER DRAIN ROCK TO BE: 19 mm MINUS GRANULAR BASE (TO MMCD SPECIFICATION)
- 2. GREEN ROOF DRAIN ROCK TO BE: 6 mm WASHED DRAIN ROCK

- 1. ALL PRODUCTS AND WORKMANSHIP, INCLUDING: PLANT MATERIAL, TRANSPORTATION, HANDLING AND PROTECTION. SCHEDULING AND STORAGE, WATERING AND IRRIGATION, TIME OF PLANTING, PLANTING, CONDITIONS FOR ACCEPTANCE AND INSECTS PESTS AND DISEASE CONTROL, TO BCLS SECTION 9 - PLANTS AND PLANTING, WRITTEN SPECIFICATIONS AND
- 2. CONDITIONS FOR TOTAL PERFORMANCE TO MMCD SECTION PLANTING OF TREES, SHRUBS AND GROUNDCOVERS. 3. IN THE EVENT OF A DISCREPANCY BETWEEN QUANTITIES LISTED ON THE PLANTING PLAN AND IN THE PLANT LIST. THE PLANTING PLAN QUANTITIES TO TAKE PRECEDENCE.

CAST IN PLACE CONCRETE:

1. ALL CAST IN PLACE CONCRETE AND ASSOCIATED WORK AND MATERIALS TO CONFORM TO MMCD SPECIFICATIONS; ASSOCIATED WORK INCLUDES GRADING, SUBGRADE COMPACTION, GRANULAR BASE MATERIALS AND COMPACTION.

IRRIGATION - DESIGN BUILD

IRRIGATION:


- 1. IT IS THE INTENTION OF THE PROJECT THAT THE LANDSCAPE CONTRACTOR FURNISH A FUNCTIONAL AUTOMATIC IRRIGATION SYSTEM TO ALL ON-SITE AND OFF SITE LANDSCAPE AREAS AS DESCRIBED ON THE LANDSCAPE DRAWINGS AND IN THIS SECTION.
- 2. THE SCOPE OF WORK INCLUDES SUPPLY AND INSTALLATION OF BACKFLOW PREVENTER, CONTROLLER, ALL IRRIGATION COMPONENTS, IRRIGATION SLEEVES YEAR MAINTENANCE/WARRANTY (SEE WRITTEN SPECIFICATIONS AND REQUIREMENTS BELOW) AND AN OPERATION MANUAL.
- 3. THE IRRIGATION CONTRACTOR SHALL COORDINATE WITH THE GENERAL CONTRACTOR AND ELECTRICAL CONTRACTOR FOR THE INSTALLATION OF IRRIGATION SLEEVES.

MAINTENANCE

- 4. UPON COMPLETION OF IRRIGATION INSTALLATION, CONTRACTOR TO SUBMIT AS-CONSTRUCTED DRAWINGS, OPERATION AND MAINTENANCE MANUAL, TOOLS PROVIDED BY THE MANUFACTURER AND BASE IRRIGATION SCHEDULE TO IIABC STANDARDS (SECTION 5 OF BCLS).
- 5. INSPECT AND CALIBRATE IRRIGATION SYSTEM AS PER SEASONAL REQUIREMENTS.
- INSPECT GROWING MEDIUM FREQUENTLYMINIMUM MONTHLY AND WEEKLY DURING PERIODS OF DROUGHT AND HIGH HEAT) FOR MOISTURE CONTENT AND ADJUST IRRIGATION SCHEDULE AS OFTEN AS REQUIRED TO MAINTAIN THE HEALTH OF THE PLANT MATERIAL DUE TO: RAPID DRAINAGE IN THE GROWING MEDIUM, ABSENCE OF A WATER TABLE, FINITE AMOUNT OF GROWING MEDIUM, AND EXPOSURE TO CLIMATIC CONDITIONS.
- 7. CONTRACTOR TO COORDINATE WITH THE OWNER'S MAINTENANCE REPRESENTATIVE AND TOGETHER PERFORM ONE WINTERIZATION AND ONE SPRING START-UP DURING THE ONE YEAR WARRANTY PERIOD.

SUBMITTALS



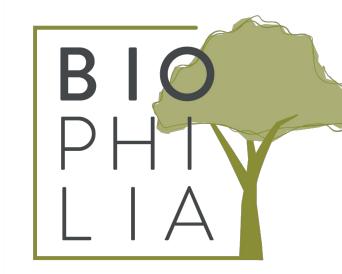

SPECIFICATION SECTION	TITLE	SHOP DRAWINGS	MOCK-UP	SUBMITTALS	FOR APPROVAL
MMCD 03 30 20	CONCRETE WALKS, CURBS AND GUTTERS				
MMCD 03 30 53	CAST IN PLACE CONCRETE				
MMCD 31 02 17	AGGREGATES AND GRANULAR MATERIALS				
MMCD 31 22 01	SITE GRADING				
MMCD 31 24 13	ROADWAY EXCAVATION, EMBANKMENT AND COMPACTION				
MMCD 32 11 23	GRANULAR BASE				
MMCD 32 14 01	UNIT PAVING		yes	yes	product cut sheets, mockup 3.0m paved area on site
CLS 4	GRADING AND DRAINAGE				
CLS 5	IRRIGATION	yes			irrigation design for approval
CLS 6	GROWING MEDIUM			yes	supplier name, growing medium test results
CLS 7	LAWNS AND GRASS (HYDRAULIC SEEDING)			yes	supplier name, product information
CLS 8	TURFGRASS SOD			yes	supplier name, product information
CLS 9	PLANTS AND PLANTING		yes	yes	nursery name, tree and shrub layout on site prior to planting
CLS 10	MULCHING			yes	
CLS 11	LANDSCAPE OVER STRUCTURES - GREEN ROOFS				
CLS 12	CONTAINER GROWN PLANTS				

1733 FAIRFIELD

1733 FAIRFIELD ROAD, VICTORIA, BC

SHEET LIST

L0.1 TREE MANAGEMENT & REMOVAL PLAN

L1.1 MATERIALS PLAN - LEVEL 1

L1.2 MATERIALS PLAN - UPPER LEVELS

L2.1 LAYOUT PLAN

L3.1 GRADING PLAN

L4.1 SOIL VOLUME PLAN

L4.2 TREE PLANTING PLAN

L4.3 PLANTING PLAN - LEVEL 1

L4.4 PLANTING PLAN - UPPER LEVELS

L5.1 LIGHTING PLAN

L6.1 IRRIGATION PLAN - LEVEL 1

L6.2 IRRIGATION PLAN - UPPER LEVELS

L7.1 PAVING DETAILS

L7.2 SITE FURNISHINGS DETAILS

L7.3 PLANTING DETAILS

GENERAL LANDSCAPE NOTES

GENERAL

1. DO NOT PROCEED IN UNCERTAINTY.

DO NOT SCALE DRAWINGS.

DRAWINGS AND SPECIFICATIONS ARE TO BE READ IN CONJUNCTION WITH ALL OTHER DRAWINGS/SPECIFICATIONS IN THIS PROJECT SET. ANY DISCREPANCIES AMONG DRAWINGS, SPECIFICATIONS AND INDUSTRY BEST PRACTICES TO BE REPORTED TO THE PROJECT / CONSTRUCTION MANAGER AND THE LANDSCAPE CONSULTANT FOR DIRECTION.

ALL LANDSCAPE SPECIFICATION SECTIONS AND DRAWINGS ARE AFFECTED BY REQUIREMENTS OF DIVISION 01 SECTIONS (PROVIDED IN THE PROJECT MANUAL).

CONTRACTOR TO CONFIRM LOCATION AND ELEVATION OF ALL UNDERGROUND UTILITIES/FEATURES PRIOR TO COMMENCING WORK CONTRACTOR TO TAKE NECESSARY PRECAUTIONS TO PROTECT SITE FEATURES / CONDITIONS, WITHIN AND BEYOND THE LIMITS OF WORK EXISTING AT THE TIME OF CONSTRUCTION. ALL DISTURBED SURFACES, AREAS, STRUCTURES, VEGETATION, HABITAT ETC. ON PUBLIC / PRIVATE PROPERTY TO PROMPTLY BE RESTORED TO EQUAL OR BETTER CONDITION THAN EXISTING

AND TO THE SATISFACTION OF THE MUNICIPALITY HAVING JURISDICTION / PROPERTY OWNER. CONTRACTOR TO MAINTAIN THE SITE IN A SAFE AND TIDY CONDITION AT ALL TIMES. DO NOT OBSTRUCT PEDESTRIAN OR VEHICULAR CIRCULATION. DO NOT LEAVE UNPROTECTED HOLES / PITS / OPENINGS OVERNIGHT. ALL EXCESS MATERIALS AND REFUSE TO BE REMOVED FROM THE SITE DAILY UNLESS OTHERWISE DIRECTED BY THE CONSTRUCTION MANAGER.

ALL WORK ON MUNICIPAL PROPERTY TO CONFORM TO THE CITY OF VICTORIBEVELOPMENT STANDARDS (AUTHORITY HAVING JURISDICTIONINCLUDING BUT NOT LIMITED TO:

1.1. CITY OF VICTORIA SUPPLEMENTARY SPECIFICATIONS SCHEDULE 'B' TO THE SUBDIVISION AND DEVELOPMENT SERVICING BYLAW NO. 12-042

1.2. CITY OF VICTORIA SUPPLEMENTAL DRAWINGS 2. CITY OF VICTORIA SUPPLEMENTARY SPECIFICATIONS FOR STREET TREES AND IRRIGATION, SCHEDULE C.ALL LANDSCAPE WORK ON THE DEVELOPMENT SITE TO CONFORM TO THE CURRENT EDITION OF THECanadian Landscape Standard (CLS), UNLESS SPECIFICALLY STATED OTHERWISE IN WRITTEN SPECIFICATIONS AND ON DRAWINGS.

ALL HARD SURFACE (INCLUDING BUT NOT LIMITED TO PAVING, CONCRETE RETAINING WALLS AND CONCRETE PLANTERS) TO CONFORM TO TWASter Municipal Construction Documents Association PLATINUM EDITION (MMCD) AND MMCD SUPPLEMENTAL DRAWINGS AND SPECIFICATIONS, UNLESS SPECIFICALLY STATED OTHERWISE IN WRITTEN SPECIFICATIONS AND ON

4. IN CASES OF CONFLICT BETWEEN THE CLS AND THE MMCD, THE MORE STRINGENT REQUIREMENT WILL TAKE PRECEDENCE.

LANDSCAPE CONTRACTOR TO BE FAMILIAR WITH MUNICIPAL DEVELOPMENT STANDARDS AND BE IN POSSESSION OF THE CLS AND MMCD MANUALS AND SUPPLEMENTAL DRAWINGS AND

6. GROWING MEDIUM AND GROWING MEDIUM TESTING TO CLS Section 6.

7. IRRIGATION DESIGN AND INSTALLATION TO IIABC STANDARDS AND CLS Section 5.

1. CONTRACTOR TO COORDINATE INSTALLATION OF IRRIGATION AND ELECTRICAL SLEEVES WITH ARCHITECTURAL, MECHANICAL, ELECTRICAL AND CIVIL WORKS.

SUBMITTALS:

1. CONTRACTOR TO PROVIDE SAMPLES, TEST RESULTS AND SHOP DRAWINGS TO LANDSCAPE CONSULTANT FOR REVIEW AND APPROVAL 45 DAYS PRIOR TO INSTALLATION. SEE ALSO SUBMITTALS TABLE BELOW FOR ADDITIONAL INFORMATION.

GROWING MEDIUM TESTING: 1. GROWING MEDIUM TEST RESULTS ARE MANDATORY.

TEST RESULTS TO INCLUDE ANALYSIS OF ALL GROWING MEDIUM NUTRIENTS NOTED IN CLS 6.2.7 AND ARE TO BE REPORTED IN THE SAME UNITS AS NOTED IN THAT SECTION. TEST RESULTS TO INCLUDE ANALYSIS OF SOIL TEXTURE, ORGANIC CONTENT AND ACIDITY AS PER CLS 6.3.5 AND BE REPORTED IN THE SAME UNITS AS NOTED IN THAT SECTION.

TEST RESULTS TO INCLUDE RECOMMENDATIONS FOR AMENDMENTS TO MEET THE REQUIREMENTS FOR EACH GROWING MEDIUM TYPE.

RECOMMENDED GROWING MEDIUM TESTING FACILITY: Pacific Soil Analysis Inc. 11720 Voyageur Way, Richmond, BC V6X 3G9.

1. COMPACTION TESTS FOR HARD SURFACE SUBGRADE, GRANULAR SUB-BASE, AND GRANULAR BASE ARE MANDATORY.

1. CONTRACTOR TO ALERT THE LANDSCAPE CONSULTANT A MINIMUM OF 3 WORKING DAYS PRIOR TO REQUIRED LANDSCAPE INSPECTIONS.

1. REQUESTS FOR SUBSTITUTIONS TO CONFORM TO THE DIVISION 01 SECTION AND BE SUBMITTED TO THE LANDSCAPE CONSULTANT, THROUGH THE PROJECT ADMINISTRATOR, A MINIMUM OF 45 DAYS PRIOR TO SCHEDULED WORK. 2. PLEASE NOTE THAT SOME SUBSTITUTIONS MAY REQUIRE MUNICIPAL APPROVAL.

WARRANTY:

1. CONTRACTOR SHALL WARRANTY ALL WORKMANSHIP AND MATERIALS FOR 1 FULL YEAR FOLLOWING THE DATE OF TOTAL PERFORMANCE AS PER MMCD UNLESS SPECIFICALLY NOTED OTHERWISE. FAULTY MATERIALS AND WORKMANSHIP SHALL BE PROMPTLY REPAIRED / REPLACED TO THE SATISFACTION OF THE LANDSCAPE CONSULTANT.

ENVIRONMENTAL PROTECTION: 1. CONTRACTOR TO INSTALL AND MAINTAIN SEDIMENTATION FILTRATION MEASURES AS REQUIRED FOR LANDSCAPE WORKS TO PREVENT MATERIALS FROM LEAVING THE SITE AND / OR ENTERING STORM DRAINS; STOCKPILED LANDSCAPE MATERIALS ARE TO BE KEPT TARPED.

ELECTRICAL - DESIGN BUILD

LANDSCAPE LIGHTING:

1. IT IS THE INTENTION OF THE PROJECT THAT THE LANDSCAPE CONTRACTOR FURNISH A FUNCTIONAL LIGHTING SYSTEM AS DESCRIBED ON THE DRAWINGS AND IN THIS SECTION.

THE SCOPE OF WORK INCLUDES SUPPLY AND INSTALLATION OF LOW VOLTAGE LIGHTING PRODUCTS, CABLING, TRANSFORMER(S) / POWER SUPPLIES / DRIVERS AND ELECTRICAL SLEEVES. 3. ELECTRICAL CONTRACTOR IS TO INCLUDE POWER (CONDUIT AND CONDUCTORS) TO LOW VOLTAGE TRANSFORMERS/DRIVERS IN SUPPORT OF THE LANDSCAPE LIGHTING PLAN. THE NUMBER OF CONNECTION POINTS IS NOT DETERMINED - THIS DEPENDS ON HOW THE LANDSCAPE CONTRACTOR LAYS OUT THE SYSTEM, BUT WILL NOT EXCEED 5. REFER TO THE LANDSCAPE LIGHTING PLAN FOR GENERAL INFORMATION.

4. 15A 1P CIRCUIT FROM HOUSE PANEL, SWITCHED BY A PROGRAMMABLE TIMER INSTALLED IN THE ELECTRICAL ROOM.

TRANSFORMER TO BE ADEQUATELY SIZED FOR THE LOAD PLUS 40% RESERVE CAPACITY. TRANSFORMERS TO BE ARRANGED SUCH THAT NO LOAD REQUIRES WIRING IN EXCESS OF 75'.

TIMER FUNCTION ON TRANSFORMER TO BE DISABLED IF PROVIDED. TRANSFORMERS, DRIVERS AND POWER SUPPLIES ARE TO BE INSTALLED IN GROUND JUNCTION BOXES, SUPPLIED AND INSTALLED BY THIS DIVISION.

8. THE LANDSCAPE CONTRACTOR SHALL COORDINATE WITH THE ELECTRICAL CONTRACTOR FOR AC CIRCUIT TO EACH JUNCTION BOX LOCATION AND WITH THE GENERAL CONTRACTOR FOR THE INSTALLATION OF ELECTRICAL SLEEVES. 9. THE USE OF GEL FILLED WIRE NUTS IS REQUIRED.

IRRIGATION COORDINATION:

1. ELECTRICAL CONTRACTOR TO COORDINATE WITH CONSTRUCTION MANAGER AND IRRIGATION DESIGNER/INSTALLER TO PROVIDE ELECTRICAL FOR THE OPERATION OF AN AUTOMATIC IRRIGATION SYSTEM AND CONTROLLER.

WINDMILL PALM REQUESTED TO BE
TRANSPLANTED / REMOVED BY LANDSCAPE
TO ALLOW FOR PLANTING OF LARGE CANOPY
TREE

TREE PROTECTION FENCING

TREE PROTECTION FENCING

TO OUTSIDE OF DRIPLINE WHERE POSSIBLE (AS SHOWN)

TO BE MAINTAINED UNTIL COMPLETION OF CONSTRUCTION
TO MUNICIPAL STANDARD

REMOVAL

PROTECTED TREE AND SHRUB FOR

MUNICIPAL TREE FOR REMOVAL

BIOPHILLA

1608 Camosun Street, Victoria BC V8T 3E6 Info@biophiliacollective.ca 250 590 1156

OWNER/CLIENT:


ARYZE DEVELOPMENTS

PROJECT ADDRESS:

1733 FAIRFIELD, VICTORIA, BC

DESIGNED BY:BIANCA BODLEY DRAWN BY:TYLER YESTAL

NO.	ISSUE	YY\MM\DD
1	ISSUED FOR DEVELOPMENT TRACKER	22\03\04
2	ISSUED FOR RZ/DP	22\05\02
3	ISSUED FOR COORDINATION	22\07\18
4	ISSUED FOR RZ/ DP	22\07\20
5	ISSUED FOR RZ/ DP RESUBMISSION	23\01\24
6	ISSUED FOR RZ/ DP RESUBMISSION	2023\08\18
7	25% BUILDING PERMIT	2023\10\10
8	ISSUED FOR BP COORDINATION	2023/11/24
9	DP/RZ REV 4	2024/01/12
10	DP/RZ REV 5	2024/02/21
11	ISSUED FOR BUILDING PERMIT	2024/03/01
12	DP/RZ REV 6	2024/07/03

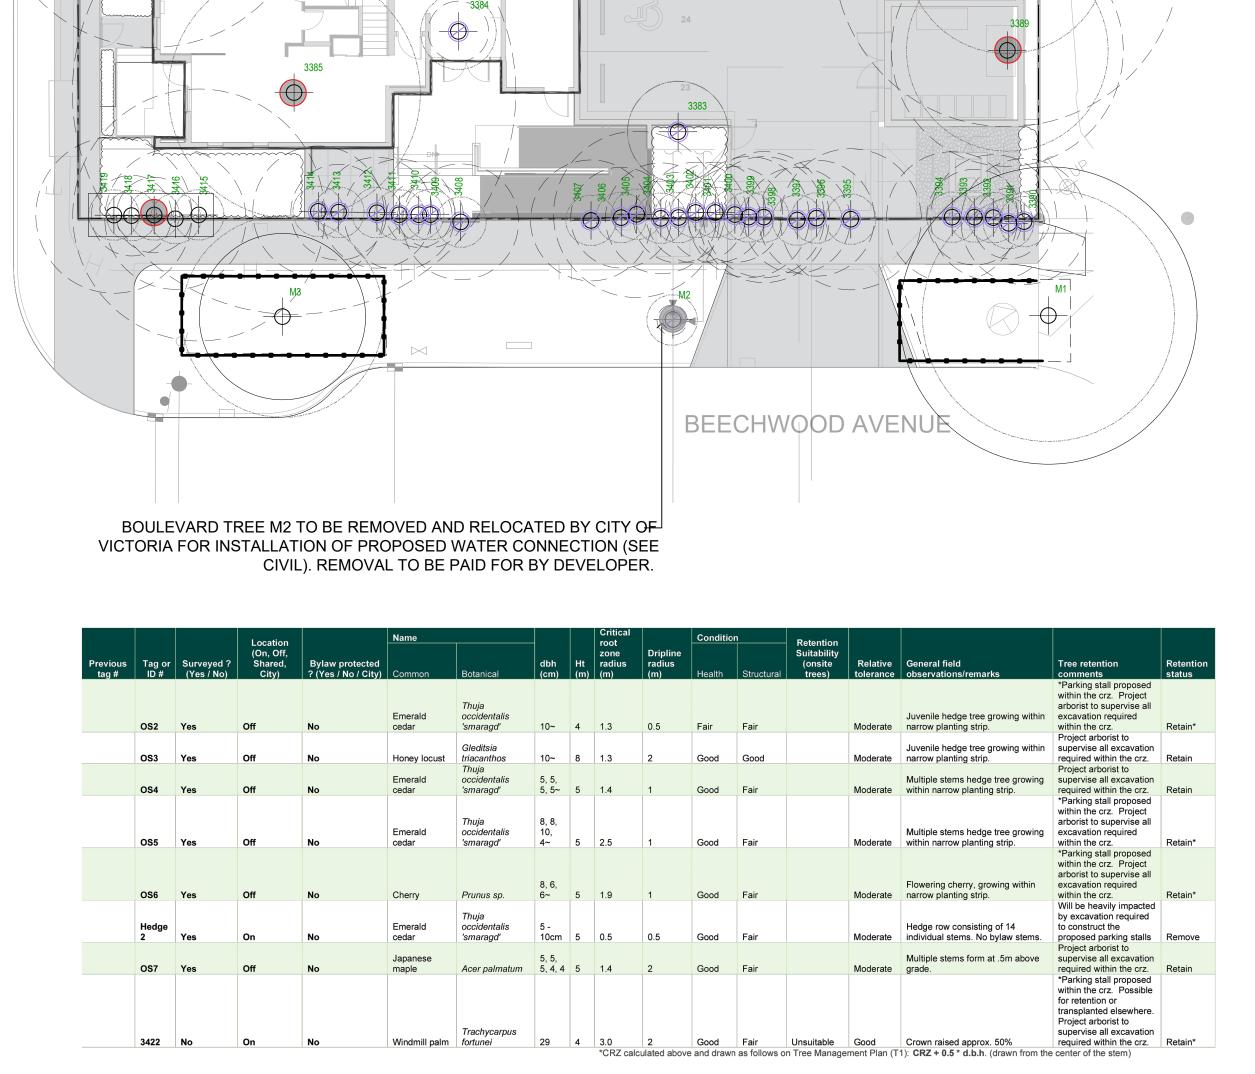

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REGISTERED

REARBERT

AND ALDERSTON

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2024-07-19


NORTH ARROW

DRAWING TITLE:

TREE REMOVAL & PROTECTION PLAN

DWG NO:

L0.1

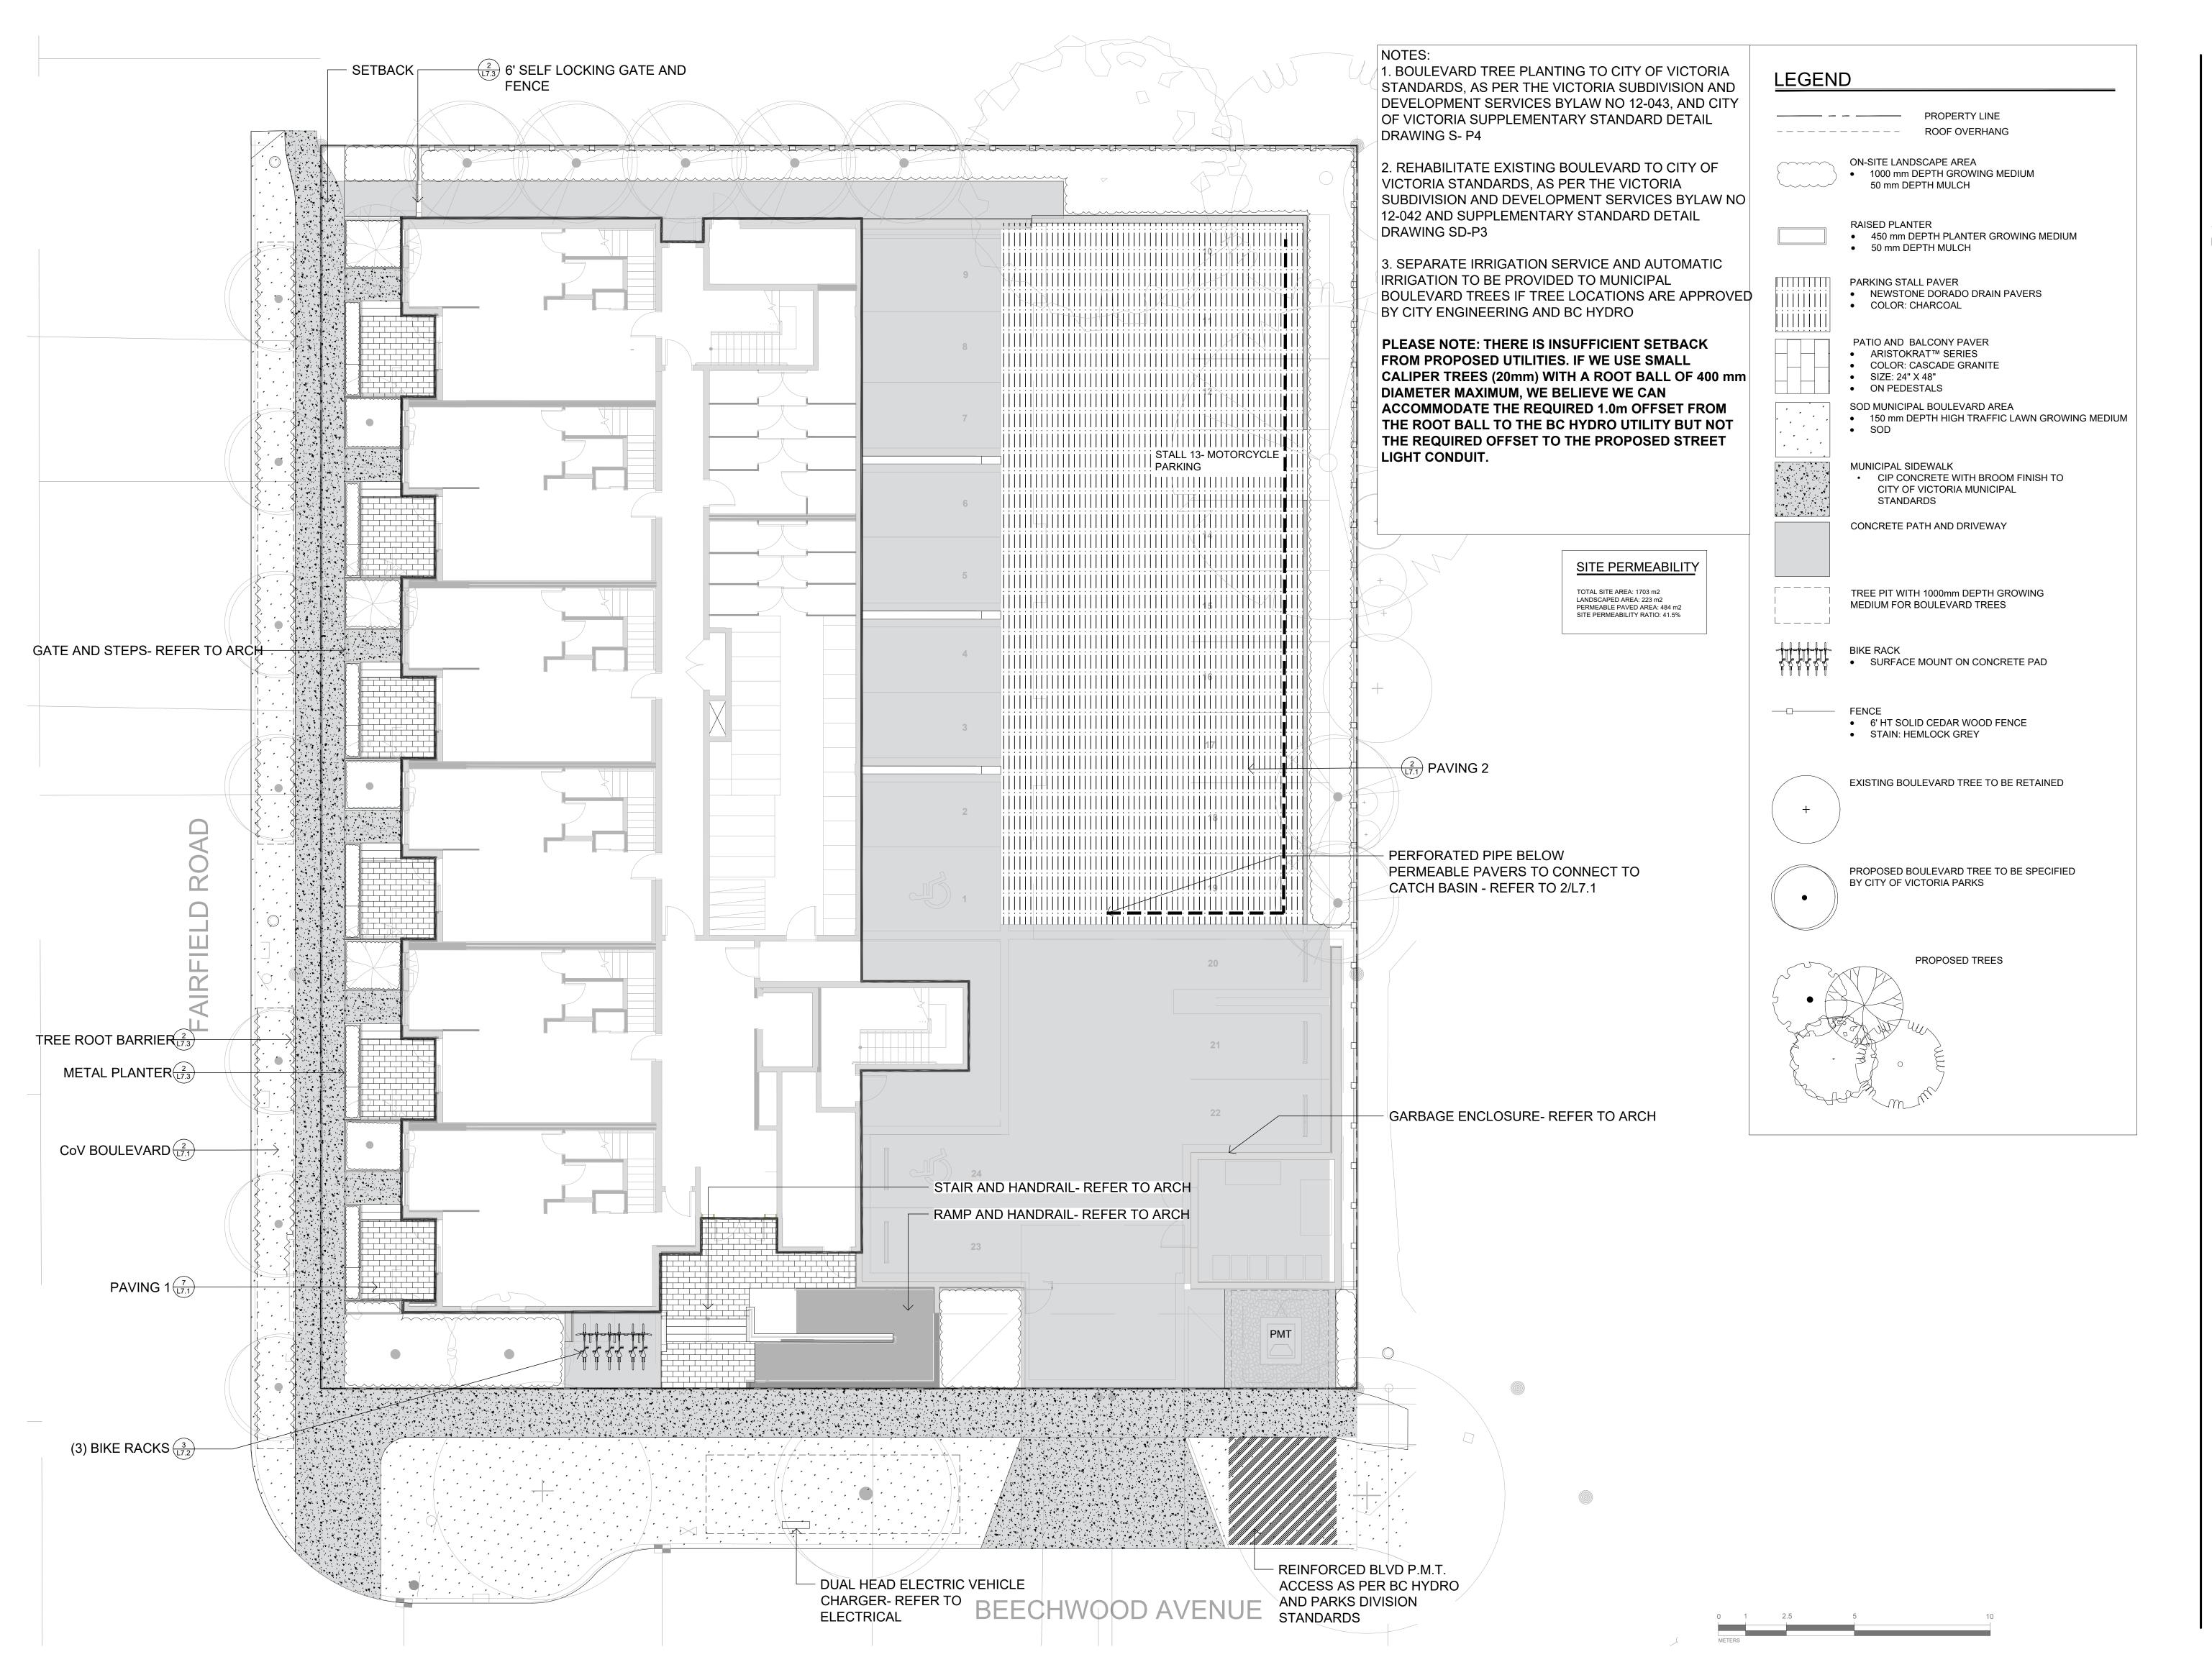



OWNER/CLIENT:

ARYZE DEVELOPMENTS

PROJECT ADDRESS:

1733 FAIRFIELD, VICTORIA, BC

DESIGNED BY:BIANCA BODLEY DRAWN BY:TYLER YESTAL

 NO.
 ISSUE
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 1
 ISSUED FOR DEVELOPMENT TRACKER
 22\03\04

 2
 ISSUED FOR RZ/DP
 22\05\02

 3
 ISSUED FOR COORDINATION
 22\07\18

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5 ISSUED FOR RZ/ DP RESUBMISSION 23\01\24
6 ISSUED FOR RZ/ DP RESUBMISSION 2023\08\18
7 25% BUILDING PERMIT 2023\10\10
8 ISSUED FOR BP COORDINATION 2023/11/24
9 DP/RZ REV 4 2024/01/12
10 DP/RZ REV 5 2024/02/21

2024/03/01

2024/07/03

11 ISSUED FOR BUILDING PERMIT

12 DP/RZ REV 6

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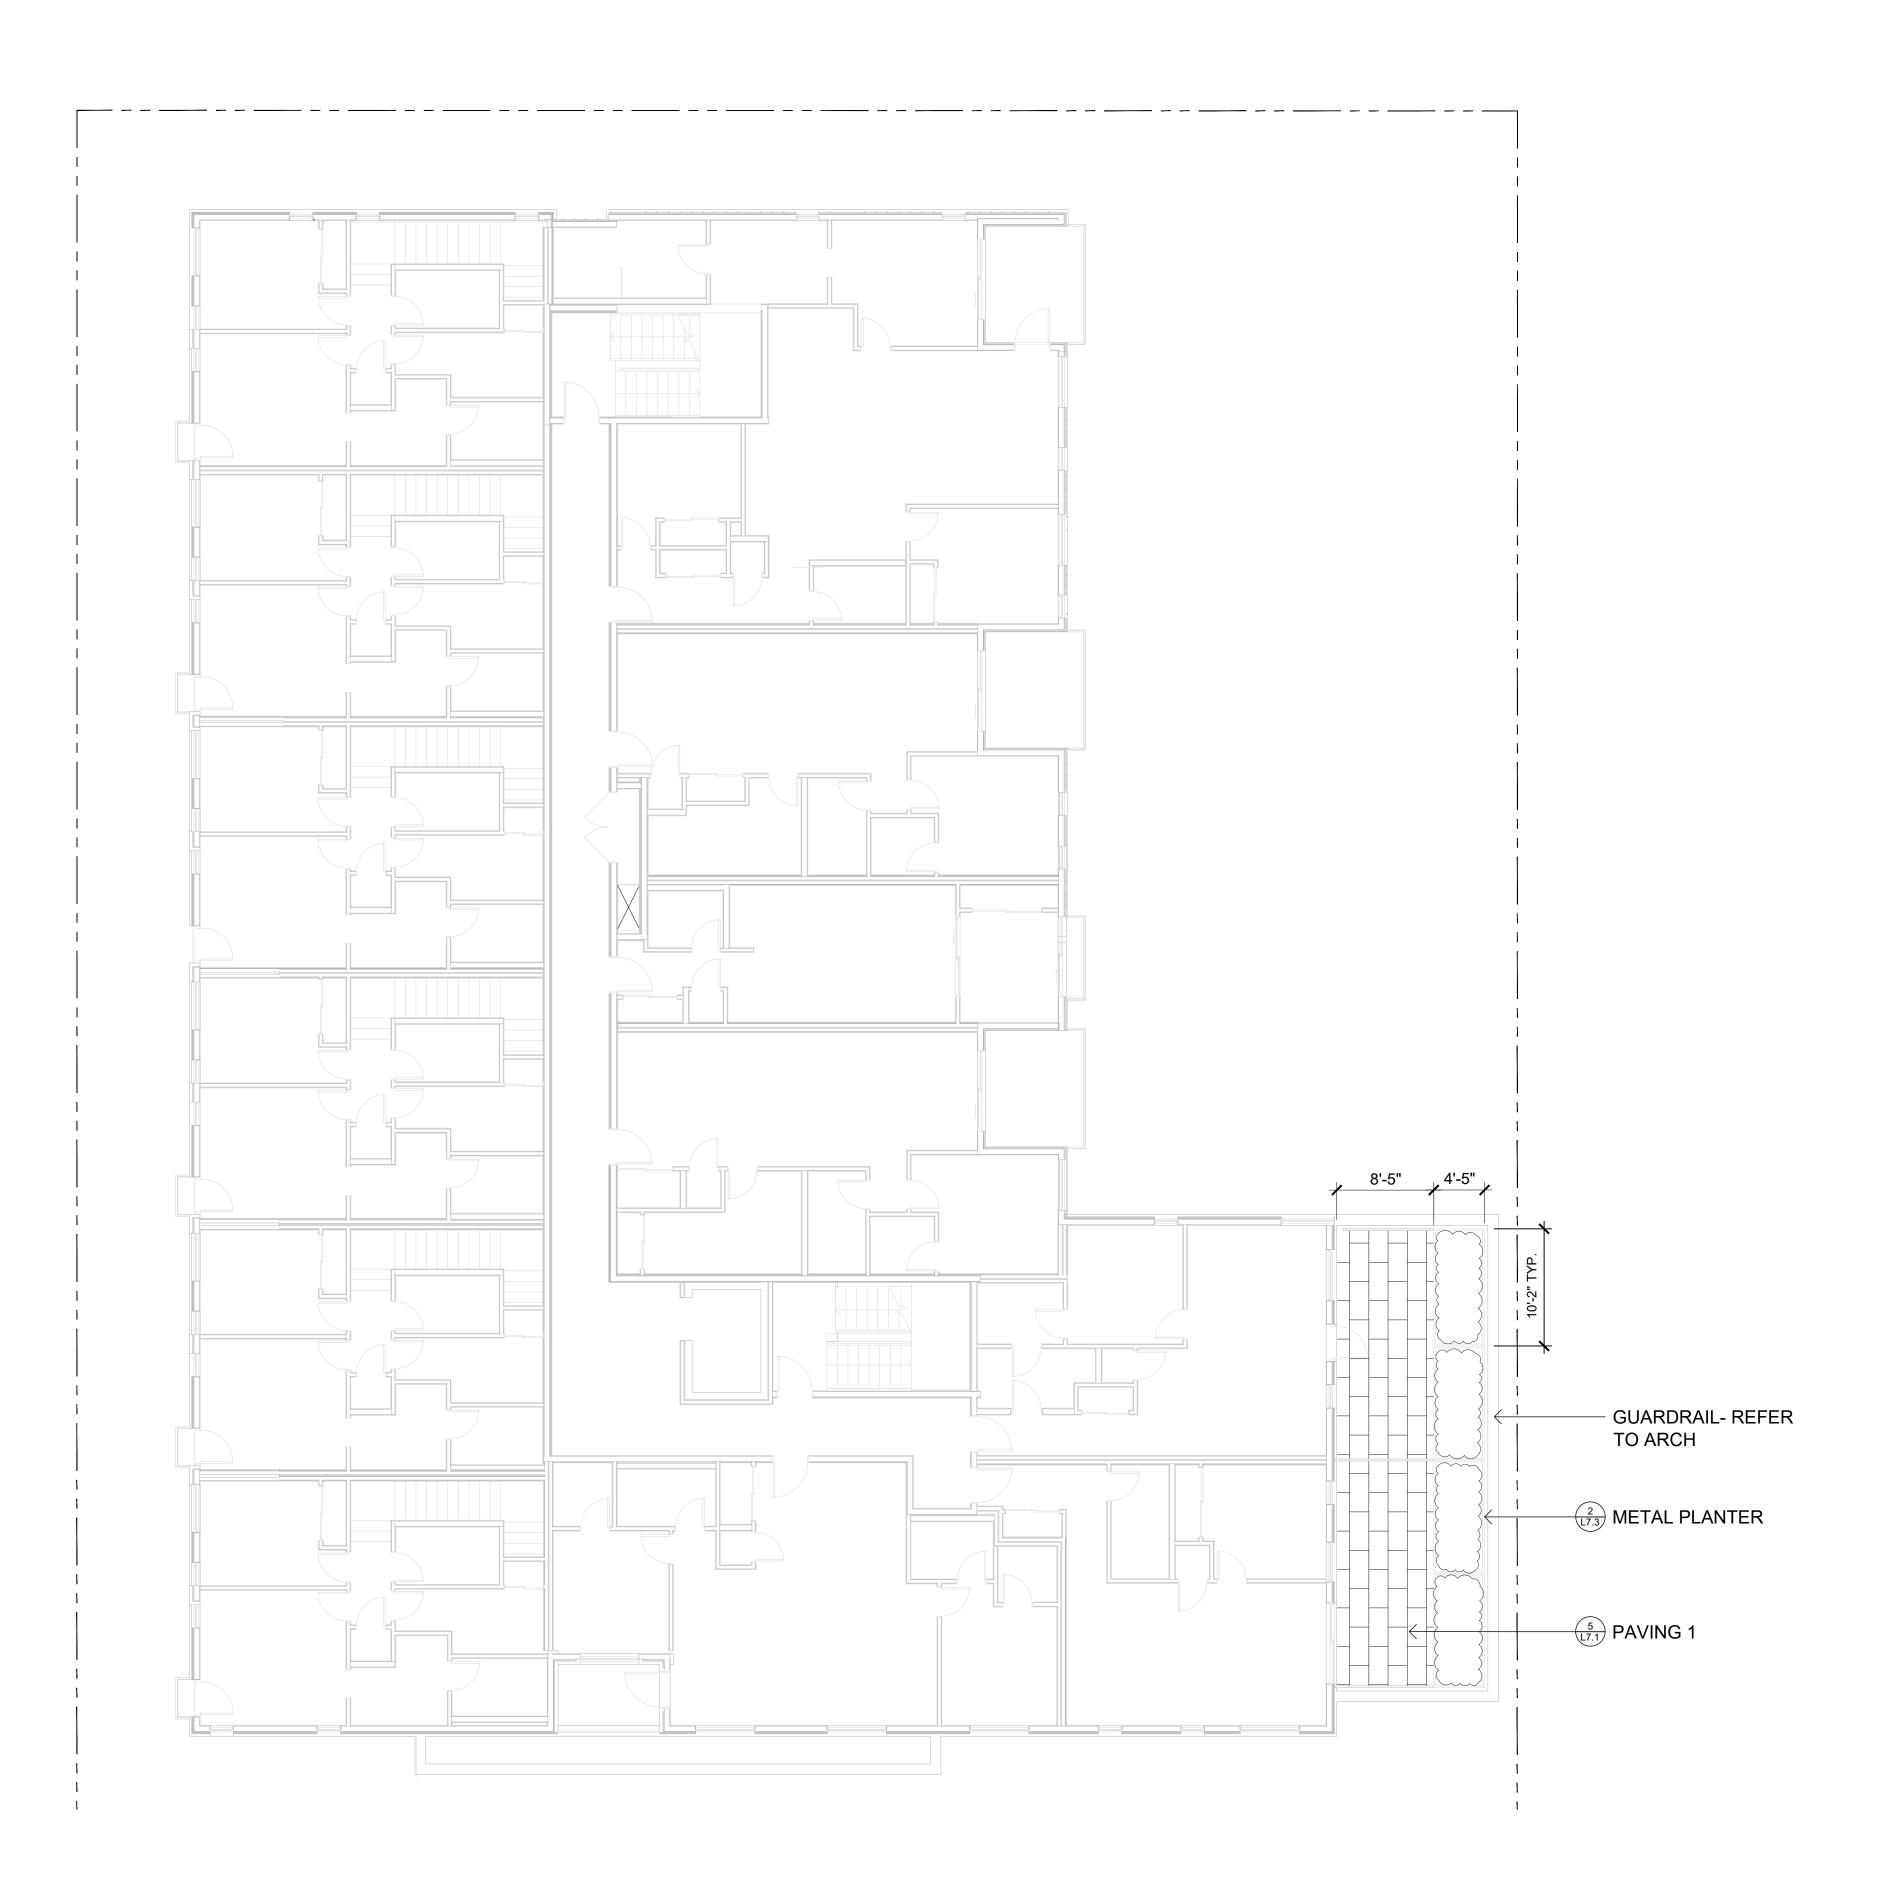
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DRAWING TITLE:


LANDSCAPE MATERIALS
PLAN
LEVEL 1

DWG NO:

L1.1



1 LEVEL 2 BALCONY & PLANTER 1:100

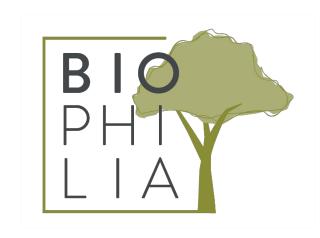

1608 Camosun Street, Victoria BC V8T 3E6 Info@biophiliacollective.ca 250 590 1156

OWNER/CLIENT:


ARYZE DEVELOPMENTS

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1733 FAIRFIELD, VICTORIA, BC

DESIGNED BY:BIANCA BODLEY DRAWN BY:TYLER YESTAL


NO. ISSUE YY\MM\DD 1 ISSUED FOR DEVELOPMENT TRACKER | 22\03\04 2 ISSUED FOR RZ/DP 22\05\02 3 ISSUED FOR COORDINATION 22\07\18 22\07\20 4 ISSUED FOR RZ/ DP 5 ISSUED FOR RZ/ DP RESUBMISSION 23\01\24 6 ISSUED FOR RZ/ DP RESUBMISSION 2023\08\18 7 25% BUILDING PERMIT 2023\10\10 8 ISSUED FOR BP COORDINATION 2023/11/24 9 DP/RZ REV 4 2024/01/12 10 DP/RZ REV 5 2024/02/21 11 ISSUED FOR BUILDING PERMIT 2024/03/01 12 DP/RZ REV 6 2024/07/03

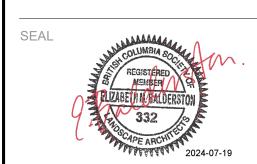


NORTH ARROW

DRAWING TITLE:

LANDSCAPE MATERIALS AND LAYOUT PLAN LEVELS 2, 3, & 4

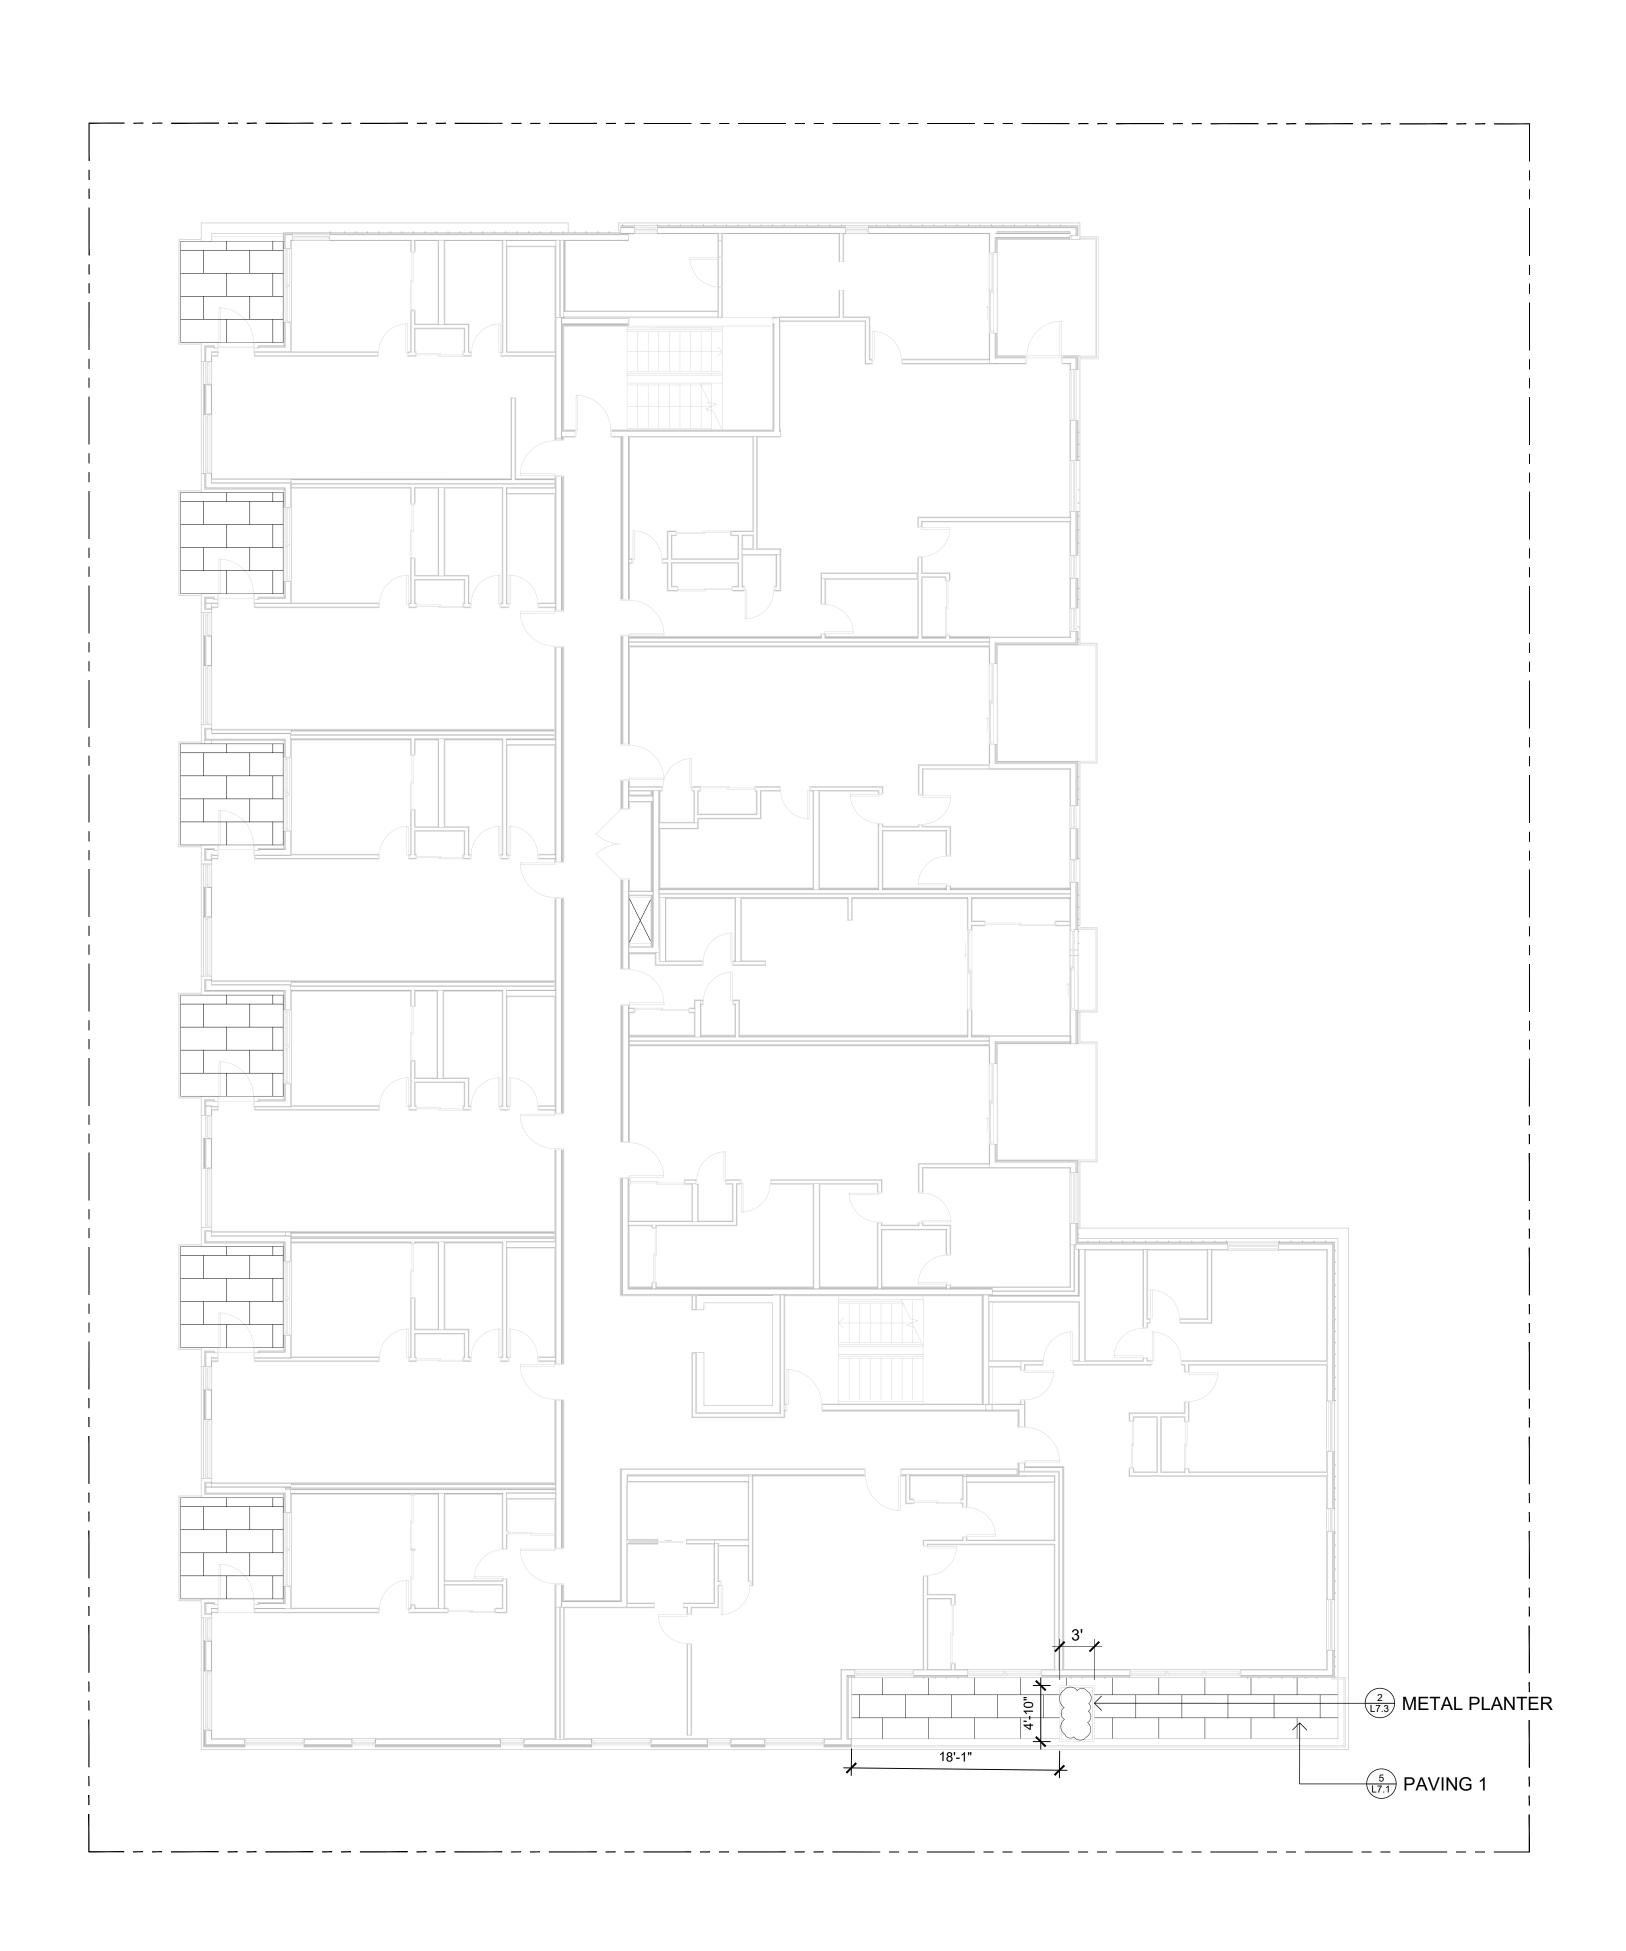

1 LEVEL 3 BALCONY & PLANTER L1.3 1:100

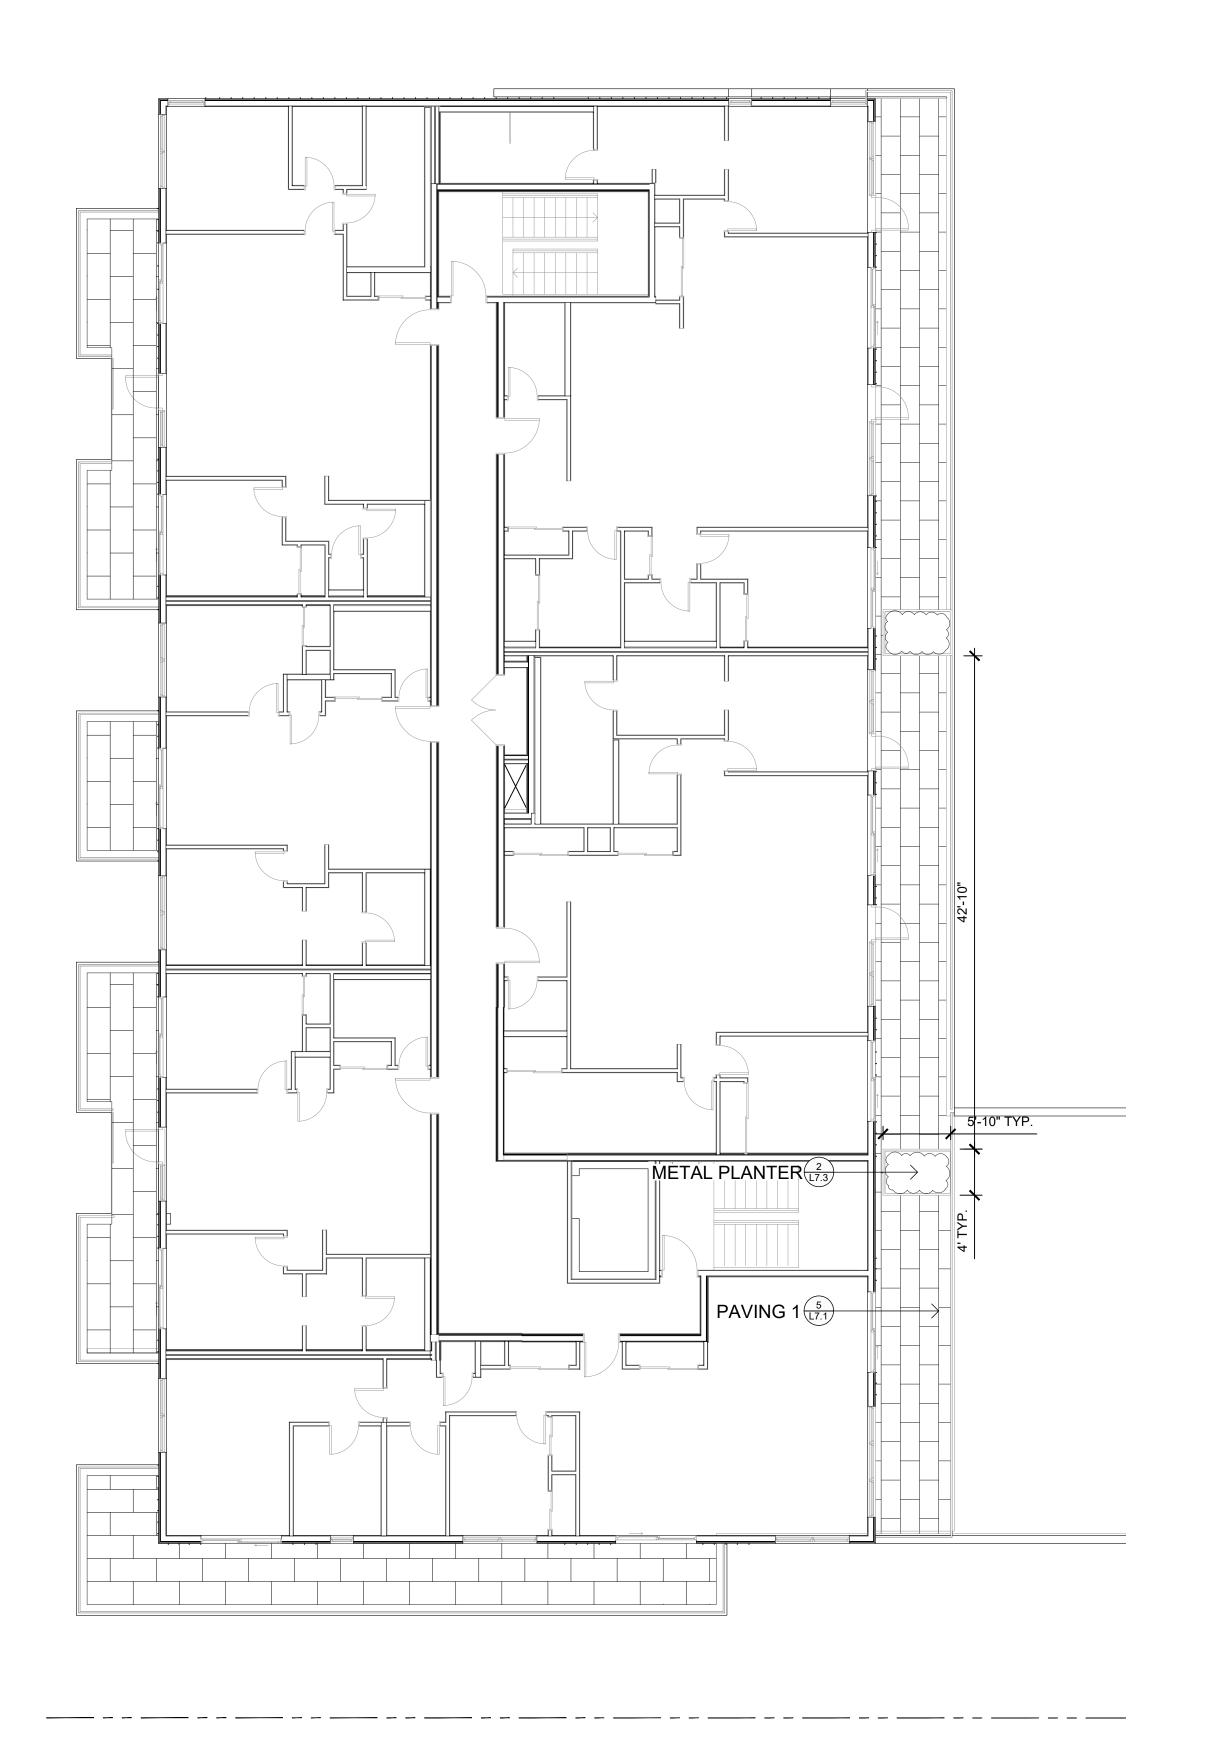

2 LEVEL 4 BALCONY & PLANTER L1.3 1:100





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ER/CLIENT:


ARYZE DEVELOPMENTS

PROJECT ADDRESS:

1733 FAIRFIELD, VICTORIA, BC

DESIGNED BY:BIANCA BODLEY DRAWN BY:TYLER YESTAL

NO.	ISSUE	YY\MM\DD
1	ISSUED FOR DEVELOPMENT TRACKER	22\03\04
2	ISSUED FOR RZ/DP	22\05\02
3	ISSUED FOR COORDINATION	22\07\18
4	ISSUED FOR RZ/ DP	22\07\20
5	ISSUED FOR RZ/ DP RESUBMISSION	23\01\24
6	ISSUED FOR RZ/ DP RESUBMISSION	2023\08\18
7	25% BUILDING PERMIT	2023\10\10
8	ISSUED FOR BP COORDINATION	2023/11/24
9	DP/RZ REV 4	2024/01/12
10	DP/RZ REV 5	2024/02/21
11	ISSUED FOR BUILDING PERMIT	2024/03/01
12	DP/RZ REV 6	2024/07/03

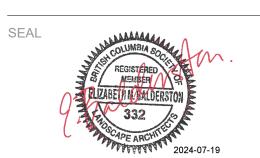


ORTH ARROW

LANDSCAPE MATERIALS
AND LAYOUT PLAN
LEVELS 2, 3, & 4

DWG NO:

SCALE: AS NOTED

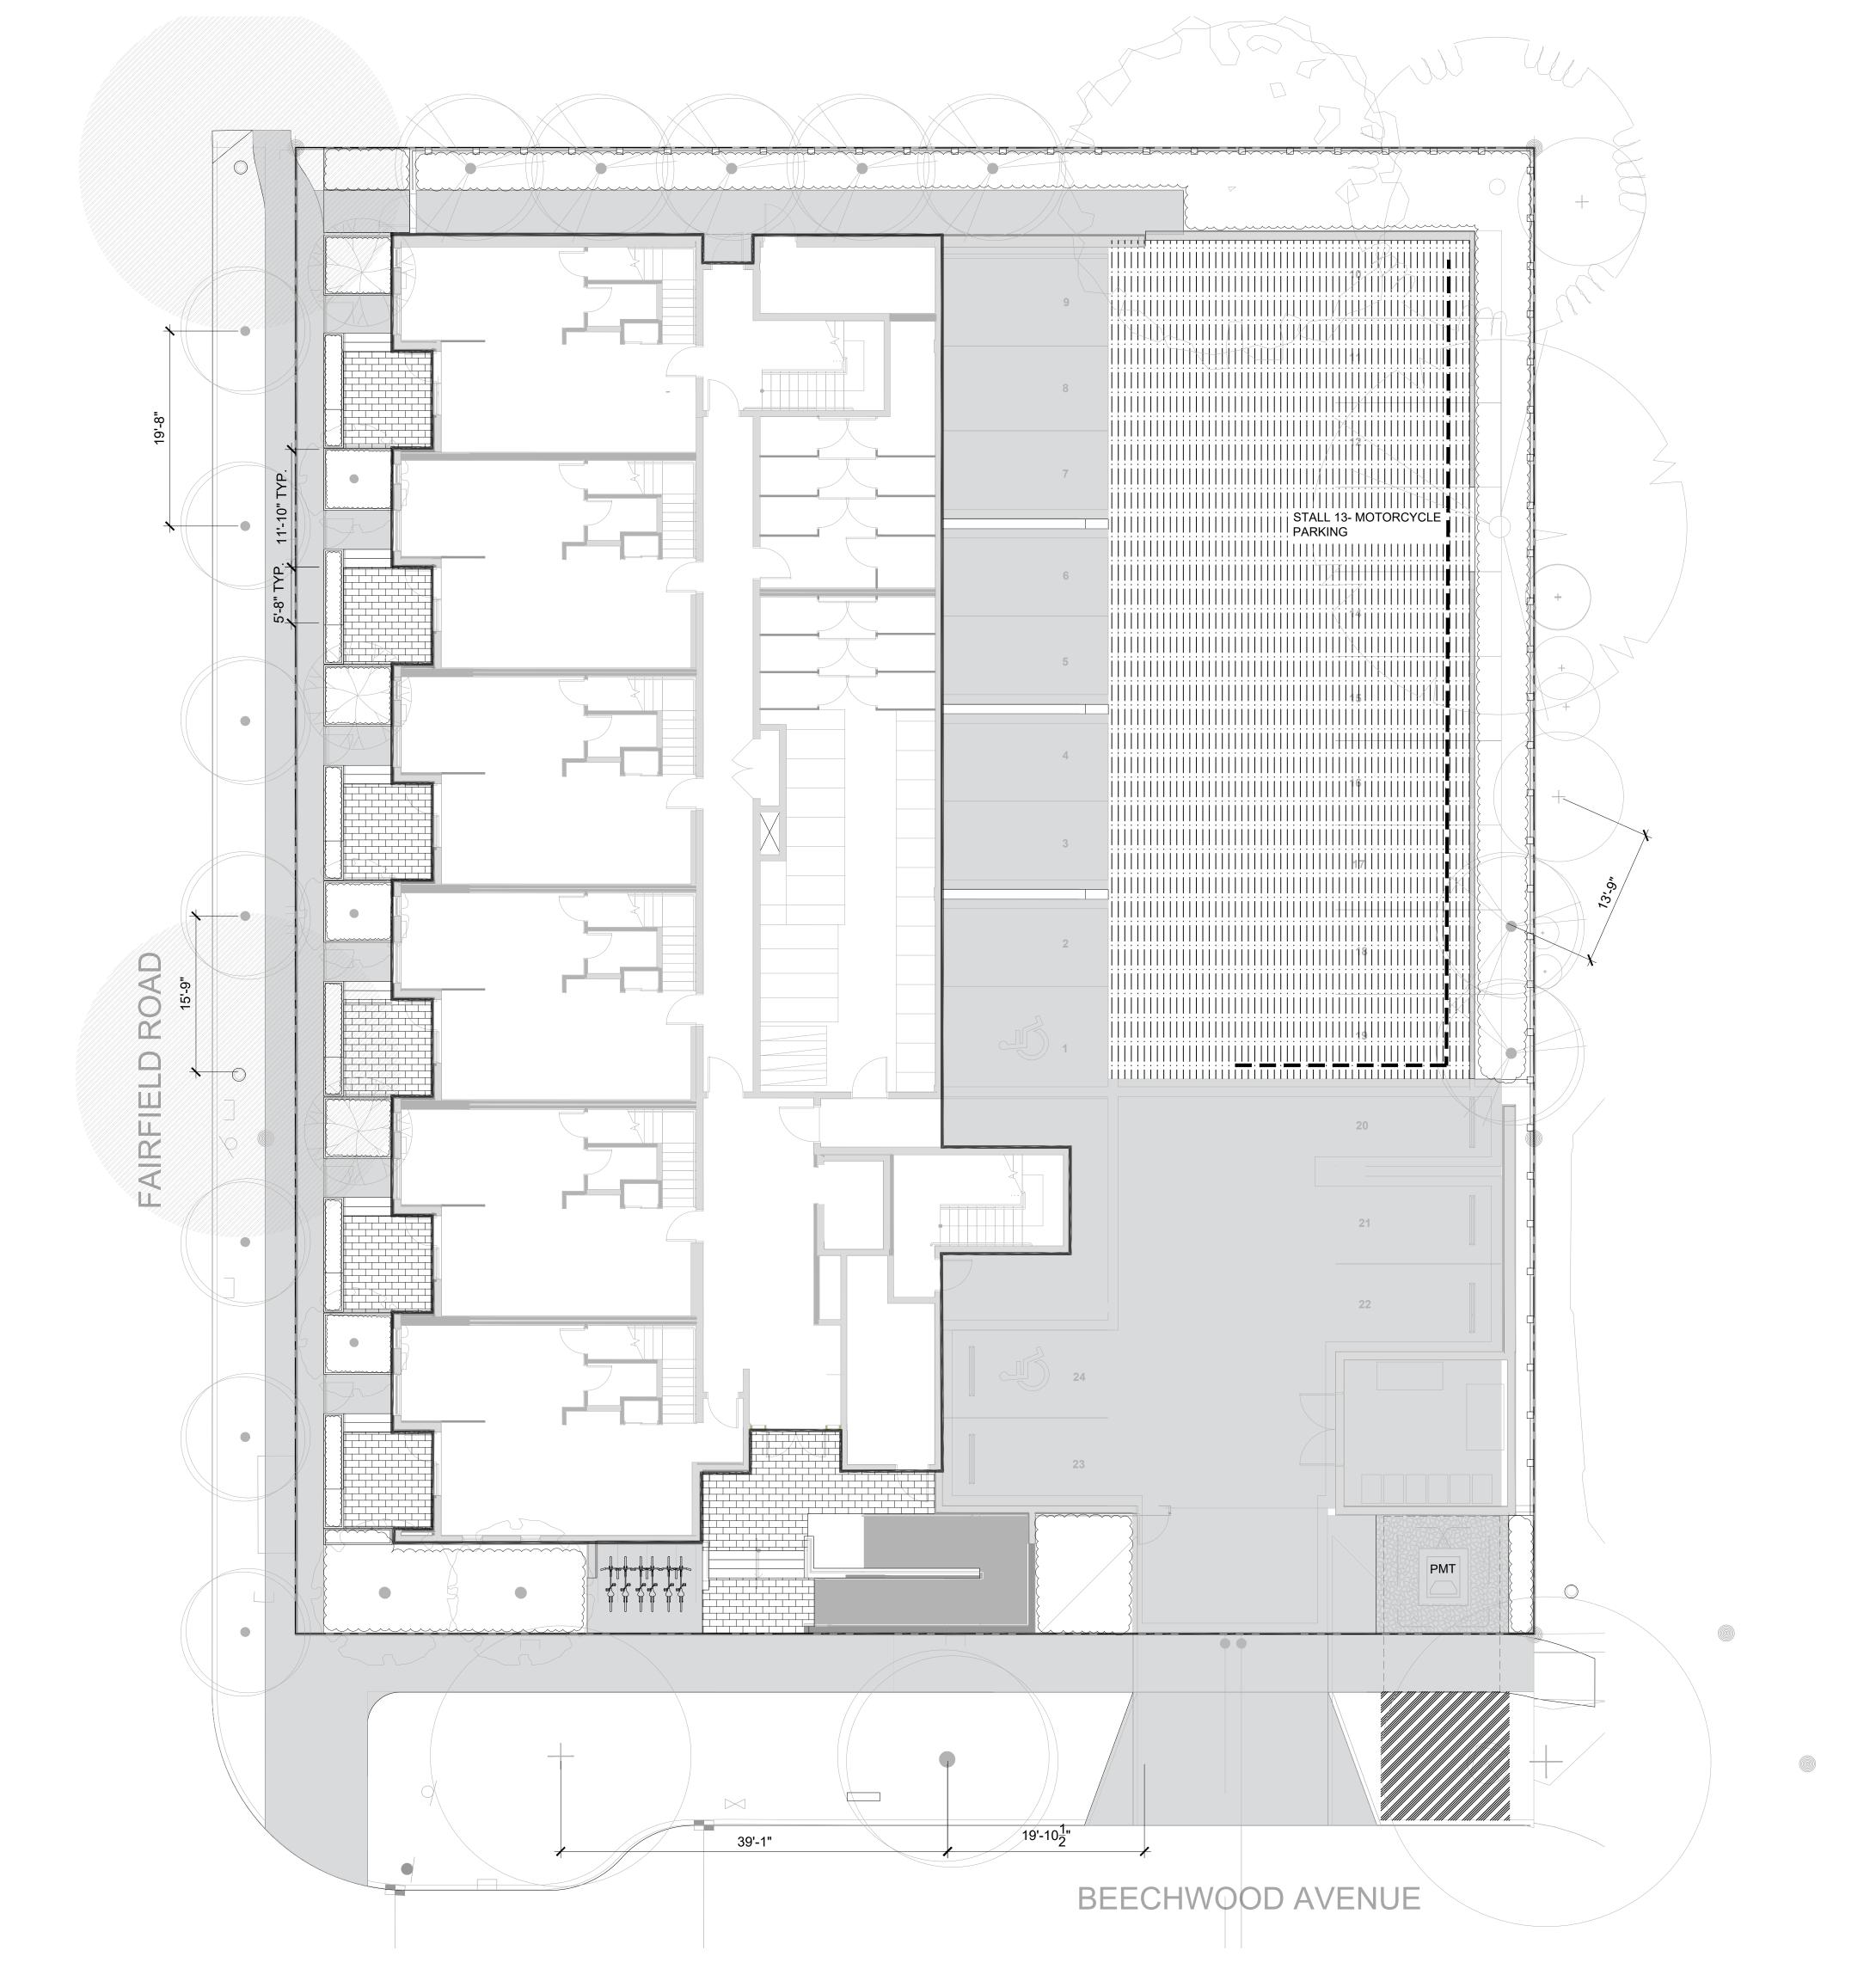



OWNER/CLIENT:

ARYZE DEVELOPMENTS

PROJECT ADDRESS:

1733 FAIRFIELD, VICTORIA, BC

DESIGNED BY:BIANCA BODLEY DRAWN BY:TYLER YESTAL

NO.	ISSUE	YY\MM\E
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7	25% BUILDING PERMIT	2023\10\
8	ISSUED FOR BP COORDINATION	2023/11/2
9	DP/RZ REV 4	2024/01/
10	DP/RZ REV 5	2024/02/2
11	ISSUED FOR BUILDING PERMIT	2024/03/0
12	DP/RZ REV 6	2024/07/0

NORTH ARROW

DRAWING TITLE: LAYOUT PLAN

LAYOUT PLAN NOTES

ALL DIMENSIONS ARE NOMINAL
 REFER TO GRADING PLAN FOR ELEVATIONS

ARCHITECT PRIOR TO INSTALLATION

ALL SITE FURNISHINGS TO BE CONFIRMED WITH LANDSCAPE





OWNER/CLIENT:


ARYZE DEVELOPMENTS

PROJECT ADDRESS:

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12	DP/RZ REV 6	2024/07/03



NORTH ARROW

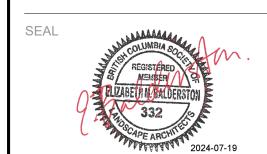
DRAWING TITLE:

GRADING PLAN

GRADING PLAN NOTES

ALL ELEVATIONS ARE NOMINAL. CONTRACTOR TO VERIFY SPOT ELEVATION PRIOR THE START OF CONSTRUCTION.
 ALL ELEVATIONS ARE TO TOP OF FINISHED GRADE UNLESS

REFER TO CIVIL FOR ALL OFFISITE AND PARKING LOT GRADING.
REFER TO ARCH FOR ONSITE HARDSCAPE GRADING.

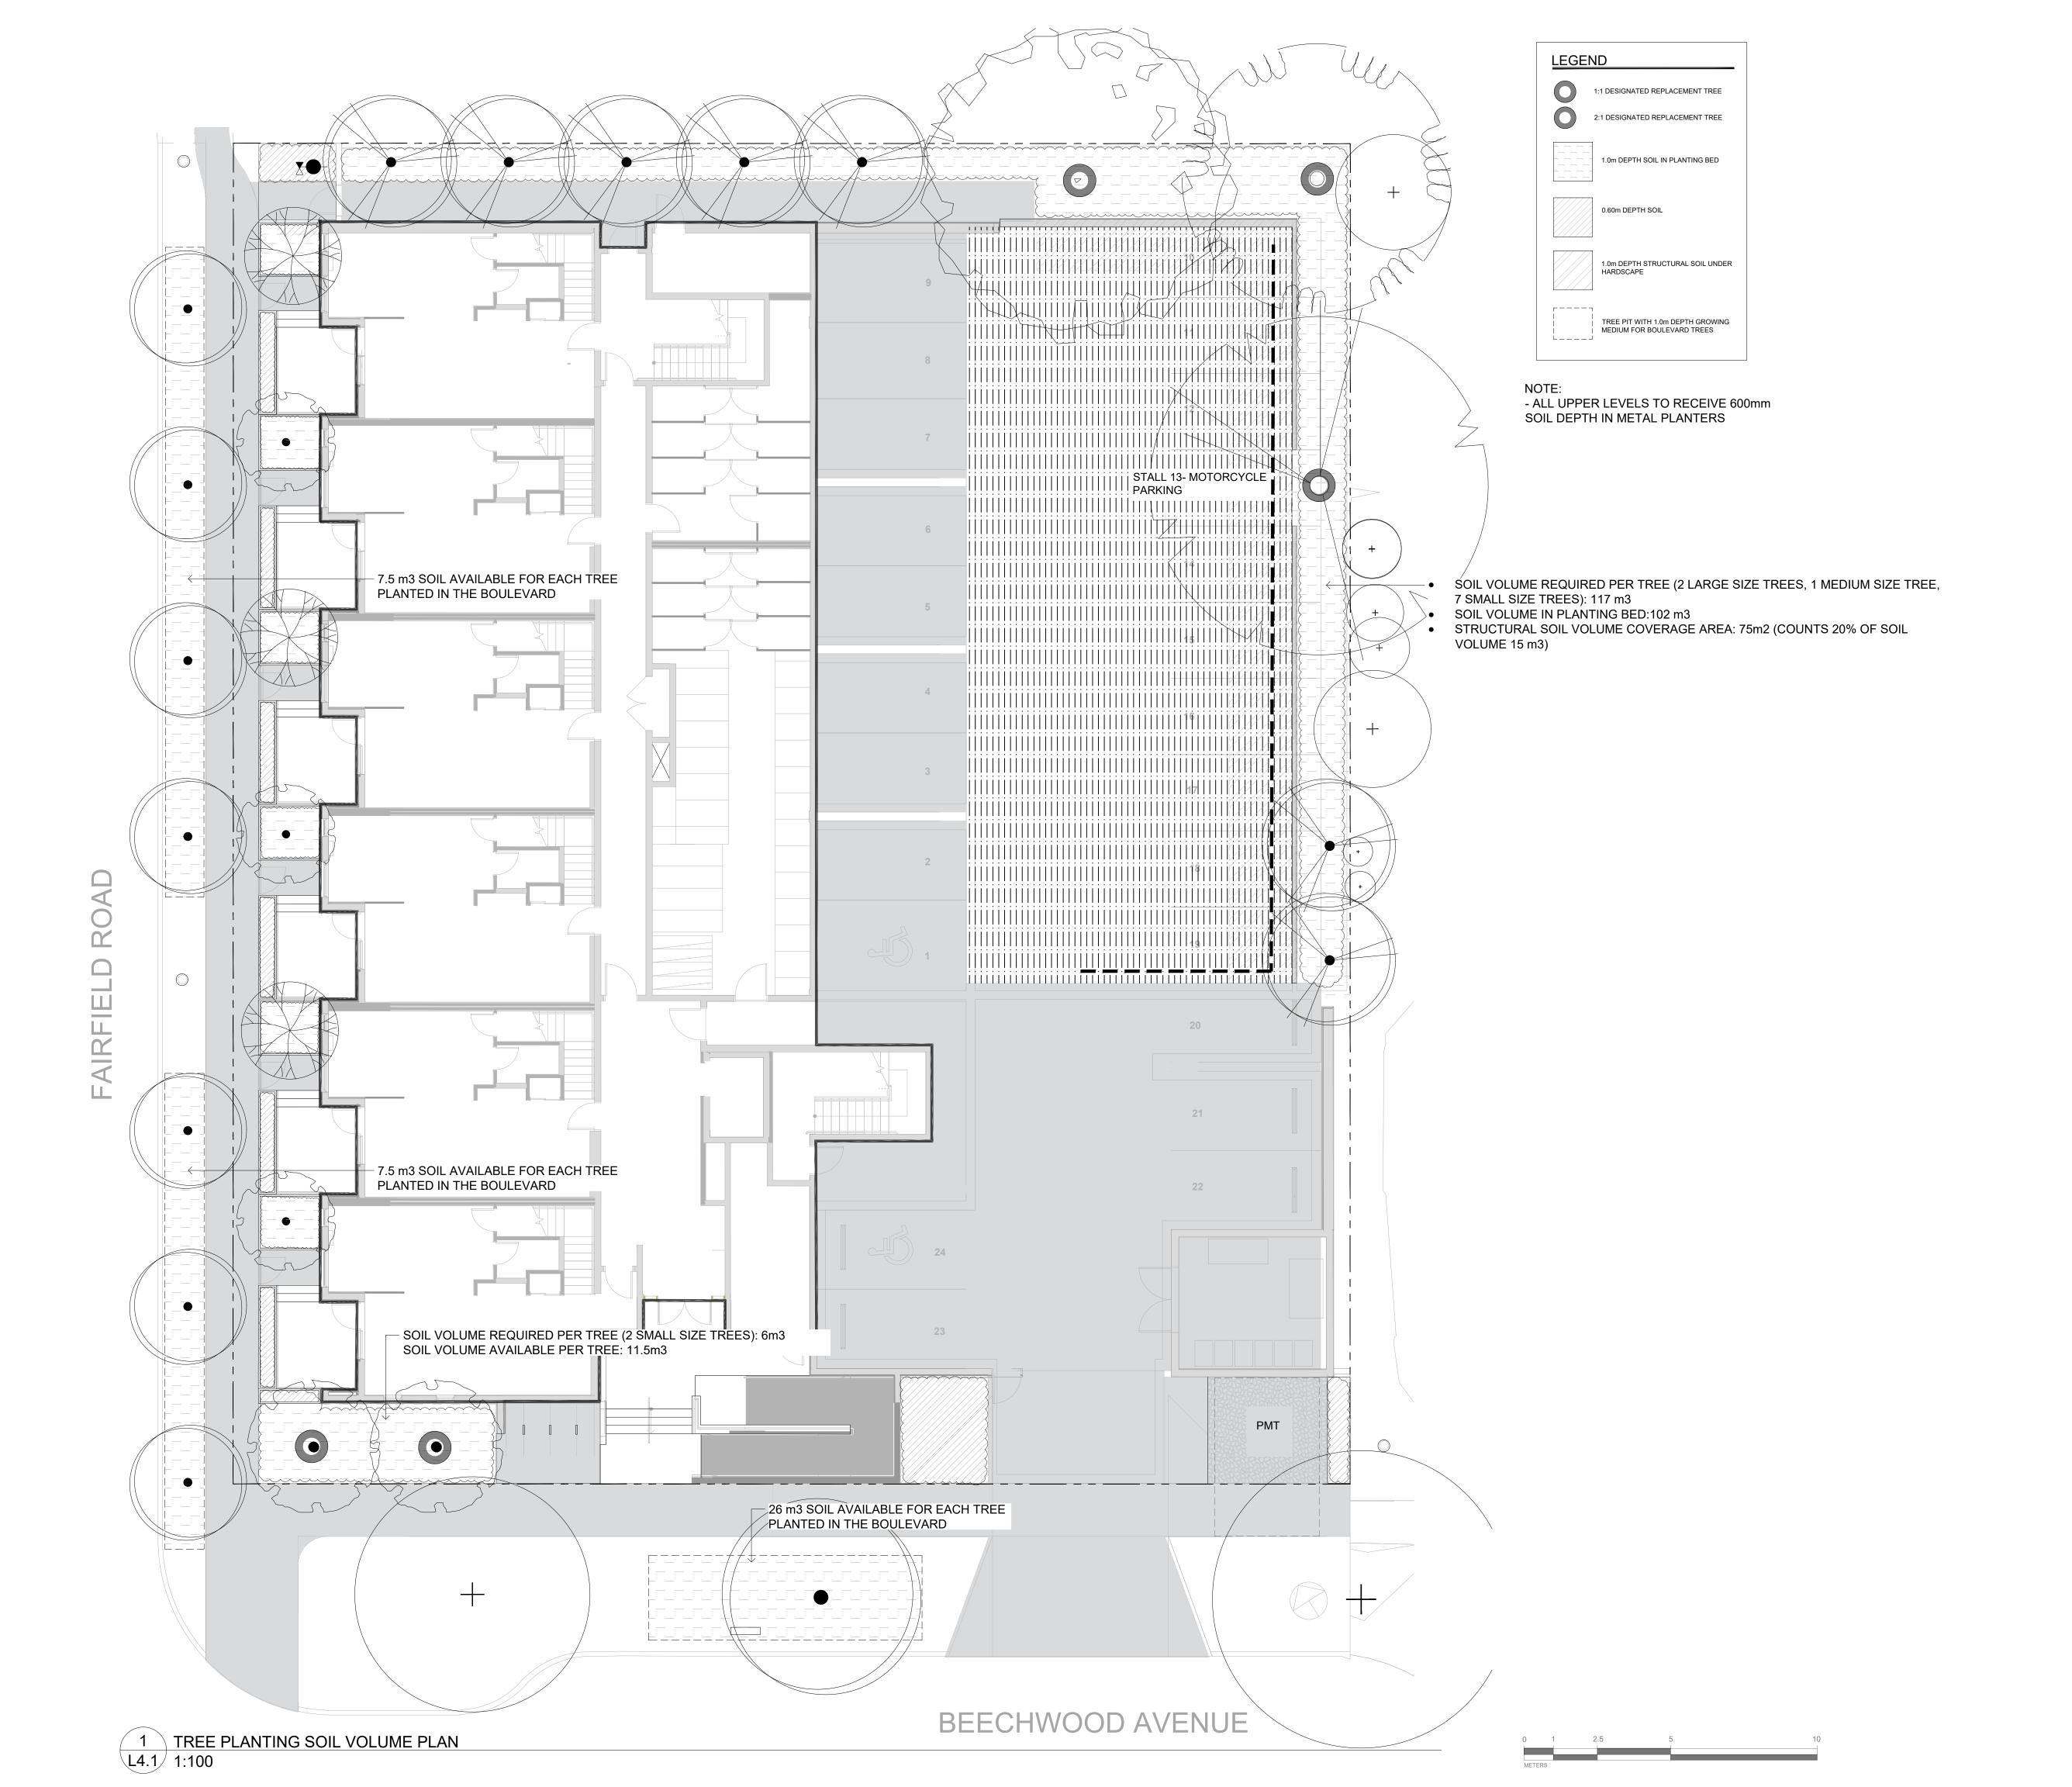



OWNER/CLIENT:


ARYZE DEVELOPMENTS

PROJECT ADDRESS:

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11	ISSUED FOR BUILDING PERMIT	2024/03/01
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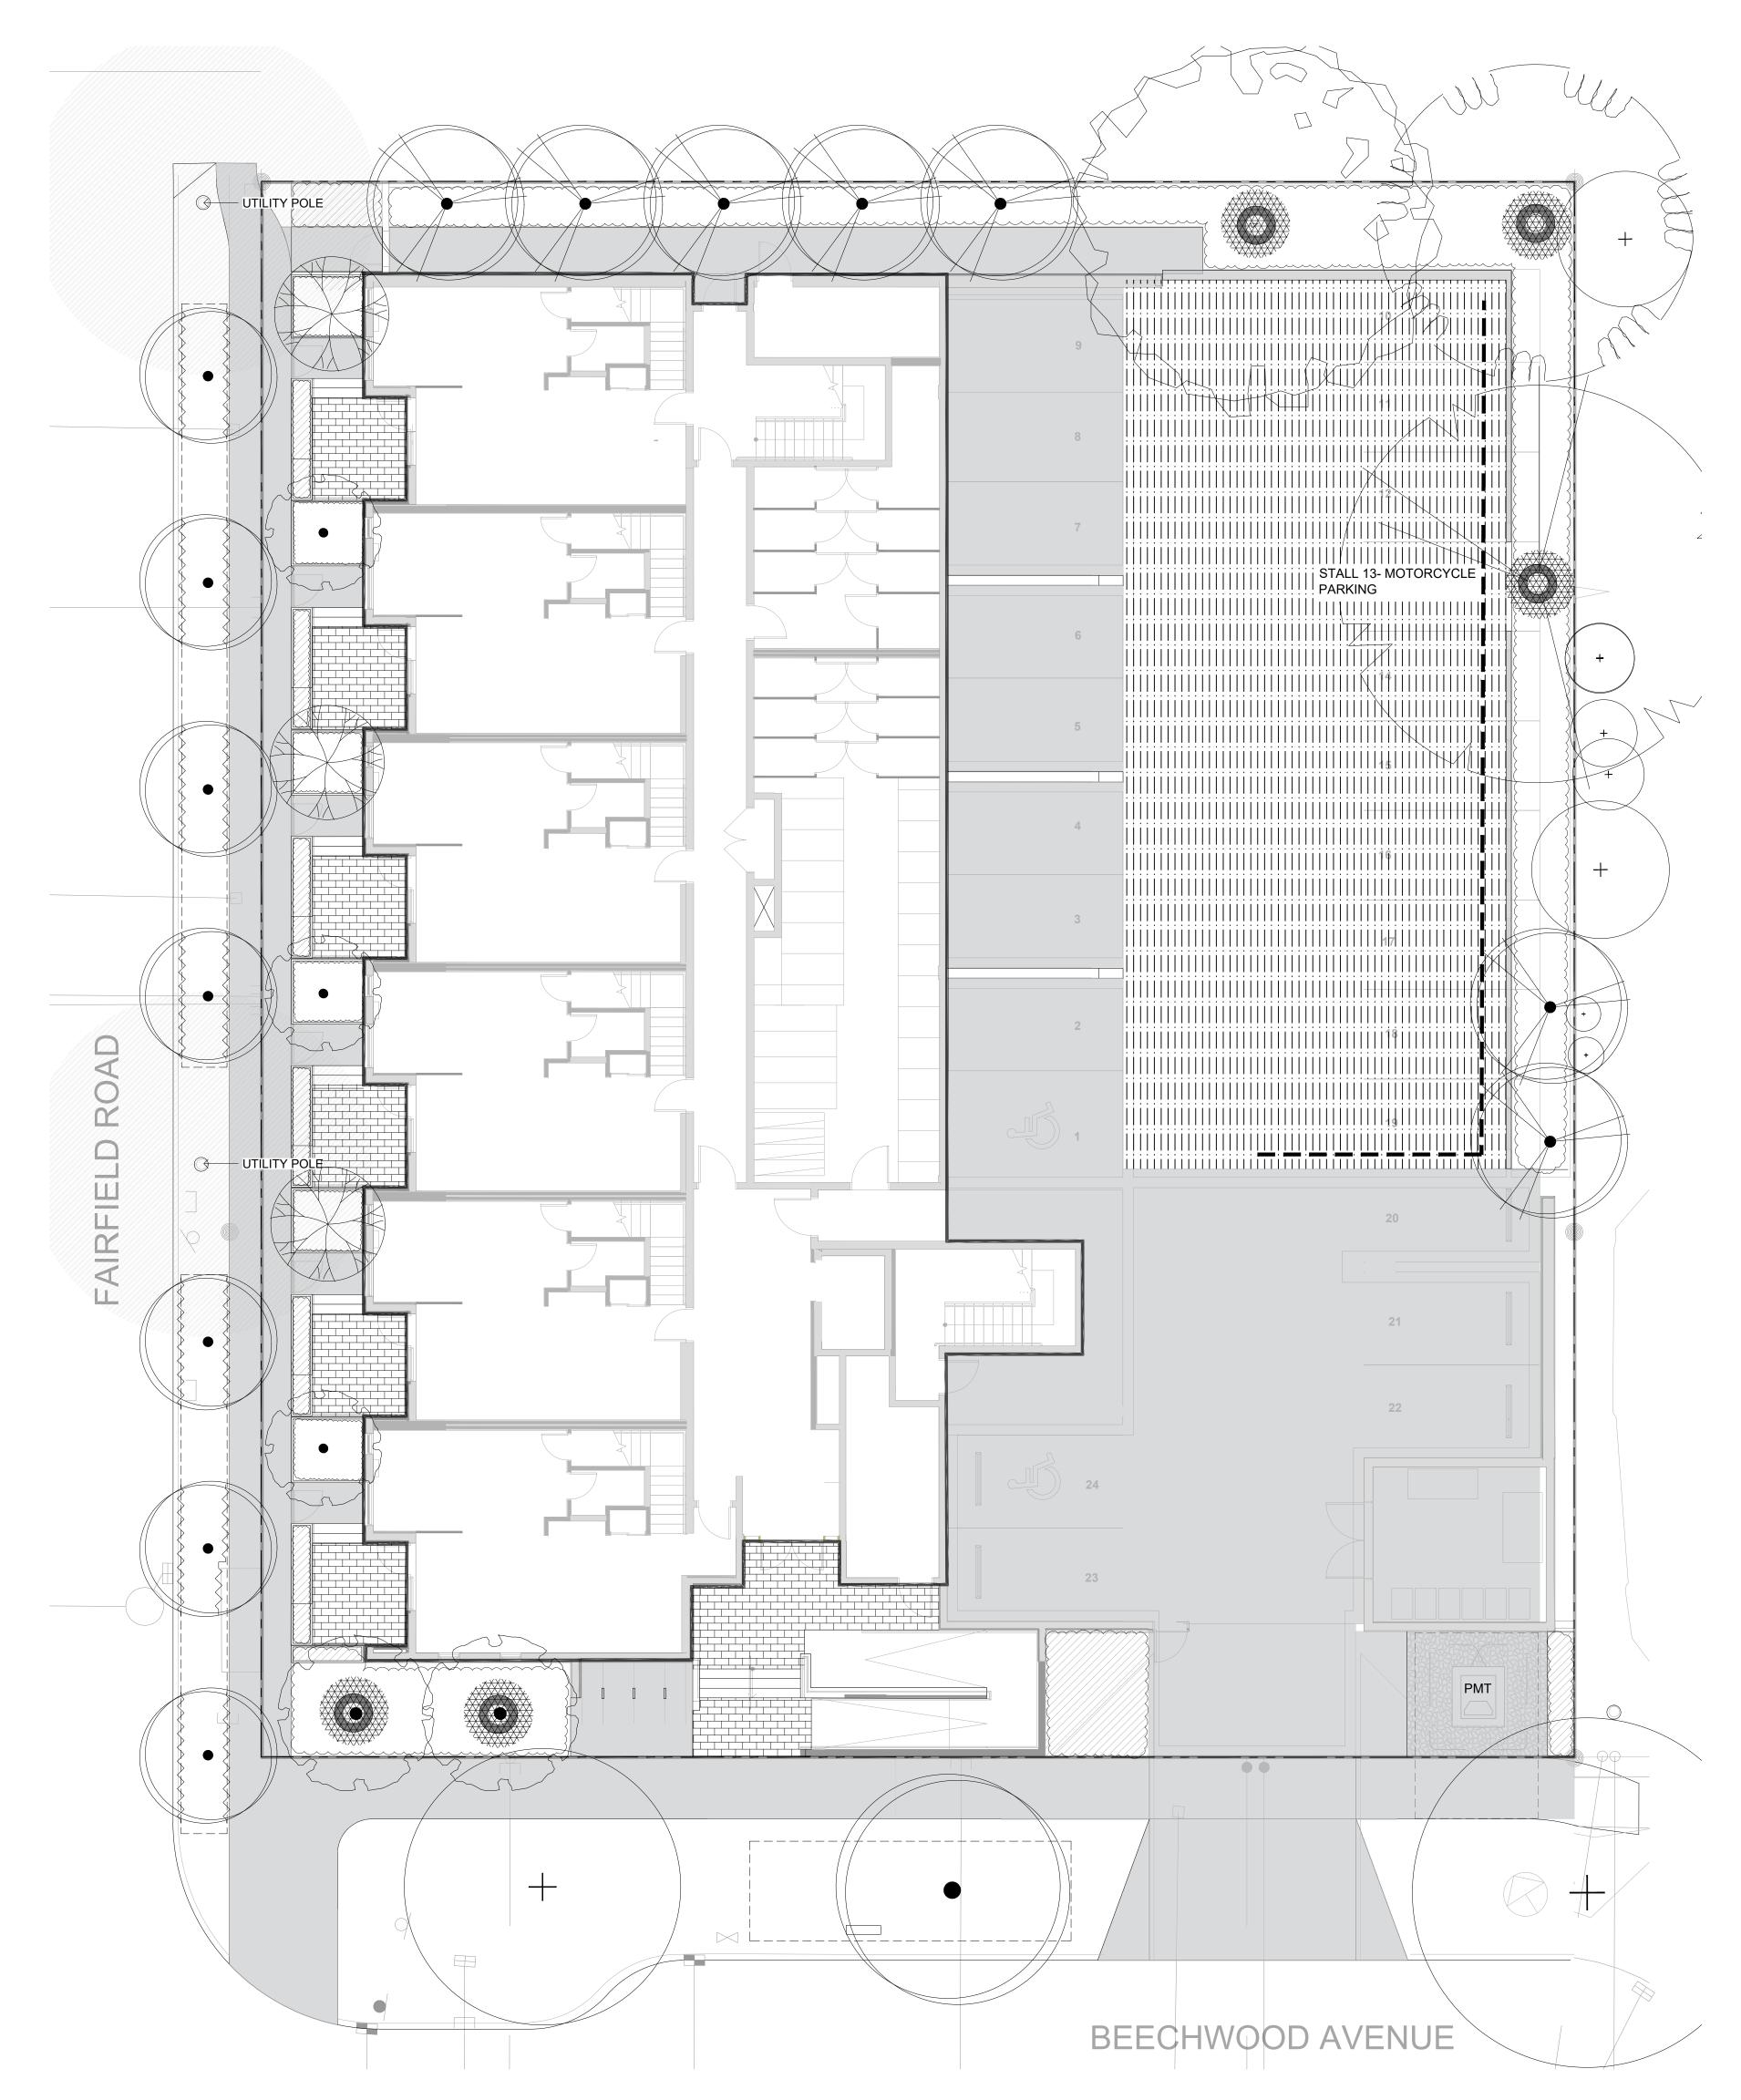



NORTH ARROW

DRAWING TITLE:

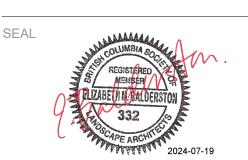SOIL VOLUME PLAN

DWG NO:



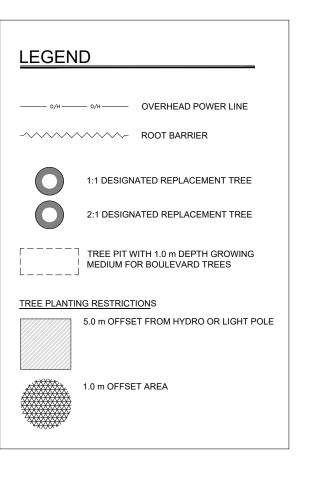

Quantity	Symbol	Latin Name	Common Name	Container	Caliper	Size	Native
5		Acer griseum	Paperbark Maple	B&B	6 cm	>2 m	
1	AM MAN MEN	Fraxinus americana 'Autumn Applause'	Autumn Applause white ash	B&B	6 cm	>2 m	
1	2	Liriodendron tulipifera	Tulip tree	B&B	6 cm	>2 m	
7		Parrotia persica 'Ruby Vase'	Ruby Vase Parrotia	B&B	6 cm	>2 m	
3		Styrax japonicus	Japanese snowbell	B&B	6 cm	>2 m	
1		Quercus palustris	Pin Oak	B&B	6 cm	>2 m	
8		BOULEVARD TREE TO BE DETERMINED BY PARKS AT BP		B&B	TBD		

TREE STATUS	TOTAL	TO BE RETAINED	TO BE REMOVED	REPLACEMENTS REQUIRED	MINIMUM REQUIRED FOR LOT SIZE	PROPOSED
ON-SITE TREES AND SHRUBS BYLAW PROTECTED	7	0	7	7	9	4
MUNICIPAL TREES	3	2	1	1		8
NEIGHBORING TREES, BYLAW PROTECTED	0	0	0	0		0

REPLACEMENT TREES TO BE PLANTED ON SITE	4	
REPLACEMENT TREE SHORTFALL	3	
TOTAL PROPOSED TREES ON SITE (REPLACEMENT (ACTUAL) + OTHER)	18	

NOTES:

- IRRIGATION SYSTEM ON CITY PROPERTY SHALL COMPLY TO CITY OF VICTORIA SUPPLEMENTARY SPECIFICATIONS FOR STREET TREES AND IRRIGATION SCHEDULE C, BYLAW 12-042, SUBDIVISION BYLAW.
 IRRIGATION DRAWINGS MUST BE SUBMITTED TO PARKS DIVISION FOR REVIEW AND APPROVAL 30 DAYS PRIOR TO INSTALLATION WORK. THE FOLLOWING IRRIGATION AND SLEEVING INSPECTIONS BY PARKS STAFF ARE REQUIRED BY SCHEDULE C.
- IRRIGATION INSPECTION REQUIREMENTS:
- a. THE IRRIGATION SYSTEM AND SLEEVING INSPECTION REQUIREMENTS CAN BE FOUND IN SCHEDULE C OF THE VICTORIA SUBDIVISION AND DEVELOPMENT SERVICING BYLAW NO. 12-042.
- b. IRRIGATION SLEEVING PRIOR TO BACKFILLING*
- c. OPEN TRENCH MAIN LINE AND PRESSURE TEST
- d. OPEN TRENCH LATERAL LINE
- e. IRRIGATION SYSTEM, CONTROLLER, COVERAGE TEST, BACKFLOW PREVENTER ASSEMBLY TEST REPORT REQUIRED, BACKFLOW ASSEMBLY IS TO HAVE AN INSPECTION TAG COMPLETED AND ATTACHED.
- 100MM SDR 28 PIPE WILL BE USED FOR IRRIGATION SLEEVING UNDER HARD SURFACES. INSTALLATIONS WHERE A 90-DEGREE BEND IS REQUIRED SHOULD BE INSTALLED USING 100MM SDR 28 GSX (22.5 DEGREE) LONG SWEEPS. INSTALL WILL BE AT 400MM DEPTH.



1608 Camosun Street, Victoria BC V8T 3E6 Info@biophiliacollective.ca 250 590 1156

OWNER/CLIENT:


ARYZE DEVELOPMENTS

PROJECT ADDRESS:

1733 FAIRFIELD, VICTORIA, BC

DESIGNED BY:BIANCA BODLEY DRAWN BY:TYLER YESTAL

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11	ISSUED FOR BUILDING PERMIT	2024/03/0
12	DP/RZ REV 6	2024/07/03

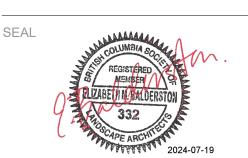

NORTH ARROW

DRAWING TITLE:

ACTUAL NUMBER: 5

2 x LARGE TREE (1:1)


1 x MEDIUM TREE (1:1)

2 x SMALL TREE (2:1)

TREE PLANTING PLAN

DWG NO:

L4.2

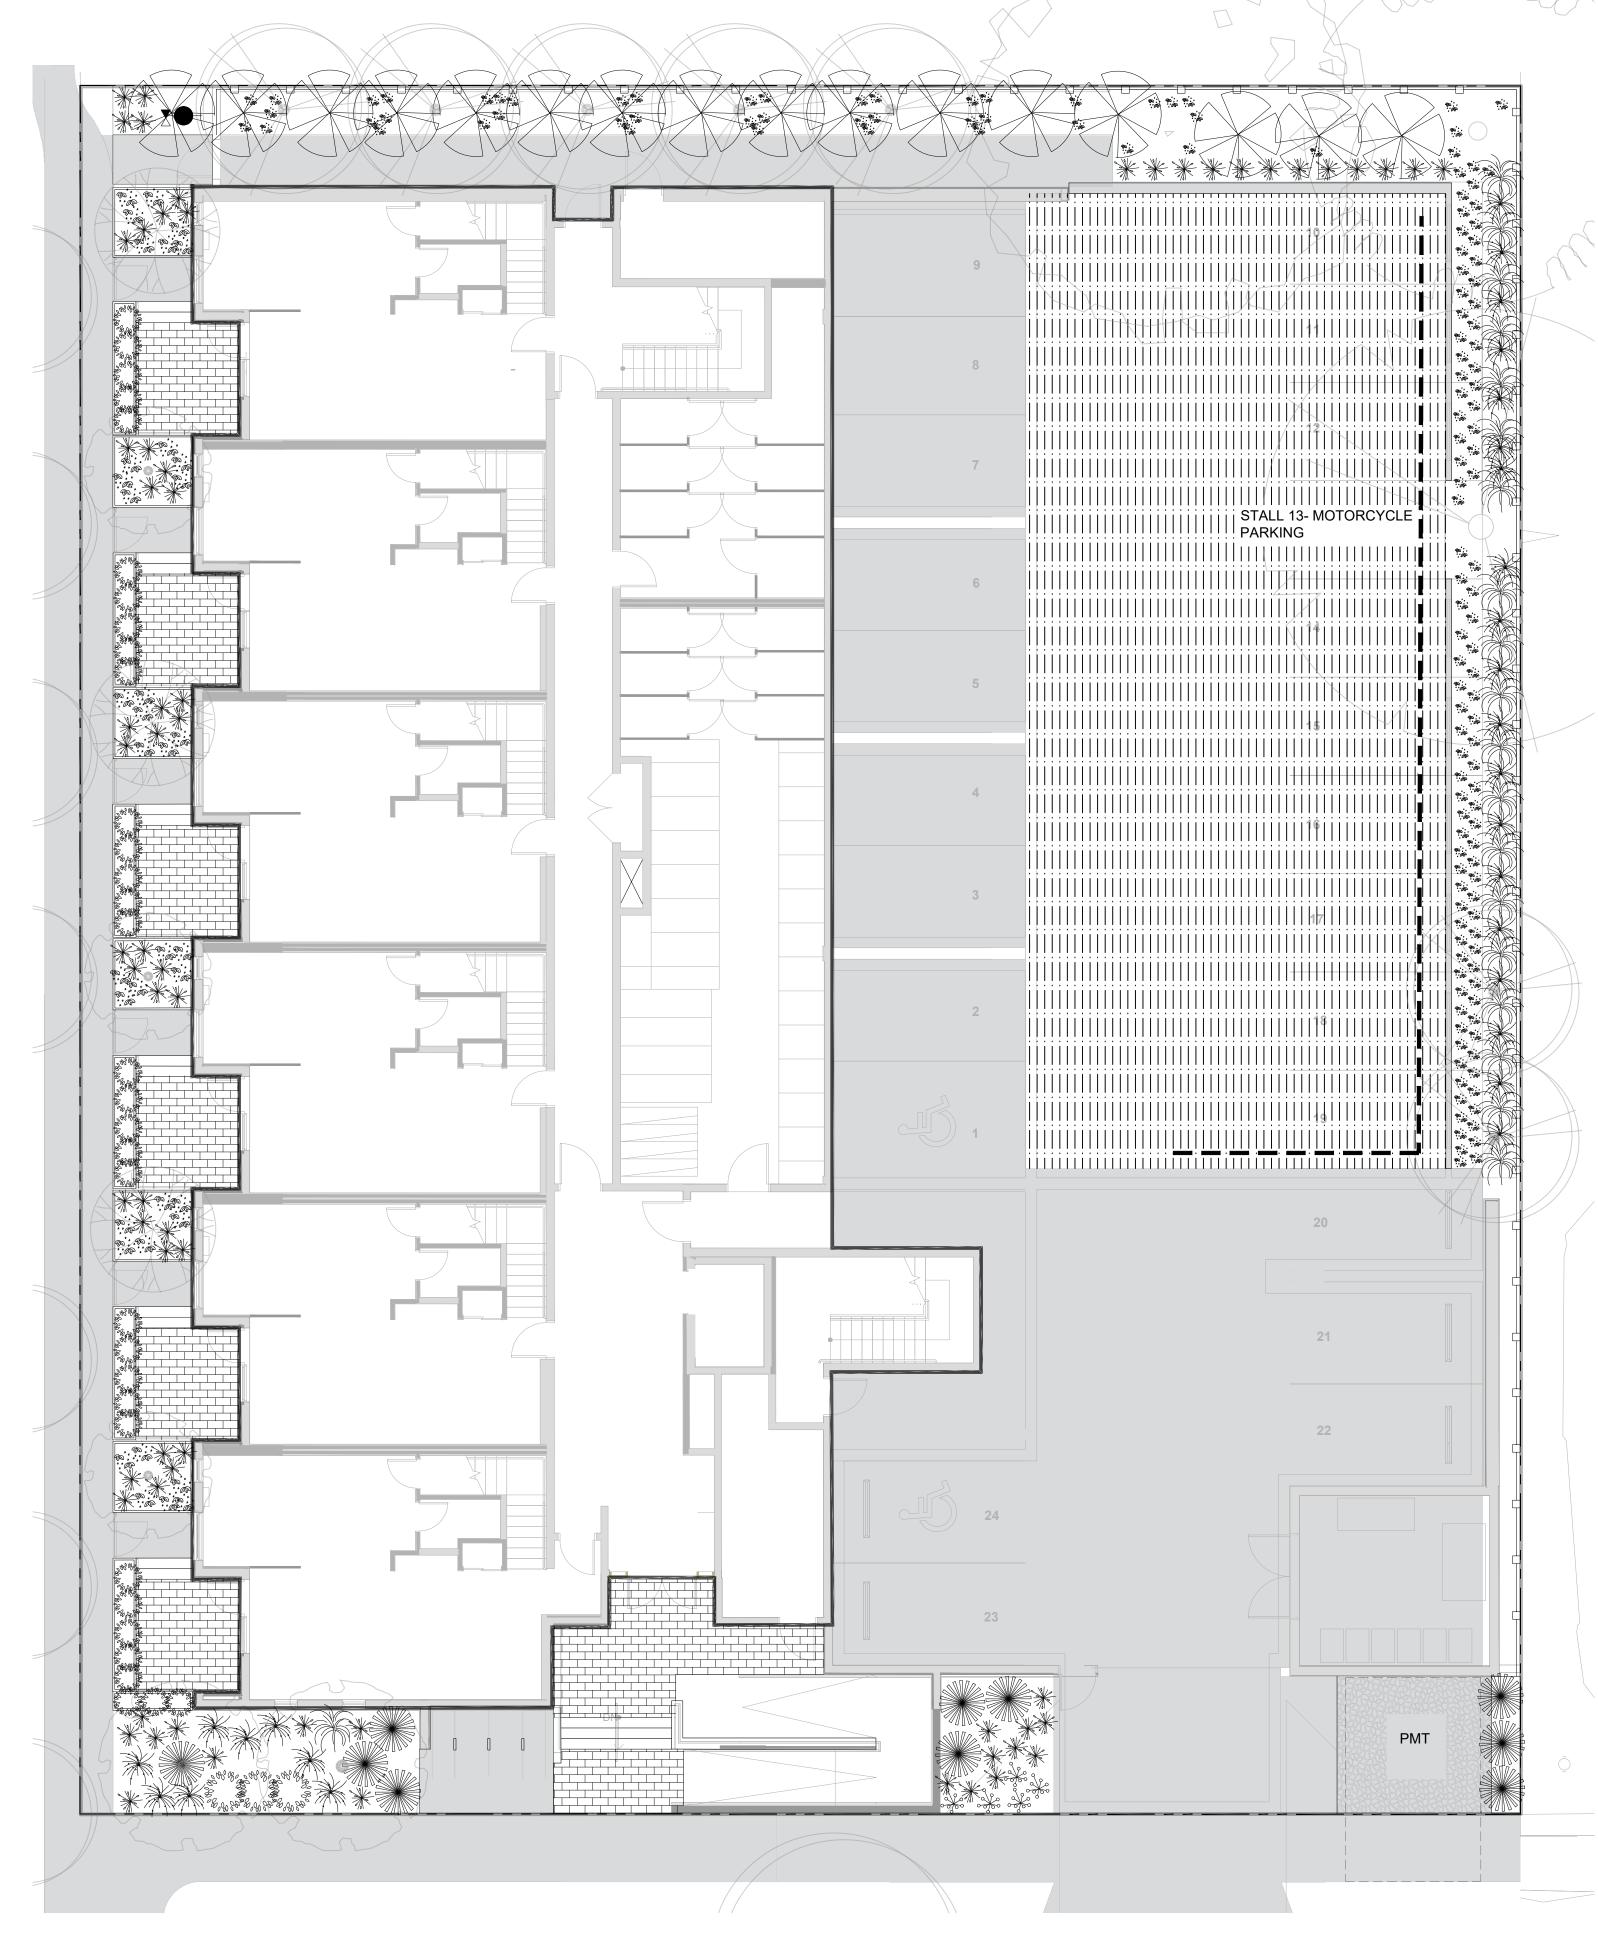

PLANT	SCHEDULE	<u> </u>				
Quantity	Symbol	Latin Name	Common Name	Container	Native	Pollinator
12		Armeria maritima 'Alba'	White-flowered Thrift	10cm		у
182	®::.	Arctostaphylos Uva-Ursi 'Massachusetts'	Kinnikinnick	10cm	у	у
69	*	Carex testacea 'Prairie Fire'	New Zealand hair sedge	#1		
10		Cephalotaxus harringtonia 'Prostrata'	Spreading Japanese plum yew	#2		
16		Choisya ternata	Mexican mock orange	#3		у
36	\$ \$ \$ \$ \$ \$ \$ \$ \$ \$ \$ \$ \$ \$ \$ \$ \$ \$ \$	Hebe pinguifolia 'Sutherlandii'	Hebe Sutherlandii	#1		
30	*	Miscanthus sinensis 'Huron Light'	Huron Light maiden grass	#1		
20		Miscanthus sinensis 'Morning Light'	Chinese silver grass Morning Light	#1		
5	%	Verbena bonariensis 'Lollipop'	Dwarf purpletop	#1		Y

1. PLANTS IN PLANT LISTS ARE SPECIFIED ACCORDING TO THE CANADIAN NURSERY LANDSCAPE ASSOCIATION CANADIAN STANDARDS FOR NURSERY STOCK AND SECTION 12, CONTAINER GROWN PLANTS FROM THE BC LANDSCAPE STANDARD, CURRENT EDITION.

'Lollipop'

PLANTING PLAN NOTES

- ALL PLANT MATERIAL TO BCSLA STANDARDS.
- 2. THE SEARCH ARE FOR PLANT MATERIAL IS THE PACIFIC NORTHWEST INCLUDING WASHINGTON, OREGON AND BRITISH COLUMBIA.
- 3. CONFIRM PLANTING LAYOUT WITH LANDSCAPE ARCHITECT ON SITE.
- 4. ALL SOIL VOLUMES TO MEET THE STANDARDS OF THE CITY OF VICTORIA. REFER TO SOIL DEPTH PLANS FOR SOIL DEPTH REQUIREMENTS.
- 5. ALL GROWING MEDIUM PROVISION AND INSTALLATION TO BE IN LINE WITH CANADIAN LANDSCAPE STANDARDS
- 6. REFER TO CIVIL AND MECHANICAL FOR DRAINS.
- 7. ALL ONSITE AND OFF-SITE LANDSCAPE AREAS TO BE IRRIGATED BY AN UNDERGROUND AUTOMATIC IRRIGATION SYSTEM. IRRIGATION TO BE SUPPLIED BY CONTRACTOR
- 8. PLANTING AROUND EXISTING CRITICAL TREE ROOT ZONES TO BE INSTALLED UNDER THE SUPERVISION OF A CERTIFIED ARBORIST.





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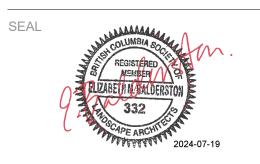
ARYZE DEVELOPMENTS

PROJECT ADDRESS:

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DESIGNED BY:BIANCA BODLEY DRAWN BY:TYLER YESTAL

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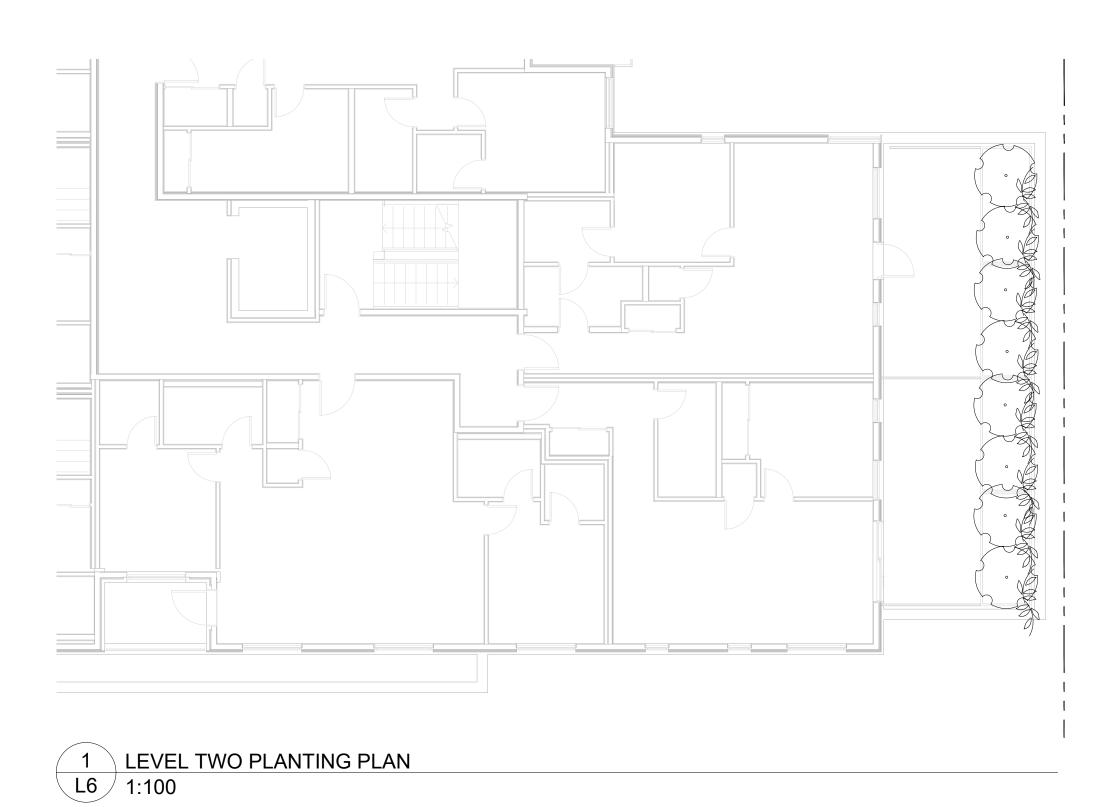
SHRUB PLANTING PLAN
LEVEL 1


DWG NO:

L4.3


1 GROUND FLOOR PLANTING PLAN

L3 1:100



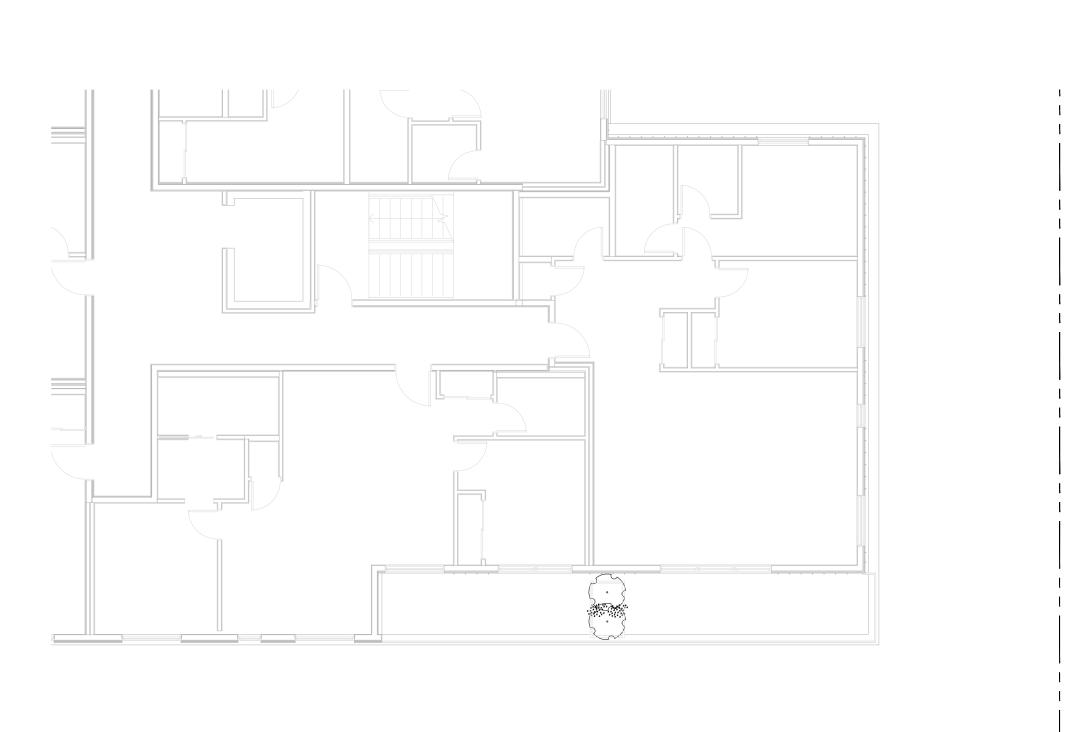

2 LEVEL THREE PLANTING PLAN L6 1:100

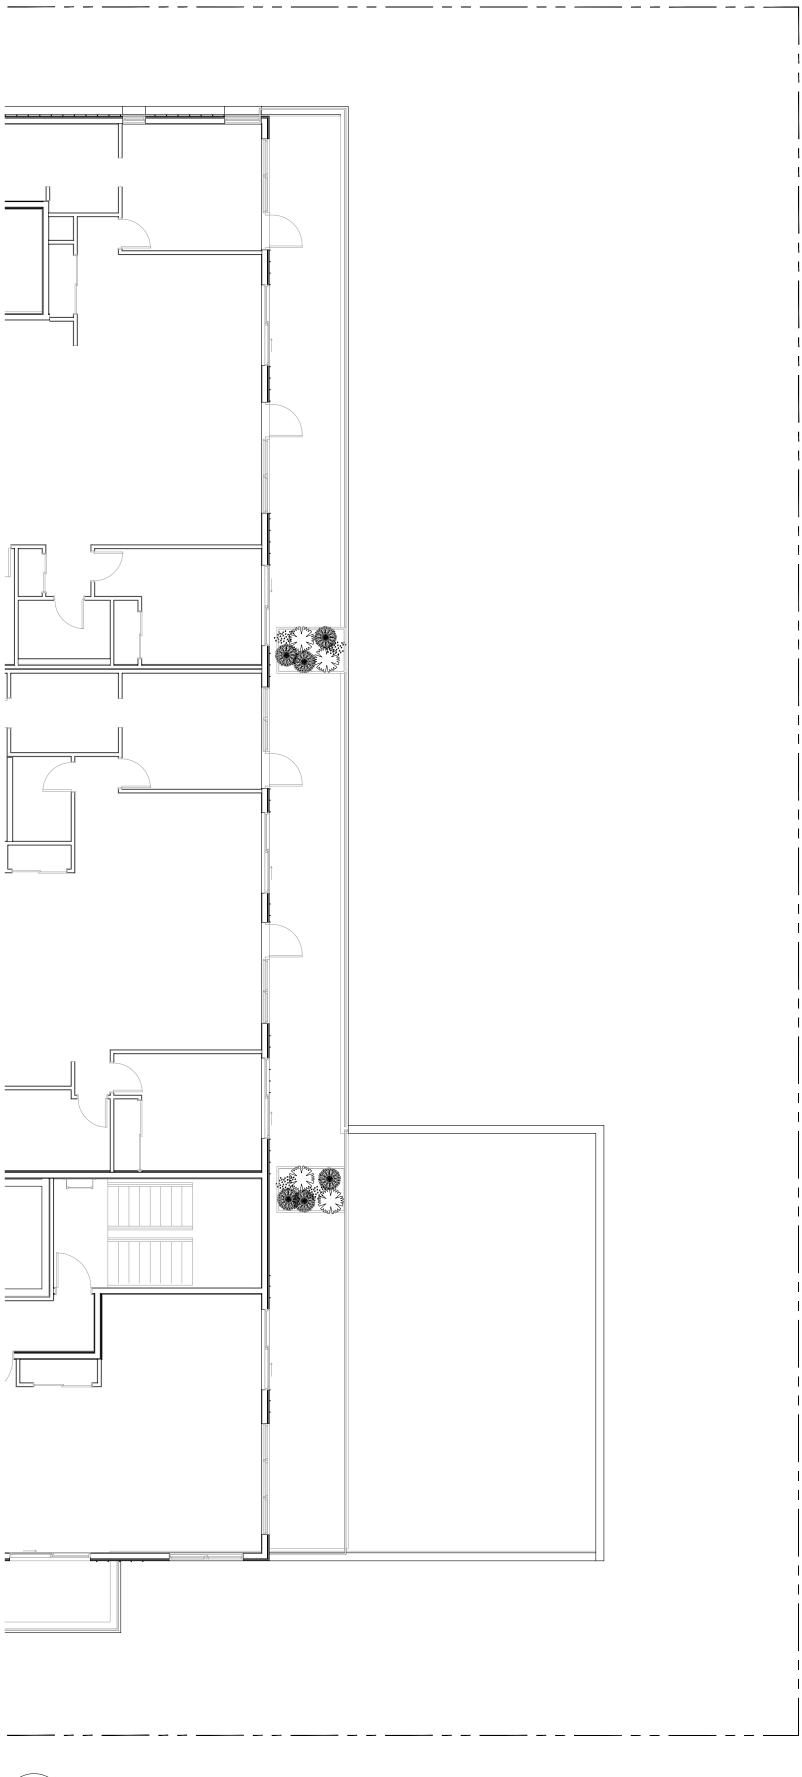

3	LEVEL FOUR PLANTING PLAN
L6	1:100

PLANT S	PLANT SCHEDULE					
Quantity	Quantity Symbol Latin Name		Common Name	Container	Native	Pollinator
6	6 Armeria maritima 'Alba' White-flowered Thrift 1 10 Choisya ternata Mexican Orange Blossom Pinus strobus 'Horsford Dwarf' Eastern white pine		10cm		у	
10				#3		у
6				#2		
4	an my	Rhododendron x	Bloom-A-Thon® White Reblooming Azalea	#1		у
8	JURG	Parthenocussus quinquefolia	Virginia Creeper	#2		

1. PLANTS IN PLANT LISTS ARE SPECIFIED ACCORDING TO THE CANADIAN NURSERY LANDSCAPE ASSOCIATION CANADIAN STANDARDS FOR NURSERY STOCK AND SECTION 12, CONTAINER GROWN PLANTS FROM THE BC LANDSCAPE STANDARD, CURRENT EDITION.

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STANDARDS

6. REFER TO CIVIL AND MECHANICAL FOR DRAINS.
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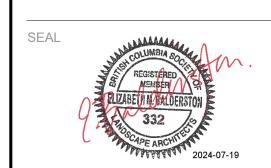
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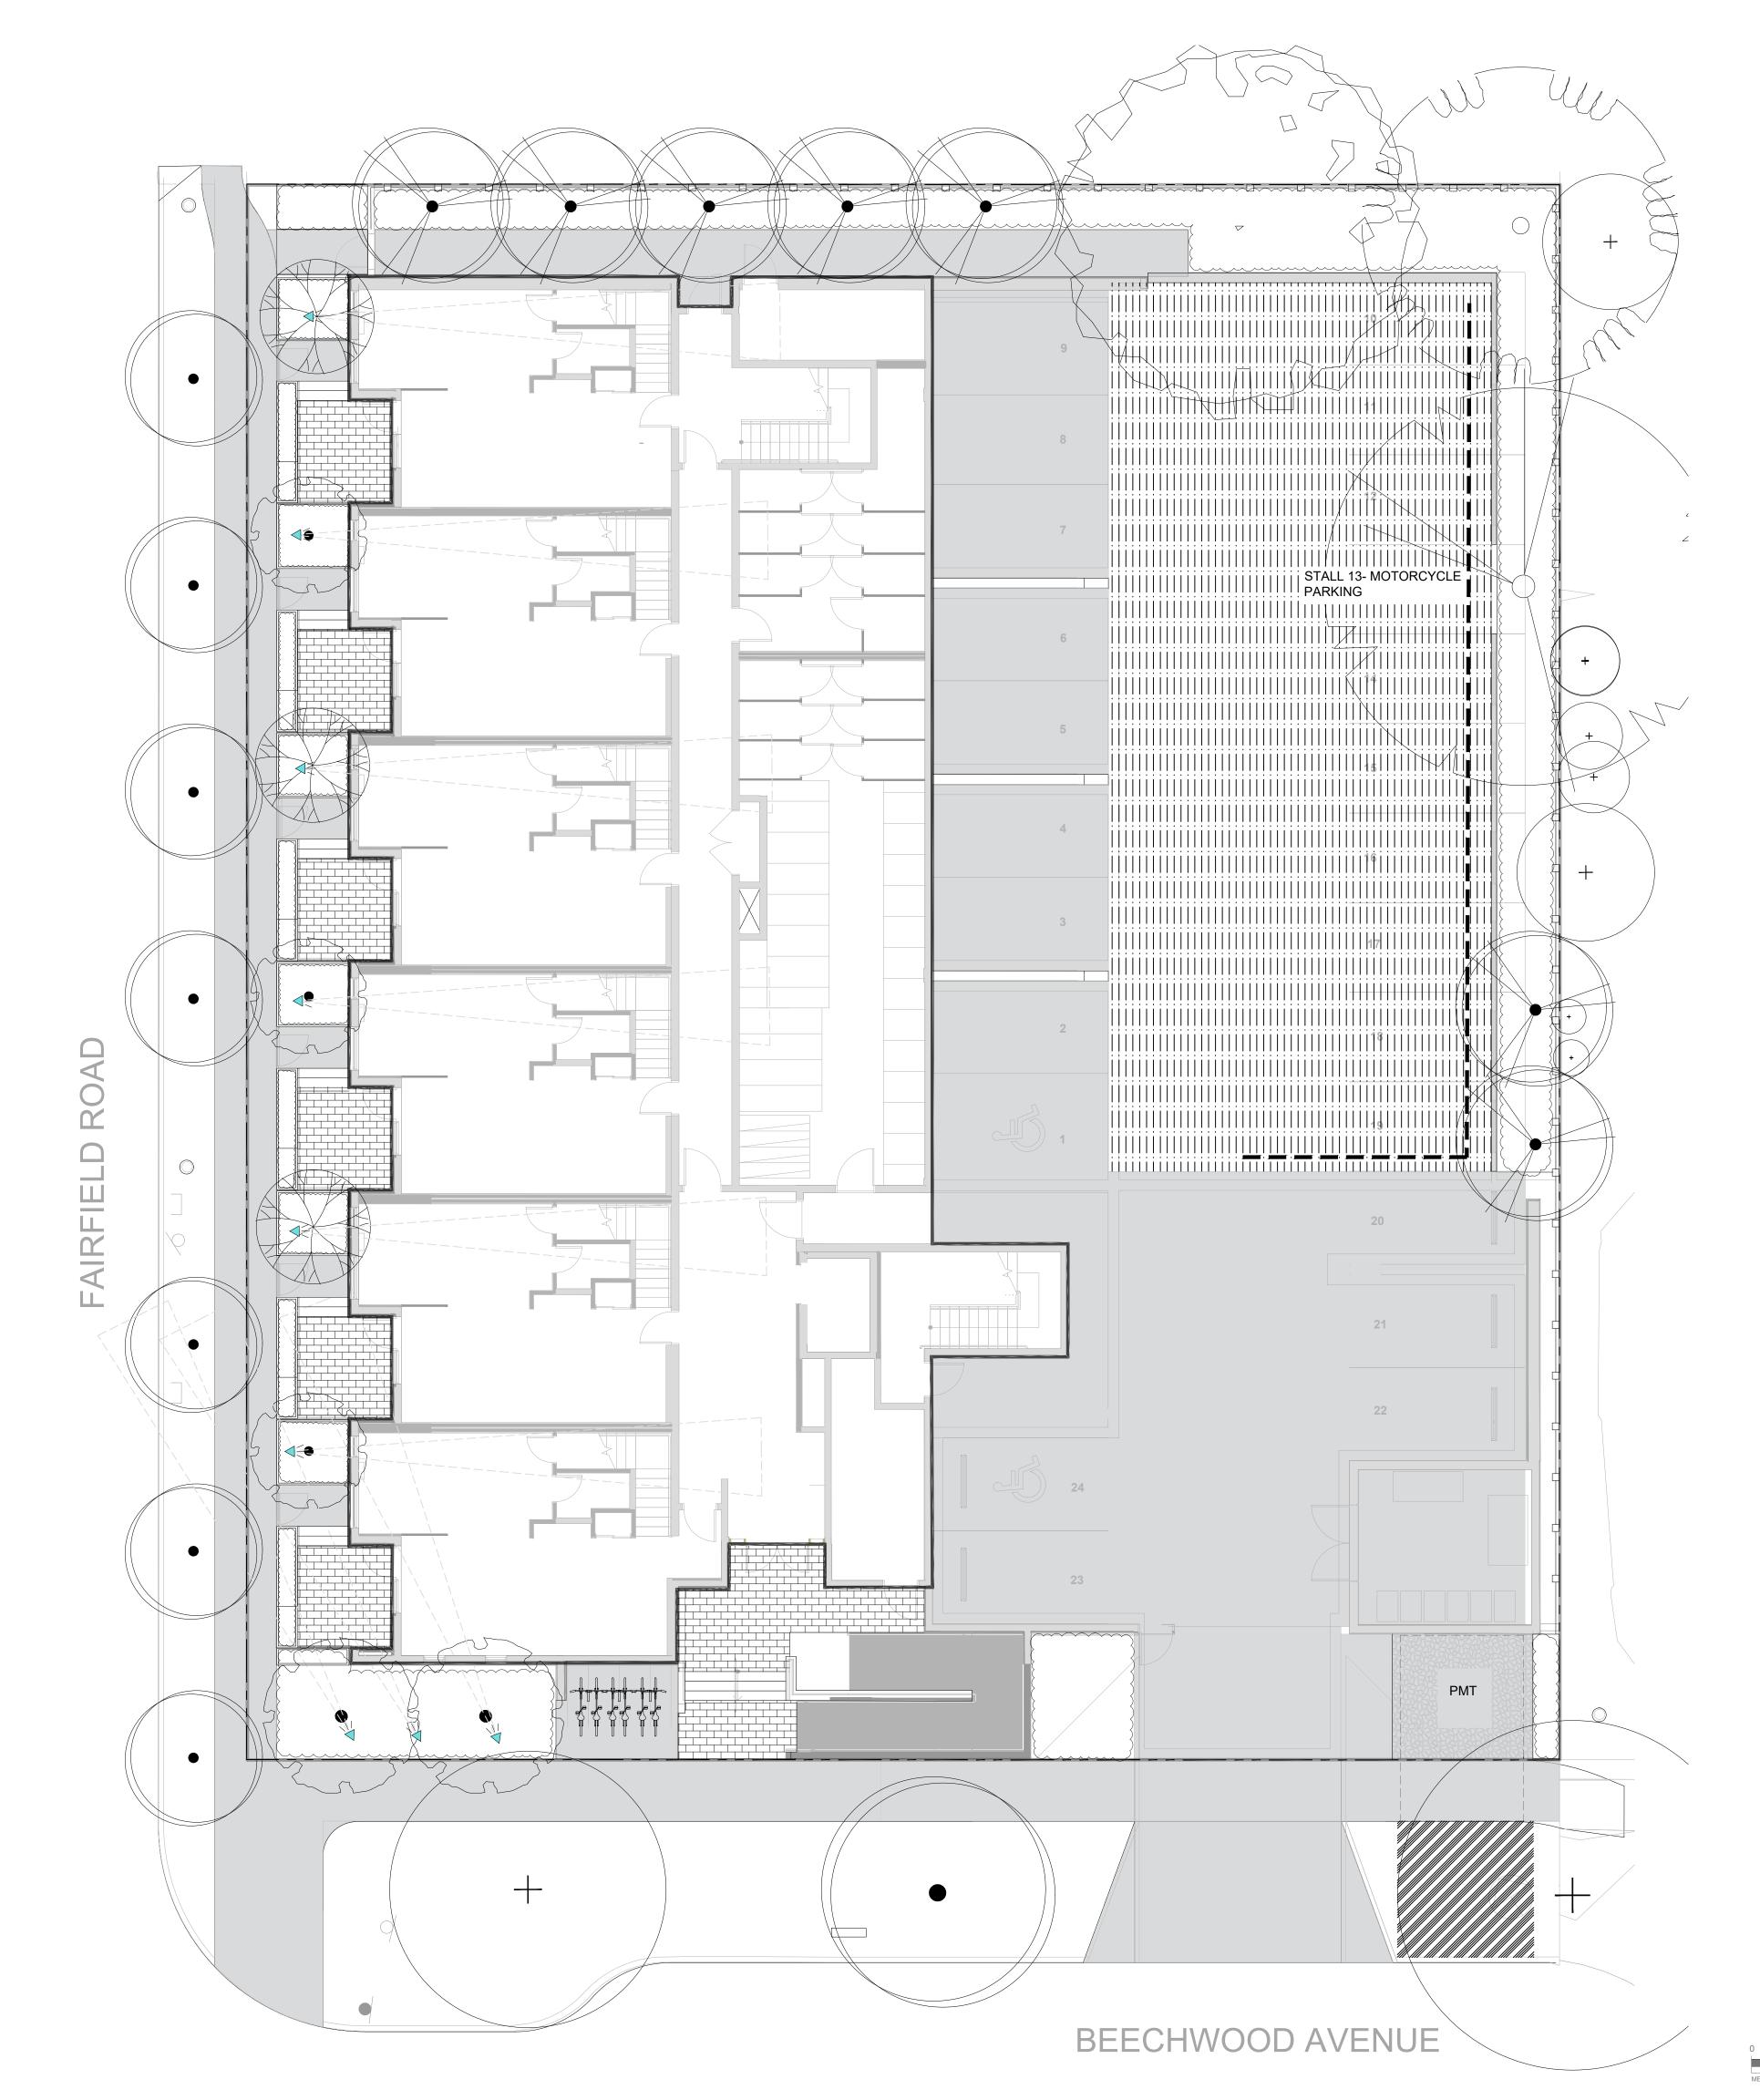
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NORTH ARROW

DRAWING TITLE:

SHRUB PLANTING PLAN LEVELS 2, 3, & 4



LIGHTING SCHEDULE

SYMBOL

MANUFACTURER/MODEL/DESCRIPTION

QTY DETAIL

9

WAC Landscape Lighting 5111
LED Accent Mini Landscape Spotlight
Order code: 5111, Aluminum Alloy, (BK) Black on Aluminum, Mounting

Lamp: 5111 Integrated LED, 18W|23VA, 2700K, Beamspread: Narrow Accessories: Additional Mounting Stake



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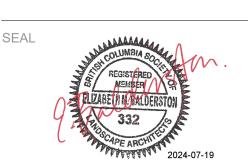
ARYZE DEVELOPMENTS

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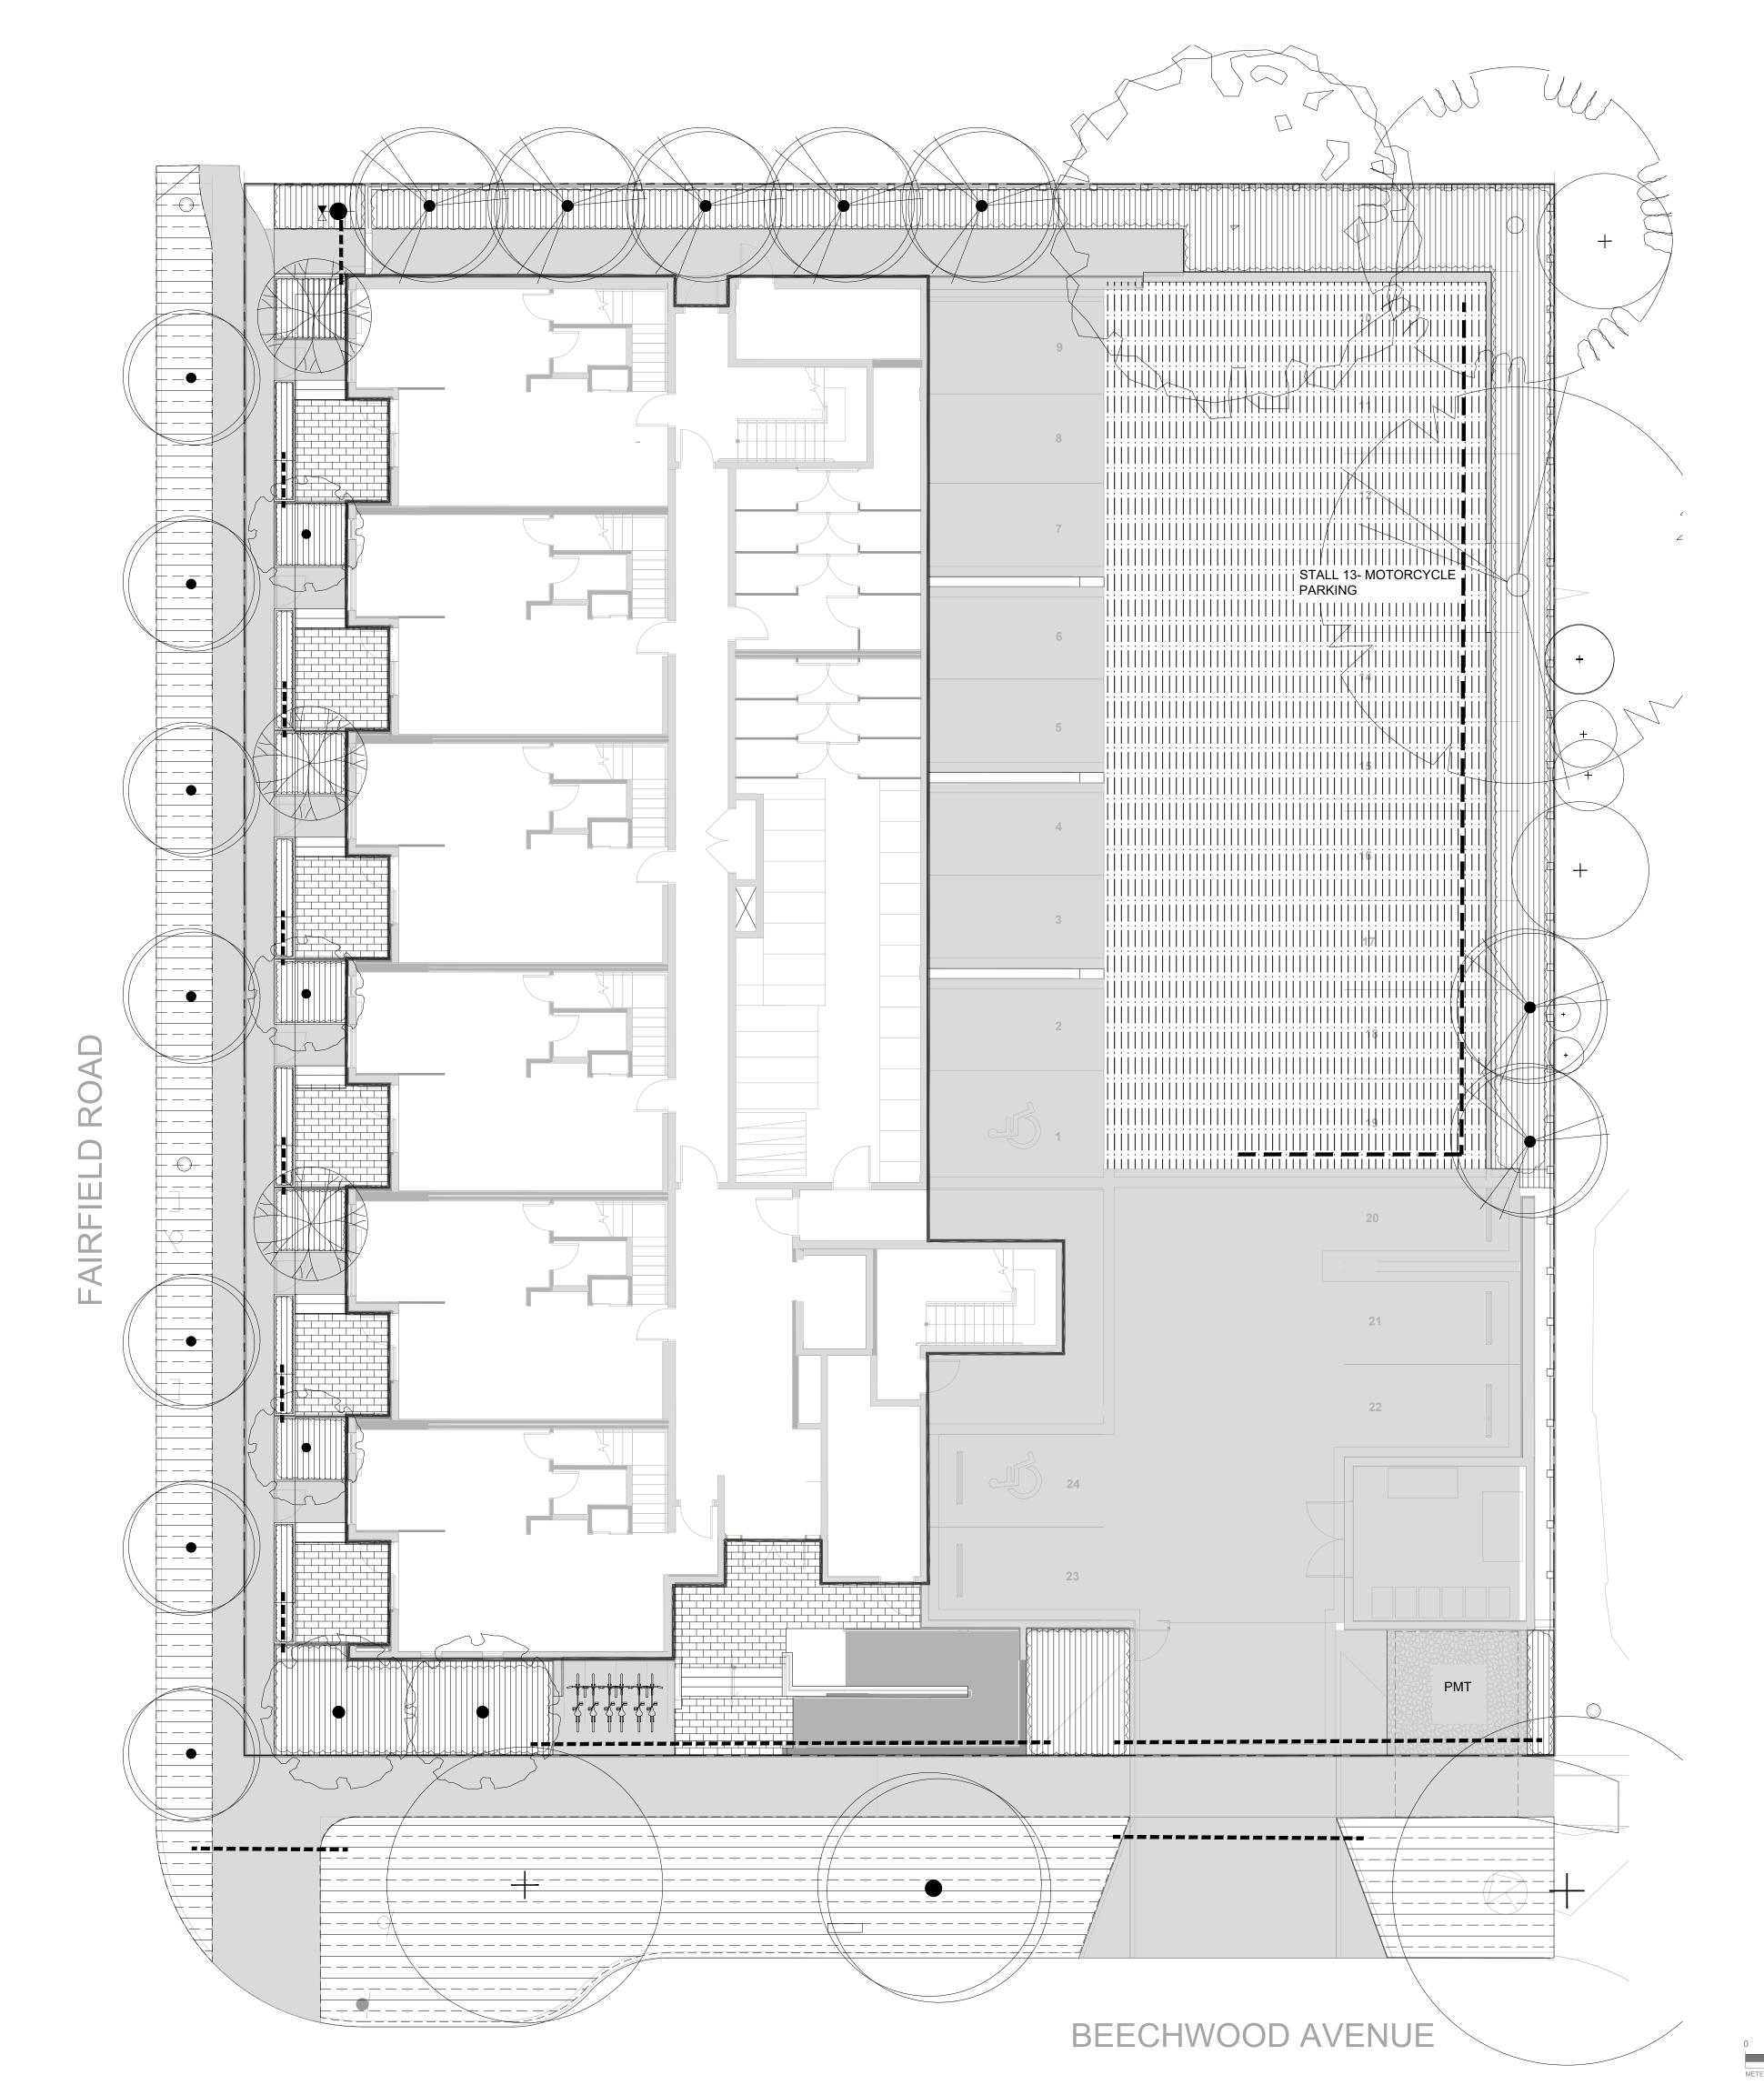
NORTH ARROW

DRAWING TITLE:

LANDSCAPE LIGHTING PLAN
LEVEL 1

DWG NO:

L5.





THE SIZE OF THE INTERIOR PIPE OF MIN.

HOSE BIB

SHUT OFF VALVE

2" PVC POINT OF CONNECTION

AREA TO RECEIVE DRIPLINE- RAIN BIRD
XFS-CV-09-12 SUB-SURFACE LANDSCAPE
DRIPLINE WITH A HEAVY-DUTY .3 BAR
CHECK VALVE. 3.41 LPH EMITTERS AT 30CM
O.C. DRIPLINE LATERALS SPACED AT 30CM
APART, WITH EMITTERS OFFSET FOR
TRIANGULAR PATTERMN. SPECIFY XF INSERT
FITTINGS



TREES IN THIS AREA TO RECEIVE ROTOR IRRIGATION

NOTES

- IRRIGATION PLANS TO BE UPDATED PRIOR TO IFC.
- OFFSITE TREES TO BE IRRIGATED BY SEPARATE IRRIGATION SYSTEM.

- ALL OFFSITE IRRIGATION TO FOLLOW THE CITY OF VICTORIA STANDARDS

- IRRIGATION DRIPLINE TO BE INSTALLED SUB-SURFACE

AND SLEEVED UNDER METAL PLANTERS
REFER TO MECHANICAL FOR HOSEBIB LOCATIONS



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OWNER/CLIENT:

ARYZE DEVELOPMENTS

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NORTH ARROW

DRAWING TITLE:


IRRIGATED AREAS PLAN LEVEL 1

DWG NO:


L6.

10 SCA




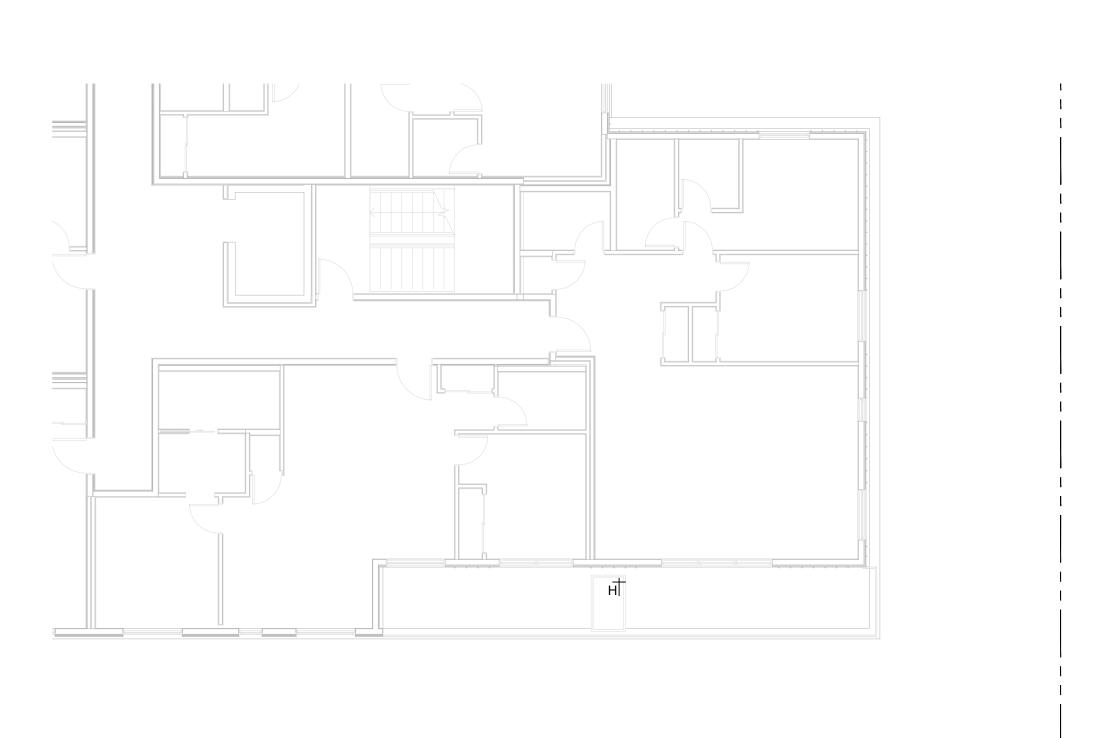



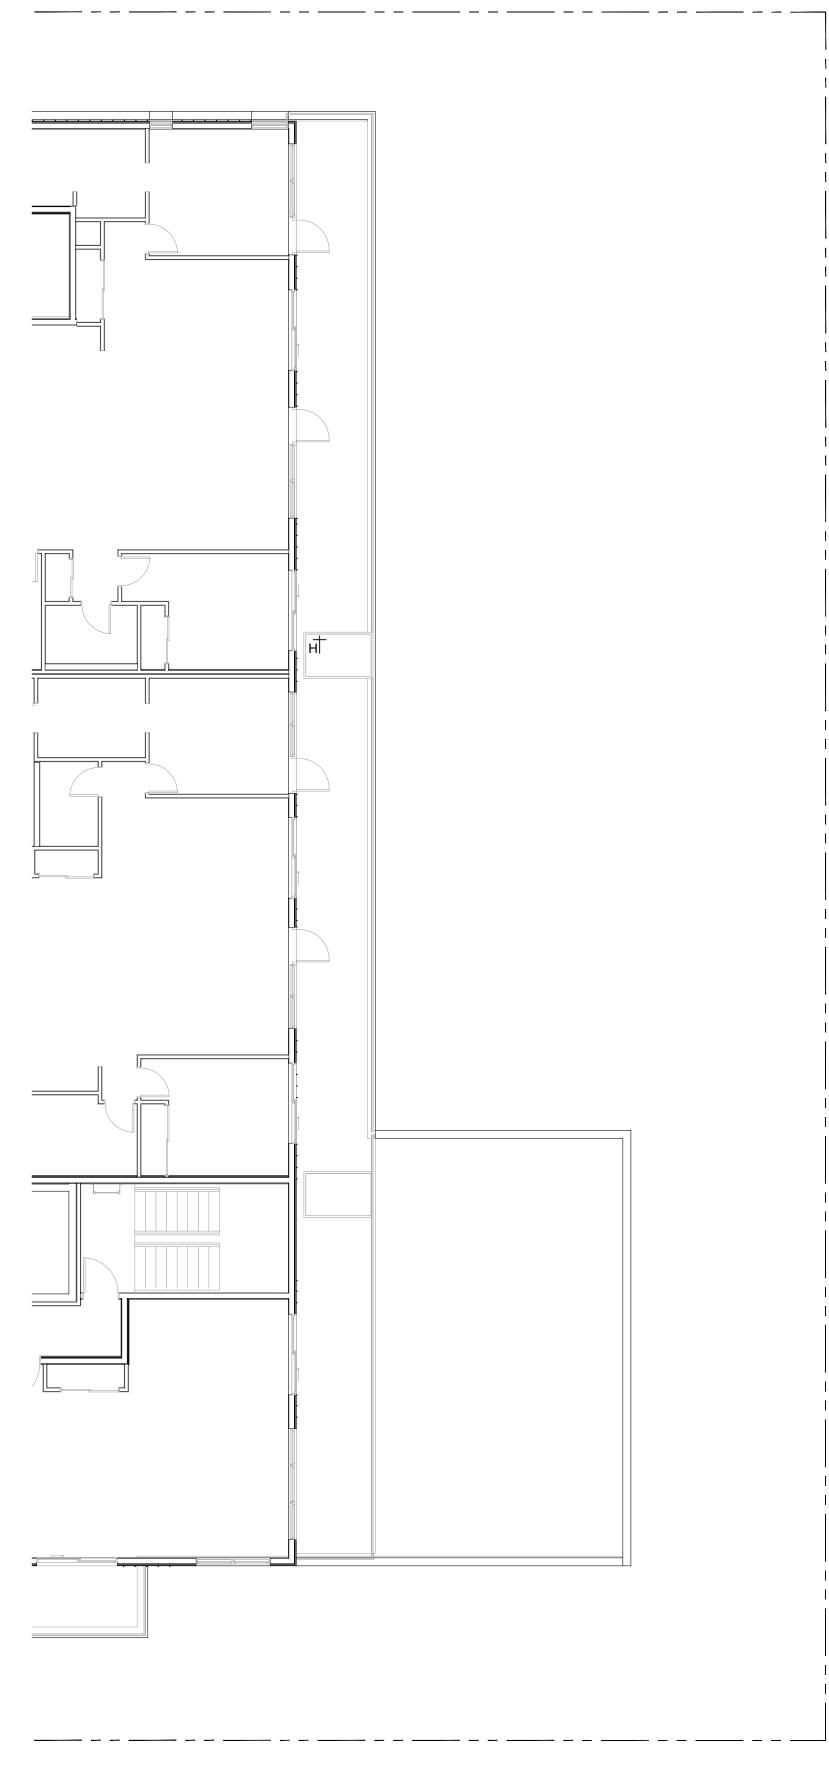


3 LEVEL FOUR IRRIGATION PLAN L6.2 1:100

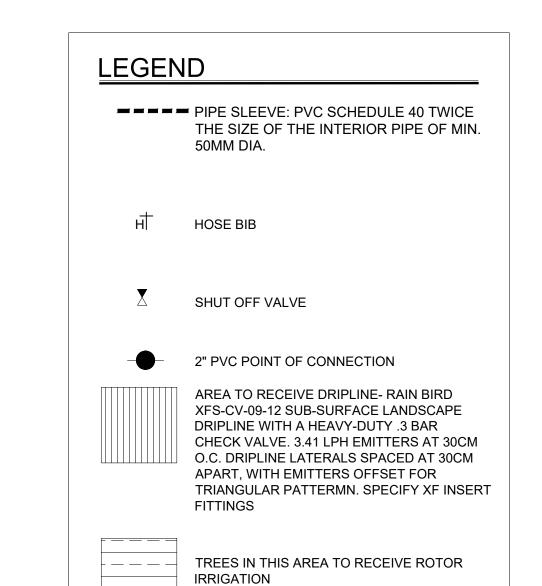

NOTES

_ _ _ _

- IRRIGATION PLANS TO BE UPDATED PRIOR TO IFC.
 OFFSITE TREES TO BE IRRIGATED BY SEPARATE IRRIGATION SYSTEM.
 ALL OFFSITE IRRIGATION TO FOLLOW THE CITY OF VICTORIA STANDARDS
- IRRIGATION DRIPLINE TO BE INSTALLED SUB-SURFACE AND SLEEVED UNDER METAL PLANTERS REFER TO MECHANICAL FOR HOSEBIB LOCATIONS

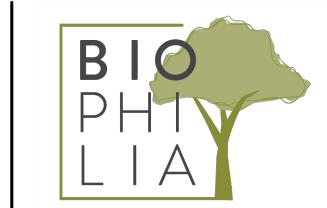

1608 Camosun Street, Victoria BC V8T 3E6 Info@biophiliacollective.ca 250 590 1156

OWNER/CLIENT:


ARYZE DEVELOPMENTS

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NORTH ARROW


DRAWING TITLE:

IRRIGATED AREAS PLAN LEVELS 2, 3, & 4


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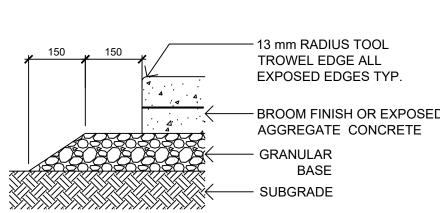
L6

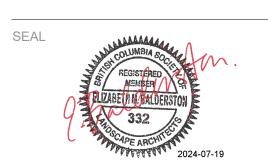SCALE: AS NOTED

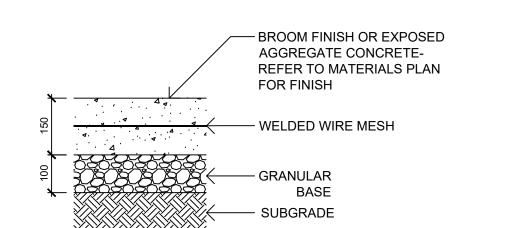


- SUBGRADE AND GRANULAR BASE TO BE
- COMPACTED TO MIN. 95% MPD. CONCRETE SIDEWALK TO MMCD/MUNICIPAL SPECIFICATIONS
- WELDED WIRE REINFORCEMENT MESH TO BE 6 X 6 X W2.9 X W2.9 (152 x 152 MW18.7/18.7) AND TO BE INSTALLED PER NRC NBC AND CAC
- STANDARDS. MIN 50 mm COVER ABOVE AND BELOW MESH.



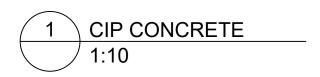

 EXTEND GRANULAR BASE 300 mm PAST EDGE OF SIDEWALK




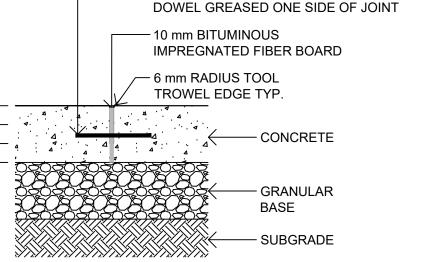

10 mm DIA X 200 mm LONG SMOOTH BAR

- BAR DOWELS @ 450 mm O.C. AND STARTING 300 mm FROM OUTSIDE EDGE OF CONCRETE - CENTER IN CONCRETE SLAB (MIN. 50 mm COVER)
- ISOLATION JOINT MAXIMUM SPACING 9.0 m JOINTING AS PER LAYOUT PLAN AND AT ALL ABUTTING CONCRETE STRUCTURES



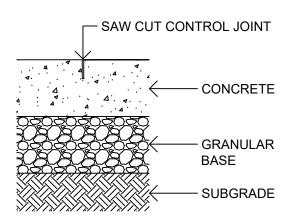


• JOINT DEPTH 1/3 SLAB THICKNESS

REFER TO PAVER MANUFACTURER FOR

INSTALLATION

 CONTROL JOINT MAXIMUM SPACING 3.0 m JOINTING PATTERN AS PER LAYOUT PLAN



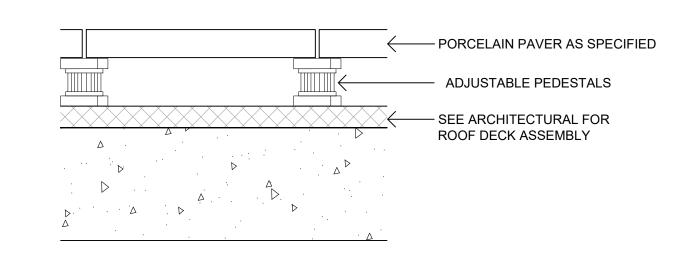


- PRIOR TO INSTALLATION, CONTRACTOR TO CONFIRM WITH ARCHITECTURAL / MEMBRANE CONSULTANT IF PROTECTION BOARD IS REQUIRED FOR PAVER PEDESTAL INSTALLATION; IF PROTECTION BOARD IS REQUIRED AND HAS NOT BEEN INSTALLED BY ARCHITECTURAL, CONTRACTOR TO NOTIFY GENERAL CONTRACTOR.
- ADJUSTABLE PEDESTALS TO BE BlackJack OneStep or BlackJack ScrewJack PEDESTALS AS REQUIRED OR APPROVED EQUAL.
- INSTALLATION TO MANUFACTURER'S SPECIFICATIONS.

Available At


View Gallery


5 \ PORCELAIN PAVER ON PEDESTAL

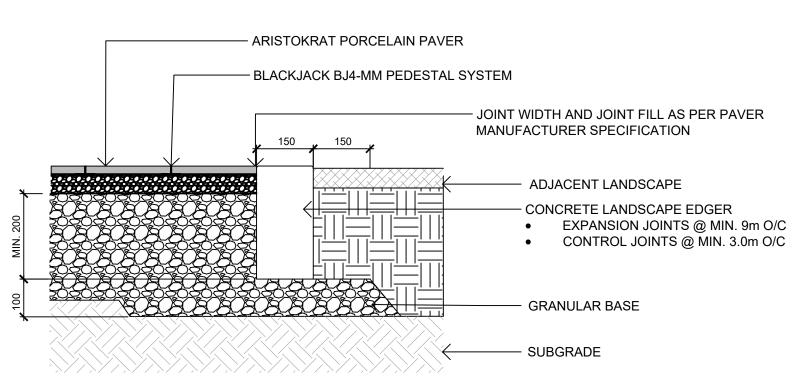

- SUBGRADE AND GRANULAR BASE TO BE COMPACTED TO MIN.
- 95% MPD. CONCRETE TO MMCD SPECIFICATION UNLESS NOTED OTHERWISE.



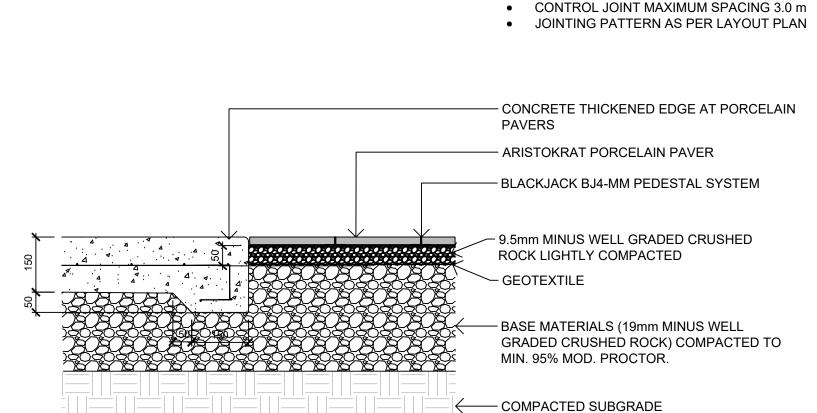

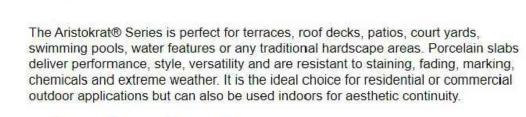

Aristokrat® Series








COLORS







GRANITE

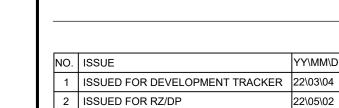

8 ISSUED FOR RZ/ DP REV 6

DESIGNED BY: BIANCA BODLEY

DRAWN BY: TYLER YESTAL

ISSUED FOR COORDINATION 22\07\18 4 ISSUED FOR RZ/ DP 22\07\20 5 ISSUED FOR RZ/ DP RESUBMISSION 23\01\24 6 ISSUED FOR RZ/ DP RESUBMISSION 7 25% BUILDING PERMIT 2023\10\10 8 ISSUED FOR RZ/ DP REV 5 2024\02\21

1608 Camosun Street, Victoria BC V8T 3E6

Info@biophiliacollective.ca 250 590 1156

ARYZE DEVELOPMENTS

OWNER/CLIENT:

PROJECT ADDRESS:

1733 FAIRFIELD


VICTORIA, BC


NEWSTONE

Dorado Drain Paver

■ 7393 HOPCOTT ROAD, DELTA, BC V4G 187 | 604-332-4030

PAVER 1

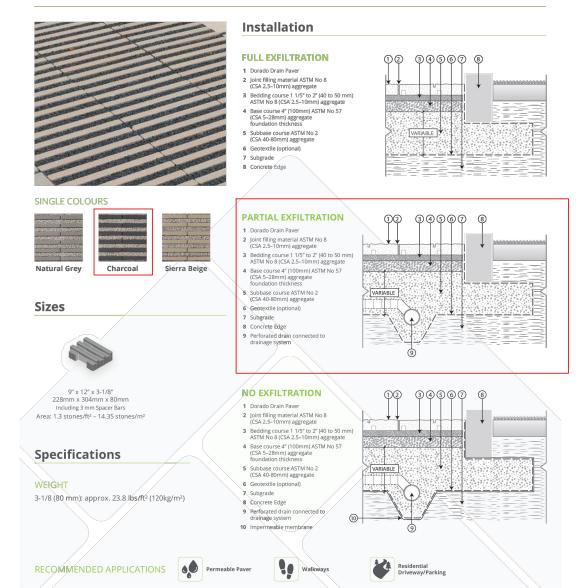


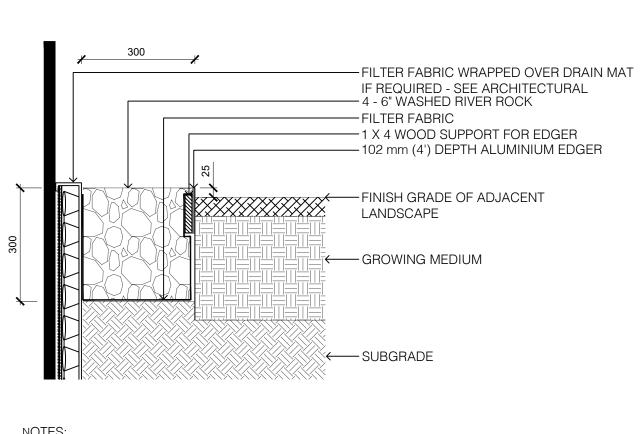

NEWSTONEGROUP.CA

- LANDSCAPE EDGER TO BE: PERMALOC CleanLine Commercial Grade Landscape Edging OR APPROVED EQUAL 4.8mm (3/16") THICKNESS; 102mm (4") HEIGHT; 4.8m (16') LENGTH; NATURAL MILL FINISH; 305mm (12") STAKE.
- INSTALL EDGER AS PER MANUFACTURER'S INSTRUCTIONS
- 1 X 4 WOOD SUPPORT TO BE STAKED IN PLACE AND USED TO ENSURE EDGER IS INSTALLED IN A STRAIGHT LINE AND MAINTAINS A STRAIGHT ALIGNMENT DURING THE INSTALLATION OF GROWING MEDIUM AND RIVER ROCK. MAY BE SCRAP WOOD AS LONG AS IT IS STRAIGHT.
- FILTER FABRIC TO BE POLYPROPYLENE FIBRE NONWOVEN GEOTEXTILE, SUCH AS NILEX 4551 OR APPROVED EQUAL



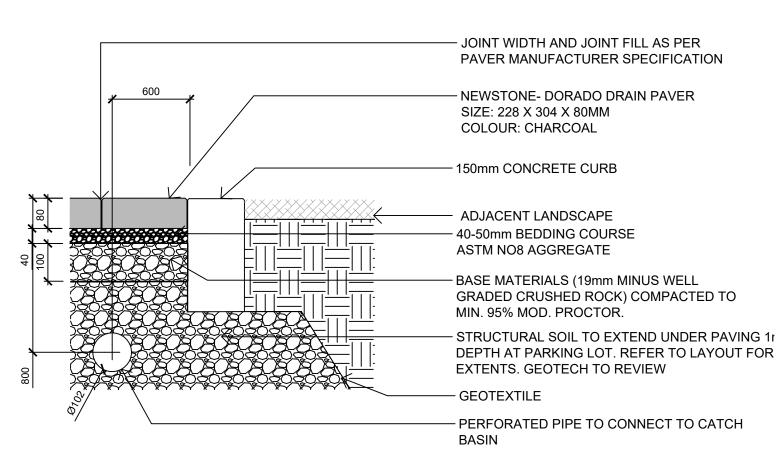


- SUBGRADE AND GRANULAR BASE TO BE COMPACTED TO MIN. 95% MPD.
- GRANULAR BASE TO BE COMPACED IN MAX. 100mm LIFTS. PAVER AND PAVER INSTALLATION TO MMCD AND MANUFACTURER'S
- SPECIFICATION UNLESS NOTED OTHERWISE.
- GEOTECH TO REVIEW PRIOR TO INSTALLATION.
- REFER TO CIVIL FOR CATCH BASIN LOCATIONS.
- DIAMETER OF PERFORATED PIPE TO BE DETERMINED BY STORMWATER ENGINEER.






PAVING DETAILS

DRAWING TITLE:

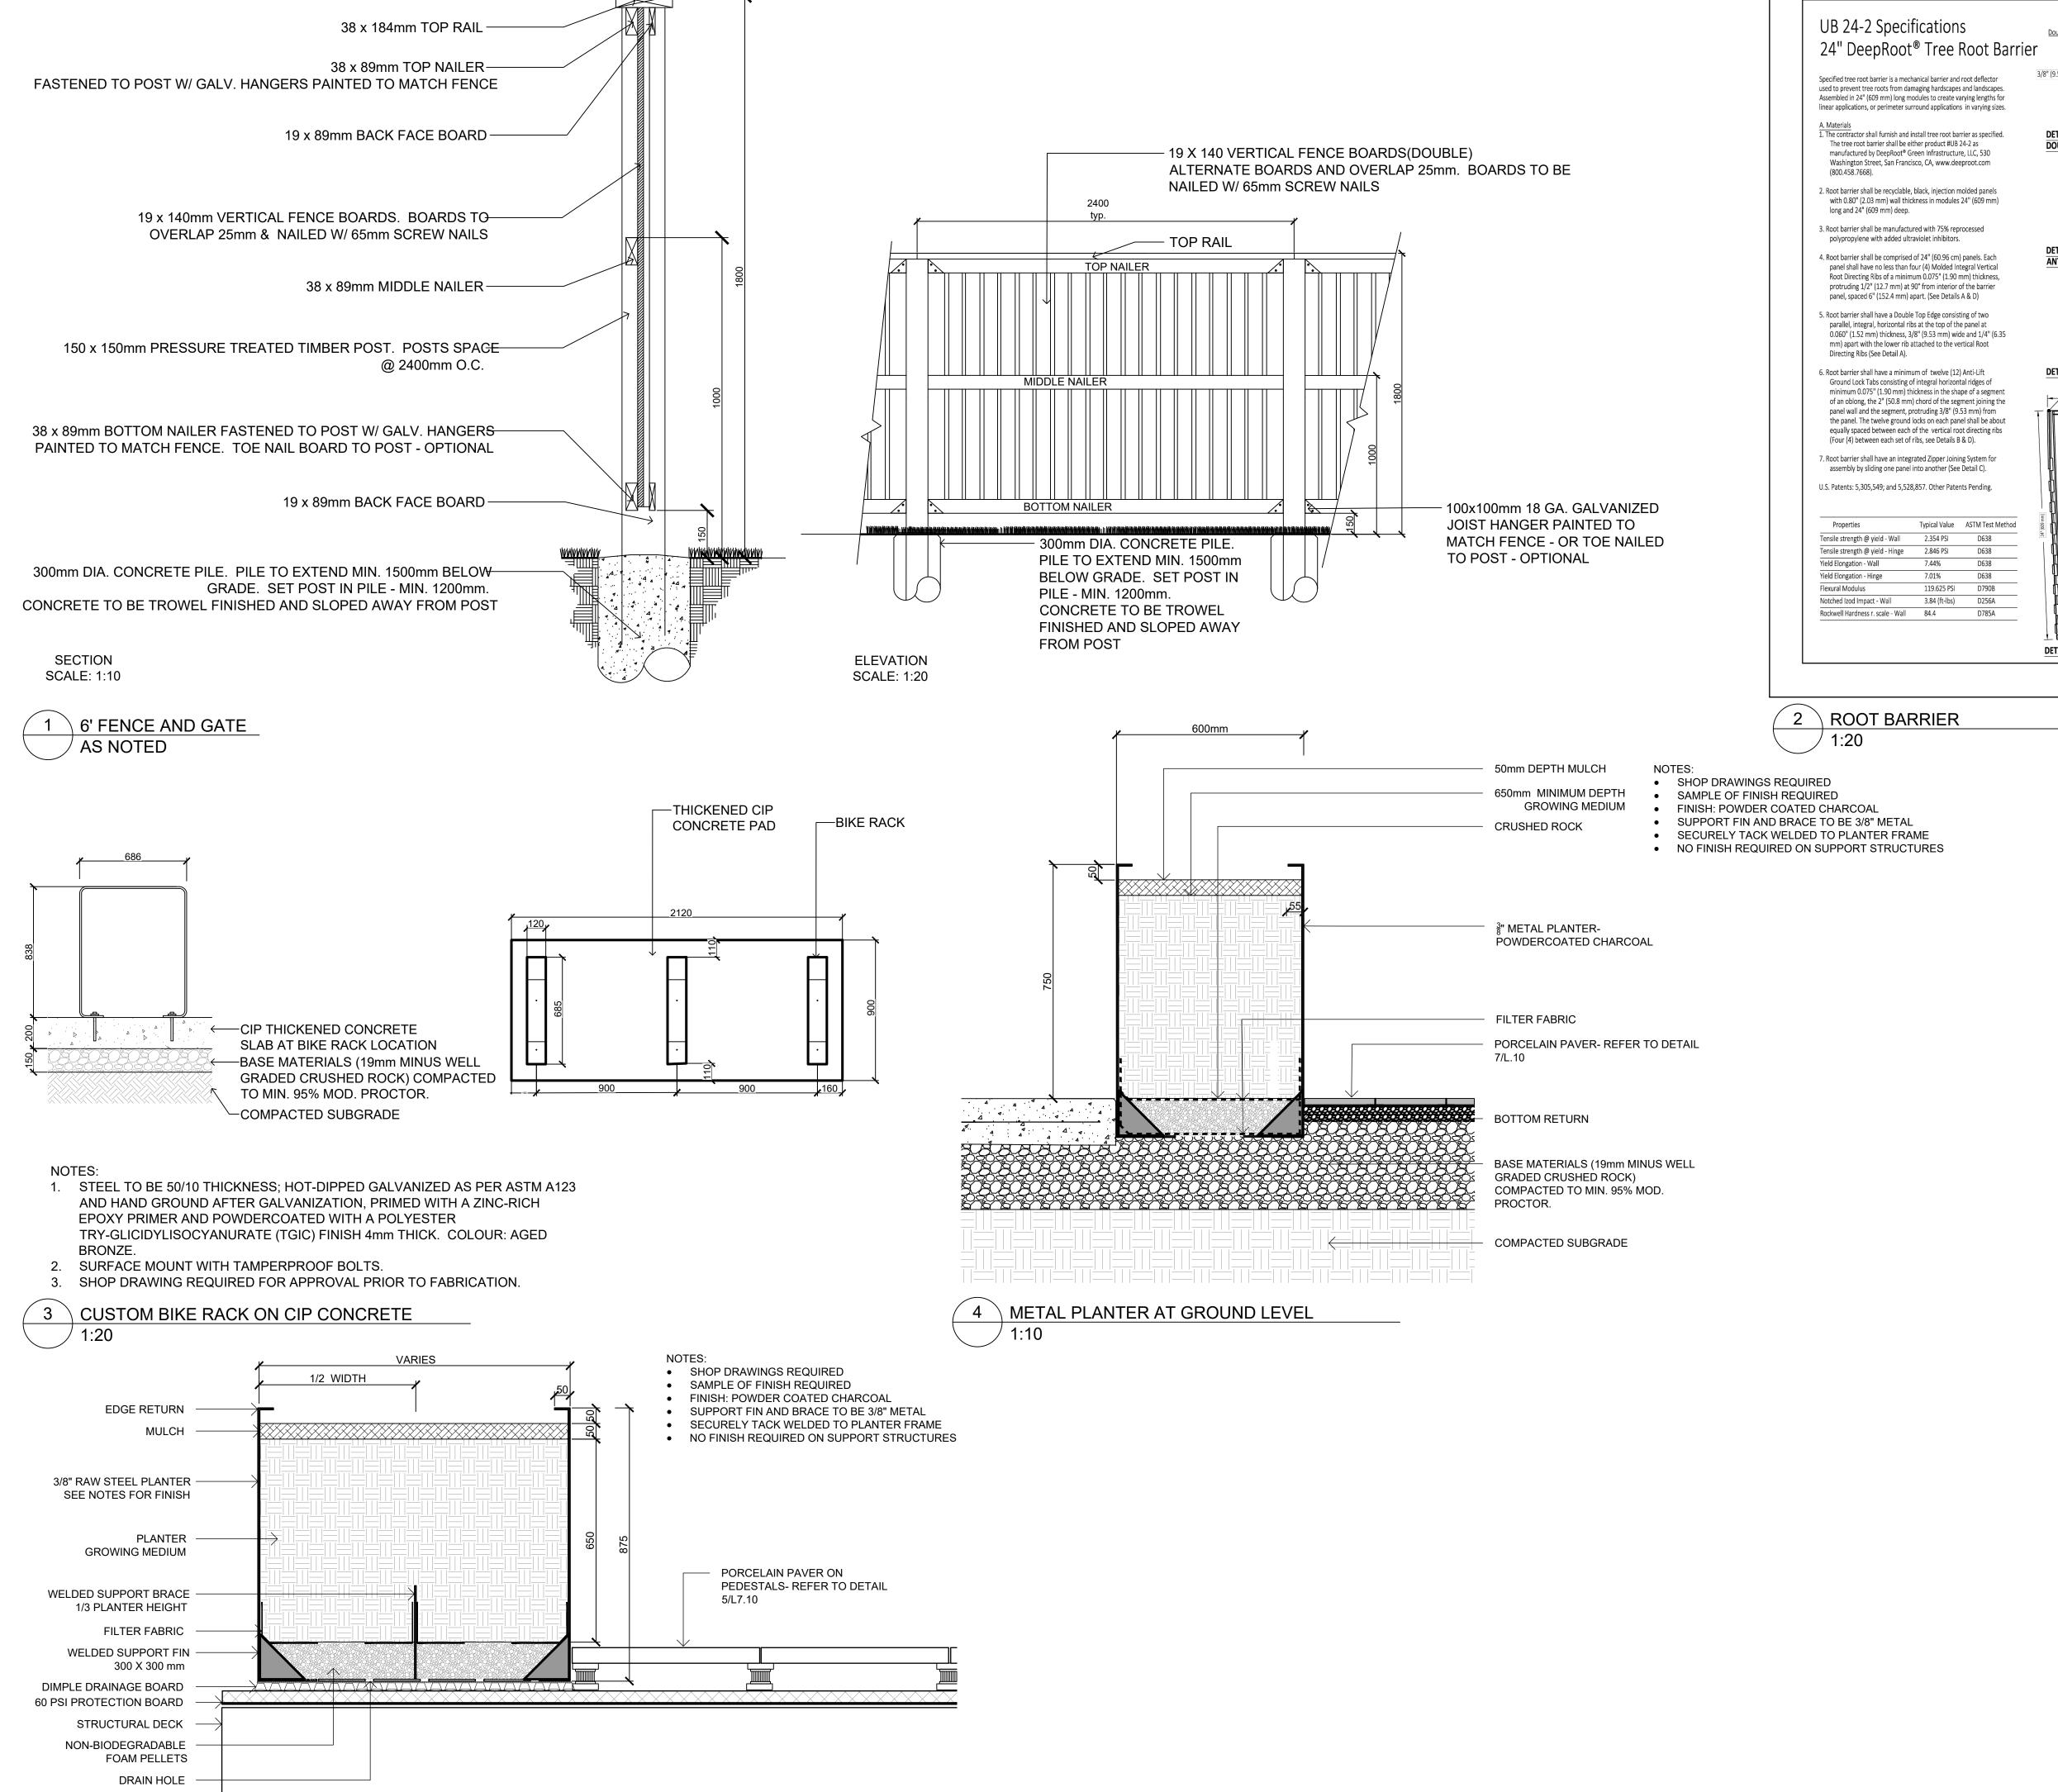

\ METAL PLANTER-UPPER LEVELS

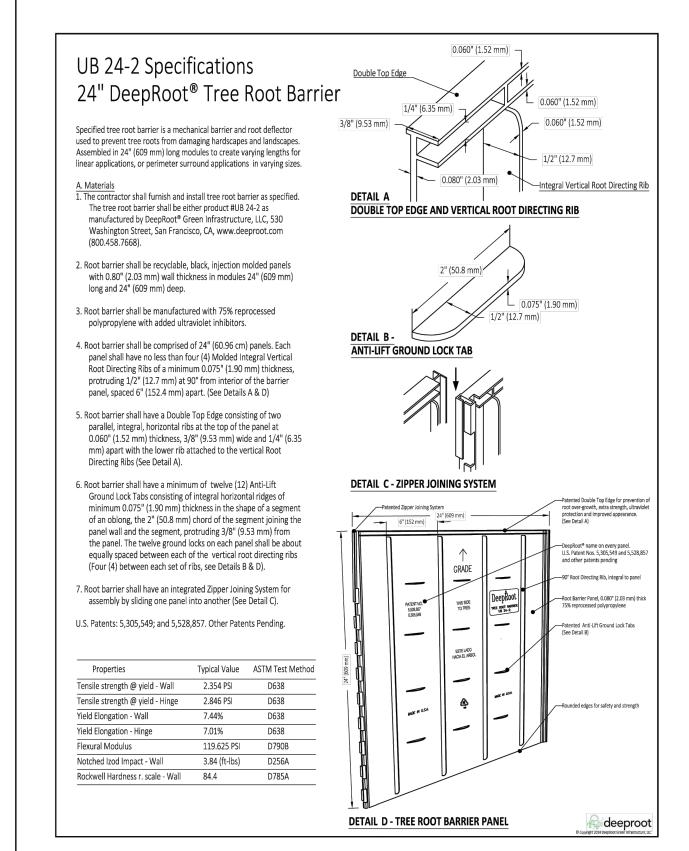

1608 Camosun Street, Victoria BC V8T 3E6 Info@biophiliacollective.ca 250 590 1156

OWNER/CLIENT:


ARYZE DEVELOPMENTS

PROJECT ADDRESS: 1733 FAIRFIELD,

VICTORIA, BC

DESIGNED BY: BIANCA BODLEY DRAWN BY: TYLER YESTAL


NO.	ISSUE	YY\MM\DD
1	ISSUED FOR DEVELOPMENT TRACKER	22\03\04
2	ISSUED FOR RZ/DP	22\05\02
3	ISSUED FOR COORDINATION	22\07\18
4	ISSUED FOR RZ/ DP	22\07\20
5	ISSUED FOR RZ/ DP RESUBMISSION	23\01\24
6	ISSUED FOR RZ/ DP RESUBMISSION	2023\08\18
7	25% BUILDING PERMIT	2023\10\10
8	ISSUED FOR RZ/ DP REV 5	2024\02\21
8	ISSUED FOR RZ/ DP REV 6	2024\07\19

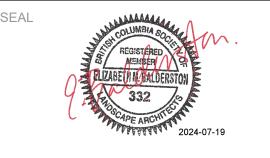

NORTH ARROW

DRAWING TITLE:

SITE FURNISHINGS **DETAILS**

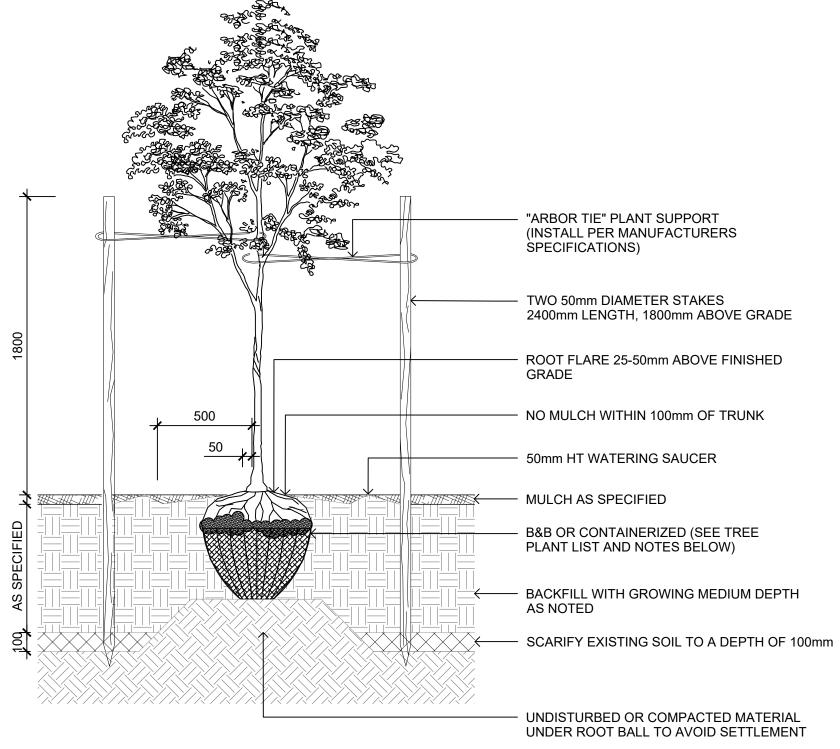


1. CONTRACTOR SHALL INSURE PERCOLATION OF ALL PLANTING PITS PRIOR TO INSTALLATION

6. TREE PLANTING ON MUNICIPAL PROPERTY TO MUNICIPAL STANDARD DETAIL


- 2. FOR B&B: REMOVE TOP 1/3 OF BURLAP AND CAGE PRIOR TO BACKFILLING WITH GROWING MEDIUM
- FOR CONTAINERS: LOOSEN ROOT STRUCTURE AND ENSURE NO CIRCLING ROOTS BY LIGHT ROOT PRUNING
 INSTALL TREE TIE AT APPROX. 50% OF TREE HT. FOR CONIFERS LESS THAN 3m HT. AND 100mm BELOW LOWEST BRANCH
- FOR DECIDUOUS LESS THAN 100mm CAL. DO NOT REMOVE OR CONSTRAIN ANY BRANCHES.
- 5. STANDARD TREE PLANTING DETAILS TO BE APPLIED ACCORDINGLY TO TREES PLANTED IN PLANTERS

1 TREE PLANTING ON GRADE

/ 1:20

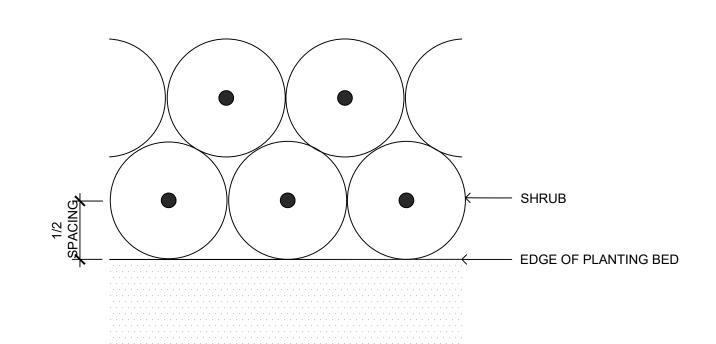


4 PLANT SPACING PLAN

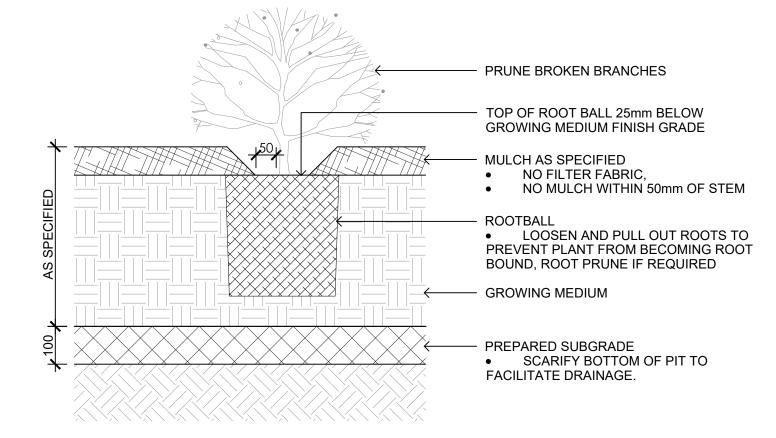

NOTES:
1. SHRUB PLANTING AS PER WRITTEN SPECIFICATIONS
2. GROWING MEDIUM AND MULCH AS PER WRITTEN SPECIFICATIONS

2 SHRUB PLANTING

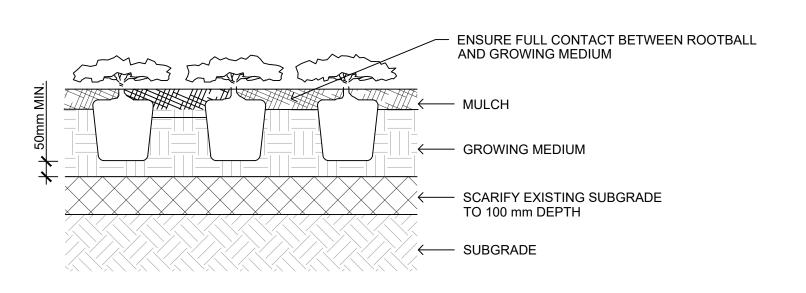

OTES:

- PLACE AND COMPACT SUBGRADE AS PER WRITTEN SPECIFICATIONS
- SUBGRADE TO BE COMPACTED TO A CONSISTENT 80% M.P.D
 GROWING MEDIUM AND MULCH AS PER WRITTEN SPECIFICATIONS
- 3 GROUNDCOVER PLANTING



1608 Camosun Street, Victoria BC V8T 3E6 Info@biophiliacollective.ca 250 590 1156

OWNER/CLIENT:

ARYZE DEVELOPMENTS

PROJECT ADDRESS:

1733 FAIRFIELD, VICTORIA, BC

DESIGNED BY: BIANCA BODLEY DRAWN BY: TYLER YESTAL

 NO.
 ISSUE
 YY\MM\DD

 1
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 6
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 2023\08\18

 7
 25% BUILDING PERMIT
 2023\10\10

 8
 ISSUED FOR RZ/ DP REV 5
 2024\02\21

8 ISSUED FOR RZ/ DP REV 6



NORTH ARROW

DRAWING TITLE:

PLANTING DETAILS

VG NO:

SCALE: AS NOTED





1733-1737 Fairfield Road Parking Variance

Final Report V04

Prepared for

Aryze Developments

Date

January 18, 2023

Project No.

04-22-0057

January 18, 2023 04-22-0057

Olivia Wheater Development Manager Aryze Developments 1839 Fairfield Road Victoria, BC V8S 1G9

Dear Olivia:

Re: 1733 - 1737 Fairfield Road, Parking Variance Final Report V04

Bunt & Associates Engineering Ltd. (Bunt) has completed our parking variance study for the proposed residential development at 1733-1737 Fairfield Road, Victoria, BC. Our Report is provided herewith, it addresses the potential transportation impacts related to the proposed development.

We trust that our input with this report will be of assistance. Please do not hesitate to contact us should you have any questions.

Best regards,
Bunt & Associates

Jason Potter, M.Sc. PTP

Senior Transportation Planner / Associate



CORPORATE AUTHORIZATION

Prepared By: Jason Potter, M.Sc. PTP

Professional Transportation

Planner / Associate

Colleen Qiu, EIT

Transportation Analyst

Bunt & Associates Engineering Ltd.

Suite 530, 645 Fort Street

Victoria, BC V8W 1G2

Canada

Telephone: +1 250 592 6122

Date: January 18, 2023

Project No. 04-22-0057

Status: Final V04

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TABLE OF CONTENTS

CUTI	VE SUN	MMARY	I
INTR	ODUC	TION	1
1.1 1.2			
EXIS	TING C	CONDITIONS	5
2.1 2.2		g Transportation Network Road Network Transit Network Cycling & Pedestrian Networks Car-Share	5 5 8
SITE	PLAN	DESIGN REVIEW	14
3.1		SupplyVehicle Parking Bylaw Requirements	14 14
VEHI	CLE PA	ARKING SUPPLY ANALYSIS	16
4.1 4.2			
VEHI	CLE TI	RIP GENERATION ESTIMATES	17
SERV	ICE VE	EHICLE OPERATIONS	17
TRAI	NSPOR	TATION DEMAND MANAGEMENT (TDM)	18
7.1 7.2		Bicycle Repair Station and Bike Wash	
	INTR 1.1 1.2 EXIST 2.1 2.2 SITE 3.1 3.2 VEHI 4.1 4.2 VEHI SERV TRAI 7.1	INTRODUC 1.1 Study F 1.2 Propos EXISTING (2.1 Land U 2.2 Existin	1.2 Proposed Development EXISTING CONDITIONS 2.1 Land Use 2.2 Existing Transportation Network 2.2.1 Road Network 2.2.2 Transit Network 2.2.3 Cycling & Pedestrian Networks 2.2.4 Car-Share 2.2.5 Existing On-Street Parking SITE PLAN DESIGN REVIEW 3.1 Site Access Design 3.2 Parking Supply 3.2.1 Vehicle Parking Bylaw Requirements 3.2.2 Bicycle Parking Bylaw Requirements VEHICLE PARKING SUPPLY ANALYSIS 4.1 Resident Parking 4.2 Visitor Parking VEHICLE TRIP GENERATION ESTIMATES SERVICE VEHICLE OPERATION S TRANSPORTATION DEMAND MANAGEMENT (TDM) 7.1 Transportation Demand Management 7.2.1 Bicycle Repair Station and Bike Wash 7.2.2 Parking Management - Unbundle Parking 7.2.3 Specialized Parking 7.2.4 Bicycle Parking 7.2.5 Transportation Options Information Package

8.	SUMMARY	. 21
EXI	HIBITS	
Exhi	bit 1.1: Site Location	2
Exhi	bit 1.2: Site Plan	4
Exhi	bit 2.1: Existing Laning & Traffic Control	6
Exhi	bit 2.2: Transit Routes & Stops	7
Exhi	bit 2.3: Cycling Network	9
Exhi	bit 2.4: Car-Share Vehicles	11
Exhi	bit 2.5: On-Street Parking Supply and Demand	13
	BLES	
	le 1.1: Proposed Land Uses and Unit Breakdown	
	le 2.1: Existing Transit Service Frequency	
Tab	le 3.1: Vehicle Parking Supply Requirement & Provision	14
Tab	le 3.2: Bicycle Parking Supply Requirement & Provision	15

EXECUTIVE SUMMARY

Aryze proposes the development of a four-storey 30-unit strata residential building at 1733 - 1737 Fairfield Road, Victoria, BC. The site is currently occupied with three single family-homes.

The proposed supply of 22 parking spaces is 14 spaces below the City of Victoria Zoning Bylaw requirements for 36 spaces, therefore a vehicle parking variance is required.

The proposed variance is considered appropriate for this site, as it will be supported by:

- Providing electric charging abilities to all of the vehicle spaces;
- Exceeding Victoria Bylaw bicycle parking requirements with 52 Long-term bicycle spaces and six weather protected Short-term bicycle spaces;
- Providing the Long-Term bicycle spaces with 110 volt charging ability;
- Providing a bicycle repair station and bike wash station;
- Improving site fronting sidewalks and boulevards to enhance the area's walkability,
- Providing a Transportation Option Information Package or Brochure for new residents; and,
- Supporting car-share activity by providing a \$500 value MODO car-share membership which would remain with the residential unit or EVO credits to a value of \$500 for each non-vehicle parking space leasing unit.

1. INTRODUCTION

1.1 Study Purpose & Objectives

Aryze is proposing the development of a residential strata building at 1733-1737 Fairfield Road. The site is currently zoned as R1-G (Gonzales Single Family Dwelling District).

The project will feature 30 residential units. They consist of six townhomes, two studios, nine 1-bedroom, four 1-bedroom plus den, four 2-bedroom, three 2-bedroom plus den and two 3-bedroom plus den units.

Bunt & Associates were retained by Aryze to conduct a parking review for the proposed parking variance and propose Transportation Demand Management (TDM) strategies to help reduce the development's demand for vehicle parking. This parking variance study will accompany Aryze's rezoning application.

The location of the proposed development site is illustrated in Exhibit 1.1.



Exhibit 1.1
Site Location

bunt &associates

1.2 Proposed Development

The proposed development is summarized in Table 1.1.

Table 1.1: Proposed Land Uses and Unit Breakdown

LAND USE	UNITS	APPROXIMATE SIZE (M²)
Townhome - 2 bedrooms	6	58
Studio	2	41
Apartment - 1 bedroom	9	51
Apartment - 1 bedroom with den	4	67
Apartment - 2 bedrooms	4	69
Apartment- 2 bedrooms with den	3	53-105
Apartment - 3 bedrooms with den	2	120-126
RESIDENTIAL TOTAL	30	-

All residential units will be condo strata units.

The development proposes including 22 parking spaces on the ground level. Two of these spaces are designated for visitor parking, the remaining 20 are for residents resulting in 0.67 spaces per unit for residents and 0.06 spaces per unit for residential visitors (0.73 spaces per unit total).

Vehicle access to the parking is on Beechwood Avenue on the south edge of the site.

Bicycle parking will exceed bylaw requirements with 52 Long-term (14 greater than Bylaw) and 6 Short-term bicycle spaces.

The proposed site plan (ground level) is shown in Exhibit 1.2.



3	DP/RZ Bov1	July 20, 2022
2	DP/R7 Submission	April 29, 2022
1	Development Tracker Application	March 7, 2022
NO.	DESCRIPTION	DATE



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1733-1737 Fairfield Rd ARYZE Sheet Name LEVEL 1 PROPOSED PLAN Date JAN 13, 2023 Scale 1:100 Project # A-101

Exhibit 1.2 Site Plan

1733-1737 Fairfield Road January 2023



2023-01-13 11:02:16 AM

2. EXISTING CONDITIONS

2.1 Land Use

1733-1737 Fairfield Road is currently occupied by three single-family homes, two are accessed from Fairfield Road and one from Beechwood Avenue. Land use adjacent to the site is primarily composed of single-family residential dwellings, with commercial land uses and a cemetery to the west of the site on Fairfield Road.

The site is located approximately 2.7 km southeast of Victoria's downtown area in the Gonzales neighbourhood. It is also located approximately 2.1 km south of Royal Jubilee Hospital and 3.7 km south of Camosun College Lansdowne Campus.

2.2 Existing Transportation Network

2.2.1 Road Network

Fairfield Street adjacent to the site is a two-way street that connects to Victoria's Downtown. Beechwood Avenue adjacent to the site operates similar to a local road. Nearby intersections are all stop-controlled.

The adjacent street network is illustrated in Exhibit 2.1.

There is currently curb side parking along both sides of Beechwood Avenue and Fairfield Road. On-street parking supply and regulations are examined in Section 2.2.5.

2.2.2 Transit Network

The site is well served by public transit, with three transit routes within 800 metres of the site (an approximate ten-minute walk). These routes and local area bus stops are presented in **Exhibit 2.2**.

The site is located less than 200 m from stops on regional route #7, and 600-800 m from stops on local routes #1 and #3. Downtown or the University of Victoria is approximately a 16-minute trip on route #7 from the site, and Camosun College's Lansdowne Campus is an approximate 14-minute trip. **Table 2.1** shows the frequencies of the transit routes near the site.

Table 2.1: Existing Transit Service Frequency

	ROUTE	APPROXIMATE HEADWAY (MIN.)				
#	BUS ROUTE NAME	AM	MID-DAY	PM	EVENING	WEEKEND
1	South Oak Bay / Downtown	45	-	45	-	-
3	James Bay / Royal Jubilee	30	65	30	-	60
7	UVic/Downtown	15	20	15	30	30



Exhibit 2.1 Existing Road Network and Laning





Exhibit 2.2 Existing Transit Routes and Stops



2.2.3 Cycling & Pedestrian Networks

The site is well connected to both walking and cycling networks. Fairfield Street and Crescent Road are signed bike routes. Downtown can be accessed in 15 minutes via Fairfield Street or via the nearby Richardson Street to the north. Continuous bike lanes on Foul Bay Road and Henderson Road provide residents with a direct cycling route to Camosun College Lansdowne Campus and the University of Victoria. The existing cycling network surrounding the site is shown in **Exhibit 2.3**.

All streets surrounding the development site have sidewalks on both sides.

The City of Victoria is rapidly upgrading its network of All Ages and Abilities (AAA) cycling infrastructure. Plans call for the existing signed bike route on Richardson Street to be upgraded to protected cycling lanes, creating a continuous, AAA cycling route that connects the site's neighbourhood to Victoria's downtown area. It is anticipated that these protected AAA cycling facilities will increase the attractiveness and viability of cycling to and from the development. With its substantial volume of bike parking, the proposed development at 1733-1737 Fairfield Street is well-positioned to support the anticipated cycling demand.

The location is within a walking distance of most everyday amenities and services, and all daily errands can be accomplished either on foot or on a bike. The Fairfield Plaza with food and services can be accessed in 6 minutes on foot or 2 minutes by bike. Walk Score is an on-line tool that assesses the walkability and bikeability of a location based on distances to a wide variety of amenities and services. The site scores a 65 for walkability which it defines as "Somewhat".

The location receives a Bike Score of 90 out of 100, placing it in Walk Score's "biker's paradise" category. This already high score is expected to improve with the cycling upgrades performed over the next few years.



Exhibit 2.3 **Cycling Network**



2.2.4 Car-Share

MODO is a two-way carsharing service; registered members can pick up the vehicle from a parking spot and must return it to the same spot when they are done. The site has two MODO carshare vehicles located within 1 km of the site, the closest of which is located approximately 800 m away at Rockland Avenue and St Charles Street. Approximately 20 other MODO vehicles are located in downtown Victoria, which is easily accessible by bike or transit. Vehicles range from compact cars and sedans to SUVs and minivans, and sedan and compact are present within 1 km of the site. **Exhibit 2.4** shows the locations of nearby Modo carsharing vehicles.

EVO car share launched in Victoria in the summer of 2021 with 80 vehicles. EVO vehicles can be used and dropped off anywhere within the designated City of Victoria area.

Another potential carsharing option for residents of the proposed development is Turo. Turo allows individuals to rent out their private vehicles when not in use. As of February 2022, one vehicle is listed on Turo within walking distance of 1733-1737 Fairfield Road, and more than 25 vehicles are listed in the greater Victoria area.

Other new car-sharing opportunities are anticipated in the years ahead as these types of businesses become more viable with app based and autonomous vehicle technologies.



Exhibit 2.4 Carshare Vehicles



2.2.5 Existing On-Street Parking

Bunt collected on-street vehicle parking supply and demand data near the proposed development site. Data was collected on Wednesday December 7, 2022, at 5PM -5:30PM and on Saturday December 10, 2022, at 3PM - 3:30PM. These periods are intended to represent average to peak periods for on-street vehicle parking activity.

The blocks surrounding the proposed development site have a range of parking regulations. These regulations as well as the observed parking demand for specific areas are shown in **Exhibit 2.5**.

Key finding include:

- The development site frontages have a total of 8 vehicle spaces, these spaces were observed to have a maximum occupancy of 6 spaces during the Saturday observation period.
- Non-site fronting parking areas on Beechwood Avenue were observed to have high parking demand with an observed 6 out of 6 spaces occupied during the weekday observation.
- Aryze's Rhodo residential development at 1839 Fairfield is across Fairfield Road from the proposed development site, it has 7 two-hour parking spaces along its frontage, these spaces were observed to have a peak demand of 4 spaces.
- There are at total of 31 publicly available on-street parking spaces within an approximate one-block area from the site. These spaces had a maximum observed demand of 19 spaces which equates to 61% occupancy or approximately 12 vacant vehicle spaces.
- There are 41 resident-only on-street parking spaces within an approximate one-block area from the site. These spaces had a maximum observed demand of 16 spaces which equates to 39% occupancy or approximately 25 vacant vehicle spaces.
- In total, including resident-only spaces and publicly available spaces, the observed area had a total of 81 parking spaces with a peak observed demand of 40 spaces (49%).

It is noted that the above data represents two days of parking data and therefore is not considered conclusive of peak period occupancy but rather is intended to provide a snapshot of on-street parking demand during these specific time periods.





	Site Frontage		No Regulation		Resident Only				2 hour	90 min			
Area	Α	В	C	D	Е	F	G	Н	_	J	K	L	М
Parking Supply	5	3	2	6	8	4	7	8	13	9	7	2	7
Dec.7, 2022 Wed. 5PM Demand	2	1	1	6	2	4	0	4	5	3	4	1	7
Dec.10, 2022 Sat. 3PM Demand	4	2	0	4	2	4	1	2	4	4	4	0	5

	No Reg.	Resident	2 hour	90 min	All
Total by Regulation	31	41	7	2	81
Dec.7, 2022 Wed. 5PM Demand	19	16	4	1	40
Dec.10, 2022 Sat. 3PM Demand	17	15	4	0	36

Exhibit 2.5 On-Street Parking Regulations, Supply and Demand



3. SITE PLAN DESIGN REVIEW

3.1 Site Access Design

The proposed development will have one vehicle access point from Beechwood Avenue.

Pedestrian access to the site's apartment units will be accessed from Beechwood Avenue. The development includes six townhomes with pedestrian access fronting Fairfield Road.

3.2 Parking Supply

3.2.1 Vehicle Parking Bylaw Requirements

The City of Victoria's parking Bylaw (Schedule C, Zoning Bylaw) specifies four the off-street parking subareas with different requirements. The proposed development is located in the "Other Areas" category. The residential component of the development is required to provide 0.85 to 1.45 resident parking spaces per residential unit depending on unit size. These rates consider the development's location outside of the Core or Village areas and the units being condo units rather than rental units.

In addition, Bylaw requires the development provide 0.1 residential visitor parking space per unit.

Bylaw requirements and proposed supplies are summarized in Table 3.1.

Table 3.1: Vehicle Parking Supply Requirement & Provision

LAND USE	DENSITY	BYLAW RATE	BYLAW SUPPLY REQUIREMENT	PROVIDED	DIFFERENCE	
Townhomes or Condominiums	0 units	0.85 spaces per unit that is less than 45m²		20	-13	
	23 units	1.00 spaces per unit that is equal to 45m² and up to 70m²	33			
	7 units	1.45 spaces per unit that is more than 70m²				
	30 units total	0.10 visitor parking spaces per unit	3	2	-1	
-	-	-	36	22	-14	

As shown in Table 3.1, the proposed total parking supply of 22 spaces is 14 spaces below Bylaw requirements. The shortfall from Bylaw is comprised of 13 resident spaces and 1 visitor space.

3.2.2 Bicycle Parking Bylaw Requirements

Well managed, secure, accessible and covered bicycle parking will be provided as part of the development plan. The site plan indicates a total of 38 long-term bicycle spaces in a dedicated bicycle parking room including two spaces for oversized cargo bicycles. In addition, 6 short-term bicycle spaces will be provided at ground level in a well lit, weather protected and highly visible area.

Current City of Victoria Bylaw requirements are provided in Table 3.2.

Table 3.2: Bicycle Parking Supply Requirement & Provision

LAND USE	DENSITY	BYLAW RATE	BYLAW SUPPLY REQUIREMENT	PROVIDED	DIFFERENCE	
Townhomes or Condominiums	30 units (all	Long-term: 1.25 spaces per unit that is 45m² or greater	201	5 21	+14 Long-term 0 Short-term	
	greater than 45m²)	Short-term: The greater of 6 spaces per building or 0.1 spaces per unit	38 Long-term 6 Short-term	52 Long-term 6 Short-term		

The proposed development plan offers 52 long-term bicycle spaces and 6 short-term spaces for a total of 58 bicycle parking spaces. This proposed supply exceeds Bylaw requirements (+14) for long-term spaces and meets requirements for short-term spaces.

4. VEHICLE PARKING SUPPLY ANALYSIS

4.1 Resident Parking

The proposed vehicle parking ratio of 0.73 spaces per unit (0.67 for residents and 0.06 for residential visitors) represents a variance from bylaw for both residents and visitors but is consistent with City objectives to right size vehicle parking. 20 units will have one vehicle space and 10 units will not have access to a vehicle space. This is considered viable as the site is well located in regard to nearby viable non-private vehicle transportation options as well as nearby amenities.

In March of 2020 Bunt & Associates collected supply and demand data at 7 Victoria and Saanich apartment buildings with 24 to 90 units of market/ strata condos. The average vehicle parking supply was 1.18 spaces per unit for residents and 0.21 spaces per unit for visitors. The demand was 0.82 spaces for residents and 0.06 visitor spaces per unit. The proposed provision of 0.67 spaces per unit for residents is below this observed demand of 0.82 spaces per unit, however the 0.82 spaces per unit rate was observed at buildings that did not have as significant or no transportation demand management initiatives to support other modes of transportation.

4.2 Visitor Parking

Previous research conducted by Bunt has repeatedly suggested that a visitor parking rate of 0.05 spaces per unit for residential buildings is adequate to accommodate peak demands. This is supported by Metro Vancouver's comprehensive "2012 Metro Vancouver Residential Apartment Parking Study". The study found peak visitor parking demand rates in the range of 0.05 to 0.07 vehicles per unit for multi-family residential. This is consistent with Bunt's in-house database of peak visitor parking demand rates.

A visitor parking demand rate of 0.05 spaces per unit would translate to peak period demand of approximately two parking spaces for the proposed 30 units. This is consistent with the proposed two visitor space provision. While additional curbside spaces are available along both road frontages and are anticipated to be used by visitors and short-term delivery vehicles, they do not count towards the site's parking count which must all be on-site.

¹ 2012 Metro Vancouver Apartment Parking Study available at: https://www.esquimalt.ca/sites/default/files/docs/municipal-hall/EVP/schedule_m_parking_study.pdf

VEHICLE TRIP GENERATION ESTIMATES

Vehicle trip generation for a typical condo residential building of this type is in the range of 0.4 total wo-way vehicle trips per weekday PM peak hour (ITE Trip Generation Manual, Edition 10) which equates to approximately 12 vehicle trips either entering or exiting the site per peak hour. This quantity of vehicle traffic is considered negligible and is not anticipated to have a significant impact on adjacent road operations. The proposed vehicle parking variance is anticipated to lower this particular developments' vehicle trip generation below a total of 10 two-way vehicle trips per peak hour.

6. SERVICE VEHICLE OPERATIONS

The City of Victoria Zoning Bylaw does not stipulate a requirement for off-street loading for residential land use. Loading activity for the proposed 30 residential units would likely involve vehicles no larger than a garbage/ recycling vehicle. Garbage and recycling bins will be accessible from the parking area.

Small sized delivery vehicles are anticipated to use the on-site visitor parking spaces or the available curbside parking along the site's Fairfield Road and Beechwood Avenue site frontages.

7. TRANSPORTATION DEMAND MANAGEMENT (TDM)

7.1 Transportation Demand Management

Transportation Demand Management (TDM) is defined as the "application of strategies and policies to reduce travel demand (specifically that of single-occupant private vehicles), or to redistribute this demand in space or in time". A successful TDM program can influence travel behaviour away from Single Occupant Vehicle (SOV) travel during peak periods towards more sustainable modes such as High Occupancy Vehicle (HOV) travel, transit, cycling or walking. The responsibility for implementation of TDM measures can range across many groups, including regional and municipal governments, transit agencies, private developers, residents/resident associations or employers.

7.2 TDM Initiatives

7.2.1 Bicycle Repair Station and Bike Wash

Aryze will provide an on-site bike repair station and a bike wash station within the bike room. This removes one of the barriers to cycling for residents who may otherwise have to purchase the tools required to perform basic maintenance on their bicycles. With the significant supply of bicycle parking and strong access to nearby cycling routes, a bike repair station would likely be well used in this development.



Figure 4.1. Bicycle Repair Station

² http://ops.fhwa.dot.gov/tdm/index.htm FHWA Travel Demand Management home page



7.2.2 Parking Management - Unbundle Parking

It is recommended that the vehicle parking spaces be unbundled from the unit costs (sold or leased separately). With 20 available vehicle spaces, all 1 bedroom plus den and larger units can be offered the choice to purchase or lease a vehicle parking space. Remaining spaces can be offered to studio and one-bedroom unit owners if available.

7.2.3 Specialized Parking

Current Bylaw required energized electric vehicle outlets for each resident vehicle space. Aryze will meet this Bylaw requirement.

7.2.4 Bicycle Parking

The development will be providing 52 long-term bicycle parking spaces and 6 short-terms spaces. This supply exceeds Bylaw requirements for long-term spaces by 14 spaces.

The developer will provide electric charging abilities for the long-term bicycle parking spaces.

7.2.5 Transportation Options Information Package

New residents are considered a pliable demographic for transportation mode change as they have yet to establish travel patterns from their new address. Clear and simple messages along with practical information about local transit services and walking and cycling routes to and from the site can help encourage residents to use more sustainable transportation modes. Information should be distributed to residents upon their move-in or made available through a website or webpage. The information provided in print or on-line should include:

- Map showing local transit routes (can be obtained from BC Transit Victoria website);
- Map showing local area cycling routes (can be obtained from City website Victoria Bike Routes);
- Map showing amenities within a typical walking catchment of 800 metres (can be obtained from Walk Score website: www.walkscore.com).

7.2.6 Car-Share

Car-sharing organizations have developed significantly in the last 5-10 years. They allow people to have access to a car without having to buy or maintain their own vehicle. A "pay as you go" approach is adopted as members pay by the hour and/or kilometre when they use a vehicle. There are currently two car share organizations in the Victoria area: Modo and EVO. Modo currently (January 2023) has a fleet of over 50 vehicles throughout the Greater Victoria area. EVO has approximately 80 vehicles.

The parking demand impact of having a car share vehicle and/ or memberships provided to residents is unclear. Some other municipalities such as Vancouver have equated varying degrees of car share participation with a parking requirement reduction of five vehicle spaces. The true impact is likely dependent on various site-specific factors such as location and resident demographics. It is our opinion that having access to a shared vehicle will remove a common barrier for residents who may consider not

owning a private vehicle, especially in the present context where the car share vehicle provides another viable transport option to an area that has other strong multi-modal transportation options.

It is recommended that the development provide MODO memberships for each resident unit that does not lease a parking space. The cost would be \$500 per unit for the membership down payment fee. The memberships will remain property of the development and are transferable to new future tenants. Residents provided with memberships will pay for vehicle use by time or by kilometers traveled.

If the developer or residents prefer EVO then credits of equal value could be provided to non-parking spaces leasing residents as EVO memberships are just \$35.

In summary, the development will provide a \$500 value MODO car-share membership which would remain with the unit or EVO credits to a value of \$500 for each non-parking space leasing unit.

8. SUMMARY

- 1. The proposed development at 1733 1737 Fairfield Road consists of 30 condo (24) and townhome (6) residential units.
- 2. Vehicle access to the building's parking spaces will be from Beechwood Avenue on the site's east frontage.
- 3. The development proposes 22 vehicle parking spaces units located within a one-level parkade structure. Two of these spaces will be for visitors. The remaining 20 spaces will service residents of the 30 units.
- 4. The vehicle parking supply of 22 spaces (0.73 spaces per unit) is 14 spaces short of the Bylaw requirement of 36 vehicle spaces. The shortfall from Bylaw is comprised of 13 resident spaces and one visitor space.
- 5. Observation of study area on-street parking indicates availability for resident visitor parking and short-term deliveries, in particular along the site's two frontages, however while these spaces may be used they do not count towards the development's parking provision as all spaces must be on-site.
- 6. The vehicle parking variance will be supported by the proposed TDM plan which includes the following initiatives:
 - a) Bicycle parking (52 Long Term and 6 Short Term) will exceed bylaw requirements.
 - b) Bicycle rooms will have enhanced access with at minimum 41-inch door widths,
 - c) Two cargo bike spaces and have ground orientated bicycle spaces above bylaw requirements.
 - d) A bike repair station and a bike wash station will be provided on-site,
 - e) Adjacent sidewalk and public realm improvements,
 - f) Transportation Options Information Package,
 - g) Unbundled vehicle parking; and,
 - h) The development will provide a \$500 value MODO car-share membership which would remain with the unit or EVO credits to a value of \$500 for each non-parking space leasing unit.

It is Bunt's view that the proposed vehicle parking supply at 1733 – 1737 Fairfield Road is appropriate for this development and this location and will not result in vehicle parking overflow into the adjacent neighbourhood. Saved costs from not building additional parking spaces can be passed onto residents through reduced development costs.