1201 Fort Street

Drawing List

Architectural

1	A000	Cover	
-	M-100A	Renderings	
- 1	A002-M	Renderings	BALLETRATIVE CHAMBIGE MAY BE BY ACCOMPANYING
-	A003-M	Renderings	DEMAND PACKAGE AND SUBMITTED AT A LATER DAT
-	A004-M	Site Analysis	
- 1	A005-M	Survey / Phas	ing Plan / Info
-	A100-M	Site Plan & Pi	roj Info
1	H-IOIA	Code Compl	lance
5	A102-M	Code Compl	lance:
15	A103-M	Average Gra	de
ା	A200-M	PI Plan	
- 1	A201-M	L1 Plan	
4	A202-M	L2 Plan	
-	A300-M	Context Elev	ations
4	A401-M	Site & Conte	et Sections
ij	AS03-M	Shadow Stud	y
-1	A210-A	PI Roor Plan	1
	A211-A	LI Floor Plan	1.
	A212-A	L2 Floor Plan	1
	A213-A	L4 Floor Plan	v.
100,084	A215-A	L5 Floor Plan	1
2	A216-A	L6 Penthous	e Floor Plan
-	A311-A	North and S	outh Elevations
	A312-A	East and We	st Elevations
	A413-A	Building Sect	ions
-	A221-B	LI & L2 Plan	5
8	A222-B	1.3 & L4 Plan	\$
9	A320-B	Elevations	
7	A420-B	Building Sect	ions

Building (Part 9 Townhouses)

1	B101	SITE PLAN & LOCATION MAP
1	8102	AVG. GRADE CALCULATIONS & TYP. SECTIONS
- 1	8201	BUILDING C PLANS
900	8202	BUILDING D PLANS
ğ	B203	BUILDING E PLANS
3	8301	BUILDING C ELEVATIONS
	8302	BUILDING D ELEVATIONS
	B303	BUILDING E ELEVATIONS
М	B401	COMBINED FRONT ELEVATIONS

Civil

ATTACHMENT C

PRELIMINARY SITE SERVICING PLAN

Landscape

L1.01	LANSCAPE PLAN
L1.02	TREE RETENTION AND REMOVAL PLA
L2.01	GRADING AND DRAINAGE PLAN
L3.01	PLANTING PLAN AND PLANT LIST
L3.02	PLANTING PLAN
1401	LANDSCAPE MATERIALS PALETTE





Contact List

PROJECT OWNER

ABSTRACT DEVELOPMENTS 301-1106 Cook Street Victoria BC VBV 3Z9 2S0.883.5579

Contact: Mike Miller, Owner

CASCADIA ARCHITECTS 1060 Meanes Street Victoria 8C V8V 3j6 250.590.3223

Contacts: Gregory Damant Architect ABC LEED AP greg@cascadisarchitects.ca

ZEBRA GROUP

LANDSCAPE ARCHITECT

MURDOCH DE GREEFF INC. 524 Culduthel Rd, Suite 200, Victoria, BC VBZ 1G1 250,412,2891

CIVIL ENGINEER

GARY CARROTHERS CONSULTING 208-2750 Quadra Street Victoria, BC VBT 4EB 250 388 6919

STRUCTURAL ENGINEER

READ JONES CHRISTOFFERSEN LTD, 645 Tyee Road, Suite 220 Victoria, BC V9A 6X5 250.386.7794

Contact Leon Plett, P.Eng., MIStructE, Struct.Eng. Iplett@rjc.ca

CONSULTING ARBORISTS

TALBOT MACKENZIE & ASSOCIATES Box 48153 RPO Uptown Victoria, BC VBZ 7H6 250.479-8733

Contact Graham Mackenzie treehelp@telus.net

ISSUED FOR RE-ZONING AND DEVELOPMENT PERMIT - 2017.11.15 Street Fort

201

A000





ARCHITECT

Peter Johannknecht Architect AIBC LEED AP peter@cascadiaarchitects.ca

TOWNHOUSE DESIGN

1161 Newport Avenue Victoria BC V85 5E6 250,360,2144

Contacts: Rus Collins Kathryn Koshman kk@zebragroup.ca

Scott Murdock, Landscape Architect, R.P. Bio, scott@mdidesign.ca

Contact: Gary Carrothers, P.Eng engineer@southisle.ca


Received City of Victoria

NOV 1 5 2017

Manning & Development Department Development Services Division





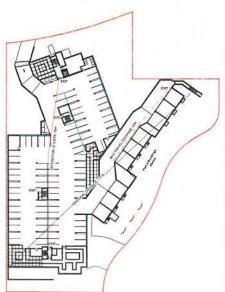

Min. Separation of two Exits: 55.5m Mex. Travel: 45m Decupancy F-3 Storage Gurage Decupant Lead: 3.200 sq m z 40 sq m/yerson = 78 persons Min. Evit Width Sames, Cartifors, Passagewaya 5, prophenses v 10 + 677mm

Stains Seem/person x 70 = 580mm

3 Level PI Key



Building A Mrs. Separation of two Estis: I'm Mrs. Travel: 25th Decupatoy: C - Residental

Min. Eat Width by Decement Load Sarper, Cartifors, Passantwers 8. Temperators 25 = 171 mm

Level I Key SCALE = 1 |500




Min. Cult Matte Names, Contribute, Pantageways 6, terrodynamia v 12 + 75 (her

Min, Separation of two Entire Sec Max. Travel. 50th

Occupancy: C - Residential

2 Level 2 Key

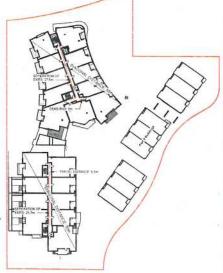


Min. Separation of two Exits: Pm Max. Travel: 30m Occupancy C-Residental Mrs. Eve Wath Barres, Contains, Passessment Elizamberson v. 25 + 155mm

4 Level Penthouse Key

Min, Separation of has Eatle: Im Mes. Travel: 30m

Mix Exit With Earnes Contines, Fastigatives 8.1 mm deckin y 20 n 122mm.

Story Employees x 22 = 160+m

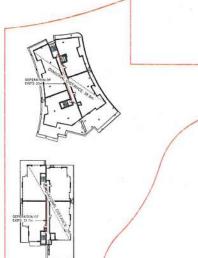

Min, Separation of two Exits: No Man, Travel: 2011 Occupancy: C - Residential

Code Compliance


1201 Fort Street Abstract Developme 1201 Fort Street Victoria, BC VBV 3L1

DESCRIPTION


CASCADIA ARCHITECTS INC 1060 Mearet Street Victoria BC VBV 1J6 Canada T 159.599.322) www.concodiu E office@concodesrchitects.cs BC Subley Code 2012 5.1 Devetal 3.1.2.1 OCCUPANCY CLASSIFICATION Group C. Residential Cossipancy Levels 1.8 Group Full: Marage Garage 1 level Selliningrada 3.1.2 Separation of Uses 3.1.17 Occupant Load: See Attinue 3.2 BUILDING FIRE SAFETY Gross Building Area: A: £.175 signs B: 3,025 ng m 3.2.2 Building Size & Construction 3.2.248 (Insue C. so to Ristorrys non-contrast constitution and non-confusible standing.
 3.2.250 (Insue C. so to 6 storrys combustible constitution. SPREKKERED Yes, Both Fulldings 14.2.1 Minute Number of Eaths. 2 per \$507 See ente plans, A-101 M See parte plane, A-101 M 3425 Tecetion of Early Max. Travel Permitted (peridential): 30m Max. Travel Permitted (F3 use; 45m

As indicated 1612 2017-11-29 12:06:06 PM GD PJ 10

A101-M

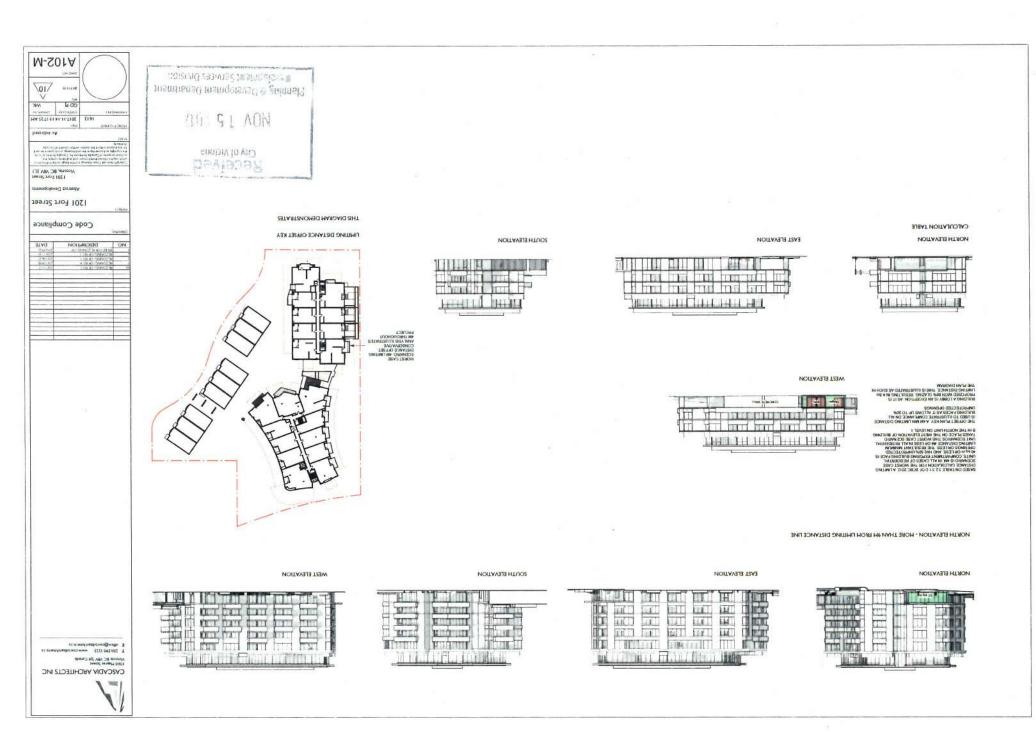



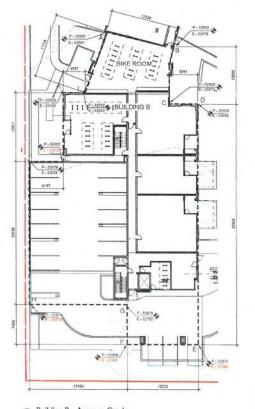

Building B - Average Grade

NOTE: RED (may show as gray) TEXT INDICATES WHERE EXISTING GRADE WAS USED TO DETERMINE AVERAGE GRADE

errago Grade Building A					Average Grade To Building B				
Point	Elevation	Span	Between Points		Point	Elevation	Span	Between Points	
	30905	A to B	9.284 mm	295,545,598 avm	A	32950	AtoR	12,325 mm	466,707,600 mm
	31814	BtoC	3,813 mm	121,522,217 mm		32950	BtoC	10,500 mm	345,975,800 mm
C	31977	CtoD	11,576 mm	371,890,576 mm	c	32950	CtoD	5,091 mm	167,748,450 mm
D	32325	D to E	22,900 mm	742,704,250 mm	D	32950	p so c	42,969 mm	1,399,457,351 mm
	12540	Etof	17,166 mm	560,778,888 mm		12106	f to F	12,733 mm	411,445,995 mm
	32796	F to G	11,121 mm	431,326,631 mm	F .	32445	F to G	7,000 mm	225,290,000 mm
G	12950	GtpH	7,236 mm	237,767,200 mm	G	12755	GtoH	17,450 mm	561,314,150 mm
N	32950	+1 to 1	6,970 mm	229,663,500 mm	н	91579	N to I	25,558 mm	824,986,682 mm
1	12950	1 to J	5,092 mm	187,551,400 mm	1	32979	I to J	6,147 mm	202:847,927 mm
1	32950	I to E	12,706 mm	418,662,700 mm	10	63070	I to K	12.411 mm	409, 176,835 mm
*	32950	K to L	17,301 mm	561,296,343 mm	K	32950	f to i.	3,957 mm	190,983,150 mm
t	31990	L to A	22,799 mm 150,544 mm	716,355,980 mm 4870650284	t	32950	LtoA	11,728 mm	386,437,600 mm 5087963348

E. A. D. A.D. (1990).

I. B. J. A. D. G. (1990).

I. B. J. A. D. G. (1990).

NO. D. BESCRIPTION DATE

(ANNEL AVERAGE Grade

1201 Fort Street

CASCADIA ARCHITECTS INC 1060 Meanes Street Victoria BC VBV 3/6 Canada

T 250,590,3223 www.cnicuditur E office@cnicuditorchitects.cs


Abstract Developms

1301 Fort Street.
Victoria, BC VSV 3L1


cough moved from the specific damp content to see or
which may be observed be referred to the couended and the observed benefits and the damp content to the
which may be observed be referred to the country to the
country of the country to the country to the
Exception of the country to the country to the
Exception of the country to the country to the
Exception of the country to the country to the
Exception of the country to the country to the
Exception of the country to the country to the
Exception of the country to the country to the
Exception of the country to the country to the
Exception of the
Exception

entitude property of Can and newtoness for Can and newtoness to the Can and newtoness to the control of Canada Andrews of Cana

A103-M

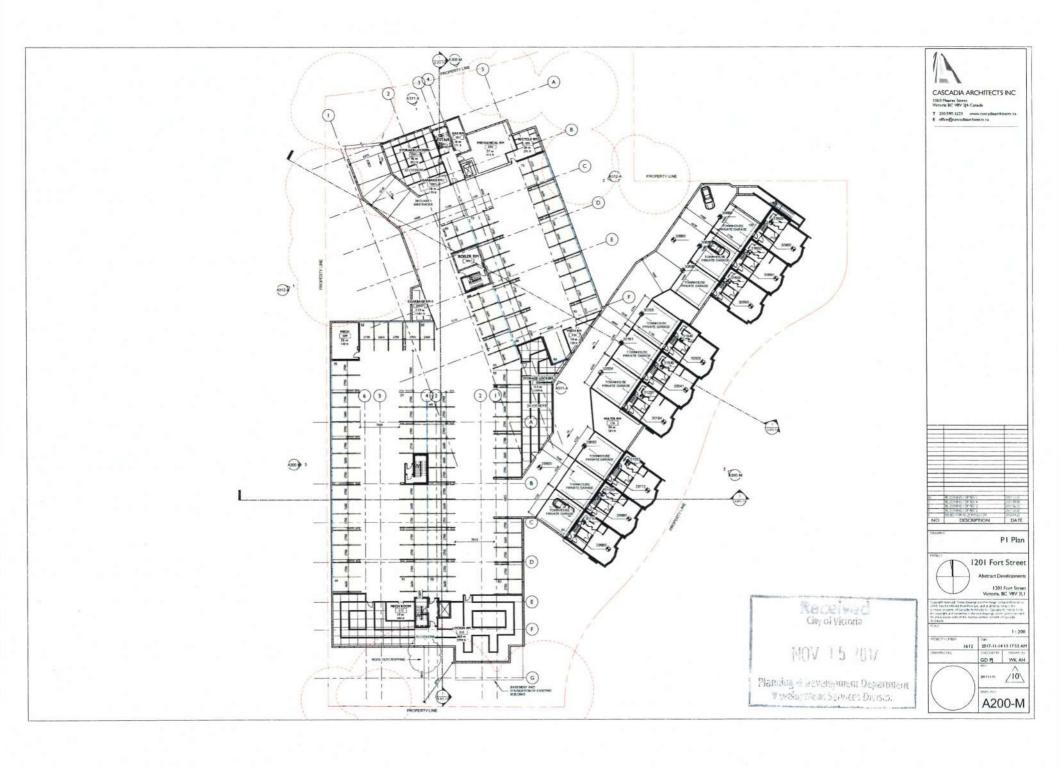




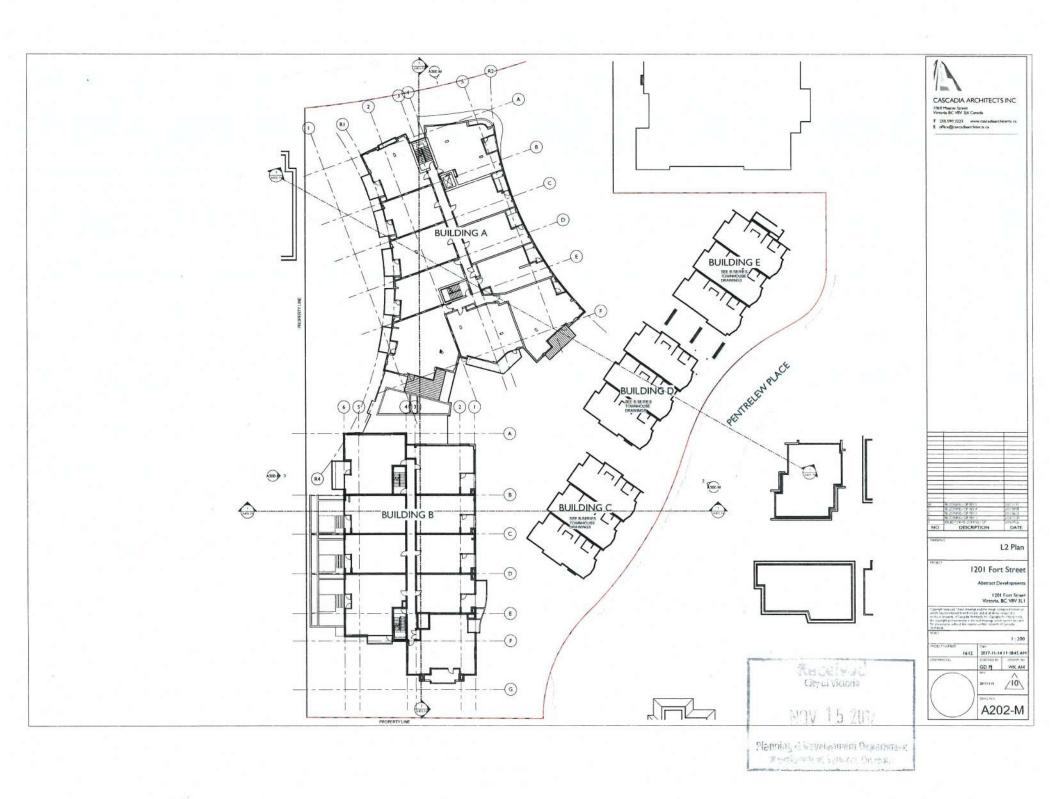



Site North Elevation - Fort

HISTE ÉLEVATION PLUETRATES EXISTING MATURE TREES, FON PROPOSED LANDECAPRIG ÉES LANDSCAPE DRAWNICS

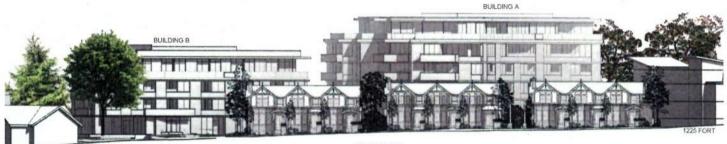

1010 PENTRELEW

TOWNHOUSES

Site East Elevation - Pentrelew

NOTE: ELEVATION ELLUSTRATES EXISTING MATURE TREES, FOR PROPOSED



1225 FORT (beyond)

BUILDING A

BUILDING B

1010 PENTRELEW

3 Site West Elevation - Linden

NOTE ELEVATION ILLUSTRATES EXISTING MATURE TREES, FOR PROPOSES

1

CASCADIA ARCHITECTS INC 1060 Heaves Street Victoria BC VBV 1)8 Canada

T 250,590,322) www.coscadi E s#Ce@bracedosechitects.co

> NOTE SET PIDATEMAL BUILDING ELEVATIONE FOR REVISIONS

#25.00.00 (1995)

#25.00.00 (1995)

#25.

Context Elevations

.....

1201 Fort Street

Abstract Developmen


1201 Fort Str Victoria BC VRV


Copying transition from the large and the strop consequent to time or park thing the interest services are upon a factor amount of the control of the contro

1 ± 200 IOSCTTURNER | 15HF IGE2 | 2017-11-29 12:16-58 PM

GD PJ WX AH


A300-M

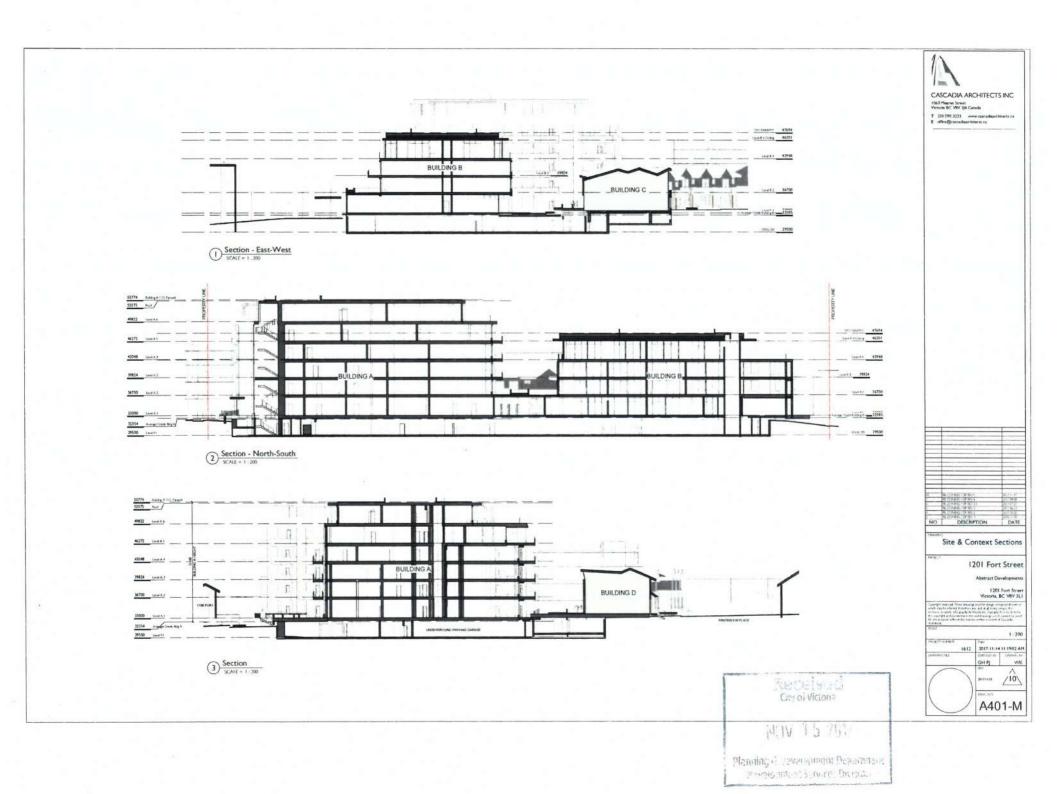


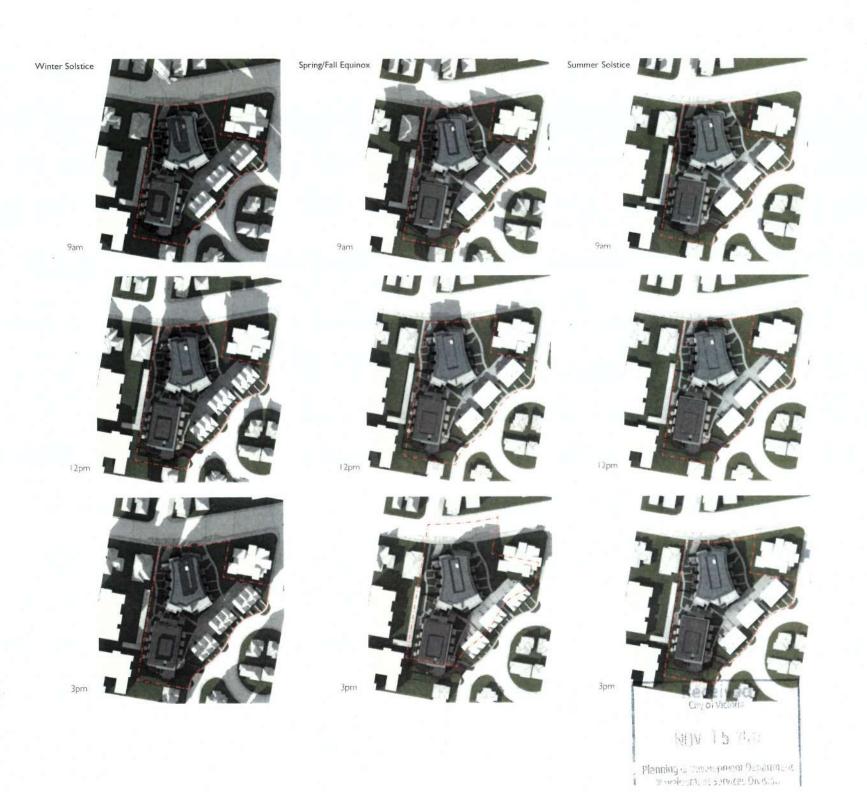





A503-M

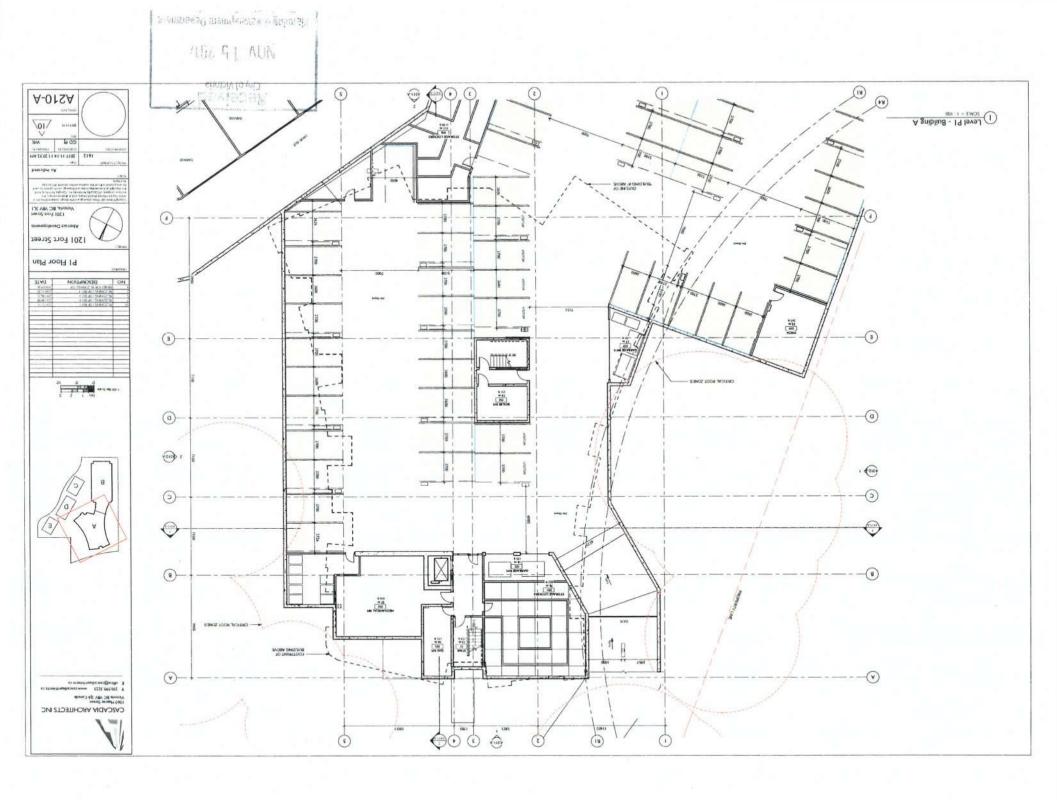


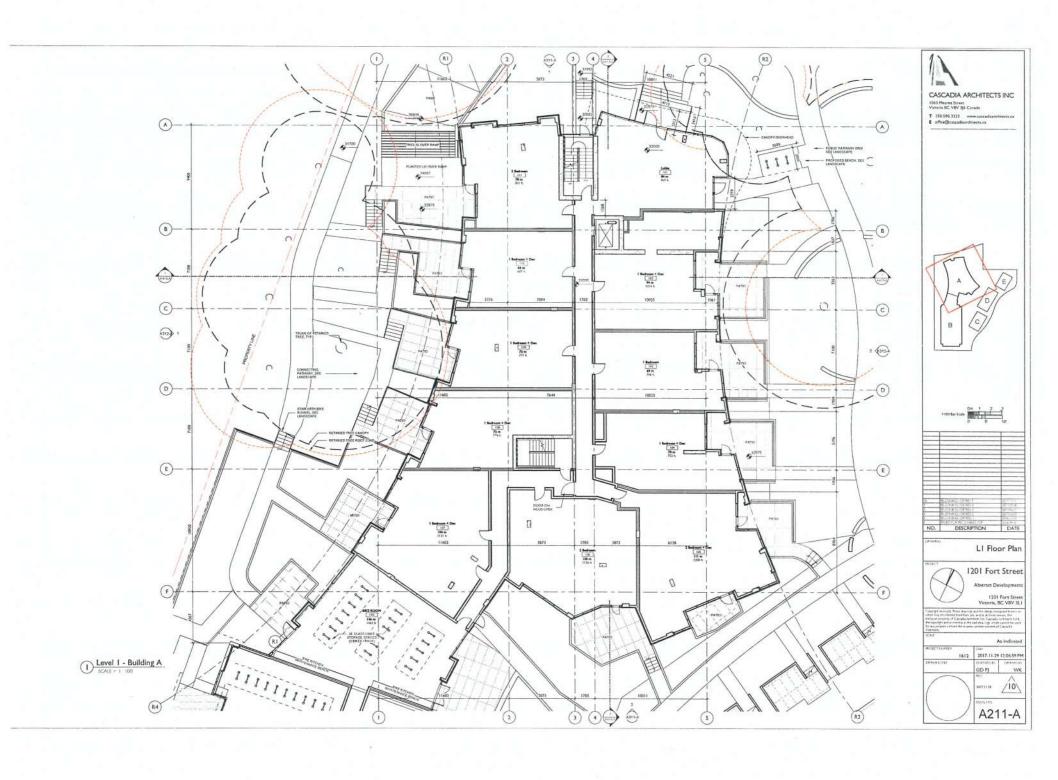

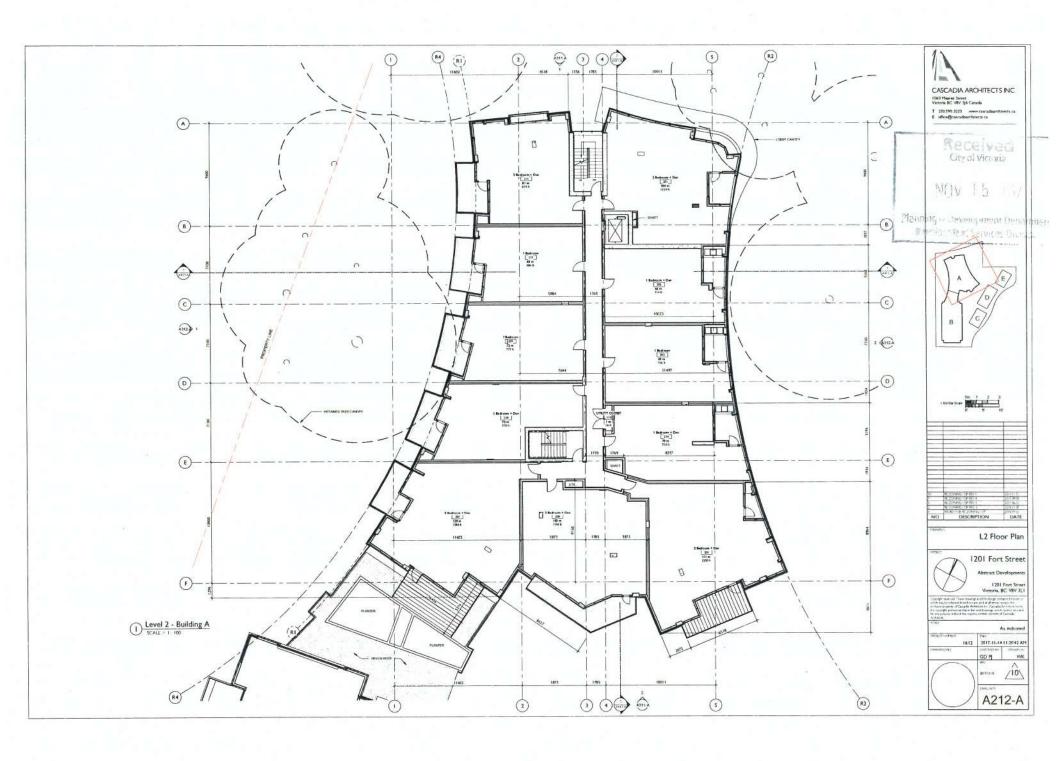



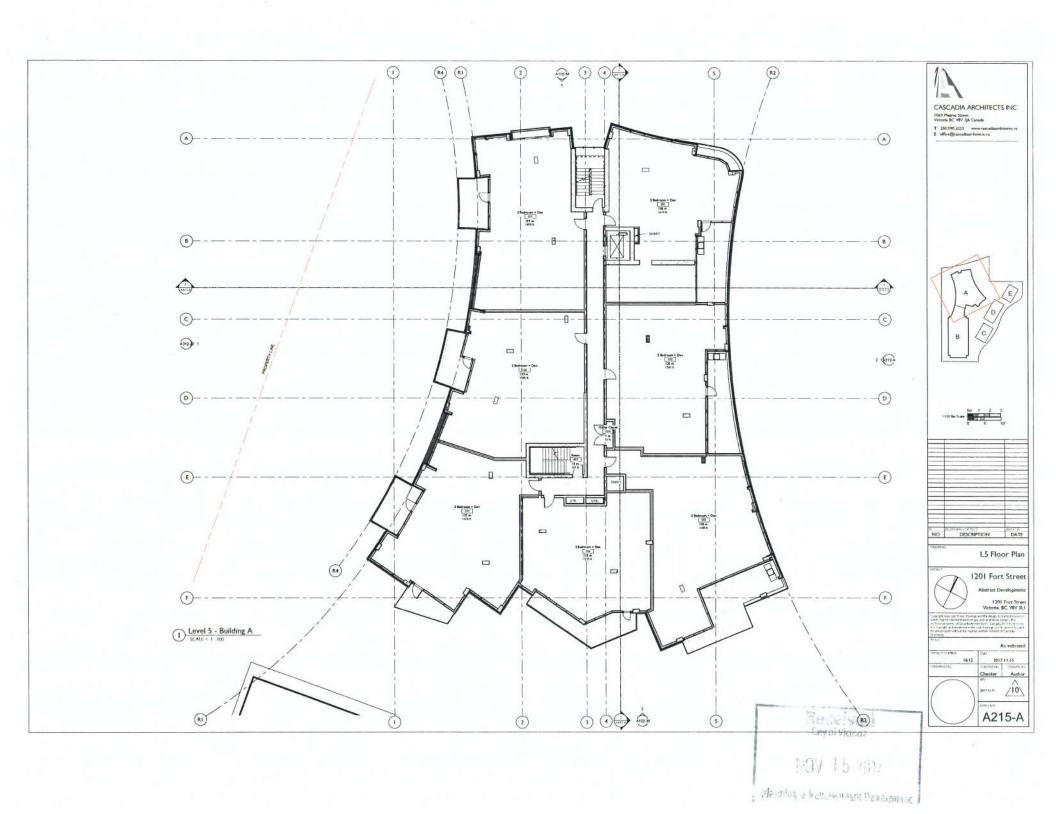


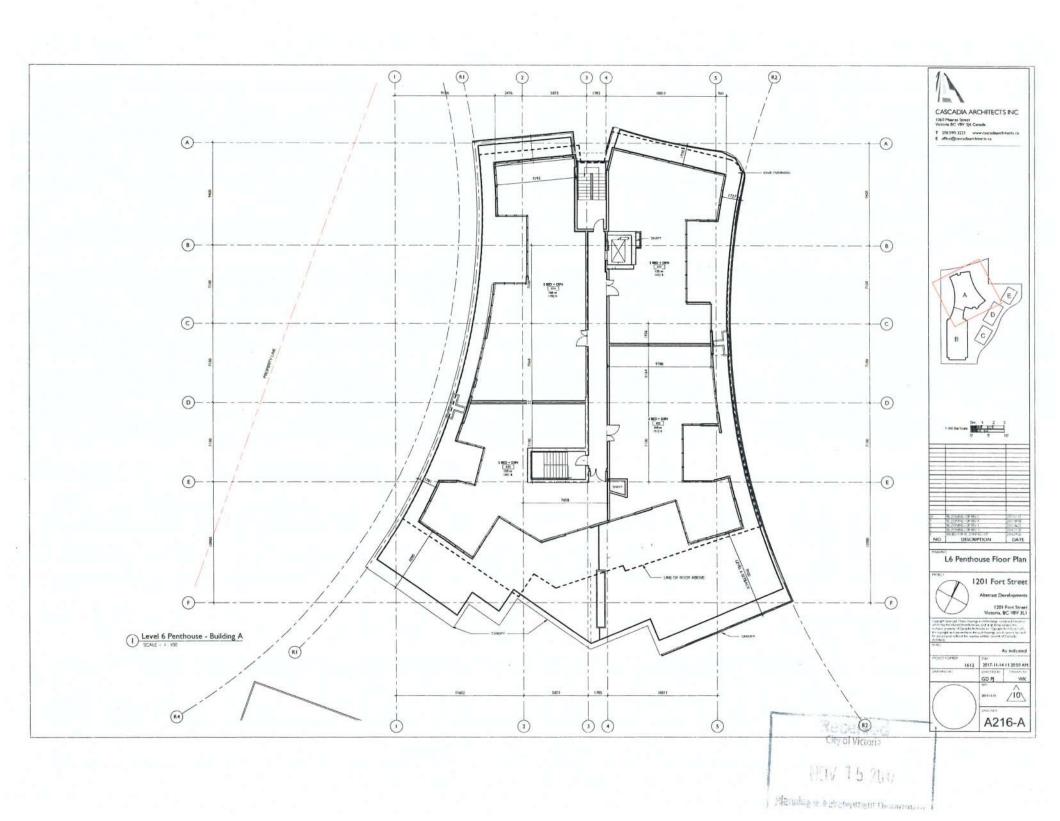








Manufaces New resument Department

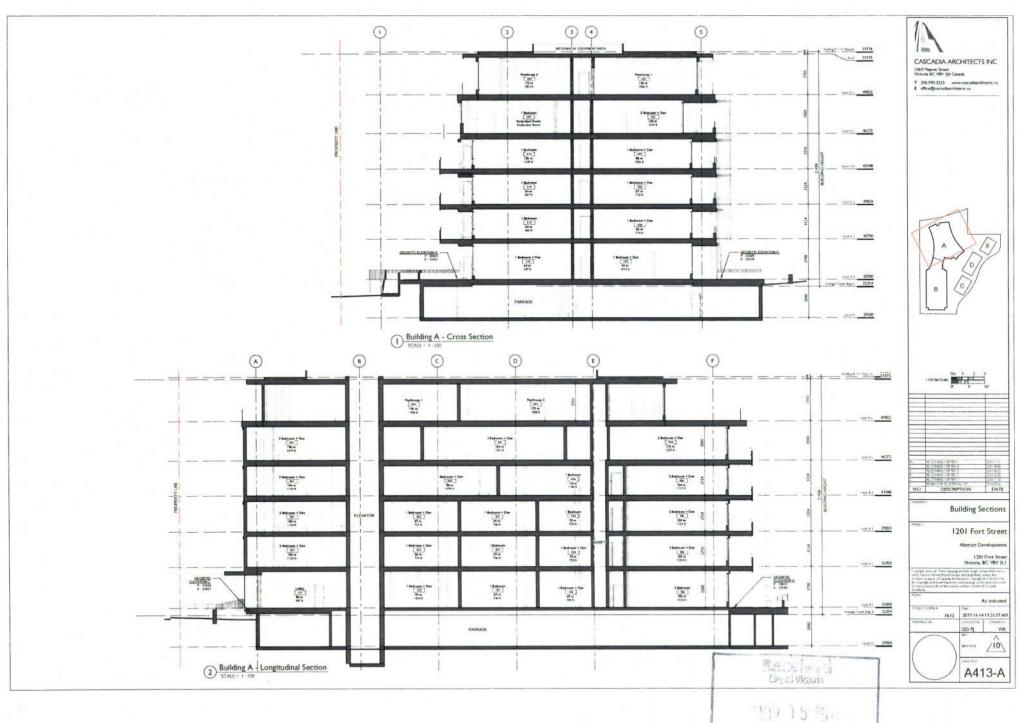



Manda, es helver punsur Department Fresholder, someter Guide

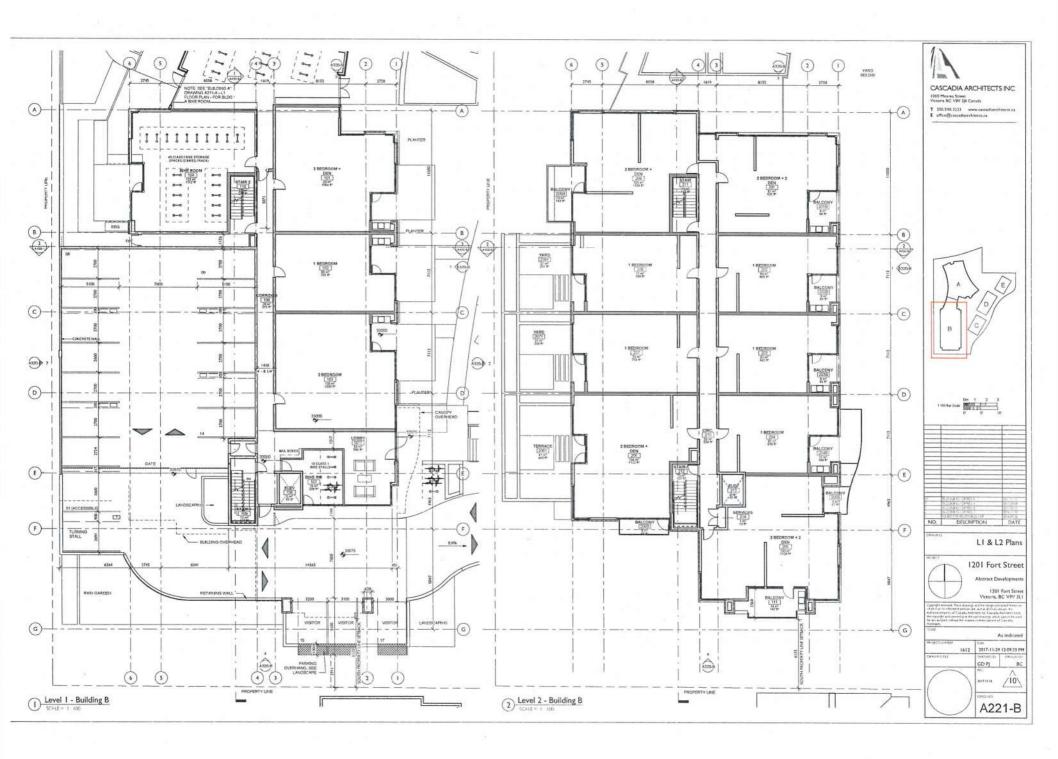

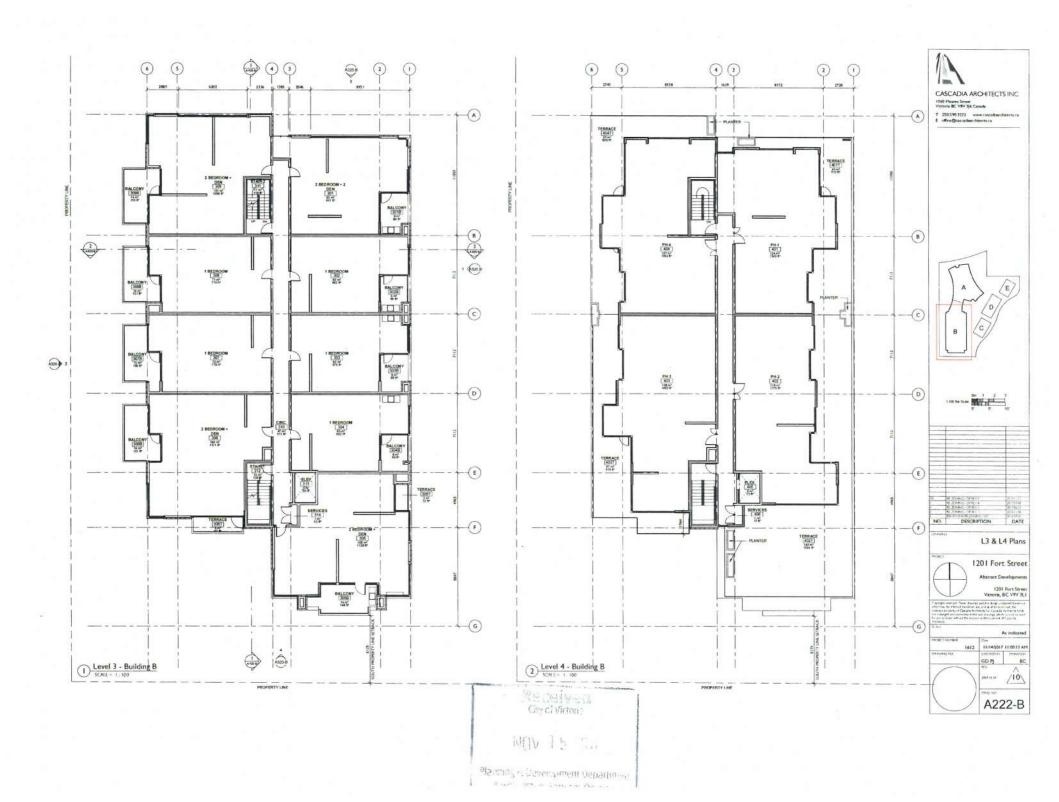


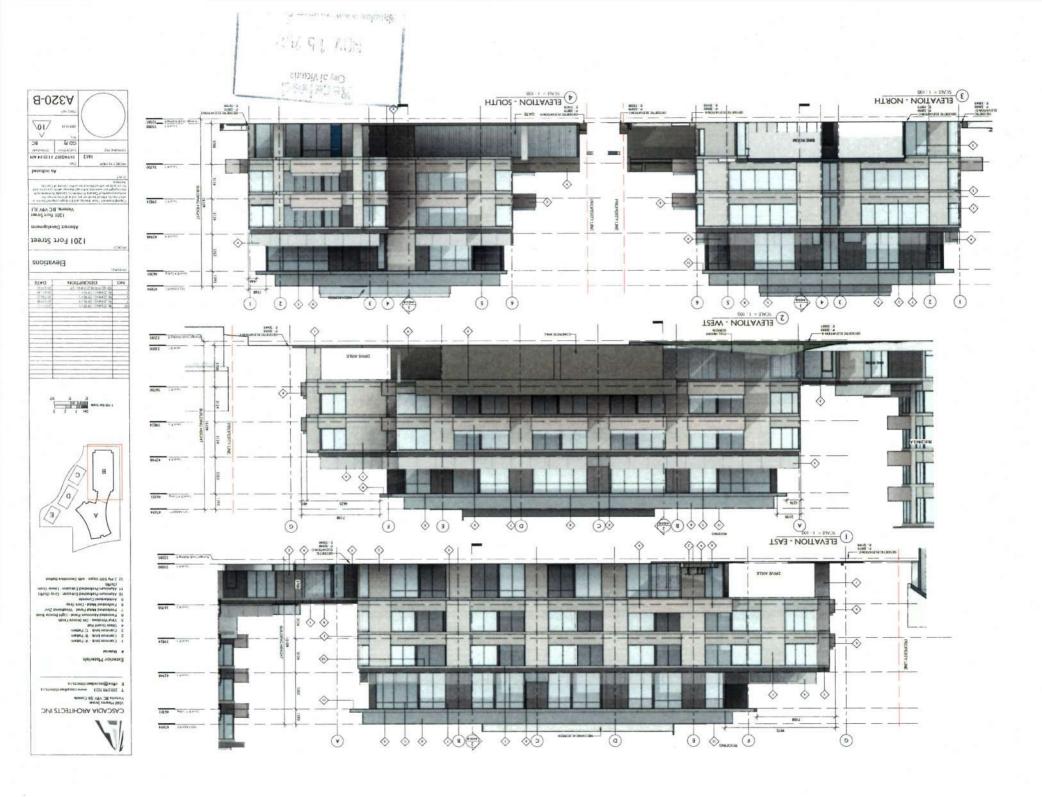

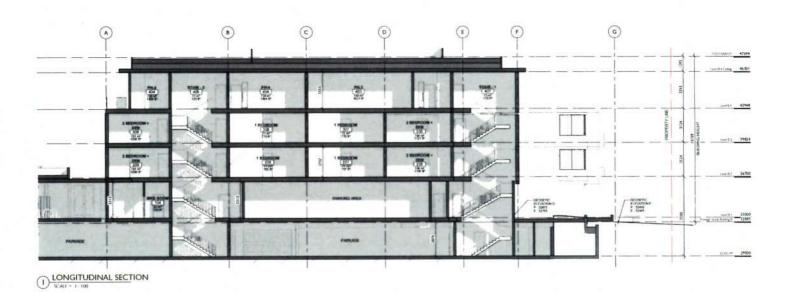

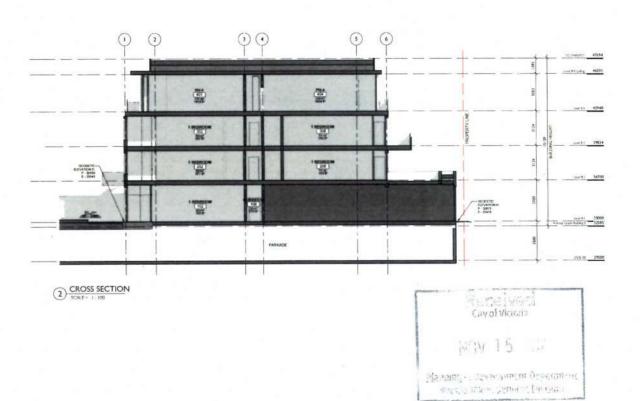



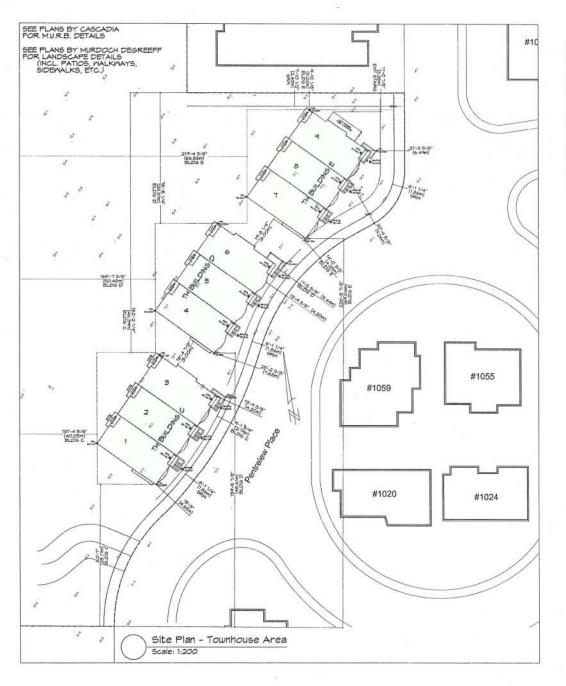



DRAWING LIST:

B101 SITE PLAN & LOCATION MAP B102 AVG. GRADE CALCULATIONS

4 TYPICAL SECTIONS

B201 BUILDING C PLANS B202 BUILDING D PLANS


B203 BUILDING E PLANS

B301 BUILDING C ELEVATIONS

B302 BUILDING D ELEVATIONS

B303 BUILDING E ELEVATIONS B401 COMBINED FRONT

ELEVATIONS

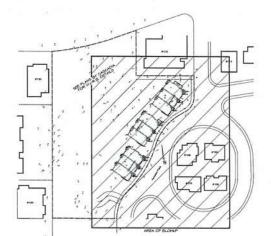

Site Plan Key Scale: 1:750 RE-ISSUED FOR REZONING & DP NOV. 30, 2017



1161 NEMPORT AVE Victoria, B.C. V85 5E6 Phone: (250) 360-2144 Fax: (250) 360-2115

Drawn By: K, KOSHMAN/ G, COLLINS


Date: SEPT 26, 2016 Scale: AS NOTED

Project: PROPOSED TOWNHOUSES 1201 FORT ST.


DV. NO.	DESCRIPTION	DATE
1	REVISED F OF THE TO TEXNITE REVISE SITE TO SUIT, REHOVE DRIVE ASSET REAR YARD PARKNO	NOV 90/16
2	ADJUST MEES TO ALLOW FOR CONCRETE TOPTING: REVISE HAN FILLOW PATIOS	FEB. 02/11
9	REVISED & OF THIS TO SO UNITS, REVISE SETSACKS TO SUIT	JN 25/11
2.1	NO CHANGES	35, 3101
4	REVISE INTS 1 & B. REVISE BLDG E SETBACKS	SEPT. OUTT
	MENTER THE CO. I ELECTRONS I SETTEACH. I OF INTER THE DEVINED. THE CO. INTEREST IN MENTER PATOS, LEVATON MENTER REVISED TO BUT, ENTER DEVINENCE REVISED SOUTH SERVICES OF THE CHIEF OF MENTER I SETTEMBER.	NOV. 15/11
9.4	NO CHENOM	MOV BOUT

Revision	Sheet:


BUT-MACH	B
750 02/TI 25: 29/TI 41: 29/TI	101
HOV WATE	Proj No. TBD

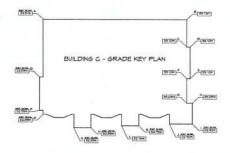


			TH Bldg	C - Average	Grade Calc	uistion		
								Average grade (tetal factors /
SEGMENT	Steet	Finish	Average	Distince	Factor	Total Factors	Passenter	perimeter)
AB.	32.61	33,12	25 #1	19.20	632.93	2241 98	68.33	32.811
BC .	33.12	:33.10	33.11	3.72				
CO	33.10	33.10	33.10	0.46	15.23			
DE	33.19	23.15	33 10	4.27	181 34			
EF:	33,10	23.10	33.10	0.45	15.23			
FG	33.50	39.04	33.07	3.29	109.80			
GH	33 04	23.05	33 65		25 11			
16	33.05	32.00	32.50	2.82	92.99			
JK KL	32 00	32.90	32.50	3.08	100.67			
x	32.90	32.75		4 11	134.91			
KX.	32.75	32.76	32.76	2.35	75.34			
1.84	32.76	32.35	32.56	4.11	133.60			
1/14	32.35	32.35	32:35	9.30	74.41			
193	32.35	32.33	32.36	4.48	144.63			
DP.	32.35	12 35		0.70	22.65			
PO	32.35	32.53		9.45			BLBG-C	
DA	32.55	32.91	32.67			Aure	PRAGE GR	ane:
Lore.	40.00	22.81	TOTAL	68.33	2241.08	Mys	32.21	NUC.

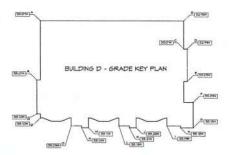


			TH Bldg	D - Average	Grada Calc	ulation		Average grade
SEGMENT	Start	Finish	Average	Distance	Factor	Total Factors	Parimeter	(fow factors /
AB	33.07	12.91	33.00	19:20	633.60	2237.50	#75	35.07
BC .	32.93	33.61	32.97	3.72	122 45			
CD	33.01	52.95	33.00	0.48	15.15			
DE	32.00	23.65	33.62	4.27	141.00			
EF:	30.05	33.09	76.07	2.85	84.25			
FG	33.06	53.18	33.14	3.37	711.68			
GH	33.18	33.18	33:18	1.18	55.76			
H	33.18	23.16	33.16	5.56	61.72			
12	33.19	23.73	33.21	2.11	136.49			
36	25.23	33.21	33.52	0.92	30.56			
ko,	33.25	33.18	33.20	1.41	46.60			
1.34	33.19	33.11	33.15	4.11	156.23			
NAME .	33.11	33.10	33.11	0.91	30.13			
NO	33.10	33.06	33 09	1.41	40.66			
OP	33.08	35.10	33.09	4.23	139.97			
PQ	23:10	33.10	33 10	0.78	23.17			
OR	33.10	33.10	33.10	4.45	147.35		BLDGO	
PA.	23.10	33.07	33.09	7.84		AVS	PAGE GR	ADE
			TOTAL	67.5	2232.50		33.07	

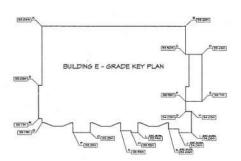

			TH Bldg	E - Average	Grade Calc	ulation		Average grade
SEGMENT	Start	Fresh	Average	Distance	Factor	Total Factors	Parmeter	(total factors /
AB	33.04	33.23	33.14	19.25	635 to	2395.78	71.72	33 405
BC	31.23	33.50	33.37	3.72	124 12	A1995 / M		32.40
ĈD	33.50	33.45		2.18	72.95			
DE	33.43	33.71	23.67	6.20	206 13			
EF	33.71	23.95	33.62	2.18	25.73			
ra	21.93	34 03	33.50	1.36	46.21			
GH	34.03	34.03	34.03	0.76	25.88			
H	34.03	34.06	34.05	2.62	96.01			
ET.	34.06	34.08	34 05	1.68	57.22			
JK	34.08	34.06	34 06	1,47	56.07			
K).	34.06	33.94		4,13	180.42			
1.54	33.54	33.62		0.01	20.66			
1,004	33.82	53.85		1.41	47,57			
NO	33.55	23.26	33.40		197 27			
DP .	33.16	33.25	33.25	2,50	76.43			
PQ ON	23.25	33.19	33.22	4.20	142.85			
90	33 19	33.17	33.18	0.70	23.23			
ns	33.17	33:08	23 15	4.45	147.41		BLDGE	
5A	33.08	33.94	33.04	7.84	250.19	AVI	FRAGE GR	ADE
			TISTAL	25.72	2395 78		33.45	

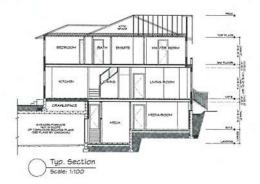

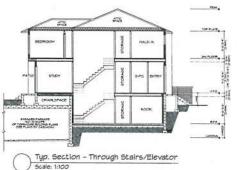

REV. NO. DESCRIPTION

REVISED AVG. GRADE CALCE: REVISE THE SECTIONS TO ADD PARKADE ADJUST SECTIONS TO ALLON FOR CONCRETE TOPPINS

REVISE SRADE HEY AND AVE. GRADE CALCULATIONS. REVISE SECTIONS TO SIXT FLAN CHANGES.
NO CHANGES

REVER BUILDING DIE AVG. GRADE AVDRAGE GRADES, SECTIONS REVEED, ELEVATOR REHOVED

Scale: 1:100

ZEBRADESIGN 1161 NEWPORT AVE Victoria, B.C. V85 5E6 Phone: (250) 360-2144 Fax: (250) 360-2115

RE-ISSUED FOR REZONING & DP NOV. 30, 2017

Drawn By: K. KOSHMAN/ C. COLLINS


Date: SEPT 26, 2016

Project: PROPOSED TOWNHOUSES 1201 FORT ST.

TILLE: AVERAGE GRADE CALCULATIONS & TYP, SECTIONS PTB. 02/11 AN. 29/17


REVISION
ST STATE STATE
STATE
STATE
STATE B 102 507T, 01/11 HOV, 15/11 Froj.No. TED

JS_ 21/17

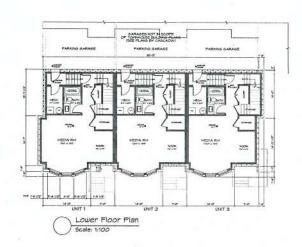





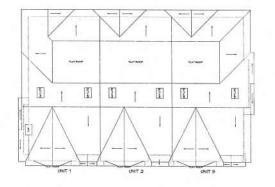

Roof Plan Scale: 1:100


		Victoria, E Phone: (2)	IPORT AVE 3.C. V85 5E6 50) 360-2144 0) 360-2115
		Drawn By:	K. KOSHMAN/ G. COLLINS
		Date: SEPT	26, 2016
		Scale: AS N	OTED
		Project:	SED
DESCRIPTION.	DATE	TOWNHO	DUSES
EXPOSED 4 OF STARS TO FECURE INTERV. BEVIOLE SIGN. OF AND, BEIOGR. 6-MANGE TO AND PARKAGE, REVIEE LOWER FLOOR TANN TO SHE REVIEE MAN FLOOR PARTOS. REVISE FLOOR TANN TO SHE 1 OF MITS FIRE BLOOL UNGUT CHANGES. 10 MITS FIRE BLOOK DEVISION, EXPLISE MAN. REVIOLE BLOOP DEVISION, EXPLISE MAN.	HOV BOVIE PESS 02/11 JAN. 25/11 JAL. 27/11 SEPT. 01/11	1201 FC Title: BUILDIN FLOOR	60
FLOOR KITCHEN LAYOUT, ADD HADON TO PONDER ROOM, REVISE 2ND FLOOR, BATHROOM LAYOUTS	Die William	Revision:	Sheet:
REMOVE THE FLOOR AND DECK, CELING HER STATE TO THE STATE OF THE STATE	NOV: 15/11	#17 NOW WORK NOW	B 201
HINDONS REVISED TO BE CONSISTANT	NOV. 30/17	NOV BUT	Proj No, TBD

REV. NO. DESCRIPTION


RE-ISSUED FOR REZONING & DP NOV. 30, 2017

ZEBRADESIGN



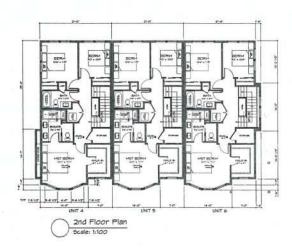



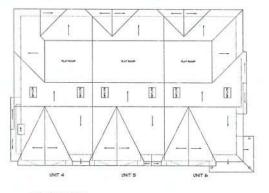


Roof Plan Scale: 1:100


			Victoria, E Phone: (2)	PORT AVE 3.C. V85 5E6 50) 360-2144 0) 360-2115	
				K, KOSHMAN/ C. COLLINS	
			Date: SEPT	26, 2016	
pescarron	- 1	DATE	Scale: AS N	KOTED	
REVISED I OF STARS TO PRIO REVISE DECK TO PATO, REHO SARASE TO ADD PRIVADE II LOMER FLOOR PLAN TO SIT REVISE HAN FLOOR PATOS	NT ENTRY NE	10V 80/16 108. 02/11	Project: PROPOSED TOWNHOUSES 1201 FORT ST.		
# OF INTO PER BLDG. LAYOUT TO FLOOR PLAYS AND ROOF	CHANGES .	IN 25/11	120110		
NO CHANGES		at. 21/11	Title		
REVISE MAN FLOOR KITCHEN I ADD PREDON TO POMBER RO NO PLOOR BATHROOM LAVO BAY REVISE TO JEO PLOOR BORHS, REVISE ROOFLINE TO BAYS: CHANGE DOWNER, RE PROOF DOWNER, RE PROOF DOWNER, RE PROOF DOWNER, RE PROOF DOWNER, RE	OM REVISE UTS ADD HASTER BUT HEN HP ROOF:	NPT OUT	BUILDIN	PLANS	
RIMOVÉ DED FLOOR 4 DECK- HOURT IN INTERE FLOOR CHAN BYLLING LOW-BED, LEDY-AND HARKERS, DURIN STARES AND HARKERS, DURIN STARES AND SCHOOL TO SATTE OF INTO B SCHOOL TO SATTE HART T, SO PARRACE THAN BY CARCADA PARRACE THAN BY CARCADA SHAFT REPOYED PROM ALL F	PATION TO LAYOUT RADES/	NOV. 15/11	Revision	B 202	
PRIDONS REVISED TO BE CON	SISTANT P	17/08 .VOH	ADV BUT	Proj.No. TBD	

5,1


RE-ISSUED FOR REZONING & DP NOV. 30, 2017

ZEBRADESIGN

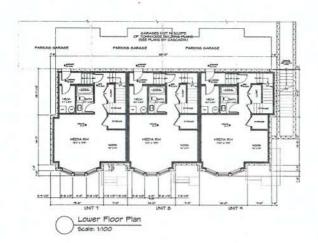

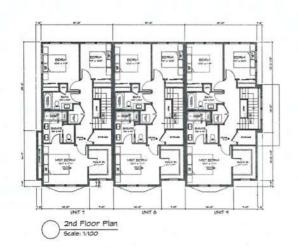



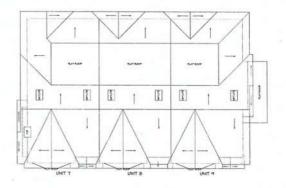

Roof Plan Scale: 1:100

	1161 NEWPORT AVE Victoris, B.C. v85 556 Phone: (250) 360-2144 Fax: (250) 360-215
	Drawn By: K. KOSHMAN/ C. COLLINS
	Date: SEPT 26, 2016 Scale: AS NOTED
0/16 02/11 5/11	Projecti PROPOSED TOWNHOUSES 1201 FORT ST.
1/11 01/11	Title: BUILDING E FLOOR PLANS

B 203 Proj No, TBD

THE PROPERTY OF THE PROPERTY O


REMOVE SED FLOOR & DECK, CELING HOSHT IN UPPER FLOOR GRANSED TO

PRODUE REVEED TO BE CONSISTANT METH ELEVATIONS: ROOF PLAN REVEED

RE-ISSUED FOR REZONING & DP NOV. 30, 2017

ZEBRADESIGN



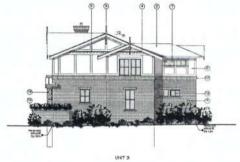


		•	9 1		
PER TO STORY OF THE STORY					4
to the first of th	WHI				
	31	HH .			Z.L.
9 99	RE.	9	90	- The fire	



STANICE ACMA CASE	Unit.1		Unit 2	100	Unit 3	
Frant Lim. Distance building foce area glisting sets persessing	Impersil > 19.68 480.46 98.42 20.49%	Metric > 6,00 44,64 9,14	Imperial > 19.68 462.81 98.42 21.26%	Metric > 6.80 43.00 9.14	Imperial > 19.68 444.83 98.42 22.13%	Metric > 6.00 41.32 9.14
Lin. Distance turbing face area glaring area presentings	n/a		n/a		Imperial 8.20 866.07 63.75 7.34%	Metric 2.50 80.65 5.62
Line, Distance Line, Distance building foce area glasting area phreadings	Imperial 17.22 447.56 111.90 25.00	Metric 5.25 41.58 10.40	Imperial 17:22 432:33 111:60 25:88%	Metric 5.25 40.17 10.40	Imperial 17:22 426:56 111:50 26:23%	Metric 5:25 39:63 10:40
County Life, Distances incitating there are a glaring heme	Imperial 6.56 927.00 65.88 7.11%	Metric 2.00 86,12 6.12	n/s		n/a	

Rear Elevation Scale: 1:100

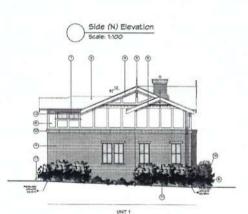

Side (S) Elevation Scale: 1:100

			Drawn By: 1	C. COLLINS
-			Date: SEPT	26, 2016
MEY, NO.	DESCRIPTION	DATE		
- 1	REVISED & OF STARS TO FRONT ENTRY,	1407/30/16	Scale: AS N	DIED
	REVISE DECK TO PATIO. PARKING REVISED TO PATILADE. RAISE ROCK BAND AROUND BLDG, REVISE SLASING CALCO.		Project:	SED
2	ADJUST ELEVATIONS TO ALLOW FOR	PED 02/11	TOWNHO	
	REVISE ELEVATIONS TO RECONTINUES * OF UNITS PER BLIDG, RECESSION EXTERIOR OF ALL THINTS	JN 25/11	1201 FO	
2.1	ADD 200 HESHT FROM THE AVERAGE SHADE" CLARETY HESHT FROM THILDING AVERAGE GRACE"	JAL 21/11	Title:	11000
1	RIMOVE I ROOF DORHON, REVINE MAN FLOOR & PATCH AND HINDON TO FORDER ROOM, REVINE SLAEMS; SLAMSE TO METAL ROOF CYCE DIRNO BLAMOUT, REVISE GLAMOUT OF DETAL	58PT, 01/11	BUILDING	
. 6	IND FLOOR AND ROOF DECK REHOVED:	NOV. 15/11		
	FIG. MADONE REVISED TO BUT ROOF		Revision:	Sheet:
	CATH BUNATON SINEED TO MATCH BUILDING E HINDON ADDED TO UPTER FLORE ON NORTH LEVATION, INT 5 FLANTER EXTENDED TO MATCH VERNING HOUSE TO MATCH VERNING HOUSE		TO SOUTH	В
81	ALL FASCIA'S REDUCED FROM 12 TO 10 NOHES, ENTRANCE SHEETS FOR UNIT 1 & 5 CHANGED TO GABLES, HINCR REVISIONS	NOV, 50/17	**************************************	301
	TO PRODUTEM ON SIDE AND REAR ELEVATIONS, FRIALS REMOVED FROM REAR SABLES		MOV SOITS	ProjNo. TED

RE-ISSUED FOR REZONING 4 DP NOV. 30, 2017

ZEBRADESIGN

1161 NEMPORT AVE Victoria, B.C. V85 5E6 Phone: (250) 360-2144 Fax: (250) 360-2115

- FINSH SCHEDULE KEY

 ① STANDING SEAH METAL ROOFING
- (2) ASPHALT/FEERSLASS SHINGLE ROOFINS
- ® DECORATIVE FINAL
- POOD PASCIA AND TRM (PANTED)
 DECORATIVE DENTILES
- (6) METAL PICKET RAILING
- O DESCURED SLASS AND METAL PRIVACY SCREEN
- (B) CEMENT BOARD PANELS (

- © CENTRY BOARD PARES 1

 © BRUK VENER

 © BRUK VENER CHANEY

 © VINT, IMPORT PREFINANCY

 © VINT, IMPORT PREFINANCY

 © VIND POOR NITH CAUSE (STANEY)

 © VIND POOR NITH CAUSE (STANEY)

 © SLIPNS GLASS DOOR, PREFINANCH

 © VIND POOR NITH CAUSE (STANEY)

 © SURVEY LANDER

 © CONCRETE STANS


 © CONCRETE STANS


 © CONCRETE PARIO

 © LIGHT FORTIRE

 © SKYLITE



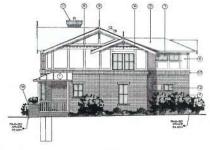

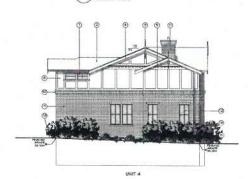

RE-ISSUED	FOR
REZONING	4 DF



Proj.No. TBD

			Drawn By:	K KOSHMAN/
NO.	DESCRIPTION	DATE		
	REVISED 4 OF STARS TO FRONT ENTRY, REVISE DECK TO PATIO PARKING	HOV SO/IN	Date: SEPT	26, 2016
	REVISED TO PARKADE RASE ROCK BAND AROUND BLDD REVISE SLAZING CALCO		Scale: AS N	IOTED
1	ADJUST ELEVATIONS TO ALLOW FOR CONCRETE TOPPING	FEB. 02/11	Project:	
	REVISE ELEVATIONS TO RECONFIGURE FOR UNITS FER BLDG; REDESIGN EXTERIOR OF ALL TH UNITS	JN. 25/11	TOWNHO	
1	ADD THE HEIGHT PROH "SITE AVERAGE GRADE", CLARETY HEIGHT FROM THUDNS AVERAGE GRADE"	AL 2971	1201 FC	RT ST.
	REMOVE I ROOF DORWING CHANGE DORWING TO HP ROOF, REVIEW MAN FLOOR, & PAID, ADD INDIDAY TO POPTOR ROOM, REVIEW SLADING, CHANGE TO HETAL ROOF OVER SHING SIMPORT, REVIEW CHANGE TOP DETAL. ADD BAYS TO THE FLOOR, 4 ADJUST, ROCKING REVISE AND, SRACES & HIGHET	SEPT. 01/11	Title: BUILDIN ELEVAT	
	SED FLOOR AND ROOF DECK REMOVED. HYPER FLOOR CELLING REMOVED IN 8-0° FRINCIONS REVISED TO BUT ROOF PITCH CHANGED GLADED CALC REVISED. LOVERED NO. BUTCH AND GLADE NO. LOVERED NO. BUTCH AND GLADE SERVED. BEYATION THE REVISED TO SHIT! HOUGH ADDED TO JETTER FLOOR ON NORTH ELEVATION.	NOV. 15/11	Revision:	Sheet:
if	ALL FASCIAS REDUCED FROM 12 TO 10 NOISES. ENTRANCE SHED FOR INST B. CHANDED TO GABLE, MINER REVISIONS TO MOOD TRIM ON SIDE AND REAR	NOV. 50/11	42V 31 42V 31 42V 4 560T (010T)	302
	BLEVATIONS, FNIALS REMOVED FROM REAR GABLES		*EV 51 NOV 10-11	Proj.No. TBD

FINSH SCHEDULE KEY

① STANDING SEAM METAL ROOFING (2) ASPHALT/FBERGLASS SHINGLE ROOFING DECORATIVE FINAL
 MOOD FASCIA AND TRIM (PAINTED)
 DECORATIVE DENTILES (6) METAL PICKET RAILING O METAL PRIVACY SCREEN (EMENT BOARD PANELS I BRICK VENEER
 BRICK CORNCE PETAIL (I) BRICK VENEER CHIMNEY

BRICK VENERK CHARGE
 VINIL PRIOCH, PREFINSHED
 MOOD DOOR NITH GLADIS (STANDE)
 LIDING GLASS DOOR, PREFINSHED
 MOOD CHARGE BRACKETS (PAINTED)
 BRICK PLANTER.
 CONCRETE STARS.

⊕ CONCRETE PATIO ⊕ LIGHT FIXTURE ⊕ SKYLITE

	9	9 6)			ř
10		0	1			PL.
				HH		0
					HH	
100	The ne		His pla		14-14	NI =
	INIT 4		at 6.		7.4	

Front Elevation Scale: 1:100

Freez Lim. Dostance sulfiding face area glazing area percentage.	Imperse/ > 19 68 446 35 102 98 23 07%	Metric > 6.00 41.47 9.57	/mpenal > 19.68 435.15 102.98 23.67%	Metric > 6.00 40.43 9.57	Impenal > 19.65 423.69 102.98 24.29%	Atetric > 6.00 39.38 9.57
South Lim. Statement building face area placing area percentage	n/a		n/a		Imperial 9.84 821.45 63.70 7.75%	Metric 3.00 76.32 5.92
Boor anthork halding fore area glisting area percentage	Imperial 17,22 421,31 111,90 26,56%	Metric 5.25 39.14 10.40	17 22 406.08 111.90 27.56%	Metric 5 25 37.73 10.40	2mpersel 17.22 400.33 111.90 27.95%	Neitric 5 25 37.19 10.40
South Lim, Butance Soliding face avea	Imperior 6.20 872,39	Motric 2.50 81.05	n/a		n/a	

Claring Area Case. Unit 4

Rear Elevation Scale: 1:100


Side (S) Elevation Scale: 1:100

HIL			
		Ш	Alexander (
			Maga-
		UNIT 6	
		5.4	
	Side (N) Elevatio	<u>n</u>





Side (N) Elevation Scale: 1:100

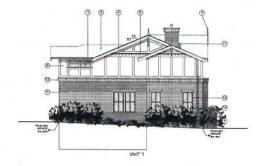

RE-ISSUED FOR
REZONING & DP
NOV. 30, 2017

ENSH SCHERGLE KEY

① STANDING SEAM HETAL ROOFING

② ASPHALT/FEBERGLASS SHINGLE ROOFING

 DECORATIVE PINAL
 POOD PASCIA AND TRM (PANTED)
 DECORATIVE DENTILES
 METAL PICKET RAILING O METAL PRIVACY SCREEN (EMENT BOARD PANELS I

(1) BRICK VENERR
(2) BRICK CONNER DETAIL
(3) BRICK VENERR CHANGY
(3) VANT, WADDON, PREFARENCE
(3) WOOD DOOR WITH GLAZING (STANED)

(S) WOOD DOOK WITH GLADAY (STANDE)
(S) MOOD INSEE BRACKETS (PANTED)
(S) BRICK PLANTED
(C) CONCRETE STAND
(C) CONCRETE FATO
(D) LIGHT FORME
(E) SKYLITE



1161 NEMPORT AVE Victoria, B.C. V85 5E6 Phone: (250) 360-2144 Fax: (250) 360-2115

	(9
Scale:	1:1

1	Side (S) Elevation
	Scale: 1:100

REV. NO.	DESCRIPTION	DATE	Drawn By: K. KOSHMAN/ C. COLLINS		
1	REVISIO * OF STARS TO FRONT ENTRY. NEVISE DISER TO PATO PARAMS REVISIO TO PARAME RASE ROCK. BAID AROAD BLDS: REVISE GLAZINS GALCS	HOV 50/16			
			Date: 9EPT 26, 2016		
2	ADJUST ELEVATIONS TO ALLOW FOR	FEB. 02/11	Scale: AS NOTED Project: PROPOSED TOWNHOUSES 1201 FORT ST. Title: BUILDING E ELEVATIONS		
3	REVISE ELEVATIONS TO RECOMPINES 1 OF UNITS FER BLDG: REDESION EXTERIOR OF ALL TH INTE	JN, 23/11			
9.1	ADD 200 HEGHT FROM "SITE AVERAGE GRACE", GLARPY HEGHT FROM "BULDING AVERAGE GRACE"	AL 27/11			
•	REMOVE LROOF DORWING CHANGE DORWING TO HP ROOF, REVISE HAN FLOOP & PAYO, ADD PRICOR TO POYDER ROOM, REVISE GLASHIS GHANGE TO METAL ROOF OVER DINNS SHAMOLT, REVISE DINNIEST TOP DETAL. ADD DAYS TO JUD FLOOR LADJEST ROOFLINE REVISE AND - SHADE LIBBOHT	SEPT. DIAT			
	SED FLOOR AND ROOF DECK REHOVED UPFER FLOOR CELING REDUCED TO 3-01 HISTORIC REVIEWD TO SUIT ROOF PITCH CHANGED, SLAZING CALL REVIEWD.	NOV. 19/17			
	BILDING LOVERED IN BUTTY AND PATO ROSES BLEVATION TREE REMISED TO SET IN MOCH ADDED TO IMPER PLANER EXTENDED TO MATCH VERAIDAL ON IMP &		Revision:	Sheet:	
9.1	ALL FASCAS REDUCED FROM 13 TO 10 NO-HIS. BYTRANCE SHEDS FOR MIT 1 # # CHANGED TO BABLES VISION REVISIONS TO MODE THAN ON HIDE AND REAR BLEVATIONS FROM SEAR BLEVATIONS FINALS REMOVED FROM REAR BABA BABLES, PRODUCES N. HTTER	NOV. 50/11	100 05/11 10/31 20/11 10/31 20/11 10/31 20/11	303	
	FLOOR BEDROOM REVISED (INT 4) GLAZING CALCULATION REVISED TO BUT		NOV. MITT	Proj.No. TBD	




Front Elevation

A STATE OF THE PARTY OF THE PAR	Unit 7		Unit B	- 12	Unit 9	
Print.	Imperial	Metric	Impenal	Metru	Imperial	Metric
Um. Distance	> 19.68	> 6.00	> 19.68	> 6.00	> 19.68	> 6.00
Incideling facia pross	436.00	40.51	430.93	40.04	416.98	38.74
gitteling area	98.42	9.14	99.42	9.14	98.42	9.14
portentage	22.57%		22.84%		23.60%	
The planet.	7		TA 1		2.0	
200	-				Imperial	Metric
Cler. Distance	n/a		n/a		14.60	4.45
Sarbitry face pres			100		805.26	74.81
clasing area					40.04	3.72
percentage	~ /				4.97%	22
HAR AND SEC.					21.00	
	Impenal	Metric	Imperial.	Mecro	Impensi	Meenic
Lim. Distance	17.22	5.25	17.22	5.25	14.73	4.69
hollding face ares	400.31	37.19	400.31	37.19	400.31	37.19
otherwise more	111.90	10.40	111.90	10.40	111.90	10.40
Destructions	27.95%		27.95%		27,95%	
Milliand In	Shirt will		4100		1 -120	
South	Imperial:	Metric				
Line Distance	9.84	3.00	n/a		n/a	
building face grea	834.78	77.55	3			
Marries Scan	65.68	6.12				
percentage	7.89%					
Name of Gradies	Blance of					


Rear Elevation Scale: 1:100



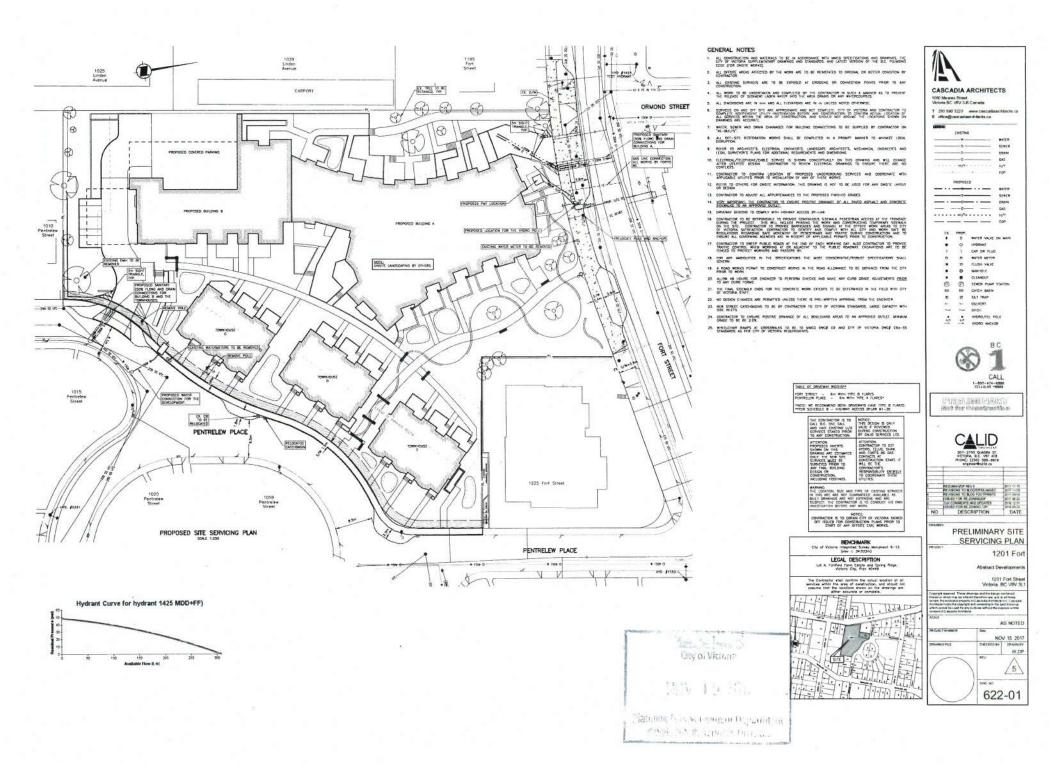





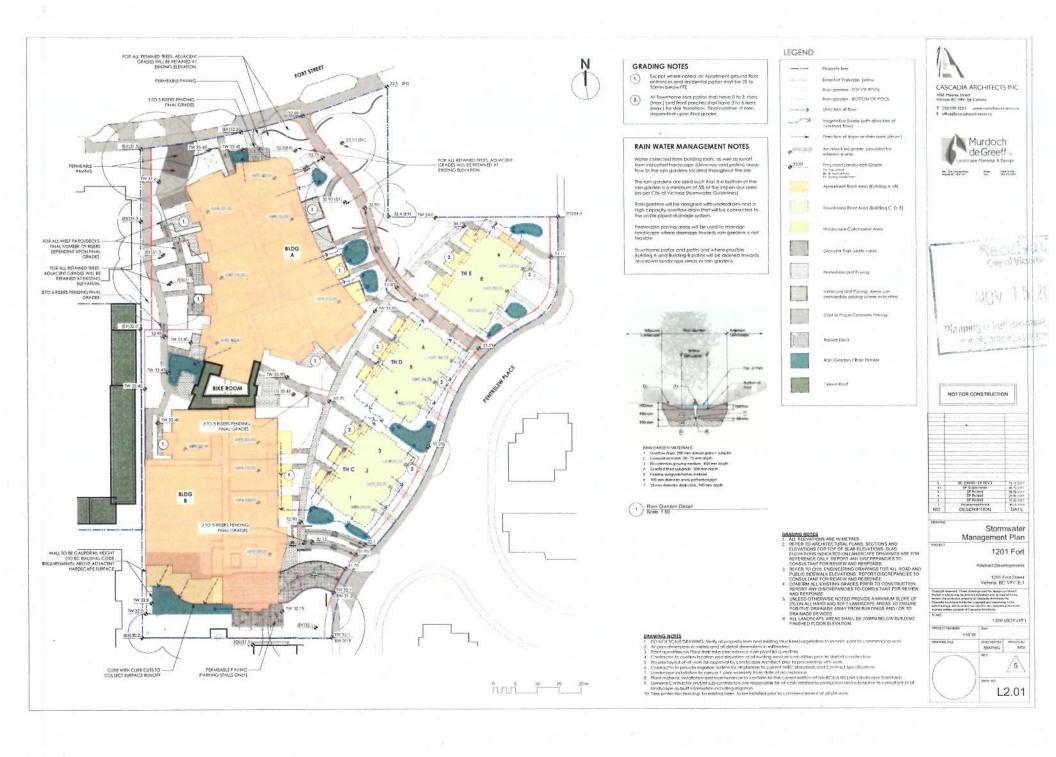





TREE PLANTING PALETTE













SHRUB AND PERENNIAL PLANTING TYPOLOGIES



























CASCADIA ARCHITECTS INC

T 350 \$70 3723 www.cocold E office@cocoldarchimeta.co



TEUE MAG City of Victoria

Planning & Development De Inchast a Service in

NOT FOR CONSTRUCTION

-+		_
		_
-		_
-		_
_		
_		
_		
_		
_		_
_		_
-+		_
-+		_
-+		+
-+		_
-		-
-	D ^a Revised	-
-	D' Rosest	\$2.00,200
	D* Rodad	
	Deverage of Parent	28.702011
2	DESCRIPTION	DATE
-		1
Tanta		
	Law	

Landscape Materials Palette

1201 Fort





























HARDSCAPE MATERIALS



